ROAD LONGITUDINAL PROFILE

LEGEND: - Natural Ground Level Planned Level BADARKHALI SIDE 12.00m 11.00m 10.00m 9.00m 8.00m 7.00m 6.00m 5.00m 4.00m 3.00m 2.00m 1.00m Datum0.00m Natural G.L Chainage Planned Level 89.99

PROFILE SCALE H=1/1000, V=1/200


Roads a	nd Highways Department (RHD)	Preparatory Survey on Cittagong Area Coal Fired Power Plant	JAPAN INTERNATIONAL	DRAWING TITLE:	SCALE	DATE	DRAWING NO
	of Communications	Development Project in Bangladesh	COOPERATION AGENCY (JICA)	ROAD LOGITUDINAL PROFILE BADARKHALI TO PLANT SITE	1:1000	AUGUST, 2013	PS/CFPP/S2K-00; 1 OF 19

LEGEND: - Natural Ground Level Planned Level BADARKHALI SIDE 12.00m 11.00m 10.00m 9.00m SCALE H=1/1000, V=1/200 8.00m 7.00m 6.00m 5.00m 4.00m 3.00m 2.00m 1.00m Datum0.00m CULVERT OF Natural G.L 76.2 size: 3.64mX10.98m Chainage Planned Level **PROFILE** SCALE H=1/1000, V=1/200

 Preparatory Survey on Cittagong Area Coal Fired Power Plant	JAPAN INTERNATIONAL	DRAWING TITLE:	SCALE	DATE	DRAWING NC
Development Project in Bangladesh	COOPERATION AGENCY (JICA)	ROAD LOGITUDINAL PROFILE BADARKHALI TO PLANT SITE	1:1000	AUGUST, 2013	3 PS/CFPP/S2K-003 2 OF 19

LEGEND: - Natural Ground Level Planned Level BADARKHALI SIDE 12.00m 11.00m 10.00m 9.00m 8.00m 7.00m 6.00m 5.00m 4.00m 3.00m 2.00m 1.00m Datum0.00m Natural G.L 1100.000 750.000 Chainage Planned Level PROFILE SCALE H=1/1000, V=1/200

Roads and Highways Department (RHD)	Preparatory Survey on Cittagong Area Coal Fired Power Plant	JAPAN INTERNATIONAL	DRAWING TITLE:	SCALE	DATE	DRAWING NC
Ministry of Communications	Development Project in Bangladesh	COOPERATION AGENCY (JICA)	ROAD LOGITUDINAL PROFILE BADARKHALI TO PLANT SITE	1:1000	AUGUST, 2013	3 PS/CFPP/S2K-00; 3 OF 19

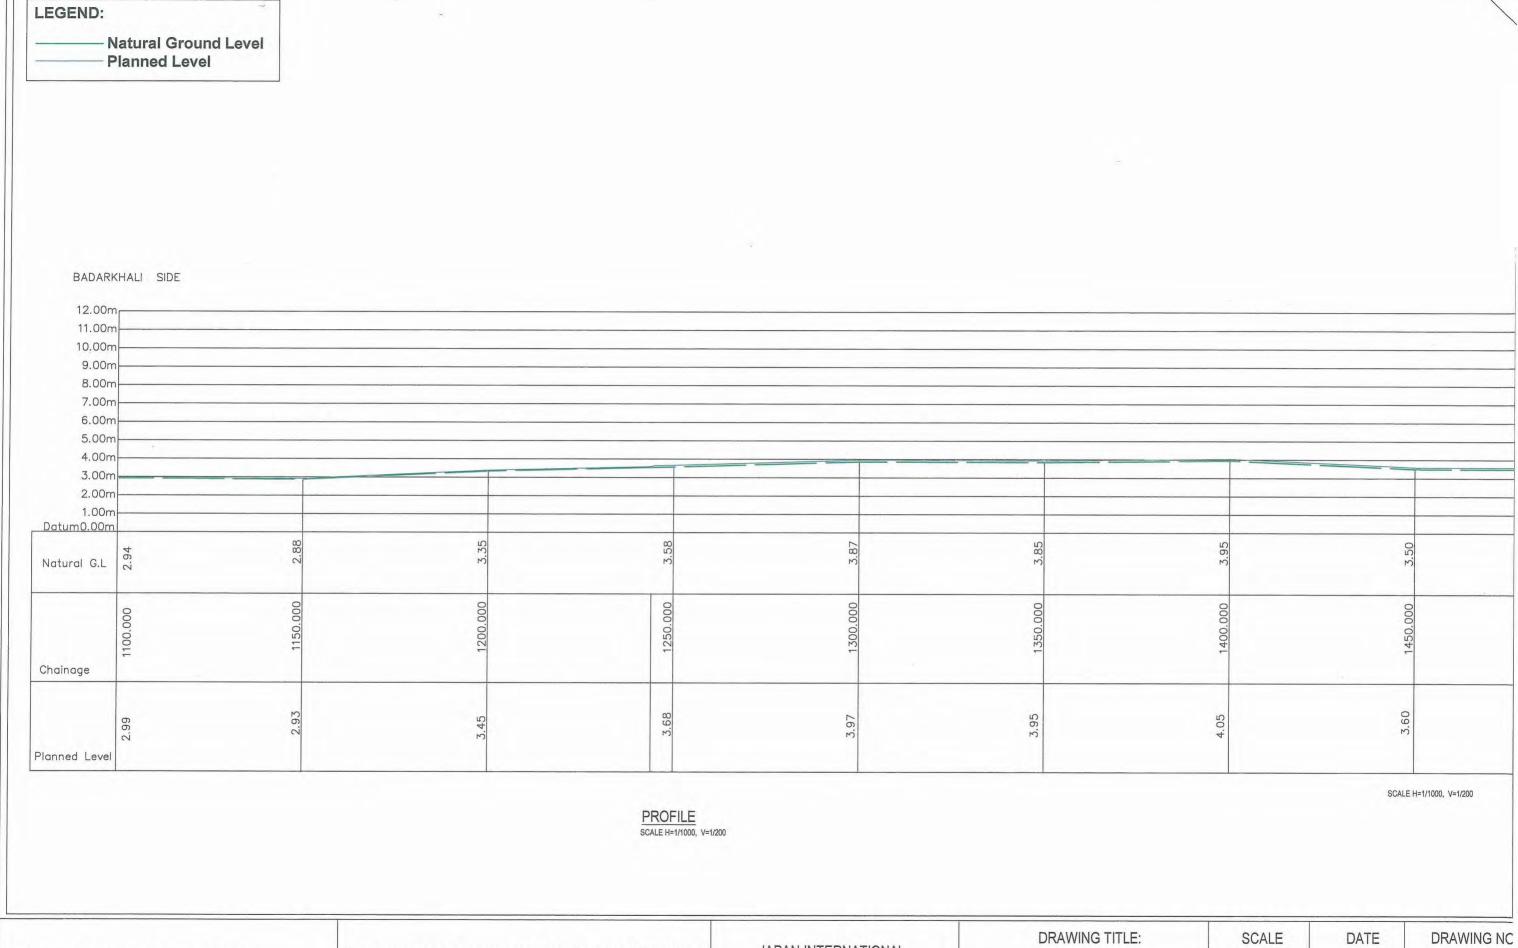

Roads and Highways Department (RHD)

Ministry of Communications

Preparatory Survey on Cittagong Area Coal Fired Power Plant

Development Project in Bangladesh

COOPERATION AGENCY (JICA)


Development Project in Bangladesh

AUGUST, 2013

PS/CFPP/S2K-00:
4 OF 19

LEGEND: Natural Ground Level Planned Level BADARKHALI SIDE 12.00m 11.00m 10.00m 9.00m 8.00m 7.00m 6.00m 5.00m 4.00m 3.00m 2.00m 1.00m Datum0.00m CULVERT CULVERT CULVERT size: 3.67mX11.03m size: 2.68mX7.47m size: 2.08mX6.57m Natural G.L 1600.000 1650.000 1750.000 Chainage 5.31 7.16 8.01 Planned Level PROFILE SCALE DRAWING TITLE: DRAWING NC DATE JAPAN INTERNATIONAL Preparatory Survey on Cittagong Area Coal Fired Power Plant Roads and Highways Department (RHD) ROAD LOGITUDINAL PROFILE PS/CFPP/S2K-000 Development Project in Bangladesh Ministry of Communications COOPERATION AGENCY (JICA) 1:1000 AUGUST, 2013 BADARKHALI TO PLANT SITE 5 OF 19

BADARKHALI SIDE

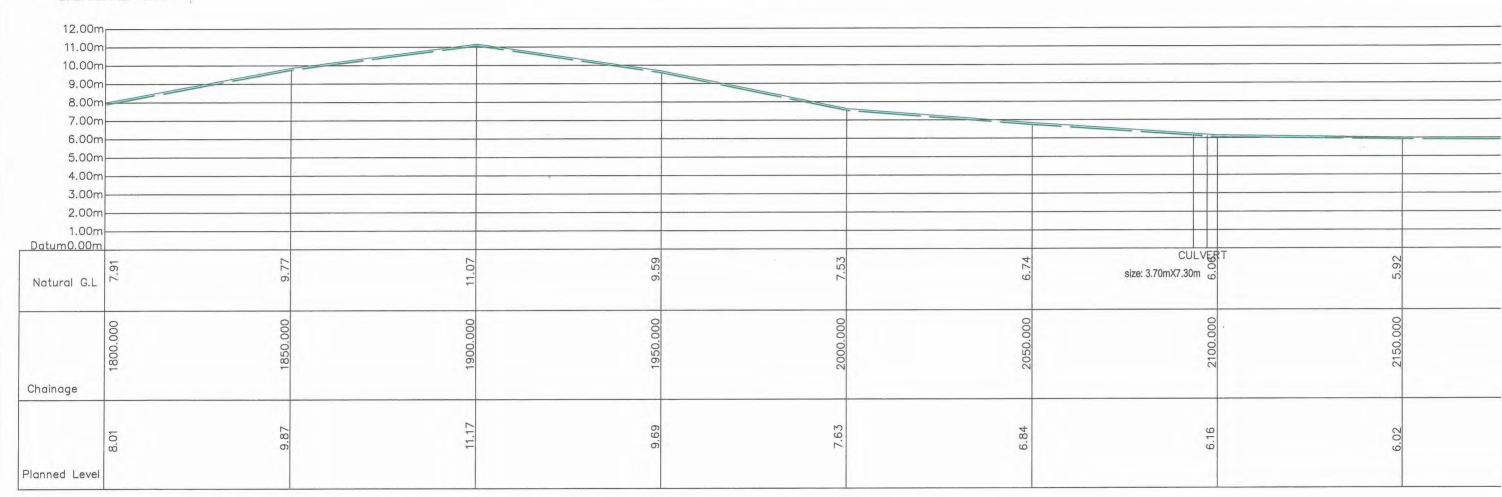

PROFILE SCALE H=1/1000, V=1/200

	Preparatory Survey on Cittagong Area Coal Fired Power Plant	JAPAN INTERNATIONAL	DRAWING TITLE:	SCALE	DATE	DRAWING NC
Roads and Highways Department (RHD) Ministry of Communications	Development Project in Bangladesh	COOPERATION AGENCY (JICA)	ROAD LOGITUDINAL PROFILE BADARKHALI TO PLANT SITE	1:1000	AUGUST, 2013	PS/CFPP/S2K-00(6 OF 19

LEGEND: - Natural Ground Level Planned Level BADARKHALI SIDE 12.00m 11.00m 10.00m 9.00m 8.00m 7.00m 6.00m 5.00m 4.00m 3.00m 2.00m 1.00m Datum0.00m CULXERT size: 1.96mX7.23m Natural G.L 26.5

2200.000

Chainage

Planned Level

PROFILE SCALE H=1/1000, V=1/200

Roads and Highways Department (RHD)	Preparatory Survey on Cittagong Area Coal Fired Power Plant	JAPAN INTERNATIONAL	DRAWING TITLE:	SCALE	DATE	DRAWING NC
Ministry of Communications	Development Project in Bangladesh	COOPERATION AGENCY (JICA)	ROAD LOGITUDINAL PROFILE BADARKHALI TO PLANT SITE	1:1000	AUGUST, 2013	7 OF 19

LEGEND: Natural Ground Level Planned Level BADARKHALI SIDE 12.00m 11.00m 10.00m 9.00m 8.00m 7.00m 6.00m 5.00m 4.00m 3.00m 2.00m 1.00m Datum0.00m CULVERT CULVERT size: 2.68mX7.25m size: 3.90mX7.49m size: 2.68mX7.25m Natural G.L 2700.000 Chainage 5.00 Planned Level **PROFILE** SCALE H=1/1000, V=1/200 DRAWING TITLE: SCALE DATE DRAWING NO JAPAN INTERNATIONAL Preparatory Survey on Cittagong Area Coal Fired Power Plant Roads and Highways Department (RHD)

COOPERATION AGENCY (JICA)

Development Project in Bangladesh

Ministry of Communications

ROAD LOGITUDINAL PROFILE

BADARKHALI TO PLANT SITE

PS/CFPP/S2K-003

8 OF 19

AUGUST, 2013

1:1000

LEGEND: Natural Ground Level Planned Level BADARKHALI SIDE 12.00m 11.00m 10.00m 9.00m 8.00m 7.00m 6.00m 5.00m 4.00m 3.00m 2.00m 1.00m Datum0.00m CULVERT size: 3.57mX7.26m 4.94 Natural G.L Chainage 5.49 5.36 10 5.04 Planned Level PROFILE SCALE H=1/1000, V=1/200 DRAWING TITLE: DRAWING NC SCALE DATE

JAPAN INTERNATIONAL

COOPERATION AGENCY (JICA)

ROAD LOGITUDINAL PROFILE

BADARKHALI TO PLANT SITE

PS/CFPP/S2K-003

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AUGUST, 2013

1:1000

Preparatory Survey on Cittagong Area Coal Fired Power Plant

Development Project in Bangladesh

Roads and Highways Department (RHD)

Ministry of Communications

LEGEND: - Natural Ground Level Planned Level BADARKHALI SIDE 12.00m 11.00m 10.00m 9.00m 8.00m 7.00m 6.00m 5.00m 4.00m 3.00m 2.00m 1.00m Datum0.00m Natural G.L Chainage Planned Level PROFILE SCALE H=1/1000, V=1/200

Roads and Highways Department (RHD)	Preparatory Survey on Cittagong Area Coal Fired Power Plant	JAPAN INTERNATIONAL	DRAWING TITLE:	SCALE	DATE	DRAWING NO
Ministry of Communications	Development Project in Bangladesh	COOPERATION AGENCY (JICA)	ROAD LOGITUDINAL PROFILE BADARKHALI TO PLANT SITE	1:1000	AUGUST, 2013	PS/CFPP/S2K-00 10 OF 19

LEGEND: Natural Ground Level Planned Level BADARKHALI SIDE 12.00m 11.00m 10.00m 9.00m 8.00m 7.00m 6.00m 5.00m 4.00m 3.00m 2.00m 1.00m Datum0.00m CULVERT NO Size: 2.24mX3.44m 3.07 Natural G.L 88 7 Chainage 5.5 5.5 Planned Level **PROFILE** SCALE H=1/1000, V=1/200 DRAWING TITLE: SCALE DATE DRAWING NC JAPAN INTERNATIONAL Preparatory Survey on Cittagong Area Coal Fired Power Plant Roads and Highways Department (RHD) AUGUST, 2013 PS/CFPP/S2K-003 ROAD LOGITUDINAL PROFILE Development Project in Bangladesh COOPERATION AGENCY (JICA) 1:1000 Ministry of Communications

BADARKHALI TO PLANT SITE


11 OF 19

LEGEND: - Natural Ground Level Planned Level BADARKHALI SIDE 12.00m 11.00m 10.00m 9.00m 8.00m 7.00m 6.00m 5.00m 4.00m 3.00m 2.00m 1.00m Datum0.00m Natural G.L Chainage Planned Level PROFILE SCALE H=1/1000, V=1/200


Roads and Highways Department (RHD)	Preparatory Survey on Cittagong Area Coal Fired Power Plant	JAPAN INTERNATIONAL	DRAWING TITLE:	SCALE	DATE	DRAWING NO
Ministry of Communications	Development Project in Bangladesh	COOPERATION AGENCY (JICA)	ROAD LOGITUDINAL PROFILE BADARKHALI TO PLANT SITE	1:1000	AUGUST, 2013	PS/CFPP/S2K-00 12 OF 19

LEGEND: - Natural Ground Level Planned Level BADARKHALI SIDE 12.00m 11.00m 10.00m 9.00m 8.00m 7.00m 6.00m 5.00m 4.00m 3.00m 2.00m 1.00m Datum0.00m Natural G.L Chainage Planned Level PROFILE SCALE H=1/1000, V=1/200

Poods and Highways Department (PHD)	Preparatory Survey on Cittagong Area Coal Fired Power Plant	JAPAN INTERNATIONAL	DRAWING TITLE:	SCALE	DATE	DRAWING NO
Roads and Highways Department (RHD) Ministry of Communications	Development Project in Bangladesh	COOPERATION AGENCY (JICA)	ROAD LOGITUDINAL PROFILE BADARKHALI TO PLANT SITE	1:1000	AUGUST, 2013	PS/CFPP/S2K-00 13 OF 19

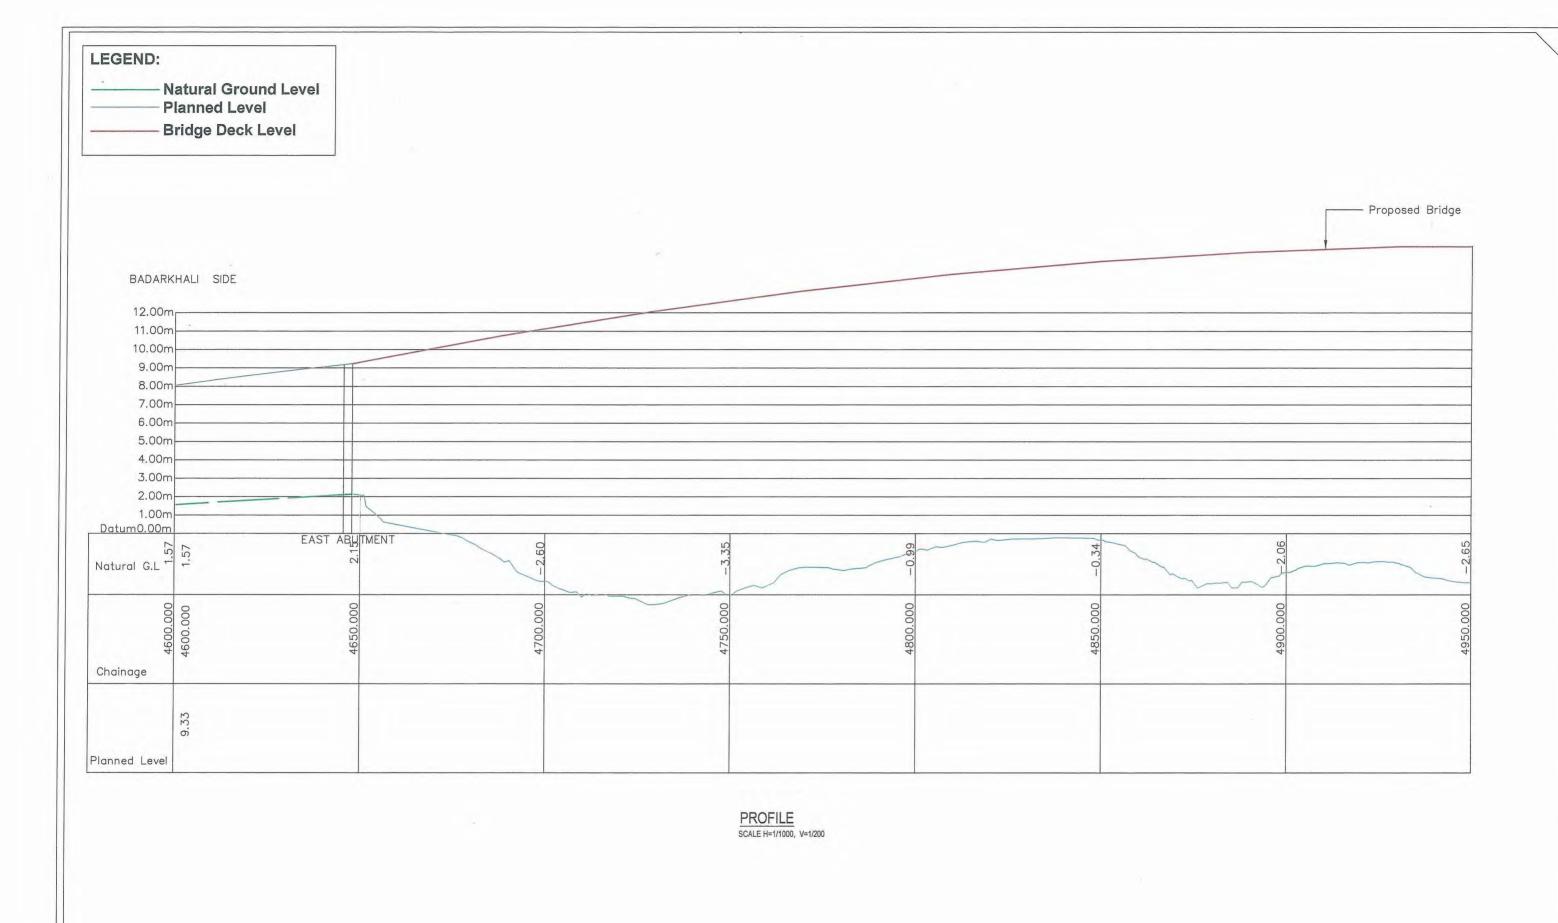

Roads and Highways Department (RHD)	Preparatory Survey on Cittagong Area Coal Fired Power Plant	JAPAN INTERNATIONAL	DRAWING TITLE:	SCALE	DATE	DRAWING NC
Ministry of Communications	Development Project in Bangladesh	COOPERATION AGENCY (JICA)	ROAD LOGITUDINAL PROFILE BADARKHALI TO PLANT SITE	1:1000	AUGUST, 2013	PS/CFPP/S2K-00 14 OF 19

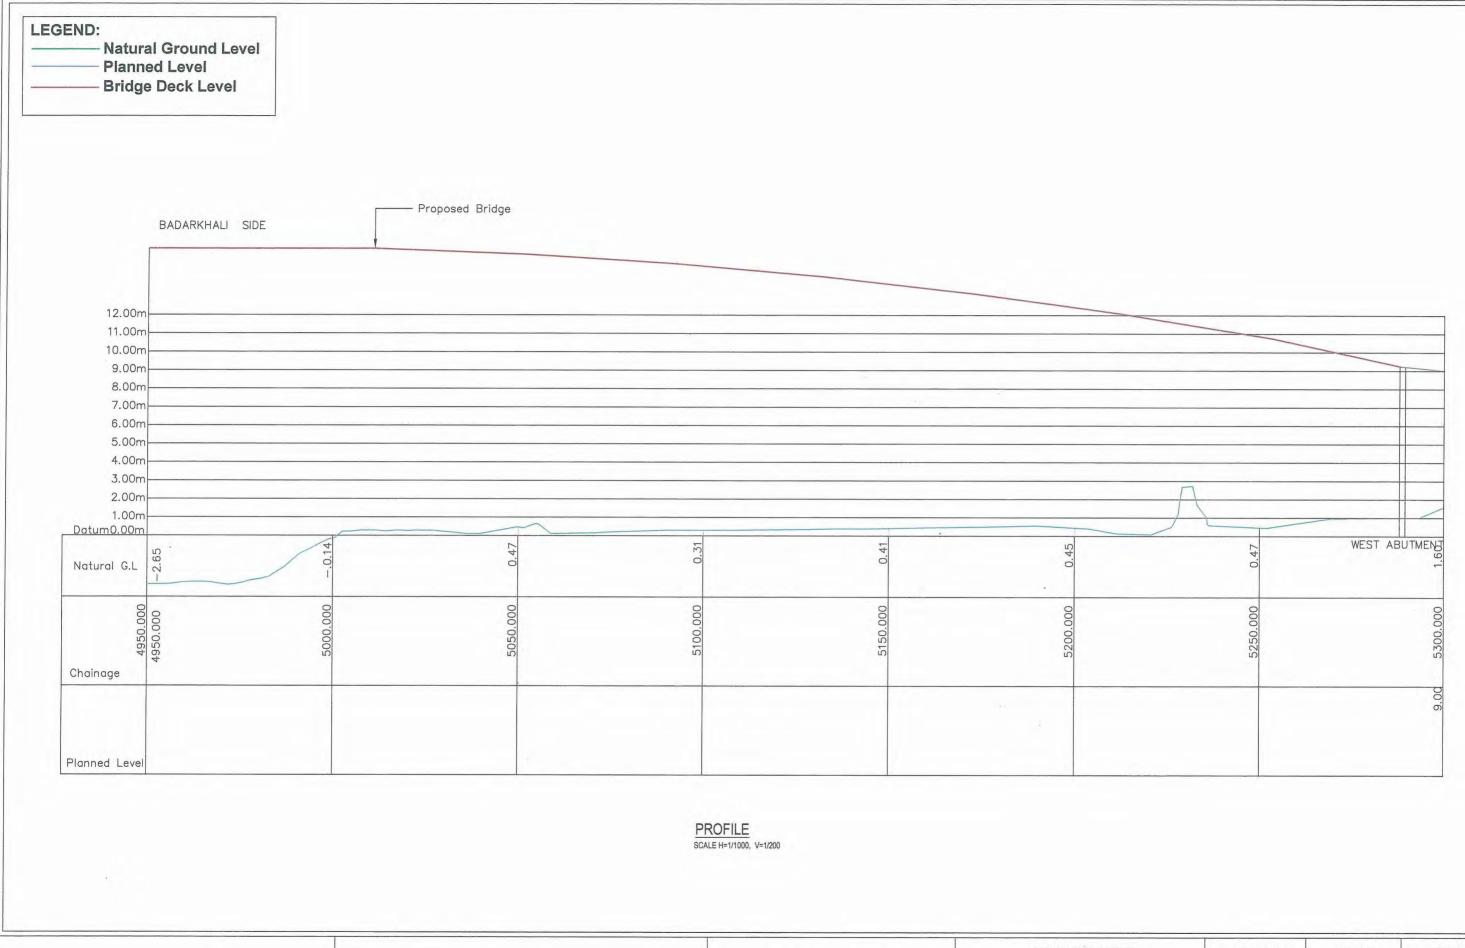

Roads and Highways Department (RHD)	Preparatory Survey on Cittagong Area Coal Fired Power Plant	JAPAN INTERNATIONAL	DRAWING TITLE:	SCALE	DATE	DRAWING NC
Ministry of Communications	Development Project in Bangladesh	COOPERATION AGENCY (JICA)	ROAD LOGITUDINAL PROFILE BADARKHALI TO PLANT SITE	1:1000	AUGUST, 2013	PS/CFPP/S2K-000 15 OF 19

LEGEND: Natural Ground Level Planned Level BADARKHALI SIDE 12.00m 11.00m 10.00m 9.00m 8.00n 7.00m 6.00m 5.00m 4.00m 3.00m 2.00m 1.00m Datum 0.00m Natural G.L 5350.000 5300.000 Chainage 9.00 Planned Level **PROFILE** SCALE H=1/1000, V=1/200 DRAWING TITLE: SCALE DRAWING N DATE JAPAN INTERNATIONAL Preparatory Survey on Cittagong Area Coal Fired Power Plant Roads and Highways Department (RHD)

Roads and Highways Department (RHD)

Ministry of Communications

Preparatory Surve

Development

Preparatory Survey on Cittagong Area Coal Fired Power Plant

Development Project in Bangladesh

COOPERATION AGENCY (JICA)

ROAD LOGITUDINAL PROFILE
BADARKHALI TO PLANT SITE

SCALE

DATE

DRAWING No.


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AUGUST, 2013

PS/CFPP/S2K-00
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LEGEND:

Natural Ground Level
Planned Level



Roads and Highways Department (RHD)

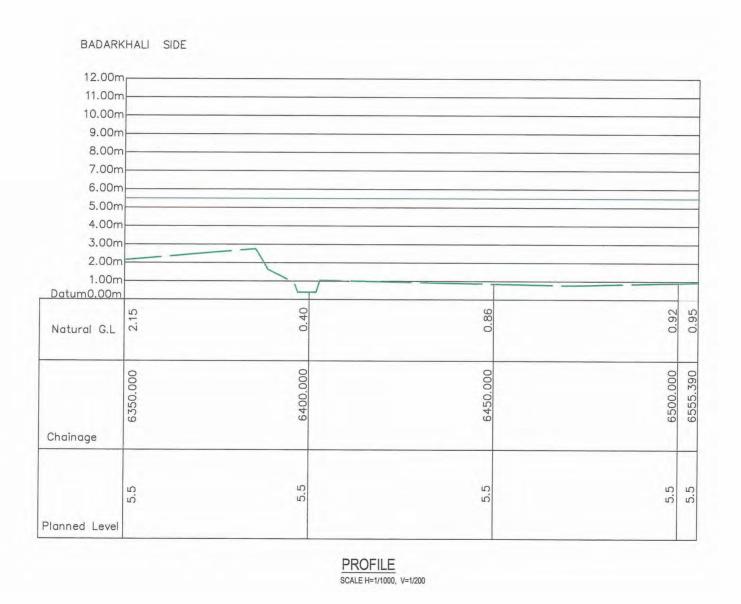Ministry of Communications

Preparatory Survey on Cittagong Area Coal Fired Power Plant

Development Project in Bangladesh

JAPAN INTERNATIONAL
COOPERATION AGENCY (JICA)

DRAWING TITLE: SCALE DATE DRAWING N

ROAD LOGITUDINAL PROFILE
BADARKHALI TO PLANT SITE


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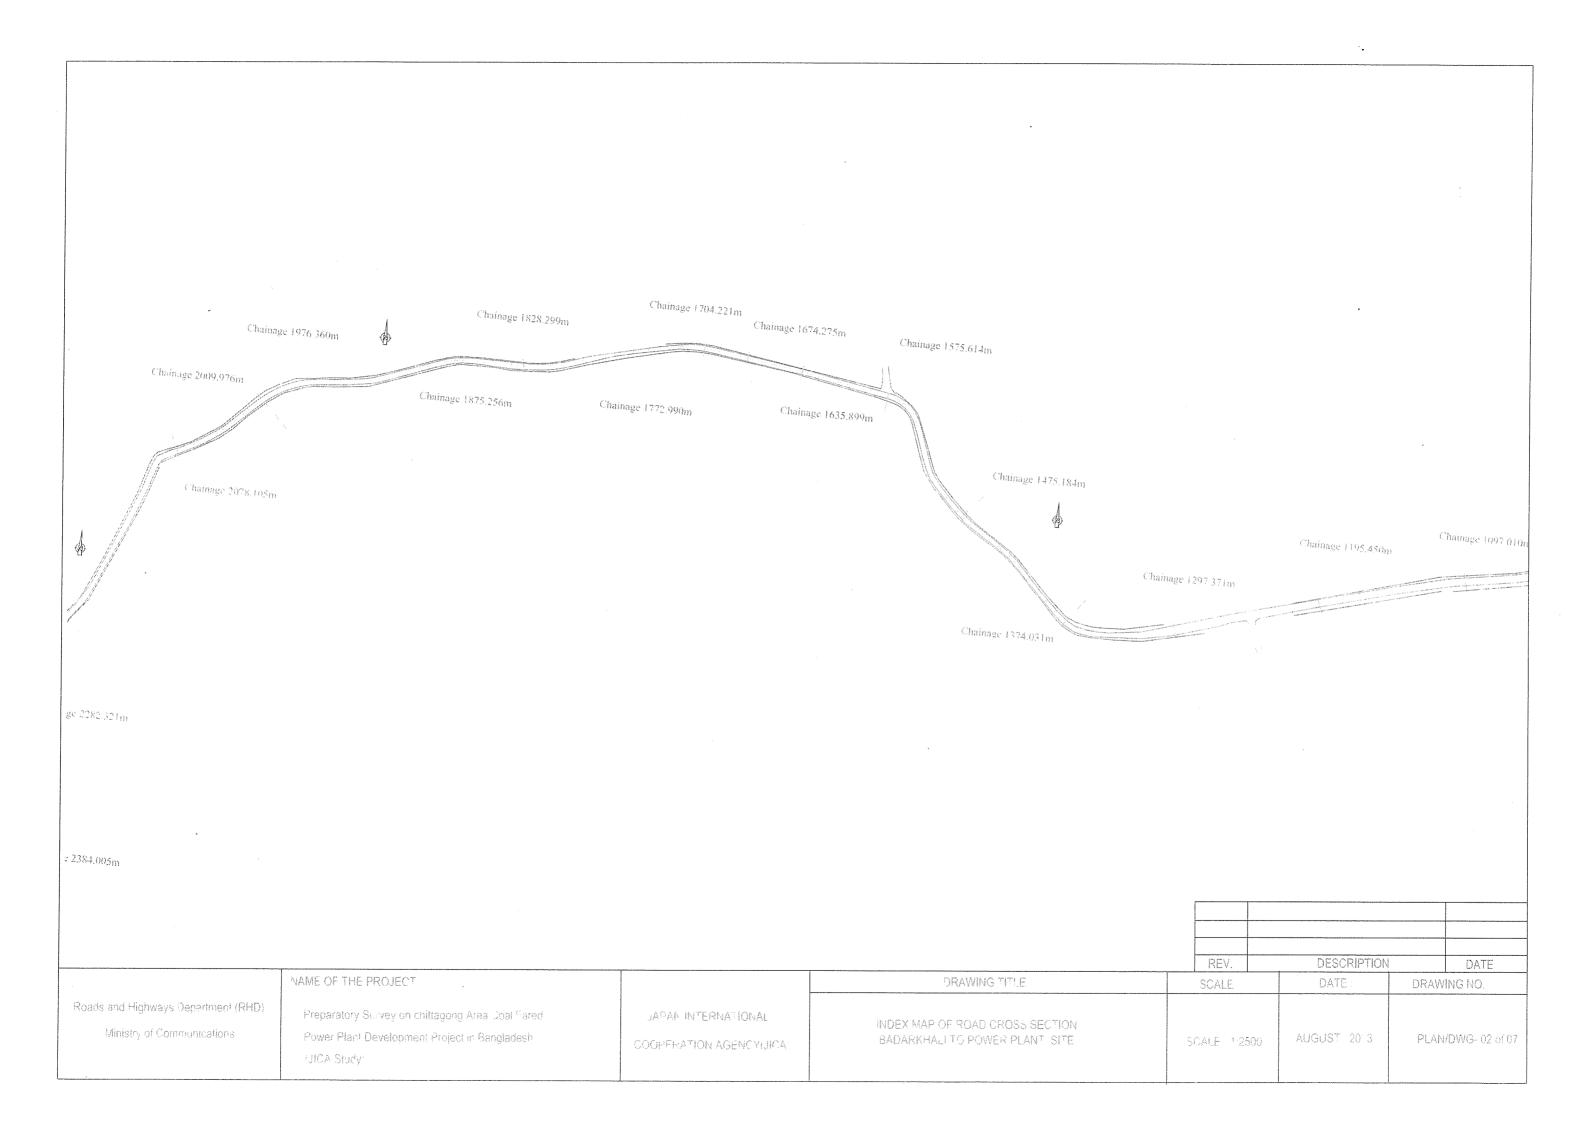
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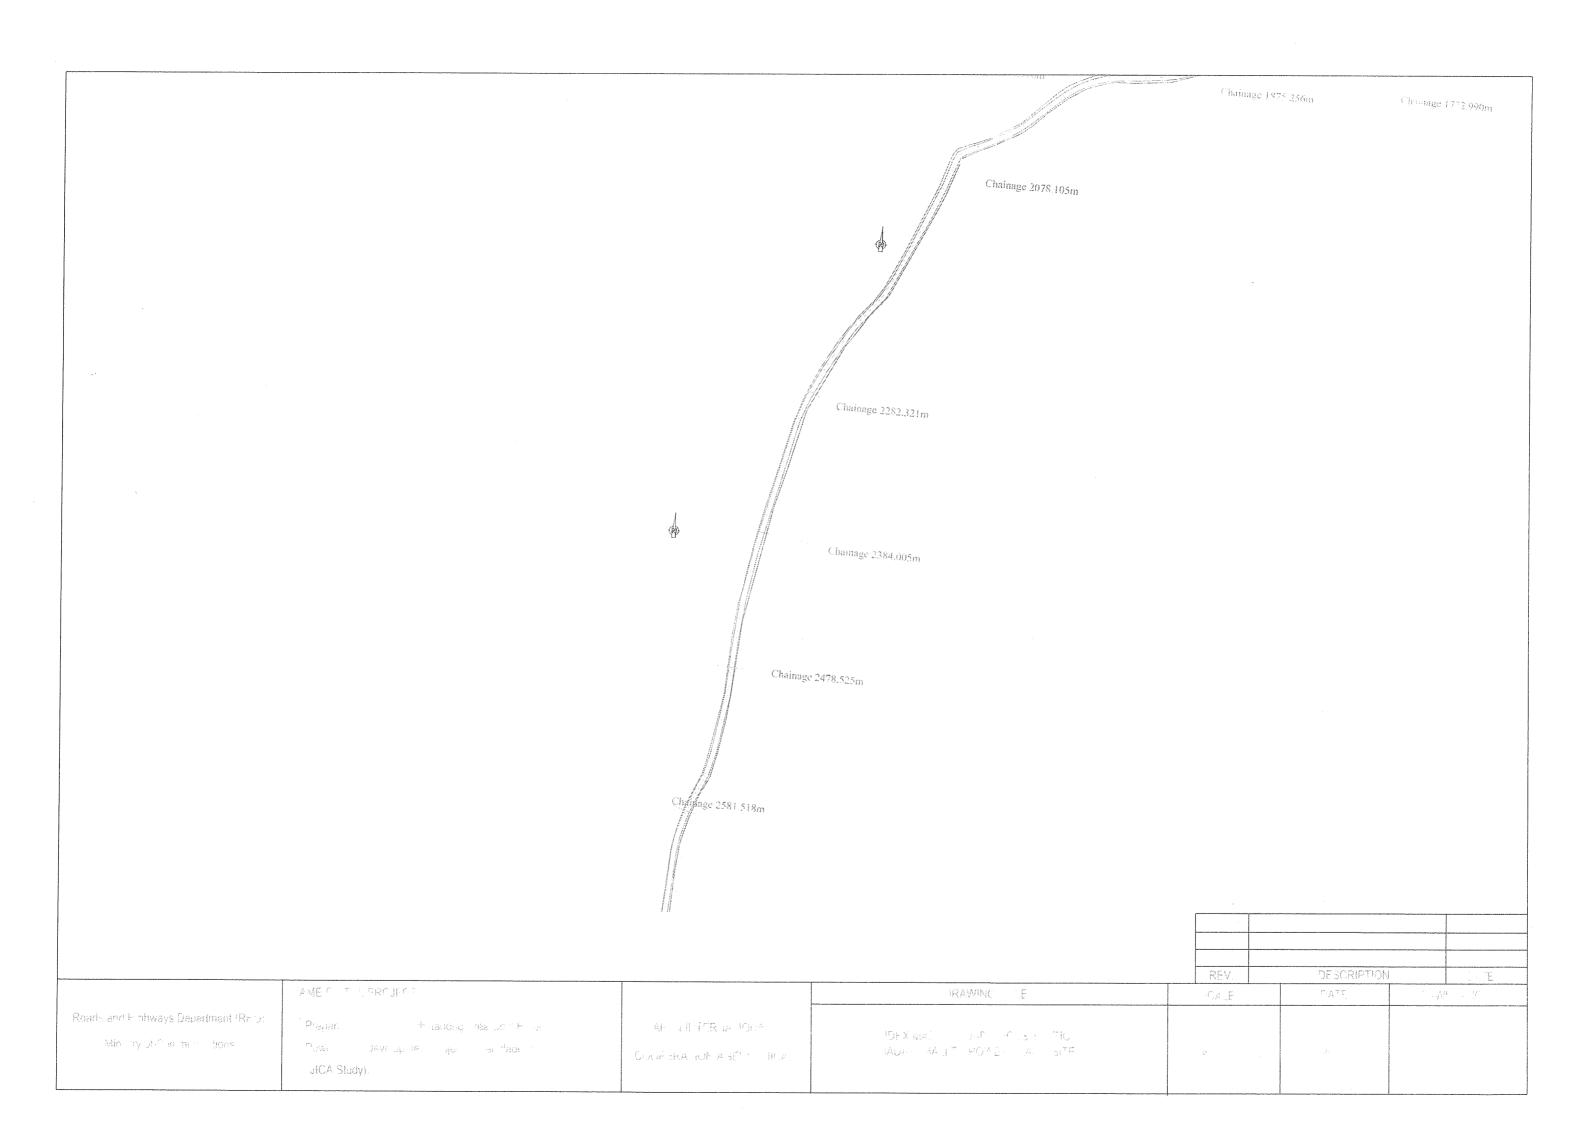
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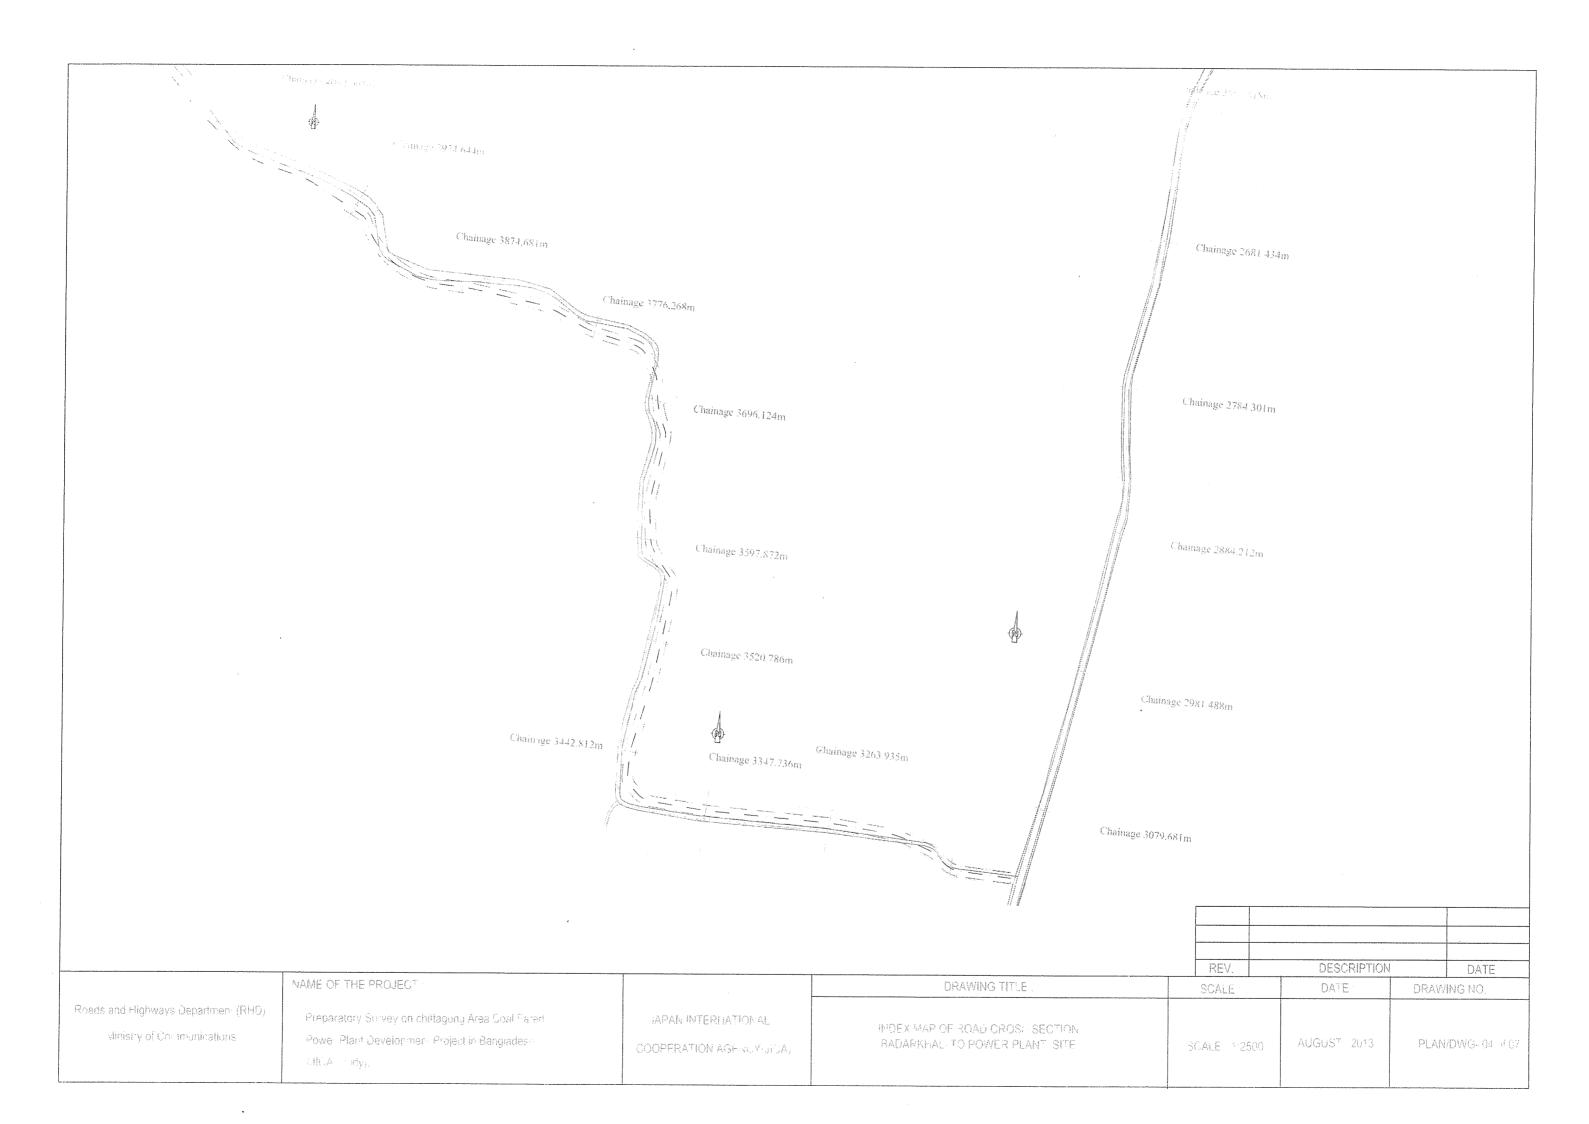
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19 OF 19


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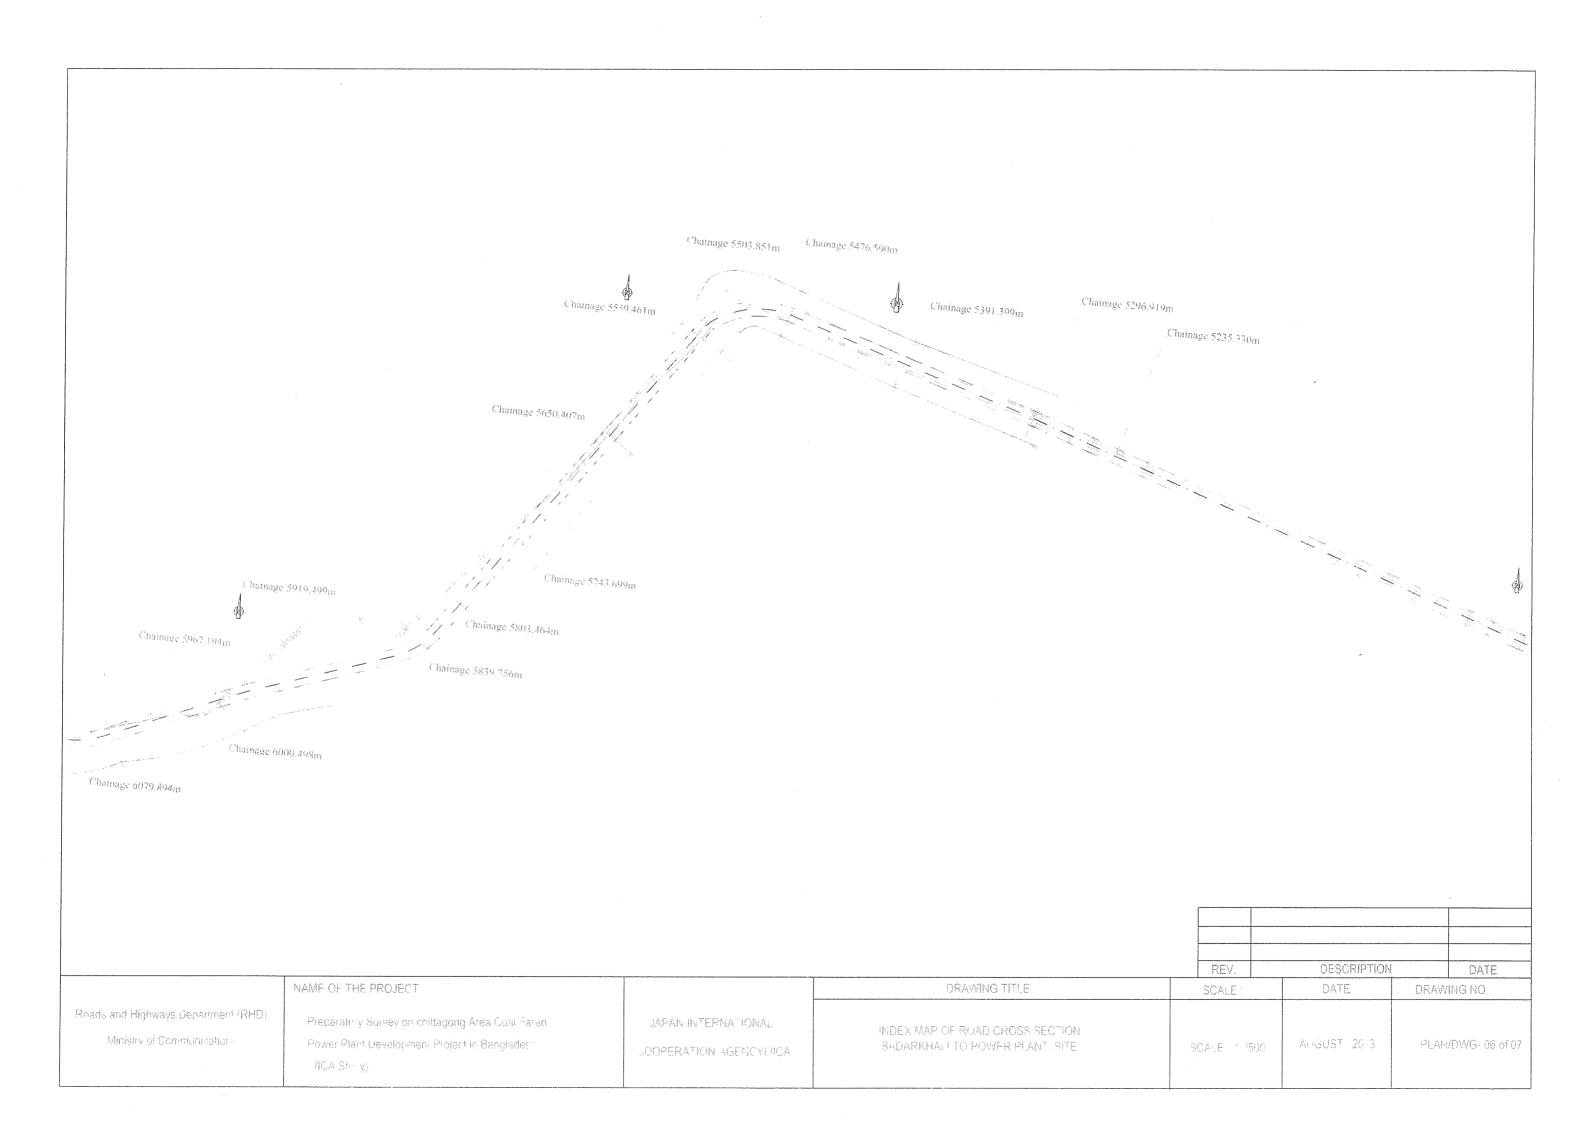










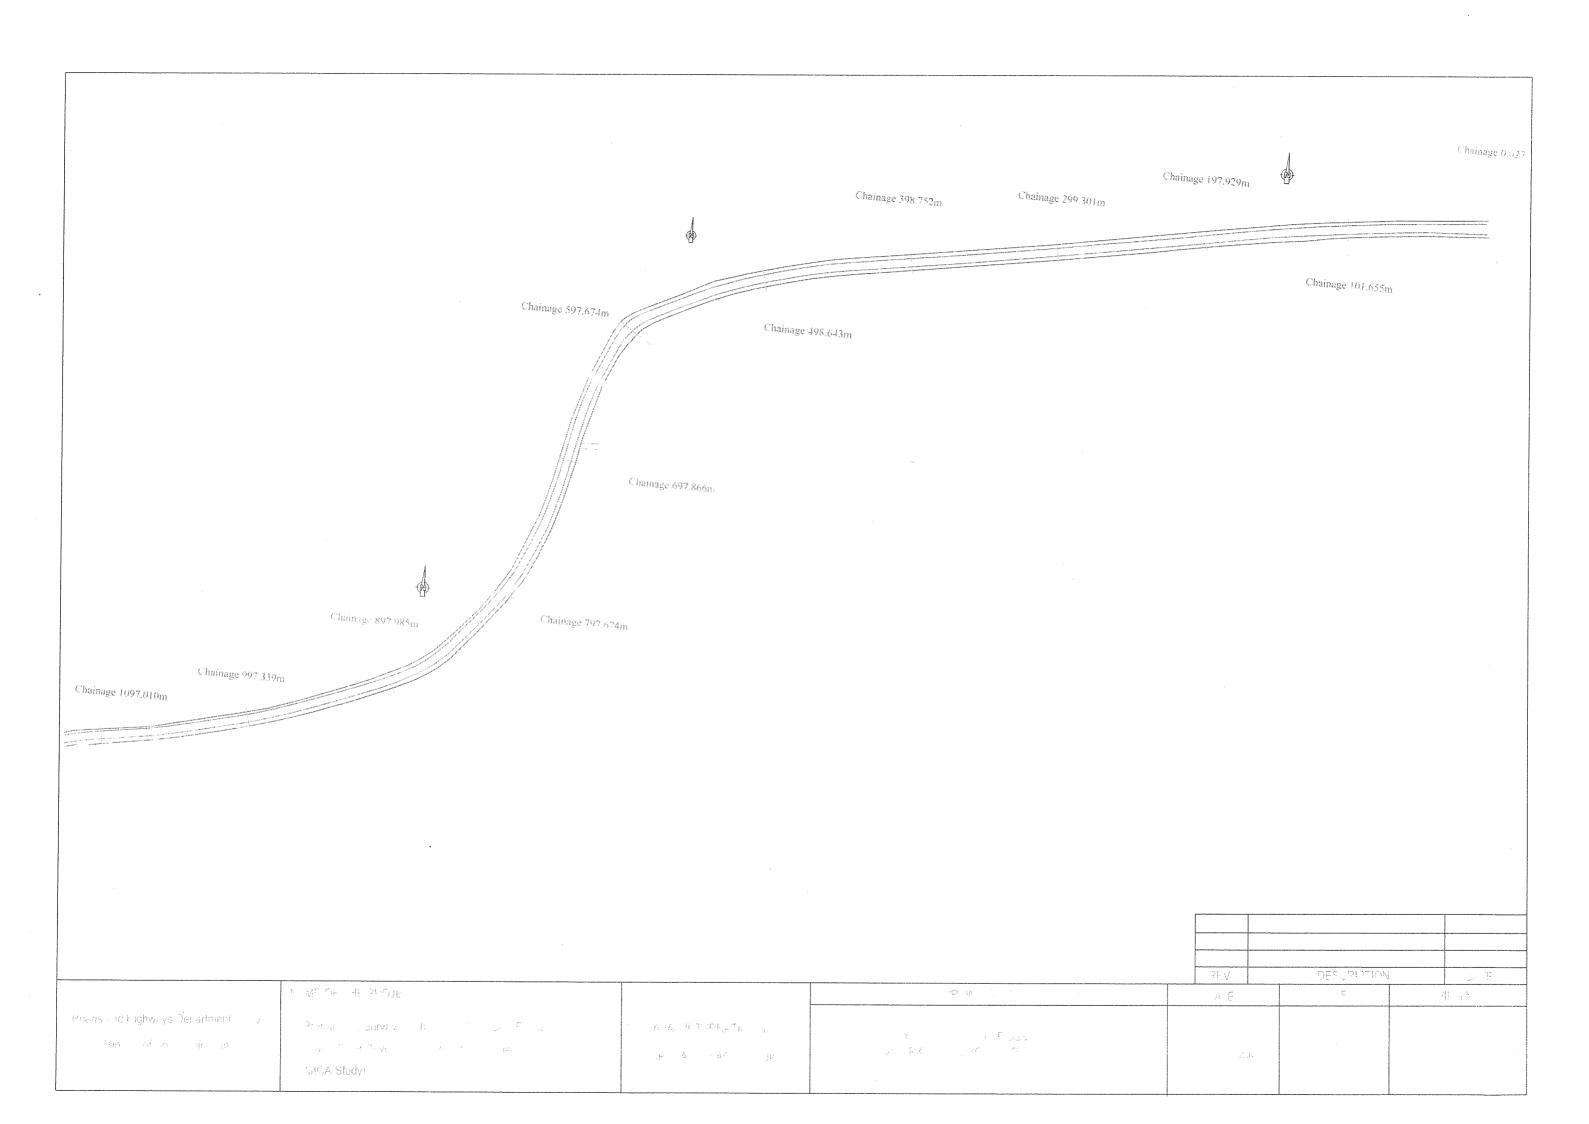

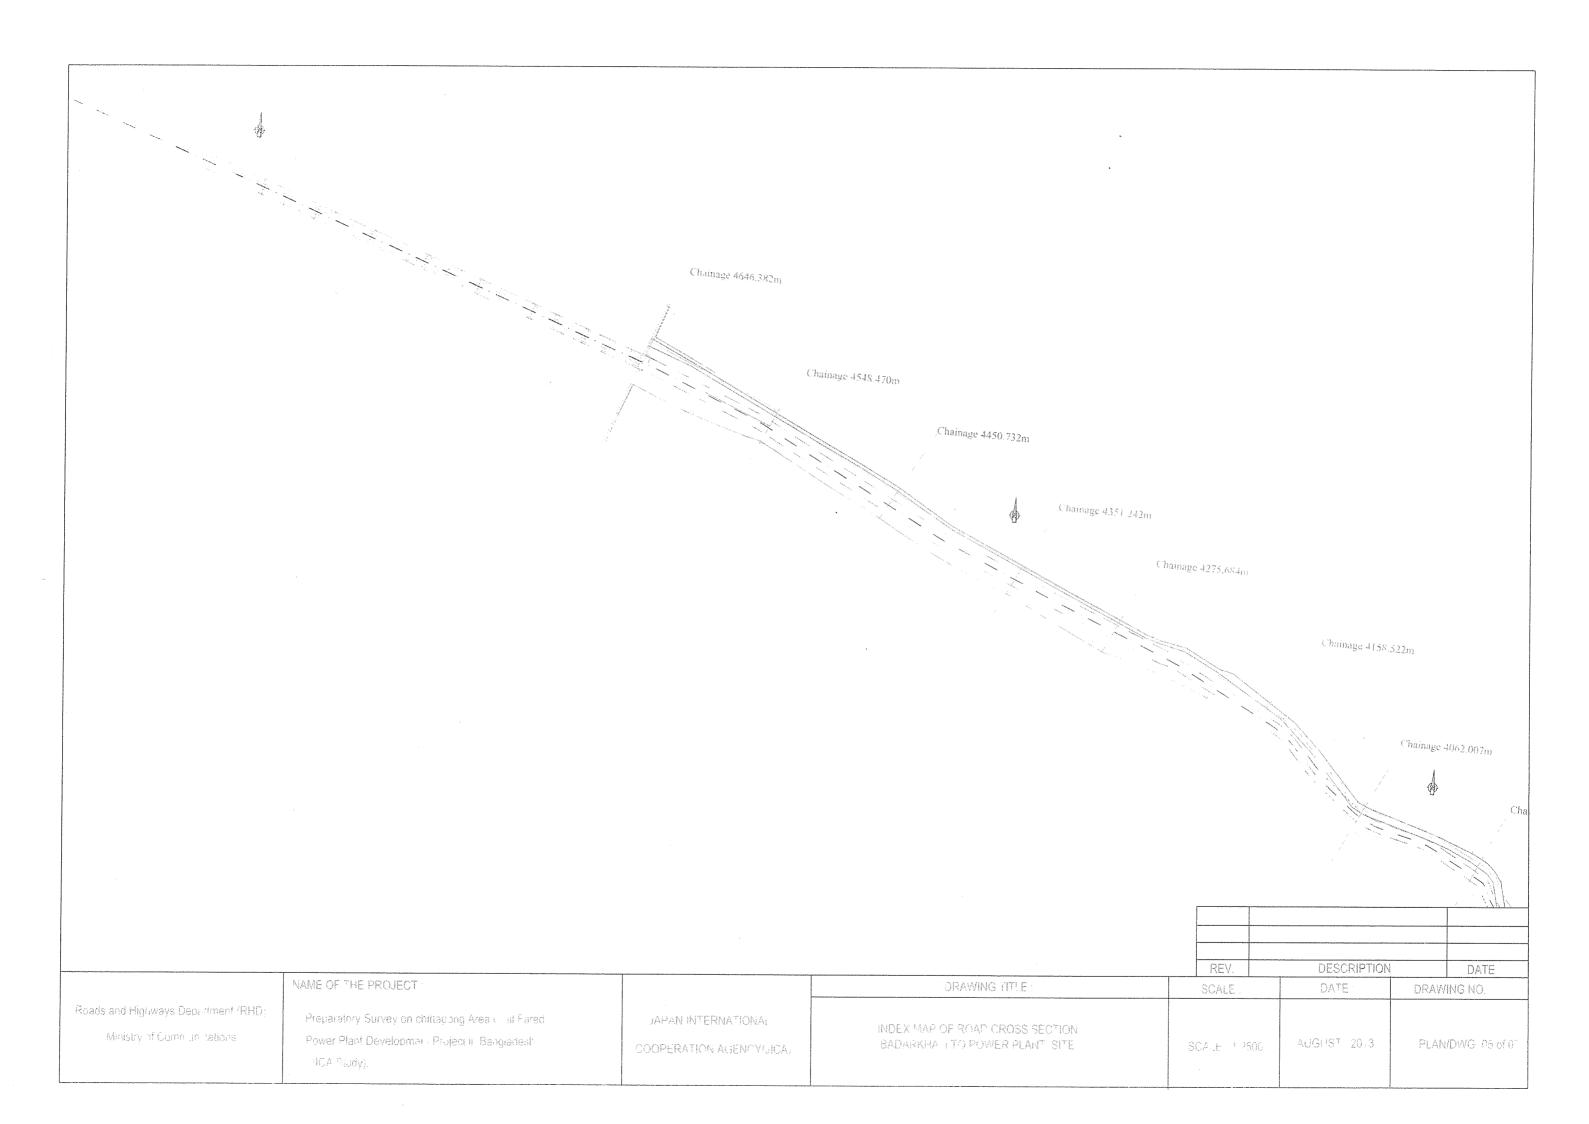

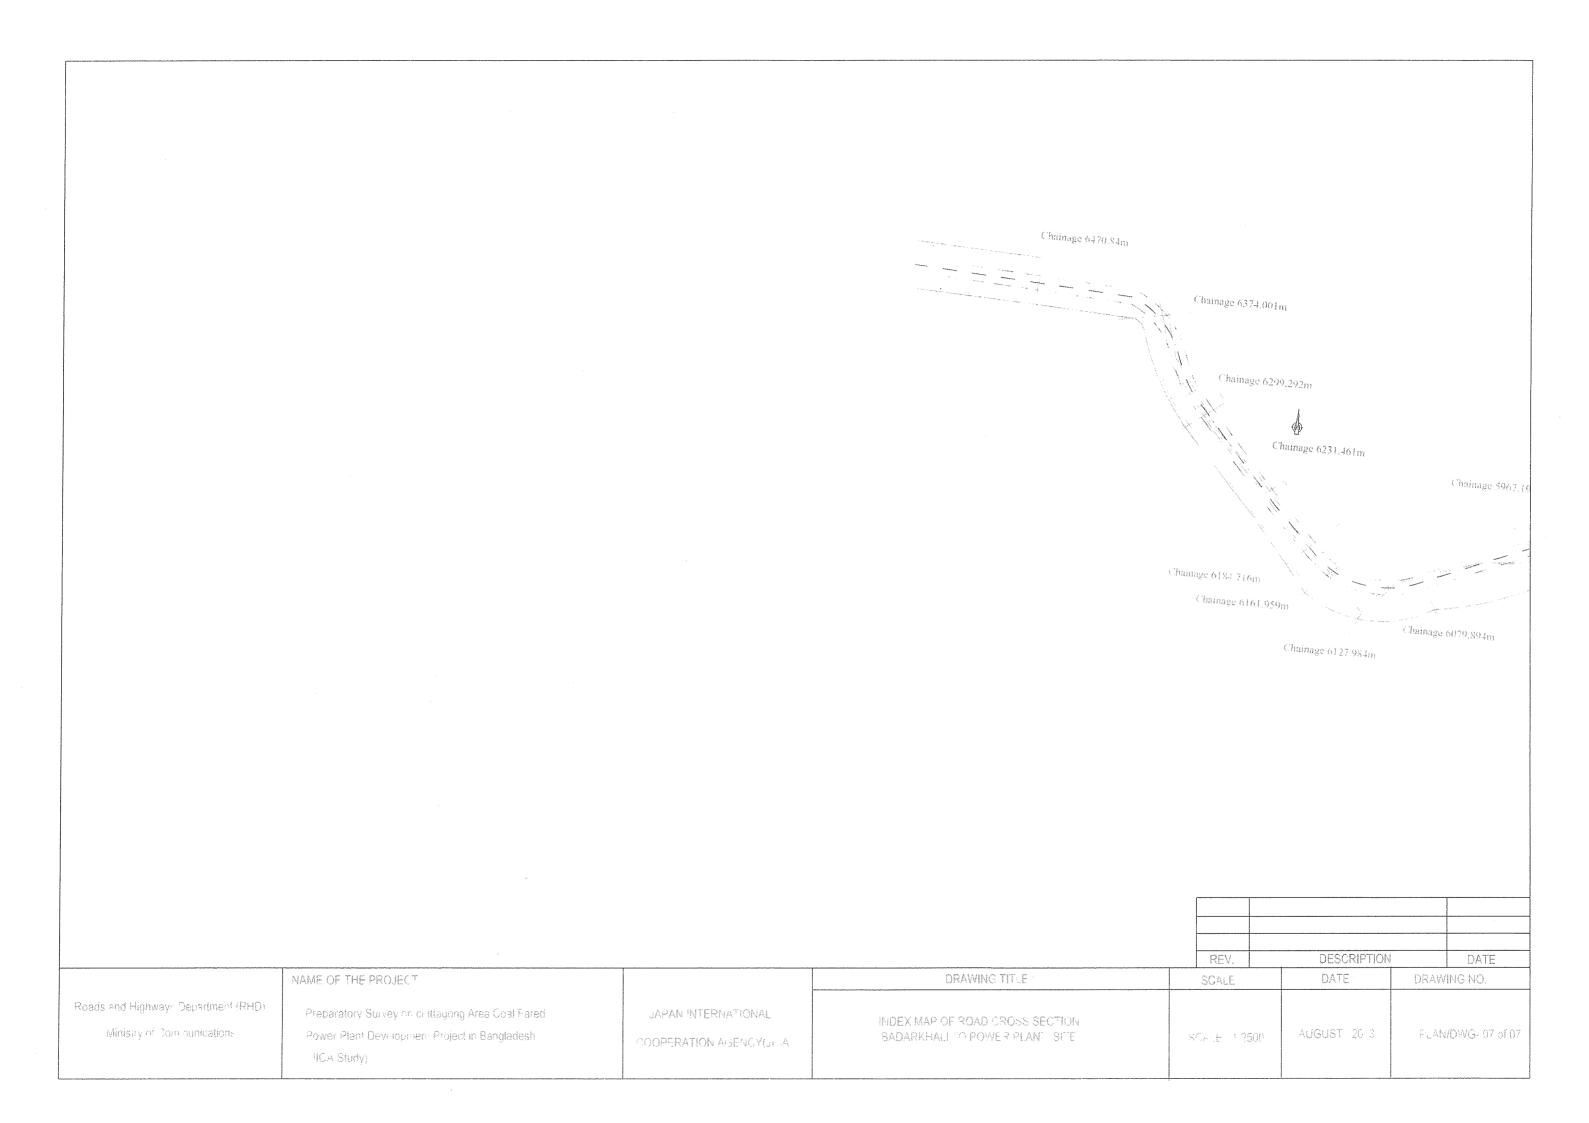


DESIGN CROSS SECTION

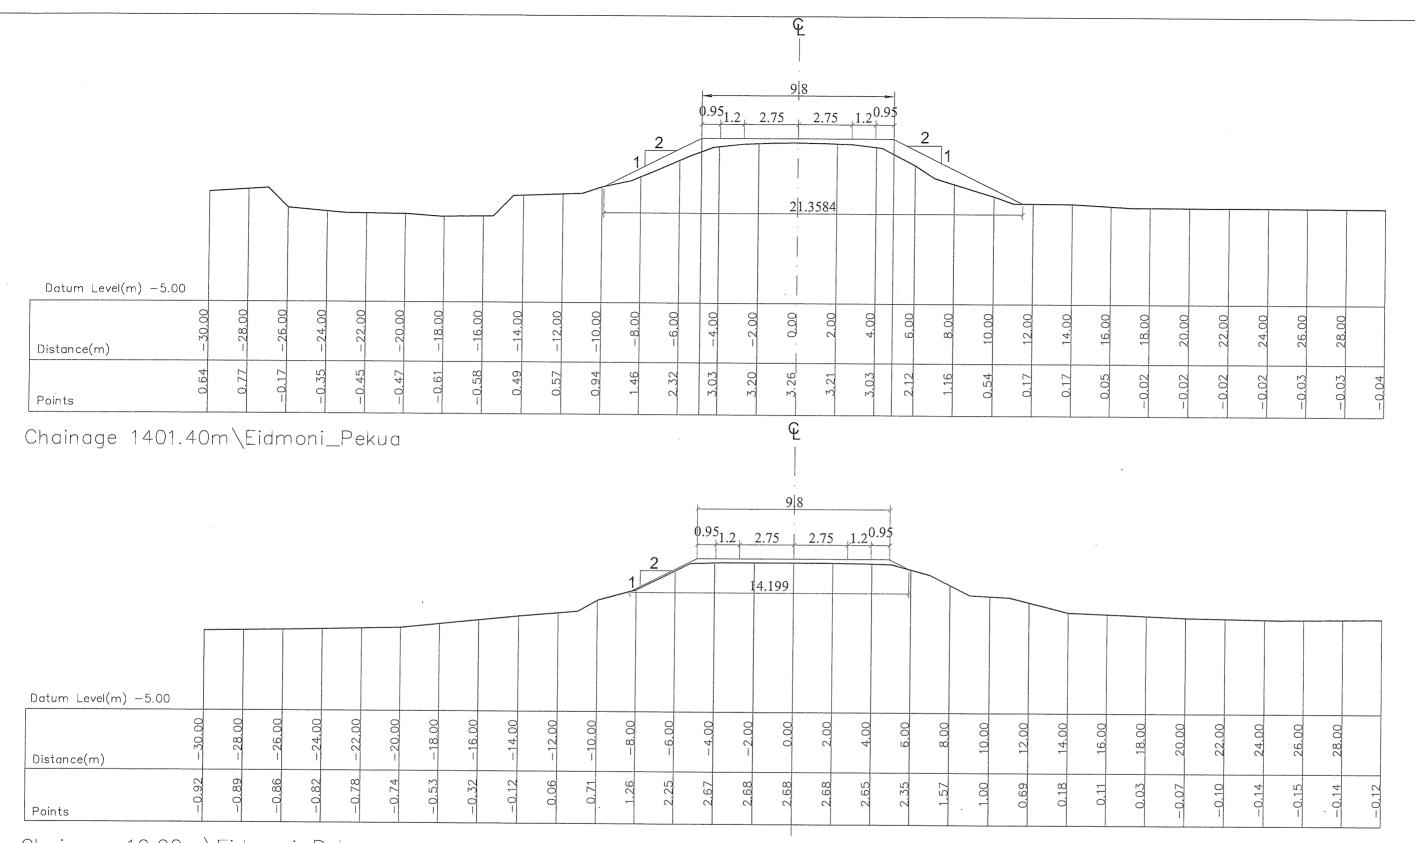


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				REV.	DESCRIPTION	DATE
	NAME OF THE PROJECT :		DRAWING TITLE :	SCALE:	DATE:	DRAWING NO.
Roads and Highways Department (RHD) Ministry of Communications	Preparatory Survey on chittagong Area Coal Fared Power Plant Development Project in Bangladesh (JICA Study).	JAPAN INTERNATIONAL COOPERATION AGENCY(JICA)	ROAD CROSS SECTION EIDMONI TO PEKUA	1:200	AUGUST, 2013	CS/DWG-01 of 54

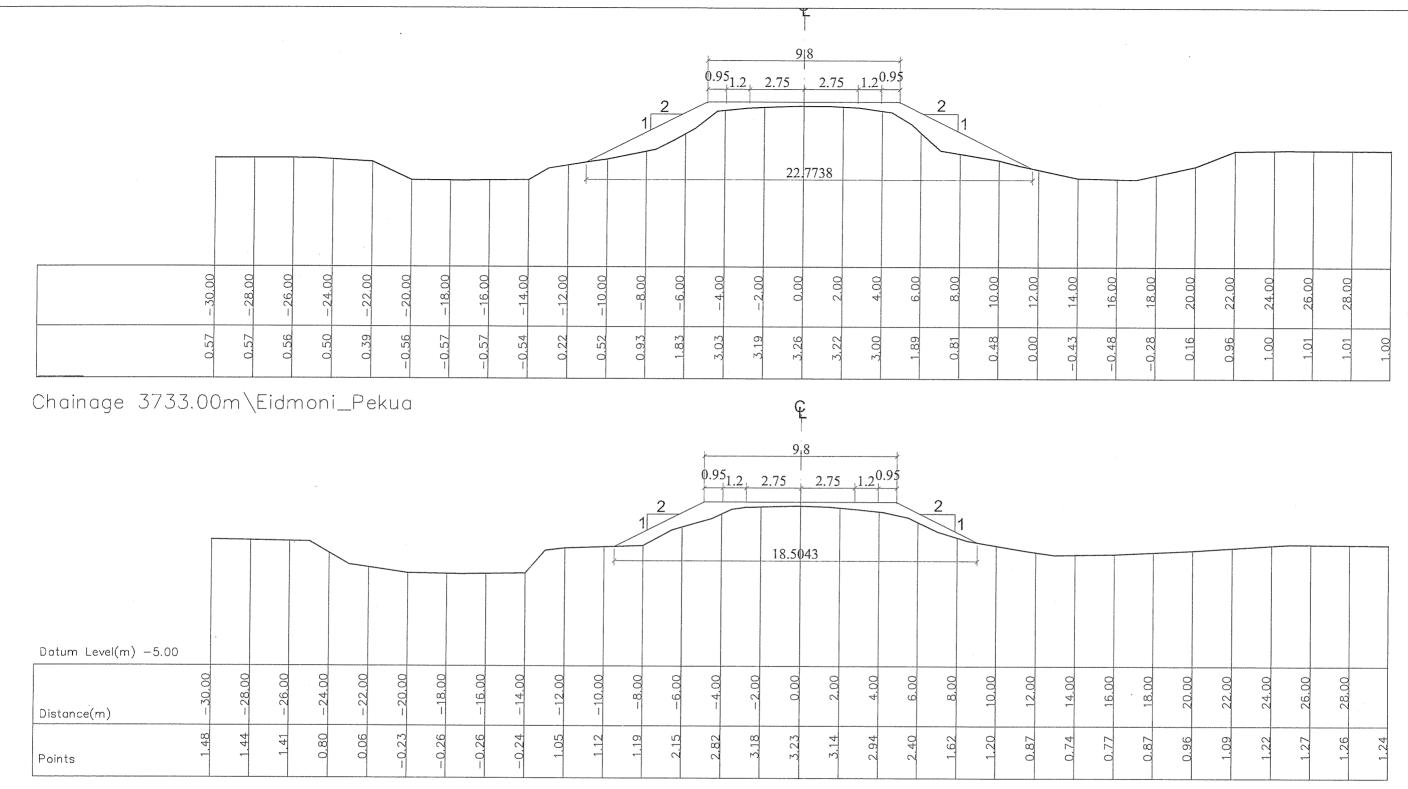


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Roads and Highways Department (RHD) Ministry of Communications	Preparatory Survey on chittagong Area Coal Fared Power Plant Development Project in Bangladesh (JICA Study).	JAPAN INTERNATIONAL COOPERATION AGENCY(JICA)	ROAD CROSS SECTION EIDMONI TO PEKUA	1:200	AUGUST, 2013	CS/DWG-02 of 54




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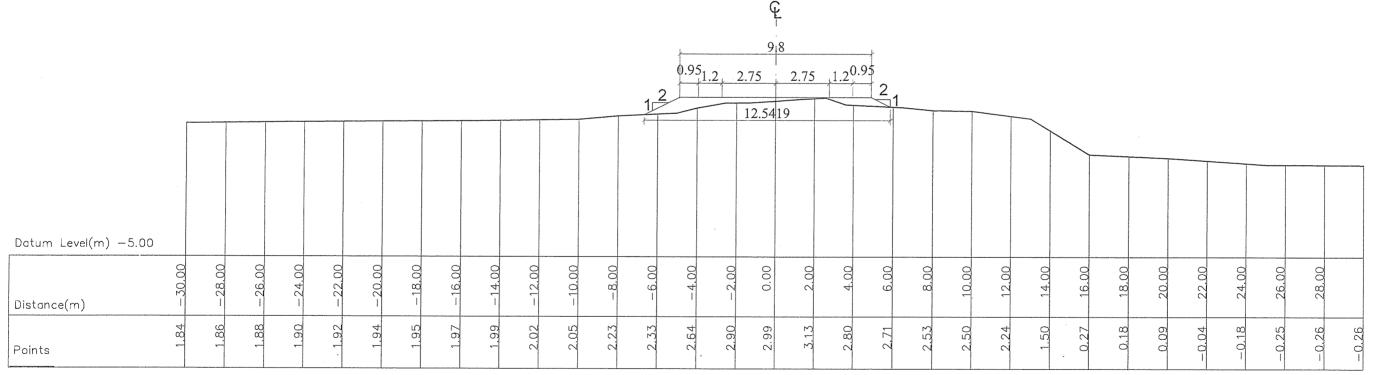

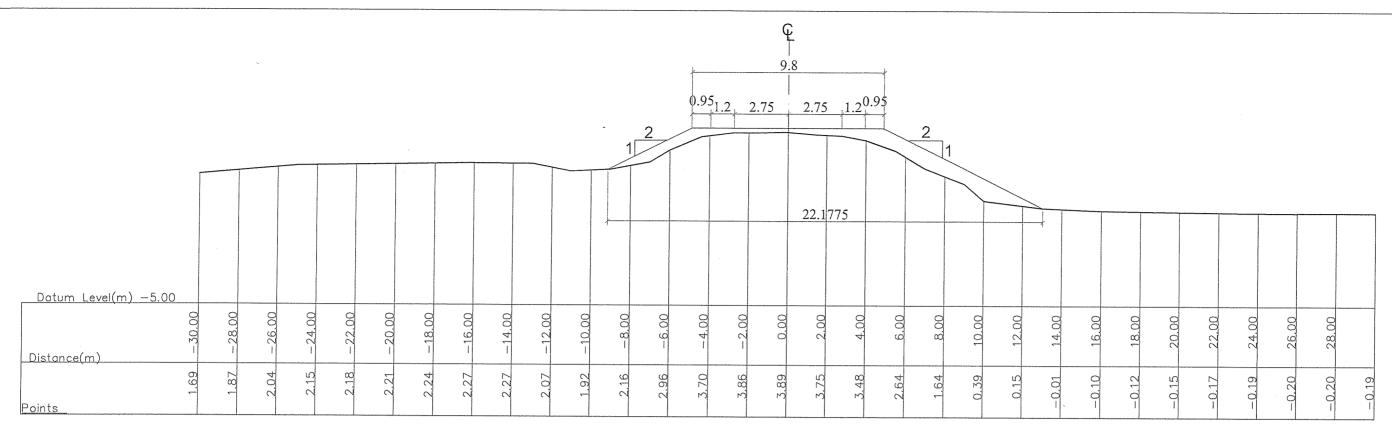
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Roads and Highways Department (RHD) Ministry of Communications	Preparatory Survey on chittagong Area Coal Fared Power Plant Development Project in Bangladesh (JICA Study).	JAPAN INTERNATIONAL COOPERATION AGENCY(JICA)	ROAD CROSS SECTION EIDMONI TO PEKUA	1:200	AUGUST, 2013	CS/DWG-03 of 54

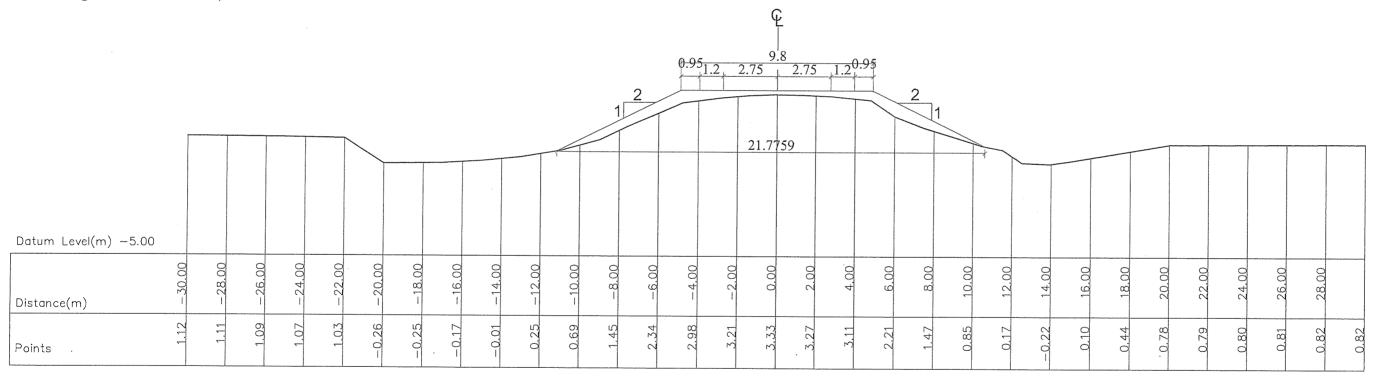



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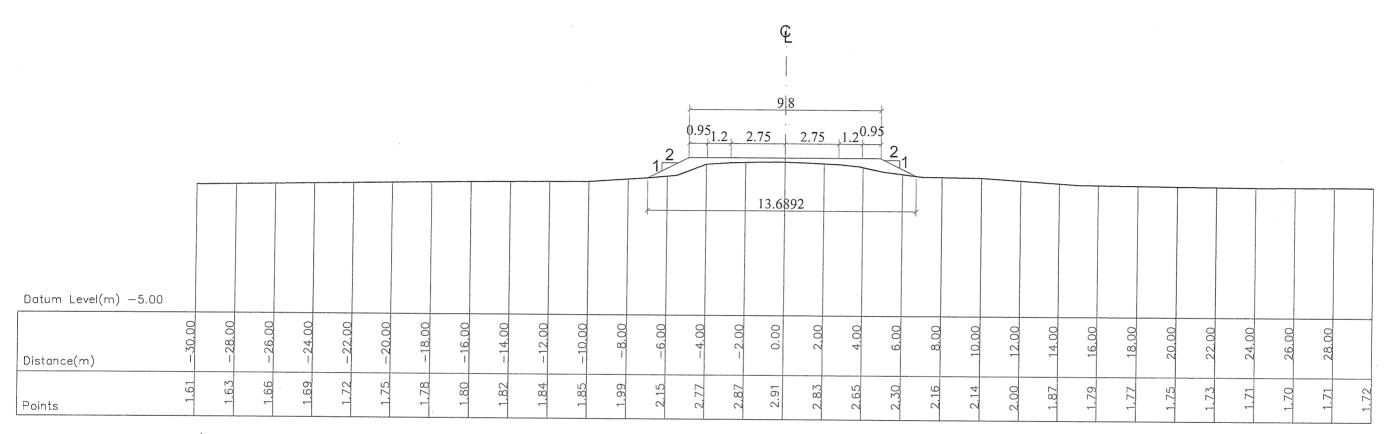
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Roads and Highways Department (RHD) Ministry of Communications	Preparatory Survey on chittagong Area Coal Fared Power Plant Development Project in Bangladesh (JICA Study).	JAPAN INTERNATIONAL COOPERATION AGENCY(JICA)	ROAD CROSS SECTION EIDMONI TO PEKUA	1:200	AUGUST, 2013	CS/DWG-04 of 54

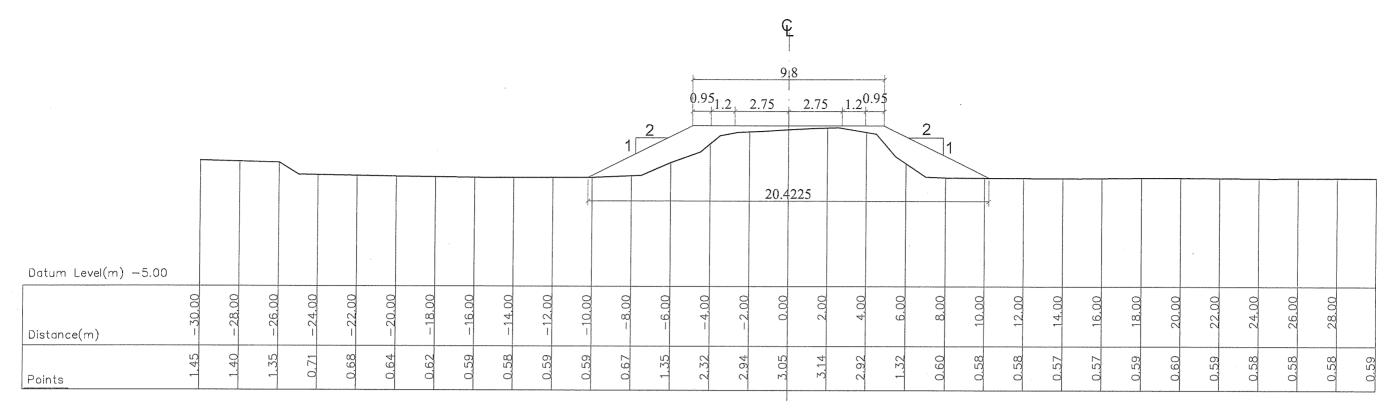




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Roads and Highways Department (RHD) Ministry of Communications	Preparatory Survey on chittagong Area Coal Fared Power Plant Development Project in Bangladesh (JICA Study).	JAPAN INTERNATIONAL COOPERATION AGENCY(JICA)	ROAD CROSS SECTION EIDMONI TO PEKUA	1:200	AUGUST, 2013	CS/DWG-05 of 54

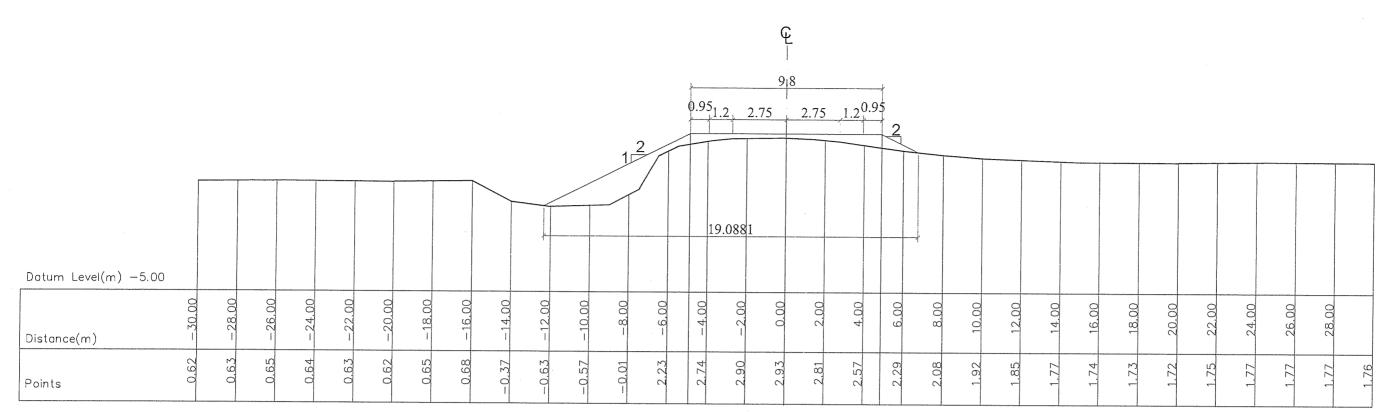

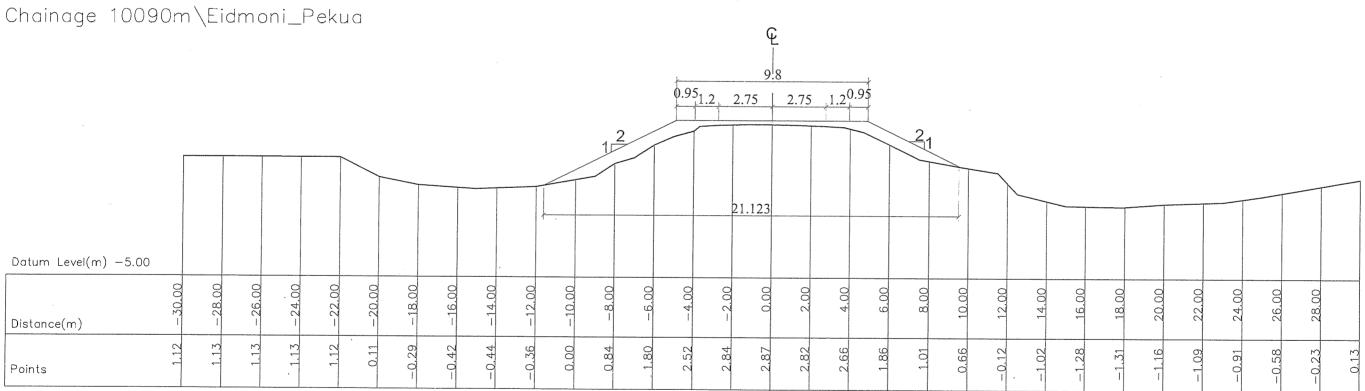
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Roads and Highways Department (RHD) Ministry of Communications	Preparatory Survey on chittagong Area Coal Fared Power Plant Development Project in Bangladesh (JICA Study).	JAPAN INTERNATIONAL COOPERATION AGENCY(JICA)	ROAD CROSS SECTION EIDMONI TO PEKUA	1:200	AUGUST, 2013	CS/DWG-06 of 54





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Chainage 05\Badarkhai-Eidmoni
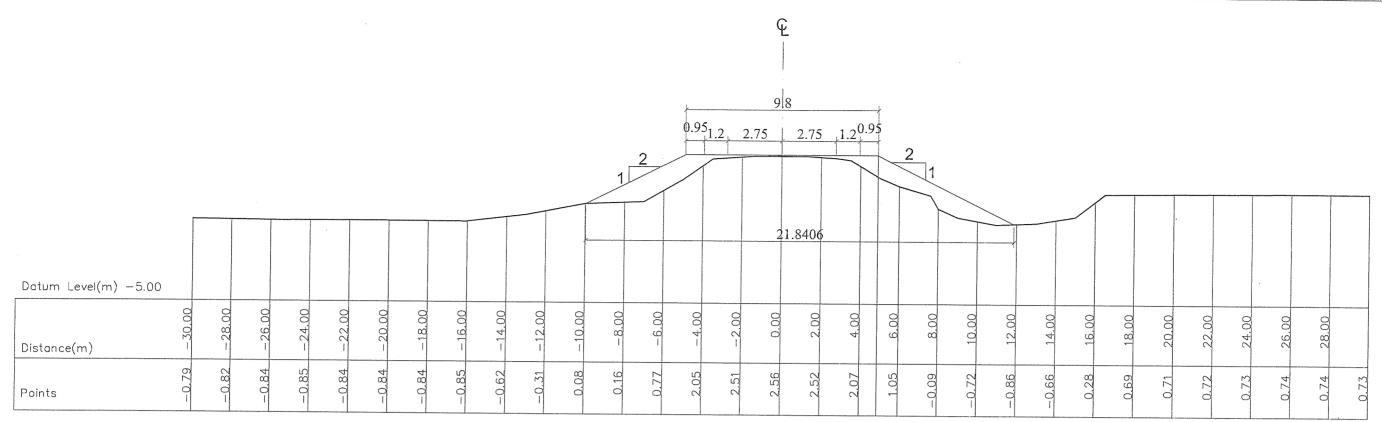
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Roads and Highways Department (RHD) Ministry of Communications	Preparatory Survey on chittagong Area Coal Fared Power Plant Development Project in Bangladesh (JICA Study).	JAPAN INTERNATIONAL COOPERATION AGENCY(JICA)	ROAD CROSS SECTION BADARKHALI TO EIDMONI	1:200	AUGUST, 2013	CS/DWG-07 of 54

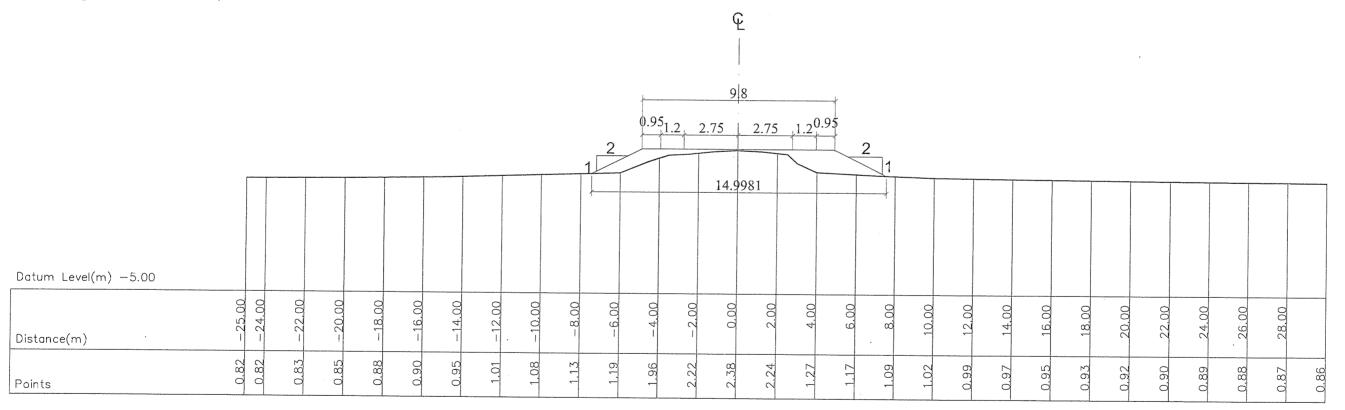

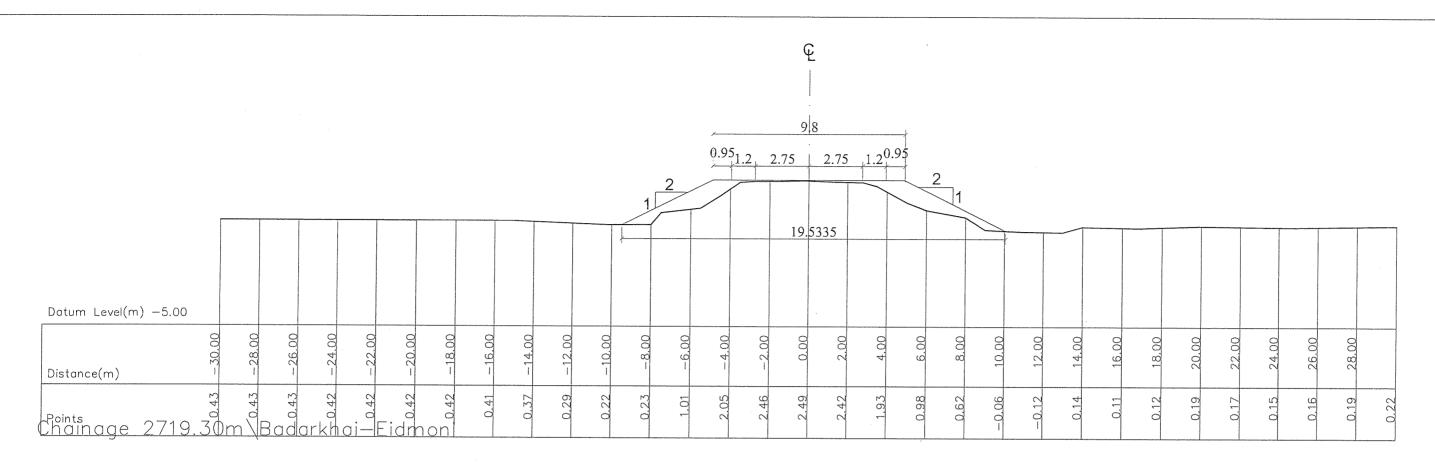

Chainage 1726m\Badarkhai—Eidmoni

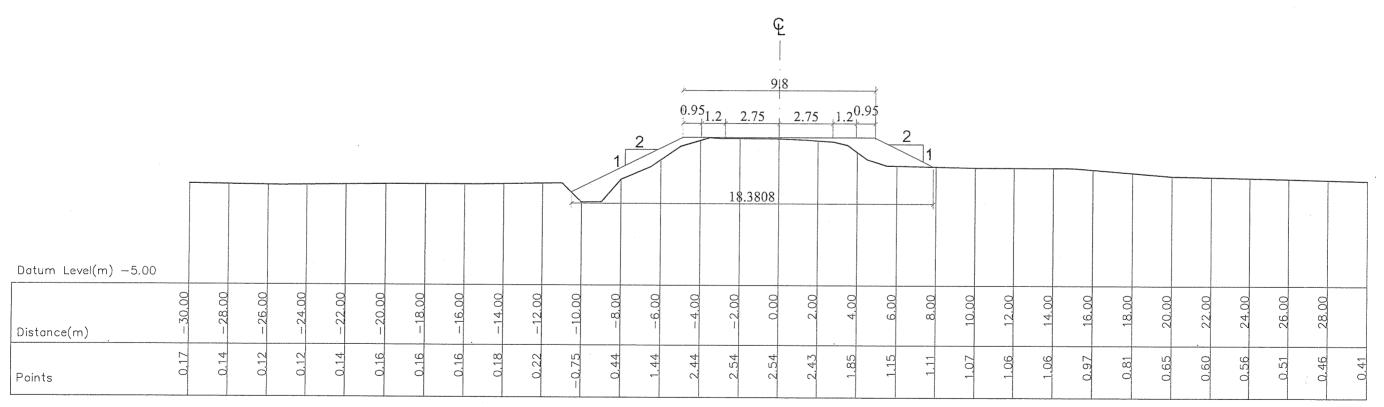NAME OF THE PROJECT:

REV.	DESCRIPTION		DATE	
 SCALE:	DATE :	DRAW	NG NO.	

Roads and Highways Department (RHD)
Ministry of Communications


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Power Plant Development Project in Bangladesh
(JICA Study).


JAPAN INTERNATIONAL
COOPERATION AGENCY(JICA)

ROAD CROSS SECTION
BADARKHALI TO EIDMONI

DRAWING TITLE:


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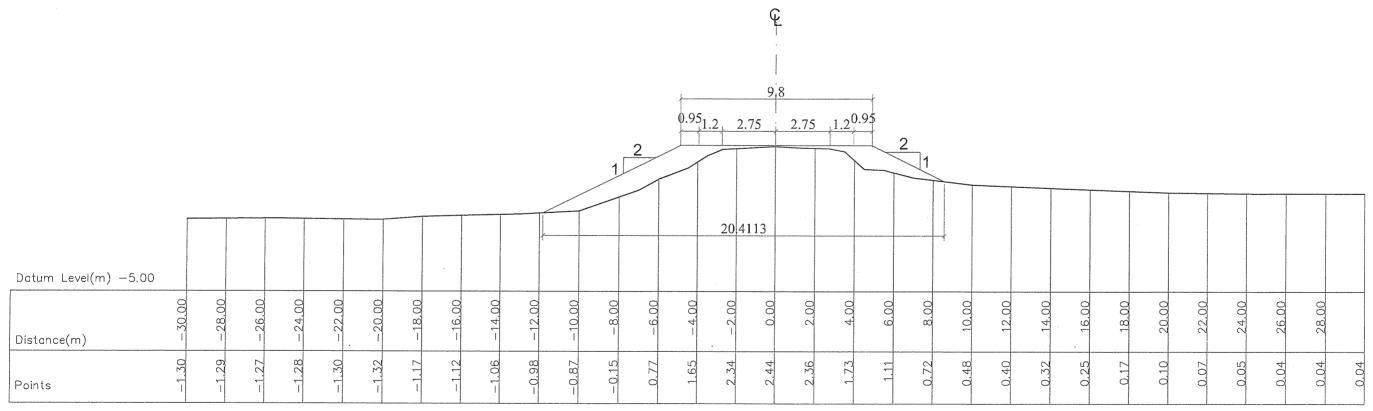

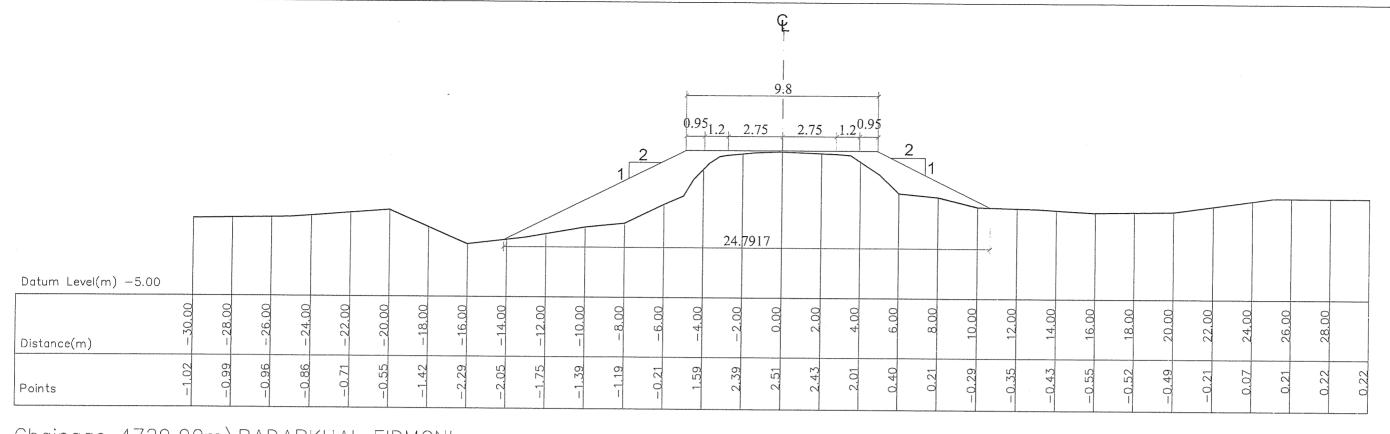
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				REV.	DESCRIPTION	DATE
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Roads and Highways Department (RHD) Ministry of Communications	Preparatory Survey on chittagong Area Coal Fared Power Plant Development Project in Bangladesh (JICA Study).	JAPAN INTERNATIONAL COOPERATION AGENCY(JICA)	ROAD CROSS SECTION BADARKHALI TO EIDMONI	1:200	AUGUST, 2013	CS/DWG-09 of 54

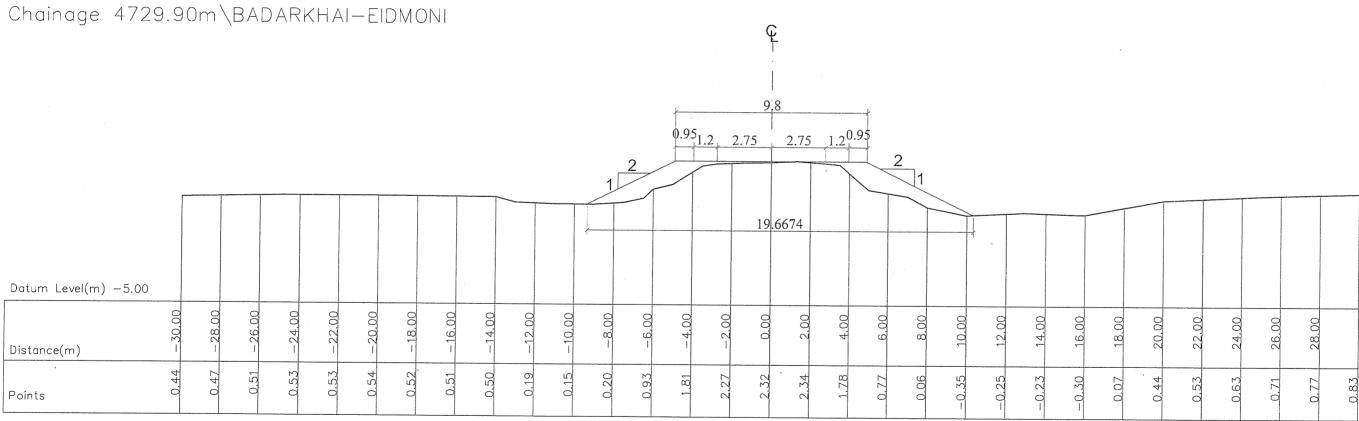


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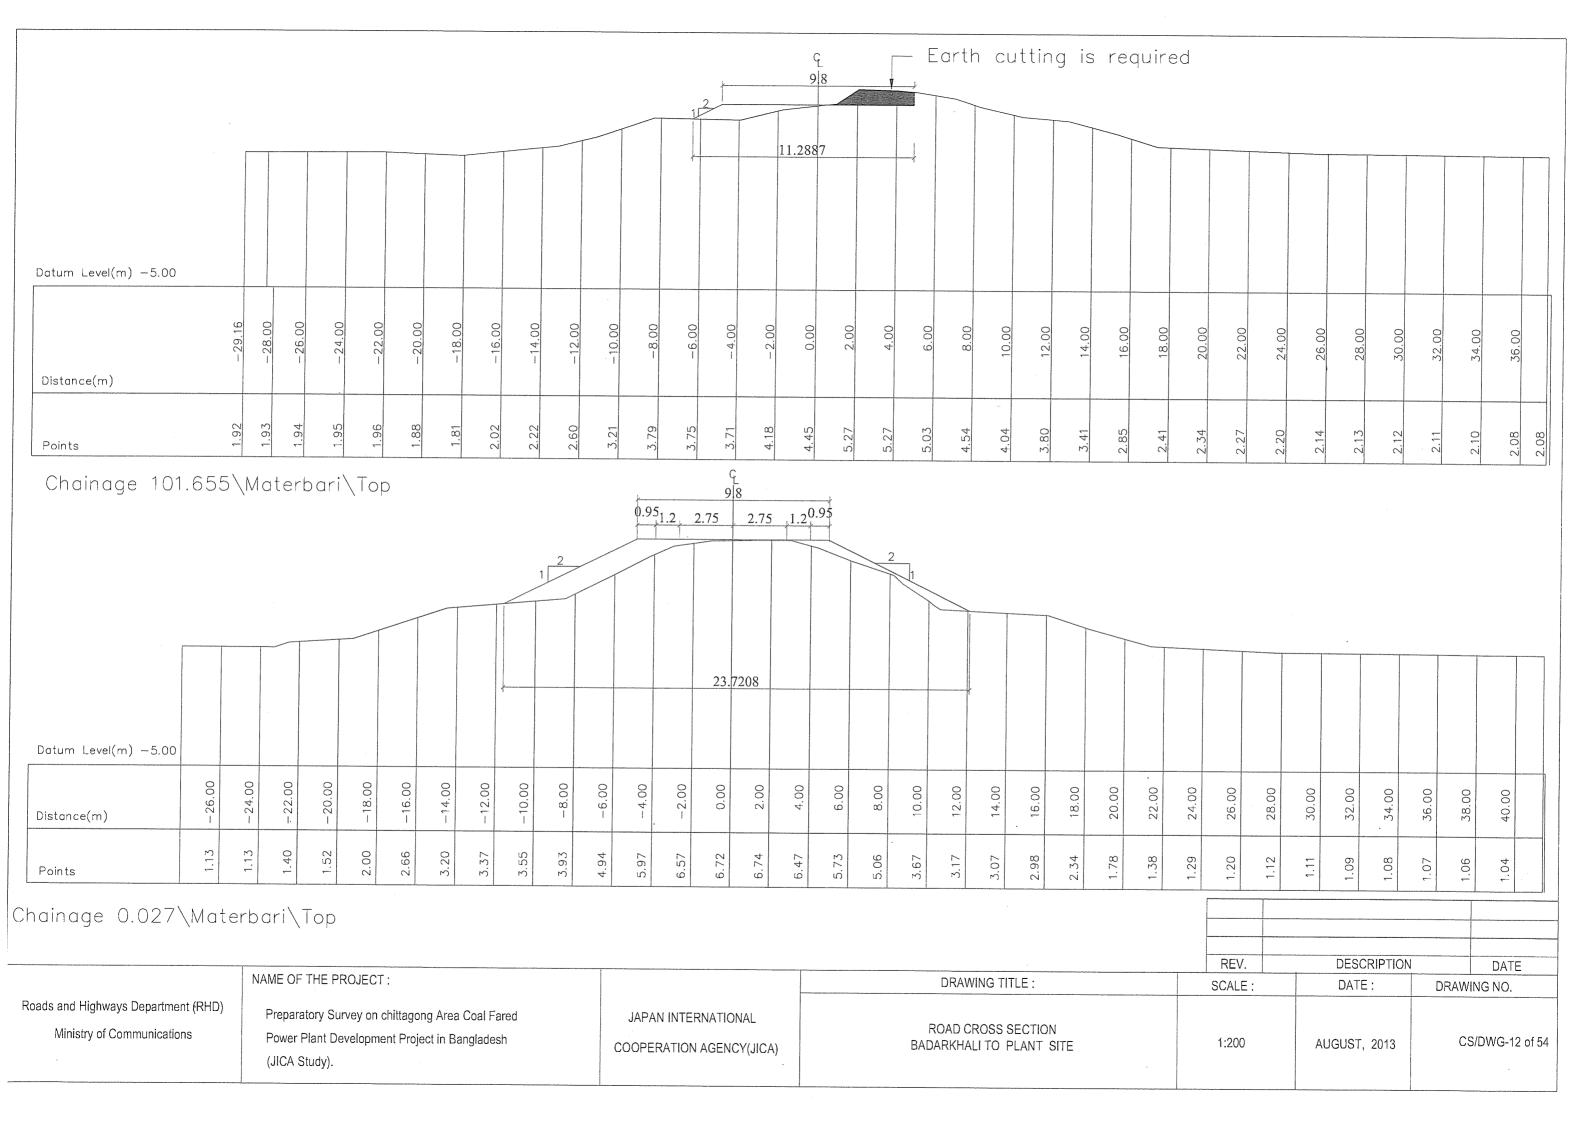
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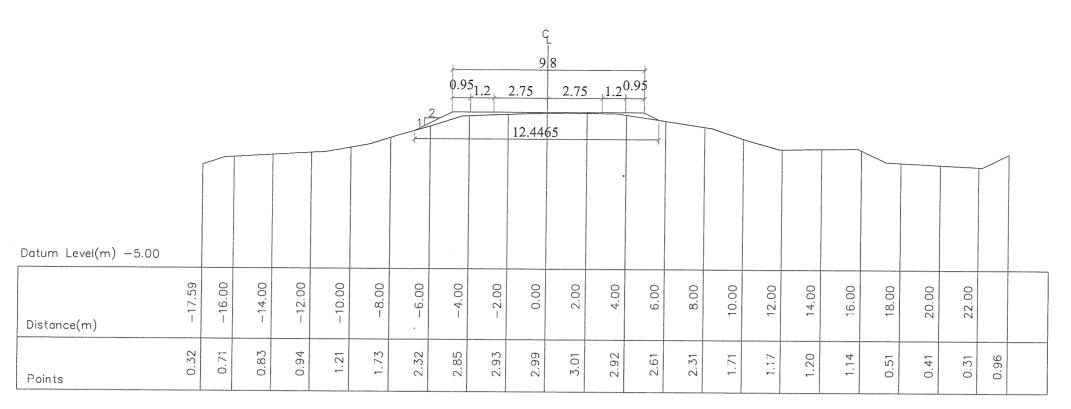
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Roads and Highways Department (RHD) Ministry of Communications	Preparatory Survey on chittagong Area Coal Fared Power Plant Development Project in Bangladesh (JICA Study).	JAPAN INTERNATIONAL COOPERATION AGENCY(JICA)	ROAD CROSS SECTION BADARKHALI TO EIDMONI	1:200	AUGUST, 2013	CS/DWG-10 of 54

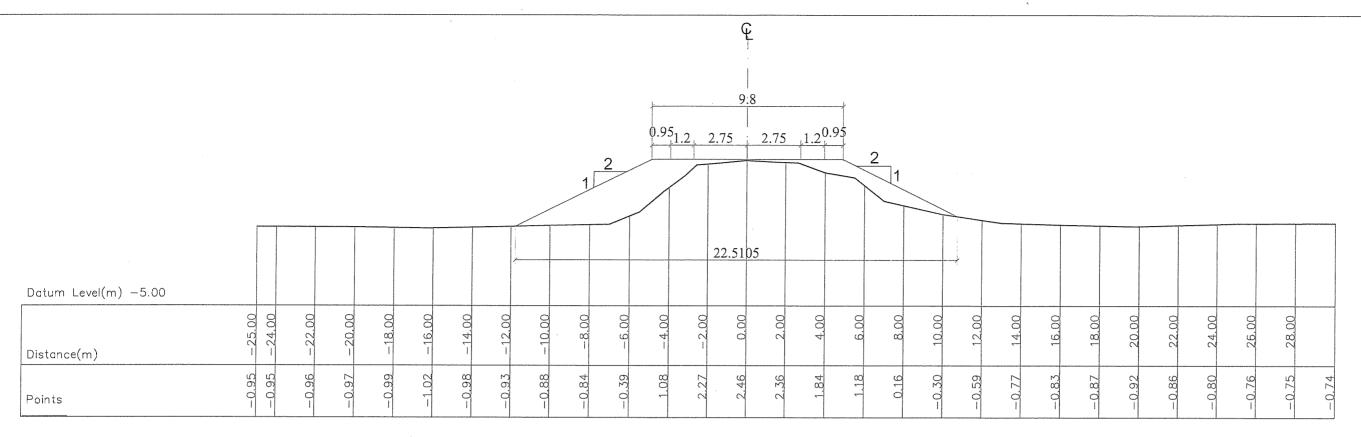


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Roads and Highways Department (RHD) Ministry of Communications	Preparatory Survey on chittagong Area Coal Fared Power Plant Development Project in Bangladesh (JICA Study).	JAPAN INTERNATIONAL COOPERATION AGENCY(JICA)	ROAD CROSS SECTION BADARKHALI TO EIDMONI	1:200	AUGUST, 2013	CS/DWG-11 of 54




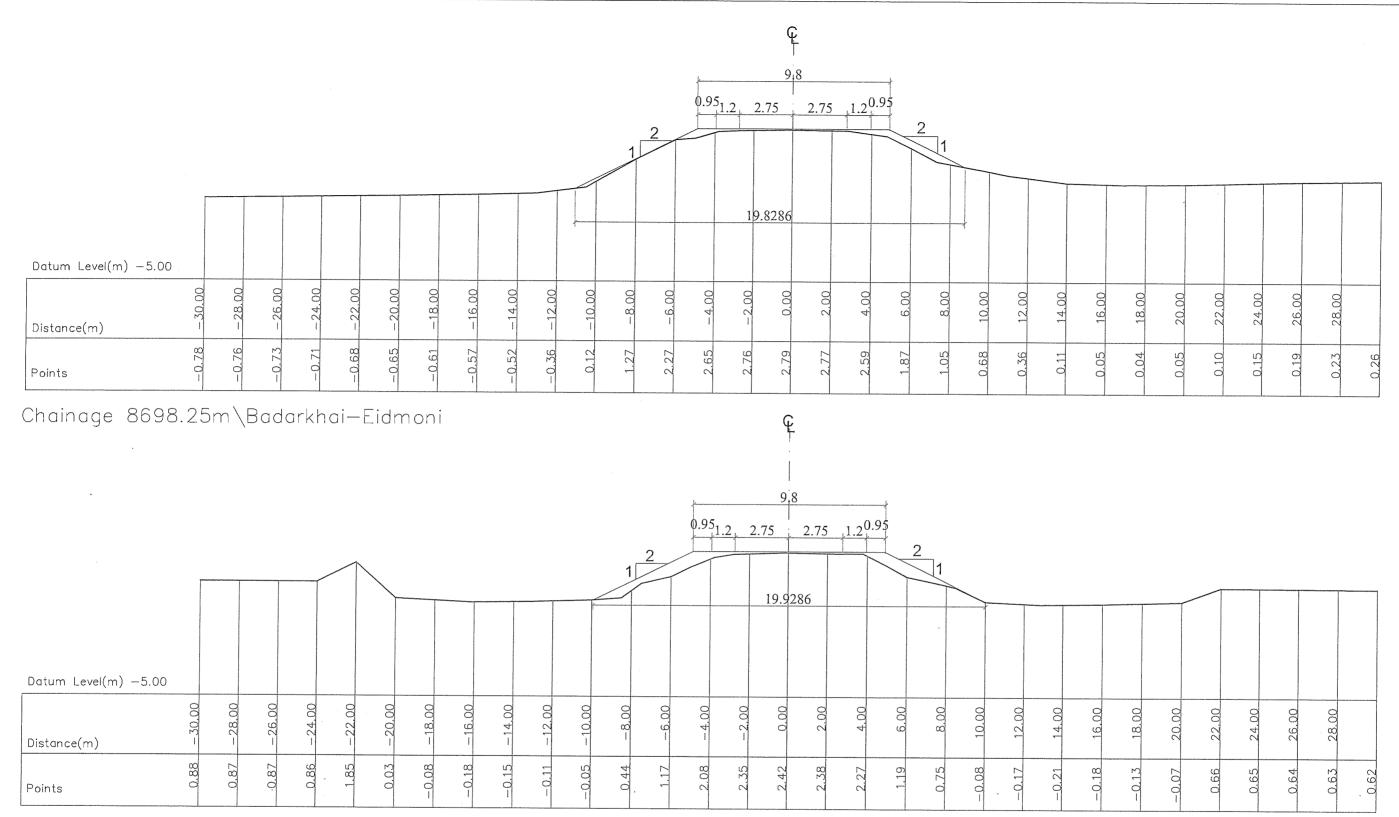

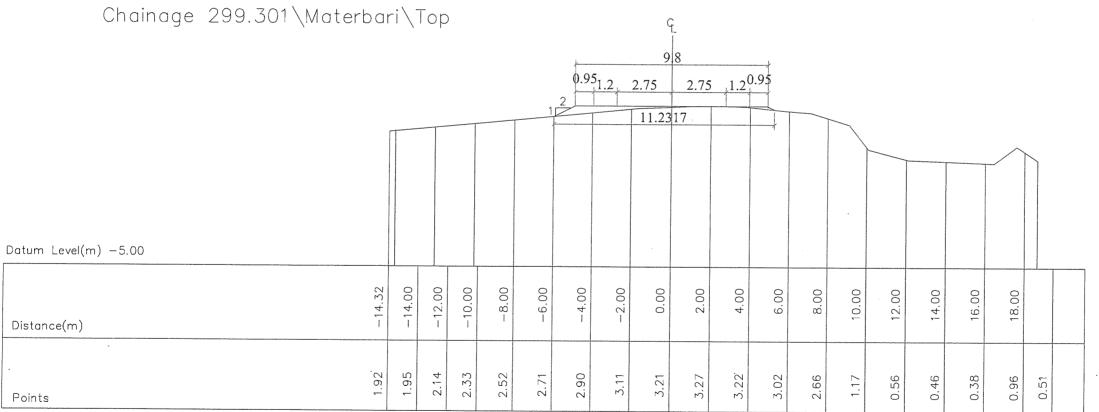


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				REV.	DESCRIPTION	DATE
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Roads and Highways Department (RHD) Ministry of Communications	Preparatory Survey on chittagong Area Coal Fared Power Plant Development Project in Bangladesh (JICA Study).	JAPAN INTERNATIONAL COOPERATION AGENCY(JICA)	ROAD CROSS SECTION BADARKHALI TO PLANT SITE	1:200	AUGUST, 2013	CS/DWG-13 of 54

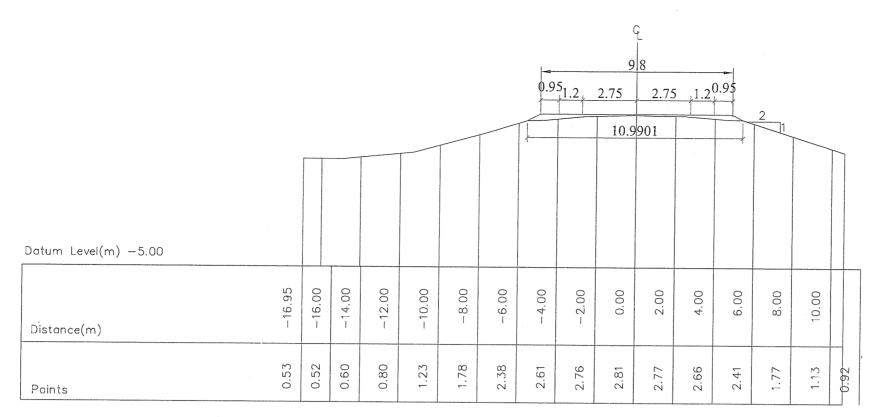


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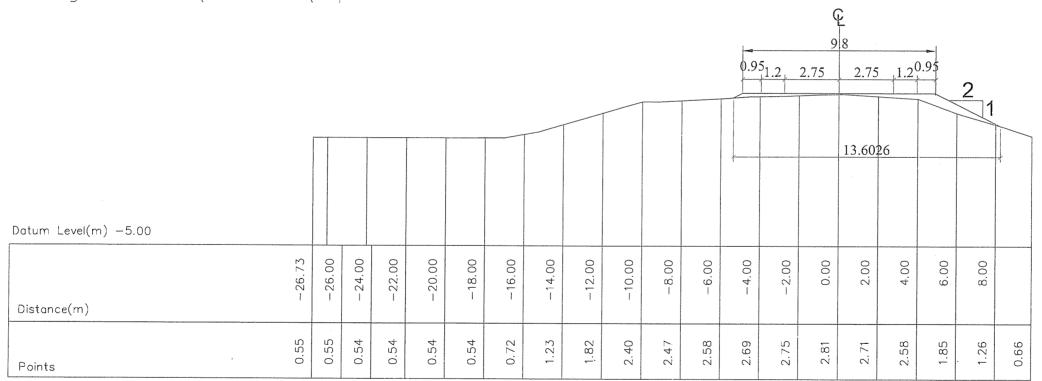


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				REV.	DESCRIPTION		DATE
	NAME OF THE PROJECT :		DRAWING TITLE :	SCALE:	DATE:	DRAWING	G NO.
Roads and Highways Department (RHD) Ministry of Communications	Preparatory Survey on chittagong Area Coal Fared Power Plant Development Project in Bangladesh (JICA Study).	JAPAN INTERNATIONAL COOPERATION AGENCY(JICA)	ROAD CROSS SECTION BADARKHALI TO PLANT SITE	1:200	AUGUST, 2013	CS/E	DWG-14 of 54

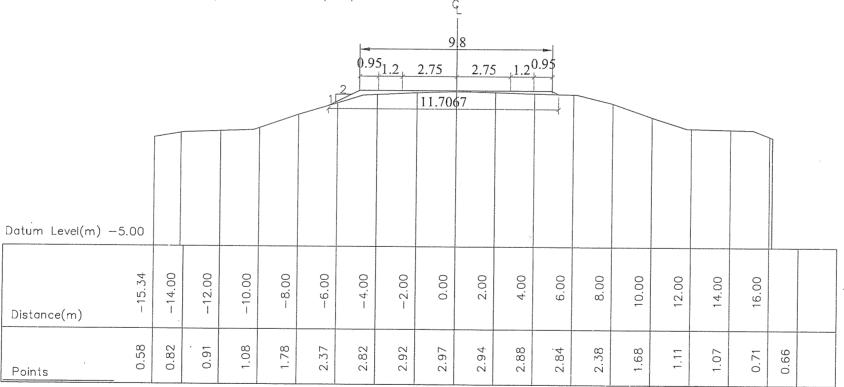


Chainage 697.866\Materbari\Top

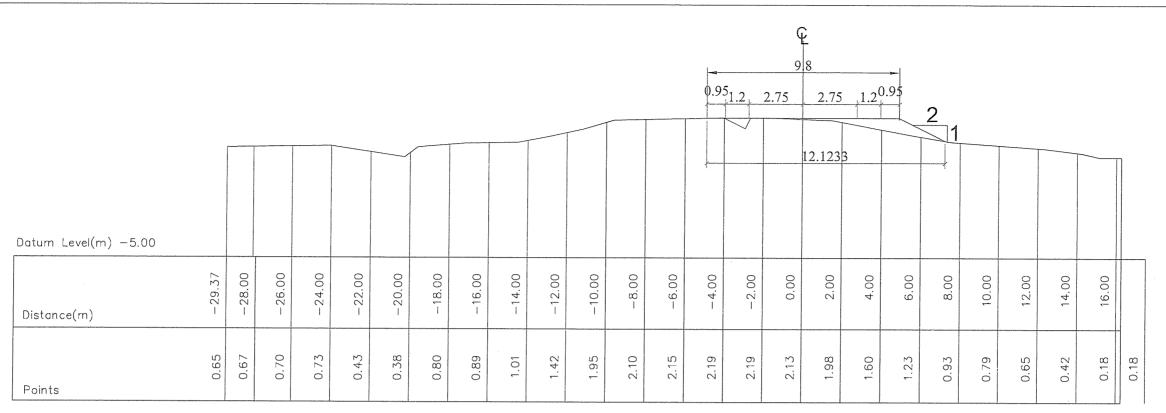

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				REV.	DESCRIPTION	DATE
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Roads and Highways Department (RHD) Ministry of Communications	Preparatory Survey on chittagong Area Coal Fared Power Plant Development Project in Bangladesh (JICA Study).	JAPAN INTERNATIONAL COOPERATION AGENCY(JICA)	ROAD CROSS SECTION BADARKHALI TO PLANT SITE	1:200	AUGUST, 2013	CS/DWG-15 of 54

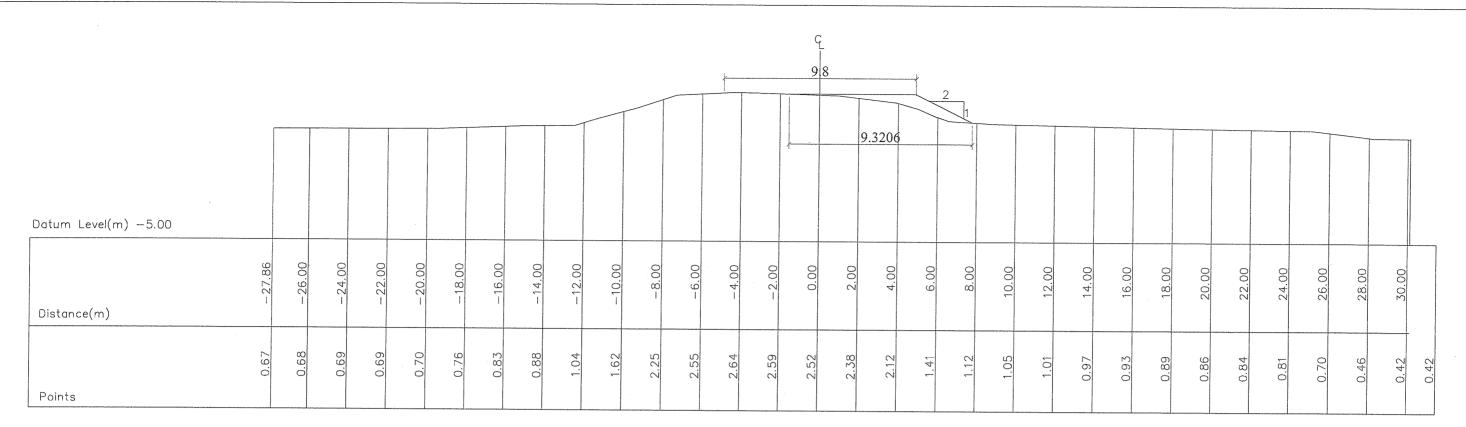


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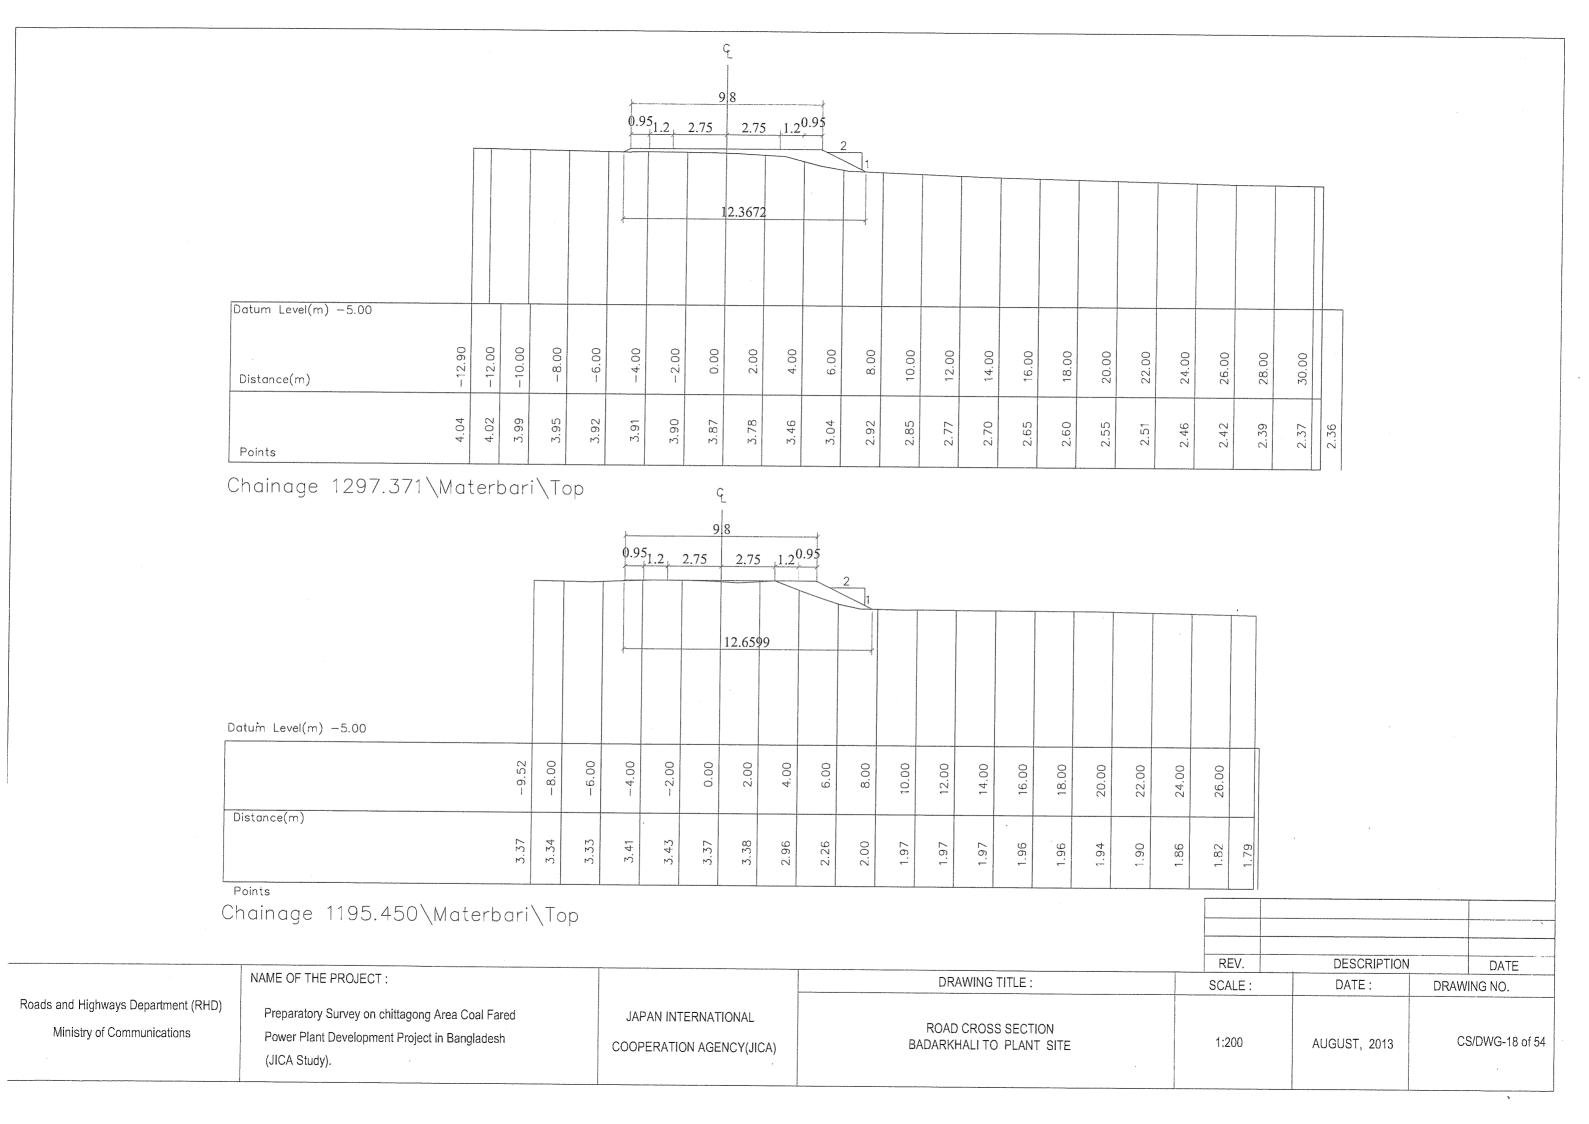
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	-24.76	-24.00	-22.00	-20.00	-18.00	-16.00	-14.00	12.00	10.00	-8.00	-6.00	-4.00	-2.00	0.00	2.00	4.00	6.00	8.00	10.00	12.00	14.00	16.00	18.00	20.00	22.00	24.00	
Distance(m)	9	ن	5		g.	7.	Š	2	0		9	ω	7	2	2	4		6		4		6	10				
Points	2.46	2.45	2.43	2.41	2.39	2.37	2.35	2.32	2.30	2.28	2.26	2.28	2.27	2.22	2.02	1.24		0.99	0.97	0.94	0.91	0.89	0.85	0.80	0.38	0.35	0.35


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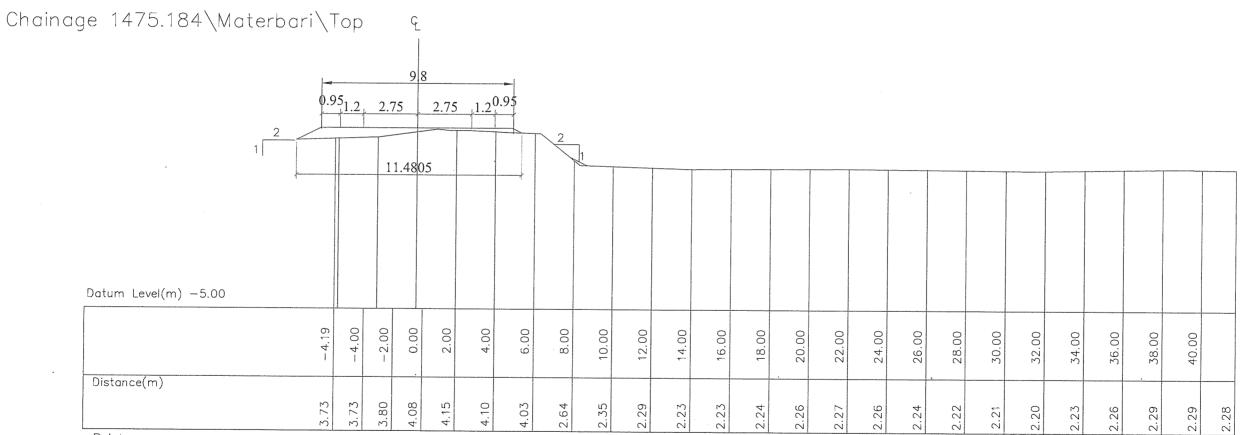
				REV.	DESCRIPTION	DATE
	NAME OF THE PROJECT:		DRAWING TITLE :	SCALE:	DATE:	DRAWING NO.
Roads and Highways Department (RHD) Ministry of Communications	Preparatory Survey on chittagong Area Coal Fared Power Plant Development Project in Bangladesh (JICA Study).	JAPAN INTERNATIONAL COOPERATION AGENCY(JICA)	ROAD CROSS SECTION BADARKHALI TO PLANT SITE	1:200	AUGUST, 2013	CS/DWG-16 of 54



NAME OF THE P				REV.	DESCRIPTION	DATE
	PROJECT:		DRAWING TITLE :	SCALE:	DATE:	DRAWING NO.
	Survey on chittagong Area Coal Fared Development Project in Bangladesh	JAPAN INTERNATIONAL COOPERATION AGENCY(JICA)	ROAD CROSS SECTION BADARKHALI TO PLANT SITE	1:200	AUGUST, 2013	CS/DWG-17 of 54

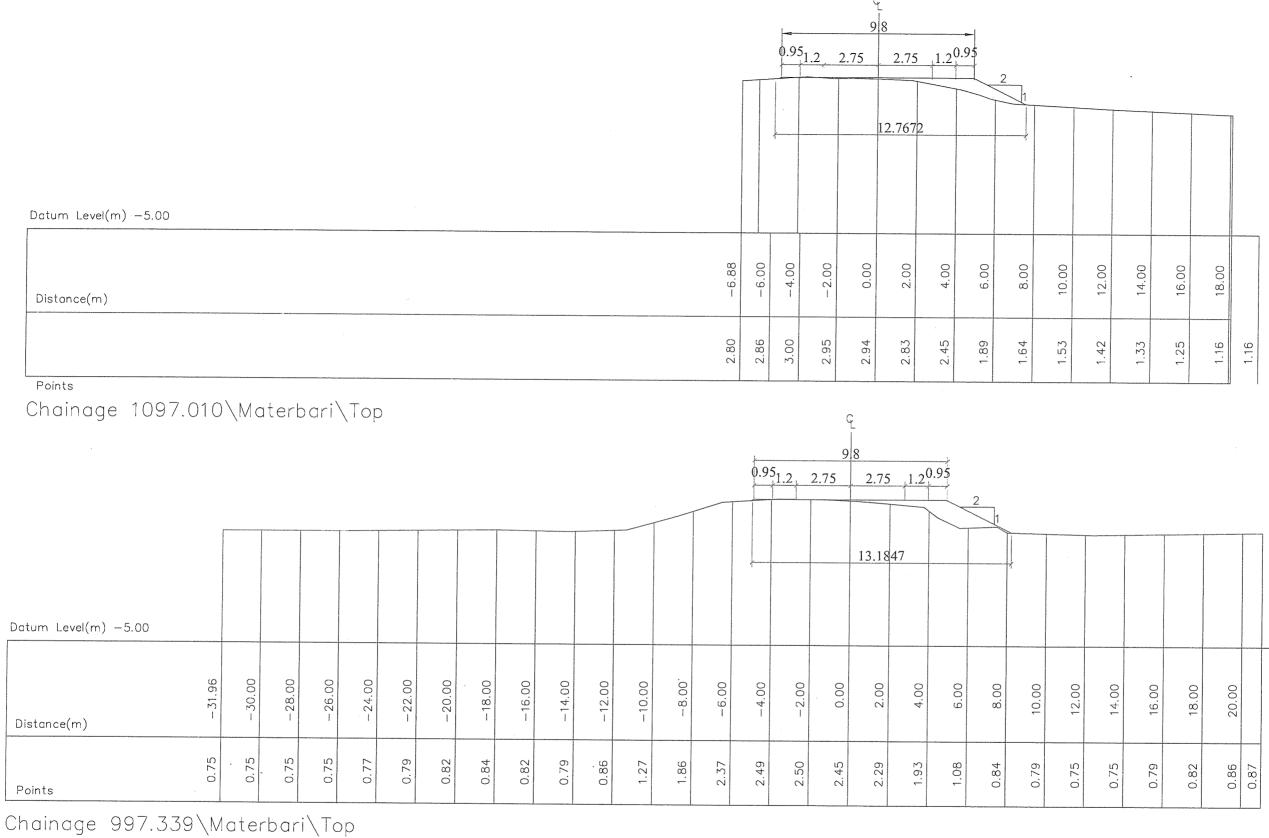



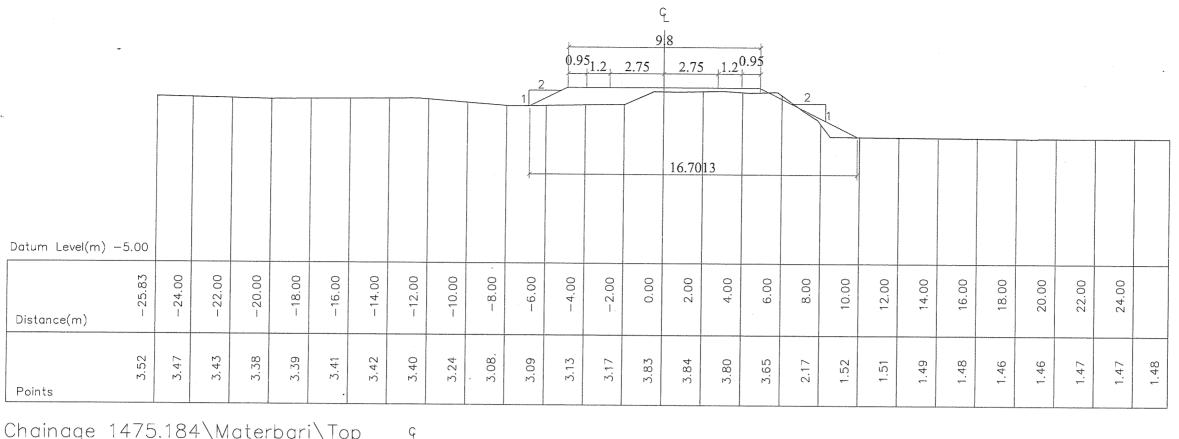

NAME OF THE PROJECT:

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REV.	DESCRIPTION	DATE
SCALE:	DATE:	DRAWING NO.

Roads and Highways Department (RHD) Ministry of Communications


Preparatory Survey on chittagong Area Coal Fared Power Plant Development Project in Bangladesh (JICA Study).

JAPAN INTERNATIONAL COOPERATION AGENCY(JICA)

ROAD CROSS SECTION BADARKHALI TO PLANT SITE

DRAWING TITLE:

CS/DWG-19 of 54 1:200 AUGUST, 2013

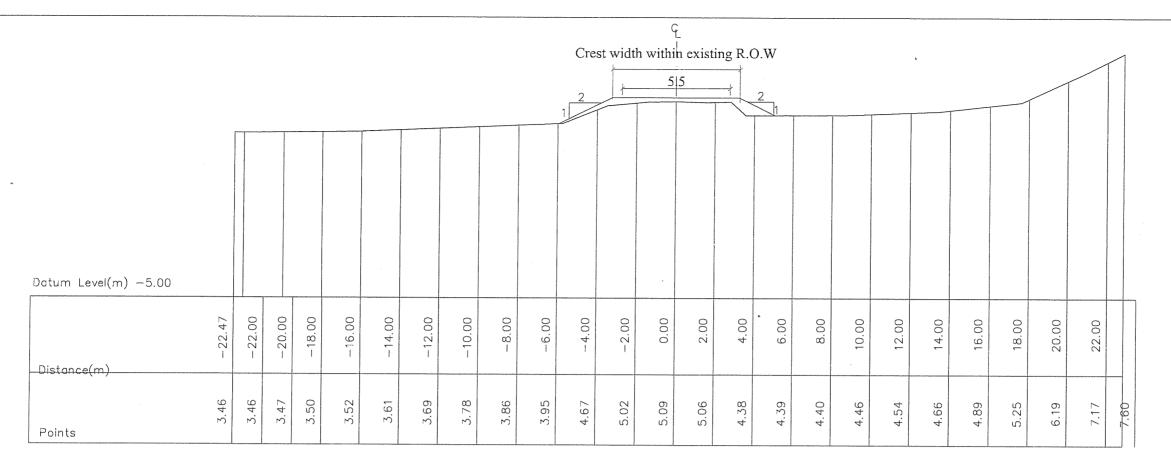

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Crest Width Exist within RoW 5|5 -36.00 -38.00 -34.00 -32.00 38.26 -30.00 -28.00 -26.00 -18.00 -16.00 -14.00 -12.00 -6.00 -2.00 8.00 3.16 3.13 3.20 3.10 3.03 3.00 3.06 2.96 2.95 2.95 2.95 3.24 4.03 4.07 4.04


Chainage 1575.614\Materbari\Top

Datum Level(m) -5.00

Distance(m)

Points

				REV.	DESCRIPTION	V	DATE
	NAME OF THE PROJECT:		DRAWING TITLE :	SCALE:	DATE:	DRAWII	NG NO.
Roads and Highways Department (RHD) Ministry of Communications	Preparatory Survey on chittagong Area Coal Fared Power Plant Development Project in Bangladesh (JICA Study).	JAPAN INTERNATIONAL COOPERATION AGENCY(JICA)	ROAD CROSS SECTION BADARKHALI TO PLANT SITE	1:200	AUGUST, 2013	CS	7/DWG-20 of 54

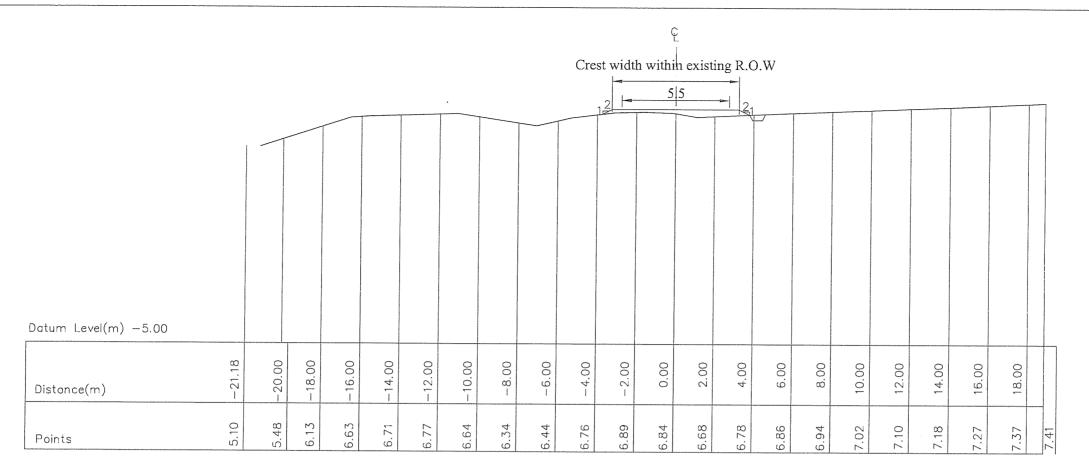

Chainage 1704.221\Materbari\Top Crest width within existing R.O.W Dotum Level(m) -5.00-19.98 -10.00 -18.00 -16.00 -14.00 12.00 -8.00 -6.00 -4.00 -2.00 0.00 2.00 4.00 6.00 8.00 10.00 12.00 14.00 Distance(m) 5.10 4.24 30 4.35 4.63 5.51 5.56 5.56 6.02 6.58 Points

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REV. DESCRIPTION DATE

SCALE: DATE: DRAWING NO.

Roads and Highways Department (RHD)

Ministry of Communications

Preparatory Survey on chittagong Area Coal Fared Power Plant Development Project in Bangladesh (JICA Study).


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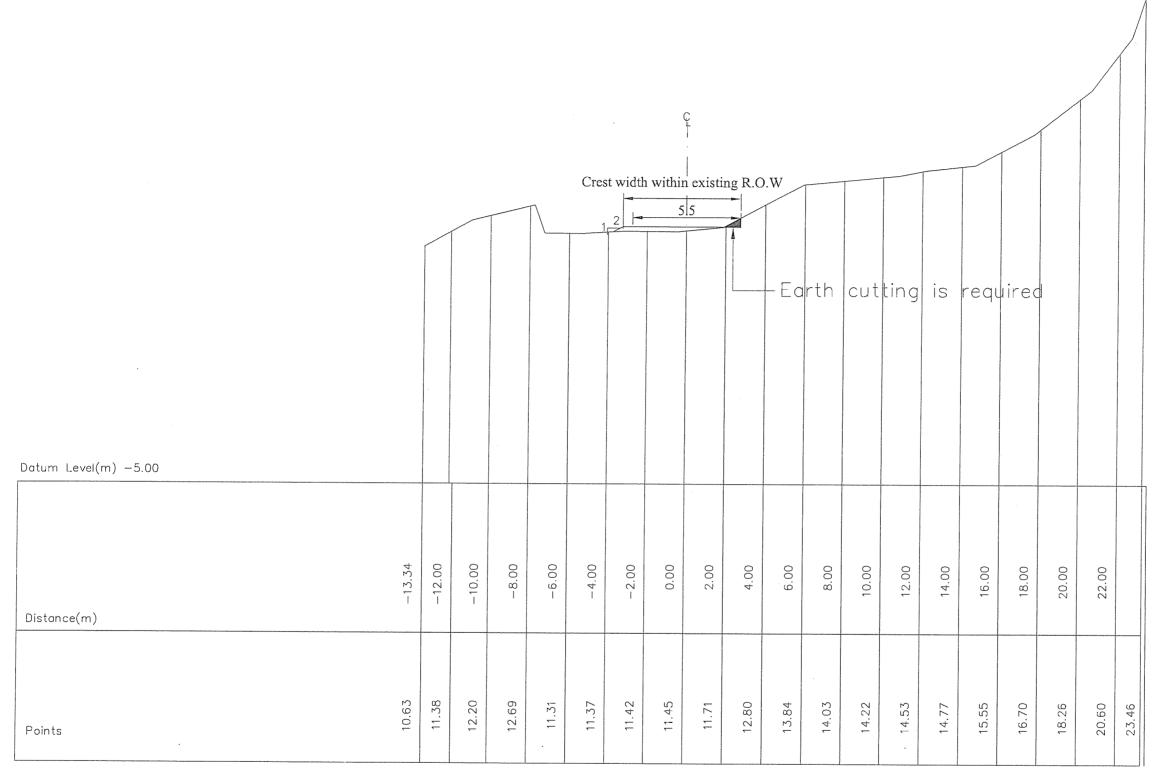
JAPAN INTERNATIONAL
COOPERATION AGENCY(JICA)

ROAD CROSS SECTION BADARKHALI TO PLANT SITE

DRAWING TITLE:


1:200 AUGUST, 2013 CS/DWG-21 of 54



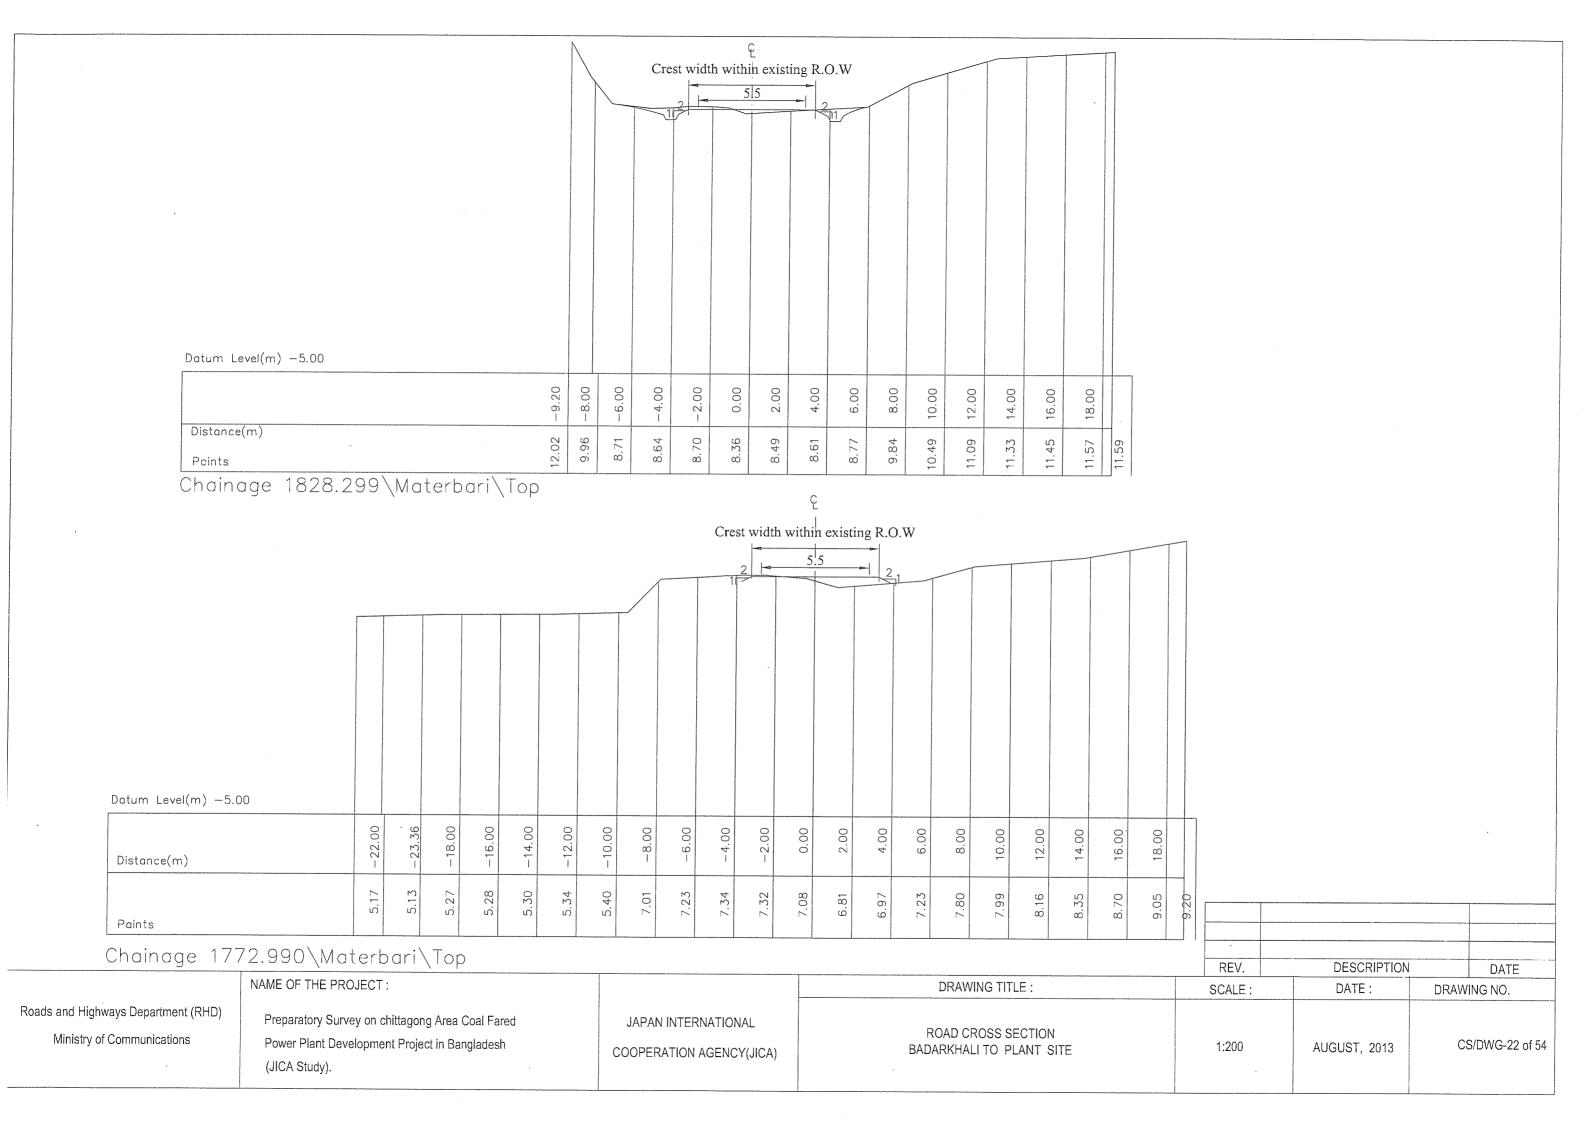

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	T			REV.	DESCRIPTION	DATE
	NAME OF THE PROJECT :		DRAWING TITLE :	SCALE:	DATE:	DRAWING NO.
Roads and Highways Department (RHD) Ministry of Communications	Preparatory Survey on chittagong Area Coal Fared Power Plant Development Project in Bangladesh (JICA Study).	JAPAN INTERNATIONAL COOPERATION AGENCY(JICA)	ROAD CROSS SECTION BADARKHALI TO PLANT SITE	1:200	AUGUST, 2013	CS/DWG-23 of 54

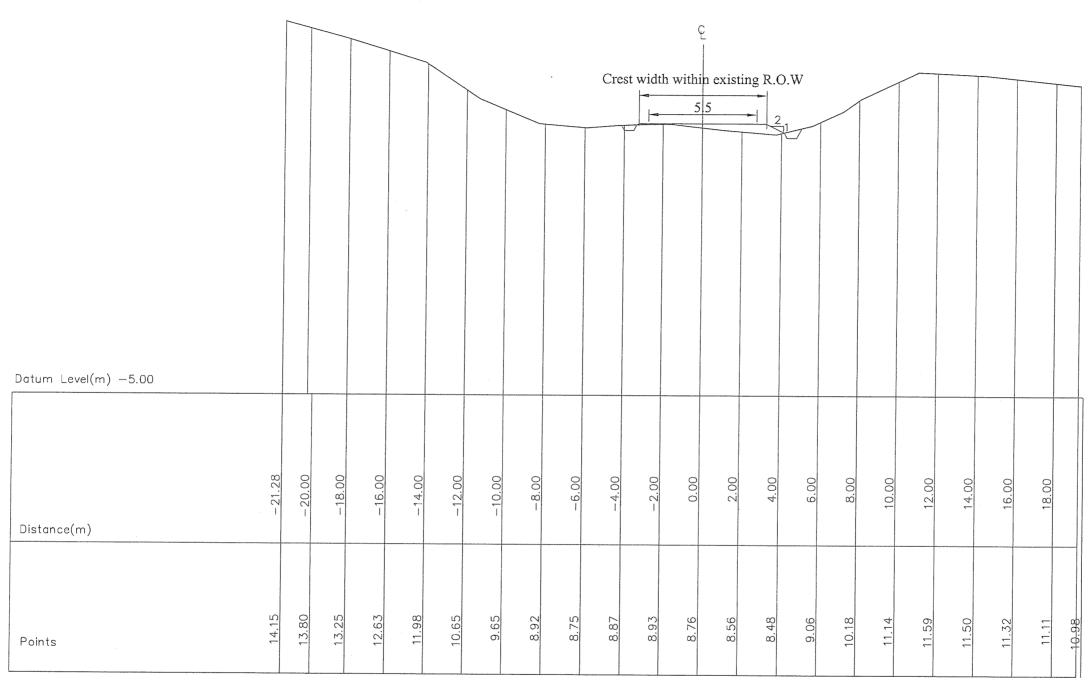

Chainage 1976.360\Materbari\Top

REV.	DESCRIPTION	DATE
SCALE:	DATE:	DRAWING NO.
1:200	AUGUST, 2013	CS/DWG-24 of 54

Roads and Highways Department (RHD) Ministry of Communications


Preparatory Survey on chittagong Area Coal Fared Power Plant Development Project in Bangladesh (JICA Study).

NAME OF THE PROJECT:

JAPAN INTERNATIONAL COOPERATION AGENCY(JICA)

ROAD CROSS SECTION BADARKHALI TO PLANT SITE

DRAWING TITLE:

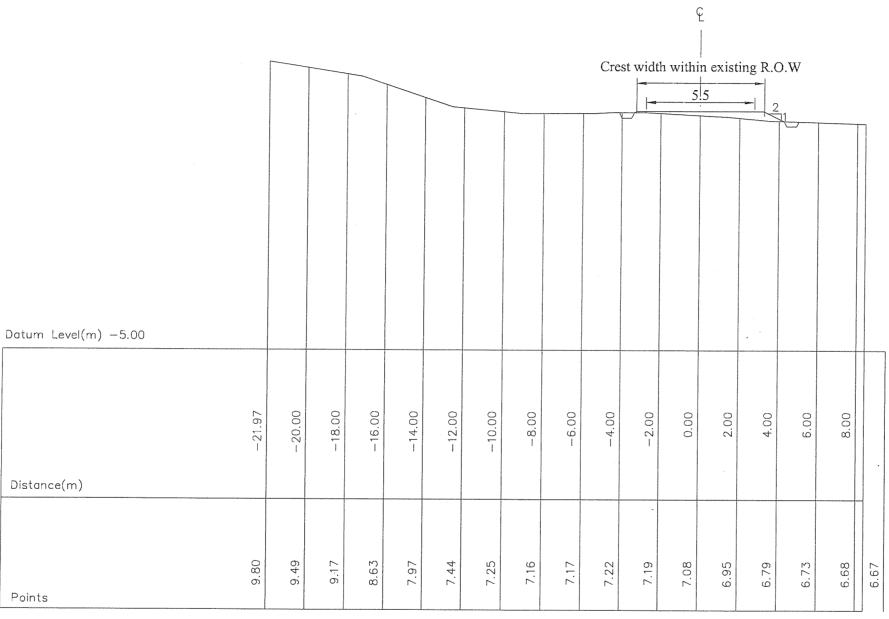

Chainage 2009.976\Materbari\Top

				REV.	DESCRIPTION	DATE
	NAME OF THE PROJECT :		DRAWING TITLE :	SCALE:	DATE:	DRAWING NO.
Roads and Highways Department (RHD) Ministry of Communications	Preparatory Survey on chittagong Area Coal Fared Power Plant Development Project in Bangladesh (JICA Study).	JAPAN INTERNATIONAL COOPERATION AGENCY(JICA)	ROAD CROSS SECTION BADARKHALI TO PLANT SITE	1:200	AUGUST, 2013	CS/DWG-25 of 54

Crest width within existing R.O.W Datum Level(m) -5.00 -18.00 -10.00 4.00 12.00 Distance(m) 6.26 6.24 6.26 6.19 6.15 6.15 6.17 6.21 6.26 5.98 5.94 6.00 6.07 6.34 Points

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	NAME OF THE PROJECT :		DRAWING TITLE :	REV. SCALE:	DESCRIPTION DATE:	DATE DRAWING NO.
Roads and Highways Department (RHD) Ministry of Communications	Preparatory Survey on chittagong Area Coal Fared Power Plant Development Project in Bangladesh (JICA Study).	JAPAN INTERNATIONAL COOPERATION AGENCY(JICA)	ROAD CROSS SECTION BADARKHALI TO PLANT SITE	1:200	AUGUST, 2013	. CS/DWG-26 of 54

Crest width within existing R.O.W Datum Level(m) -5.00 -12.00 -10.00 -8.00 0.00 -4.00 -2.00 2.00 4.00 6.00 8.00 Distance(m) 5.99 6.10 6.22 5.62 5.67 5.75 5.52 5.33 5.71 5.62 Points

Chainage 2282.321\Materbari\Top

REV. DESCRIPTION DATE

SCALE: DATE: DRAWING NO.

Roads and Highways Department (RHD)

Ministry of Communications

Preparatory Survey on chittagong Area Coal Fared Power Plant Development Project in Bangladesh (JICA Study).

NAME OF THE PROJECT:

JAPAN INTERNATIONAL
COOPERATION AGENCY(JICA)

ROAD CROSS SECTION BADARKHALI TO PLANT SITE

DRAWING TITLE:

1:200 AUGUST, 2013

CS/DWG-27 of 54

Crest width within existing R.O.W Datum Level(m) -5.00 -34.00 -32.00 -24.00 -22.00 -20.00 -14.00 -12.00 -10.00 -8.00 -6.00 2.00 4.00 6.00 18.00 20.00 Distance(m) 4.31 4.27 4.27 4.27 4.27 4.27 4.26 4.25 4.24 4.24 4.25 4.29 4.62 4.89 4.94 4.64 5.06 4.46 4.27 4.15 4.09 4.06 4.02 4.05 4.13 4.08 4.11 Points

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REV.	DESCRIPTION		DATE	
SCALE.	DATE ·	DBVWI	NG NO	Ī


Roads and Highways Department (RHD)
Ministry of Communications

Preparatory Survey on chittagong Area C	Coal Fared
Power Plant Development Project in Ban	gladesh
(JICA Study).	

NAME OF THE PROJECT :


JAPAN INTERNATIONAL
COOPERATION AGENCY(JICA)

DRAWING TITLE :	SCALE:	DATE:	DRAWING NO.
ROAD CROSS SECTION BADARKHALI TO PLANT SITE	1:200	AUGUST, 2013	CS/DWG-28 of 54

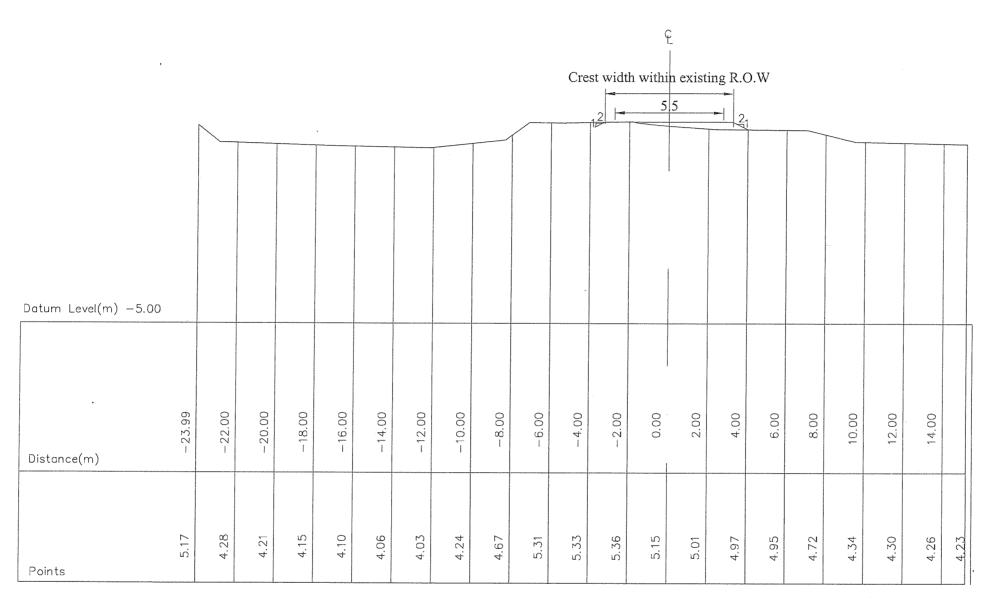


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	NAME OF THE PROJECT :		DRAWING TITLE :	REV.	DESCRIPTION DATE:	DATE DRAWING NO.
Roads and Highways Department (RHD) Ministry of Communications	Preparatory Survey on chittagong Area Coal Fared Power Plant Development Project in Bangladesh (JICA Study).	JAPAN INTERNATIONAL COOPERATION AGENCY(JICA)	ROAD CROSS SECTION BADARKHALI TO PLANT SITE	1:200	AUGUST, 2013	CS/DWG-29 of 54

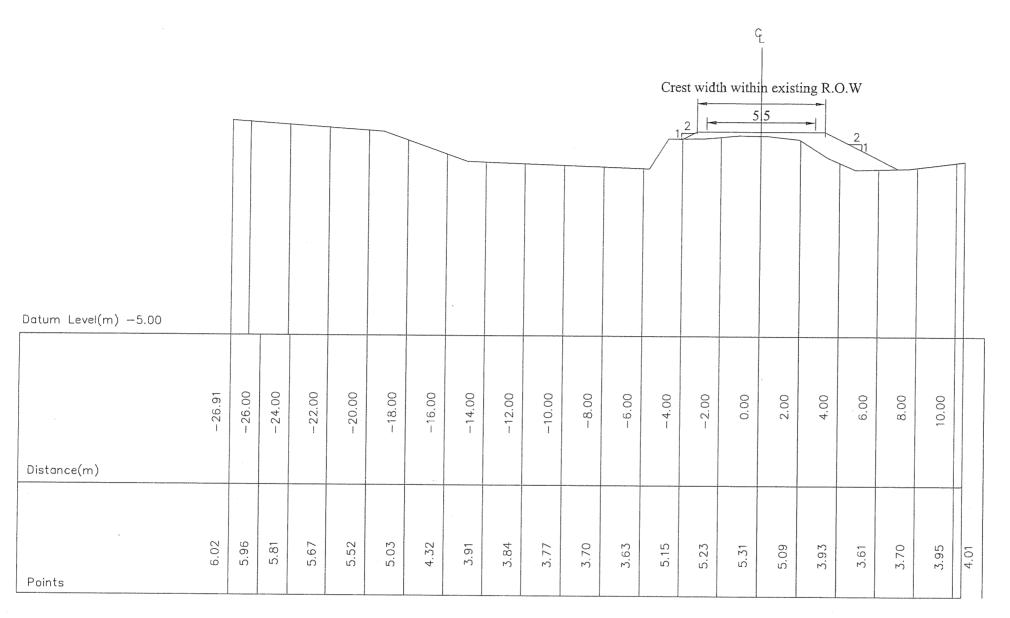

Chainage 2581.518\Materbari\Top

				REV.	DESCRIPTION	DATE
	NAME OF THE PROJECT :		DRAWING TITLE :	SCALE:	DATE:	DRAWING NO.
Roads and Highways Department (RHD) Ministry of Communications	Preparatory Survey on chittagong Area Coal Fared Power Plant Development Project in Bangladesh (JICA Study).	JAPAN INTERNATIONAL COOPERATION AGENCY(JICA)	ROAD CROSS SECTION BADARKHALI TO PLANT SITE	1:200	AUGUST, 2013	CS/DWG-30 of 54

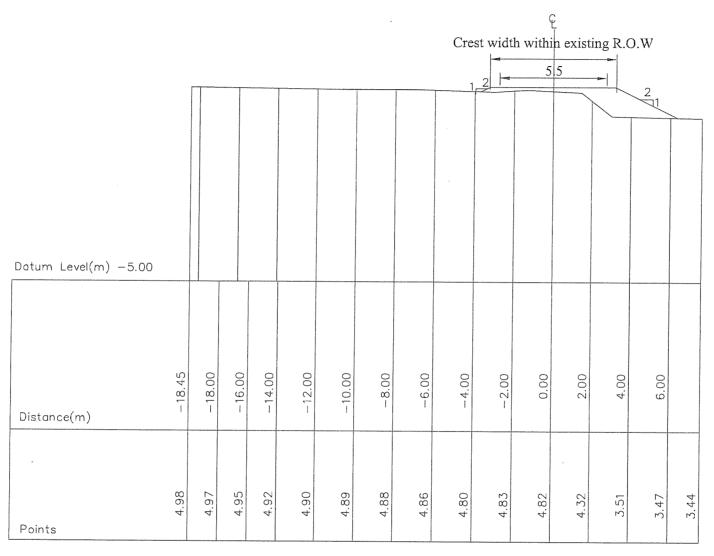

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REV.	DESCRIPTION	DATE
SCALE:	DATE:	DRAWING NO.
1:200	AUGUST, 2013	CS/DWG-31 of 54


Roads and Highways Department (RHD)
Ministry of Communications

NAME OF	THE PROJECT :
Prepara	tory Survey on chittagong Area Coal Fared
Power F	lant Development Project in Bangladesh
(JICA S	tudy).

JAPAN INTERNATIONAL
COOPERATION AGENCY(JICA)

DRAWING TITLE:

ROAD CROSS SECTION BADARKHALI TO PLANT SITE

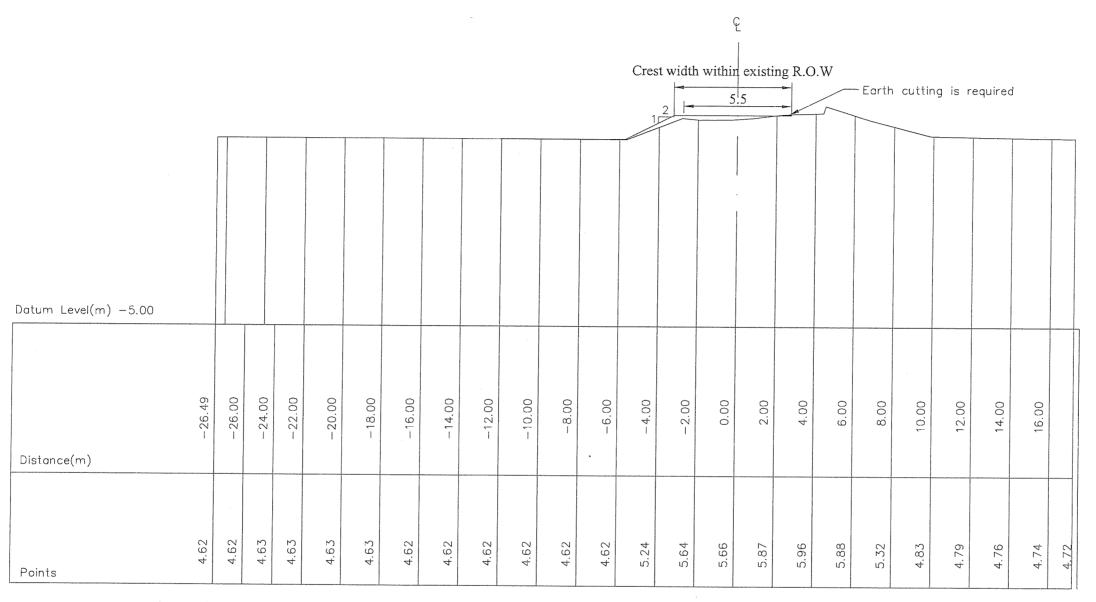

Chainage 2784.301\Materbari\Top

	NAME OF THE PROJECT :	-	DRAWING TITLE :	REV.	DESCRIPTION DATE:	DATE DRAWING NO.
Roads and Highways Department (RHD) Ministry of Communications	Preparatory Survey on chittagong Area Coal Fared Power Plant Development Project in Bangladesh (JICA Study).	JAPAN INTERNATIONAL COOPERATION AGENCY(JICA)	ROAD CROSS SECTION BADARKHALI TO PLANT SITE	1:200	AUGUST, 2013	CS/DWG-32 of 54

Crest width within existing R.O.W ___Earth cutting is required Datum Level(m) -5.00 -18.00 -16.00 -20.00 -12.00 -10.00 2.00 4.00 20.00 30.00 Distance(m) 4.63 4.61 4.69 5.11 4.39 4.63 4.21 Points

Chainage 2884.212\Materbari\Top

	NAME OF THE PROJECT :		DRAWING TITLE :	REV.	DESCRIPTION DATE :	DATE DRAWING NO.
Roads and Highways Department (RHD) Ministry of Communications	Preparatory Survey on chittagong Area Coal Fared Power Plant Development Project in Bangladesh (JICA Study).	JAPAN INTERNATIONAL COOPERATION AGENCY(JICA)	ROAD CROSS SECTION BADARKHALI TO PLANT SITE	1:200	AUGUST, 2013	CS/DWG-33 of 54

Crest width within existing R.O.W Datum Level(m) -5.00 -26.00 -22.00 -20.00 -18.00 -12.00 -10.00 -8.00 -6.00 4.00 6.00 8.00 Distance(m) 5.57 5.47 5.45 5.44 5.40 5.39 4.93 5.62 5.24 4.67 4.60 4.54 4.42 4.32 Points


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				REV.	DESCRIPTION	DATE
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Roads and Highways Department (RHD) Ministry of Communications	Preparatory Survey on chittagong Area Coal Fared Power Plant Development Project in Bangladesh (JICA Study). JAPAN INTERNATIONAL COOPERATION AGENCY(JICA)	JAPAN INTERNATIONAL COOPERATION AGENCY(JICA)	ROAD CROSS SECTION BADARKHALI TO PLANT SITE	1:200	AUGUST, 2013	CS/DWG-34 of 54

Crest width within existing R.O.W Datum Level(m) -5.00 -16.00 -4.00 9.00 34.00 -2.00 10.00 22.00 24.00 38.00 44.00 Distance(m) 5.10 4.89 5.54 5.37 4.43 4.22 5.06 4.98 4.87 5.21 5.66 5.45 4.51 4.52 4.50 4.43 4.87 4.19 Points


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				REV.	DESCRIPTION	DATE
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Roads and Highways Department (RHD) Ministry of Communications	Preparatory Survey on chittagong Area Coal Fared Power Plant Development Project in Bangladesh (JICA Study).	JAPAN INTERNATIONAL COOPERATION AGENCY(JICA)	ROAD CROSS SECTION BADARKHALI TO PLANT SITE	1:200	AUGUST, 2013	CS/DWG-35 of 54



CH. 3263.94m

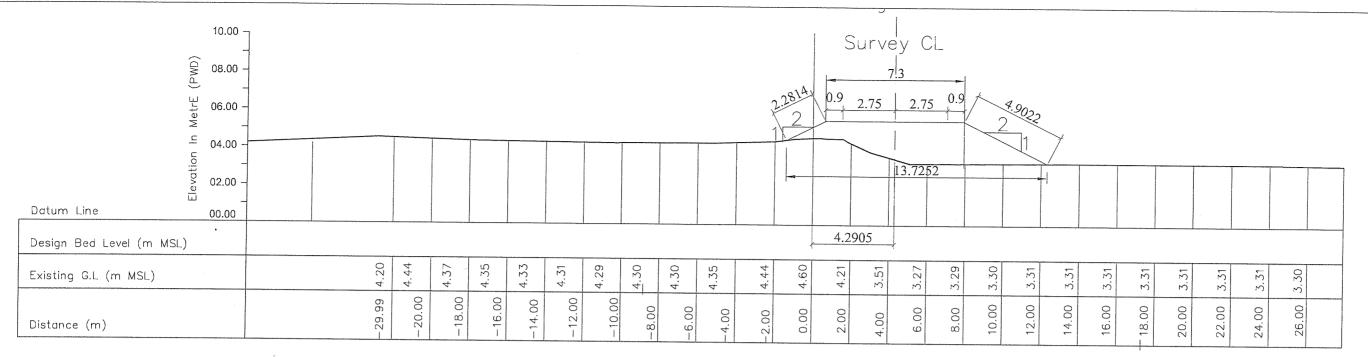
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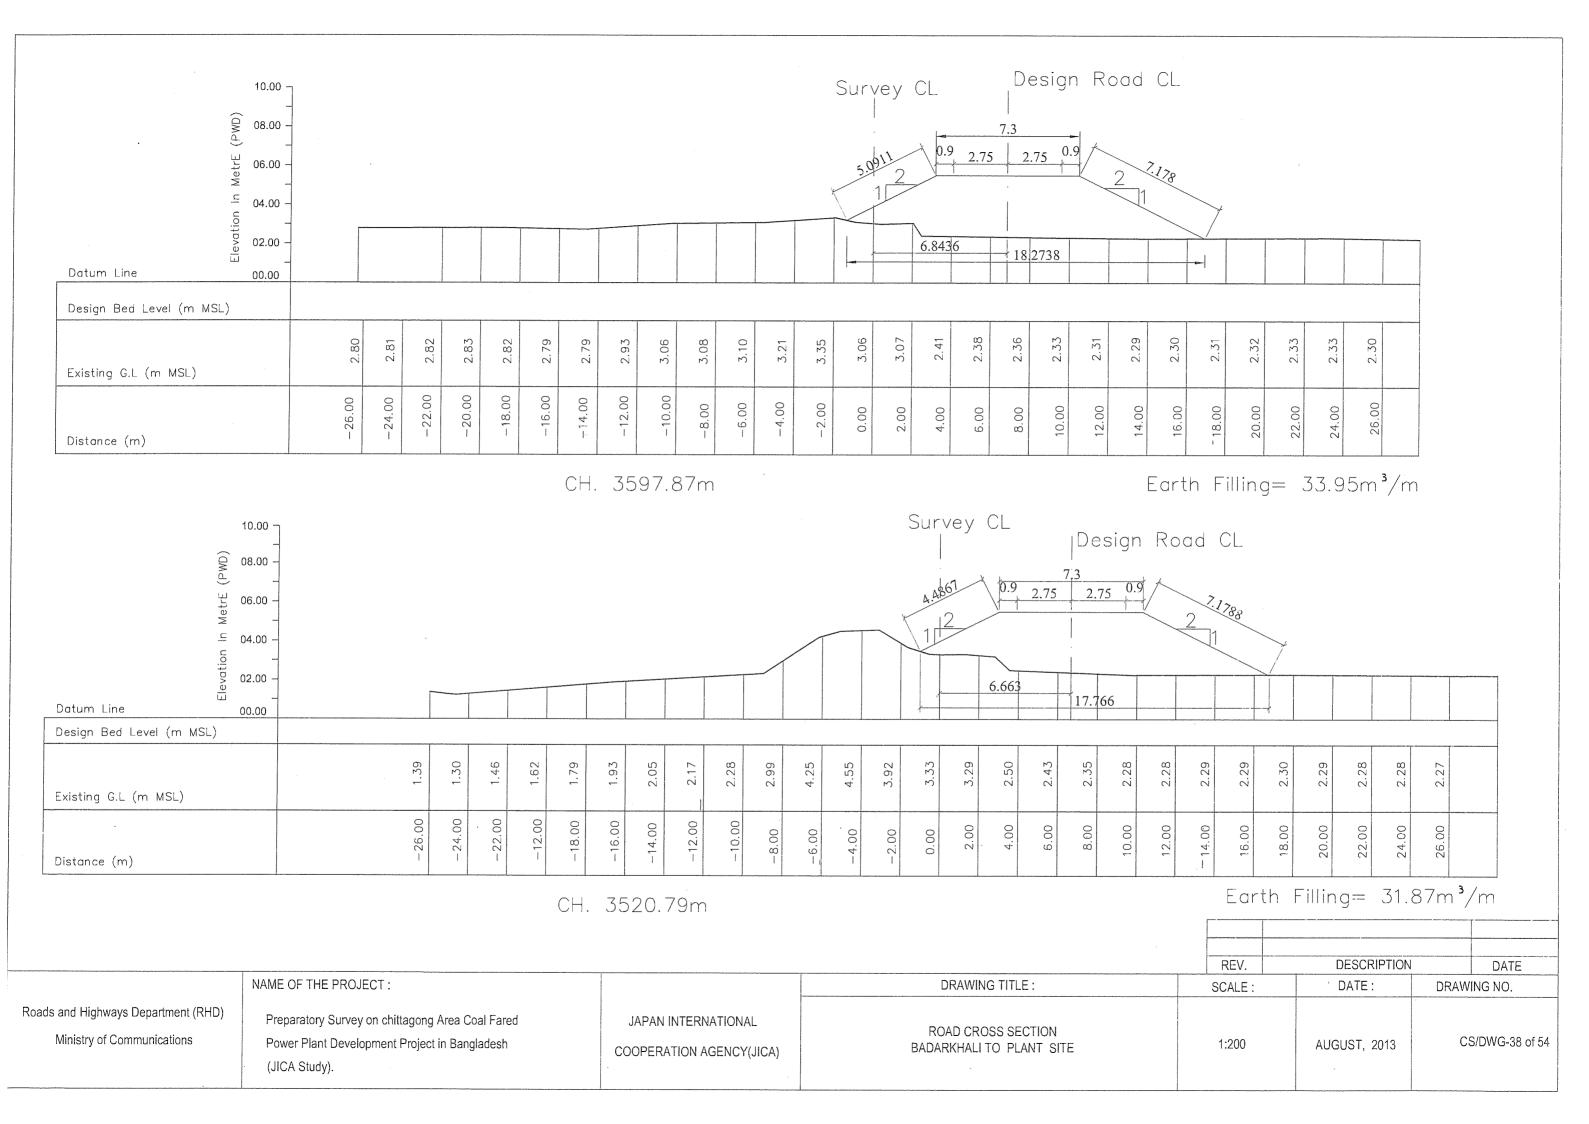



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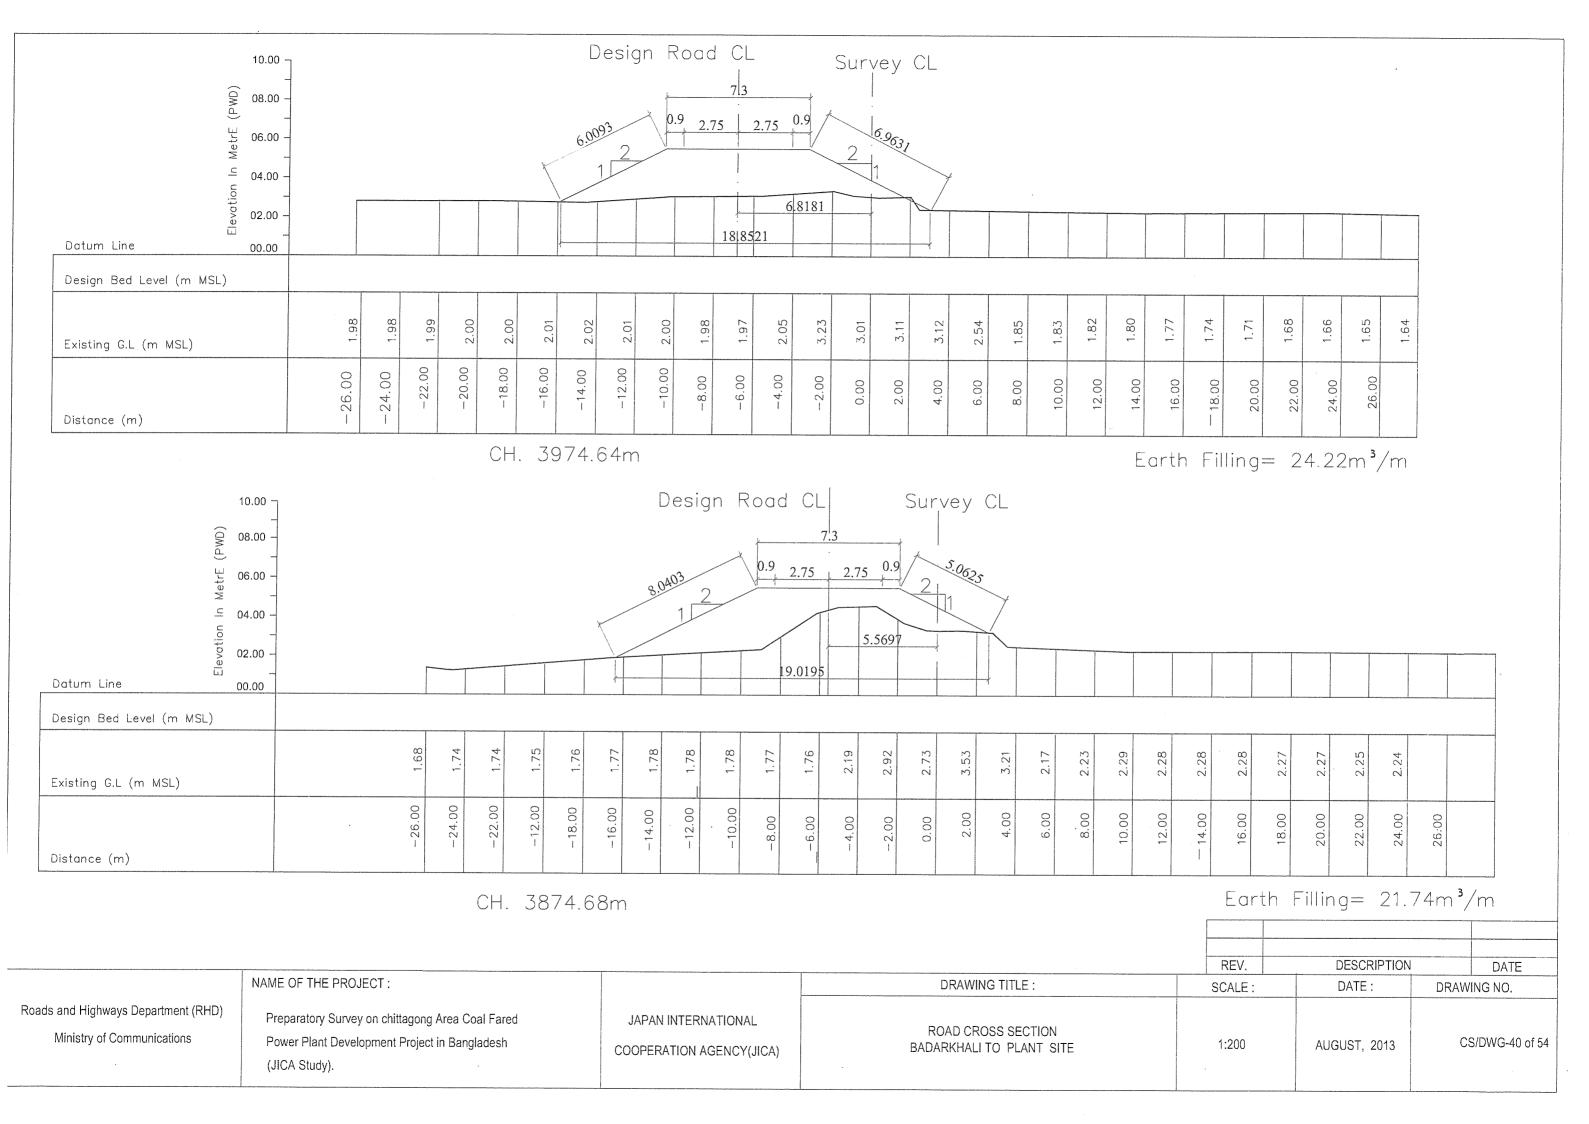
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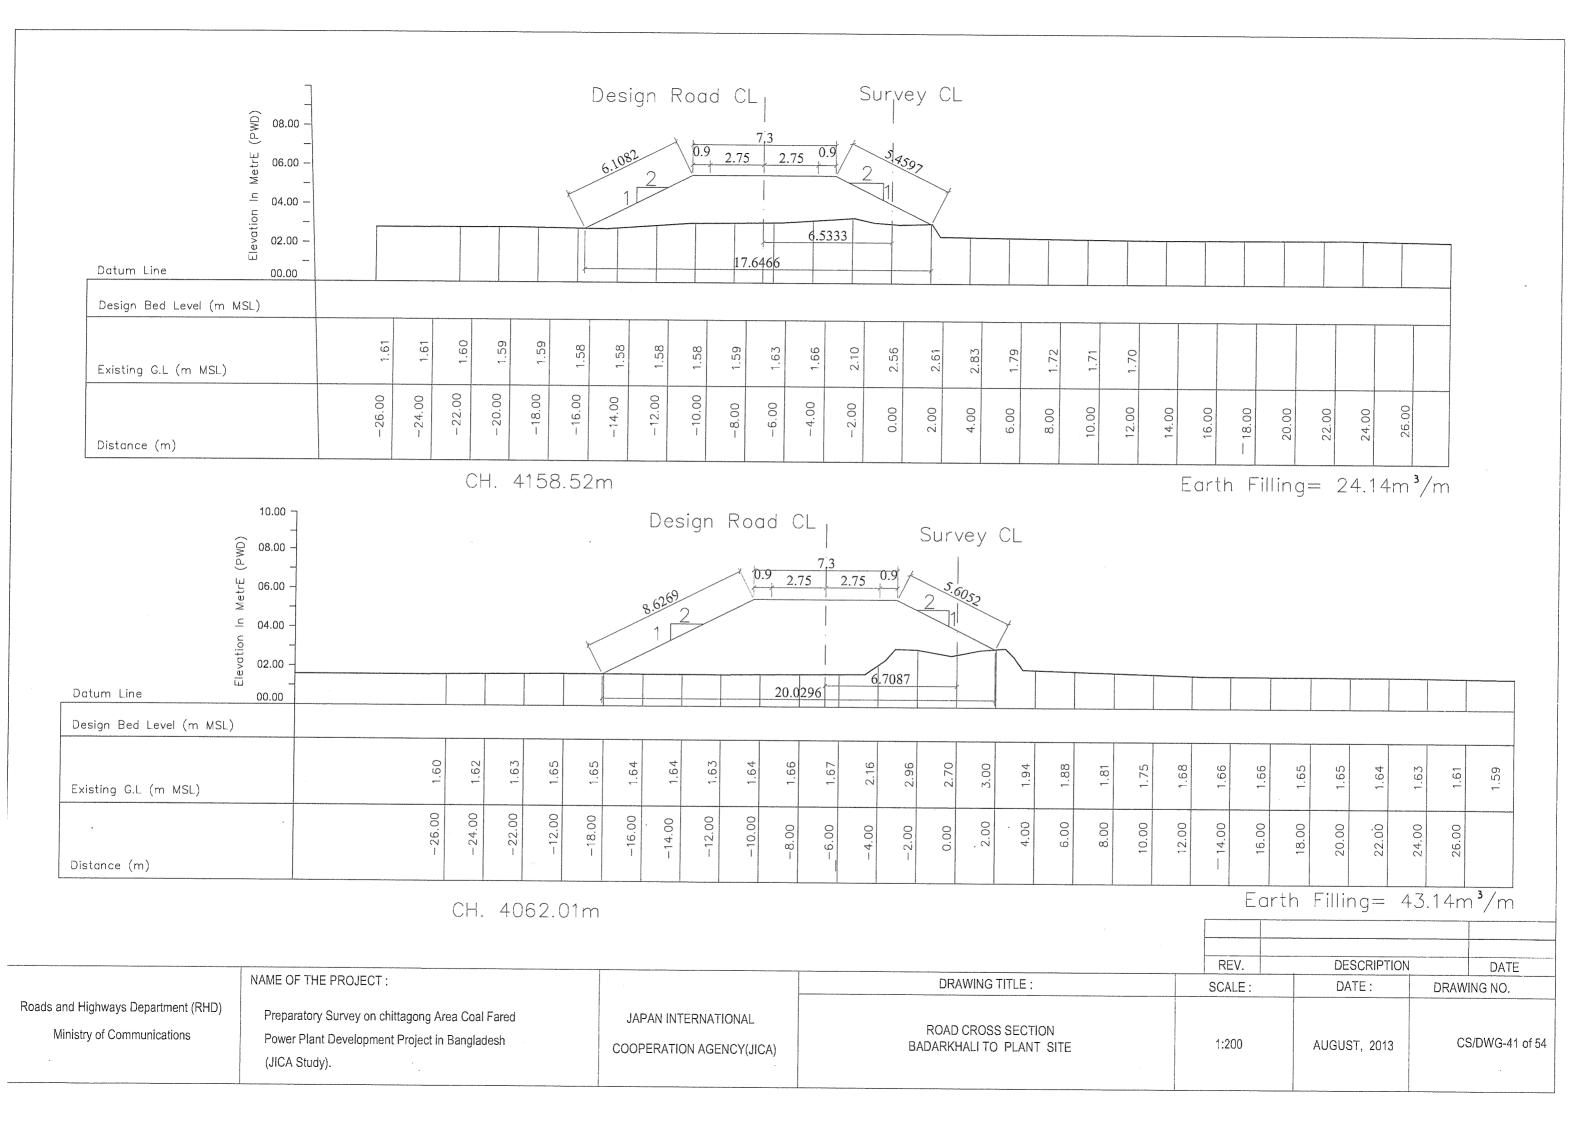
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Roads and Highways Department (RHD) Ministry of Communications	Preparatory Survey on chittagong Area Coal Fared Power Plant Development Project in Bangladesh (JICA Study).	JAPAN INTERNATIONAL COOPERATION AGENCY(JICA)	ROAD CROSS SECTION BADARKHALI TO PLANT SITE	1:200	AUGUST, 2013	CS/DWG-36 of 54

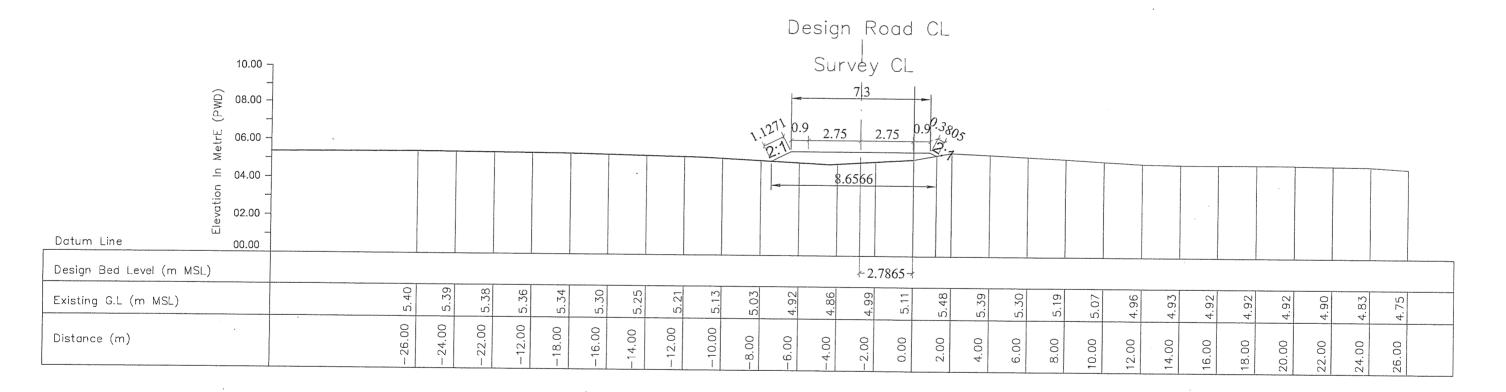








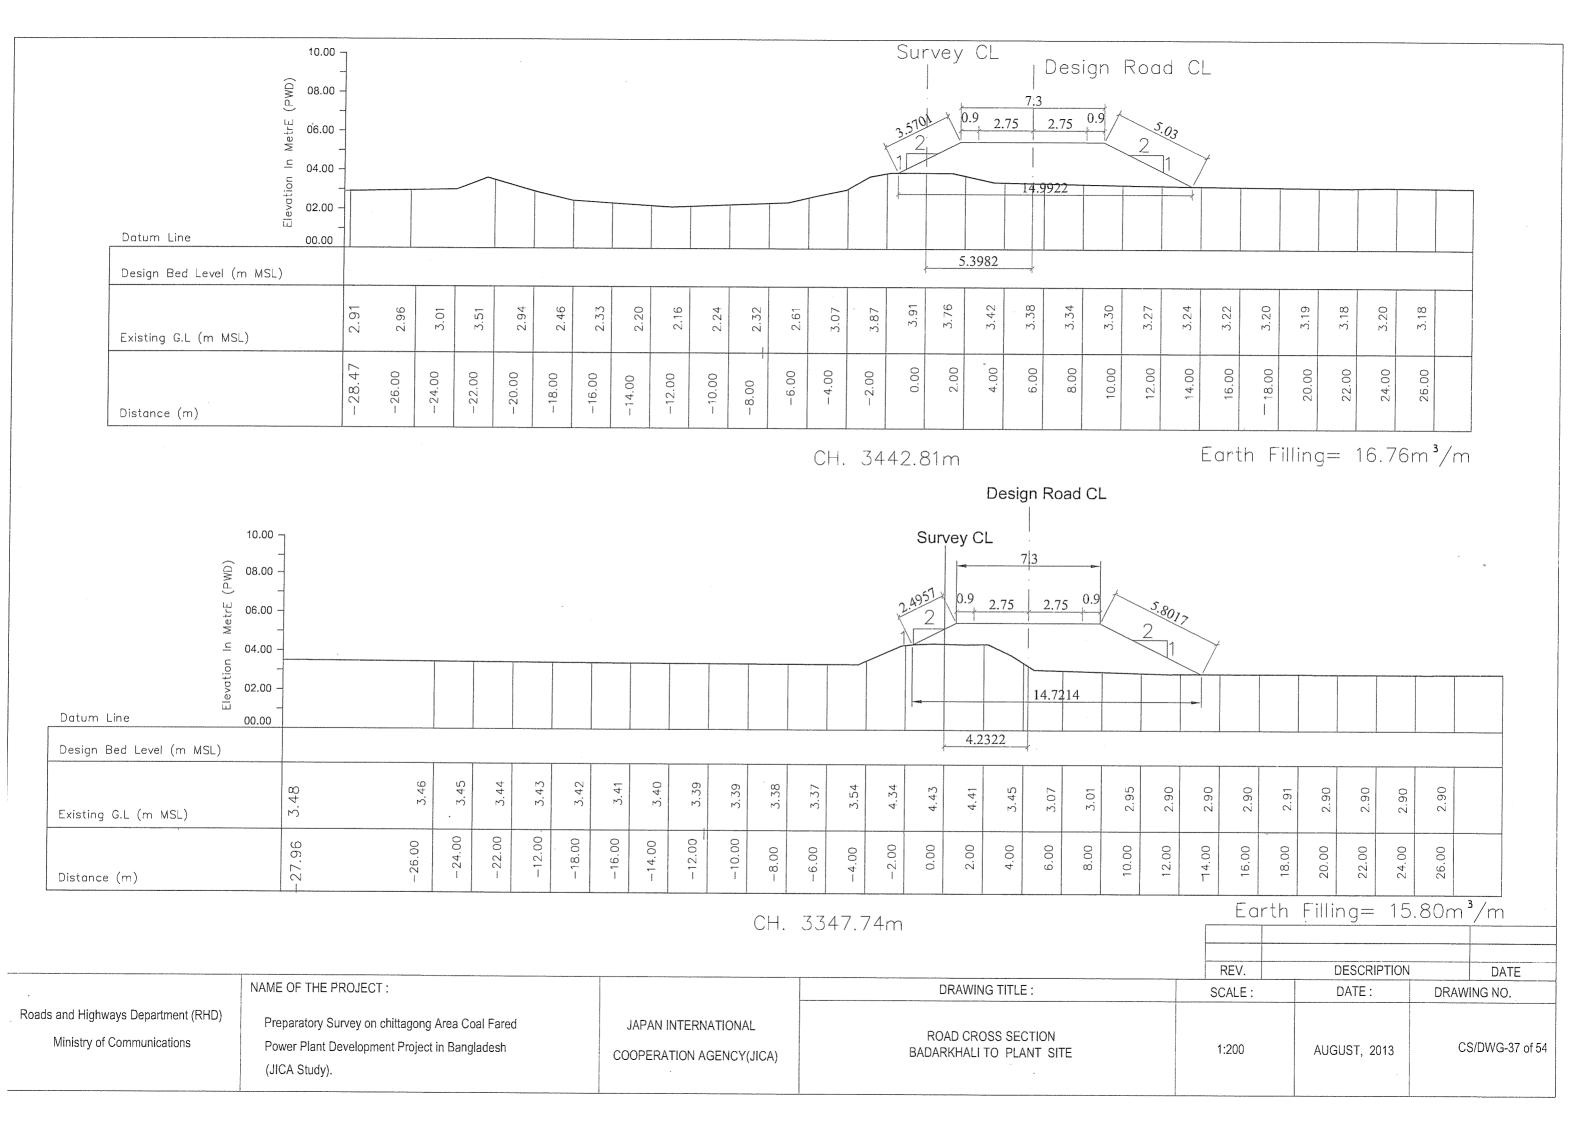


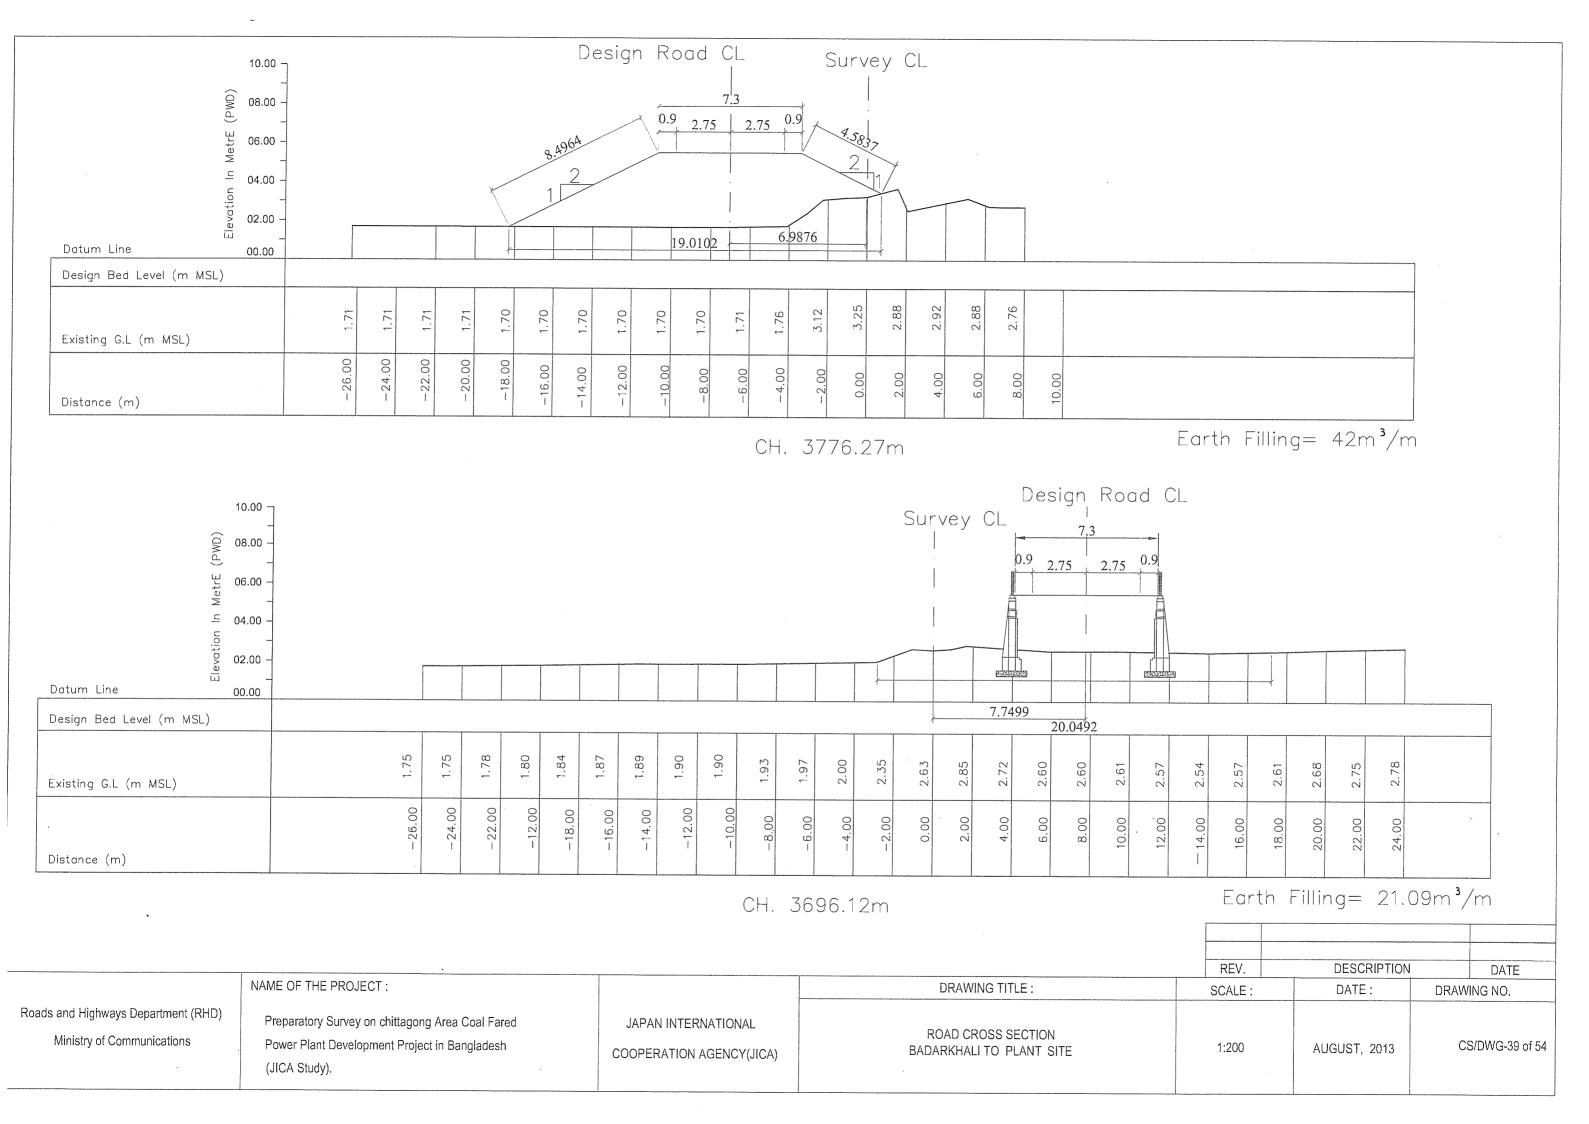

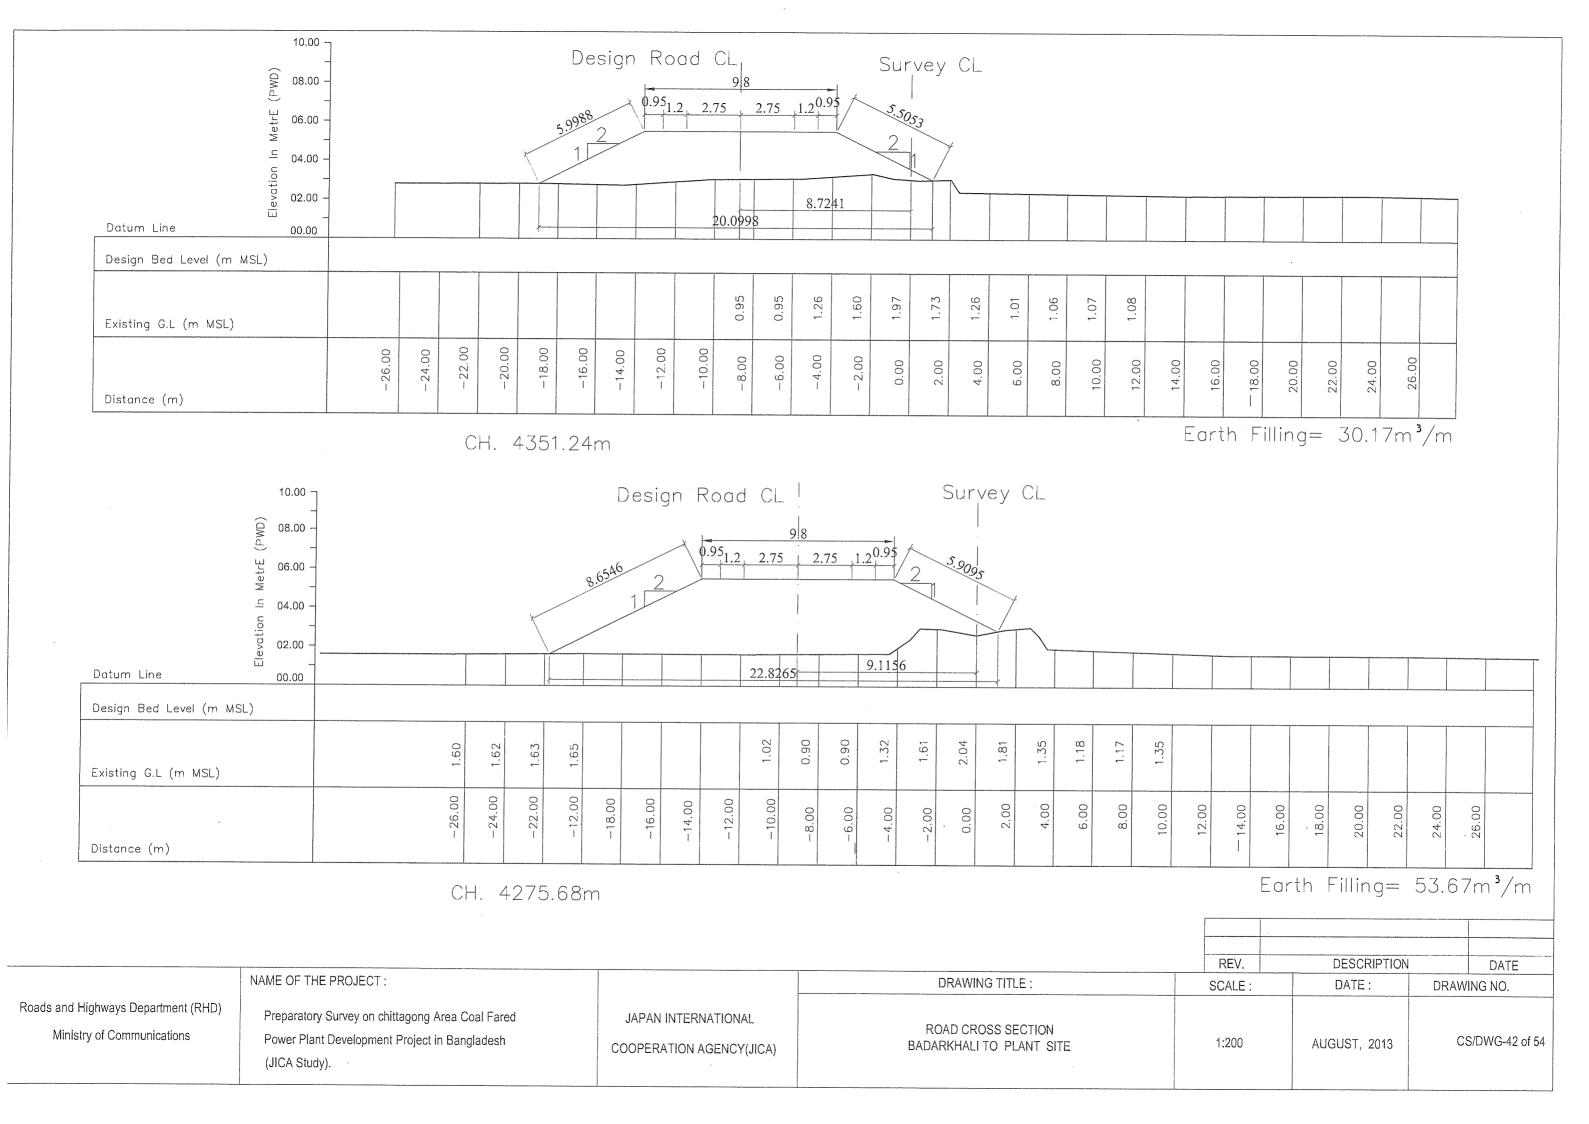

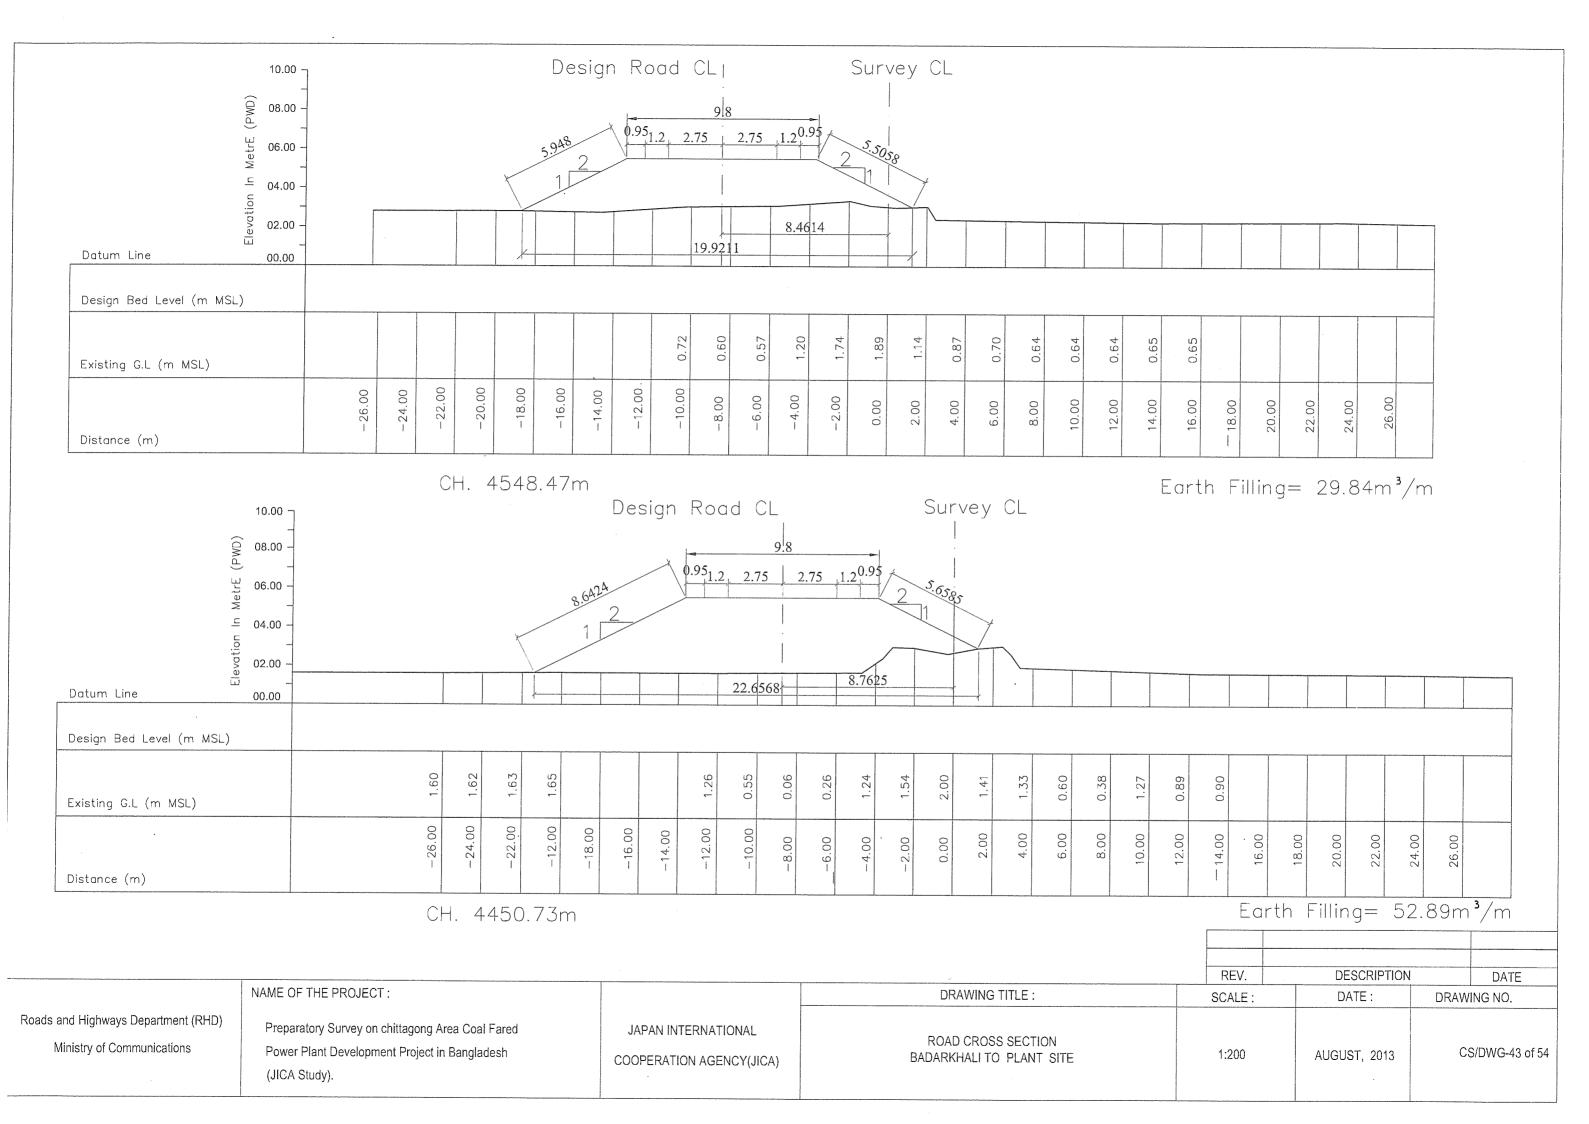

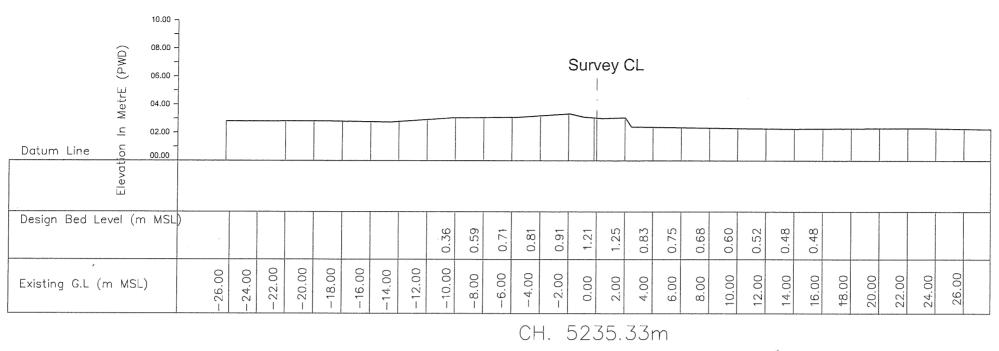


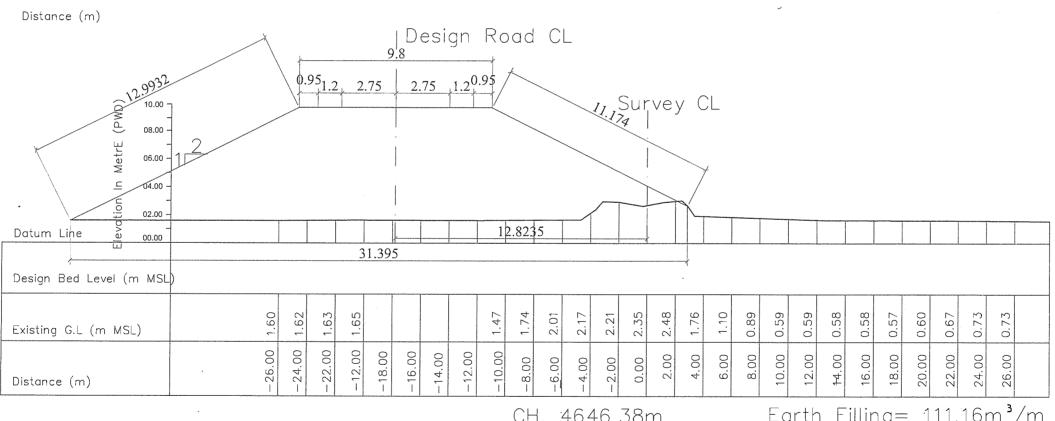



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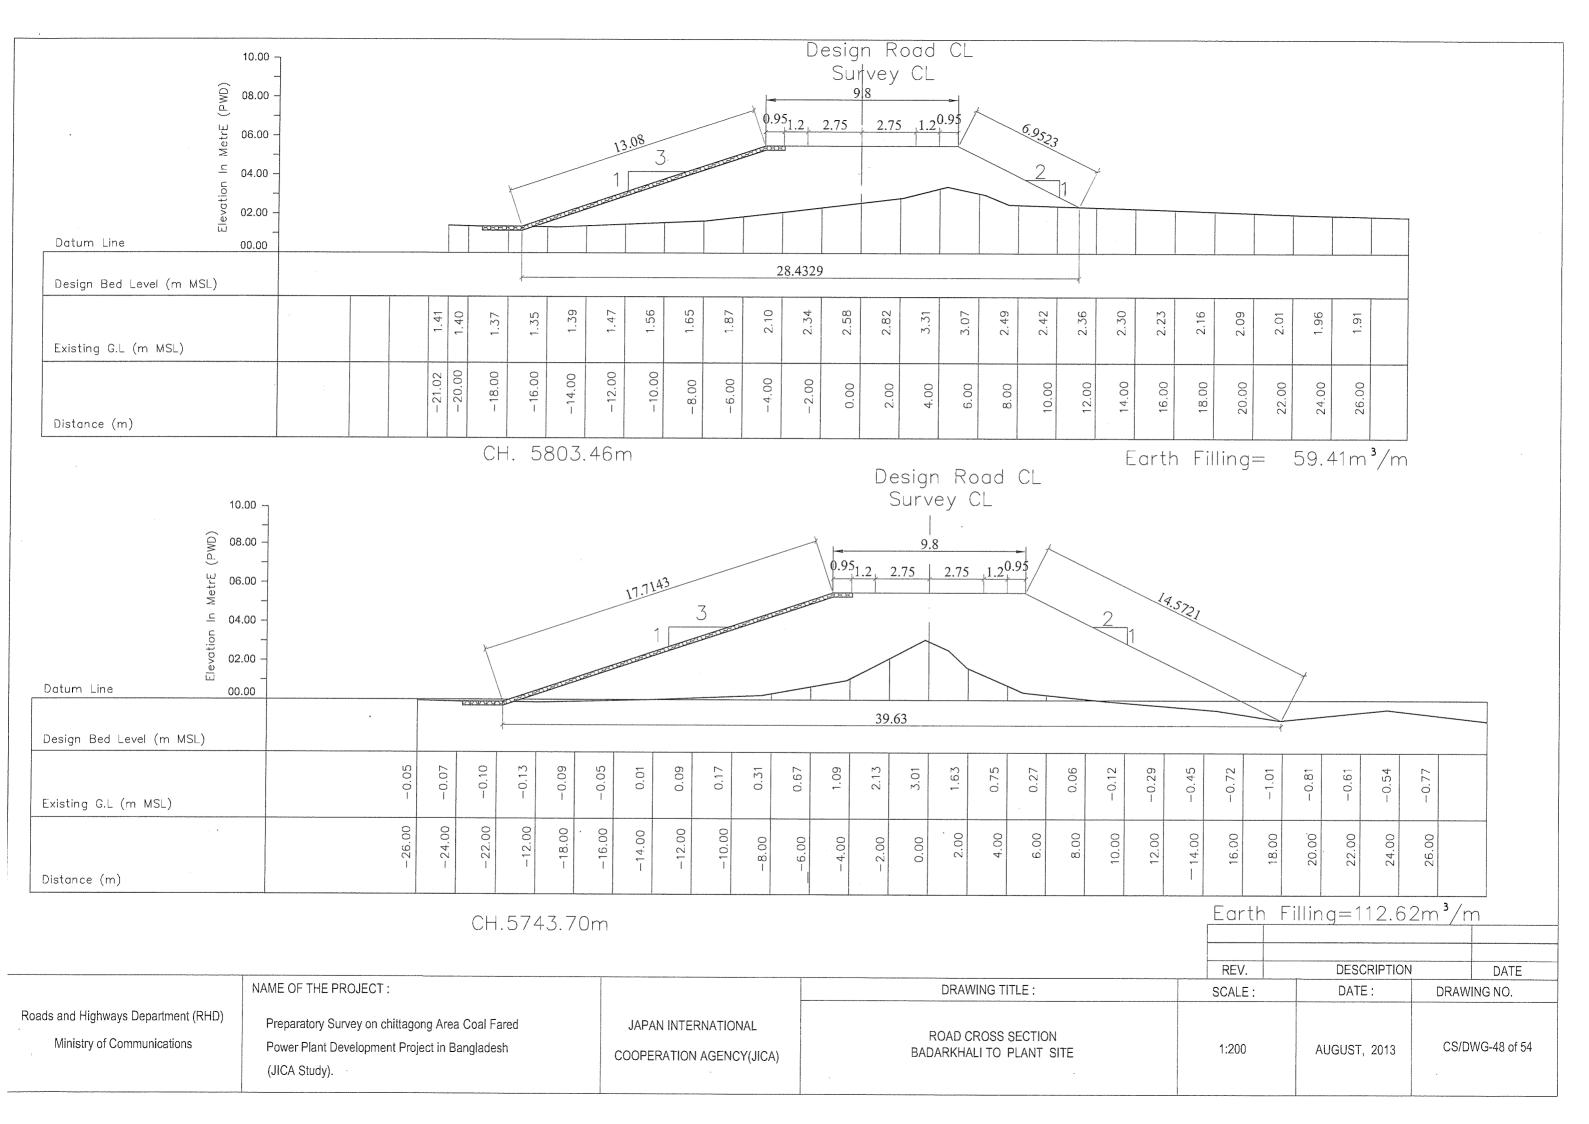
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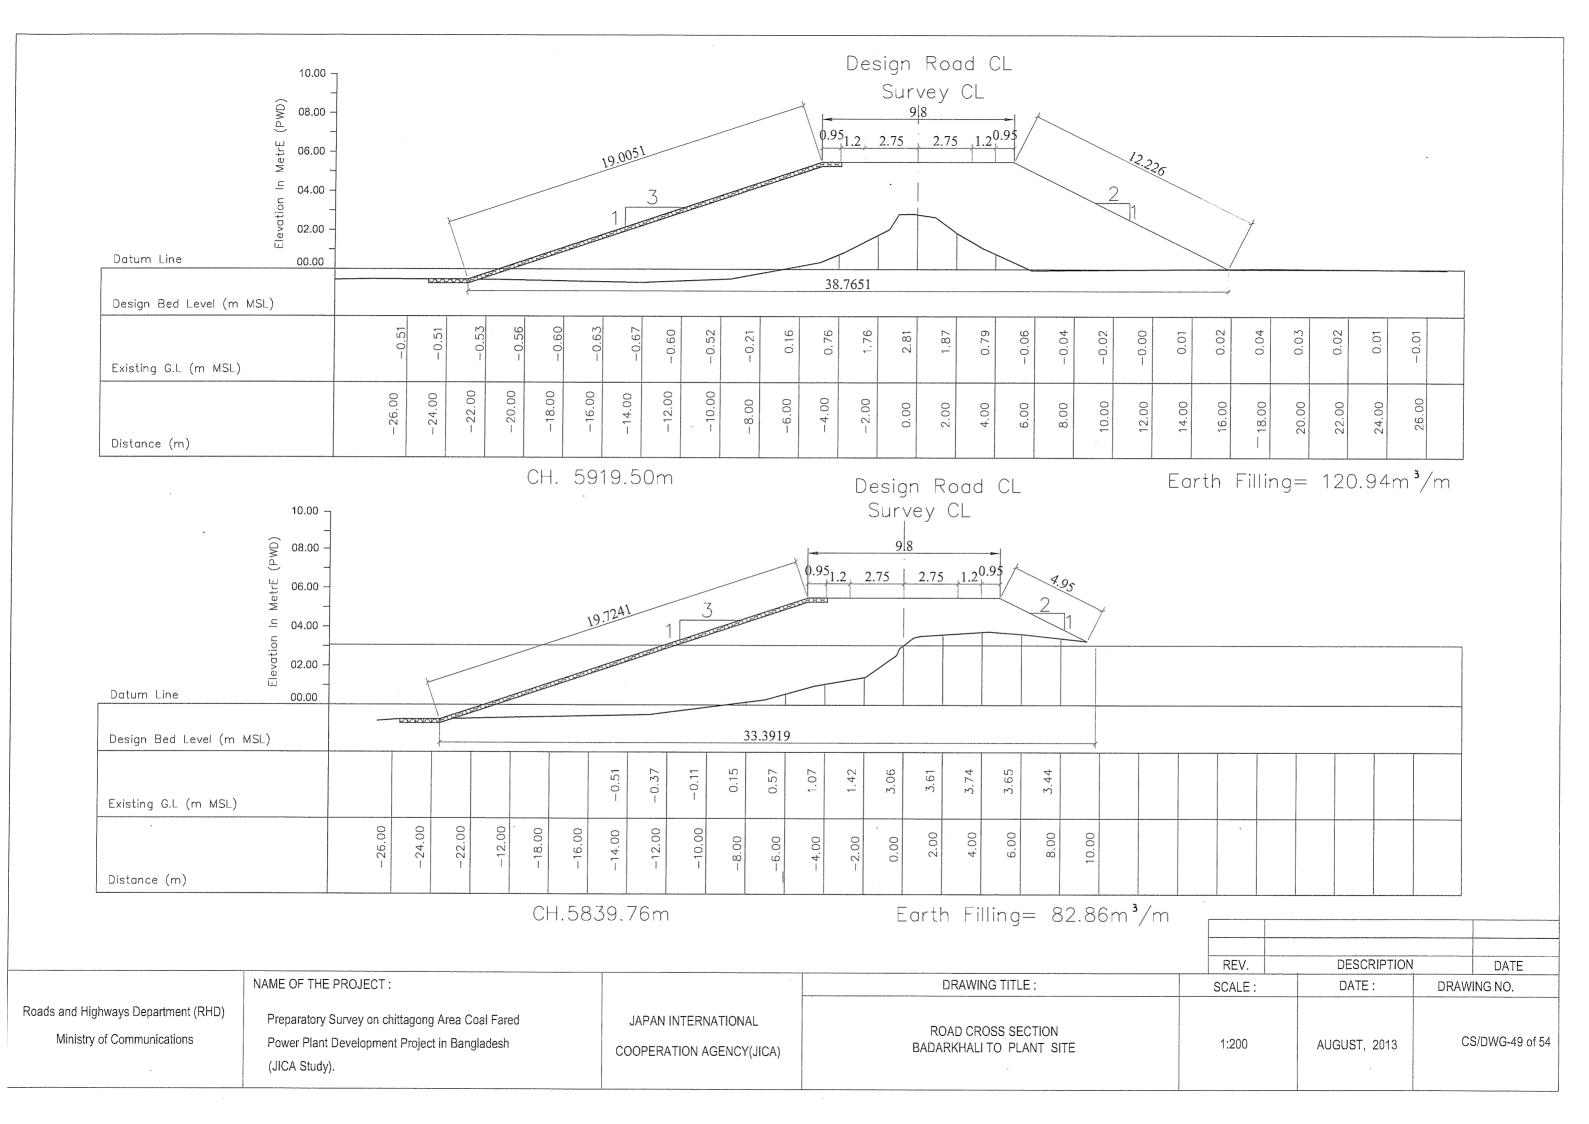
			•	REV.	DESCRIPTION	DATE
	NAME OF THE PROJECT :		DRAWING TITLE :	SCALE:	DATE:	DRAWING NO.
Roads and Highways Department (RHD) Ministry of Communications	Preparatory Survey on chittagong Area Coal Fared Power Plant Development Project in Bangladesh (JICA Study).	JAPAN INTERNATIONAL COOPERATION AGENCY(JICA)	ROAD CROSS SECTION BADARKHALI TO PLANT SITE	1:200	AUGUST, 2013	CS/DWG-44 of 54







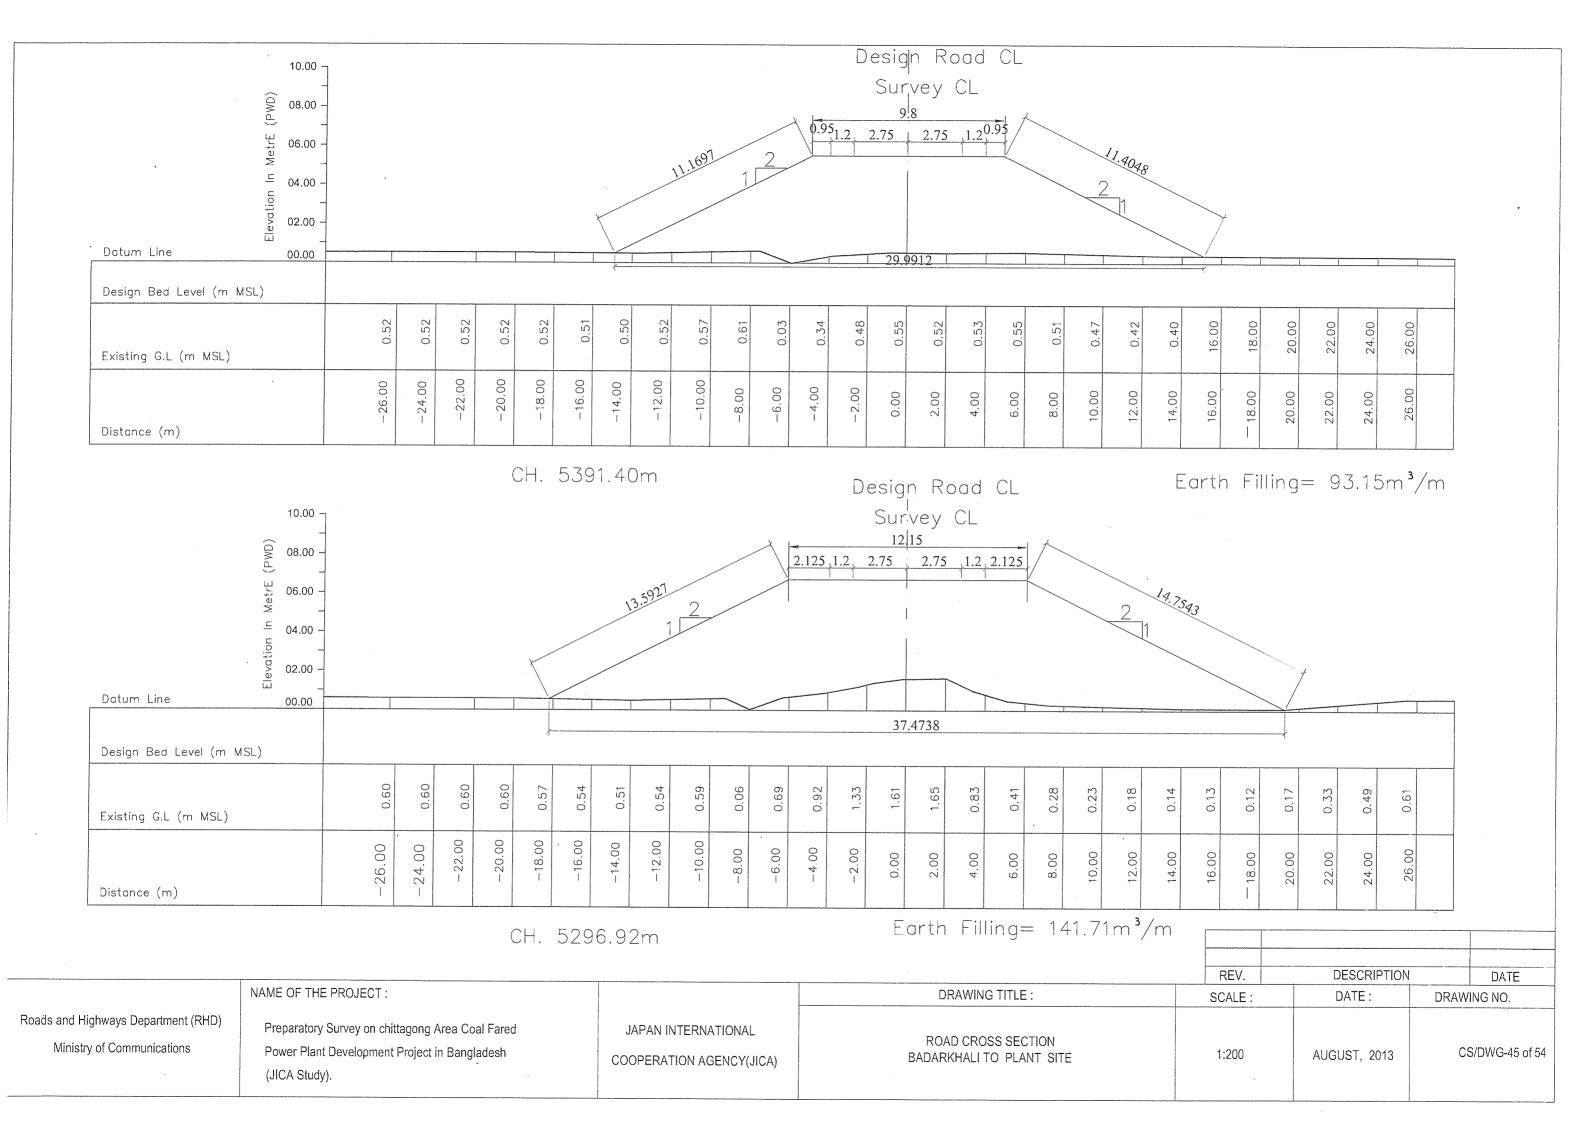


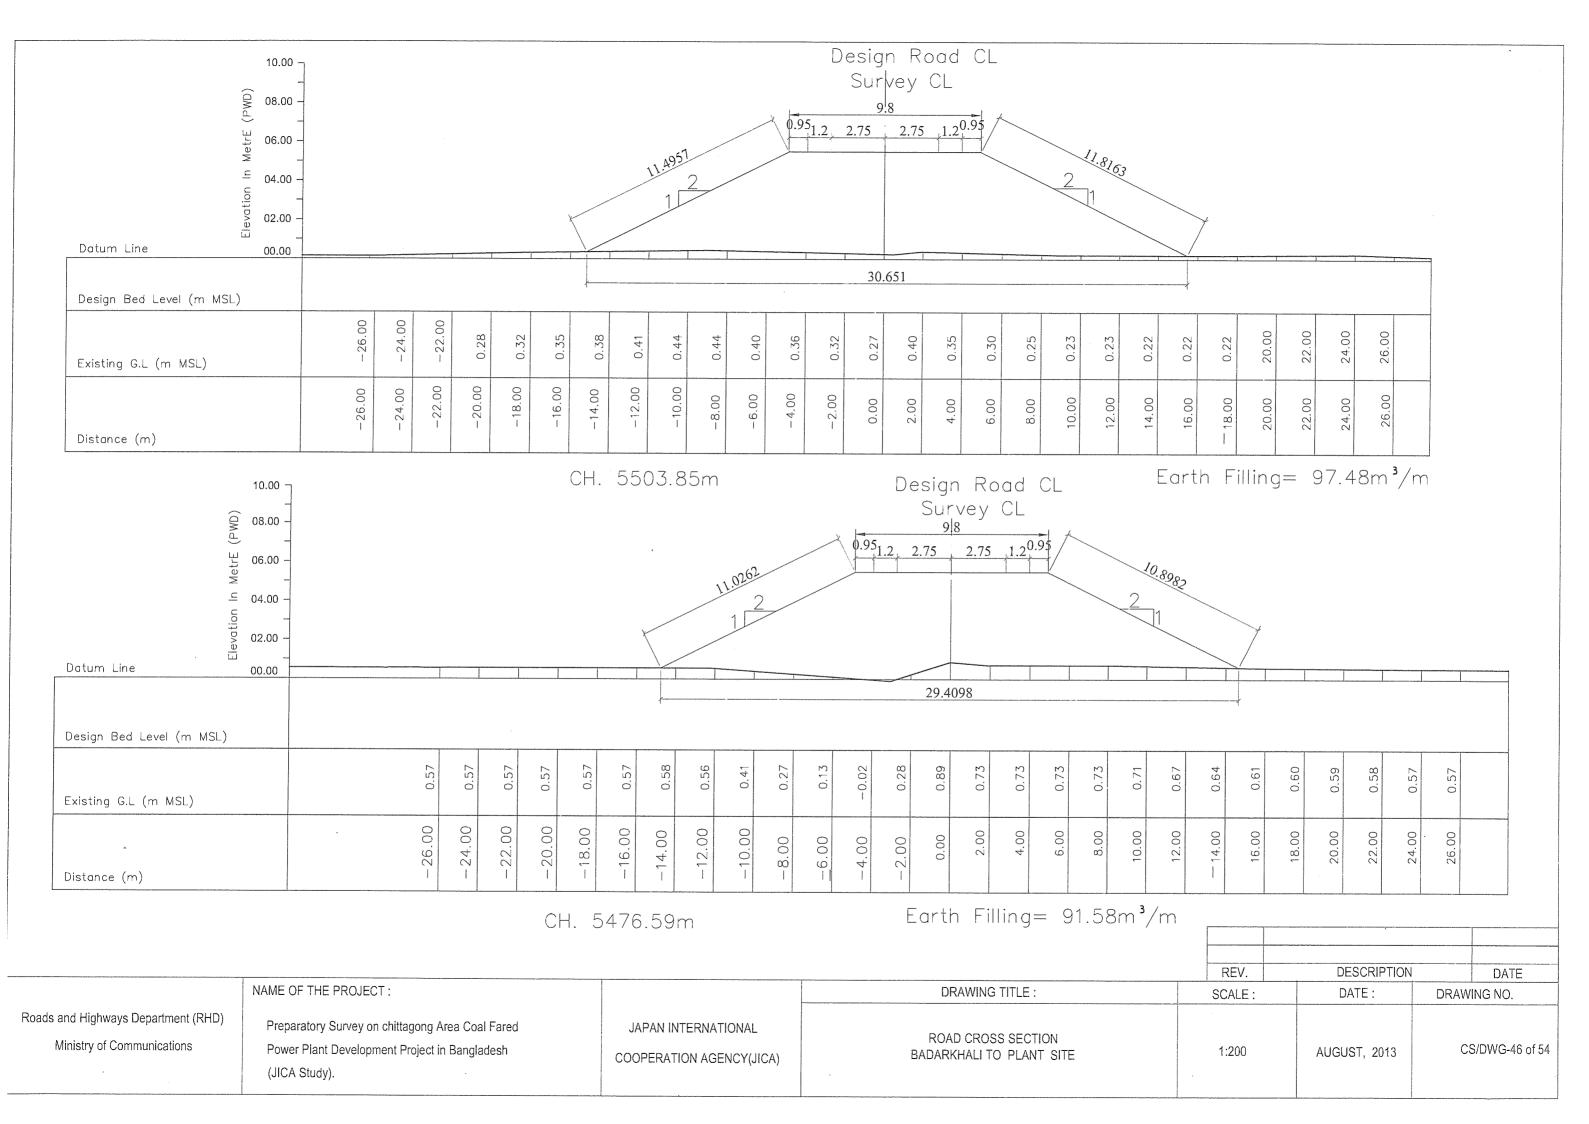


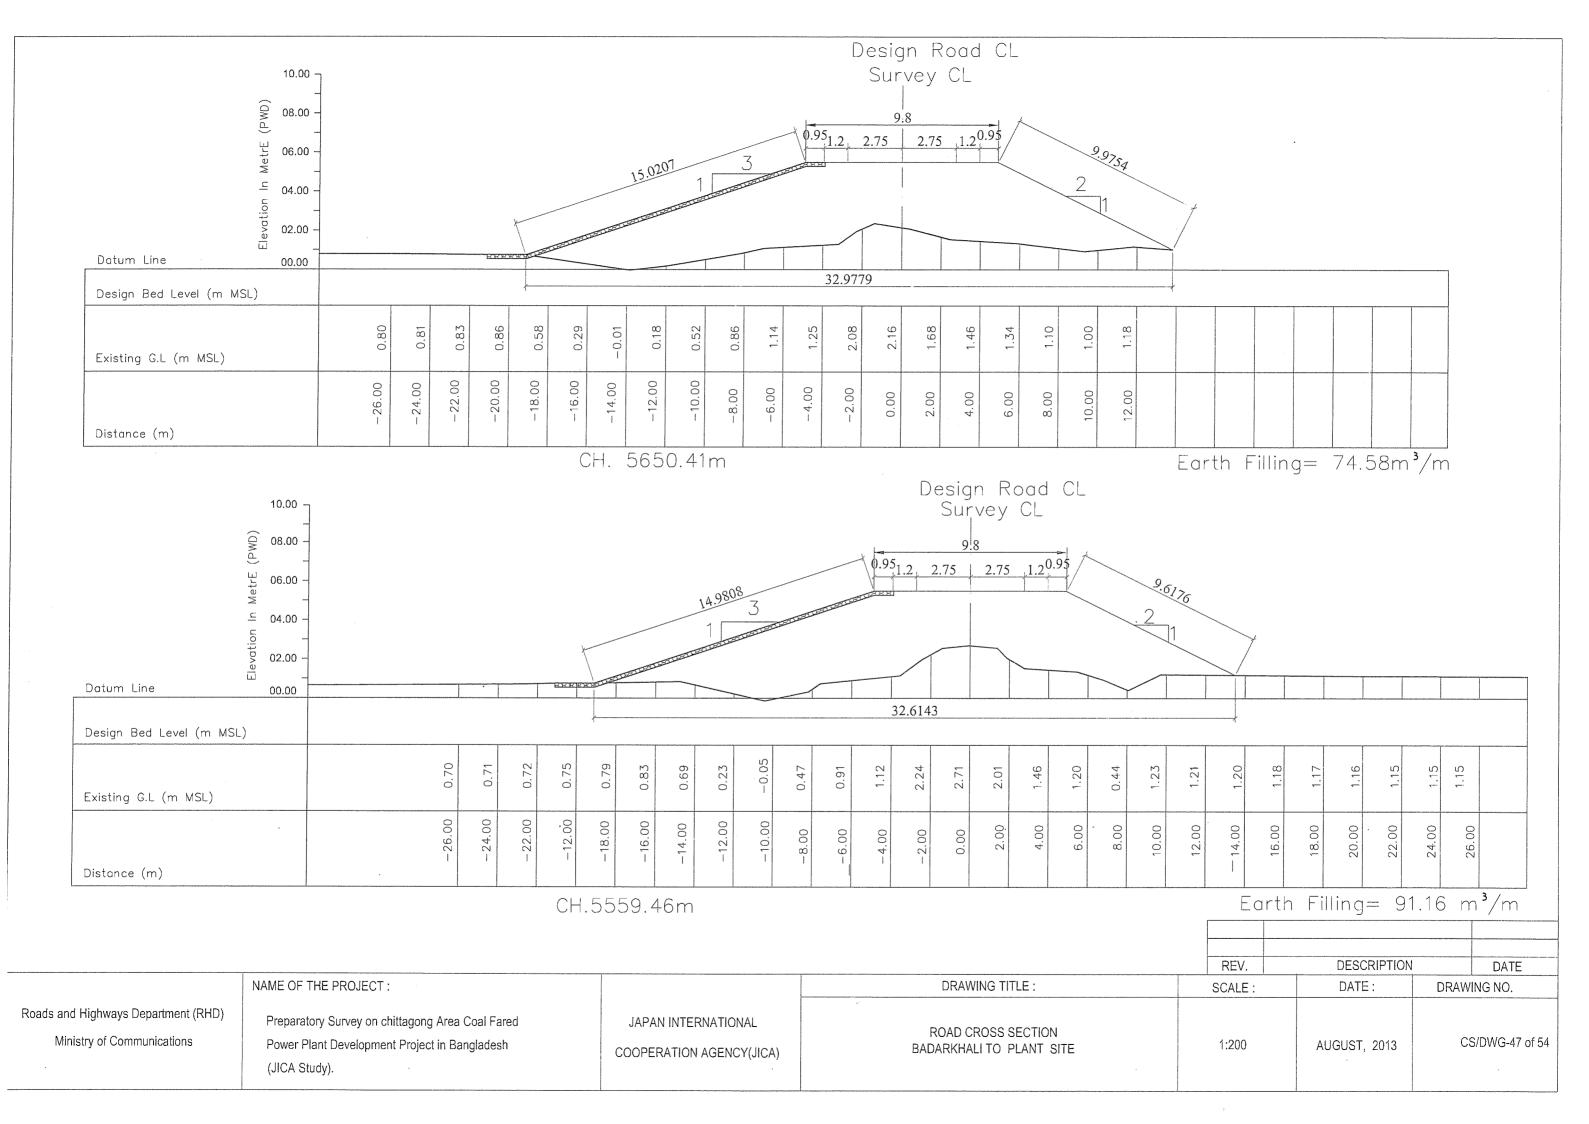

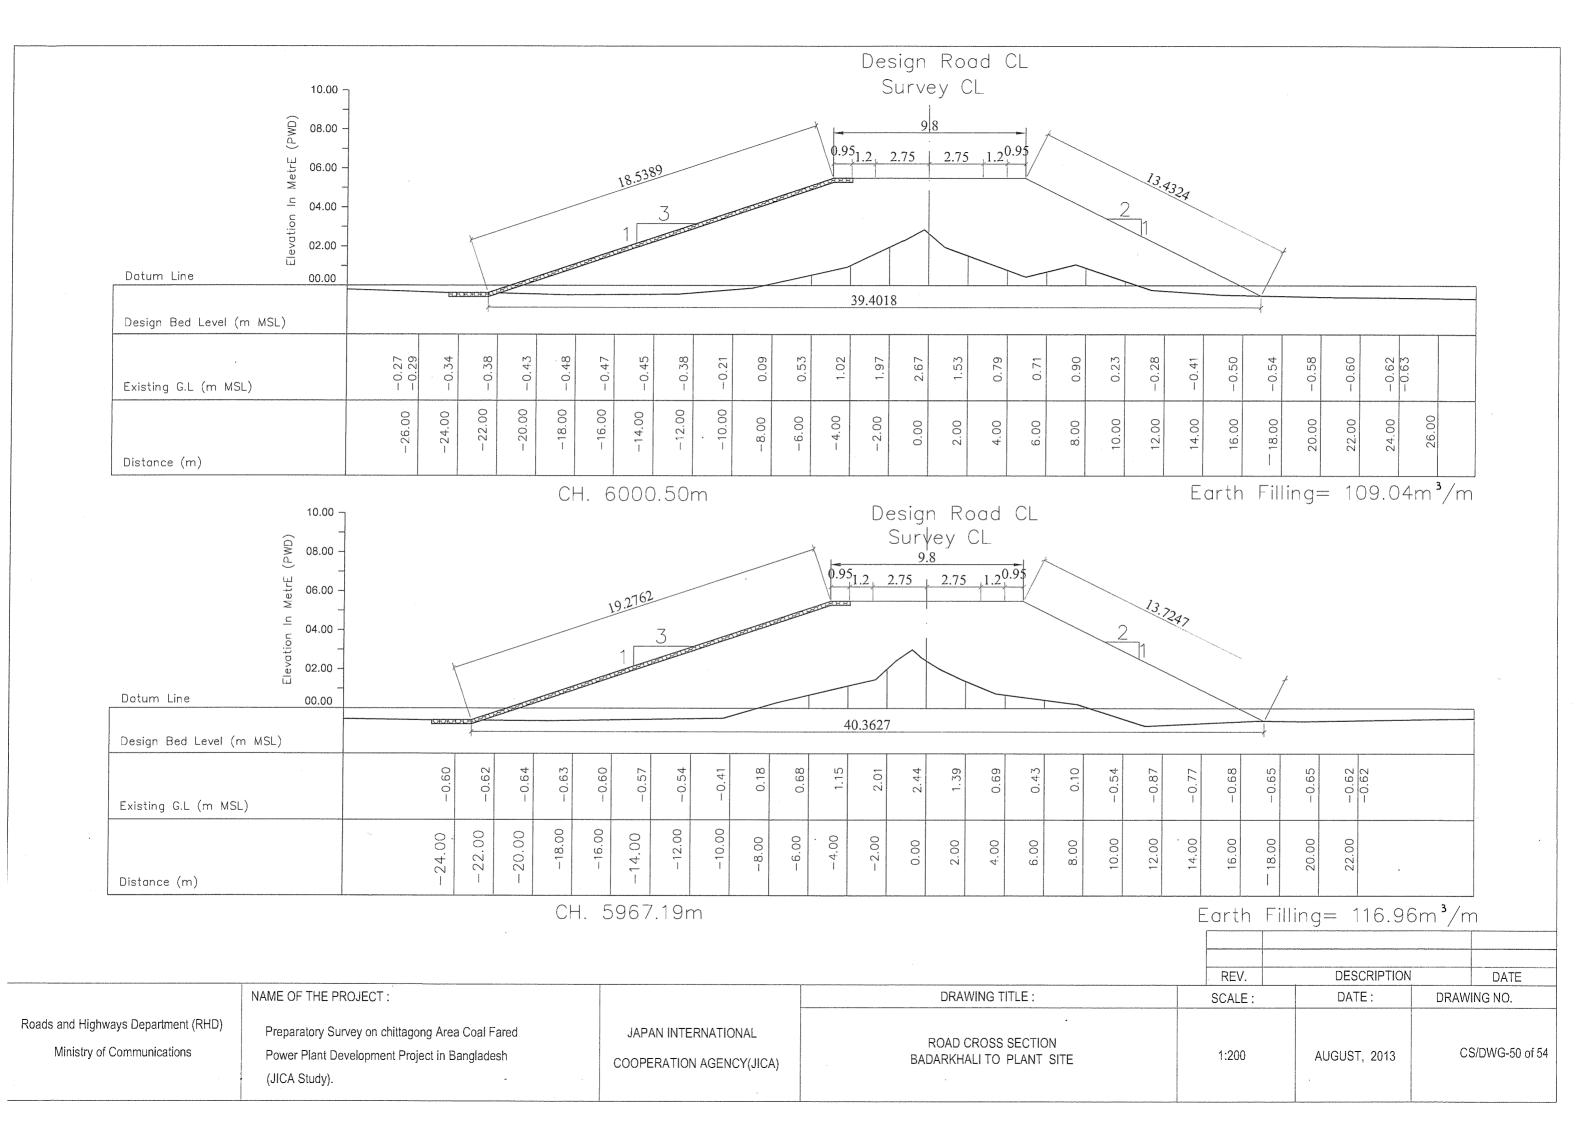

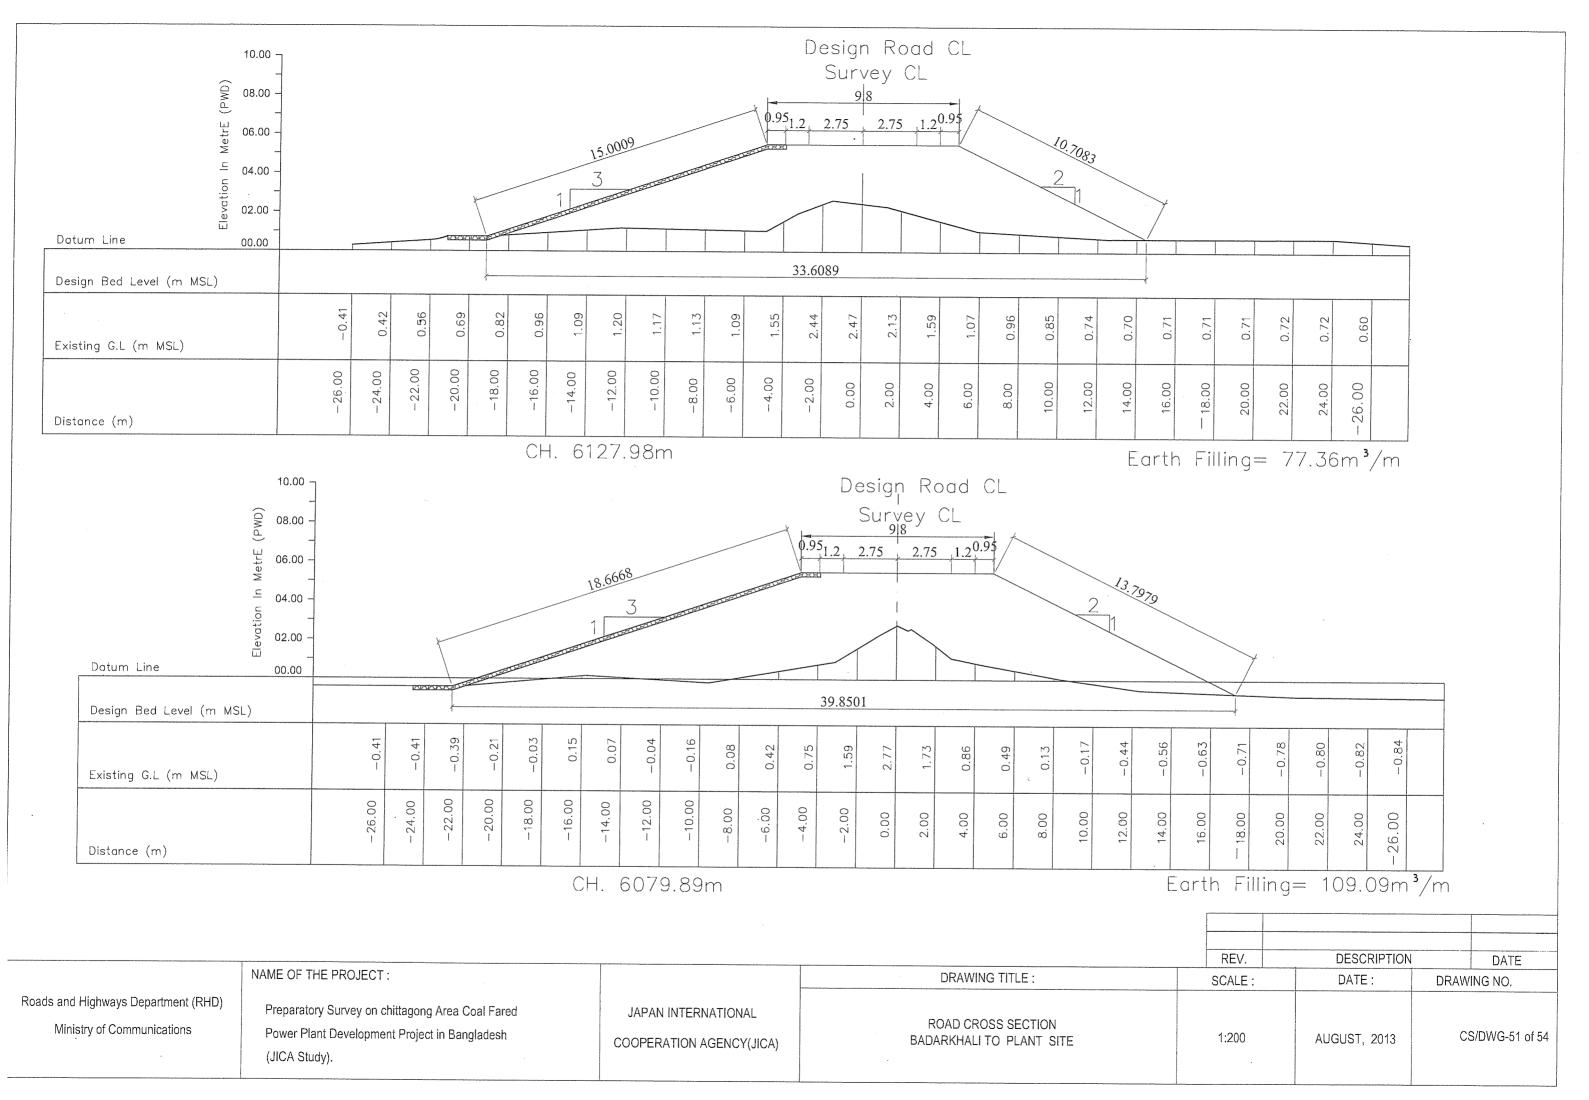

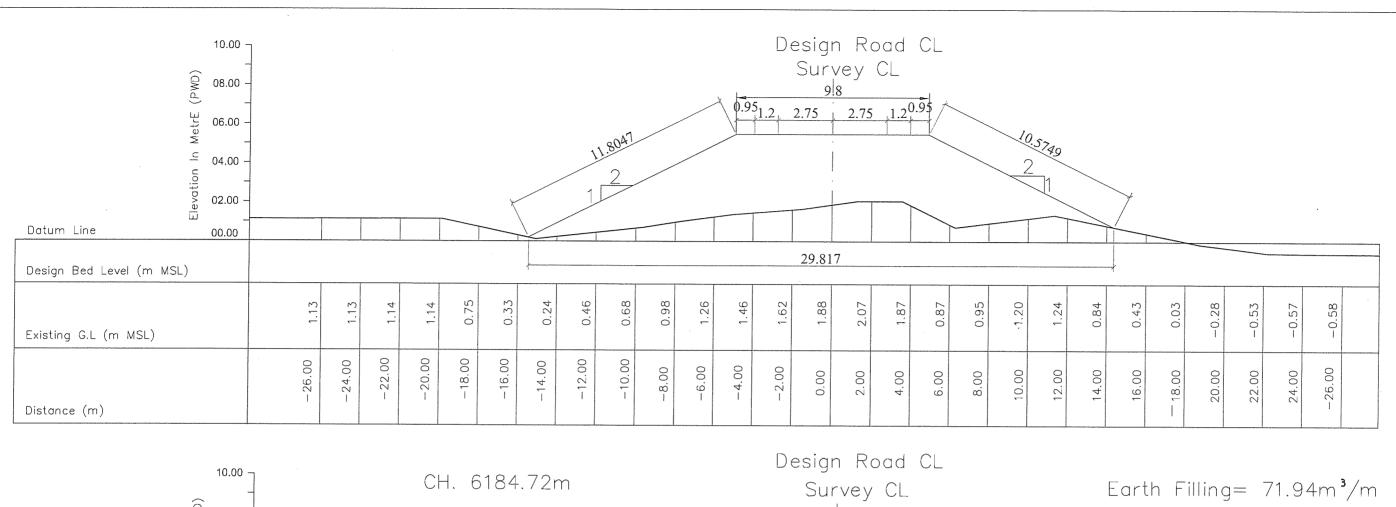


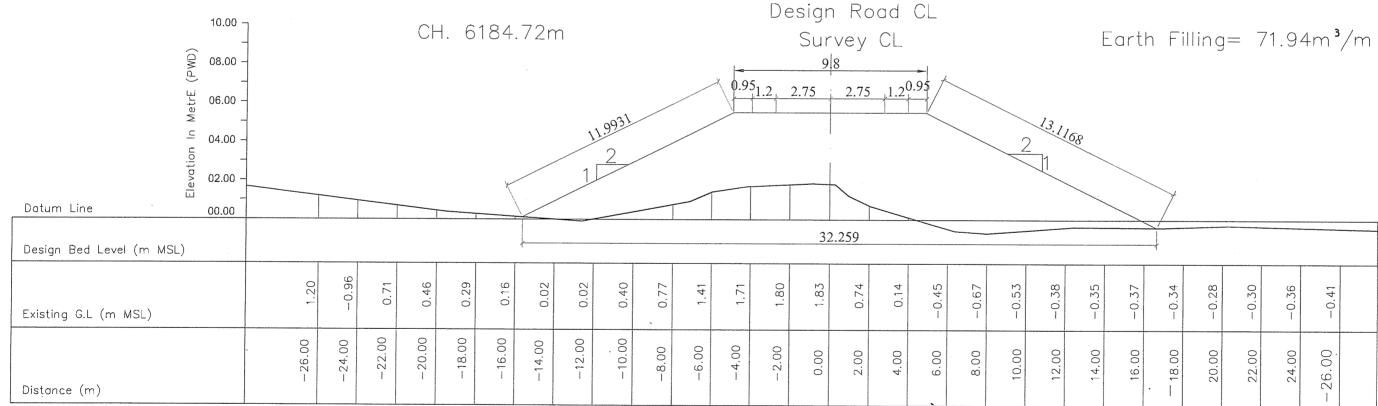

CH. 6161.96m

Earth Filling= 95.17m³/m

		-		REV.	DESCRIPTION	DATE
	NAME OF THE PROJECT:		DRAWING TITLE :	. SCALE:	DATE:	DRAWING NO.
Roads and Highways Department (RHD) Ministry of Communications	Preparatory Survey on chittagong Area Coal Fared Power Plant Development Project in Bangladesh (JICA Study).	JAPAN INTERNATIONAL COOPERATION AGENCY(JICA)	ROAD CROSS SECTION BADARKHALI TO PLANT SITE	1:200	AUGUST, 2013	CS/DWG-52 of 54

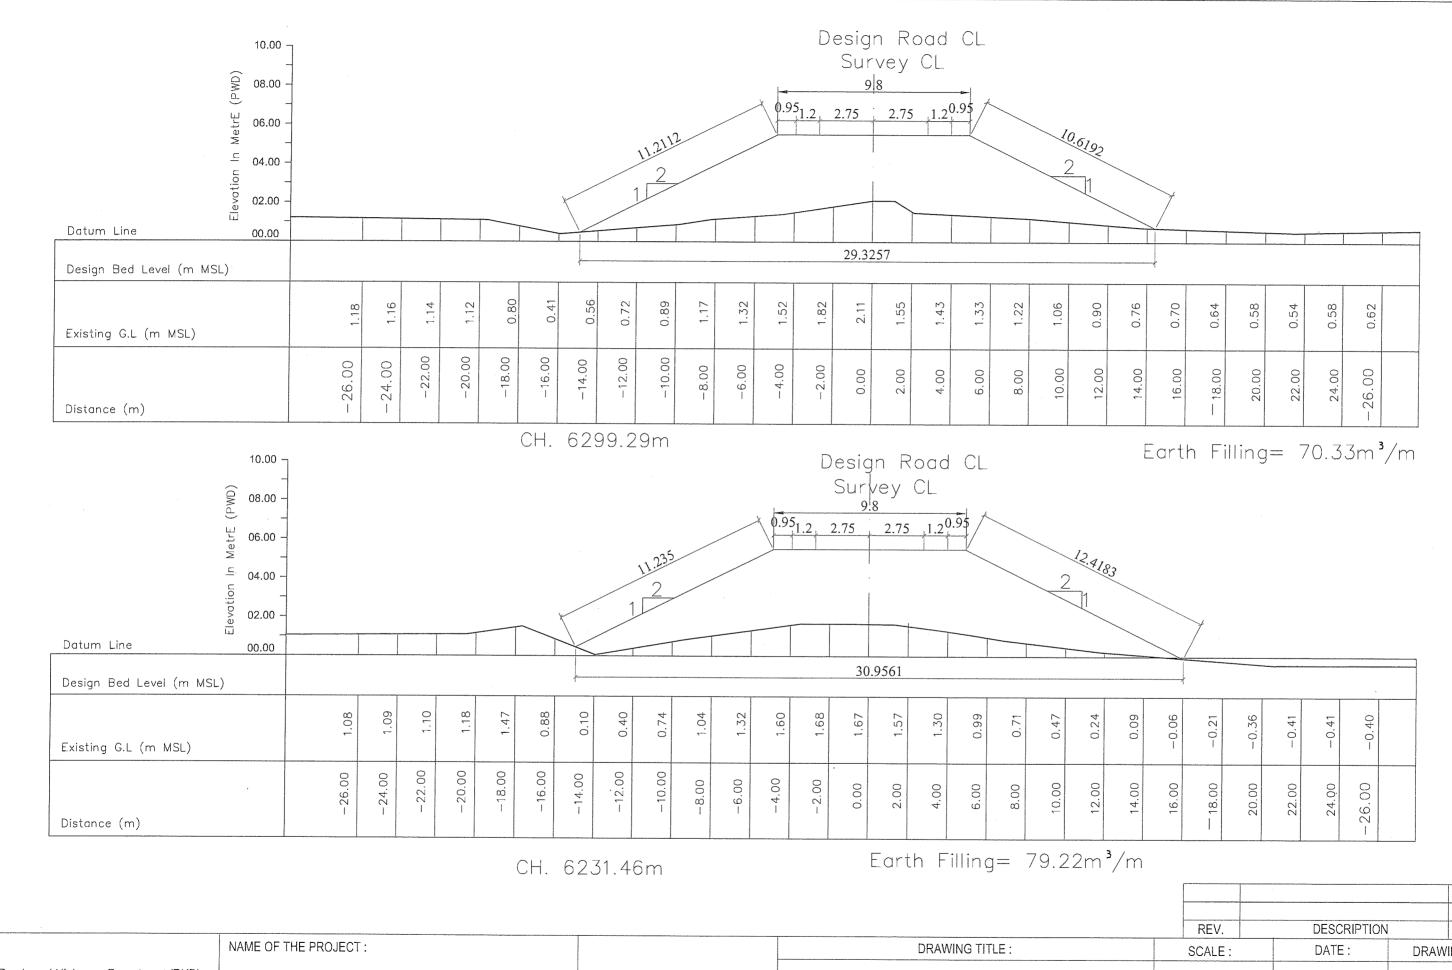

Roads and Highways Department (RHD)
Ministry of Communications

NAME OF THE PROJECT:

Preparatory Survey on chittagong Area Coal Fared
Power Plant Development Project in Bangladesh
(JICA Study).

Properatory Survey on chittagong Area Coal Fared
Power Plant Development Project in Bangladesh
(JICA Study).

DRAWING TITLE:

SCALE:

DATE:


DRAWING NO.

ROAD CROSS SECTION
BADARKHALI TO PLANT SITE


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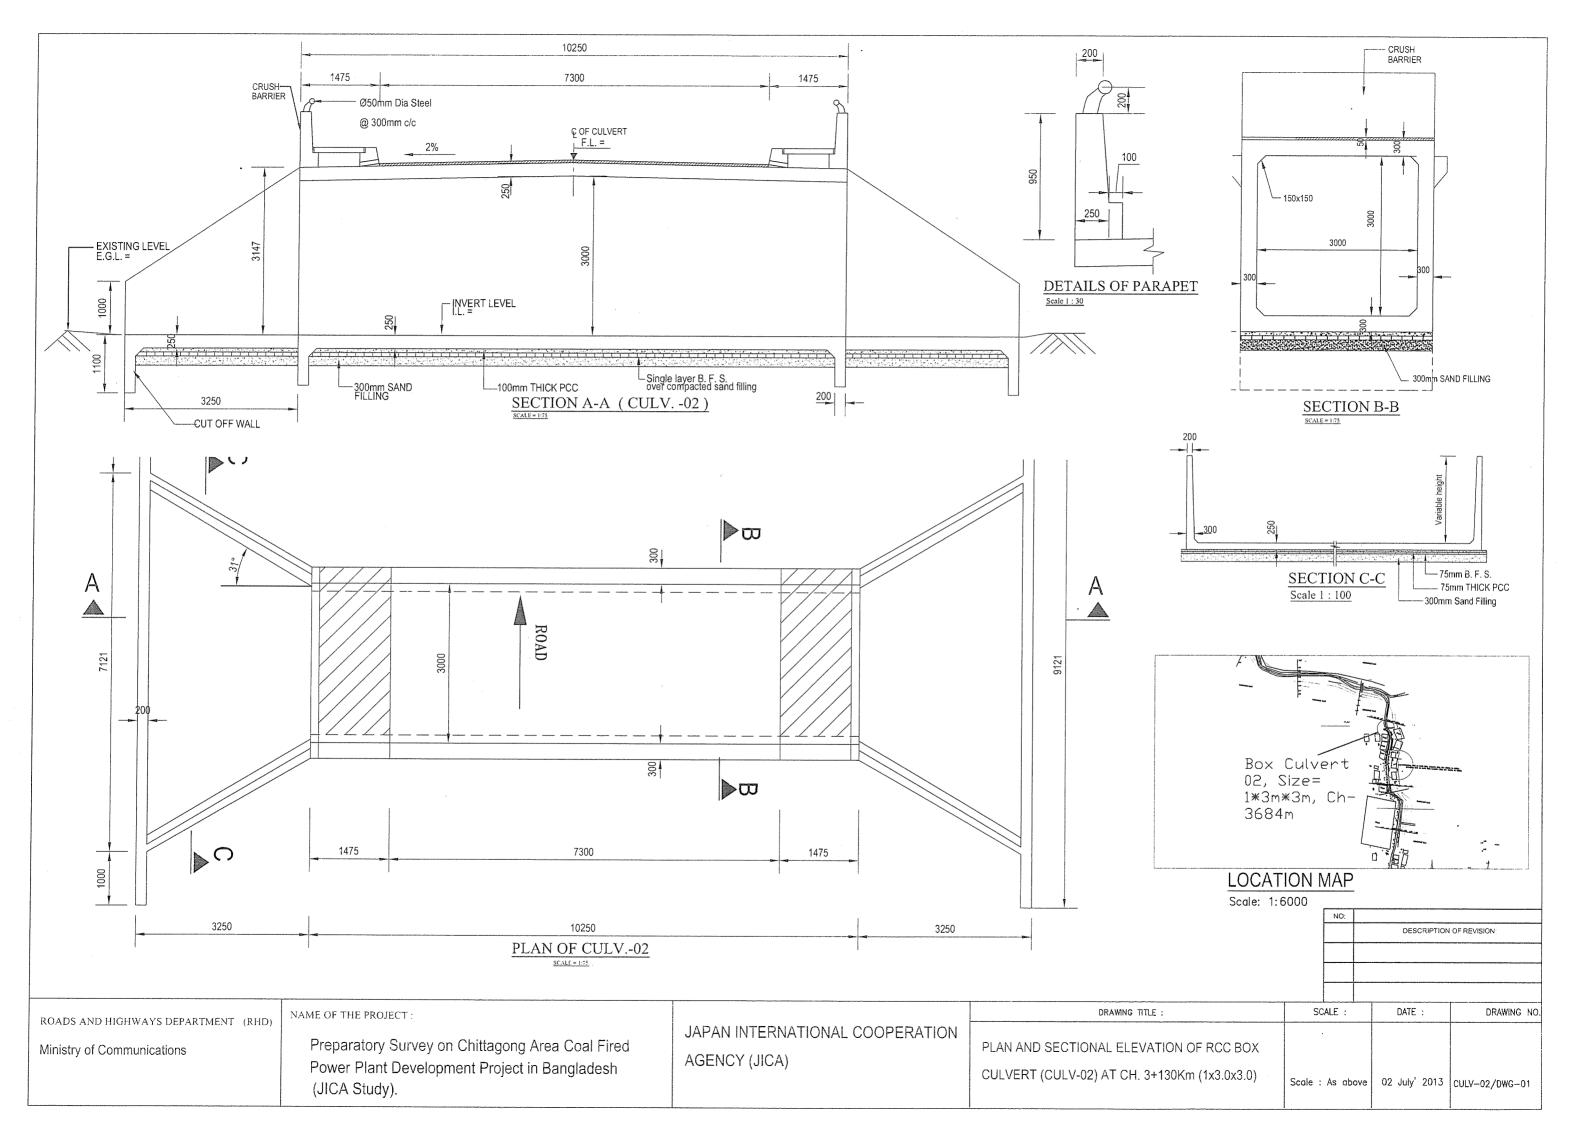
AUGUST, 2013


CS/DWG-53 of 54

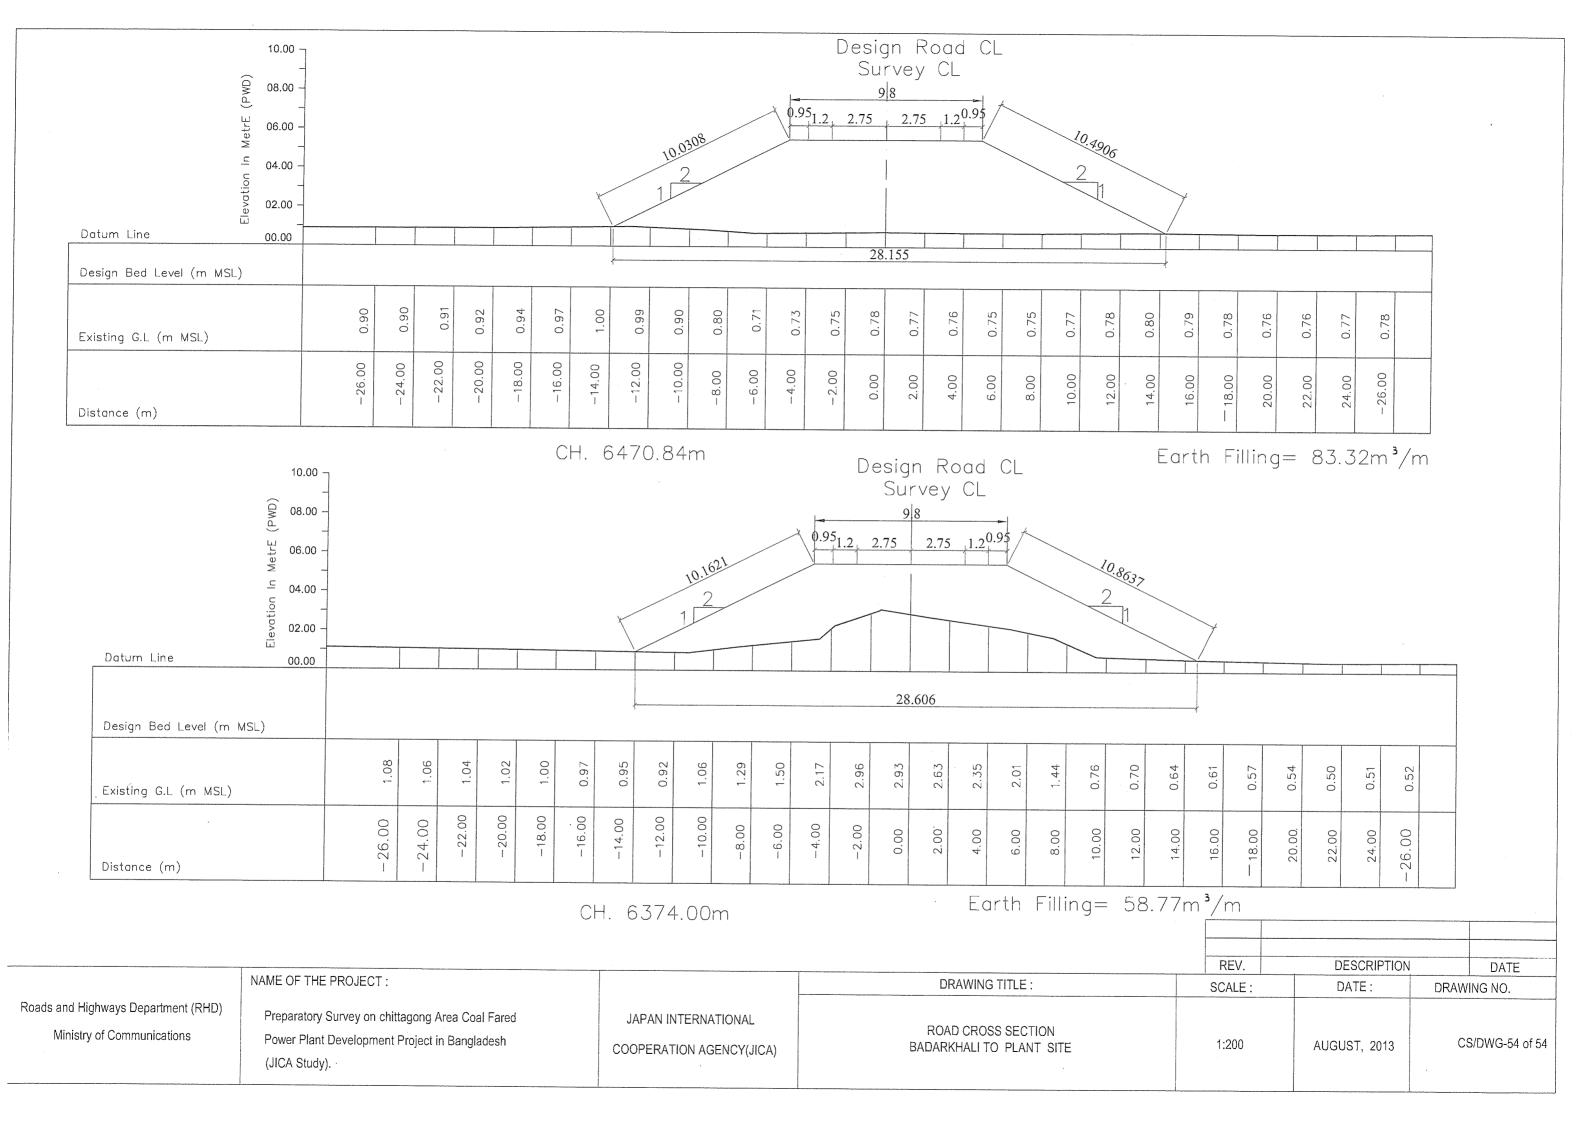



CULVERT AND ROAD ANCILLARY STRUCTURES




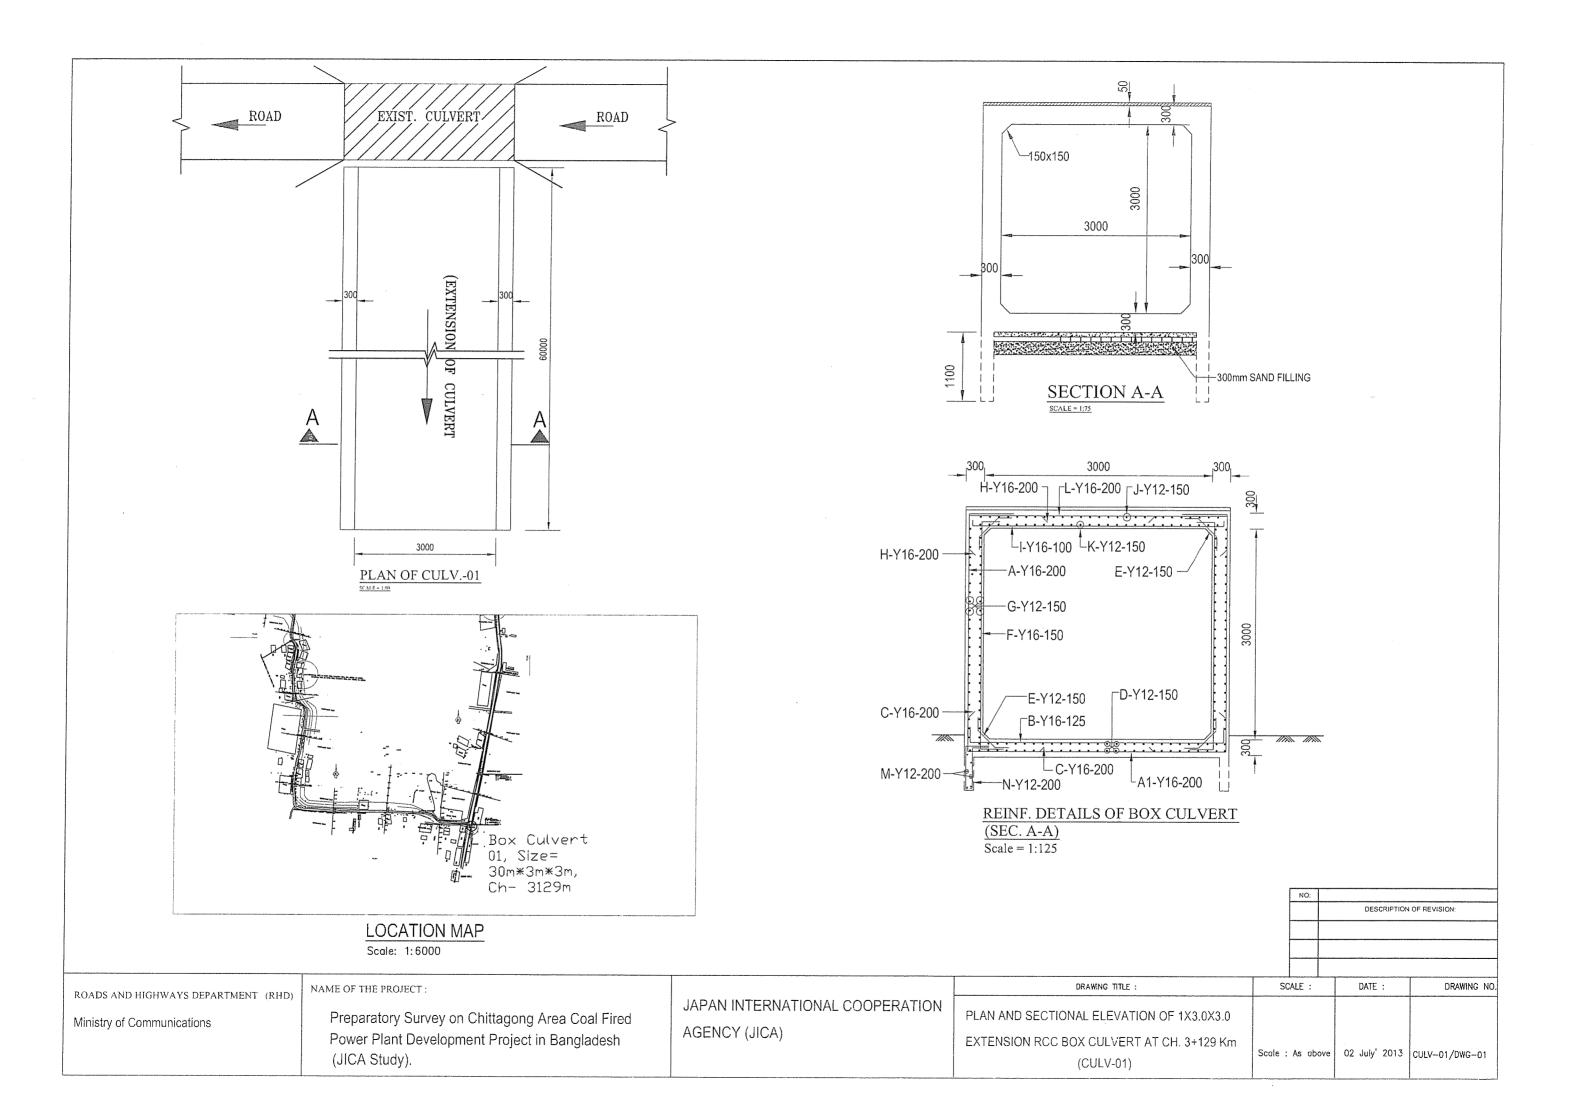


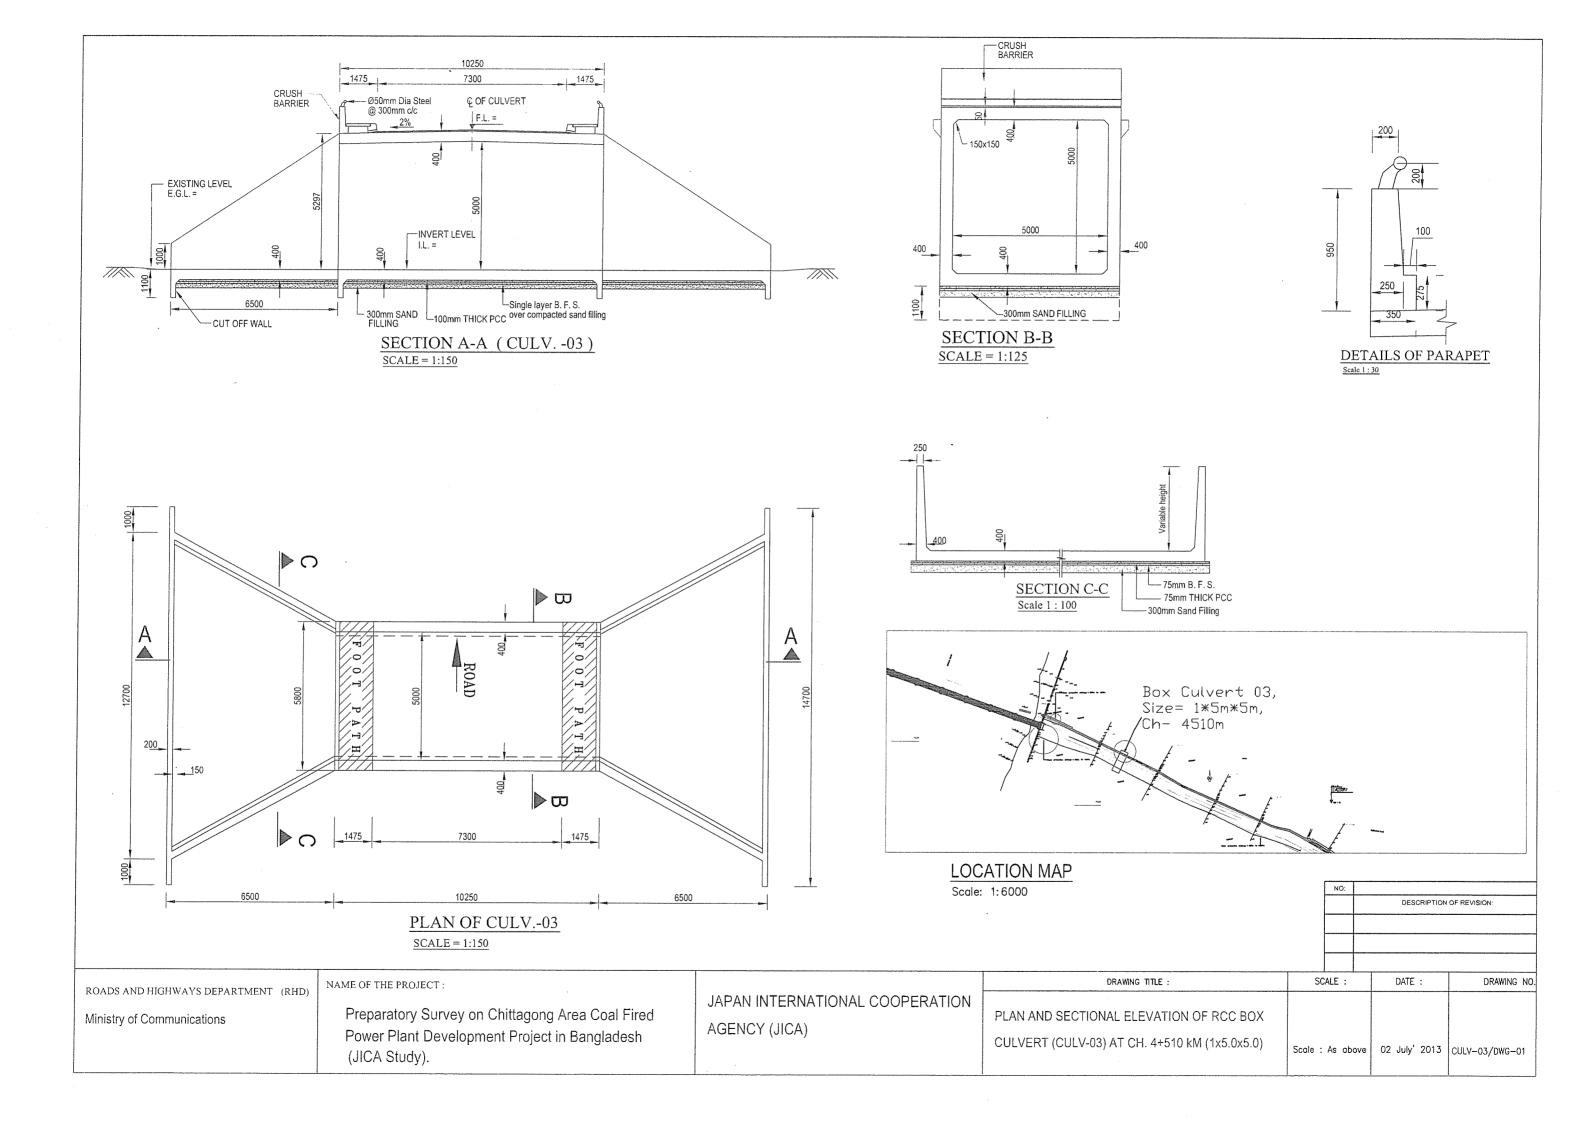


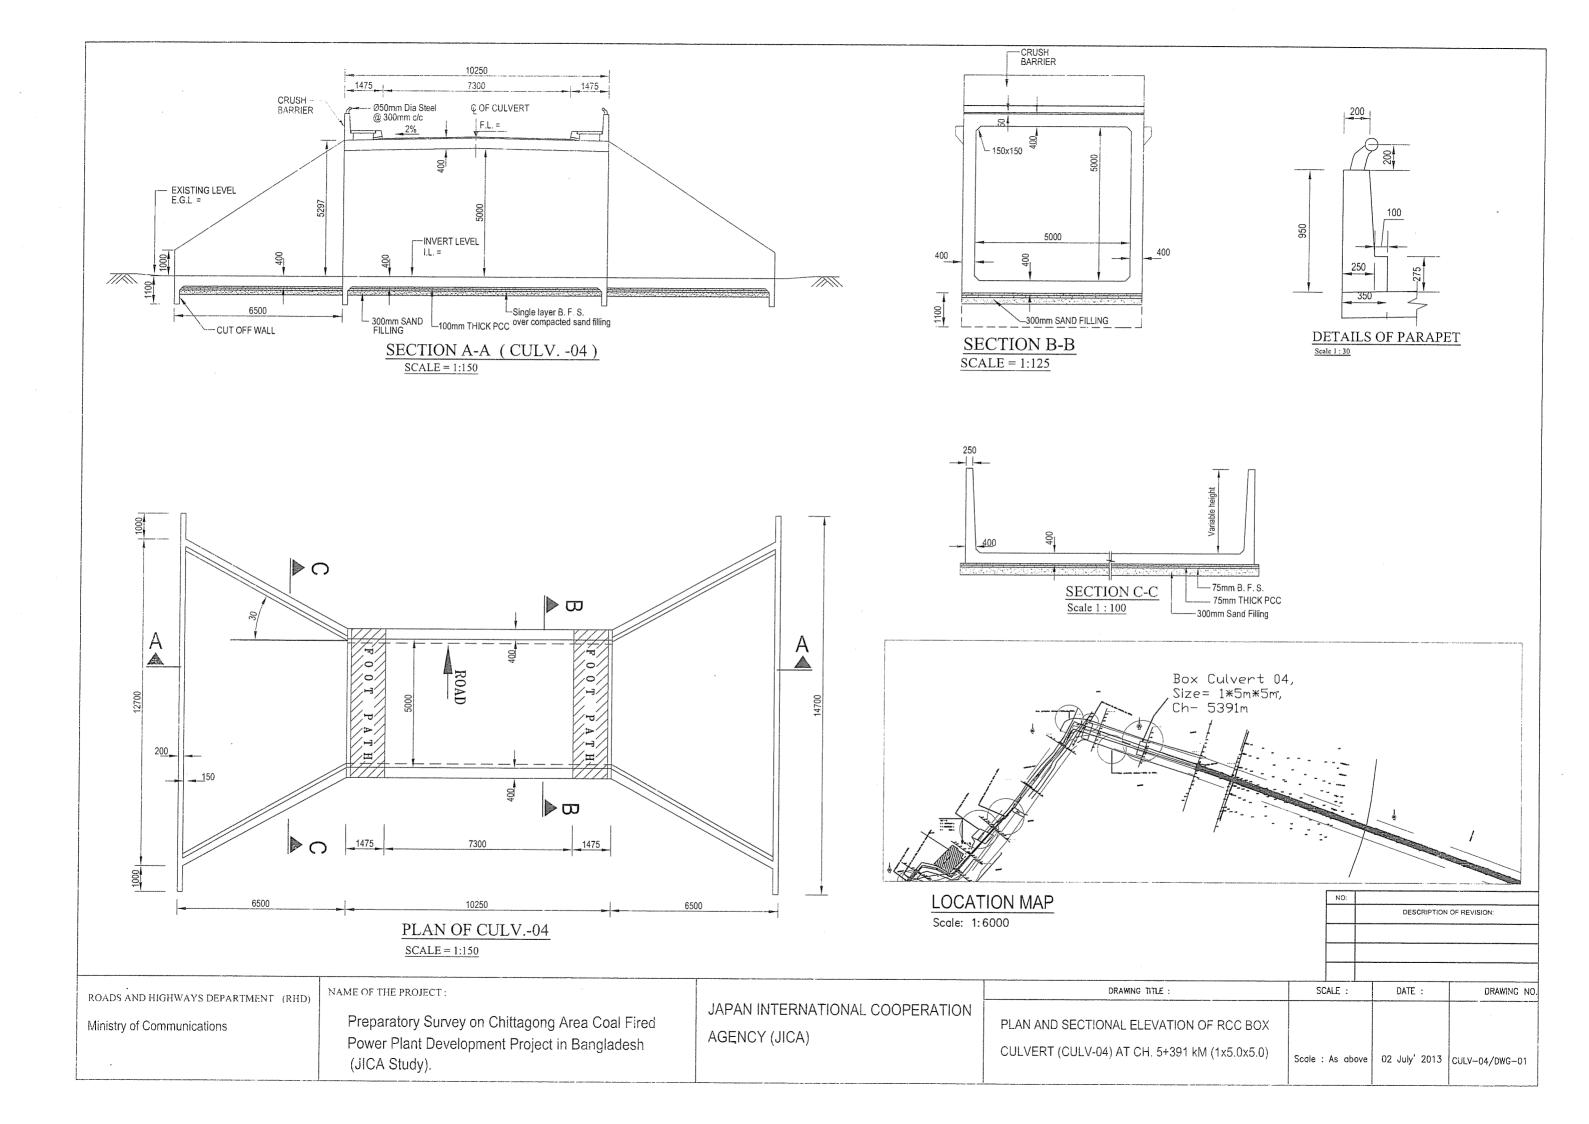


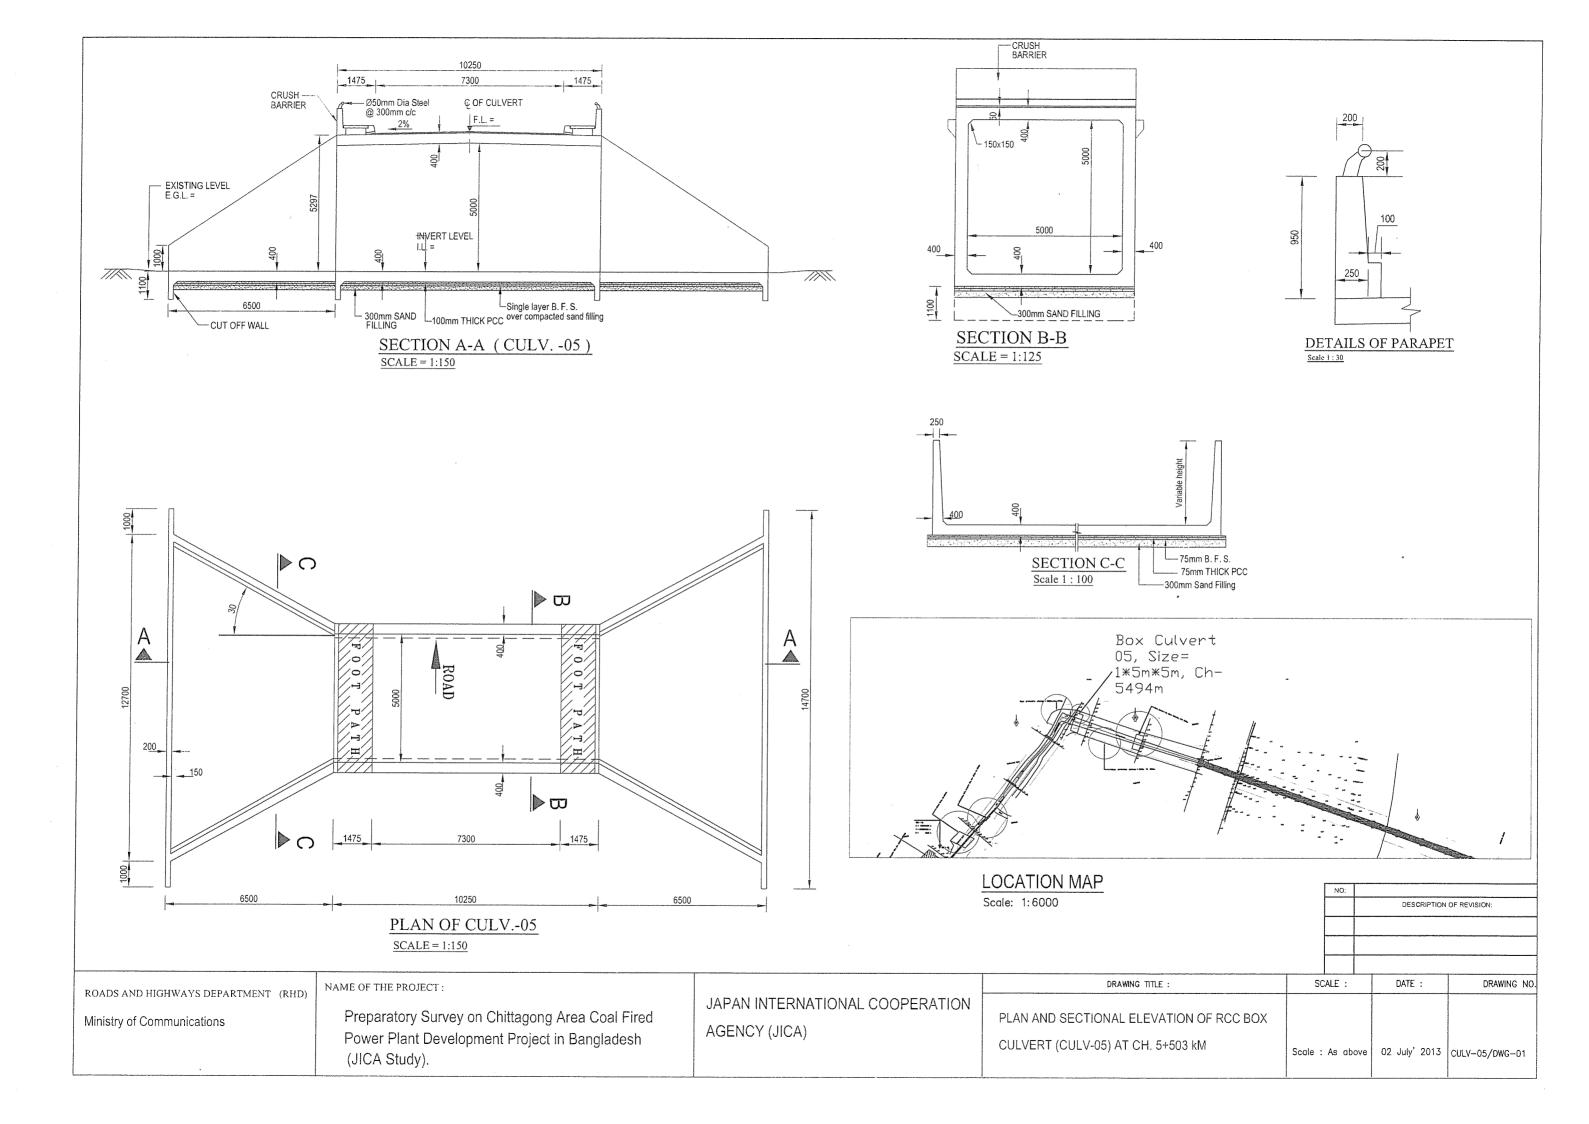


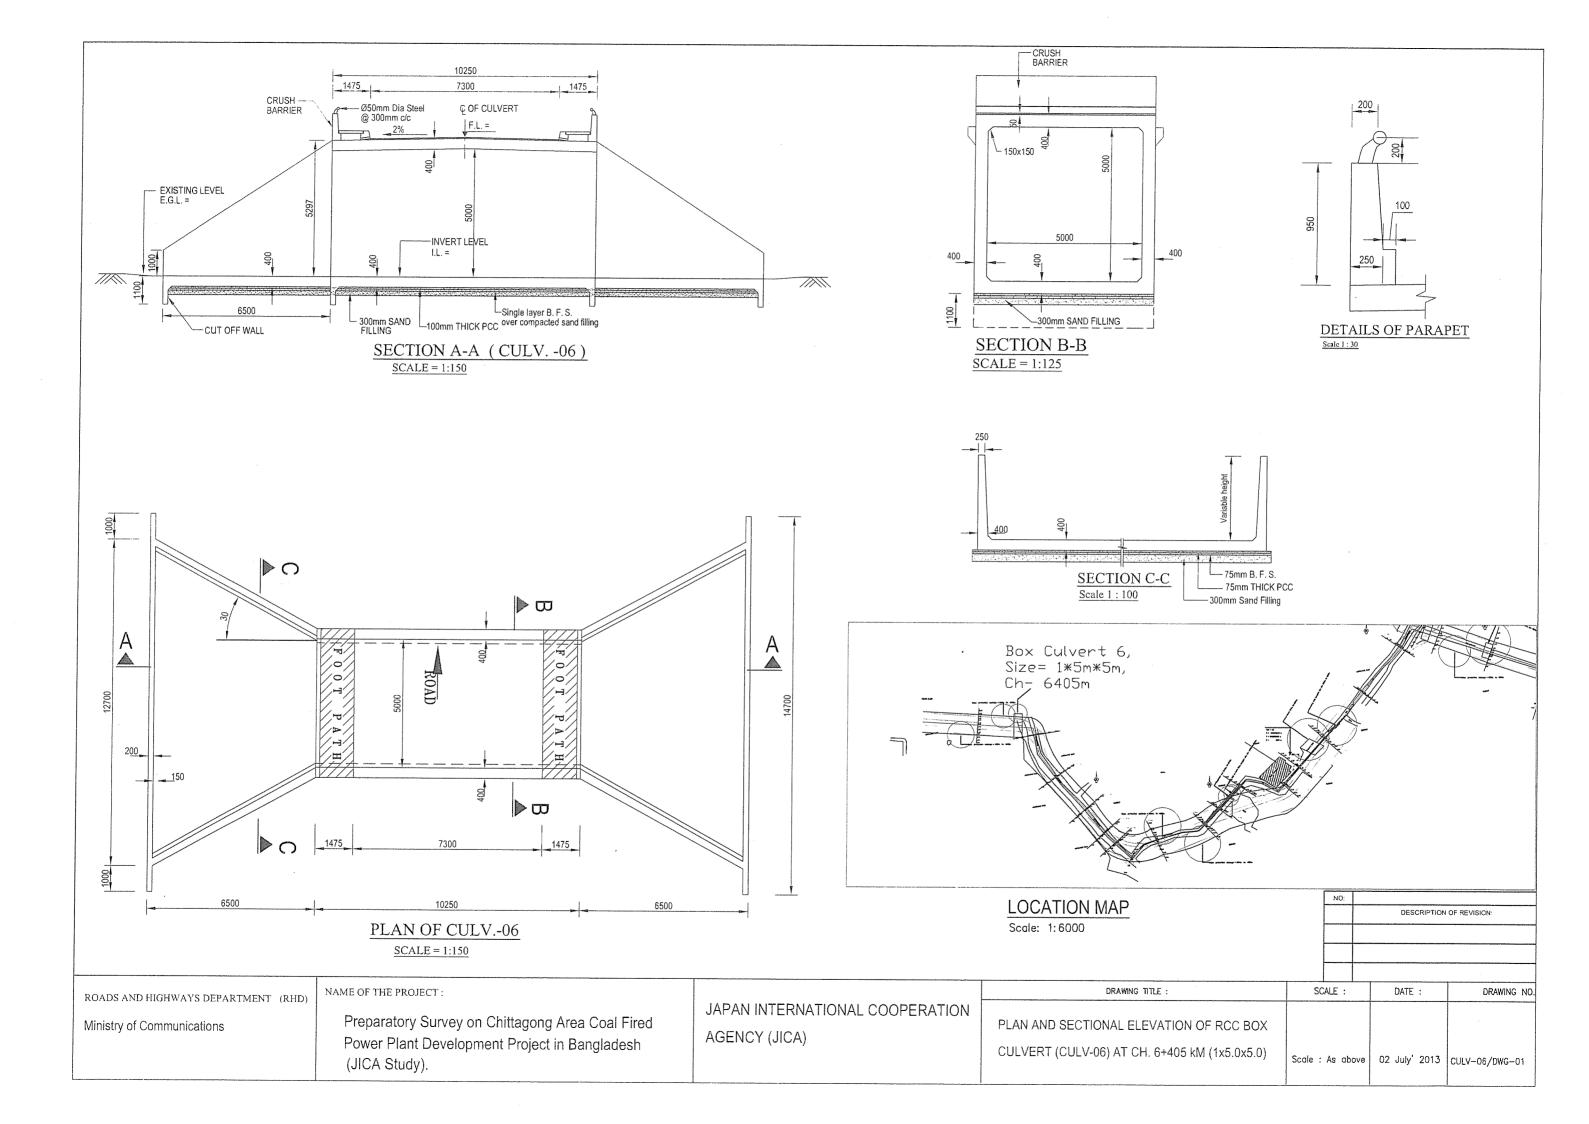

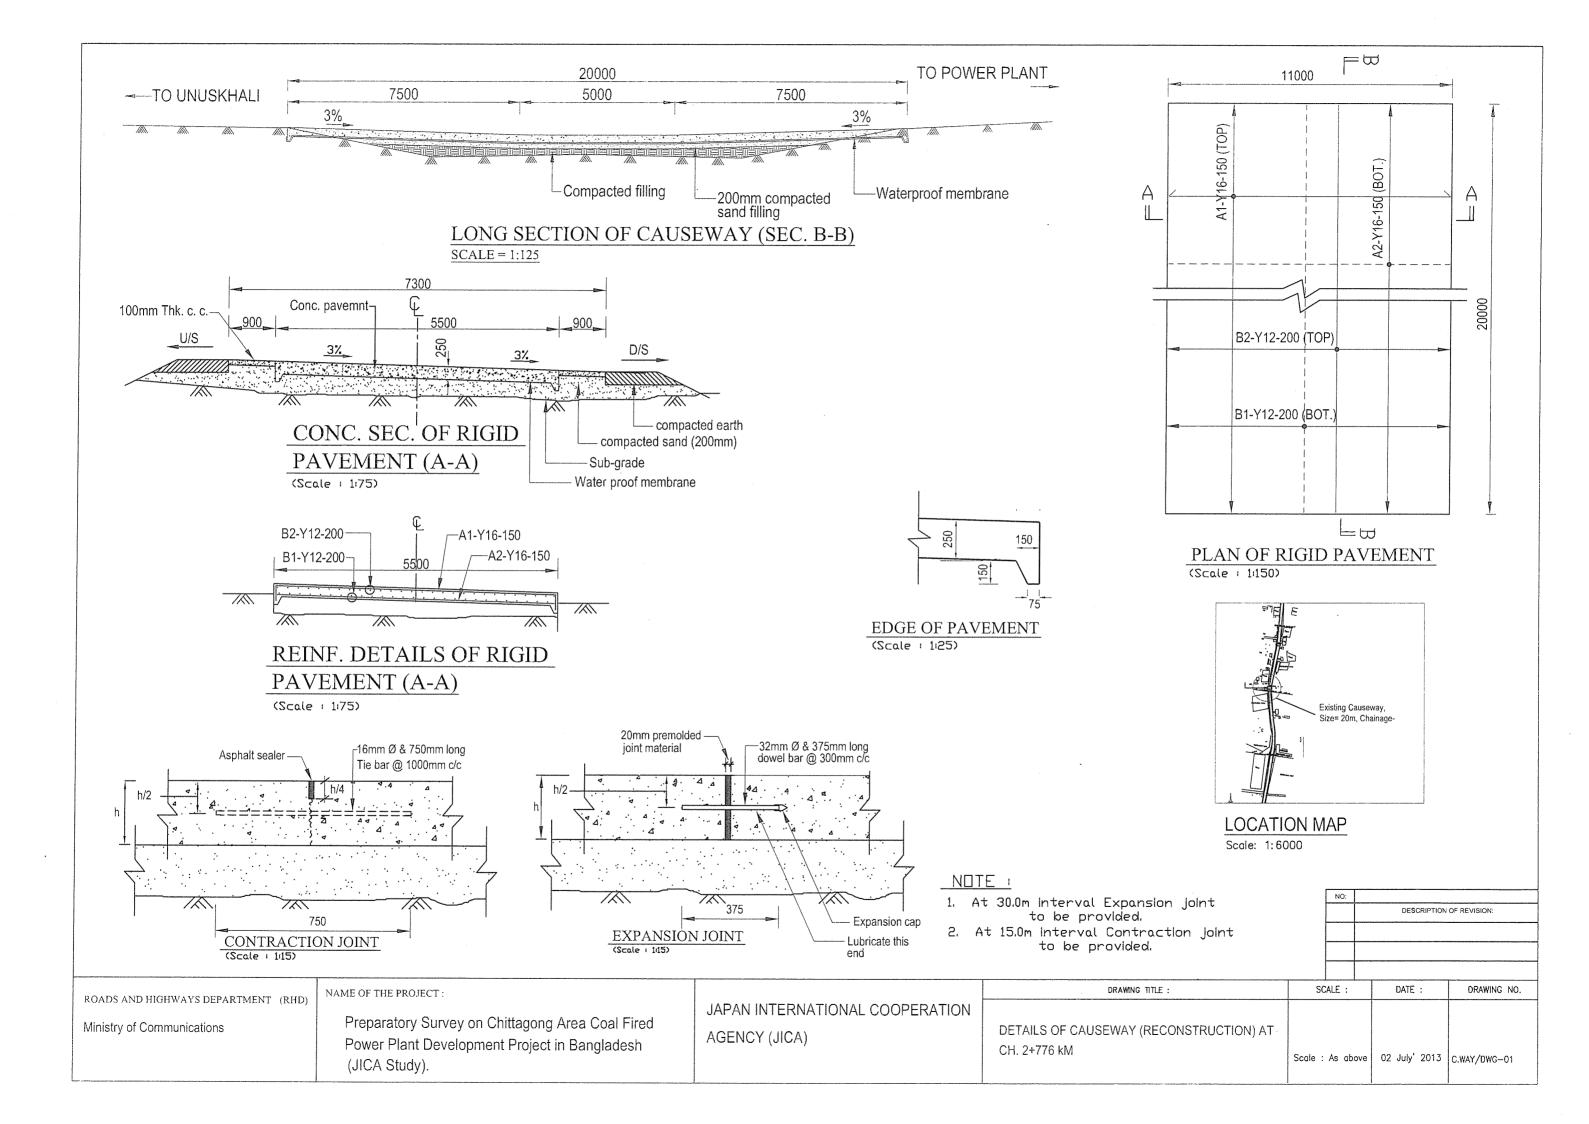

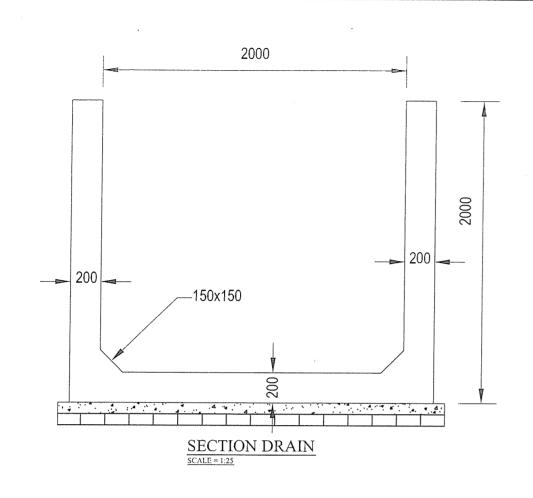

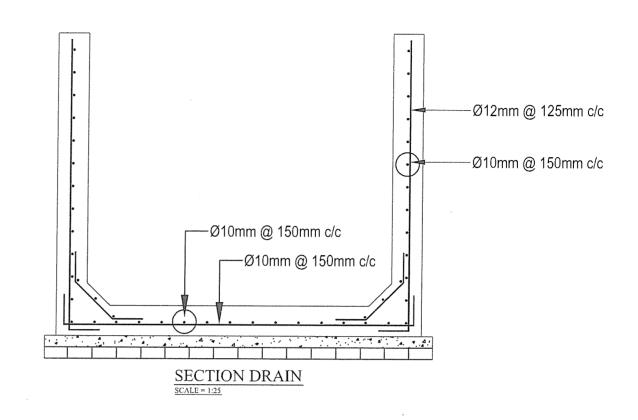

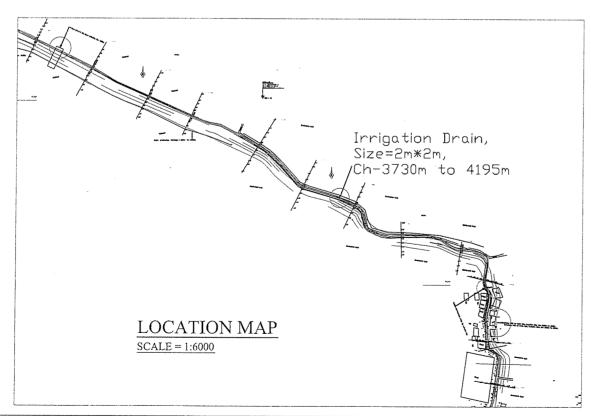

NOTE:

- 1. Length of Irrigation drain = 465.0m
- 2. For steel, fy = 276 Mpa
- 3. For concrtel, fc = 21 Mpa

DESCRIPTION OF REVISION:

DRAWING NO.

ROADS AND HIGHWAYS DEPARTMENT (RHD)


Ministry of Communications

NAME OF THE PROJECT :


Preparatory Survey on Chittagong Area Coal Fired Power Plant Development Project in Bangladesh (JICA Study).

JAPAN INTERNATIONAL COOPERATION AGENCY (JICA)

DRAWING TITLE : SCALE : DATE: SECTION OF IRRIGATION DRAIN (2.0m x2.0m) FROM CH. 3+730KkM TO 4+195kM Scale : As above 02 July 2013 IRRI-DR/DWG-01

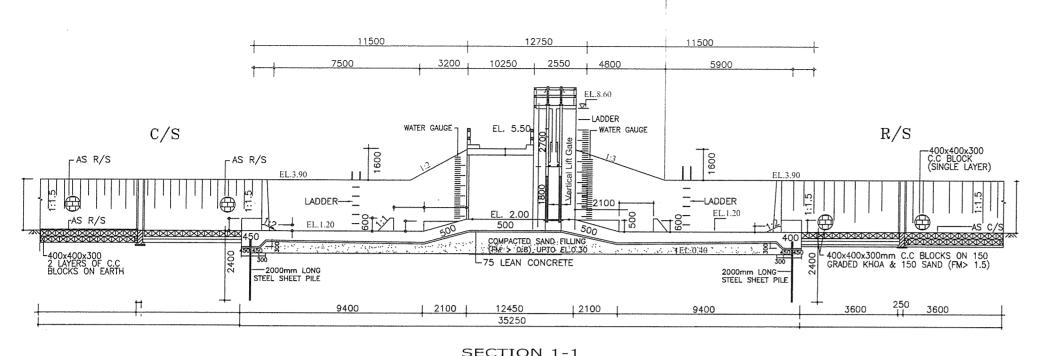

SECTION 1-1

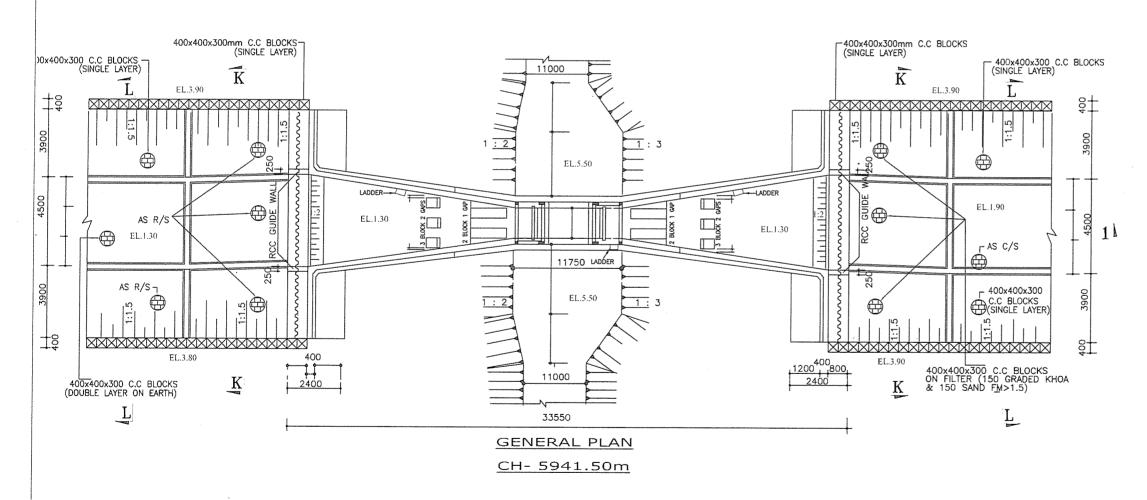

SPECIFIC	CATION & NOTES	ON MATERIAL	& WORK	
1. R.C.C WORKS: A. Concrete : i) Strength:	All R.C.C WORKS 28—days standard cylinder crushing strength shall be 17 N/mm²	R.C.C PILES 28—days standard cylinder crushing strength shall be 20.7 N/mm²	LEAN CONCRETE	
ii) Proportion by volume	1:2:4	1:1.5:3	1:3:6	
iii) Cement	Portland Type—1	Portland Type-1	Portland Type-1	
iv) Coorse aggregate	20mm down graded crushed stone chips (Well graded between 20mm & 8mm size.)	20mm down graded crushed stone chips (Well graded between 20mm & 8mm size.)		
v) Sond	FM 1.80	FM 1.80	FM 1.00	
vi) Slump: (at work)			60-75 mm	
B. Reinforcement	60 grade deformed M.S. bor	60 grade deformed M.S. bar	1	
	Minimum yield strength 414 N/mm ²	Same as in all R.C.C Works		
No hook should be used for M.S deformed bars.				

2. Clear concrete cover over reinforcement bars shall be :

Earth faces = Water faces = 50mm All other faces = 25mm R.C.C Piles = 40mm

3. Brick bolcks : 1st closs bricks in 1:6 cement morter with sand (FM 1.00)

4. Back filling : Back filling outside obutments, wing walls and return walls up to FGL shall be done simultaneously on both sides with lacal sandy soil and should be free fram vegetable roots and other organic materials, as soon as wall lifts are constructed.

5. Foundation

Treatment : Faundation treatment to be done by sand filling up to 0.00m PWD (will be reviewed after subsoil investigation results are obtained)

6. Strength During pouring samples shall be collected by the cantractor in presence of Engineer—in—charge in standard cylinder, one for each wing wall, abutment, return wall, top slab, apron and barrel faundation for testing 7day strengths for quality control.

7. Protective work : Earthfill in side slopes shall be compacted in horizantal layers to satisfaction of the Engineer in charge before placing filter moterial and block.

8. Elevations : All elevations in this drawing are in meter (PWD).

9. Dimensions : All dimensions are in millimeters.

10. Embeded M.S embedded parts such as angles, channels for vertical gates Parts of and fram & wall brakets for flap gotes welded to anchor bars shall be installed in proper alignment during casting of concrete as shown in working drawing.

REV.	DESCRIPTION		DATE
SCALE:	DATE:	DRAWING NO.	

Roads and Highways Department (RHD) Ministry of Communications

Preparatory Survey on chittagong Area Coal Fared Power Plant Development Project in Bangladesh (JICA Study).

NAME OF THE PROJECT:

JAPAN INTERNATIONAL COOPERATION AGENCY(JICA)


Regulator


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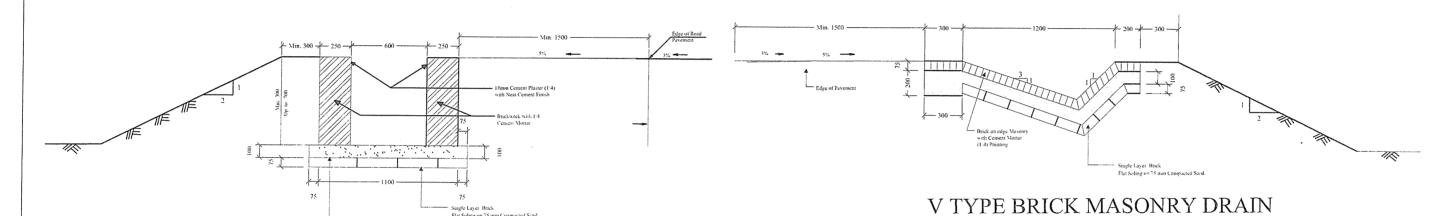
SCALE: 1:200

AUGUST, 2013


RG/DWG-01 of 02



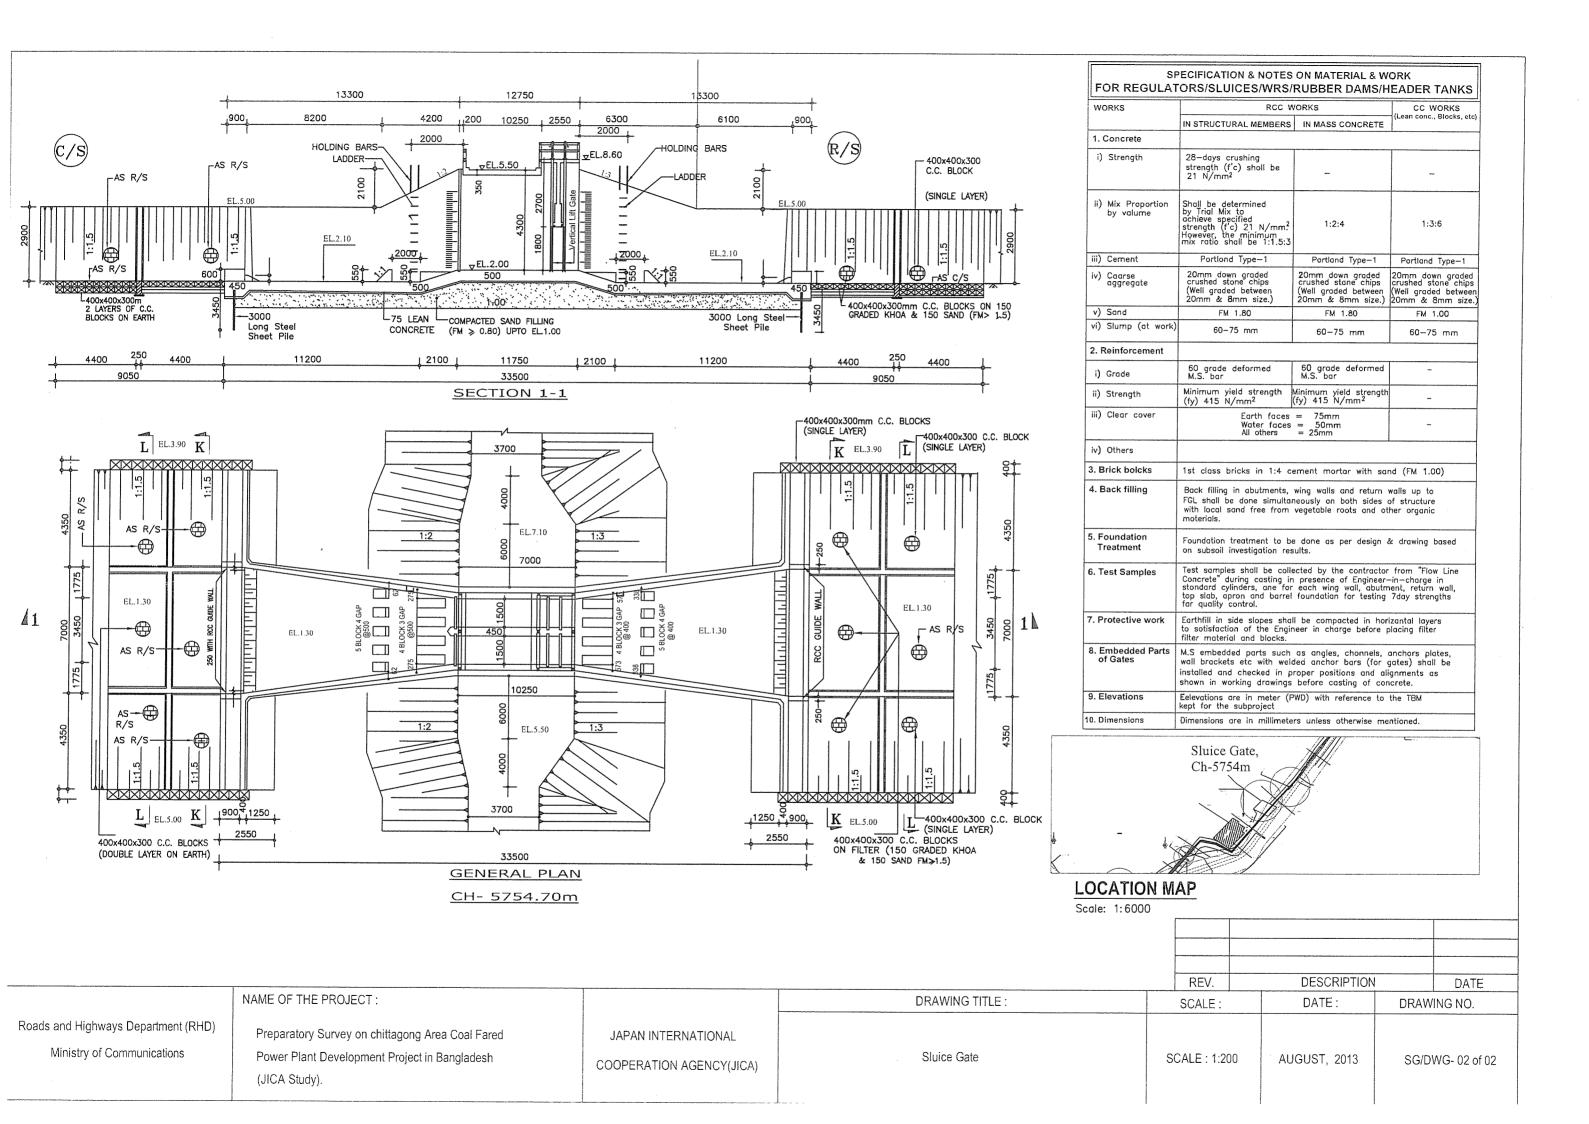

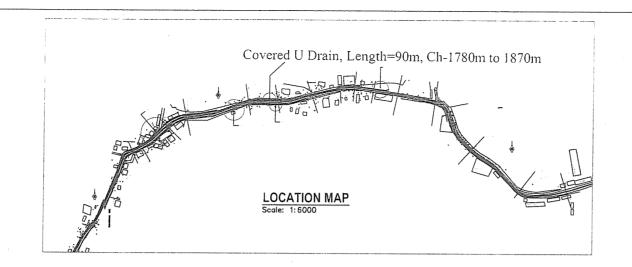

U TYPE BRICK MASONRY DRAIN

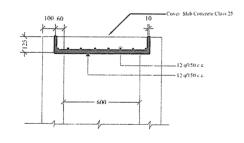


REINFORCEMENT DETAIL FOR COVER SLAB


 All dimensions are in mm unless otherwise specified.


Notes:

- 1. Subgrade under drains to be compacted to 98% MDD or as directed by the Engineer.
- 2. All drains to be laid to a longitudinal fall of not lass than 1:300 with a positive outfall to a water course.
- 3. Open "U" drains to be located as far as possible from road edge.

	NAME OF THE PROJECT :		DRAWING TITLE :	REV.	DESCRIPTION DATE:	DATE DRAWING NO.
Roads and Highways Department (RHD) Ministry of Communications	Preparatory Survey on chittagong Area Coal Fared Power Plant Development Project in Bangladesh (JICA Study).	JAPAN INTERNATIONAL COOPERATION AGENCY(JICA)	Saucer Drain, Side Ditch and Side Ditch (Lined)	SCALE : 1:30	AUGUST, 2013	SDR/DWG- 01 of 04

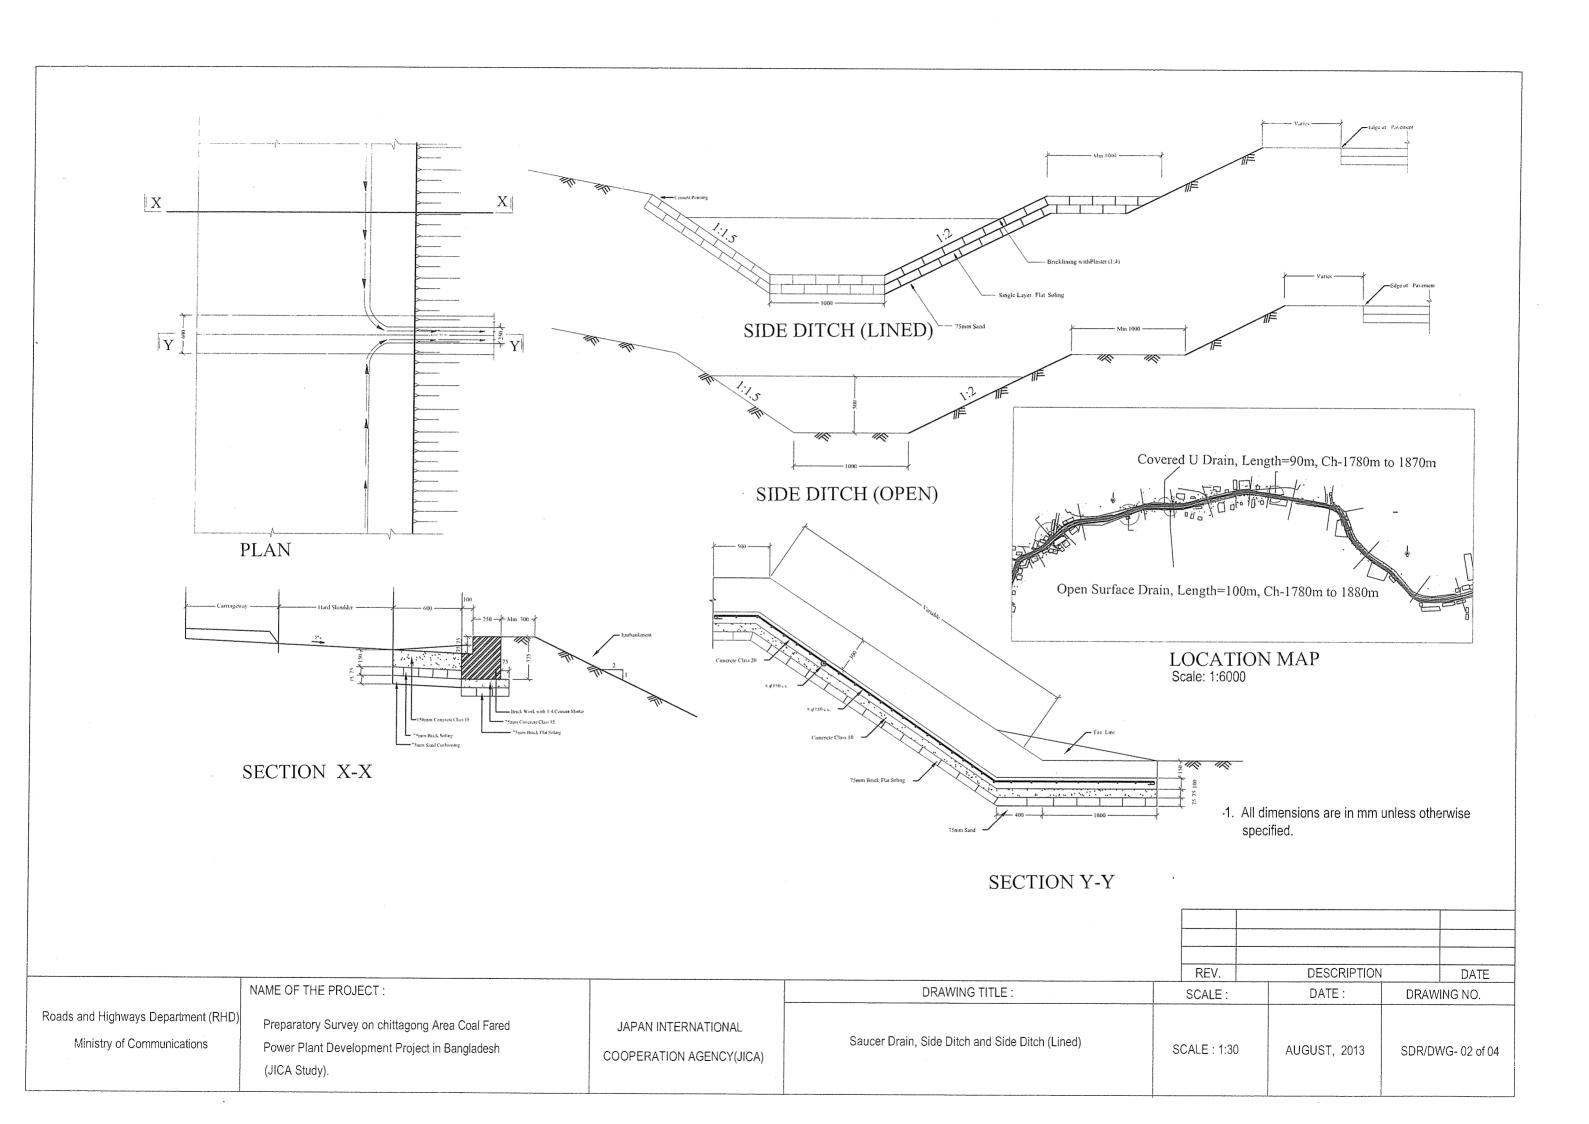


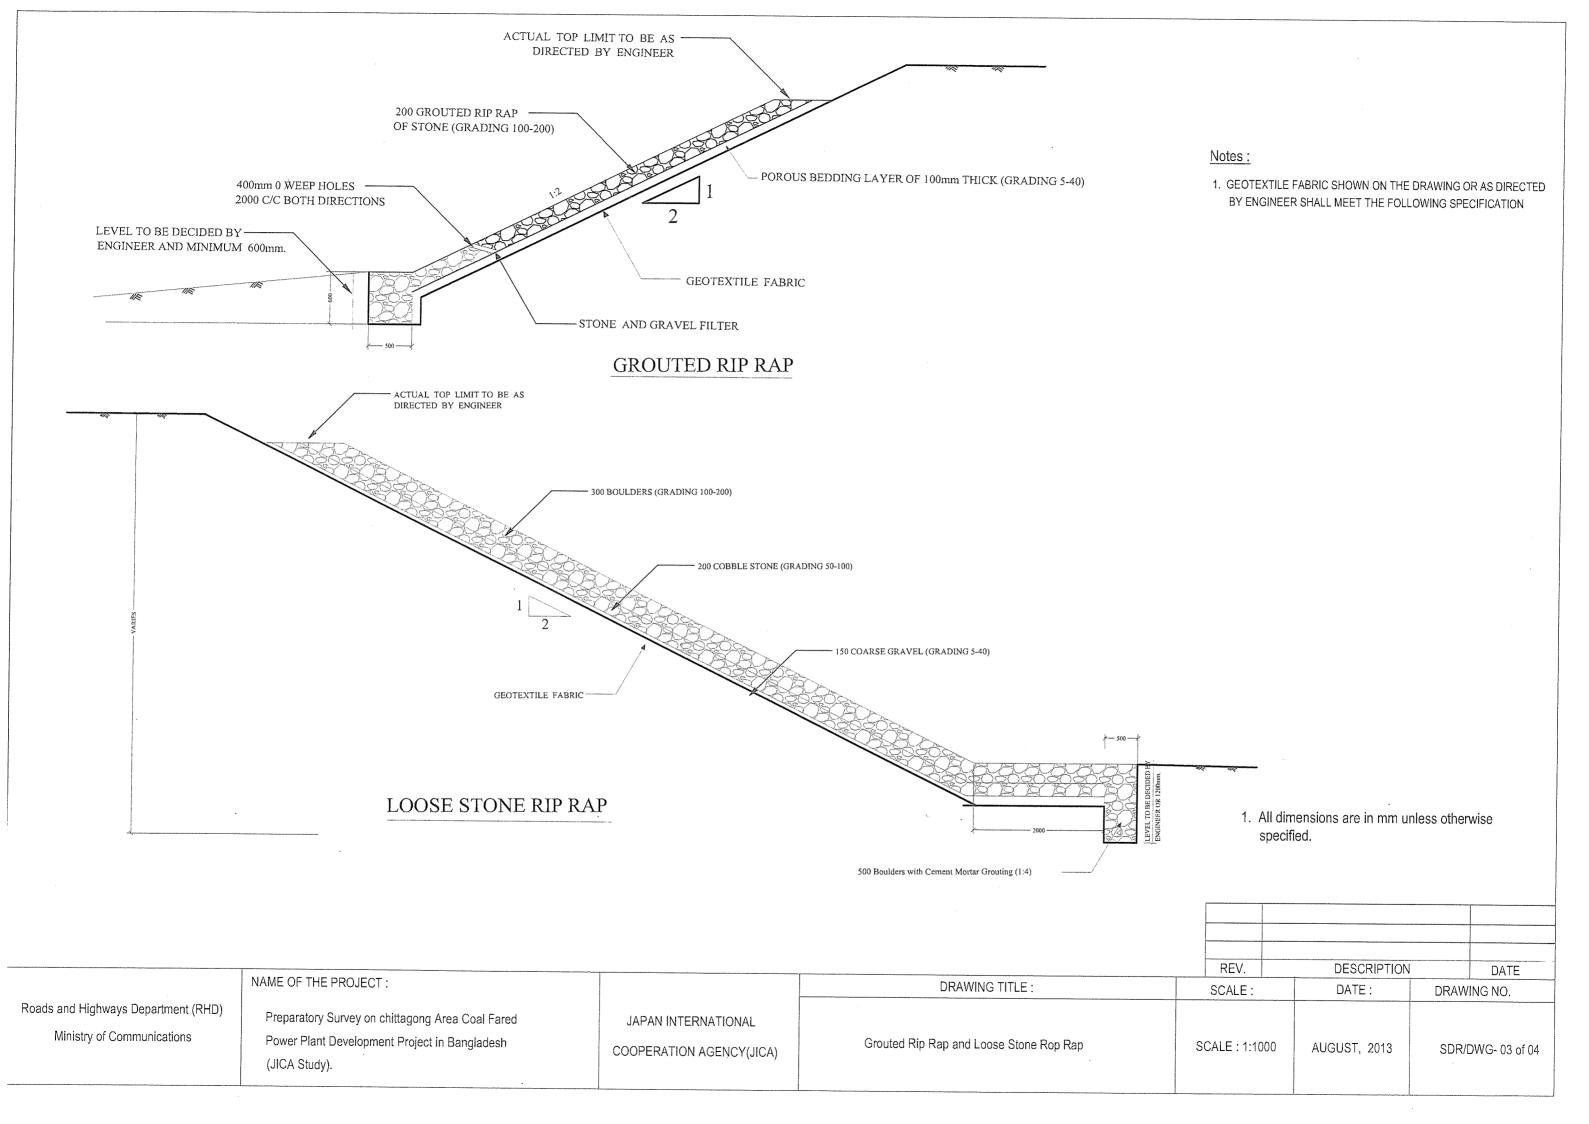

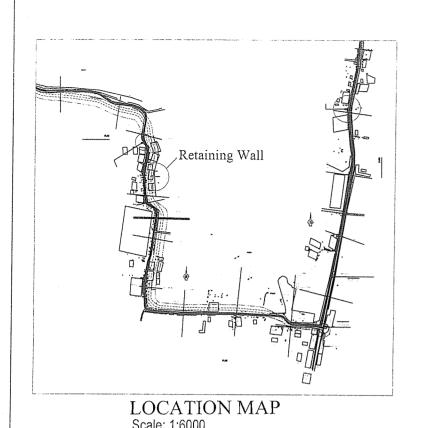


Dimension		H<25 0 0				
	1500	2500	Compute as Follows			
b1	100	210	(H-600) x 0.11			
 b2	200	440	(H-650) x 0.24			
b3	600	950	b1+b2+300			
В	1300	1650	b3+700			

Precast Concrete Block Concrete

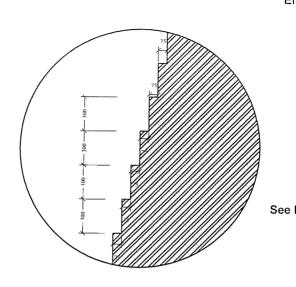

DETAIL OF A

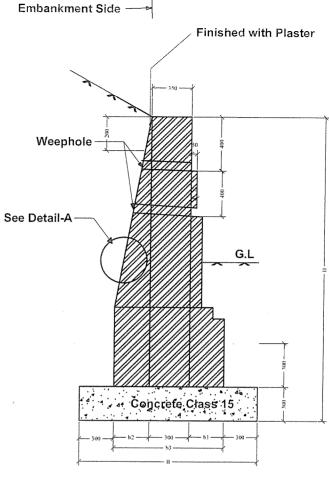

BRICK MASONRY TOE WALL

Notes:

For Toe Wall

- 1. All brick masonry work shall be done in 1:3 cementmar mortar.
- 2. Weep holes shall be provided as per specification and shall be provided one per 1.5m.square of vertical area unless directed by the engineer. Their spacing shall be staggered
- 3. Applicable only where subgrade > 5%

Scale: 1:6000	*/	Class 20	~~5888888888	R
	× 400 1 100			
Gabion N	llesh hored to Embankment Slope	300		2000
1	-2000x2000x75mm Gabion Mesh	2200		2200
Where D				
by Engir	neer	2000	Xwaraa .	

EMBANKMENT SLOPE PROTECTION (CONCRETE BLOCKS)

1. All dimensions are in mm unless otherwise specified.

CBR.

	p			REV.	DESCRIPTION	DATE
	NAME OF THE PROJECT :		DRAWING TITLE :	SCALE:	DATE:	DRAWING NO.
Roads and Highways Department (RHD) Ministry of Communications	Preparatory Survey on chittagong Area Coal Fared Power Plant Development Project in Bangladesh (JICA Study).	JAPAN INTERNATIONAL COOPERATION AGENCY(JICA)	Roadside Drainage	SCALE: 1:30	AUGUST, 2013	SDR/DWG- 04 of 0


GENERAL NOTES FOR THE CONSTRUCTION OF REINFORCED CONCRETE (RCC) GHAT


 CEMENT ORDINARY PORTLAND CEMENT TYPE-1(ASTM-C150-86) a) SETTING TIME : INITIAL SETTING TIME: NOT LESS THAN 45 MINUTES FINAL SETTING TIME : NOT MORE THAN 8 HOURS b) STRENGTH COMPRESSIVE STRENGTH 50mm CUBE SPECIMEN AS PER ASTM-C150-86 07 DAYS STRENGTH : 19.30 Mpa (2800 psi). 2. REINFORCEMENT a) STRENGTH YIELD STRENGTH (fy) OF MILD STEEL DEFORMED BAR SHALL NOT BE LESS THAN 410 N/sq.mm (60000 psi) AND THE STEEL SHOULD CONFORM ASTM-A615-88 & EQUIVALENT. b) SPLICES IN REINFORCEMENT -SPLICES IN REINFORCEMENT IF NECESSARY SHALL BE MADE ONLY AS APPROVED BY THE ENGINEER-IN-CHARGE. -SPLICES IN REINFORCEMENT OF MAXIMUM STRESS IN SLABS, BEAMS AND GIRDERS SHOULD BE AVOIDED. C) LAP LENGTH i) FOR TENSION M.S. DEFORMED BAR - 40 BAR DIAMETER WITHOUT HOOKS ii) FOR COMPRESSION M.S. DEFORMED BAR - 30 BAR DIAMETER WITHOUT HOOKS 3. CONCRETE i) FOR PILE CAP, ABUTMENT & WINGWALL, PIER, GIRDER, DIAPHRAGM, DECK SLAB, RAIL POSTS AND HAND RAILS. 28 DAYS STANDARD CYLINDER CRUSHING STRENGTH, fc = 25 N/sq.mm (3600 psi) ii) FOR RCC PRECAST PILES. 28 DAYS STANDARD CYLINDER CRUSHING STRENGTH, fc = 25 N/sq.mm (3600 psi) YIELD STRENGTH OF M.S. DEFORMED BAR, fy = 410 N/sq.mm (60,000 psi) FOR PRECAST PILE MIX RATIO BY VOLUME, CEMENT:SAND:COARSE AGGREGATE: 1:1.5:3 iii) FOR RCC CAST-IN-SITU PILES. 28 DAYS STANDARD CYLINDER CRUSHING STRENGTH, fc = 25 N/sq.mm (3600 psi) YIELD STRENGTH OF M.S. DEFORMED BAR, fy = 410 N/sq.mm (60,000 psi)

4. MINIMUM CLEAR COVER TO MAIN REINFORCEMENT: a) FOR ROOF SLAB AND BUILDING : 20mm b) FOR DECK SLAB TOP REINF. :50 mm BOTTOM REINF. : 25 mm c) FOR GIRDER, DIAPHRAGM AND PIER CAP **BOTTOM BAR** :40 mm SIDE :40 mm d) FOR RETAINING WALL EARTH FACE : 50 mm when form work is used WATER FACE :50 mm when form work is used e) PILE CAP **BOTTOM** : 50 mm above pile cut-off level OTHER FACES : 50 mm f) MEMBERS CAST AGAINST AND PERMANENTLY EXPOSED TO NON-SALINE WATER / SOIL : 75 mm g) MEMBERS PERMANENTLY EXPOSED TO SALINE WATER / SOIL : 100 mm 5. MIXER MACHINE AND VIBRATOR MUST BE USED IN ALL RCC CASTING. CONSTRUCTION JOINTS IN ADDITION TO THE PLACES SHOWN IN THE DRAWING SHALL BE PROVIDED AS PER DIRECTION OF THE ENGINEER-IN-CHARGE. 7. ALL DIMENSIONS ARE IN MILLIMETER UNLESS OTHERWISE MENTIONED. 8. COARSE AGGREGATE 20 mm down graded stone chips in accordance with BS882 or equivalent.


- SAND FILLING MUST BE MECHANICALLY COMPECTED AND COMPACTION SHALL BE OF 95% MDD (MODIFIED)
- FOR HANDLING /OR LIFTING OF PRECAST PILE 25mm ~50mm DIAMETER TOGGLE HOLES REQUIRD AND THEIR LOCATION ARE AT 0.206L FROM EITHER END, WERE L=LENGTH OF PILE.


				REV.	DESCRIPT	TION DATE
ROADS AND HIGHWAYS DEPARTMENT (RHD)	NAME OF THE PROJECT :		DRAWING TITLE :	SCALE :	DATE :	DRAWING NO.
Ministry of Communications	Preparatory Survey on Chittagong Area Coal Fired Power Plant Development Project in Bangladesh (JICA Study).	JAPAN INTERNATIONAL COOPERATION AGENCY (JICA)	GENERAL NOTES OF RCC WORK	Scale : N.T.S.	Sept' 2013	BRDG/GEN/DWG-01

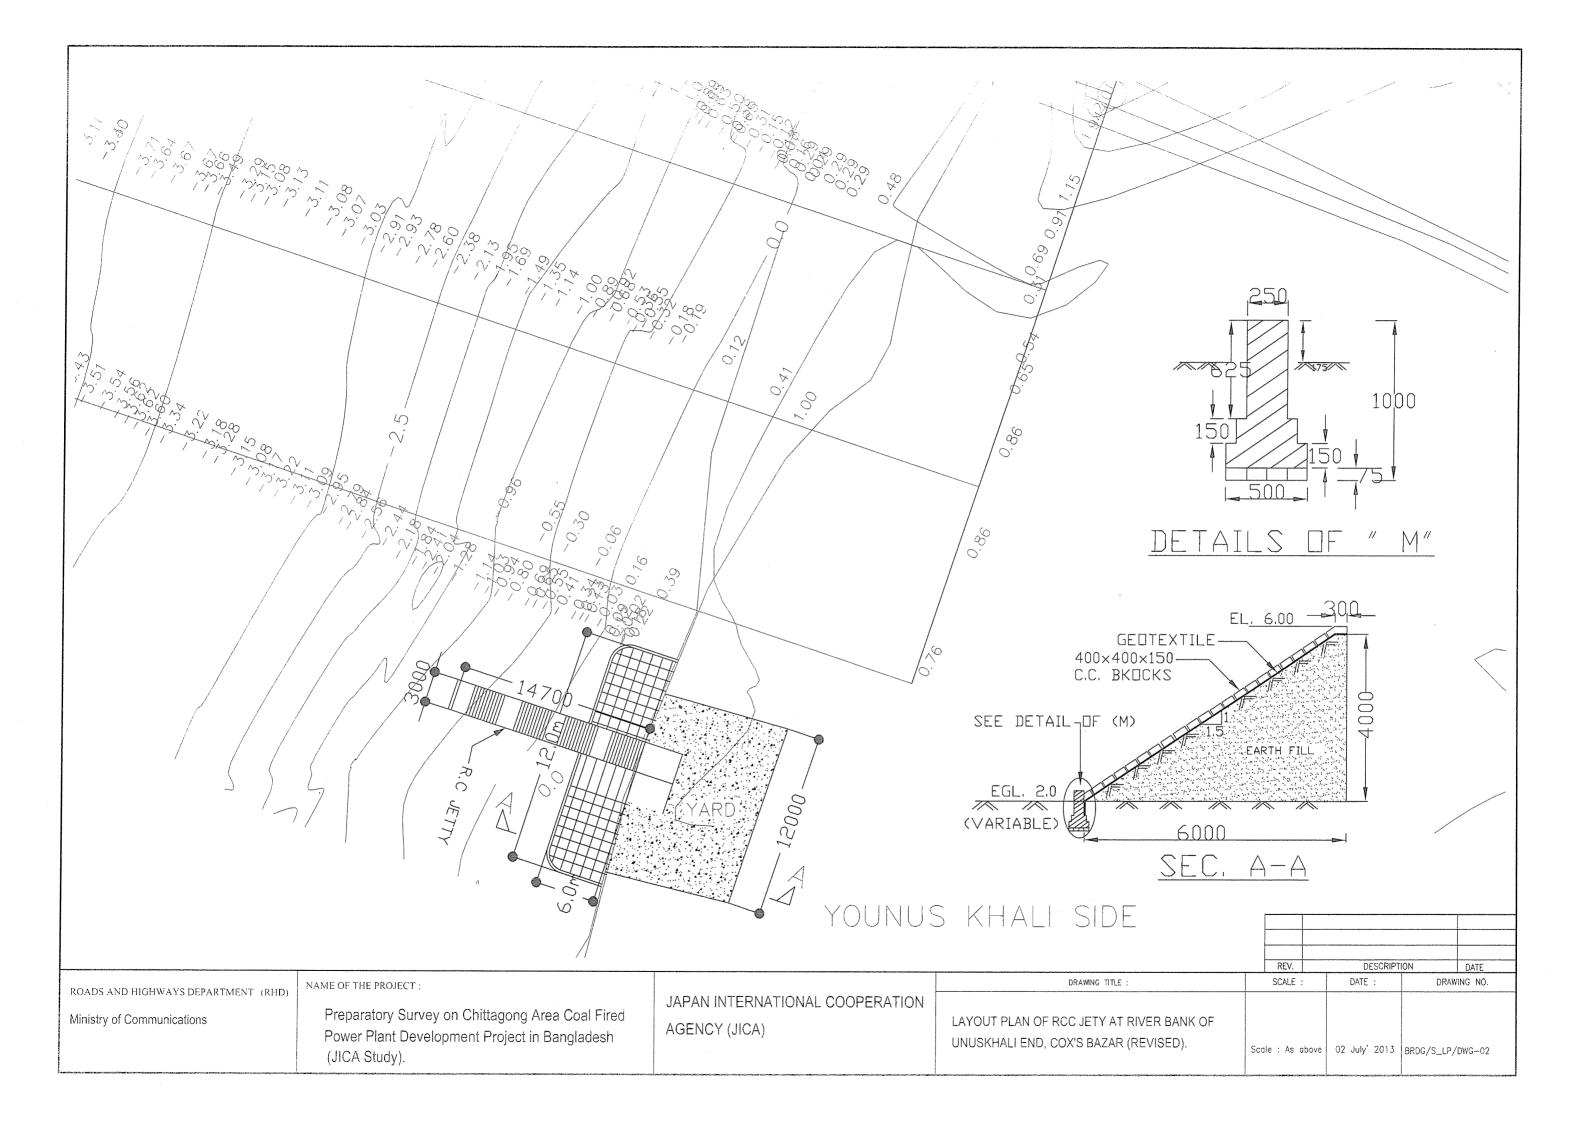


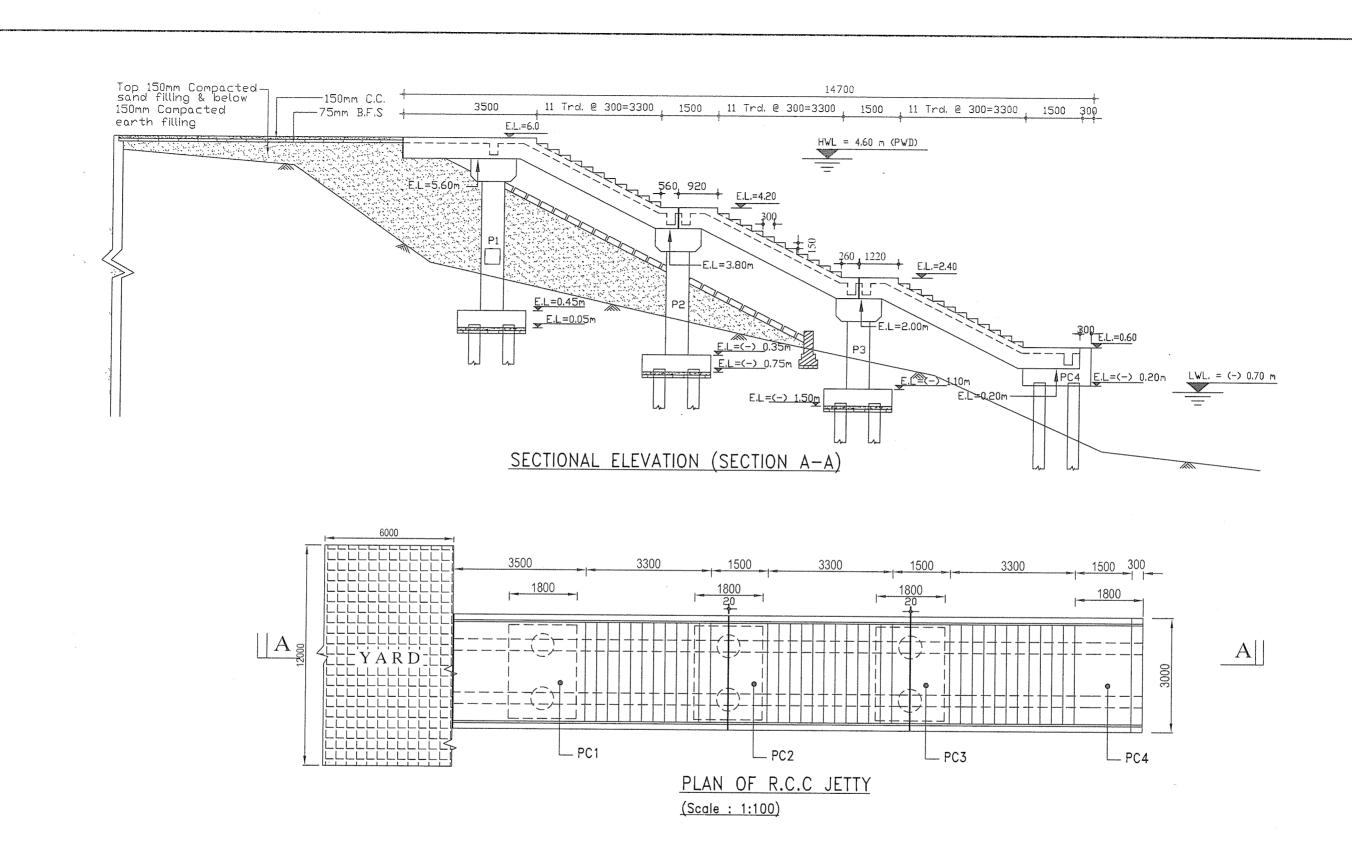


				REV.	DESCRIF	PTION DATE
ROADS AND HIGHWAYS DEPARTMENT (RHD)	NAME OF THE PROJECT :		DRAWING TITLE :	SCALE :	DATE :	DRAWING NO.
Ministry of Communications	Preparatory Survey on Chittagong Area Coal Fired Power Plant Development Project in Bangladesh (JICA Study).	JAPAN INTERNATIONAL COOPERATION AGENCY (JICA)	PLAN & SECTIONAL ELEVATION OF RCC JETY (REVISED)	Scale : As above	Sept' 2013	BRDG/P_ELV/DWG-03

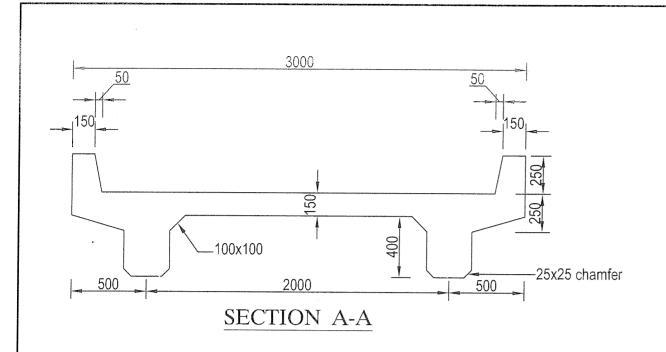

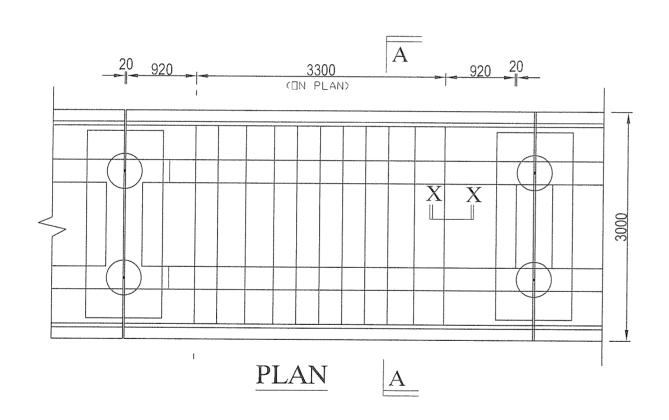

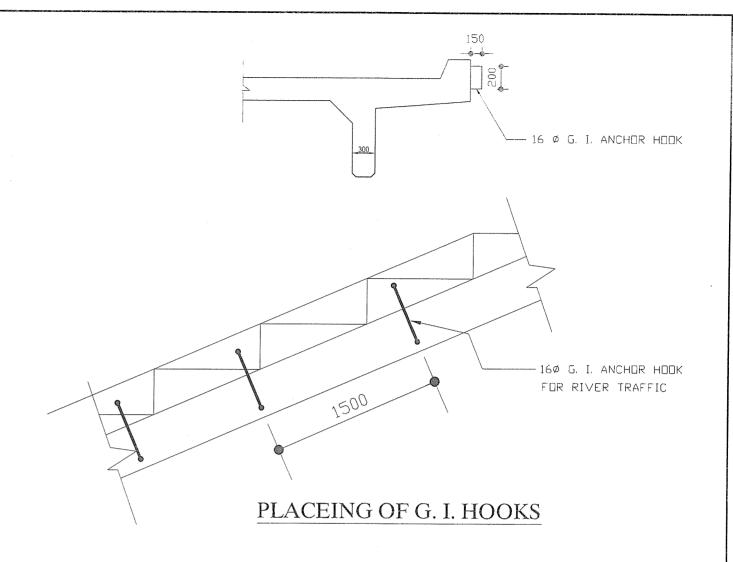

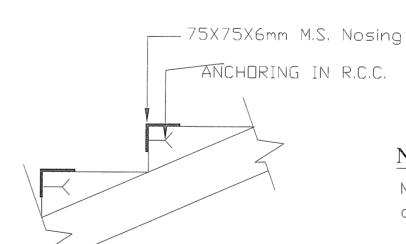


NOTE:


M.S Nosing to be provided on all edges of step

SEC. X-X
PLACING OF M.S. NOSING

		<u>~</u>		REV.	DESCRIPT	ION DATE
ROADS AND HIGHWAYS DEPARTMENT (RHD)	NAME OF THE PROJECT :		DRAWING TITLE :	SCALE :	DATE :	DRAWING NO.
Ministry of Communications	Preparatory Survey on Chittagong Area Coal Fired Power Plant Development Project in Bangladesh (JICA Study).	JAPAN INTERNATIONAL COOPERATION AGENCY (JICA)	DETAILS OF DECK SECTION FOR RCC JETTY (REVISED)	Scale : As above	e 02 July' 2013	BRDG/DECK/DWG-04
To remove the second of the contract of the co	NOTIFIED AND AND ADDRESS OF THE PROPERTY OF TH					

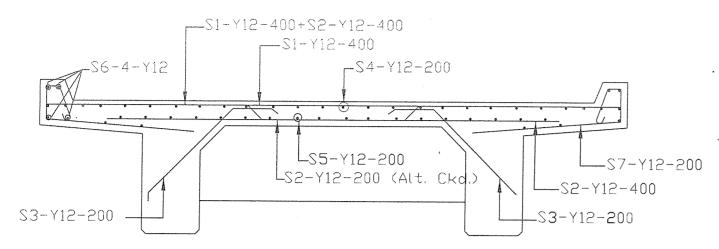

REINF. DETAIL OF SLAB

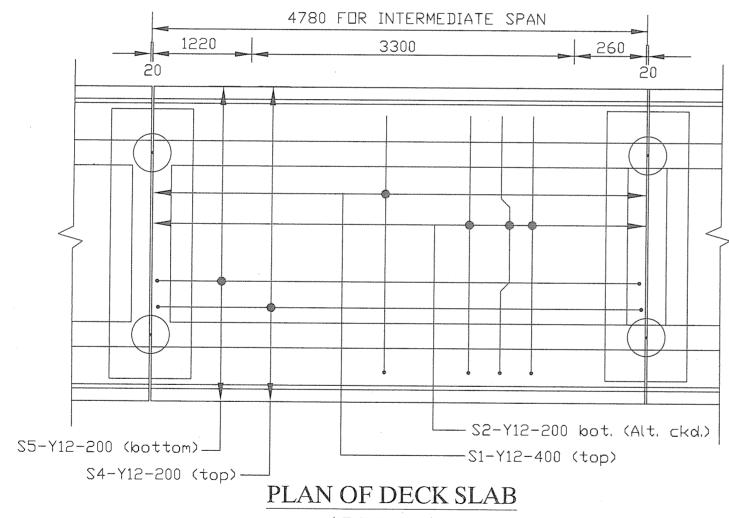

LEGEND:

S3-Y12-200 :

S3 : BAR MARK

Y12 : DIA OF DEFORMED BAR

200 : SPACING OF BAR IN MM

S6-4-Y12 :


S6 : BAR MARK


4 : NOS OF BAR


Y12 : DIA OF DEFORMED BAR


PLAN OF DECK SLAB
(REINF.)


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ROADS AND HIGHWAYS DEPARTMENT (RHD)	NAME OF THE PROJECT:		DRAWING TITLE :	SCALE :	DATE :	DRAWING NO.
Ministry of Communications	Preparatory Survey on Chittagong Area Coal Fired Power Plant Development Project in Bangladesh (JICA Study).	JAPAN INTERNATIONAL COOPERATION AGENCY (JICA)	REINF. DETAILS OF DECK SECTION FOR RCC JETTY (REVISED)	Scale : As above	sept' 2013	BRDG/DECK/DWG-05

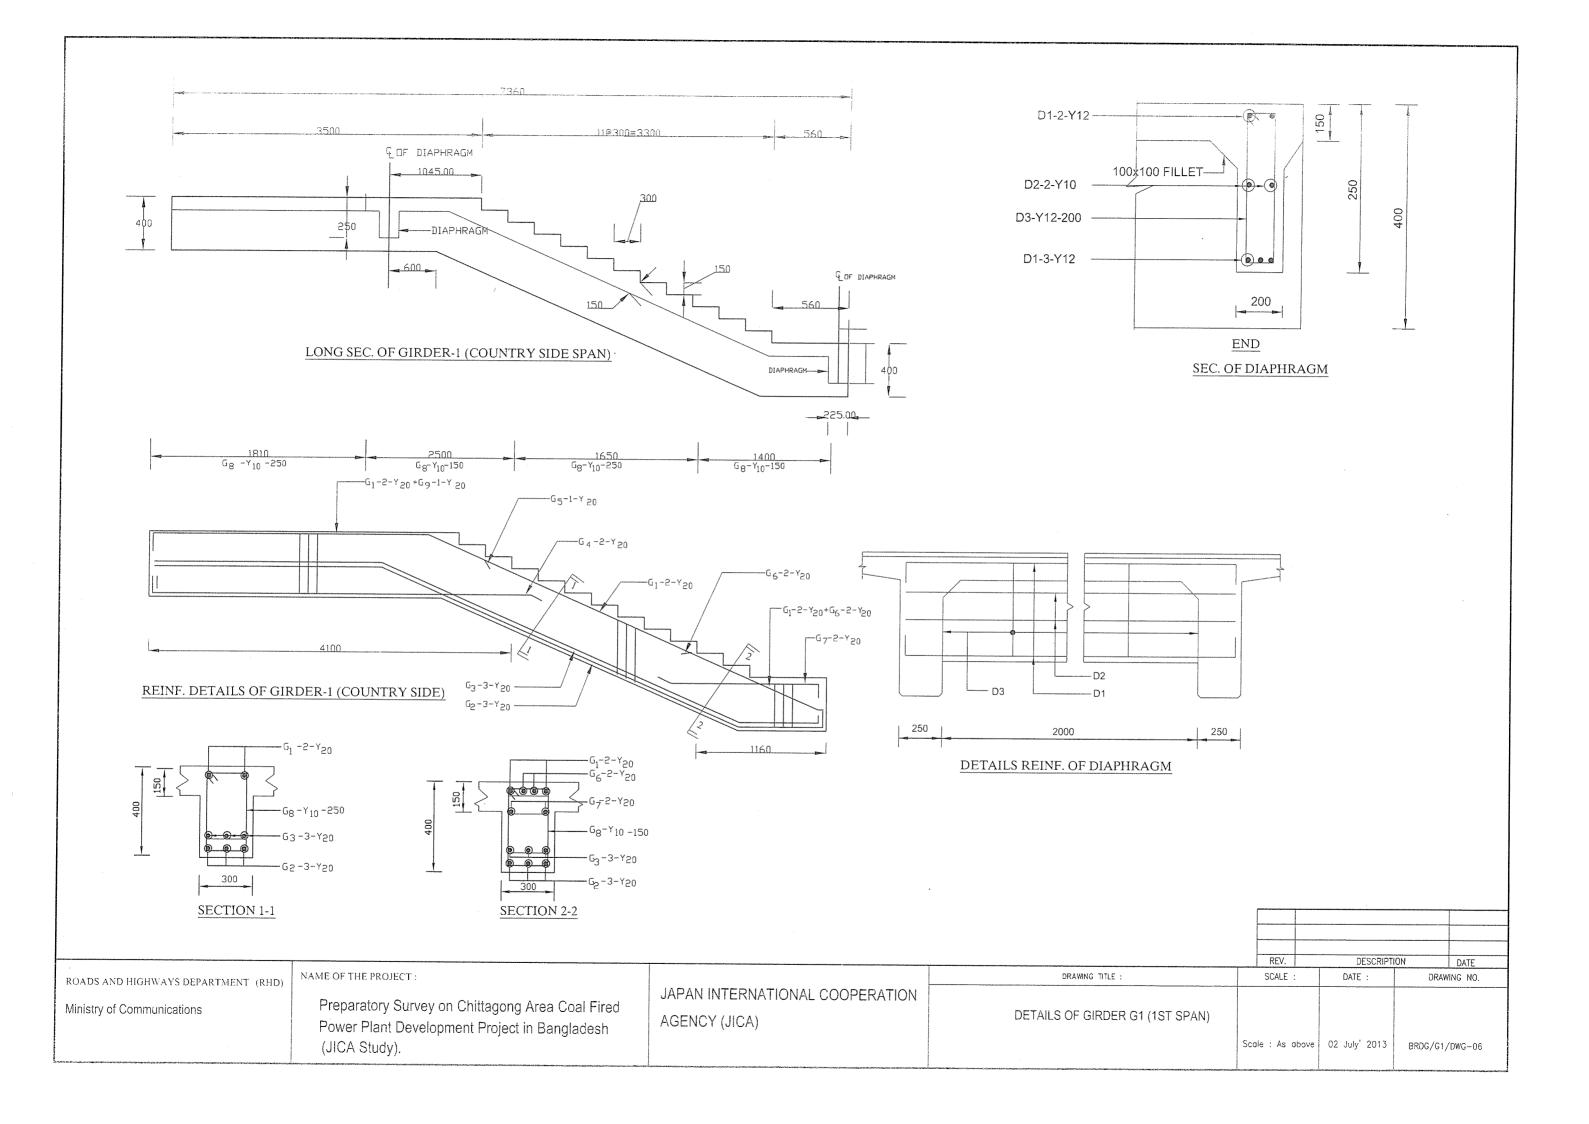


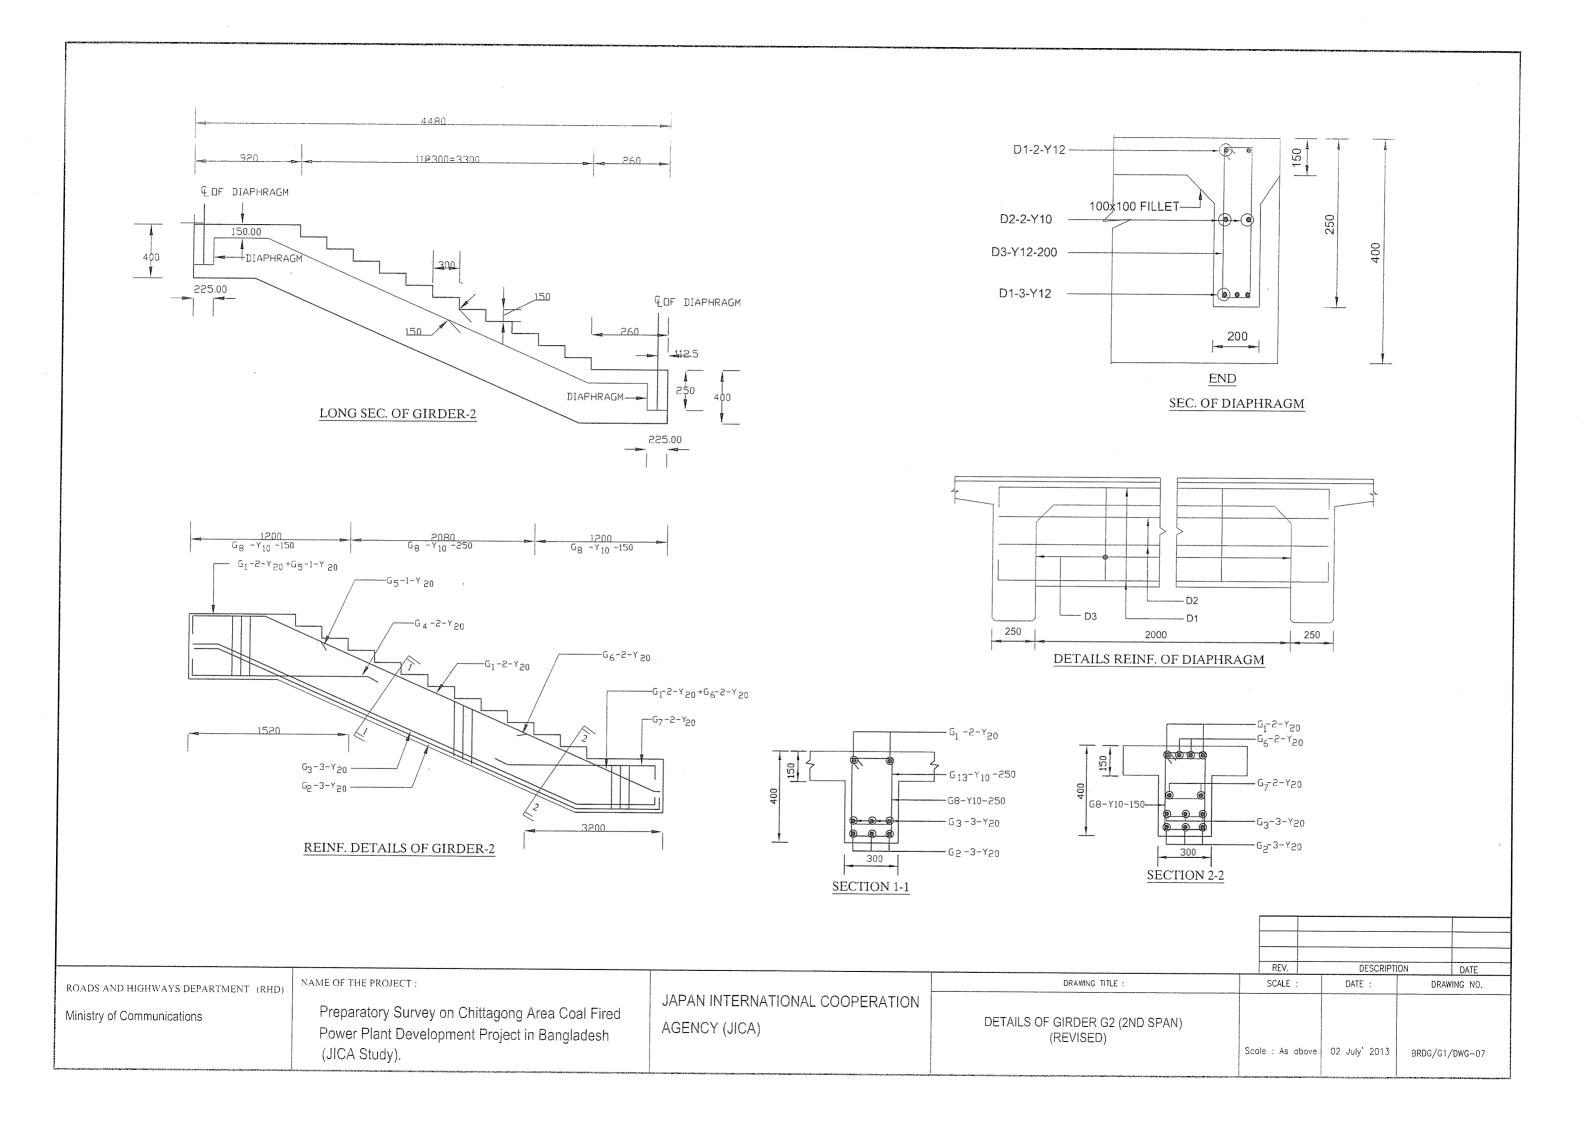


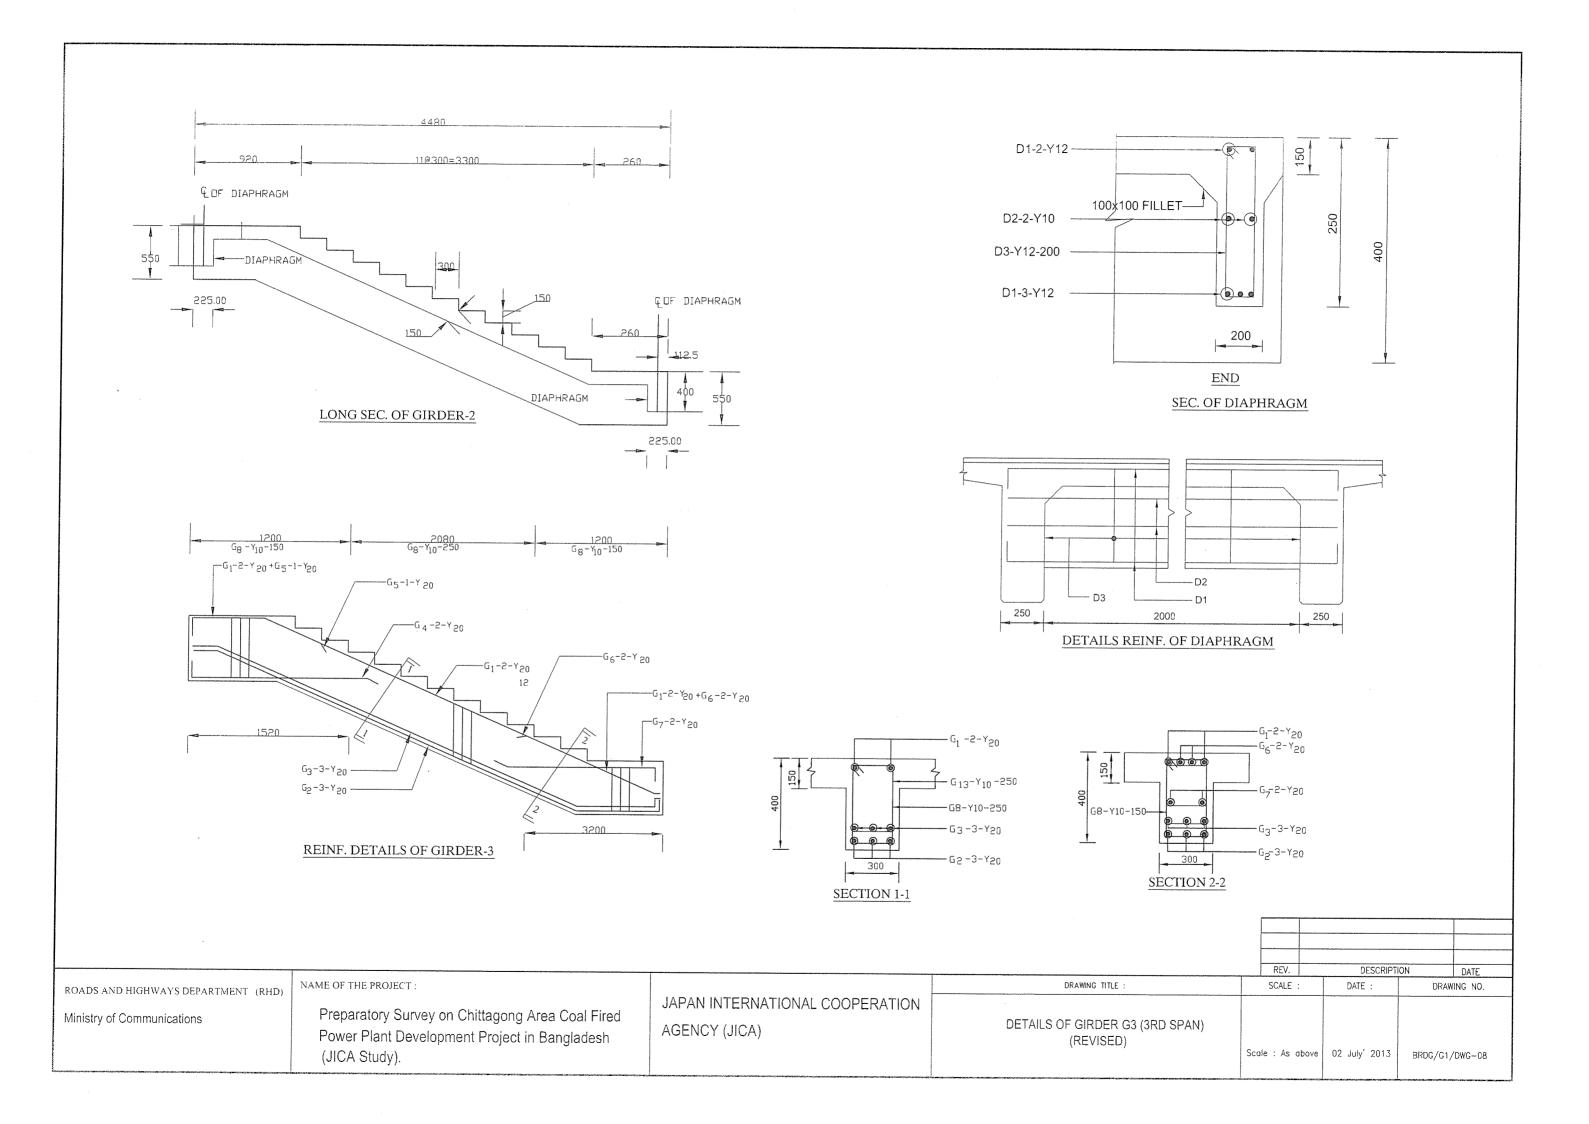

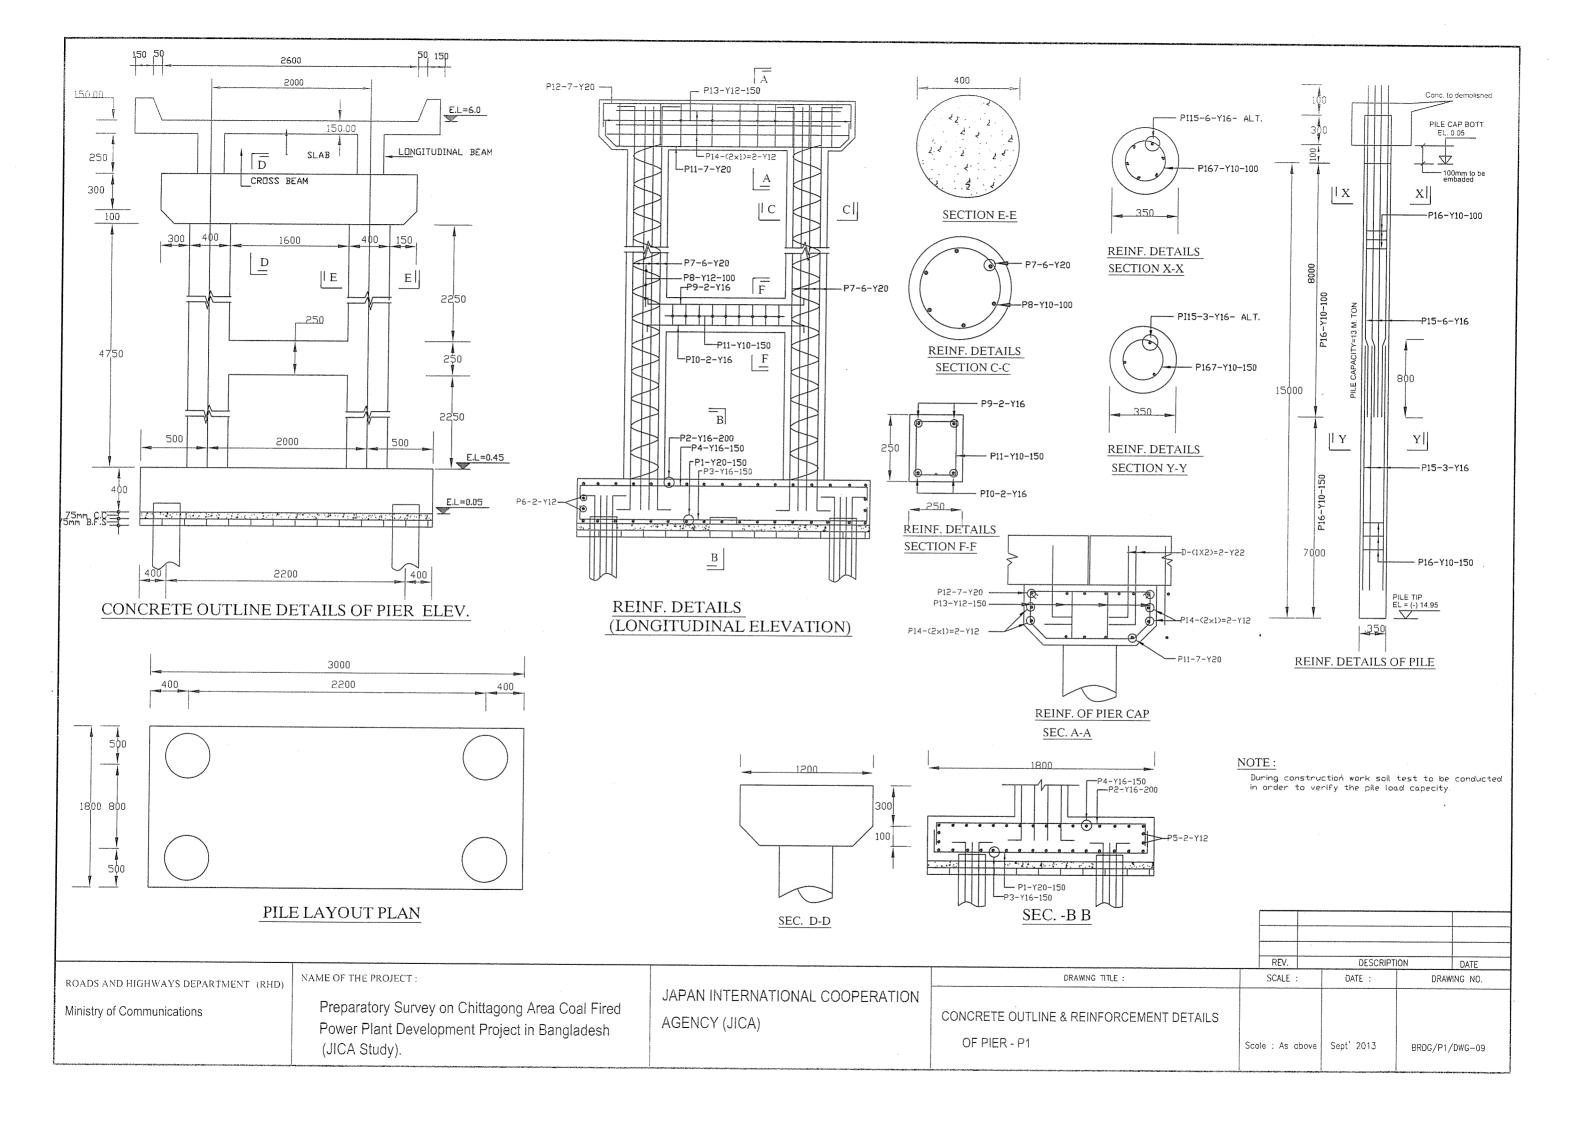


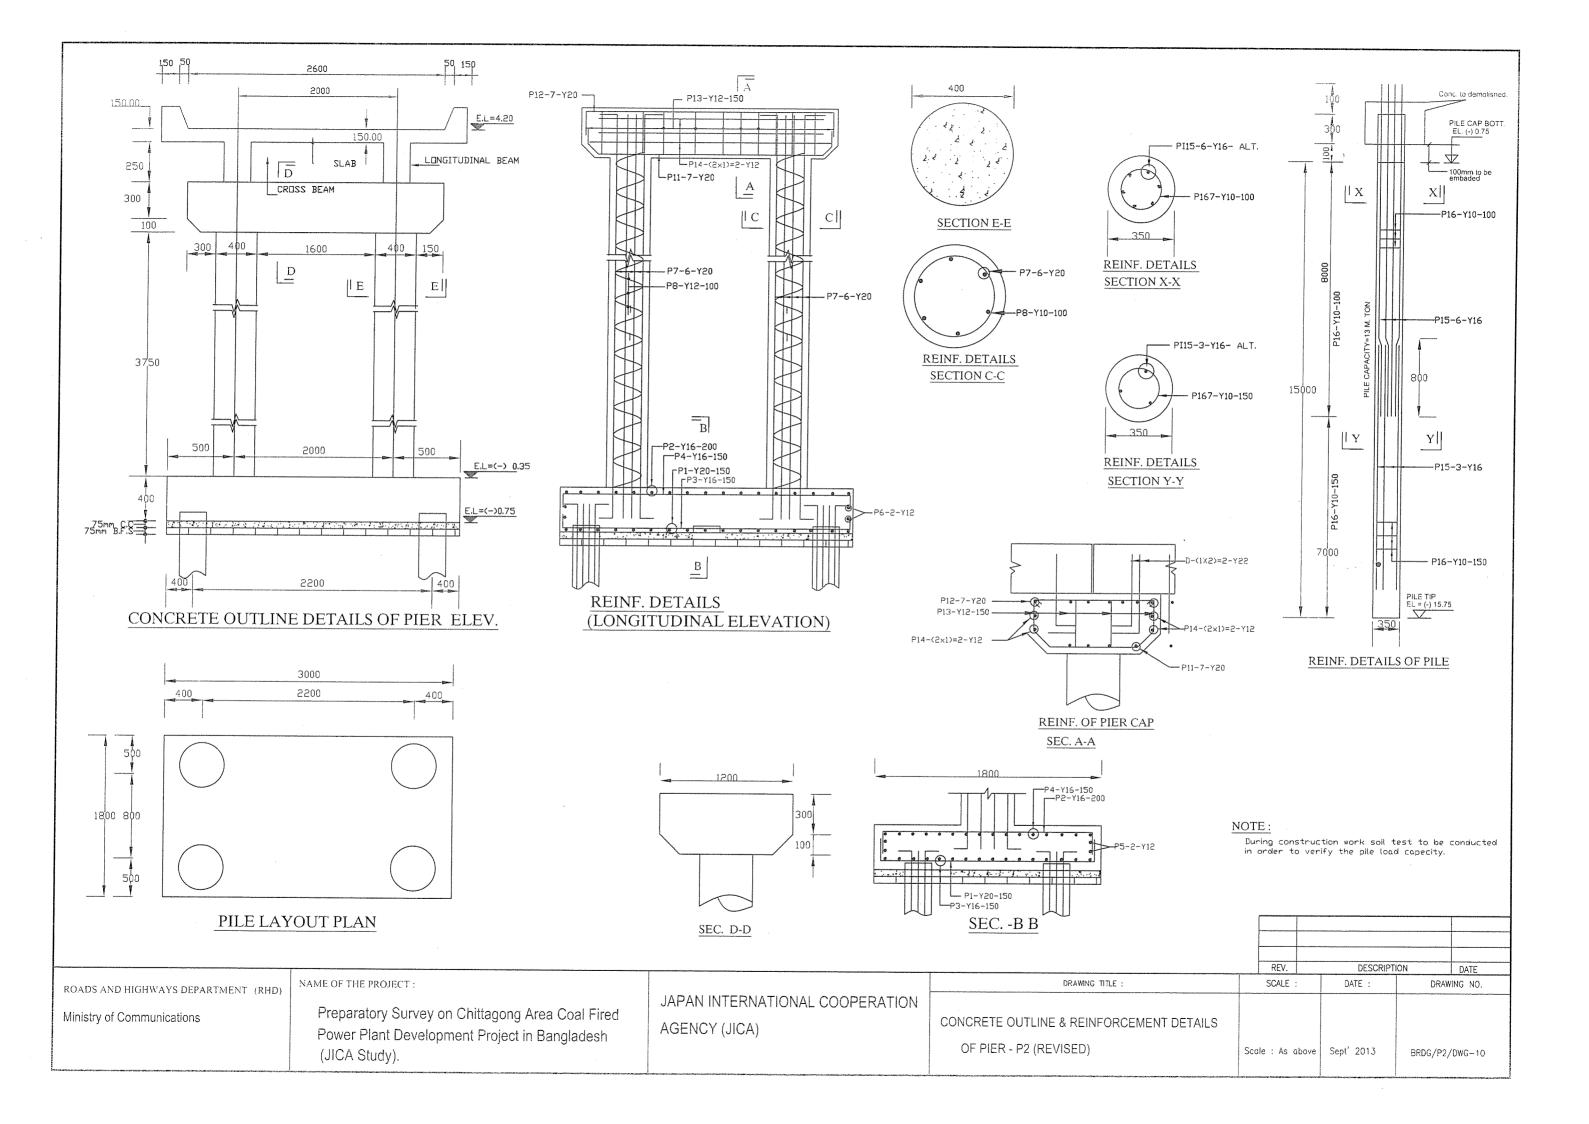


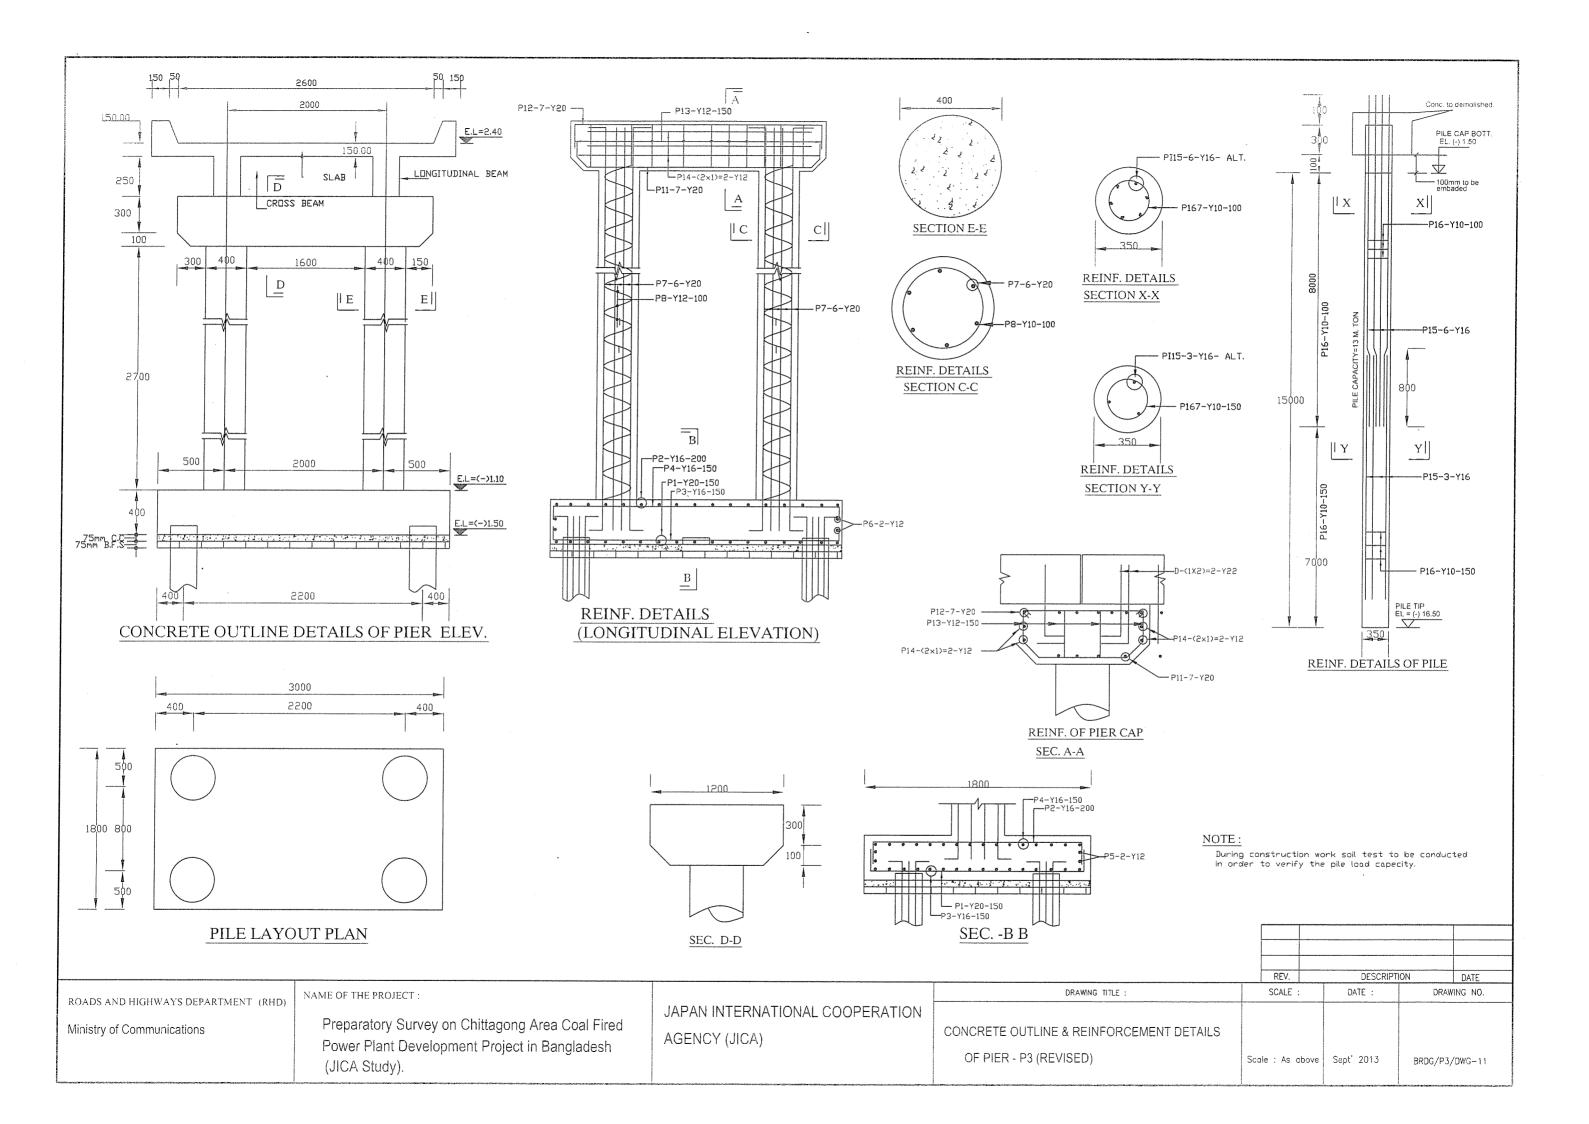


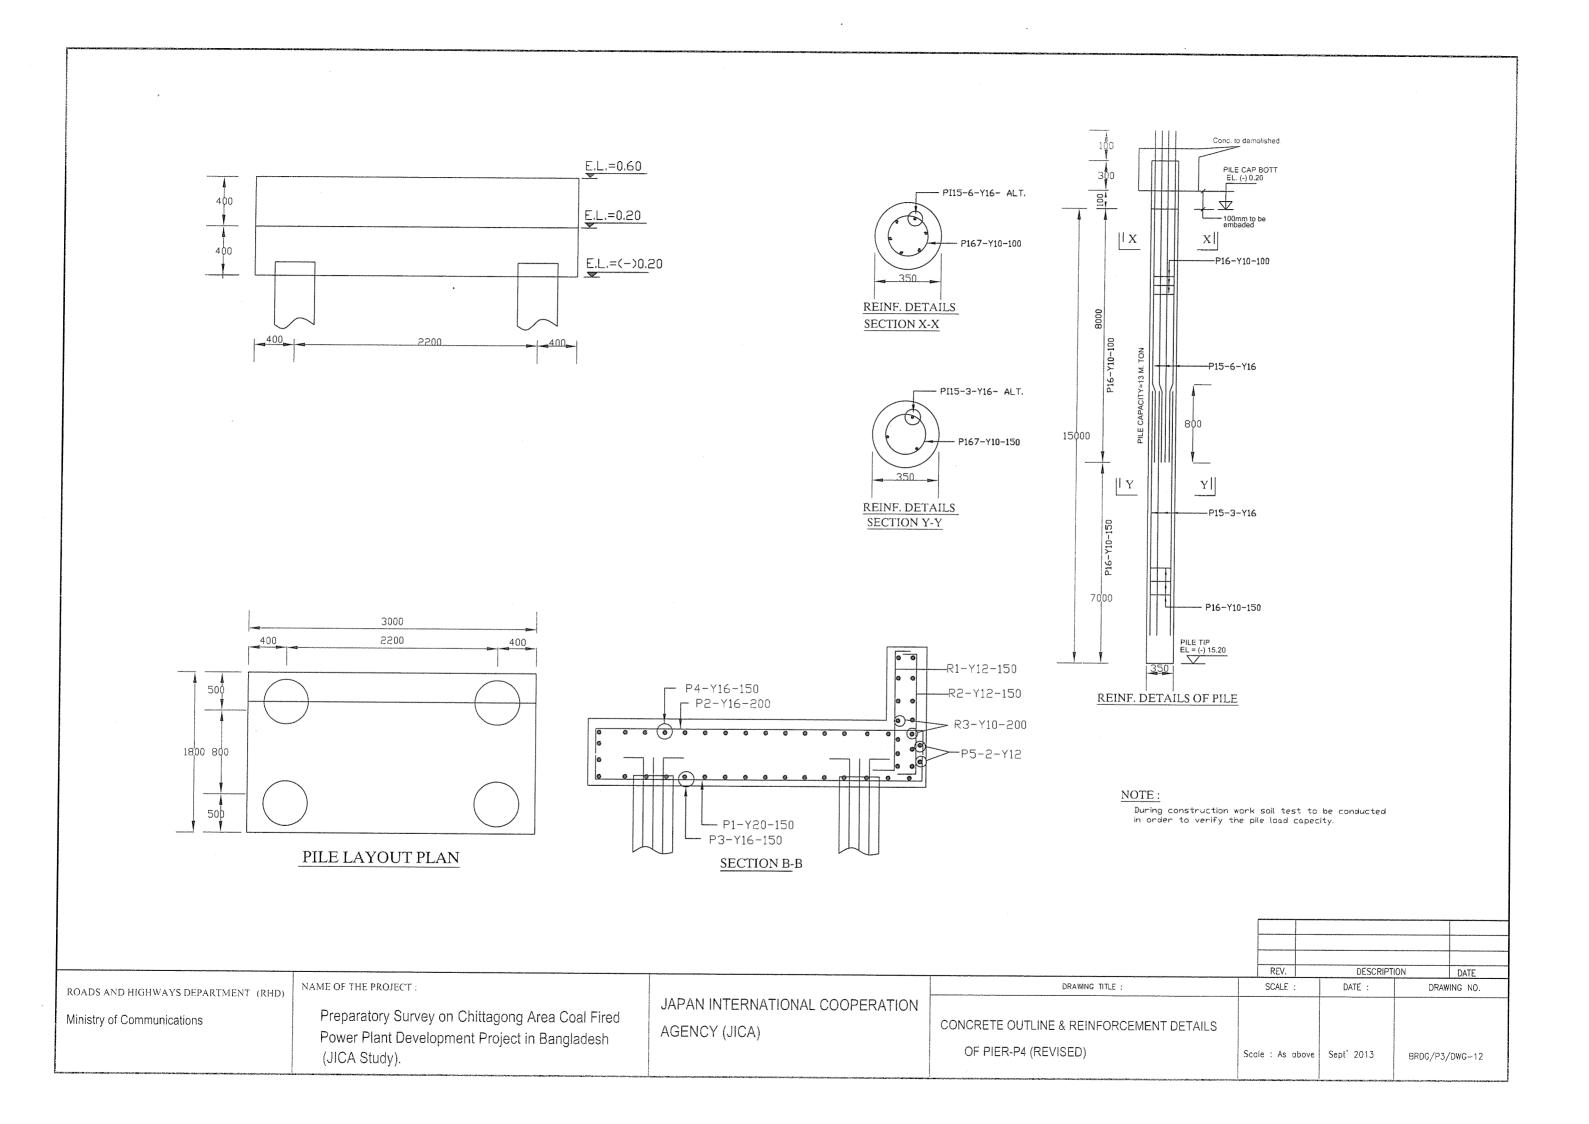



DRAINAGE ROUTE MAP

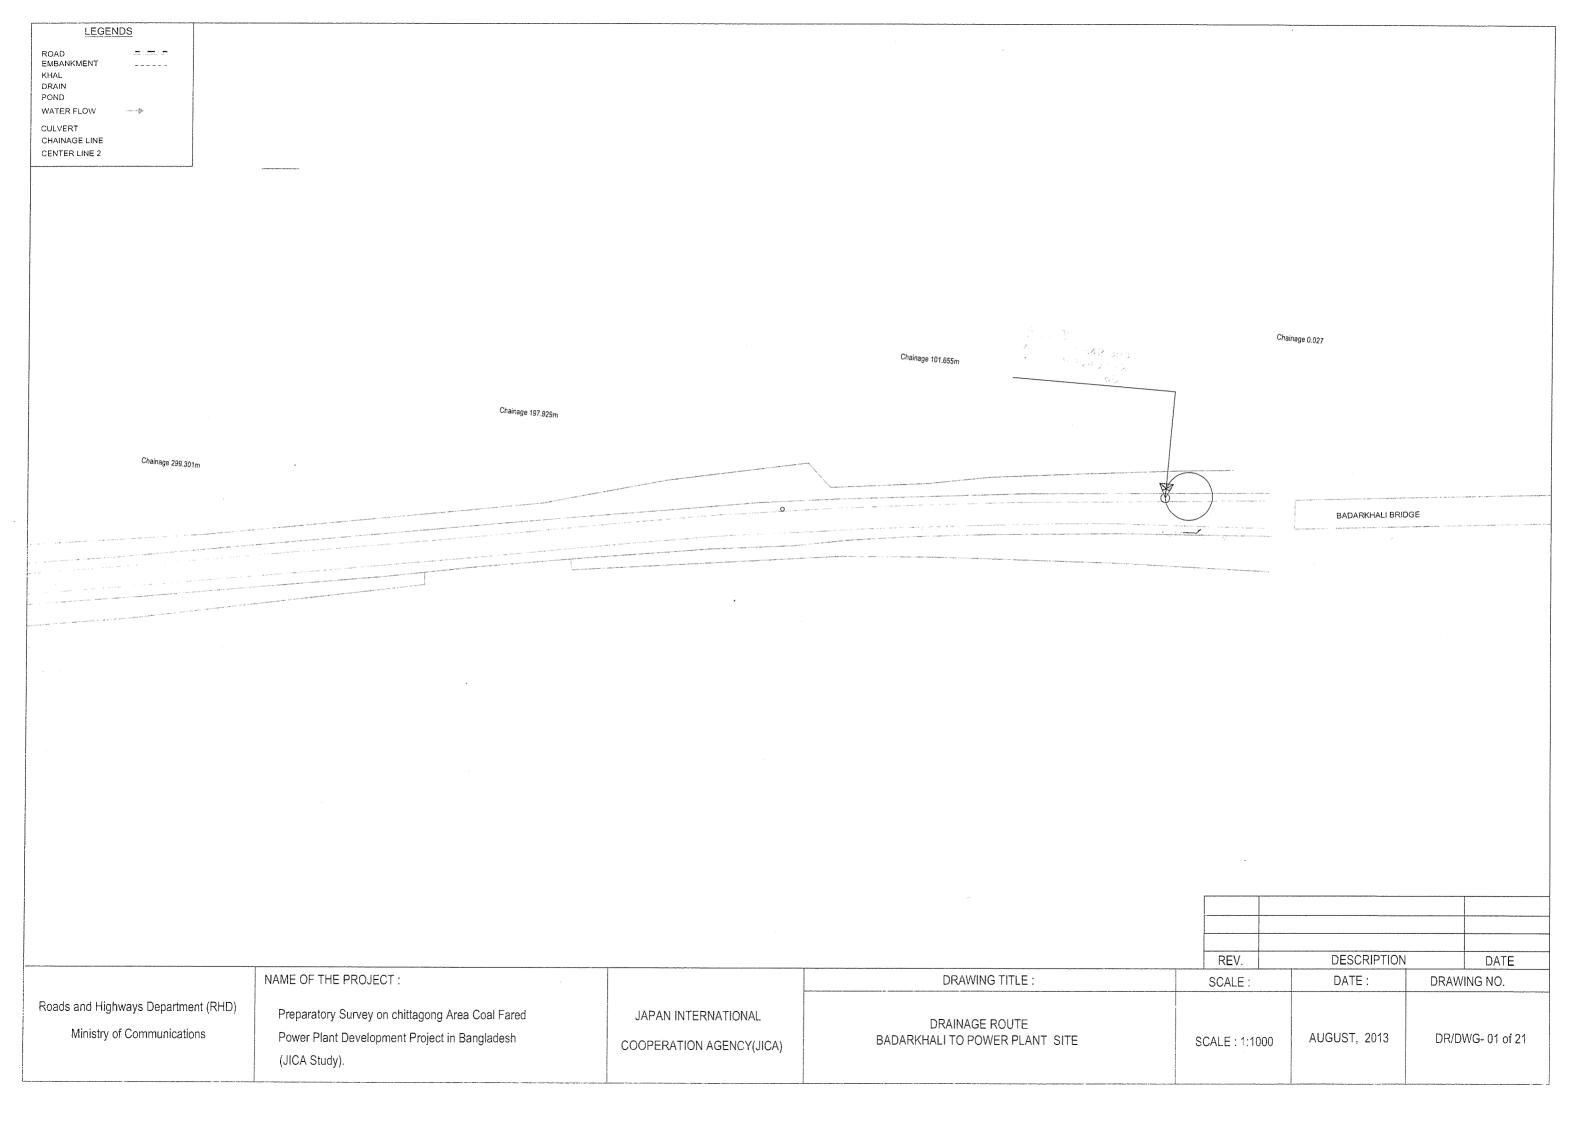


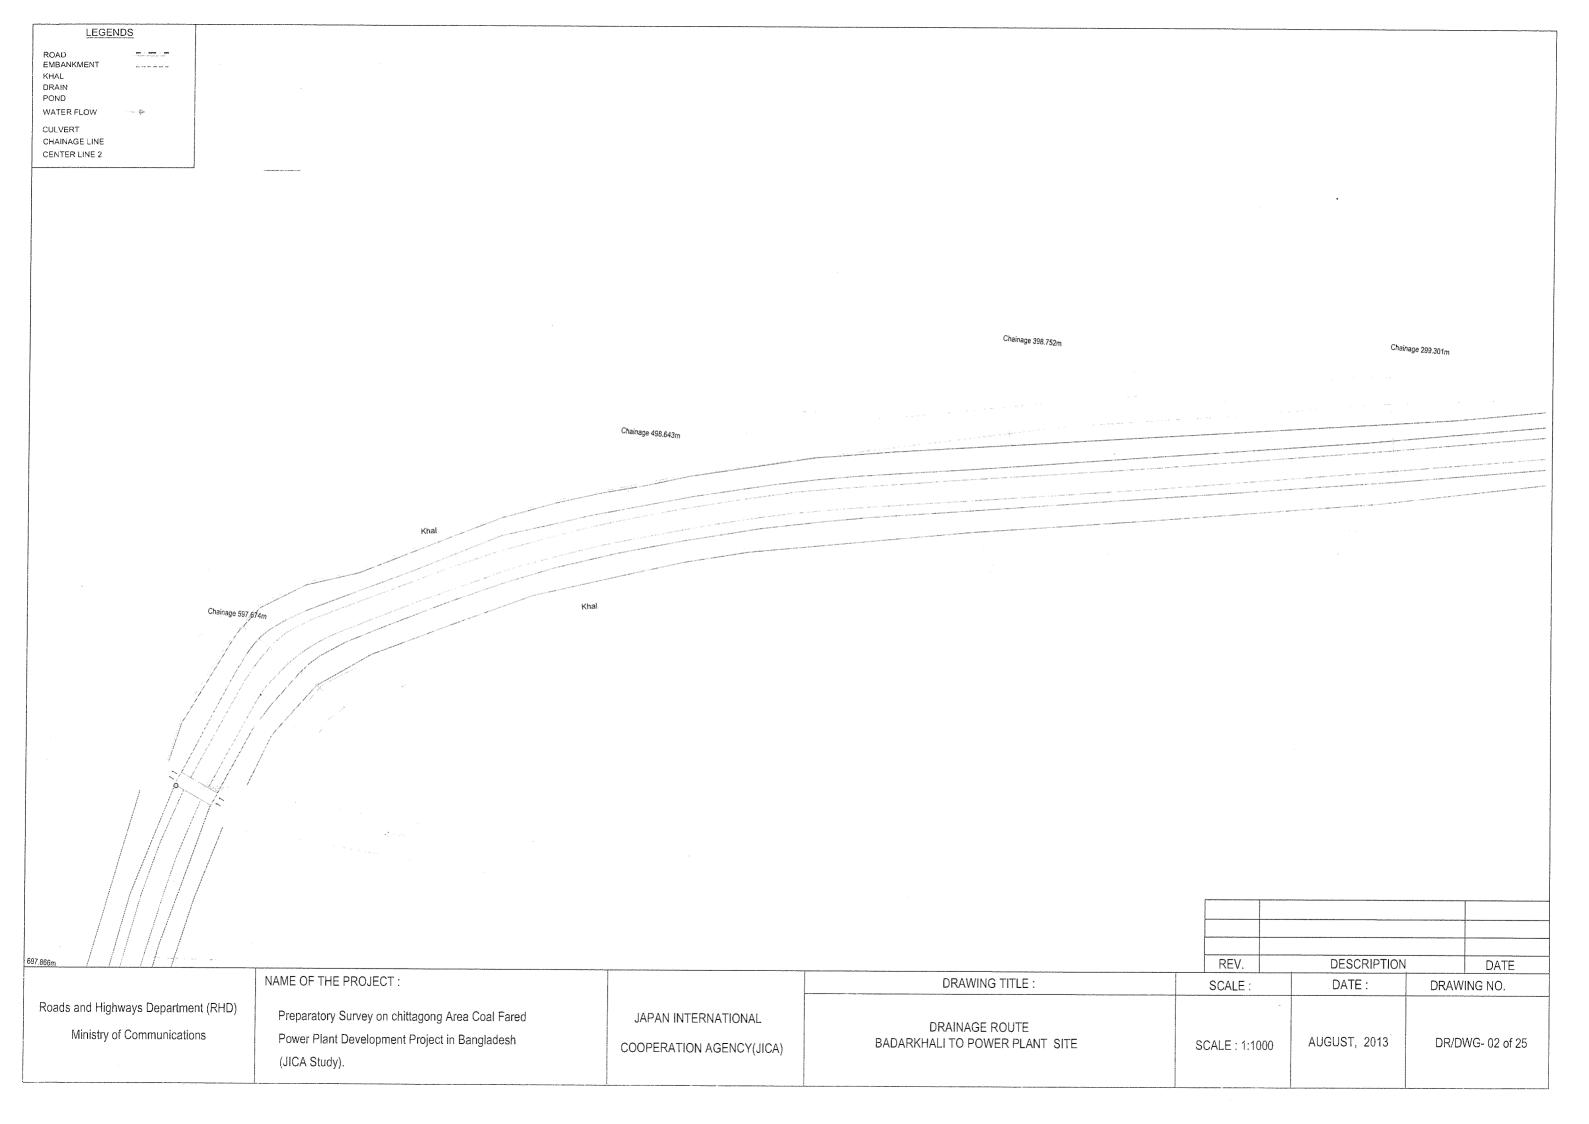


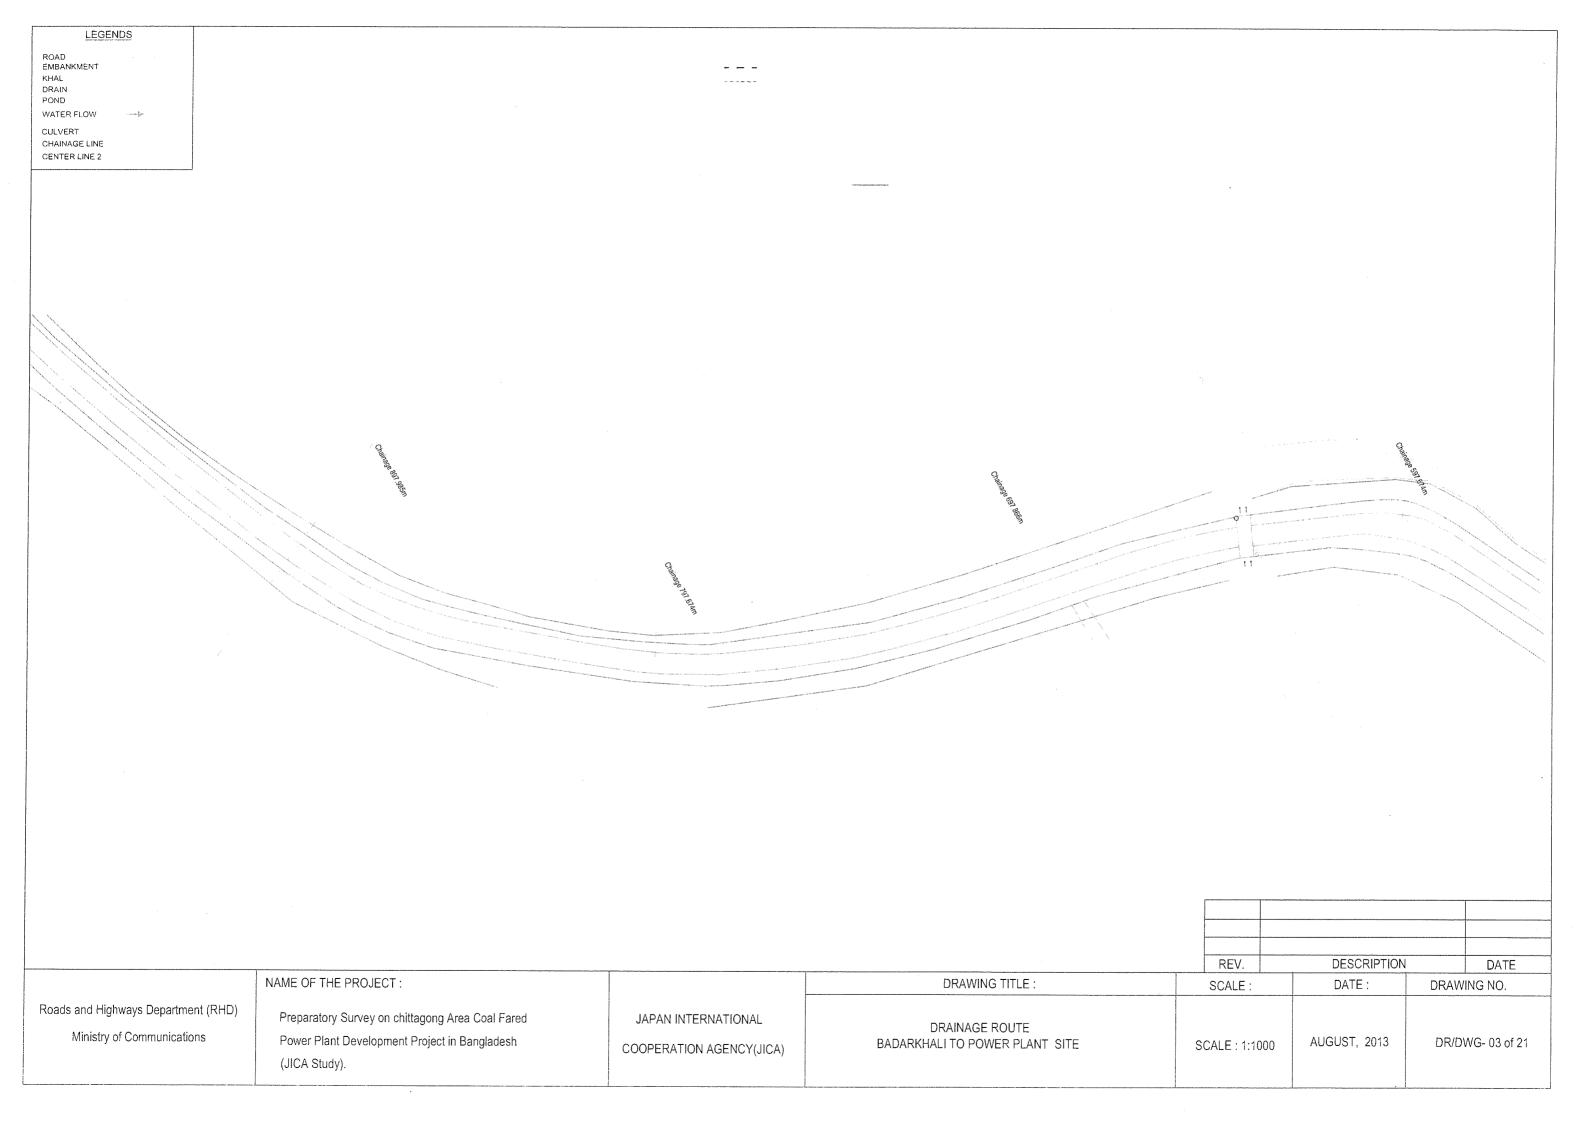


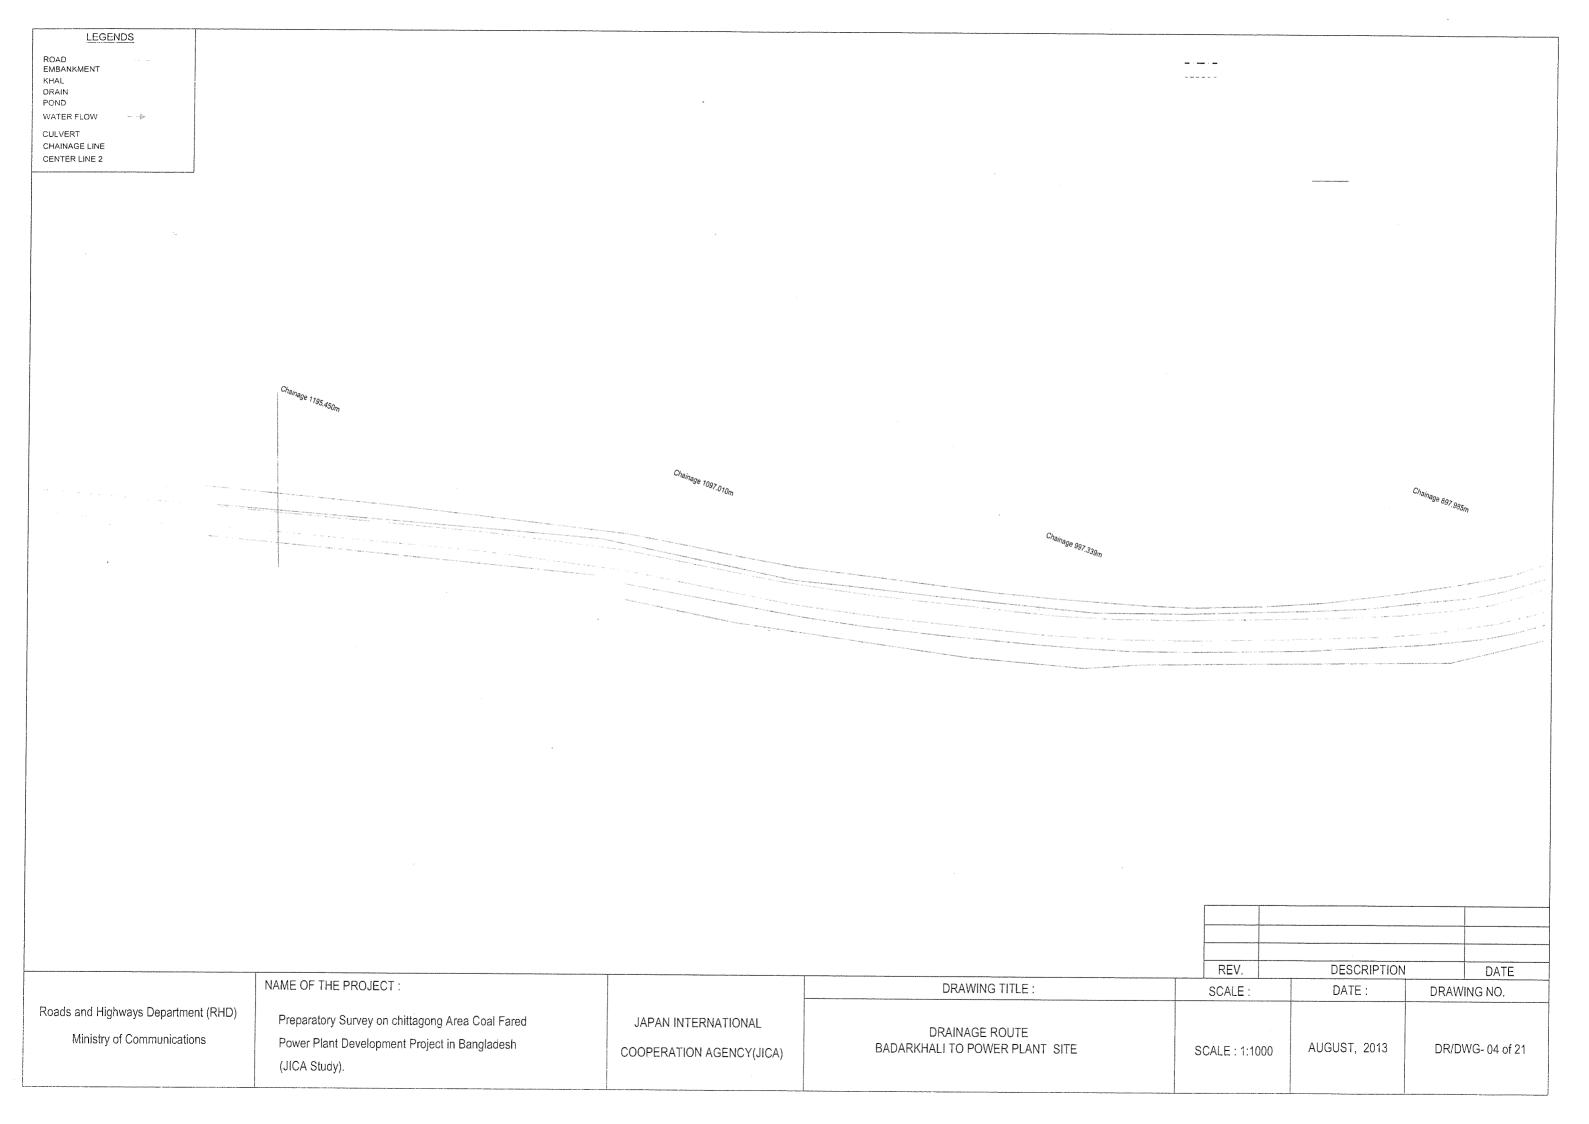

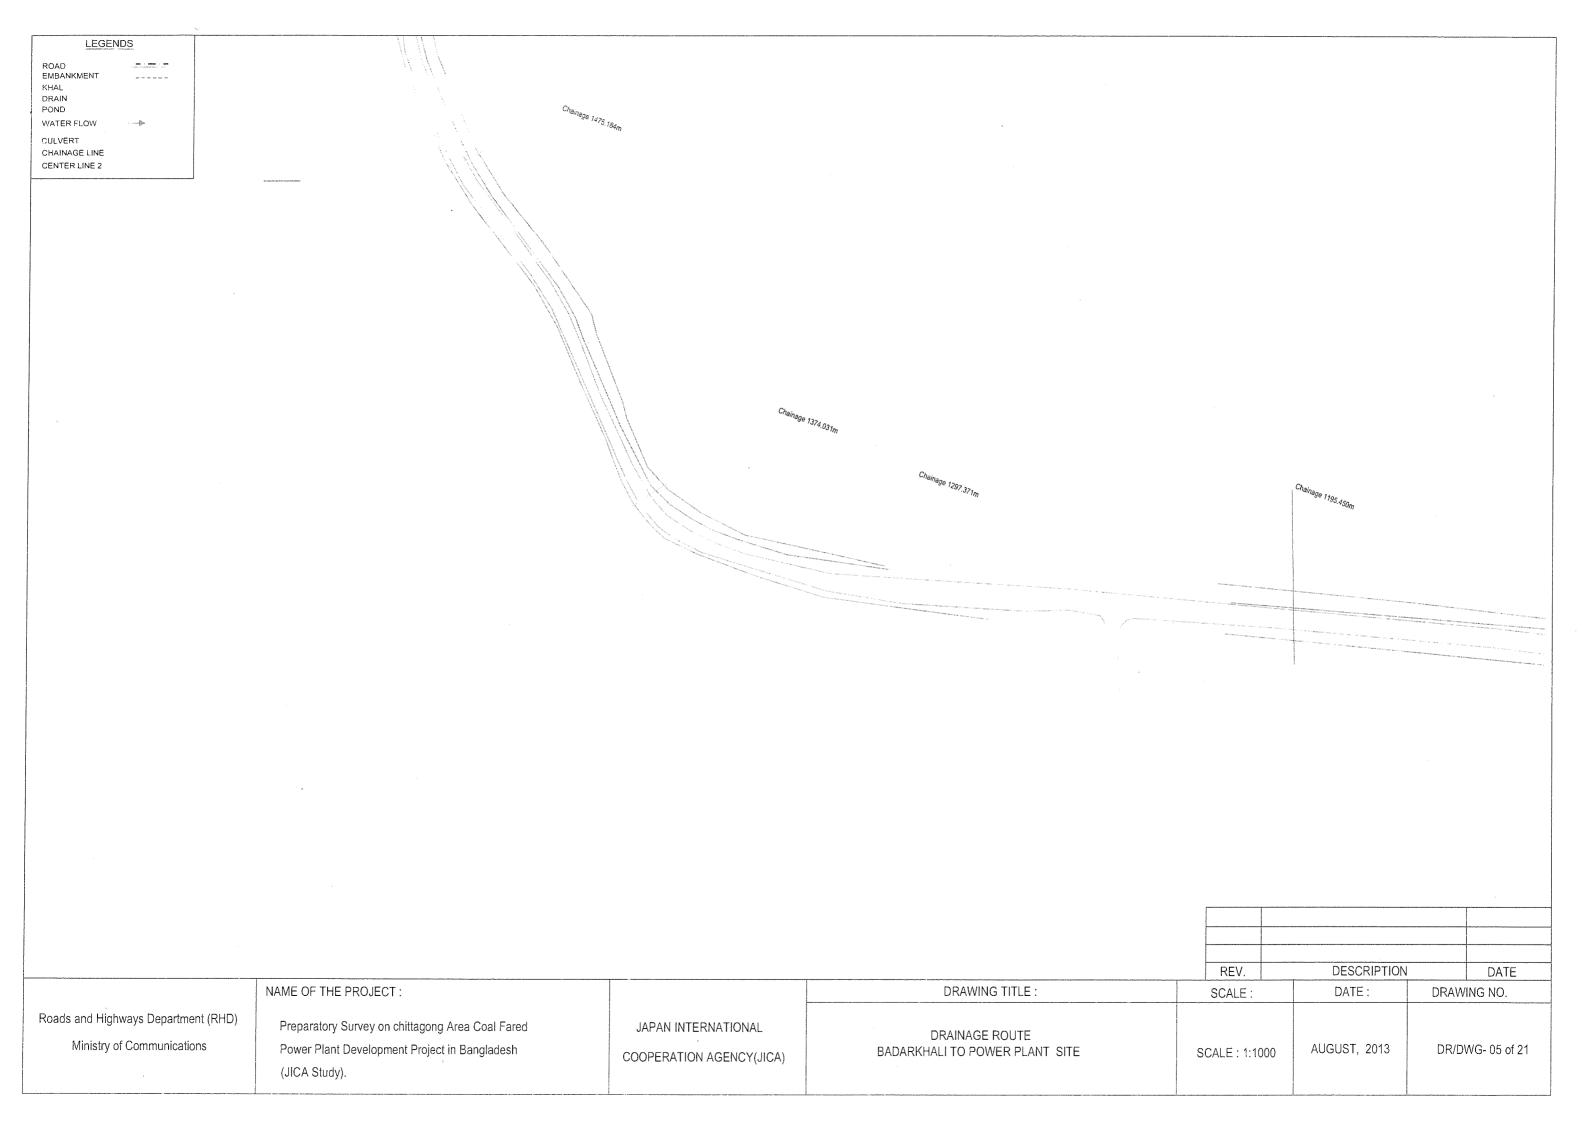


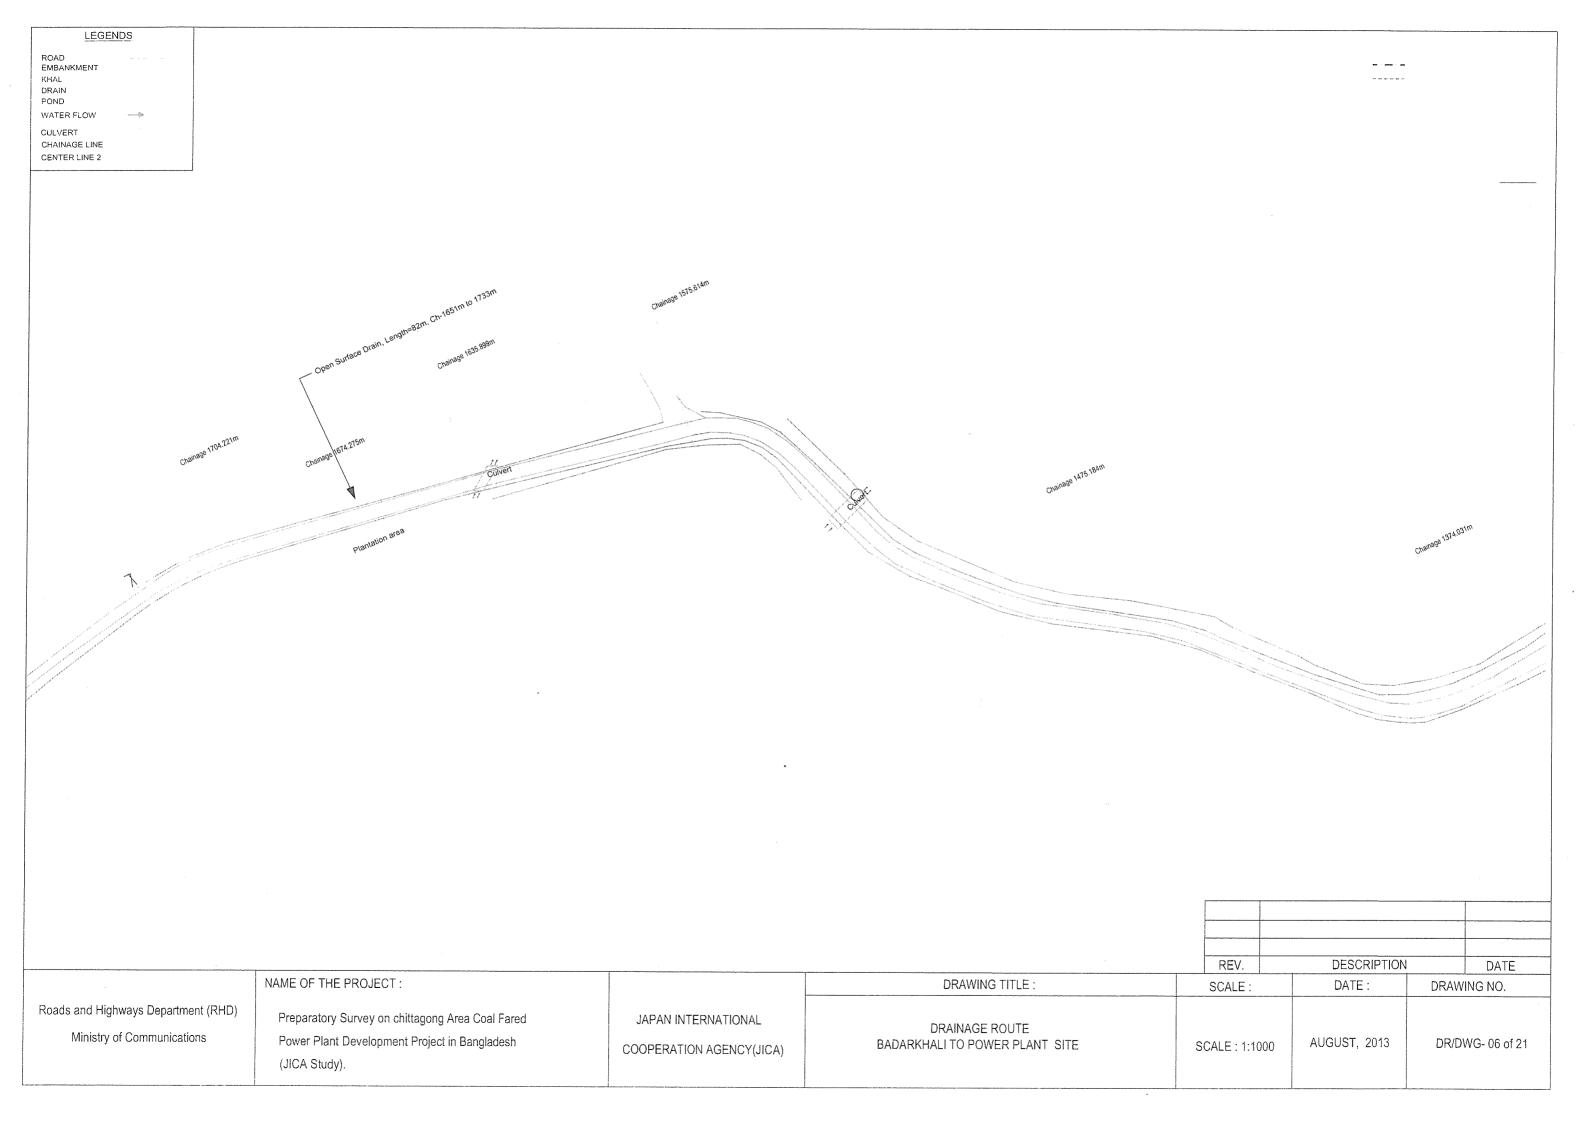


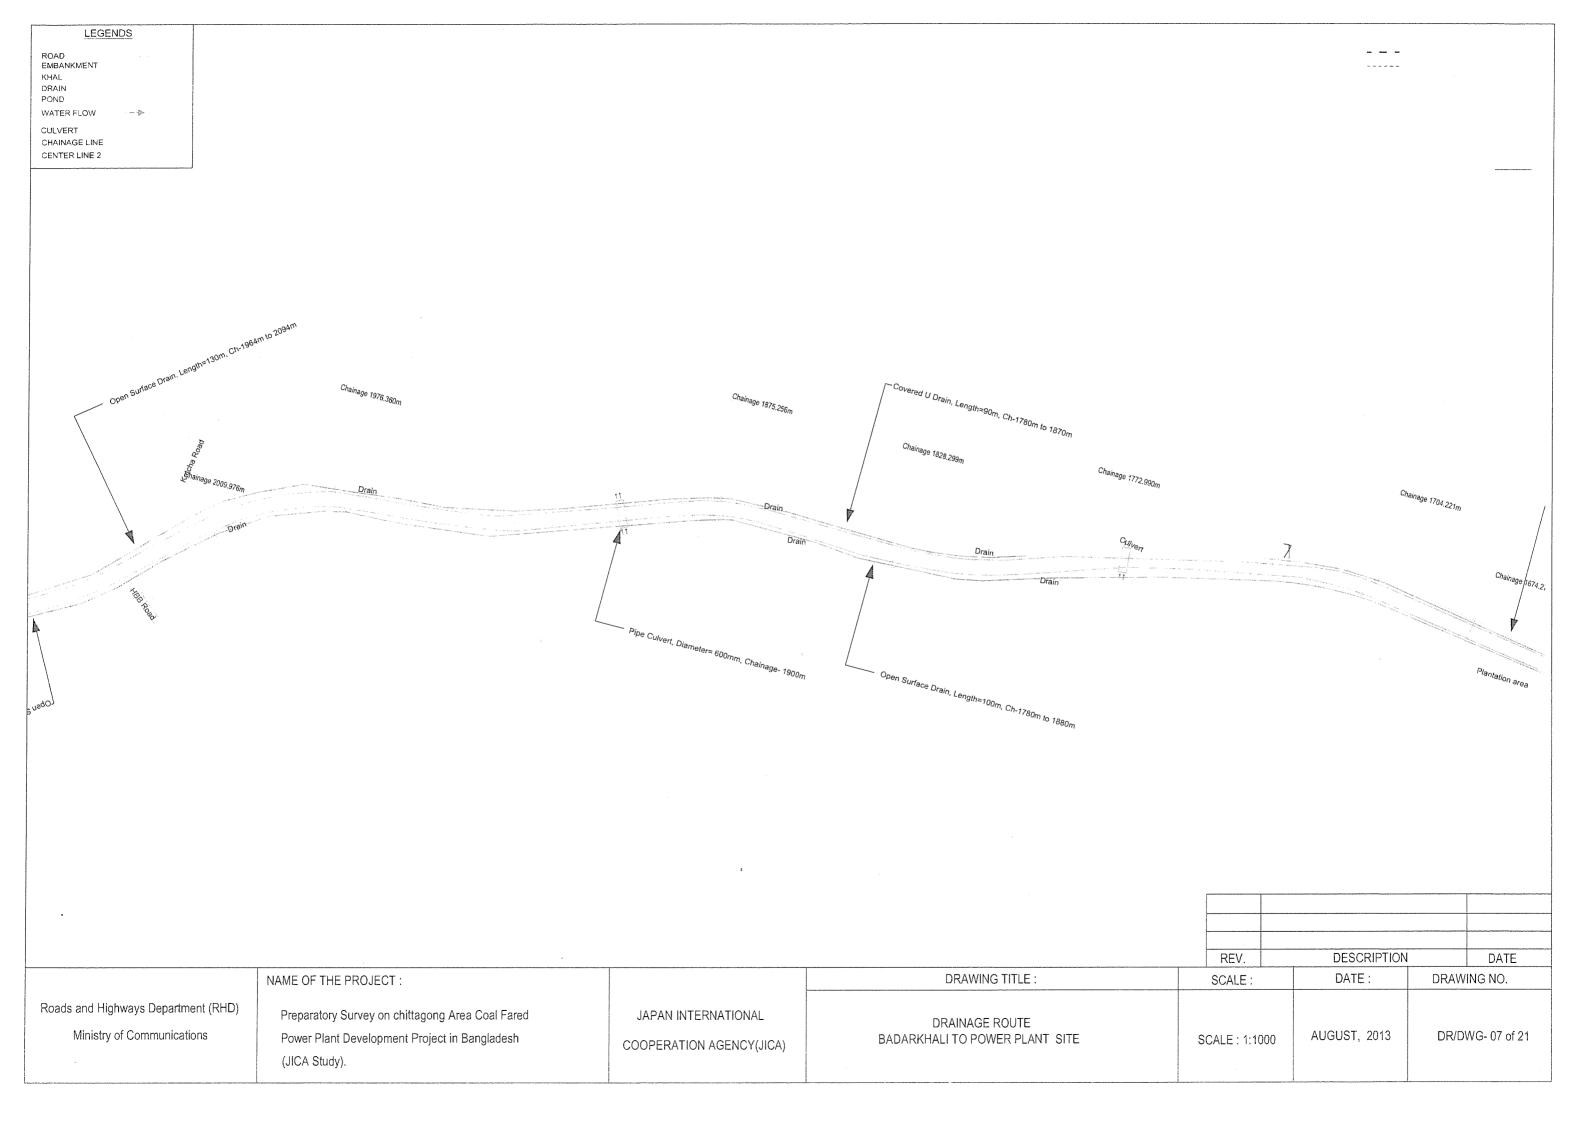


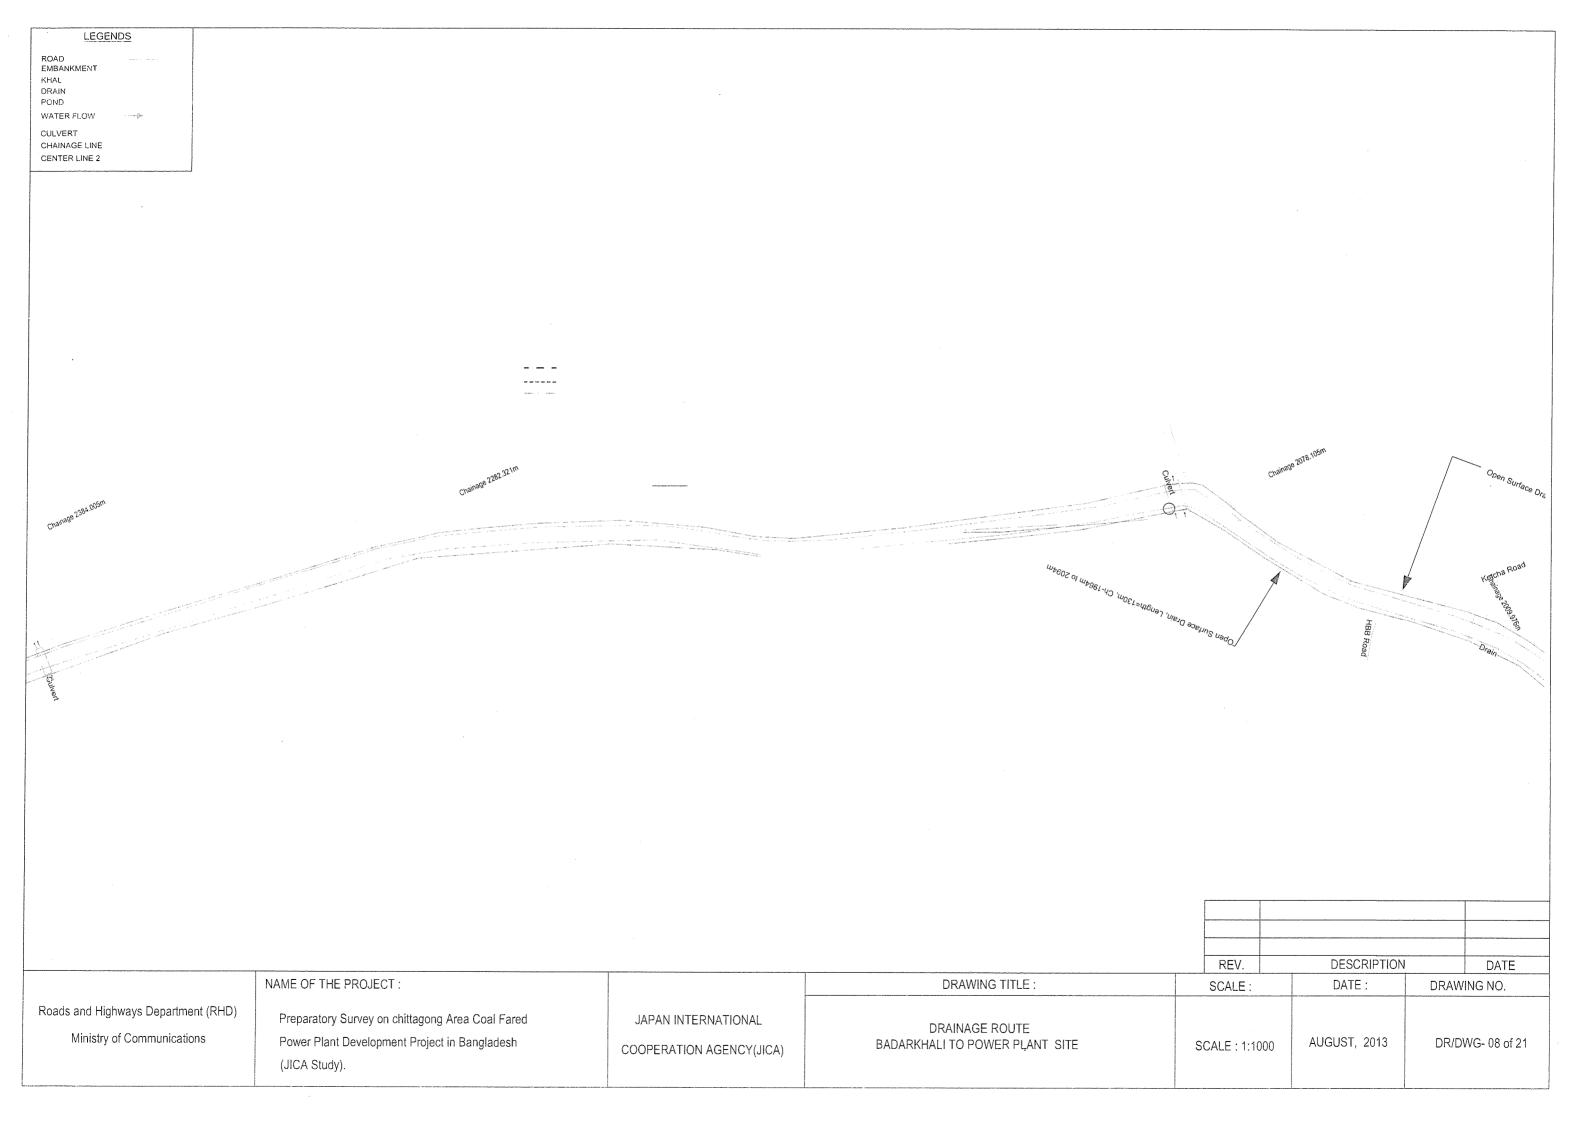



LEGENDS				**************************************			
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EMBANKMENT							
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POND WATER FLOW → WATER FLOW							
CULVERT			,				
CHAINAGE LINE		•					
CENTER LINE 2							
							•
						•	
way, Size= 20m, Chainage- 2776m							
	•						
							Chainage 2364.005m
,							
		Chainage 2581.518m		Chainage 2478.525m			
	Chainage 2661.434m			Chainage 2478.525m			
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Roads and Highways Department (RHD)	NAME OF THE PROJECT:		DRAWING TITLE:			DESCRIPTION	DATE
Roads and Highways Department (RHD)	NAME OF THE PROJECT: Preparatory Survey on chittagong Area Coal Fared	JAPAN INTERNATIONAL	DRAWING TITLE : DRAINAGE ROUTE	Pond	SCALE:	DESCRIPTION DATE:	DATE DRAWING NO.
	NAME OF THE PROJECT: Preparatory Survey on chittagong Area Coal Fared Power Plant Development Project in Bangladesh		DRAWING TITLE:	Pond	SCALE:	DESCRIPTION	DATE
Roads and Highways Department (RHD)	NAME OF THE PROJECT: Preparatory Survey on chittagong Area Coal Fared	JAPAN INTERNATIONAL	DRAWING TITLE : DRAINAGE ROUTE	Pond	SCALE:	DESCRIPTION DATE:	DATE DRAWING NO.

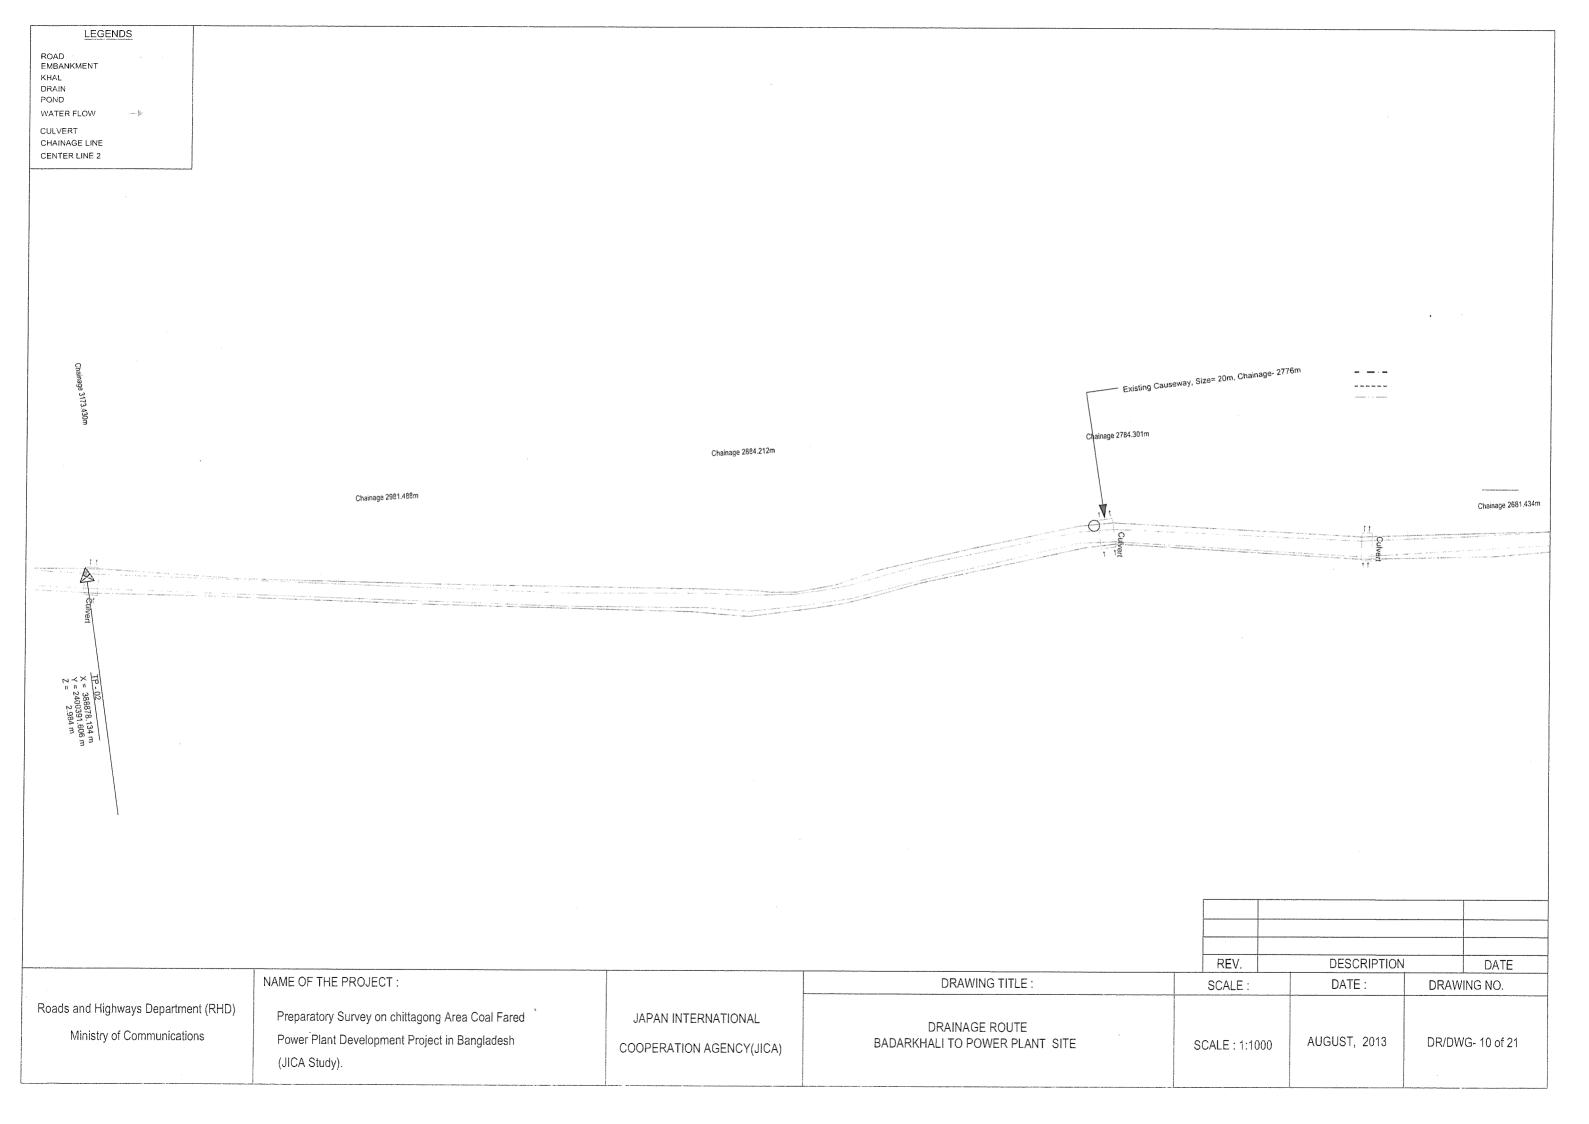


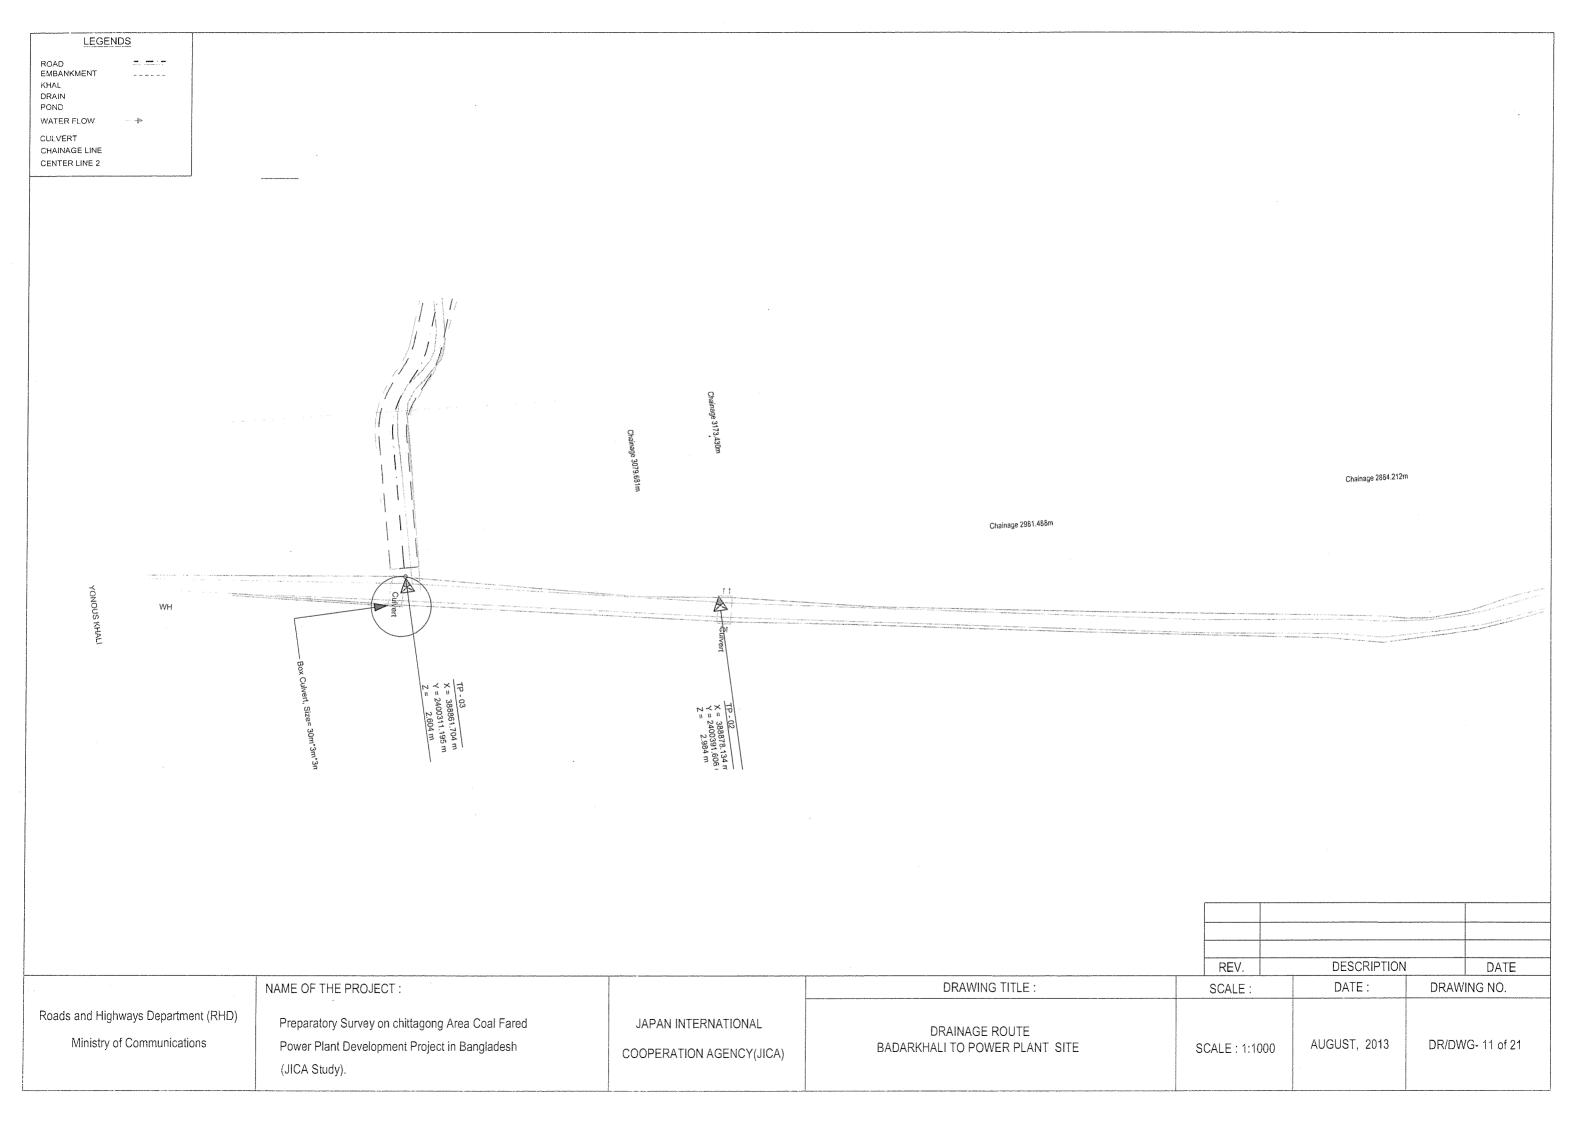


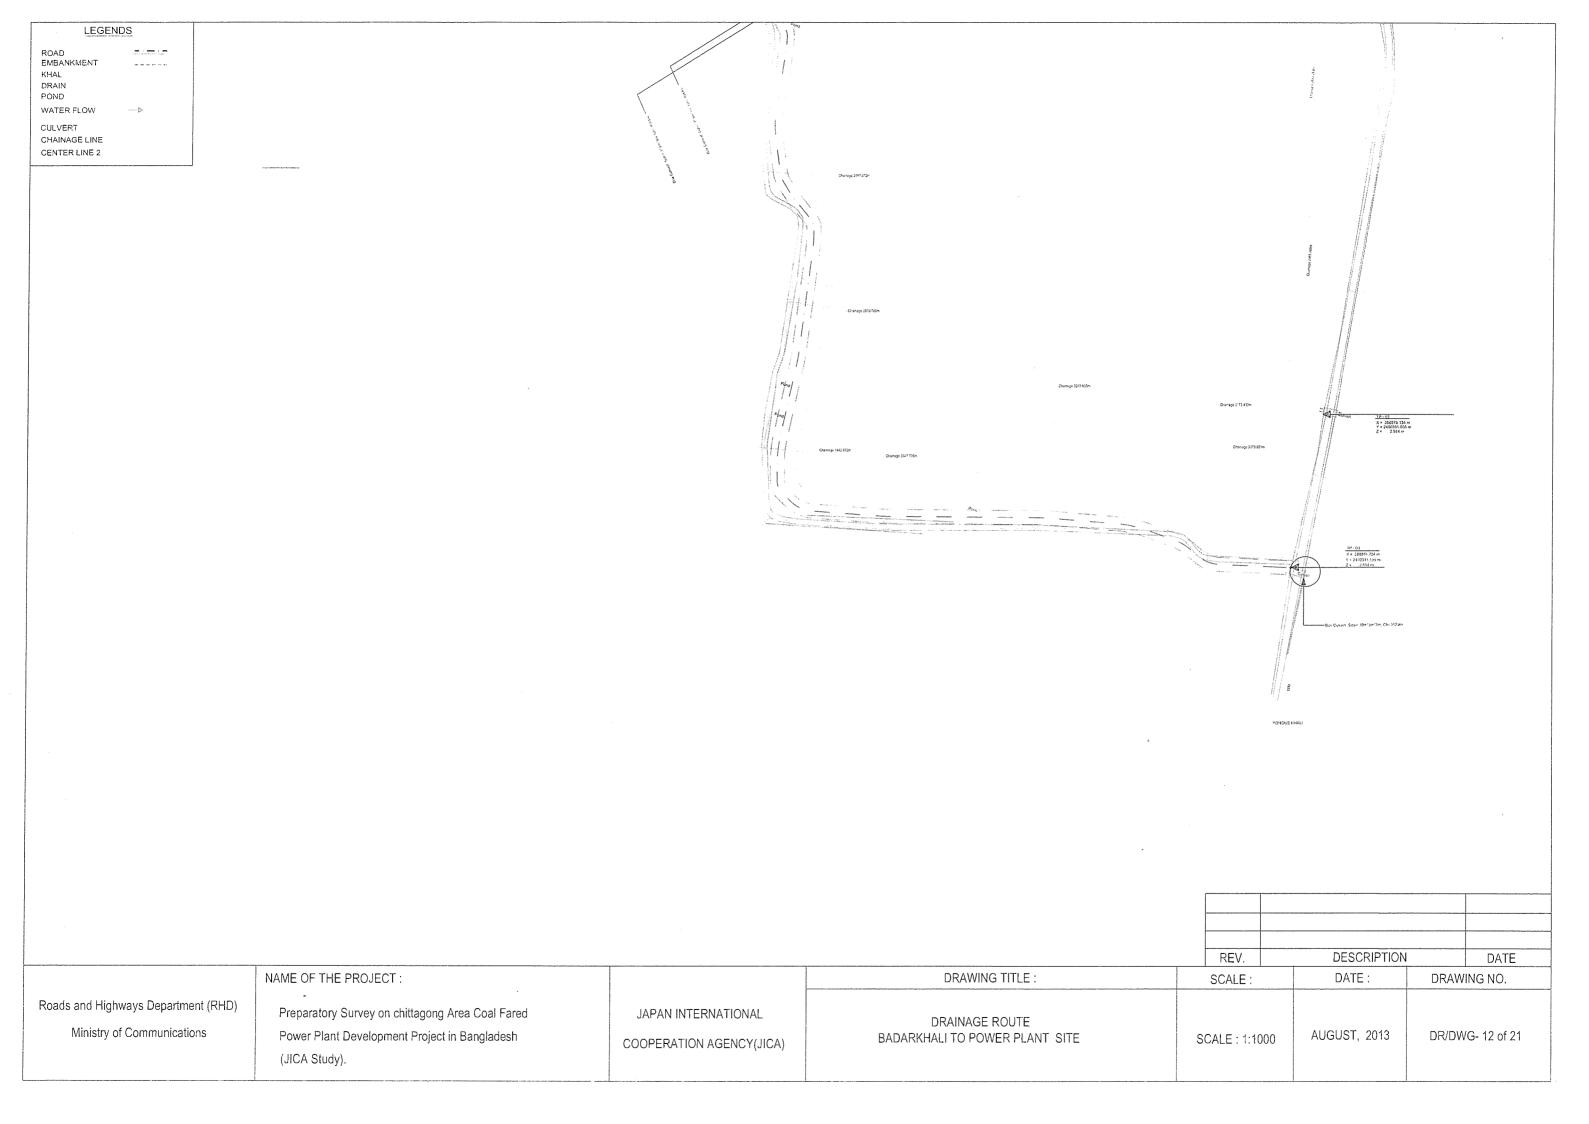

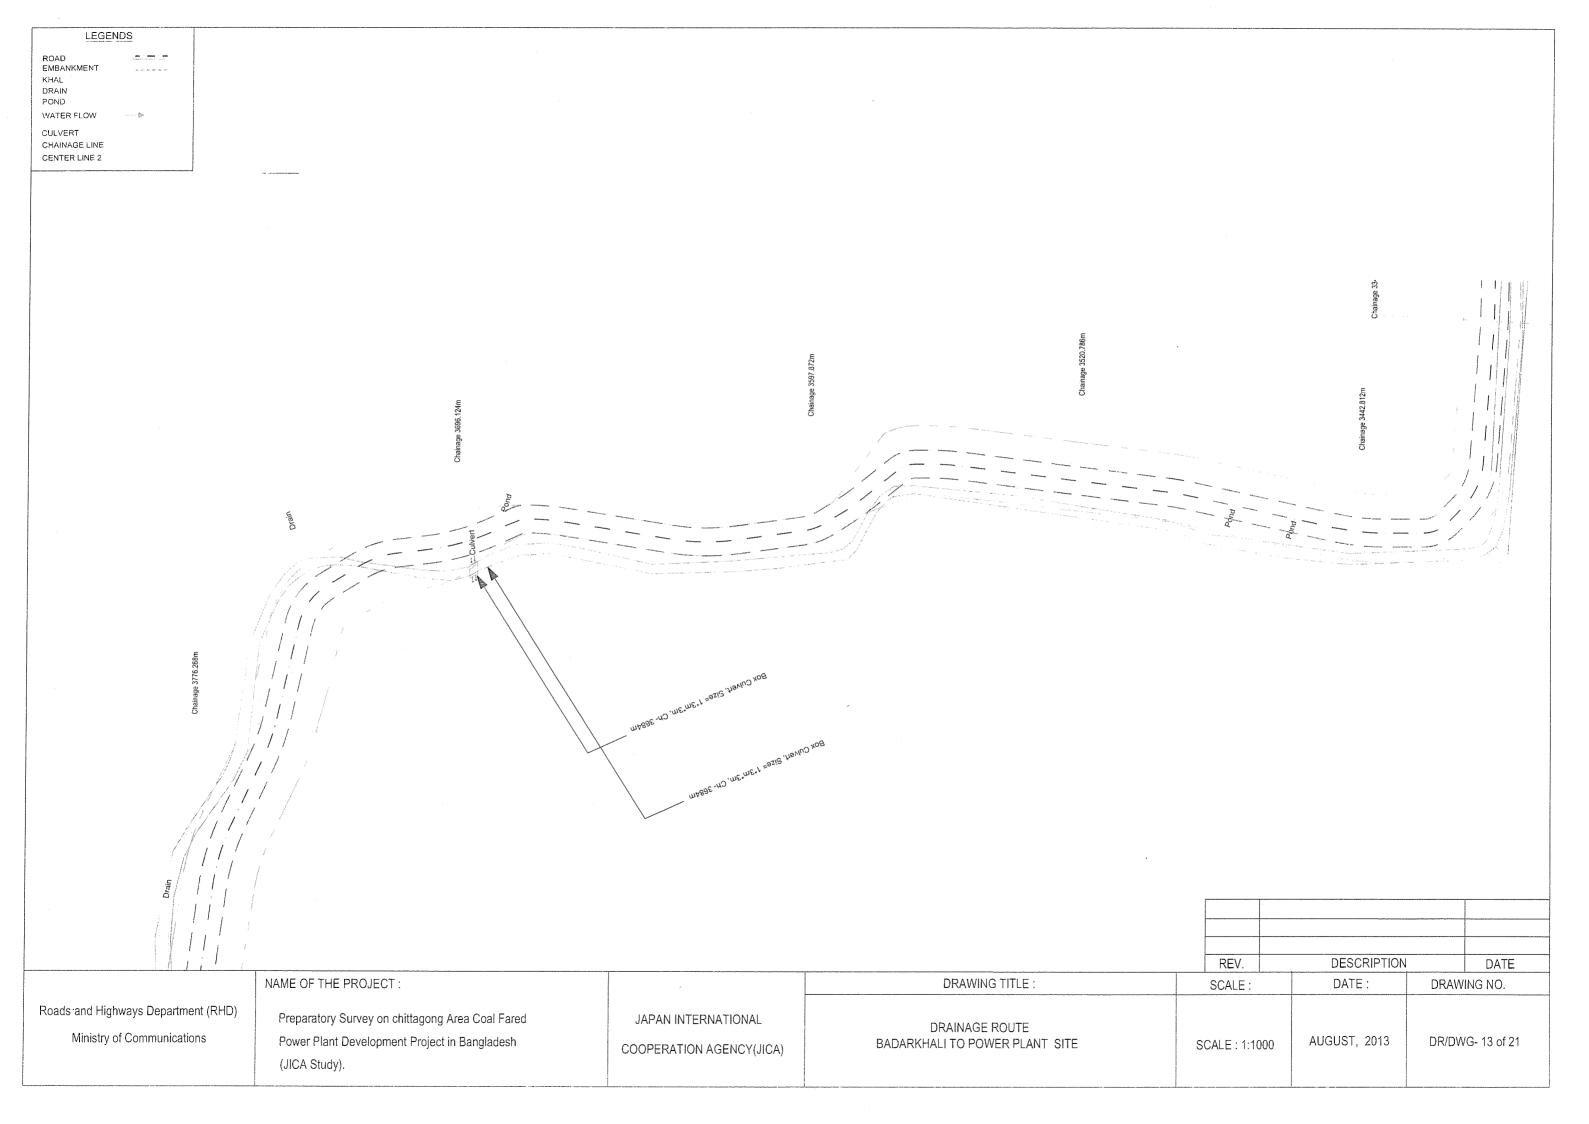

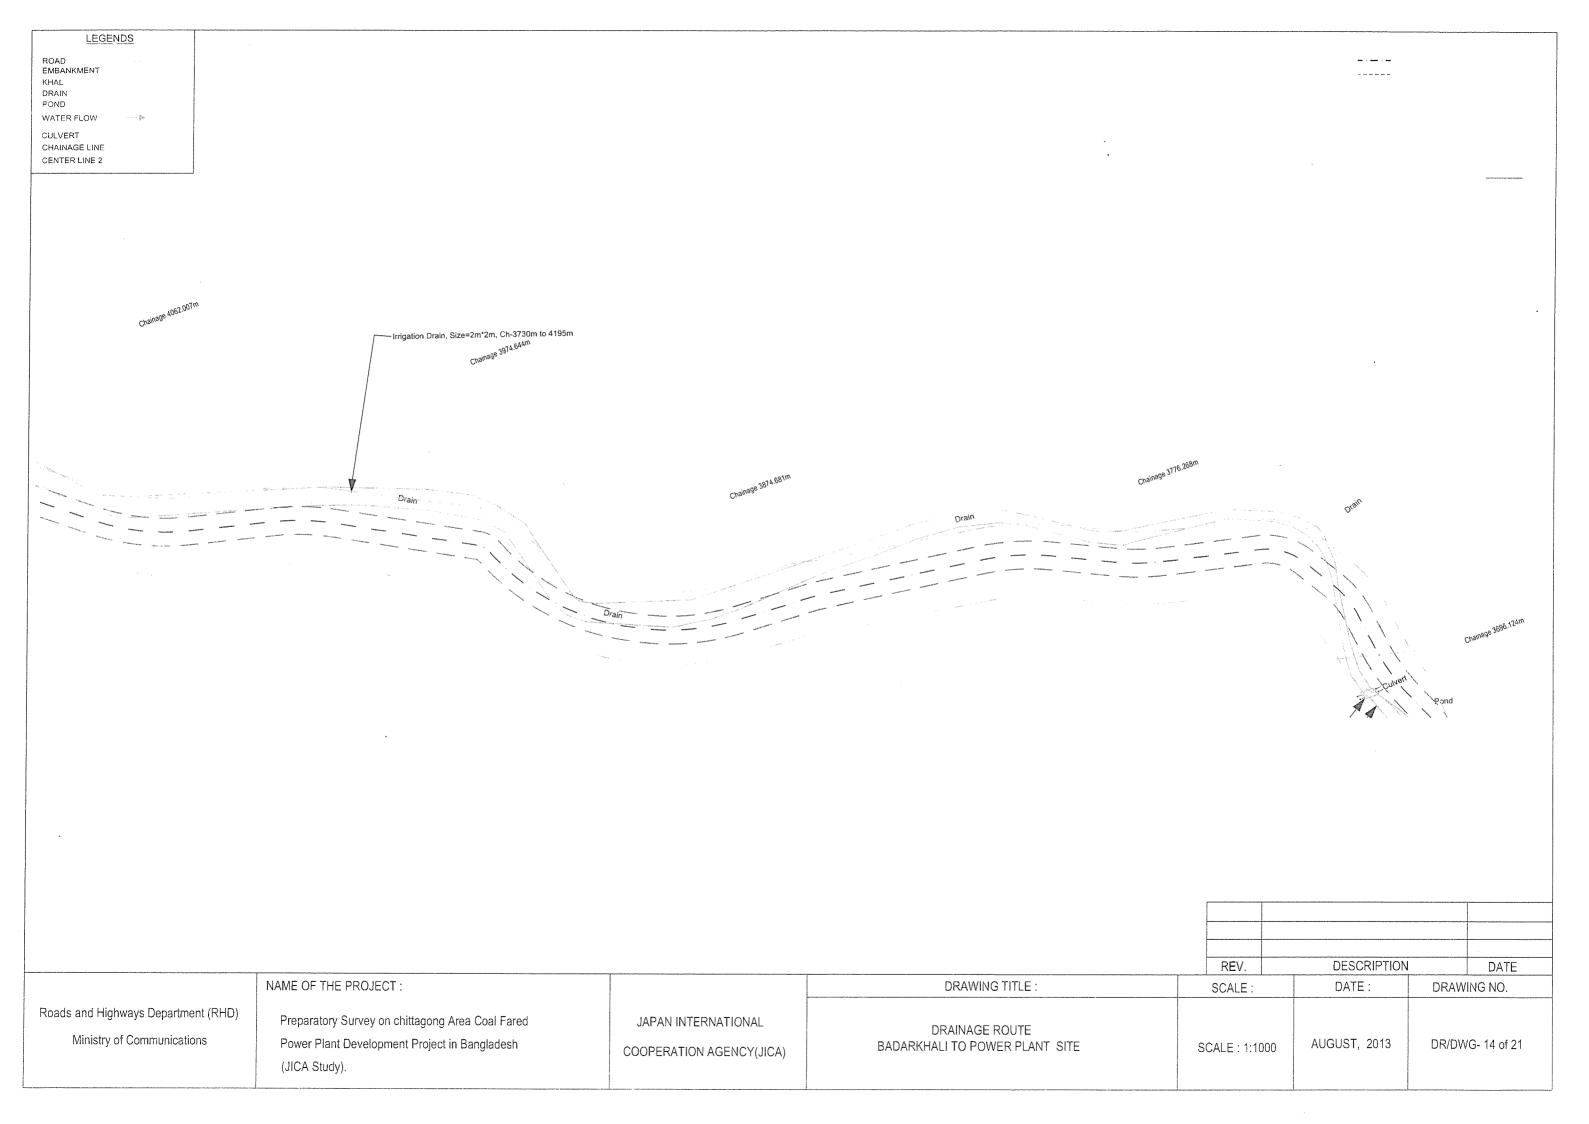


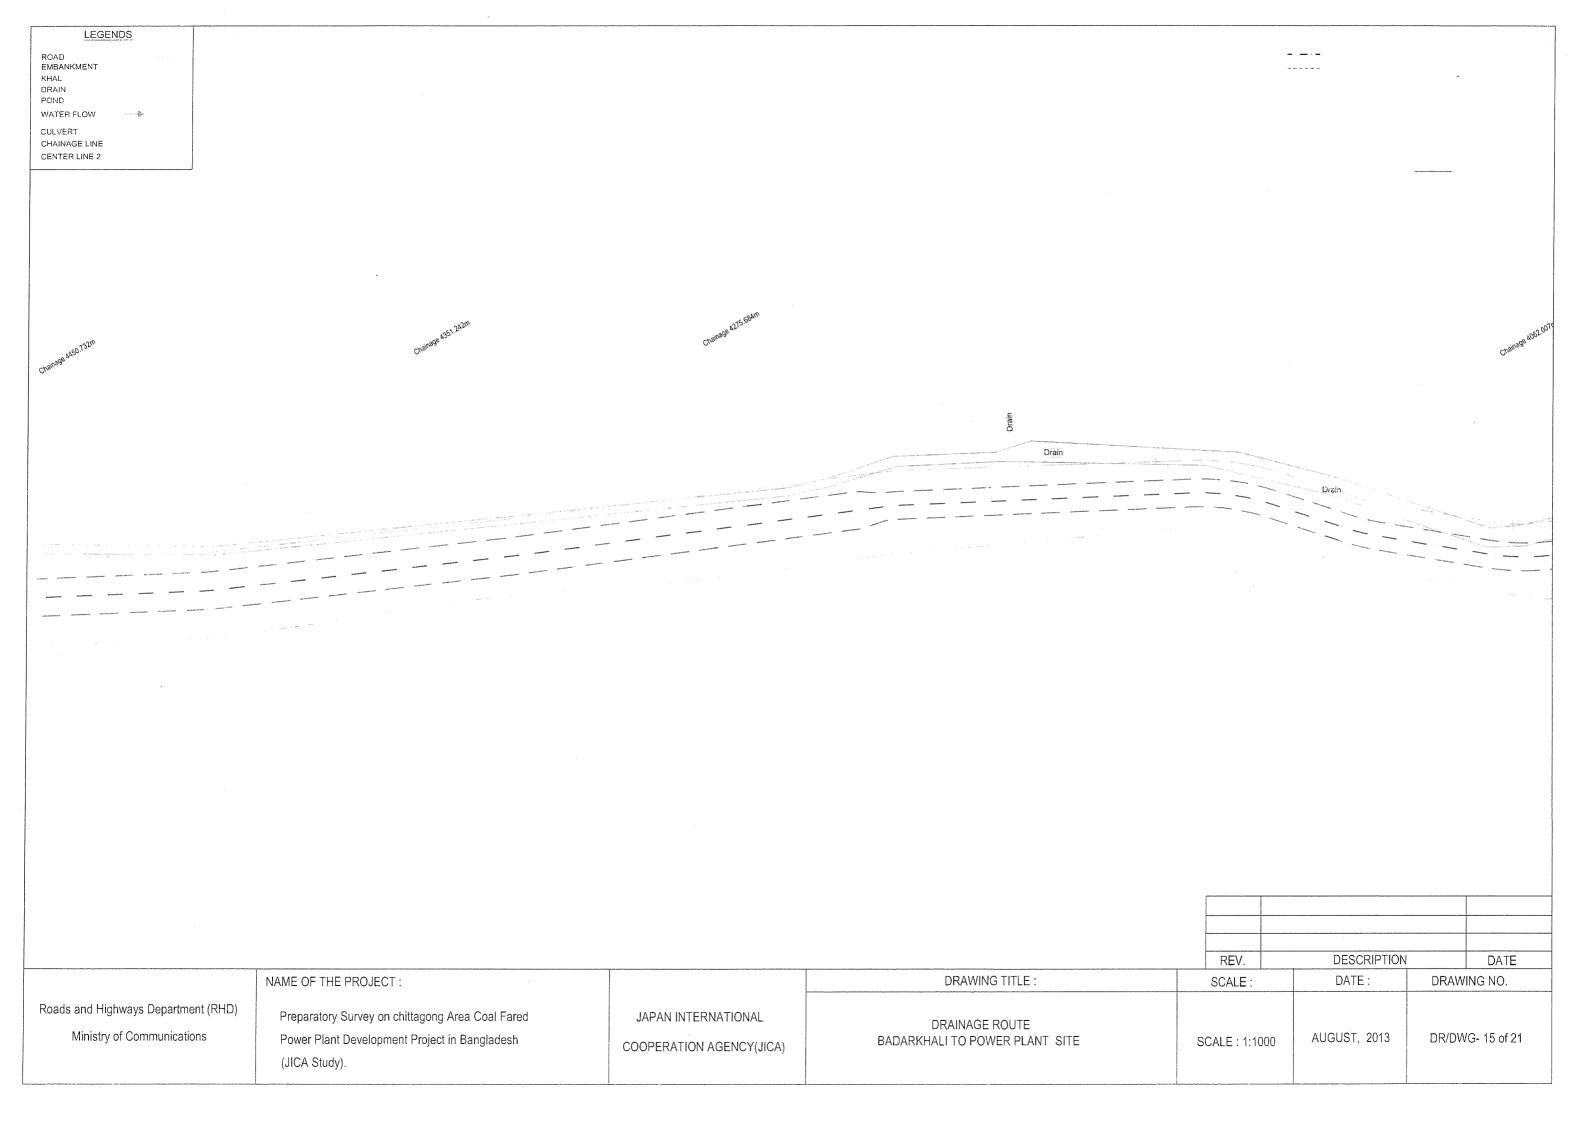


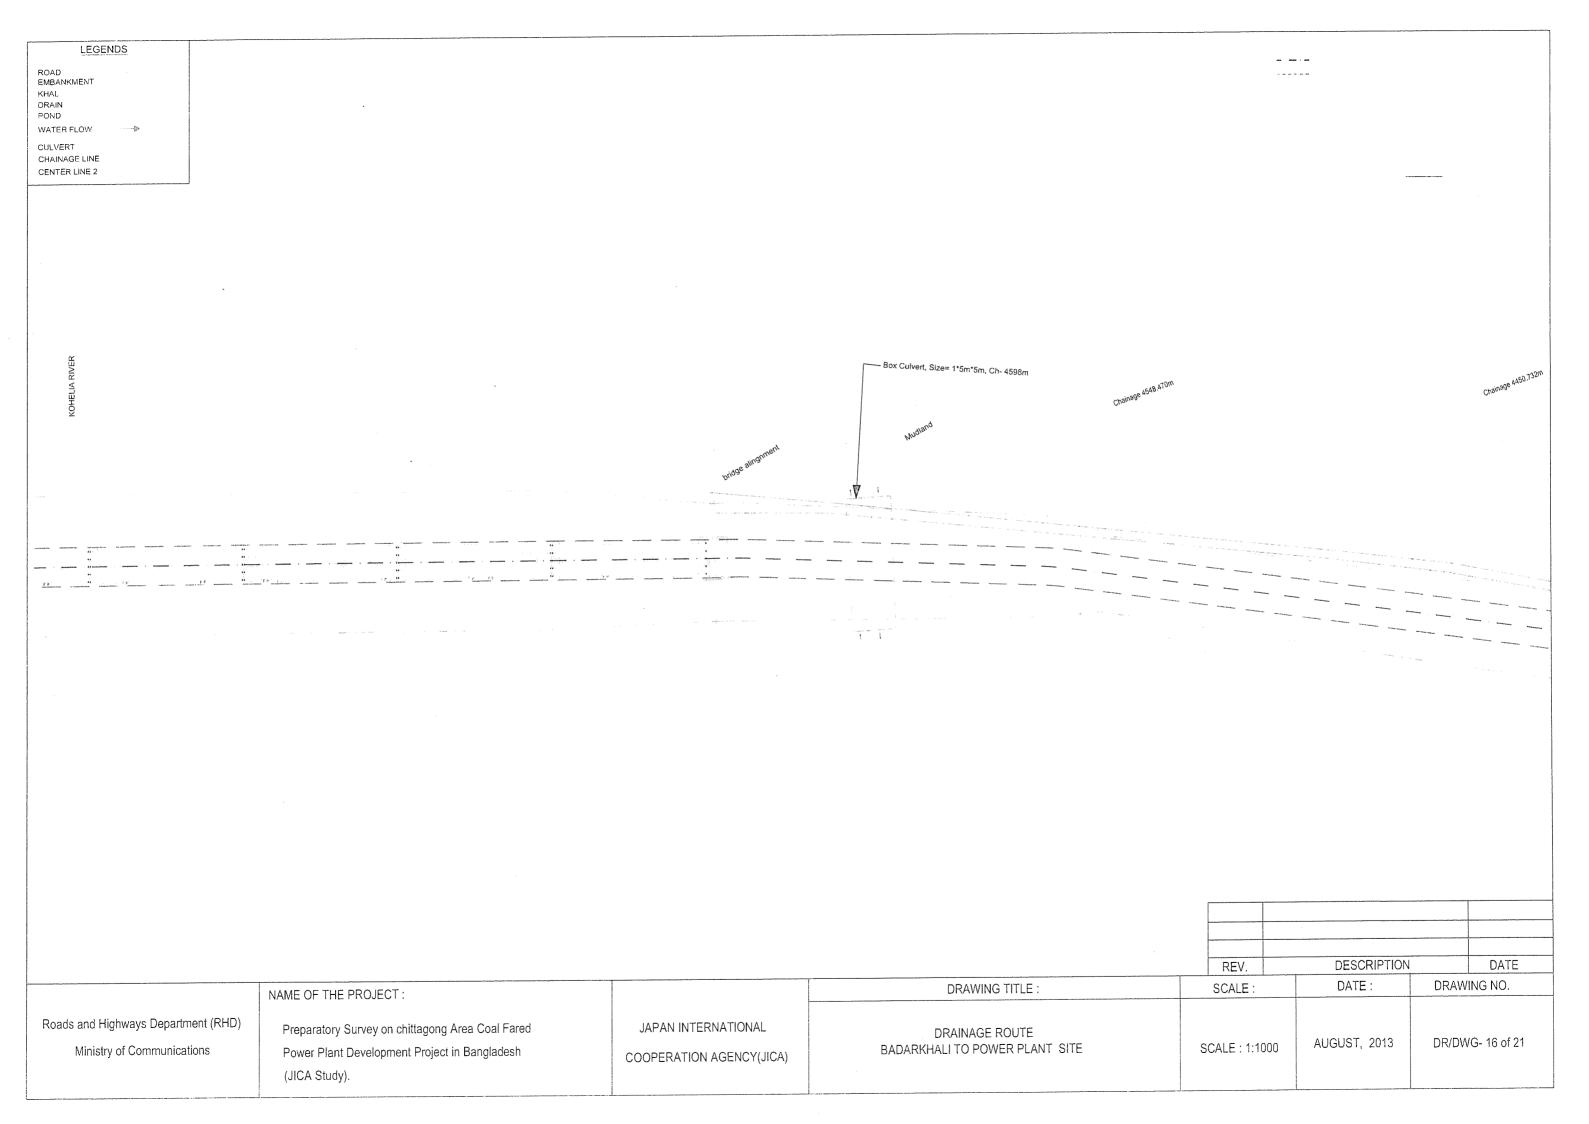



LEGENDS		**************************************				
ROAD EMBANKMENT						
EMBANKMENT KHAL DRAIN				~ ~ ~ ~ ~		
POND WATER FLOW						
CULVERT						
CHAINAGE LINE CENTER LINE 2						

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Roads and Highways Department (RHD)	Preparatory Survey on chittagong Area Coal Fared	JAPAN INTERNATIONAL	DRAINAGE ROUTE			
Ministry of Communications	Power Plant Development Project in Bangladesh	COOPERATION AGENCY(JICA)	BADARKHALI TO POWER PLANT SITE	SCALE: 1:1000	AUGUST, 2013	DR/DWG- 17 of 21
	(JICA Study).	200. Elethornochorno				
		And a series				

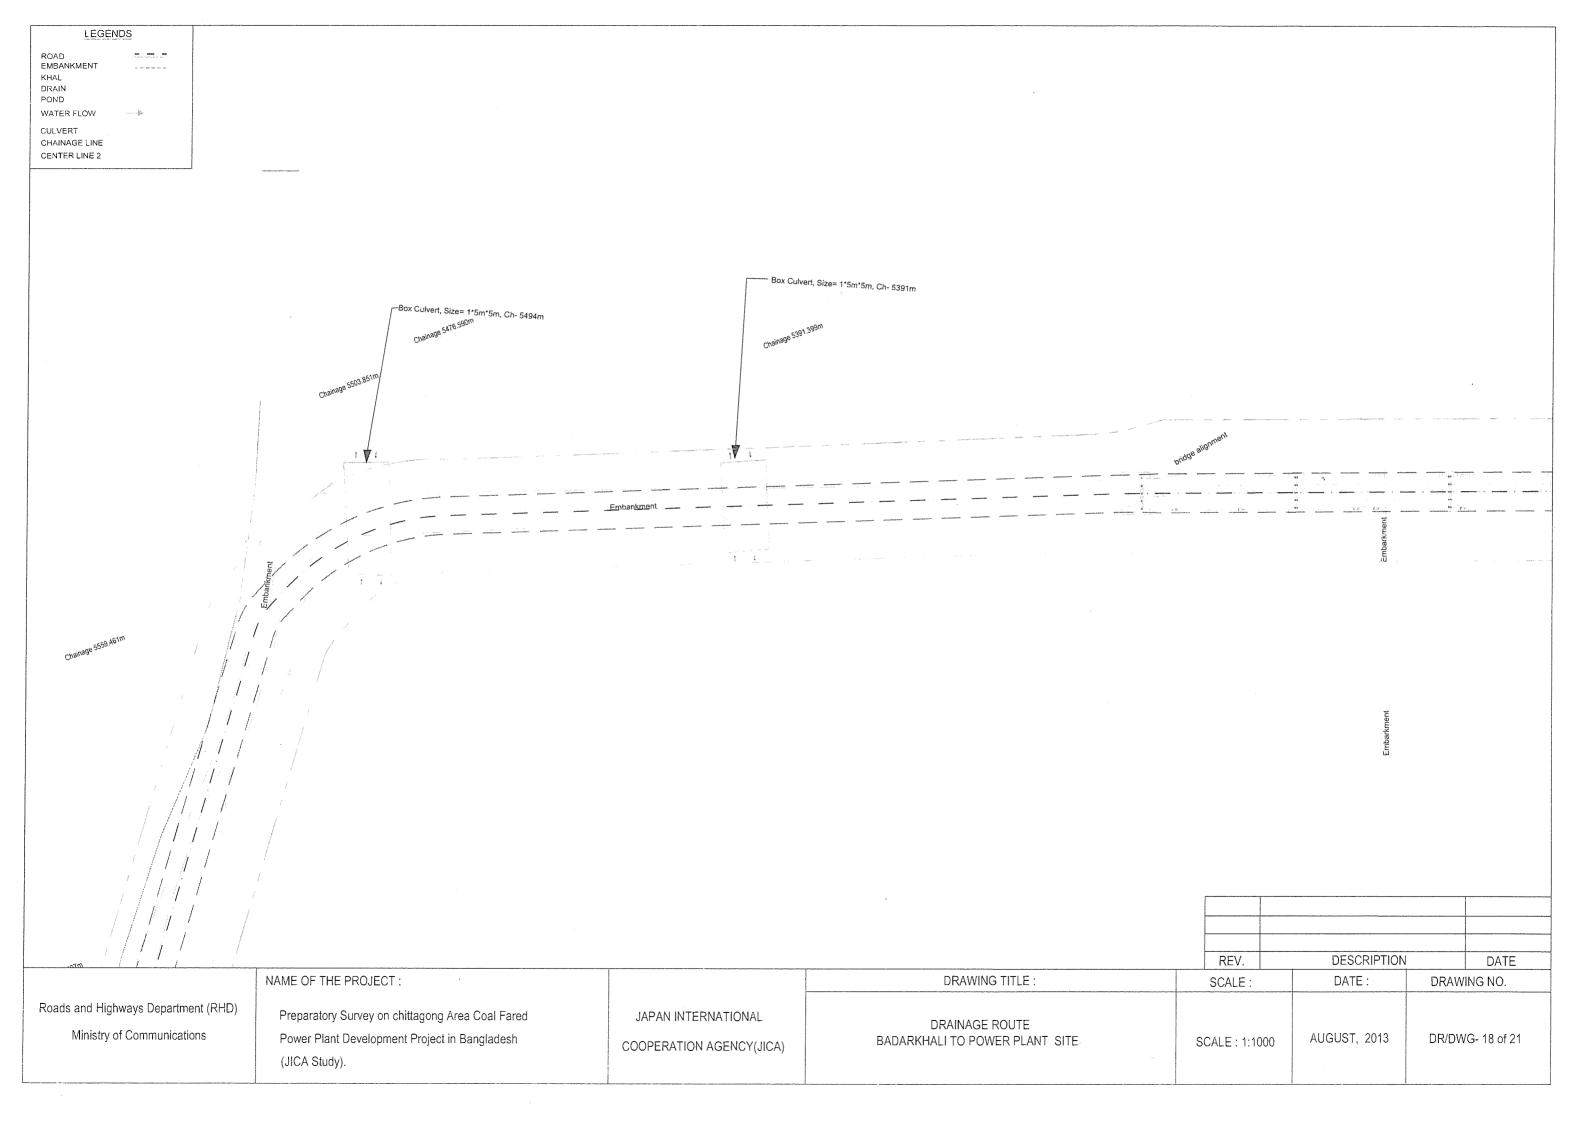

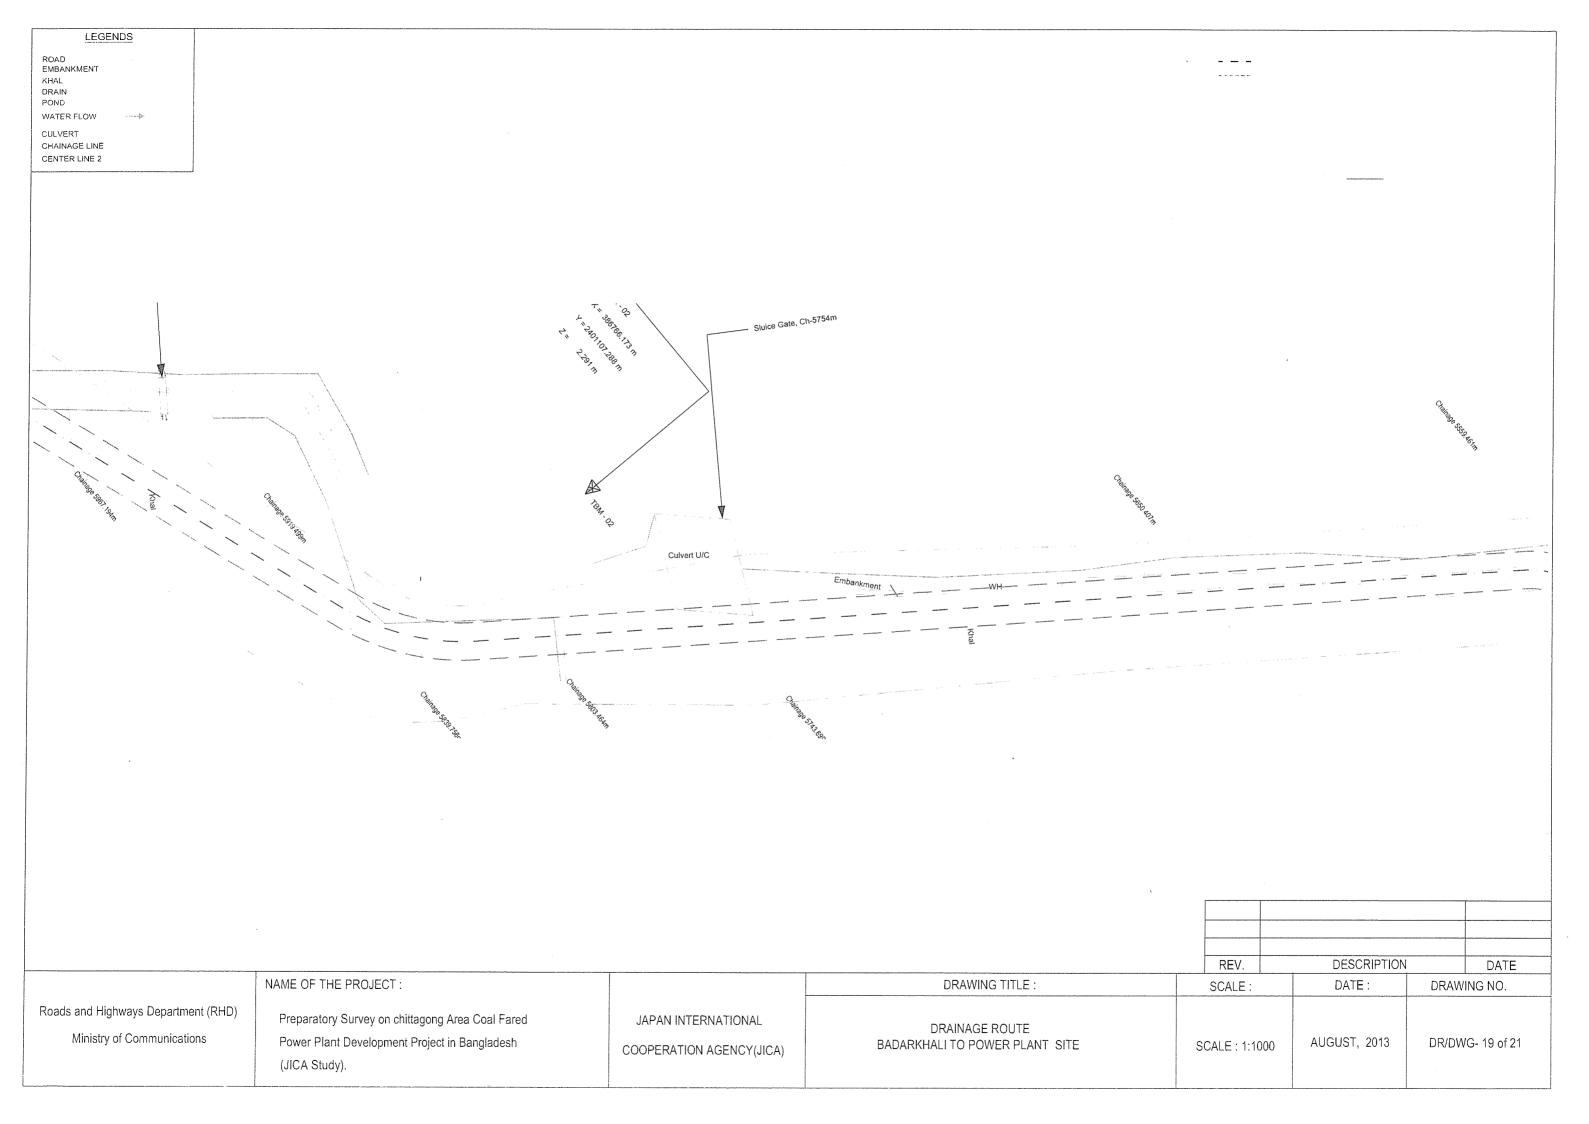


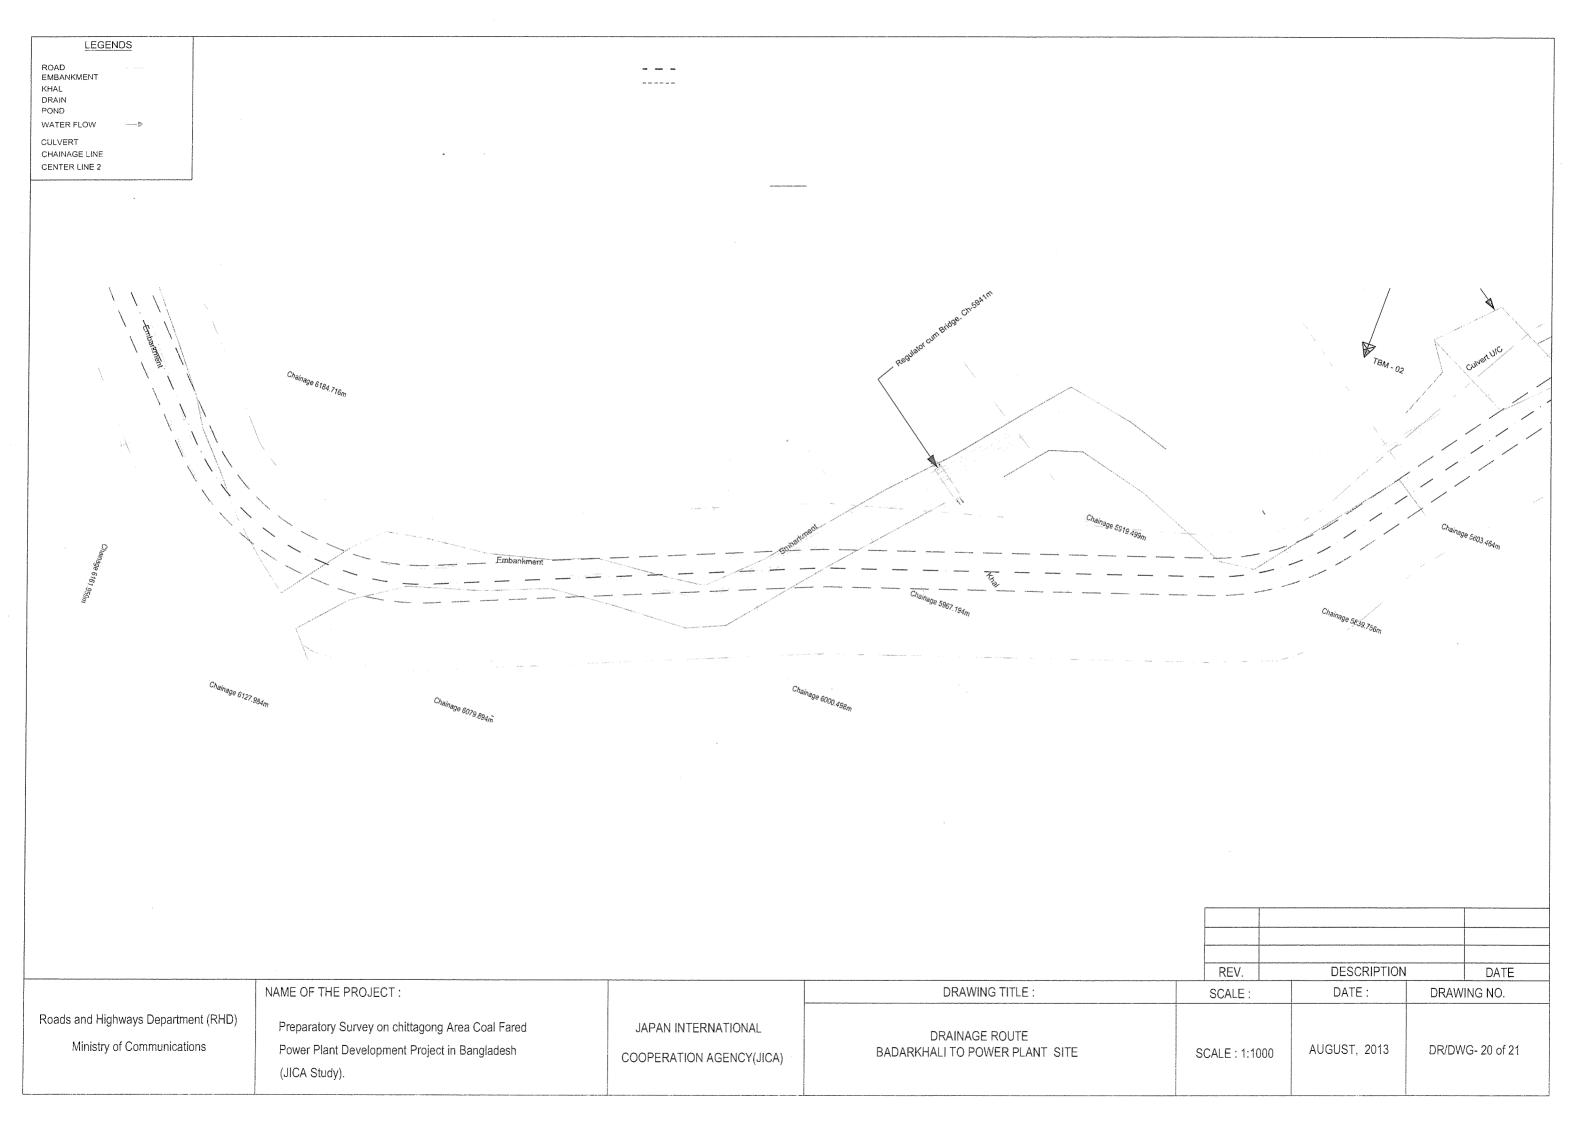

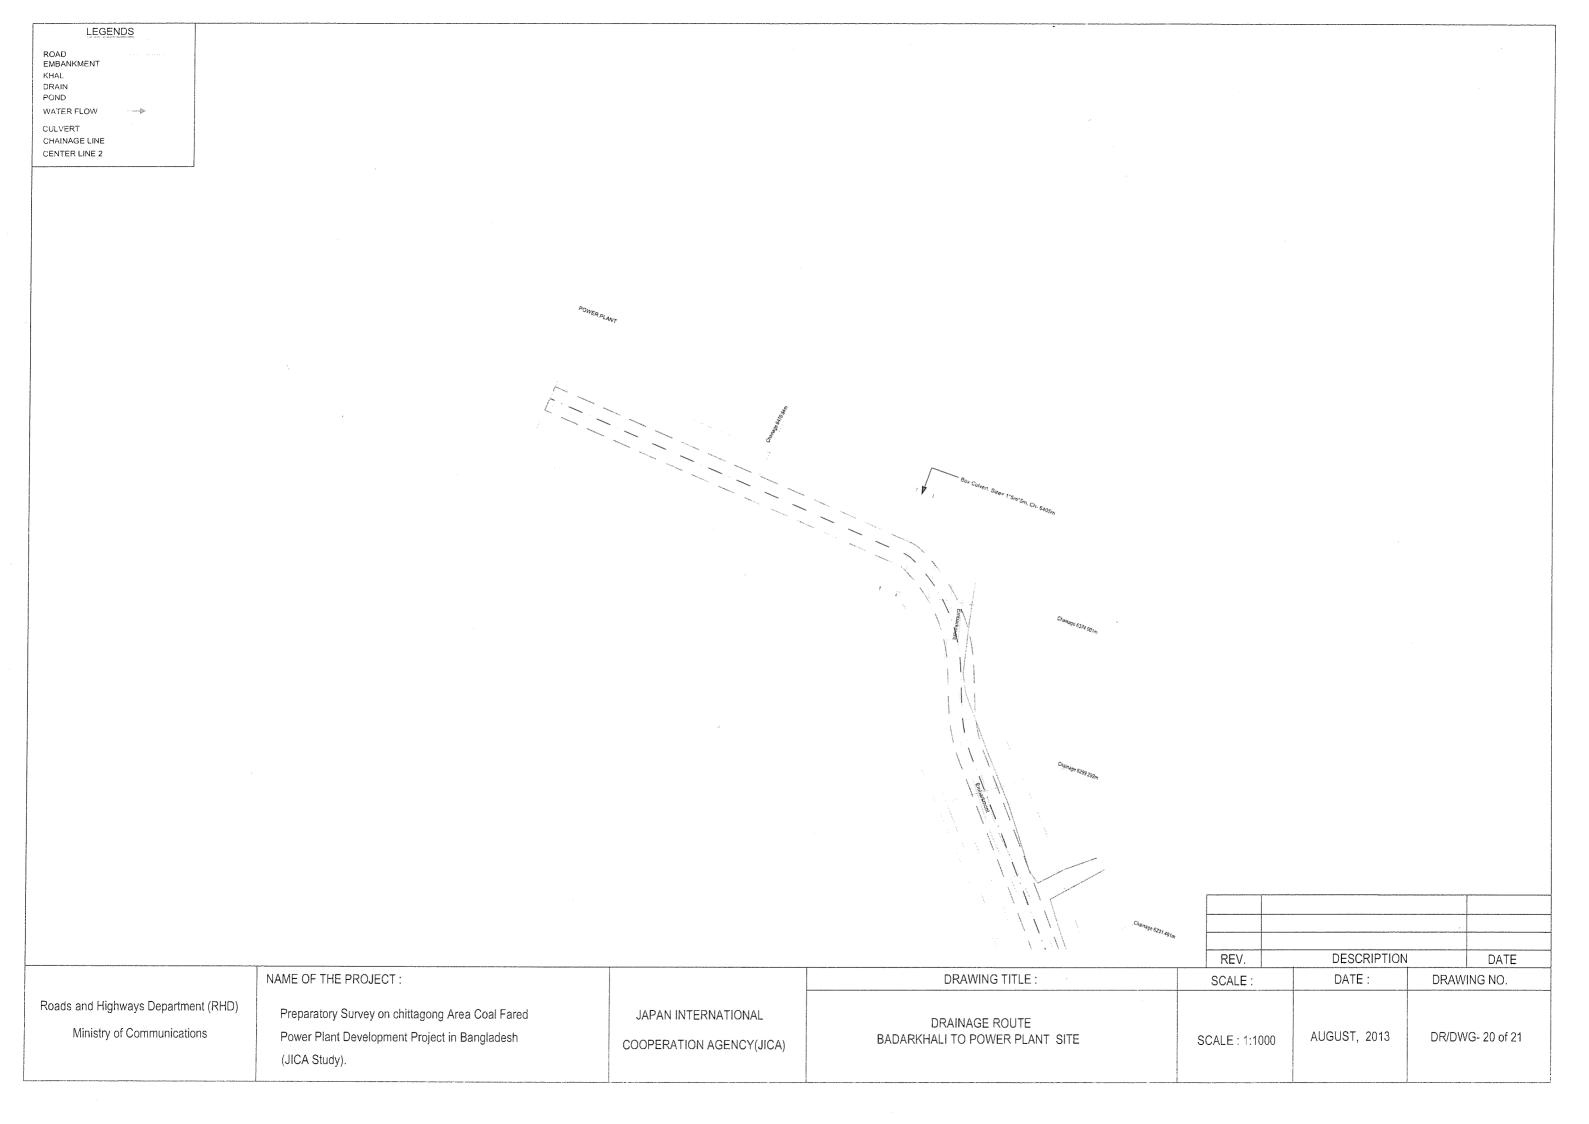

TYPICAL CROSS SECTION


1. (a)Ekota Bazar to Pekua Intersection, 50% Length to be Asphaltic Overlay

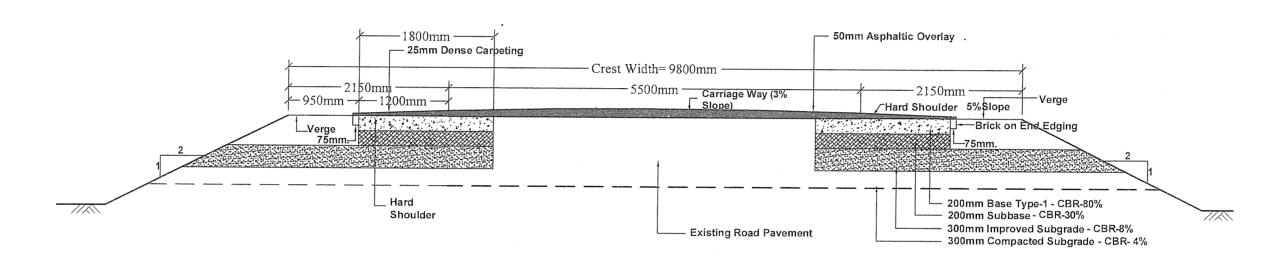

Section: Ekota Bazar to Pekua Intersection (Length Approx. 11.8Km)

				REV.	DESCRIPTIO	N DATE
	NAME OF THE PROJECT :		DRAWING TITLE :	SCALE:	DATE:	DRAWING NO.
Roads and Highways Department (RHD) Ministry of Communications	Preparatory Survey on chittagong Area Coal Fared Power Plant Development Project in Bangladesh (JICA Study).	JAPAN INTERNATIONAL COOPERATION AGENCY(JICA)	ROAD TYPICAL CROSS SECTION AKOTA BAZAR TO PEKUA INTERSECTION .	1 : 50	AUGUST, 2013	RDS/DWG-01 of 09


1. (b)Ekota Bazar to Pekua Intersection 50% Partial Reconstruction

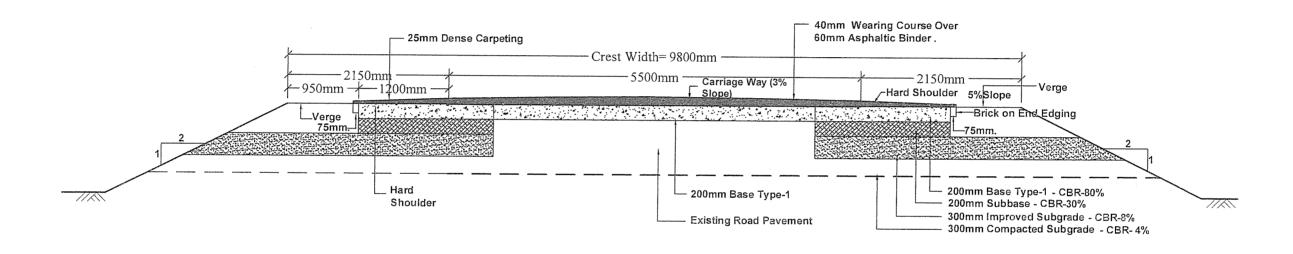

Section: Ekota Bazar to Pekua Intersection (Length Approx. 11.8Km)

				REV.	DESCRIPTIO	N DATE
	NAME OF THE PROJECT :		DRAWING TITLE :	SCALE:	DATE :	DRAWING NO.
Roads and Highways Department (RHD) Ministry of Communications	Preparatory Survey on chittagong Area Coal Fared Power Plant Development Project in Bangladesh (JICA Study).	JAPAN INTERNATIONAL COOPERATION AGENCY(JICA)	ROAD TYPICAL CROSS SECTION AKOTA BAZAR TO PEKUA INTERSECTION .	1:50	AUGUST, 2013	RDS/DWG-02 of 09


2. Pekua Intersection to Eidmoni Intersection Partial Reconstruction

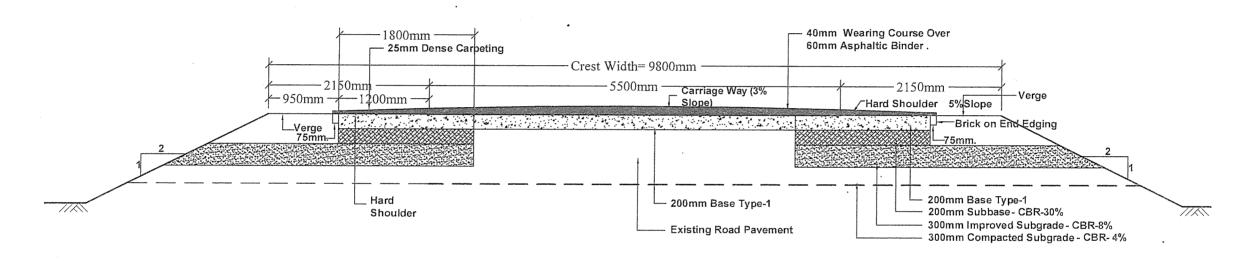

Section: Pekua Intersection to Eidmoni Intersection (Length Approx. 10.90Km)

				REV.	DESCRIPTIO	N DATE
•	NAME OF THE PROJECT :		DRAWING TITLE :	SCALE:	DATE:	DRAWING NO.
Roads and Highways Department (RHD) Ministry of Communications .	Preparatory Survey on chittagong Area Coal Fared Power Plant Development Project in Bangladesh (JICA Study).	JAPAN INTERNATIONAL COOPERATION AGENCY(JICA)	ROAD TYPICAL CROSS SECTION PEKUA INTERSECTION EIDMONI	1:50	AUGUST, 2013	RDS/DWG-03 of 09


3. Eidmoni Intersection to Janata Bazar Aspahaltic Overlay

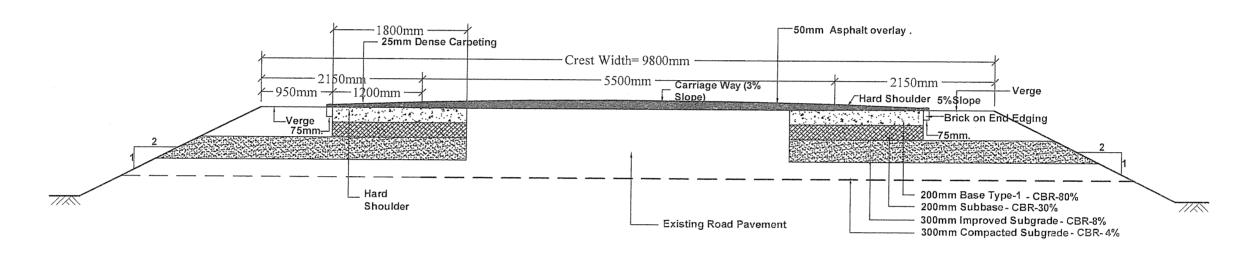

Section: Eidmoni Intersection to Janata Bazar (Length Approx. 8.6Km)

~				REV.	DESCRIPTION	N DATE
	NAME OF THE PROJECT :		DRAWING TITLE :	SCALE:	DATE:	DRAWING NO.
Roads and Highways Department (RHD) Ministry of Communications	Preparatory Survey on chittagong Area Coal Fared Power Plant Development Project in Bangladesh (JICA Study).	JAPAN INTERNATIONAL COOPERATION AGENCY(JICA)	ROAD TYPICAL CROSS SECTION EIDMONI TO JANATA BAZAR	1 : 50	AUGUST, 2013	RDS/DWG-04 of 09


4. Janata Bazar to Yunuskhali Intersection Full Reconstruction

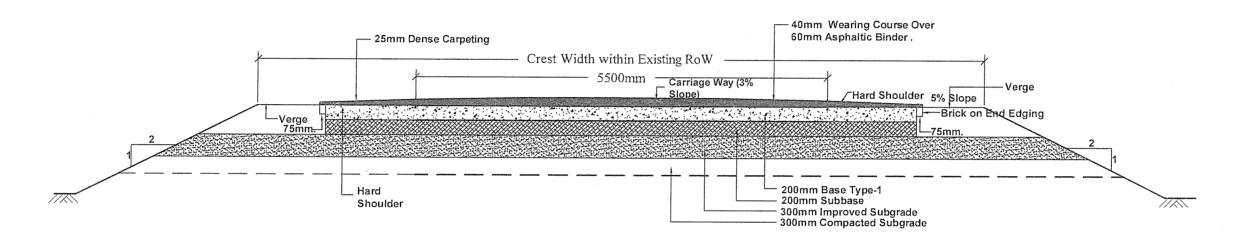

Section: Janata Bazar to Yunuskhali Intersection (Length Approx. 1.9Km)

				REV.	DESCRIPTIO	N DATE
	NAME OF THE PROJECT :		DRAWING TITLE :	SCALE:	DATE :	DRAWING NO.
Roads and Highways Department (RHD) Ministry of Communications .	Preparatory Survey on chittagong Area Coal Fared Power Plant Development Project in Bangladesh (JICA Study).	JAPAN INTERNATIONAL COOPERATION AGENCY(JICA)	ROAD TYPICAL CROSS SECTION JANATA BAZAR TO YUNUSKHALI VILLAGE	1 : 50	AUGUST, 2013	RDS/DWG-05 of 09


5. a. Yunuskhali End New Construction

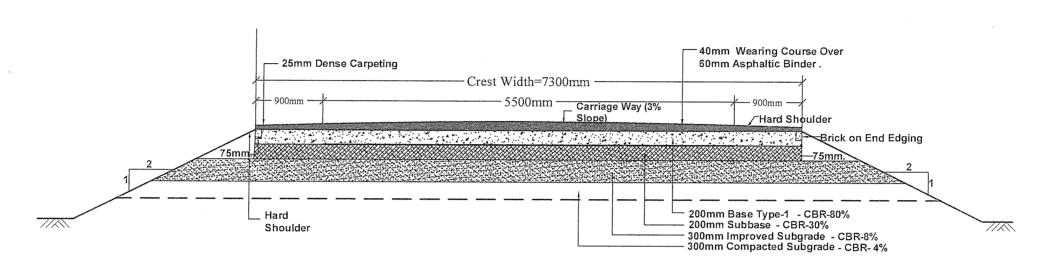

Section: ThroughYunuskhali village.(Length Approx. 1071.44 m, Ch-3125.56m to 4197m)

				REV.	DESCRIPTIO	N DATE
	NAME OF THE PROJECT :		DRAWING TITLE :	SCALE:	DATE:	DRAWING NO.
Roads and Highways Department (RHD) Ministry of Communications	Preparatory Survey on chittagong Area Coal Fared Power Plant Development Project in Bangladesh (JICA Study).	JAPAN INTERNATIONAL COOPERATION AGENCY(JICA)	ROAD TYPICAL CROSS SECTION YUNUSKHALI END .	1 : 50	AUGUST, 2013	RDS/DWG-06 _, of 09


5. b. Yunuskhali End New Construction

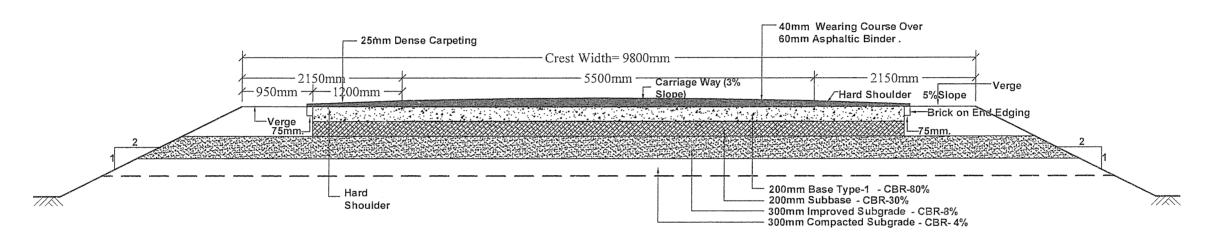

Section: New Construction through Salt Field at Yunuskhali End (Length Approx. 452m, Ch-4194.84 to 4647.84)

				REV.	DESCRIPTION	N DATE
	NAME OF THE PROJECT :		DRAWING TITLE :	SCALE:	DATE:	DRAWING NO.
Roads and Highways Department (RHD) Ministry of Communications	Preparatory Survey on chittagong Area Coal Fared Power Plant Development Project in Bangladesh (JICA Study).	JAPAN INTERNATIONAL COOPERATION AGENCY(JICA)	ROAD TYPICAL CROSS SECTION YUNUSKHALI VILLAGE	1:50	AUGUST, 2013	RDS/DWG-07 of 09


6. (a) New Construction through Salt Field

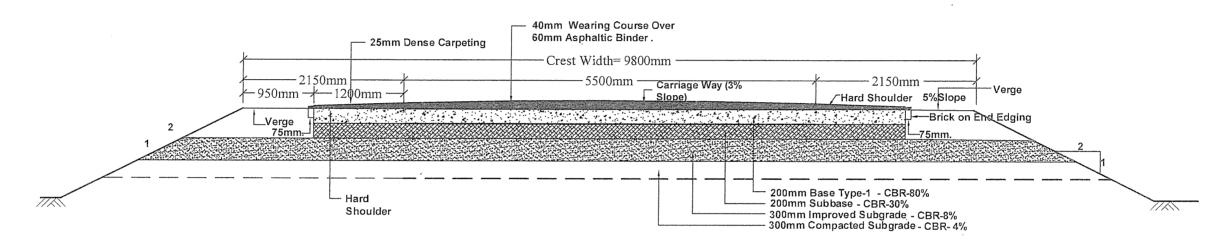

Section: New Construction through Salt Field (Length approx. 659.86m)


				REV.	DESCRIPTIO	N DATE
	NAME OF THE PROJECT :		DRAWING TITLE :	SCALE:	DATE:	DRAWING NO.
Roads and Highways Department (RHD) Ministry of Communications	Preparatory Survey on chittagong Area Coal Fared Power Plant Development Project in Bangladesh (JICA Study).	JAPAN INTERNATIONAL COOPERATION AGENCY(JICA)	ROAD TYPICAL CROSS SECTION NEW CONSTRUCTION THROUGH SALT FIELD	1:50	AUGUST, 2013	RDS/DWG-08 of 09

New Construction over BWDB Embankment

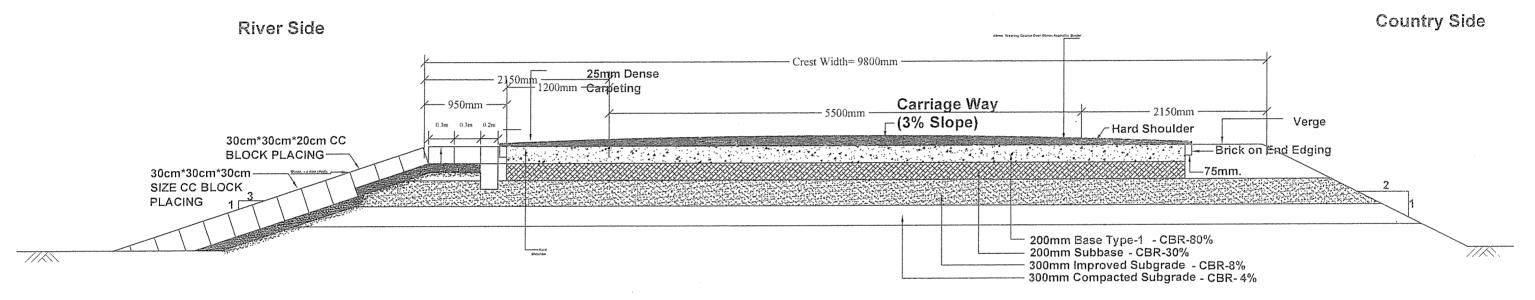

Section: New Construction over BWDB Embankment (Length Approx.605.75m)

			•	REV.	DESCRIPTION	
	NAME OF THE PROJECT :		DRAWING TITLE :	SCALE:	DATE :	DRAWING NO.
Roads and Highways Department (RHD) Ministry of Communications	Preparatory Survey on chittagong Area Coal Fared Power Plant Development Project in Bangladesh (JICA Study).	JAPAN INTERNATIONAL COOPERATION AGENCY(JICA)	ROAD CROSS SECTION WITH REVETMENT	1 : 40	AUGUST, 2013	RDS/DWG

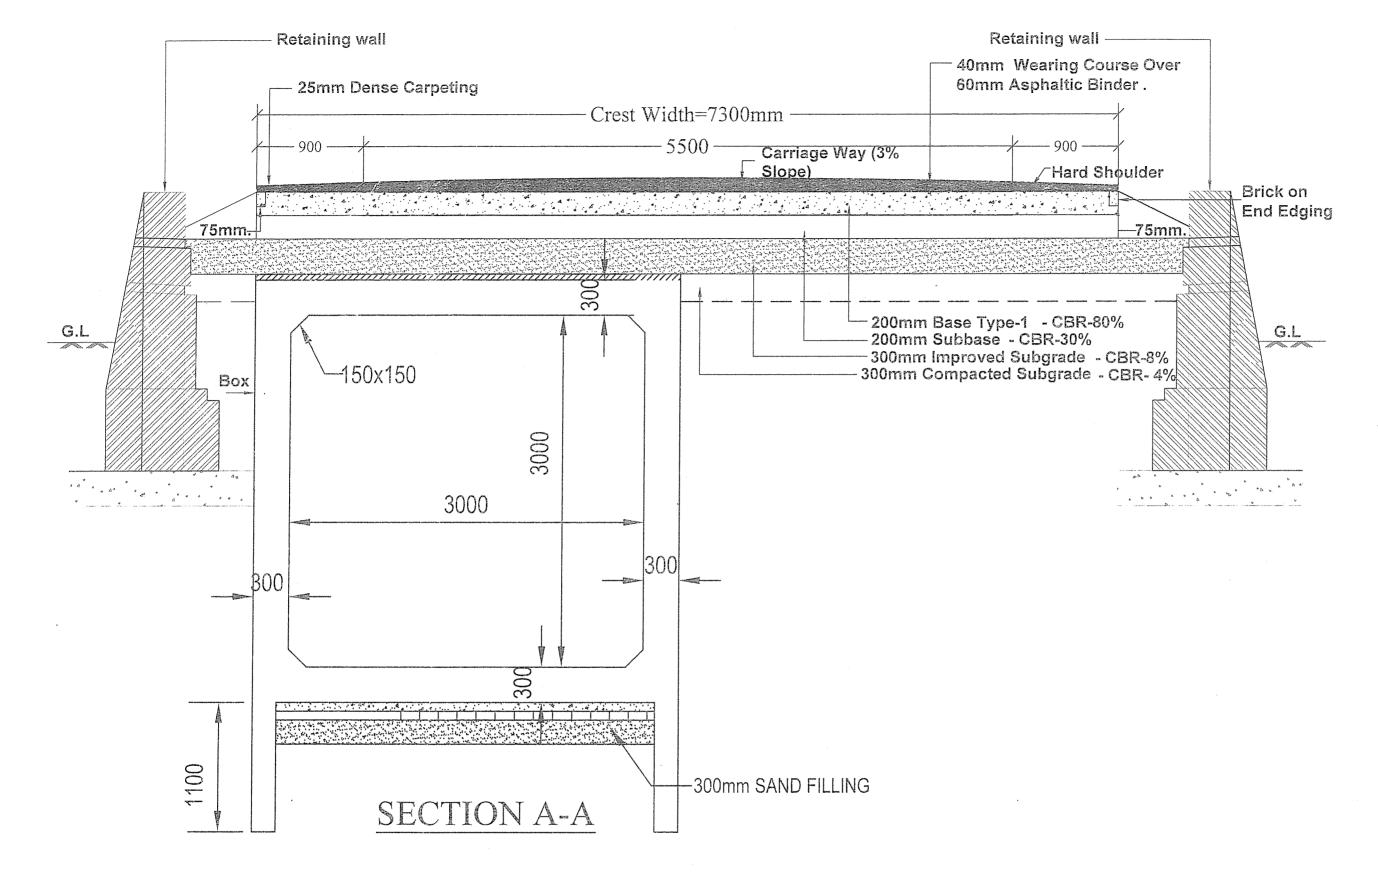

Section: Near Yunuskhali Intersection (Chainage- 3173.43m)

				REV.	DESCRIPTION	N	DATE
	NAME OF THE PROJECT :		DRAWING TITLE :	SCALE:	DATE :	DRAWII	NG NO.
Roads and Highways Department (RHD) Ministry of Communications	Preparatory Survey on chittagong Area Coal Fared Power Plant Development Project in Bangladesh (JICA Study).	JAPAN INTERNATIONAL COOPERATION AGENCY(JICA)	ROAD TYPICAL CROSS SECTION NEAR YUNUSKHALI INTERSECTION	1:30	AUGUST, 2013	RS/DW(G-01 of 01