


B1-5100-01

SOIL AND VENT PIPING SYSTEM SCHEMATIC DIAGRAM


representation of the second s	PREPARED BY:	RECOMMENDNG APPROVAL:	APPROVED:	PROJECT TITLE:				SHEET CONTENTS:	SHEET NO:
Republic of the Philippines DEPARTMENT OF TRANSPORTATION AND COMMUNICATIONS Republic of the Philippines JAPAN INTERNATION COOPERATION AGENCY	LEOVIMEL J. VINELES Filipino Registered Engineer			NEW DOLLOL AIDDODE CONCEDITOTION AND			_	COMPONENT-4: BUILDING WO SUBCOMPONENT-4-1:	B1-5100-0°
JICA DESIGN CONSULTANT JOINT VENTURE	PROF: SANITARY ENGINEER PTR. 2024236 REG. NO.: 0002435 DATE: 07-09-2013 T.I.N. 237-652-602-000 PLACE: MANILA			NEW BOHOL AIRPORT CONSTRUCTION AND SUSTAINABLE ENVIRONMENT PROTECTION PROJECT				(B1) PASSENGER TERMINAL E	BUILDING (PTB) DRAWING SCALE:
JAC JAPAN AIRPORT CONSULTANTS, INC. NIPPON KOEI CO., LTD. NJS CONSULTO.		ILDEFONSO T. PATDU, JR. Assistant 1 Secretary	JULIANITO G. BUCAYAN, JR. Undersecretary		JUNE 2013		WIM	HC MECHANICAL SANITARY AND PLUMBING SOIL & VENT PIPING SYSTEM SCHEMAT	
INC. CO., LTD. CO., L	Team Leader	for Project Implementation, DOTC		LOCATION: MUNICIPALITY OF PANGLAO, PROVINCE OF BOHOL, PHILIPPINES	DATE INDEX	AMENDMENTS Prepared by	Checked by		

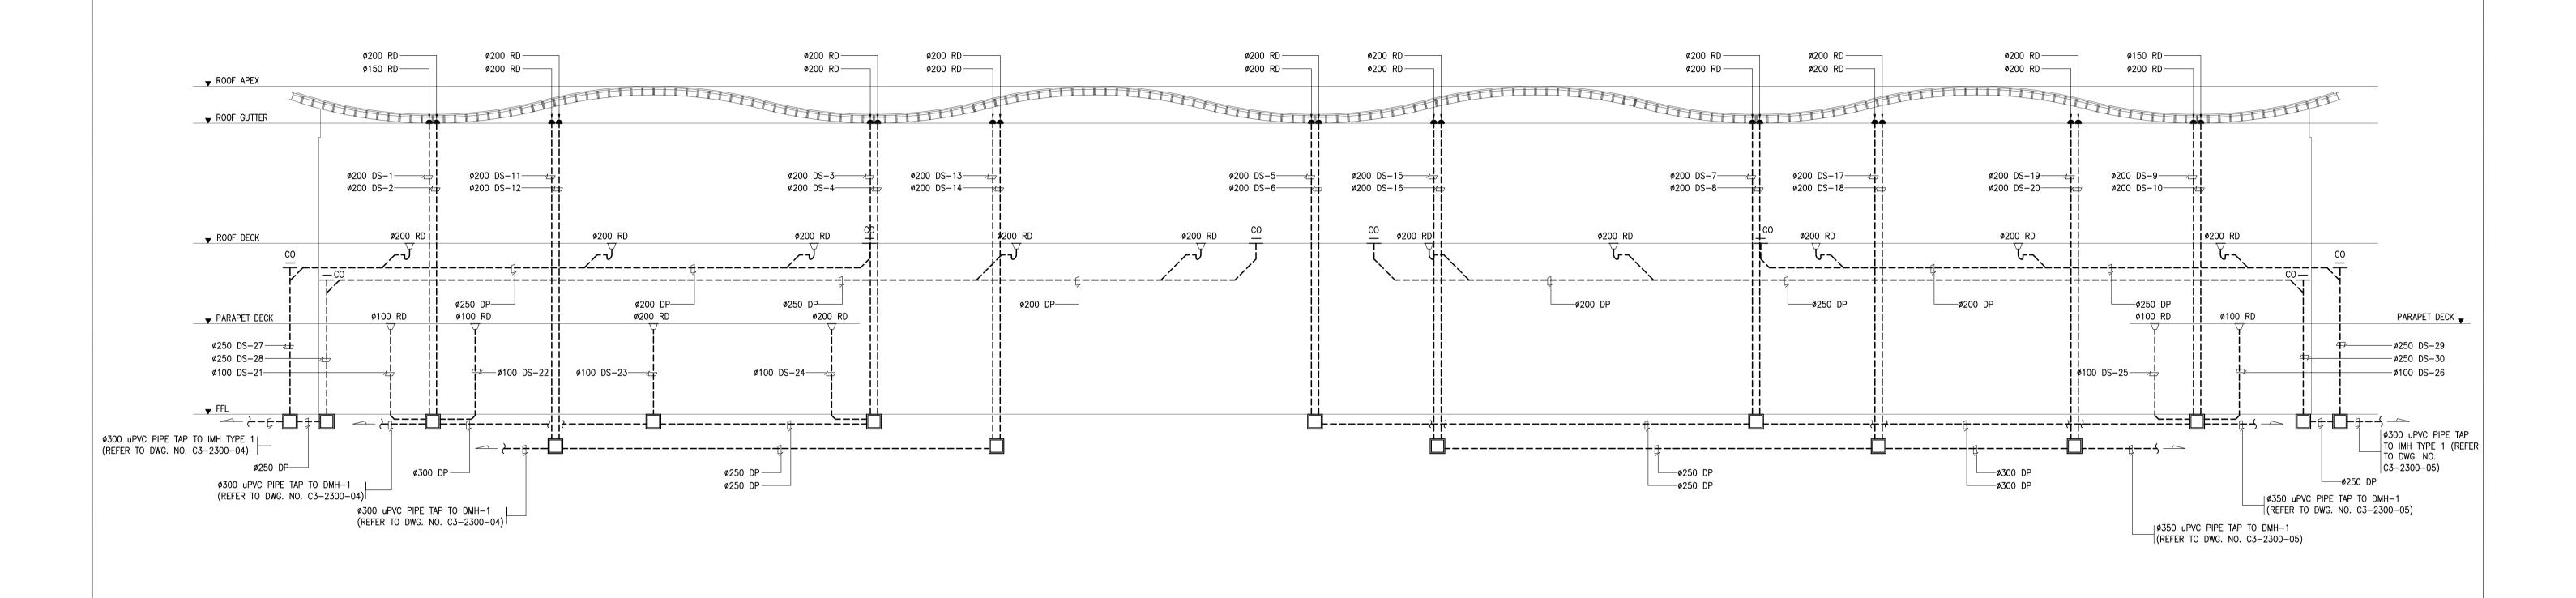

1 S7
B1-5100-02 NTS


STORM DRAINAGE PIPING SYSTEM SCHEMATIC DIAGRAM


	transortation top		PREPARED BY:	RECOMMENDNG APPROVAL:	APPROVED:	PROJECT TITLE:				SHEET CONTENTS:	SHEET NO:
(Republic of the Philippines DEPARTMENT OF TRANSPORTATION AND	JAPAN INTERNATIONAL COOPERATION AGENCY	LEOVIMEL J. VINELES						-	COMPONENT-4: BUILDING WORKS (B) SUBCOMPONENT-4-1:	B1-5100-02
	COMMUNICATIONS	AGENCY	Filipino Registered Engineer			NEW BOHOL AIRPORT CONSTRUCTION AND				(B1) PASSENGER TERMINAL BUILDING (PTB)	
	JICA DESIGN CONSULT	ANT JOINT VENTURE	T.I.N. 237-652-602-000 PLACE: MANILA	1		SUSTAINABLE ENVIRONMENT PROTECTION PROJECT					DRAWING SCALE:
	AC S JAPAN AIRPORT CONSULTANTS, INC.	NIPPON KOEI CO., LTD. NJS CONSULTANTS CO., LTD.	TADASHI AOI	ILDEFONSO T. PATDU, JR. Assistant Secretary	JULIANITO G. BUCAYAN, JR.		JUNE 2013	WIM	НС	MECHANICAL SANITARY AND PLUMBING STORM DRAINAGE PIPING SYSTEM SCHEMATIC DIAGRAM	NTS
	INC.	CO., LTD.	Team Leader	for Project Implementation, DOTC	Undersecretary for Project Implementation, DOTC	LOCATION: MUNICIPALITY OF PANGLAO, PROVINCE OF BOHOL, PHILIPPINES	DATE INDEX AMENDMENTS	Prepared Checked by	Validated by	STORM STORM STORM STORM STORM	

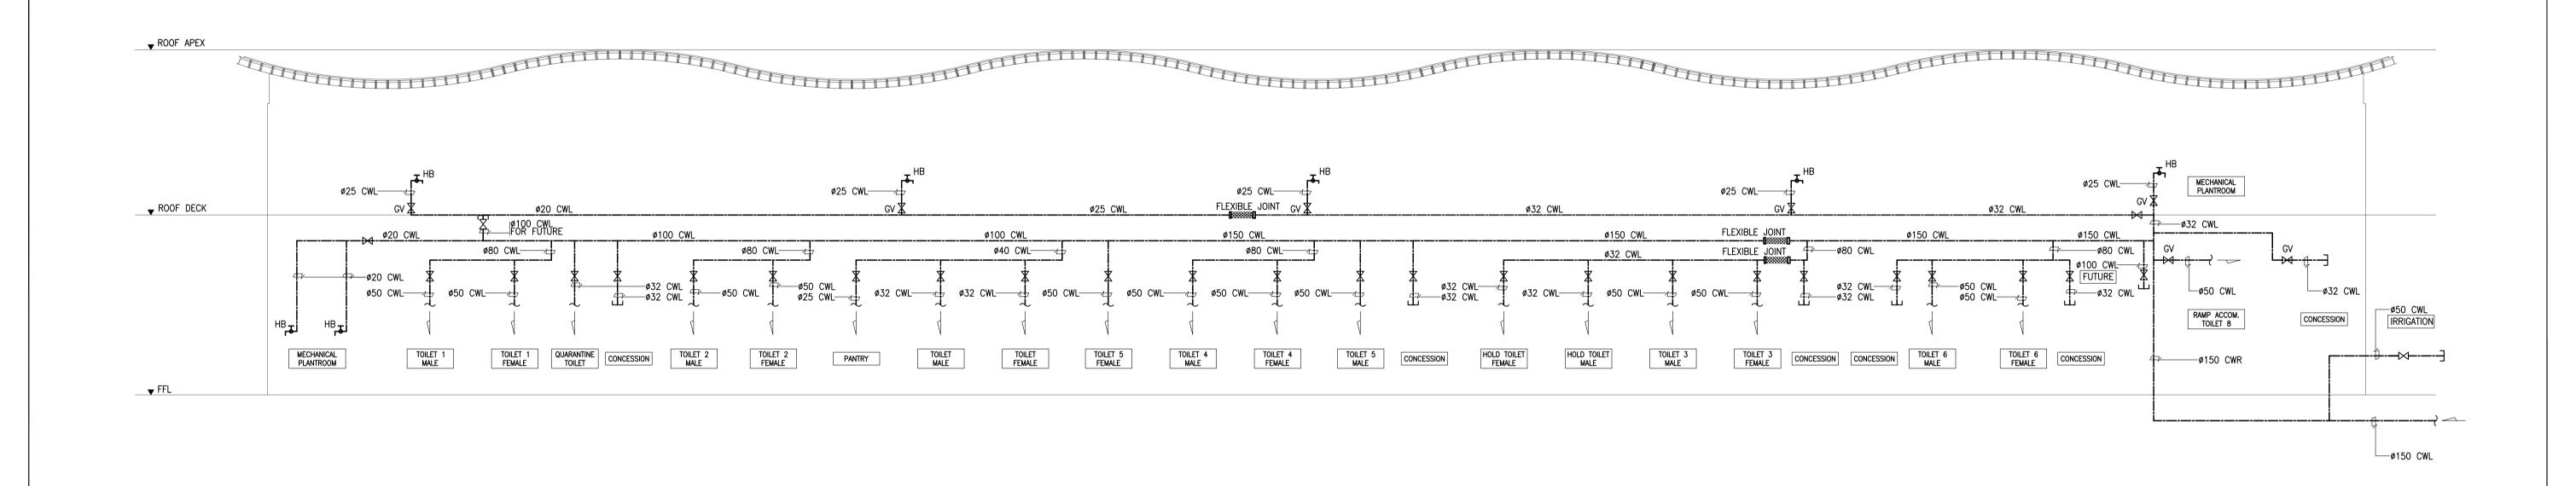






transportation area		PREPARED BY:	RECOMMENDNG APPROVAL:	APPROVED:	PROJECT TITLE:					SHEET CONTENTS:	SHEET NO:
Republic of the Philippines DEPARTMENT OF TRANSPORTATION AND	JAPAN INTERNATIONAL COOPERATION AGENCY	LEOVIMEL J. VINELES				- -	_		_	COMPONENT—4: BUILDING WORKS (B)	B1-5100-03
COMMUNICATIONS		Filipino Registered Engineer PROF: SANITARY ENGINEER PTR. 2024236			NEW BOHOL AIRPORT CONSTRUCTION AND					SUBCOMPONENT-4-1: (B1) PASSENGER TERMINAL BUILDING (PTB)	B1 0100 00
JICA DESIGN CONSULT	TANT JOINT VENTURE	REG. NO.: 0002435 DATE: 07-09-2013 T.I.N. 237-652-602-000 PLACE: MANILA			SUSTAINABLE ENVIRONMENT PROTECTION PROJECT						DRAWING SCALE:
JAC JAPAN AIRPORT CONSULTANTS, INC.	NIPPON KOEI CO., LTD. NJS CONSULTANTS CO., LTD.	TADACHI AOI	ILDEFONSO T. PATDU, JR.	JULIANITO G. BUCAYAN, JR.		JUNE 2013		WIM	НС	MECHANICAL SANITARY AND PLUMBING COLD WATER SUPPLY SYSTEM SCHEMATIC DIAGRAM	NTS
INC.	CO., LTD.	TADASHI AOI Team Leader	Assistant Secretary for Project Implementation, DOTC	Undersecretary for Project Implementation, DOTC	LOCATION: MUNICIPALITY OF PANGLAO, PROVINCE OF BOHOL, PHILIPPINES	DATE INDEX	AMENDMENTS	Prepared Checked by by	Validated by	- COLD WATER SOLIE STOLEN SCHEMATIC DIAGRAM	6

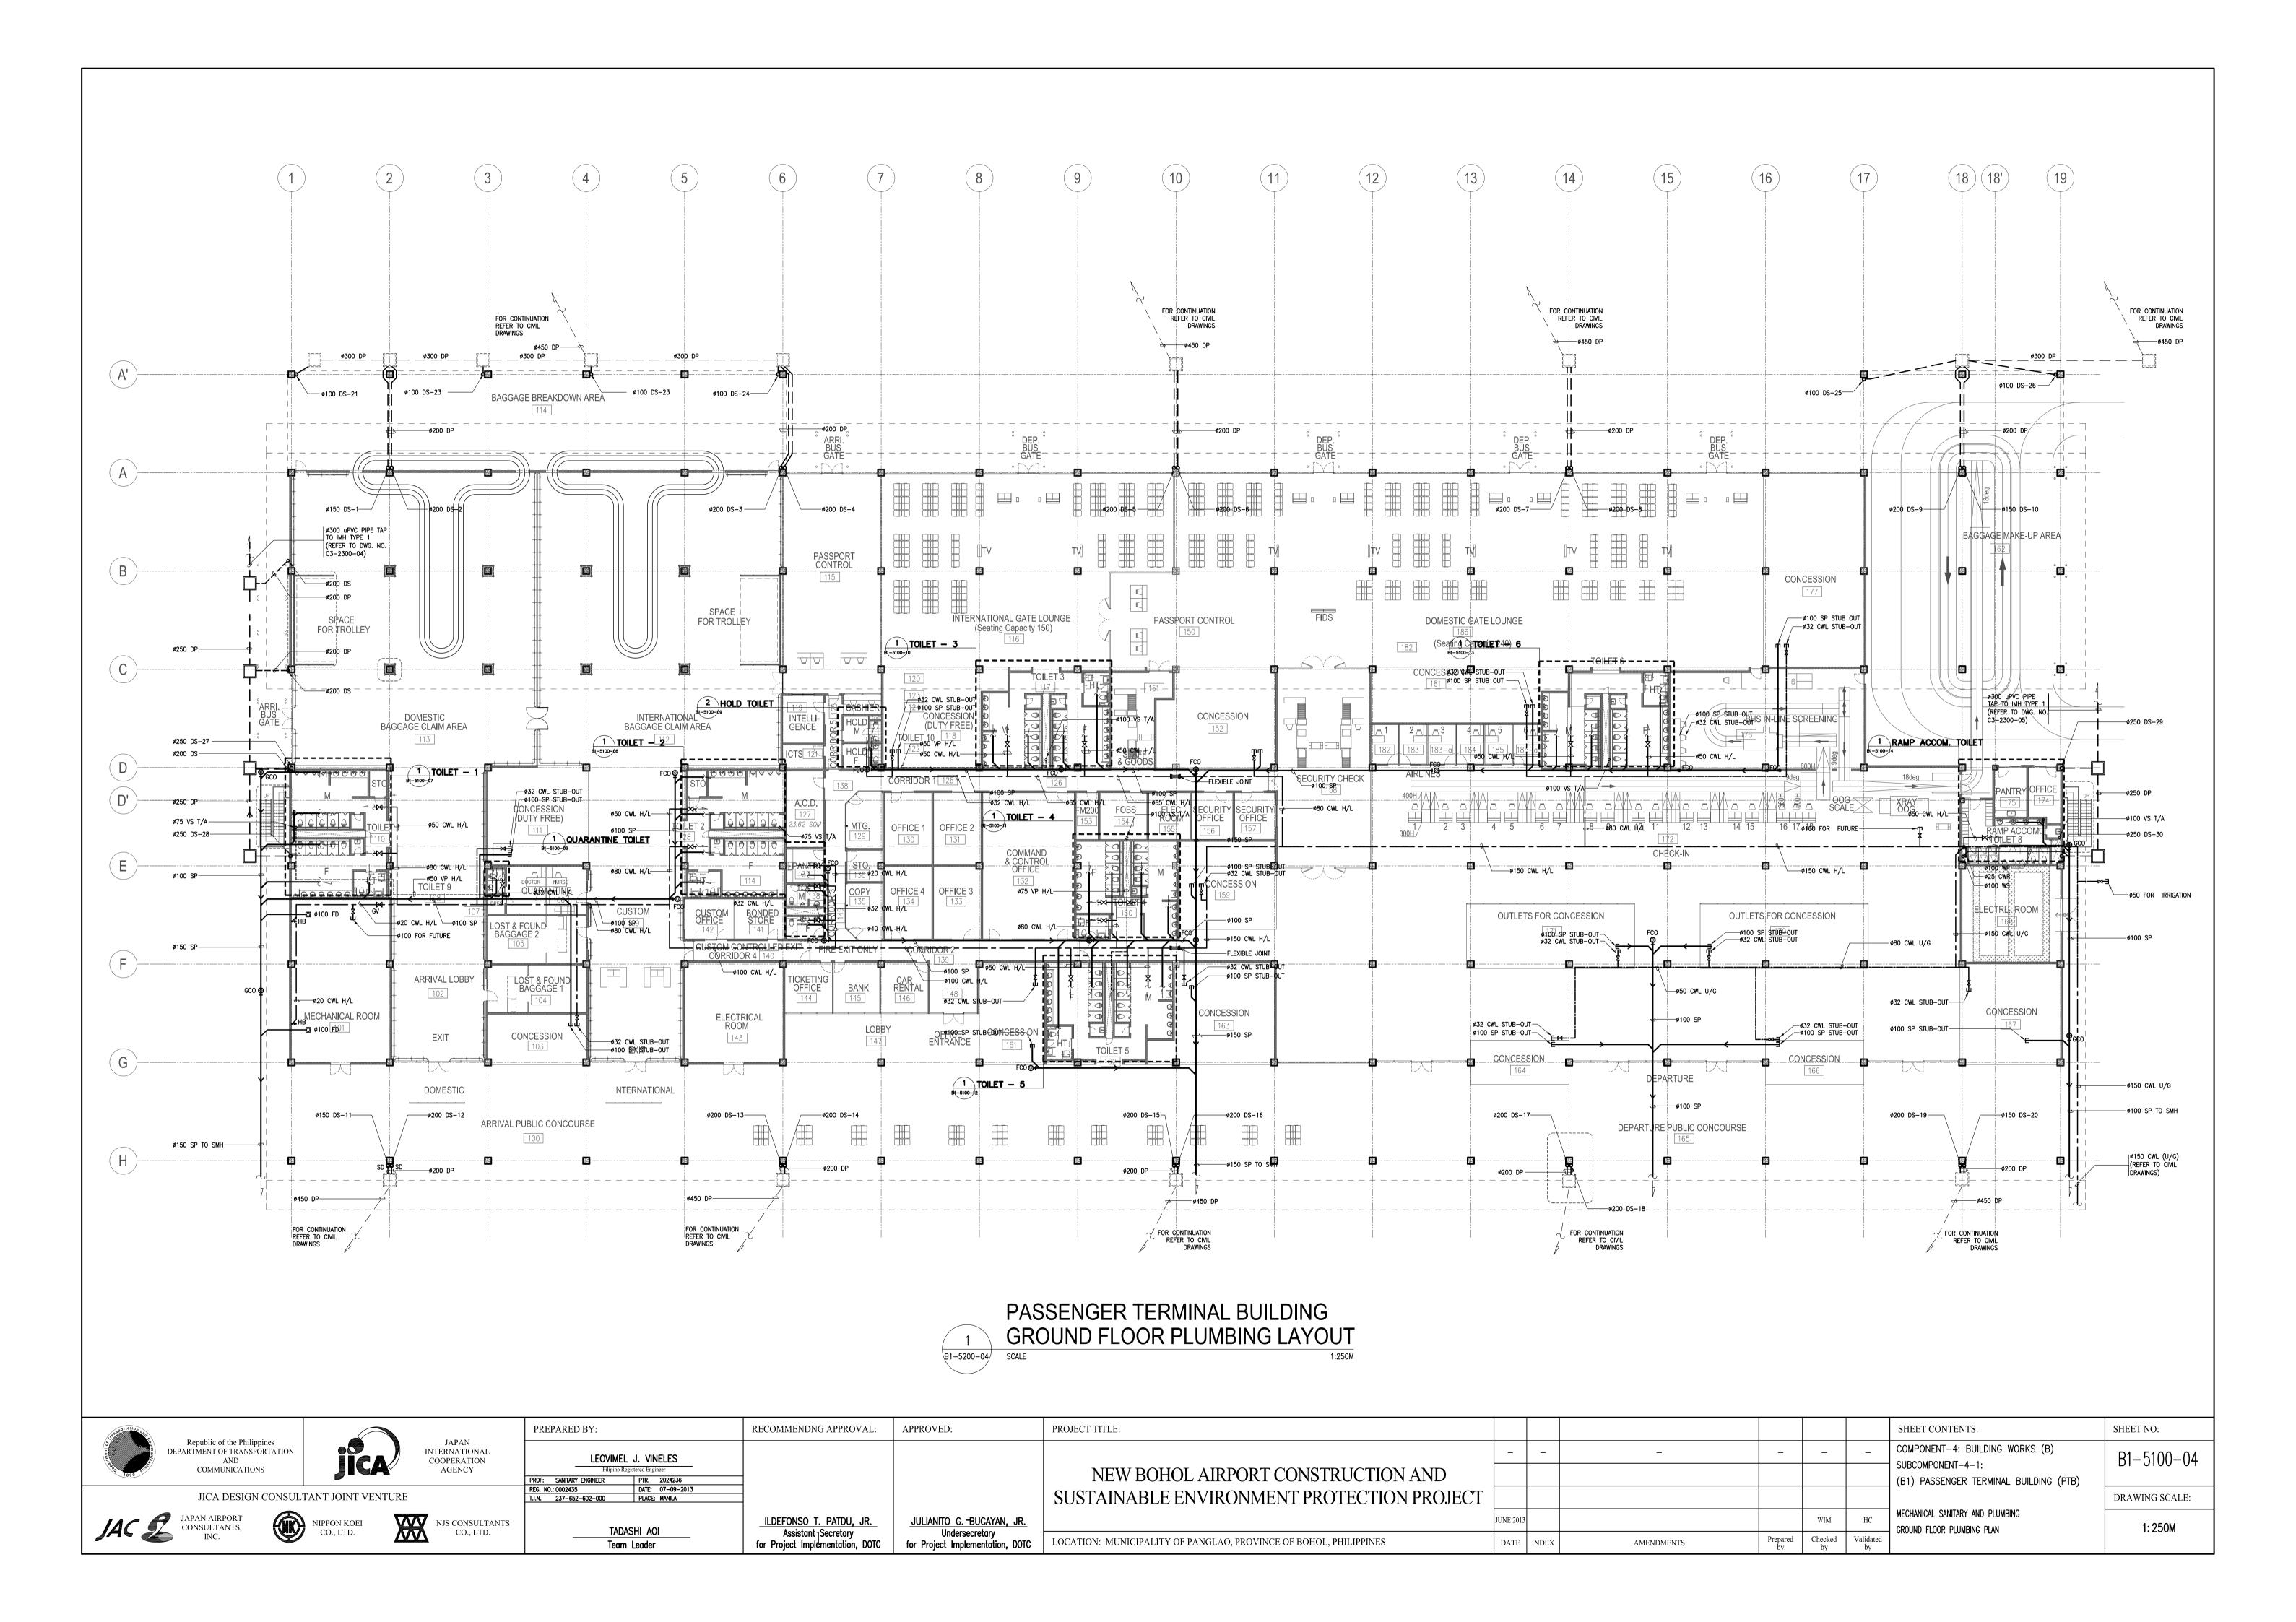

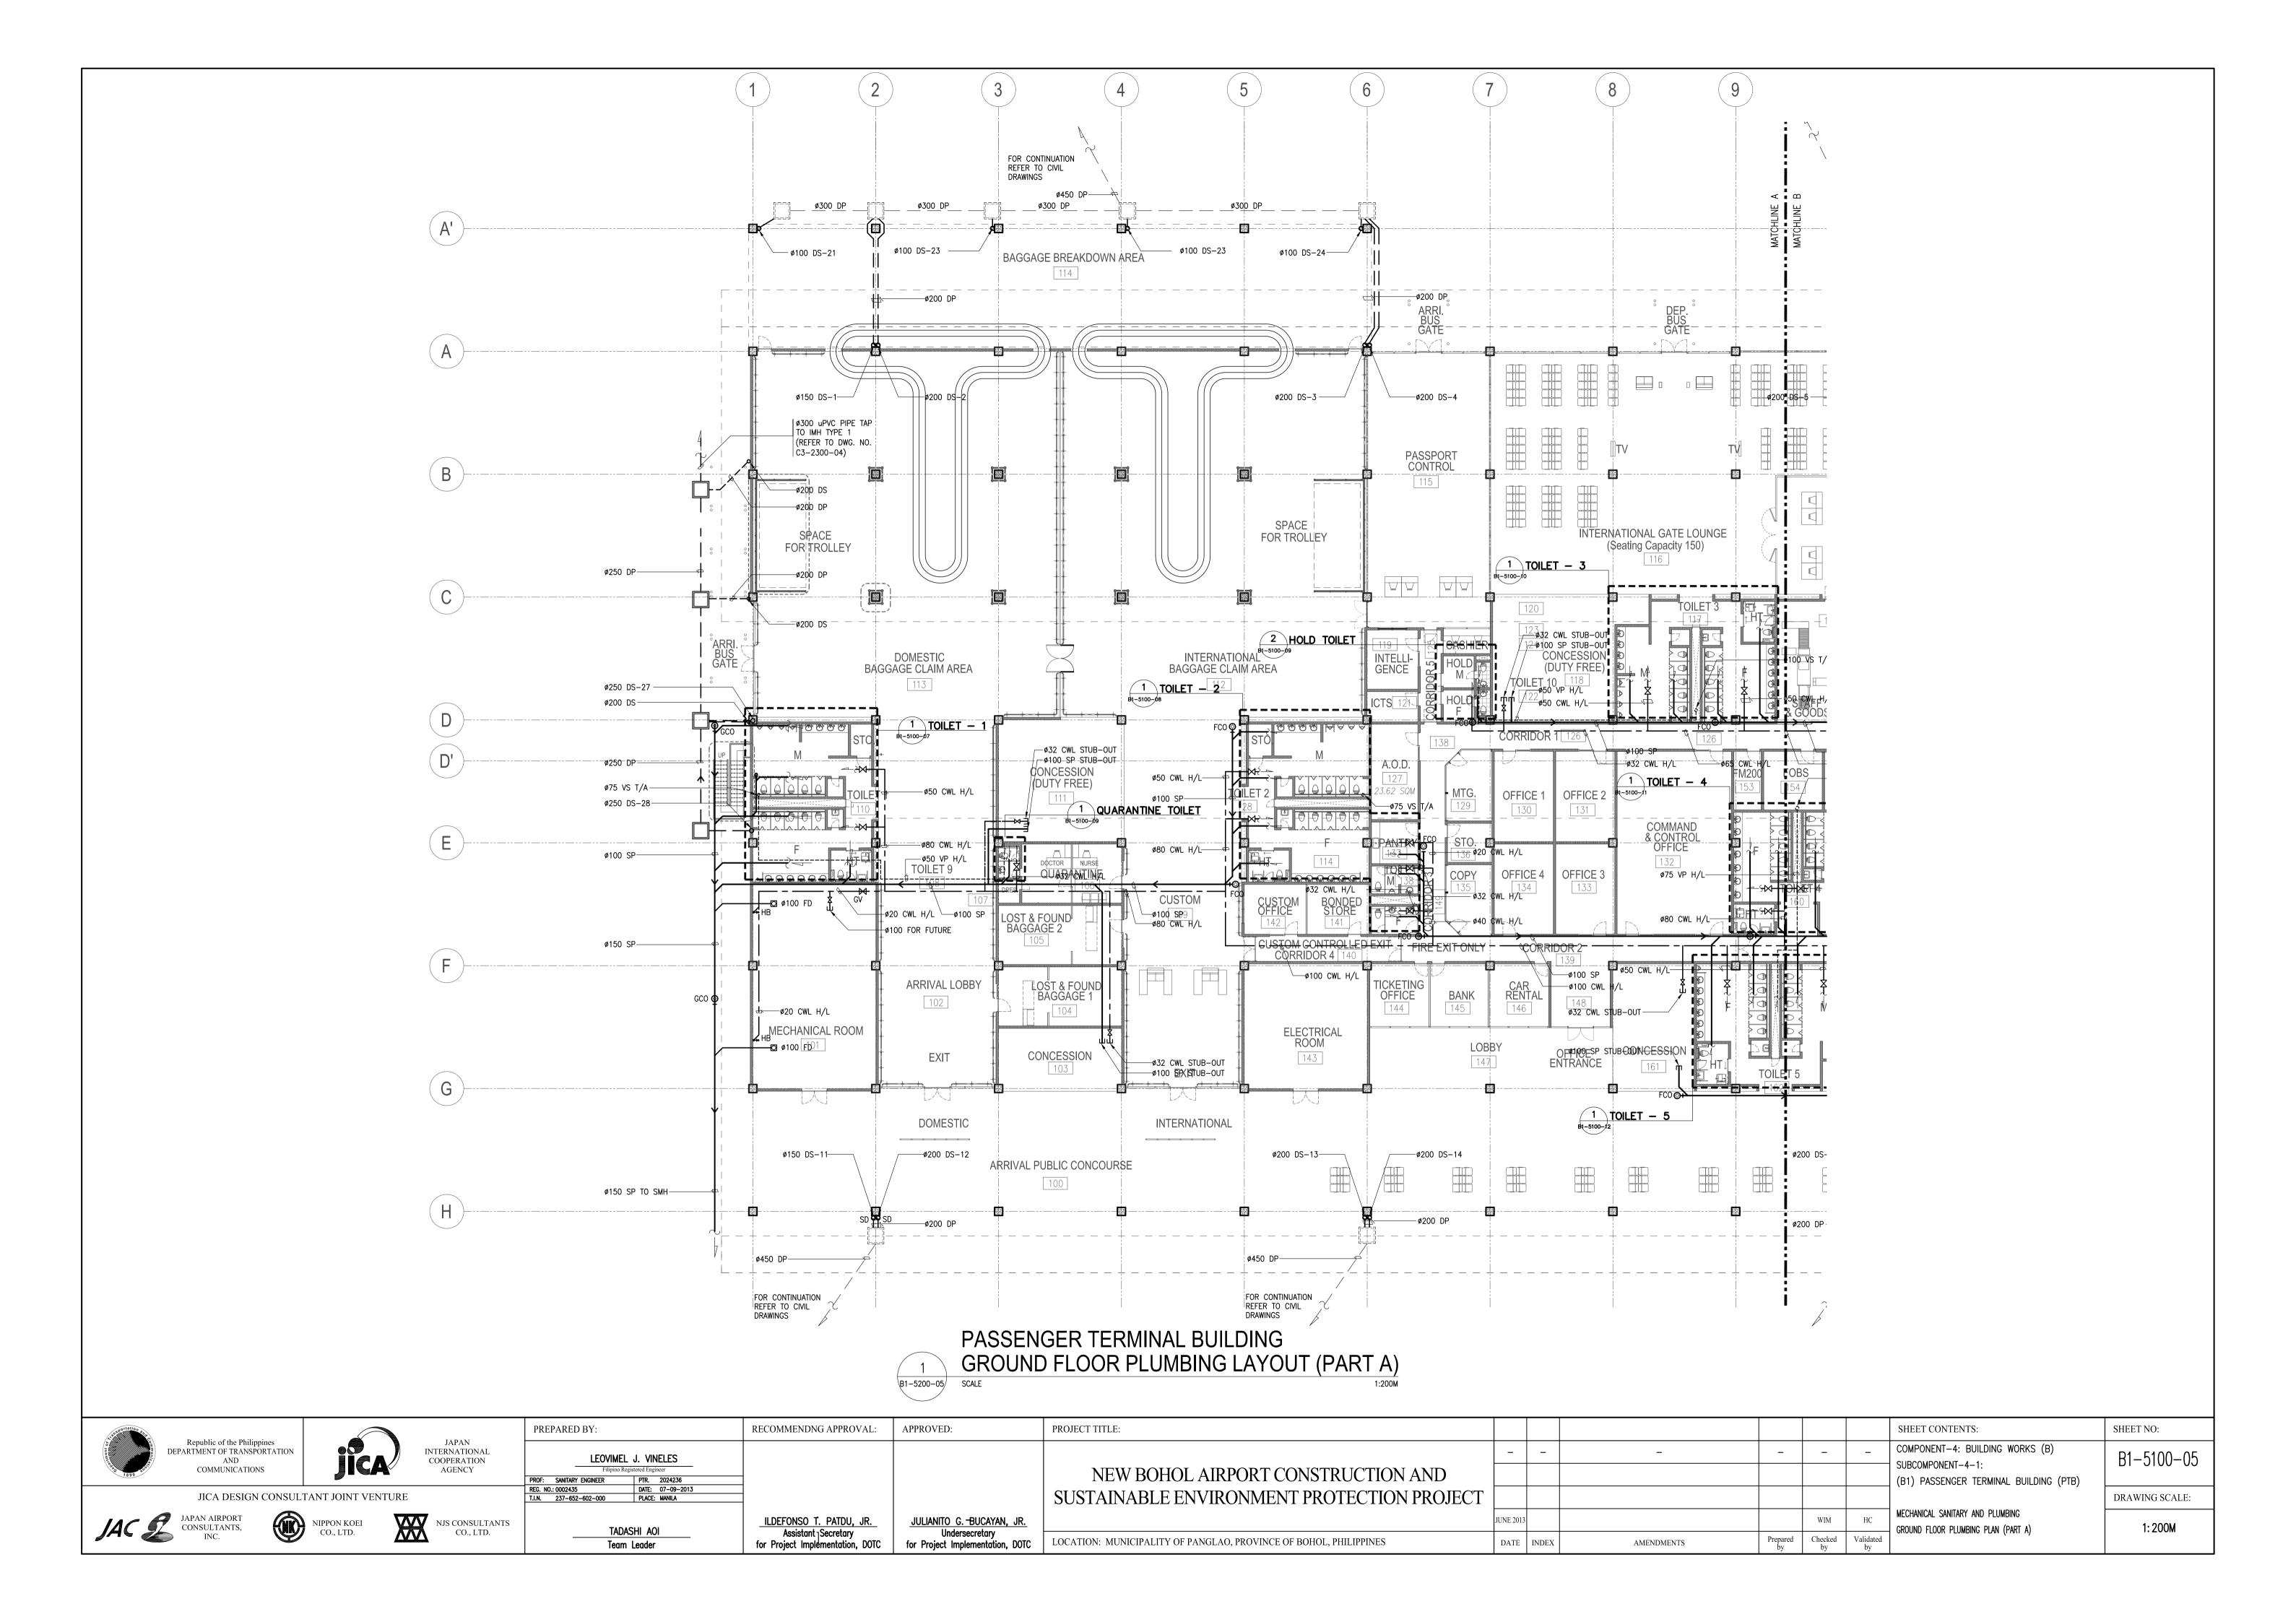

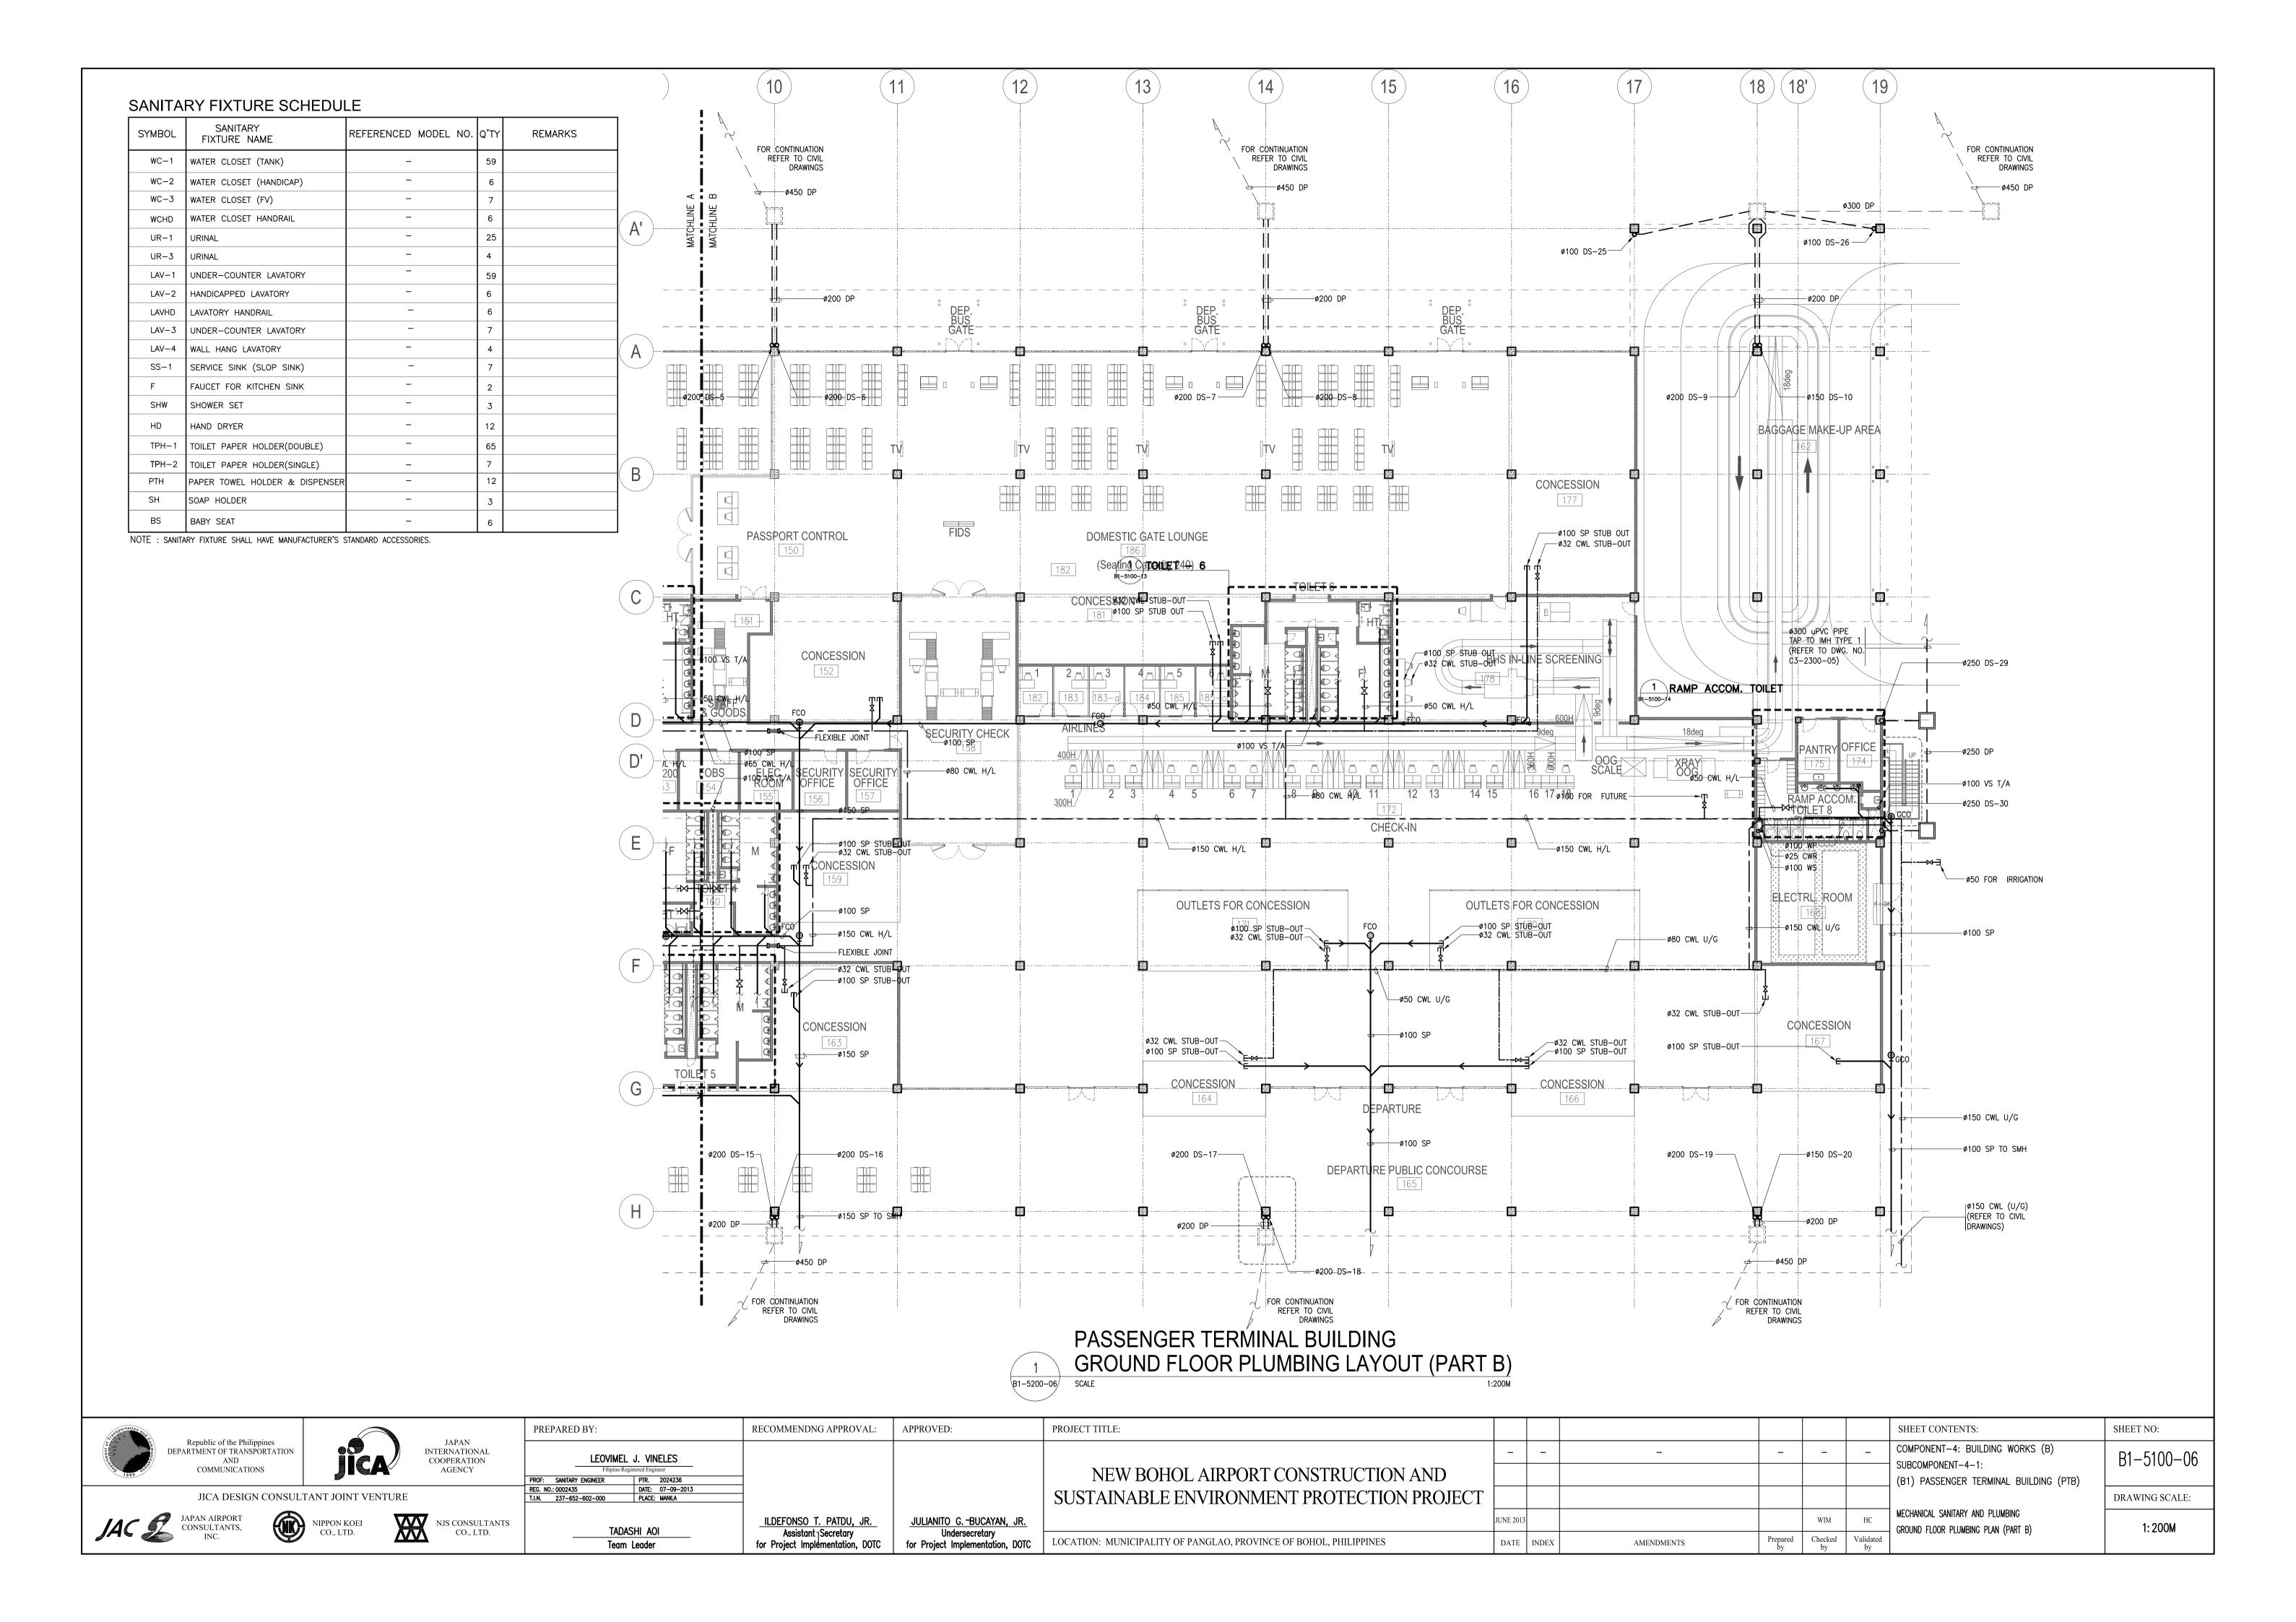


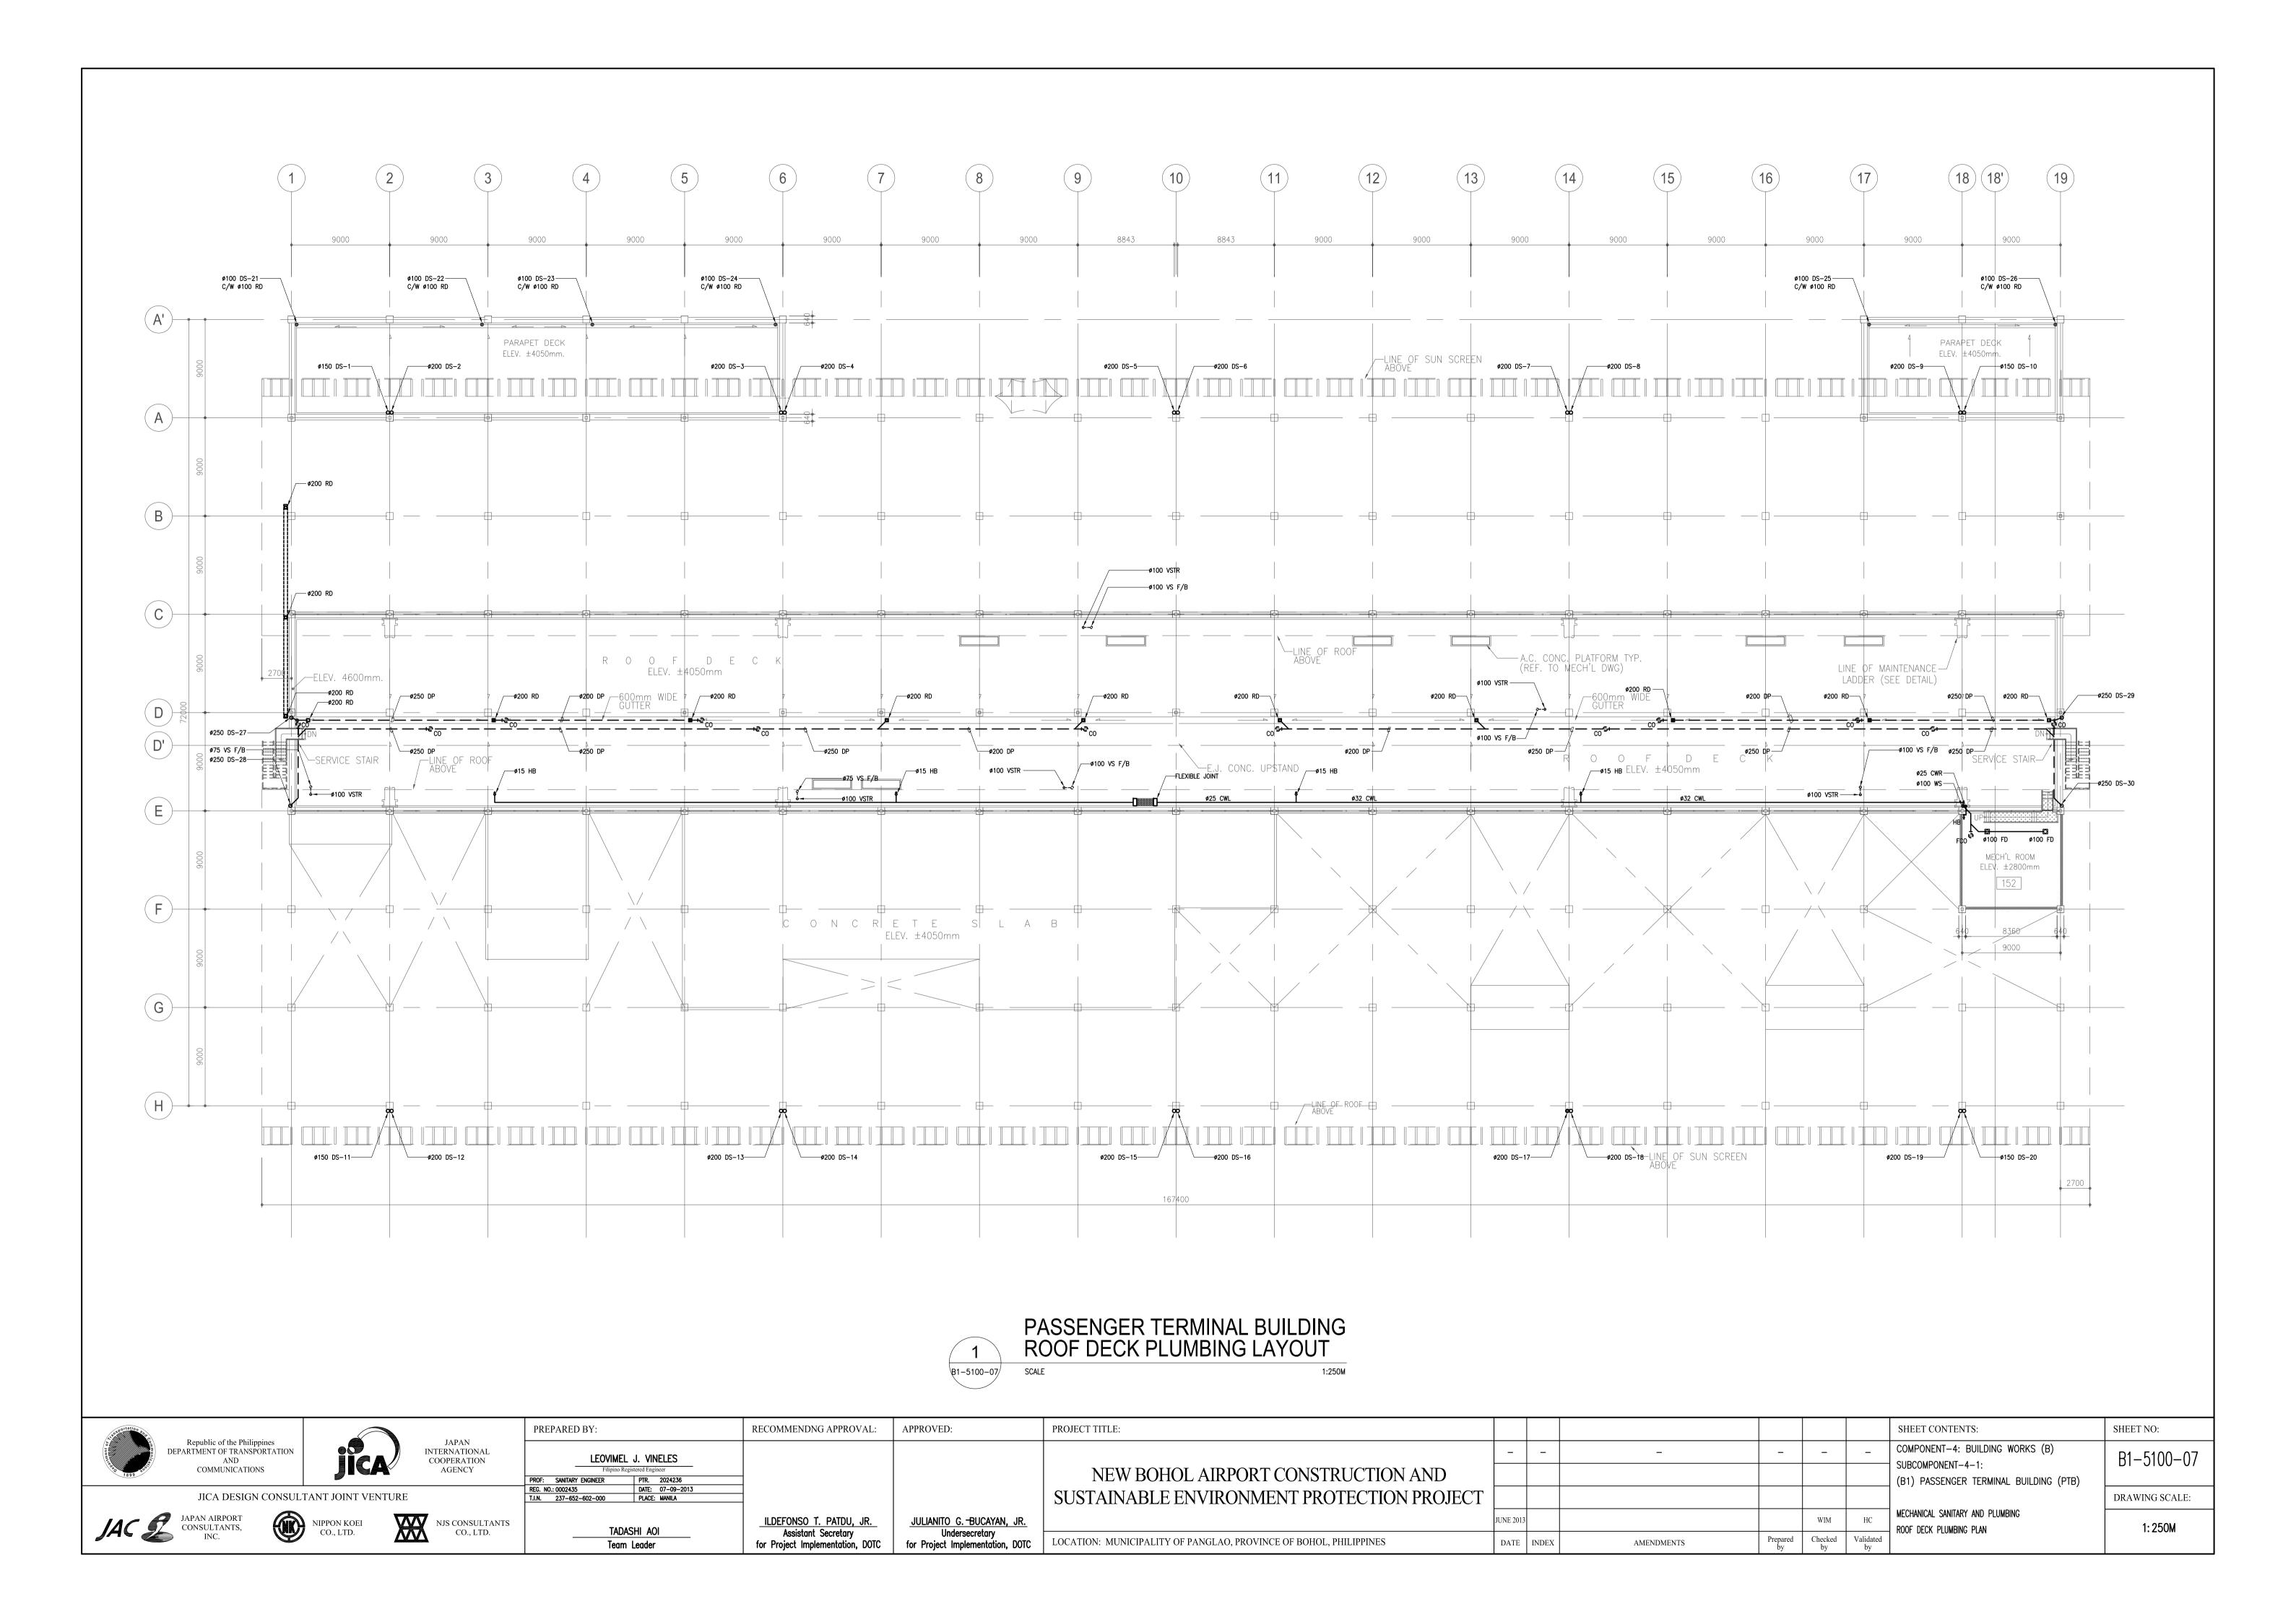


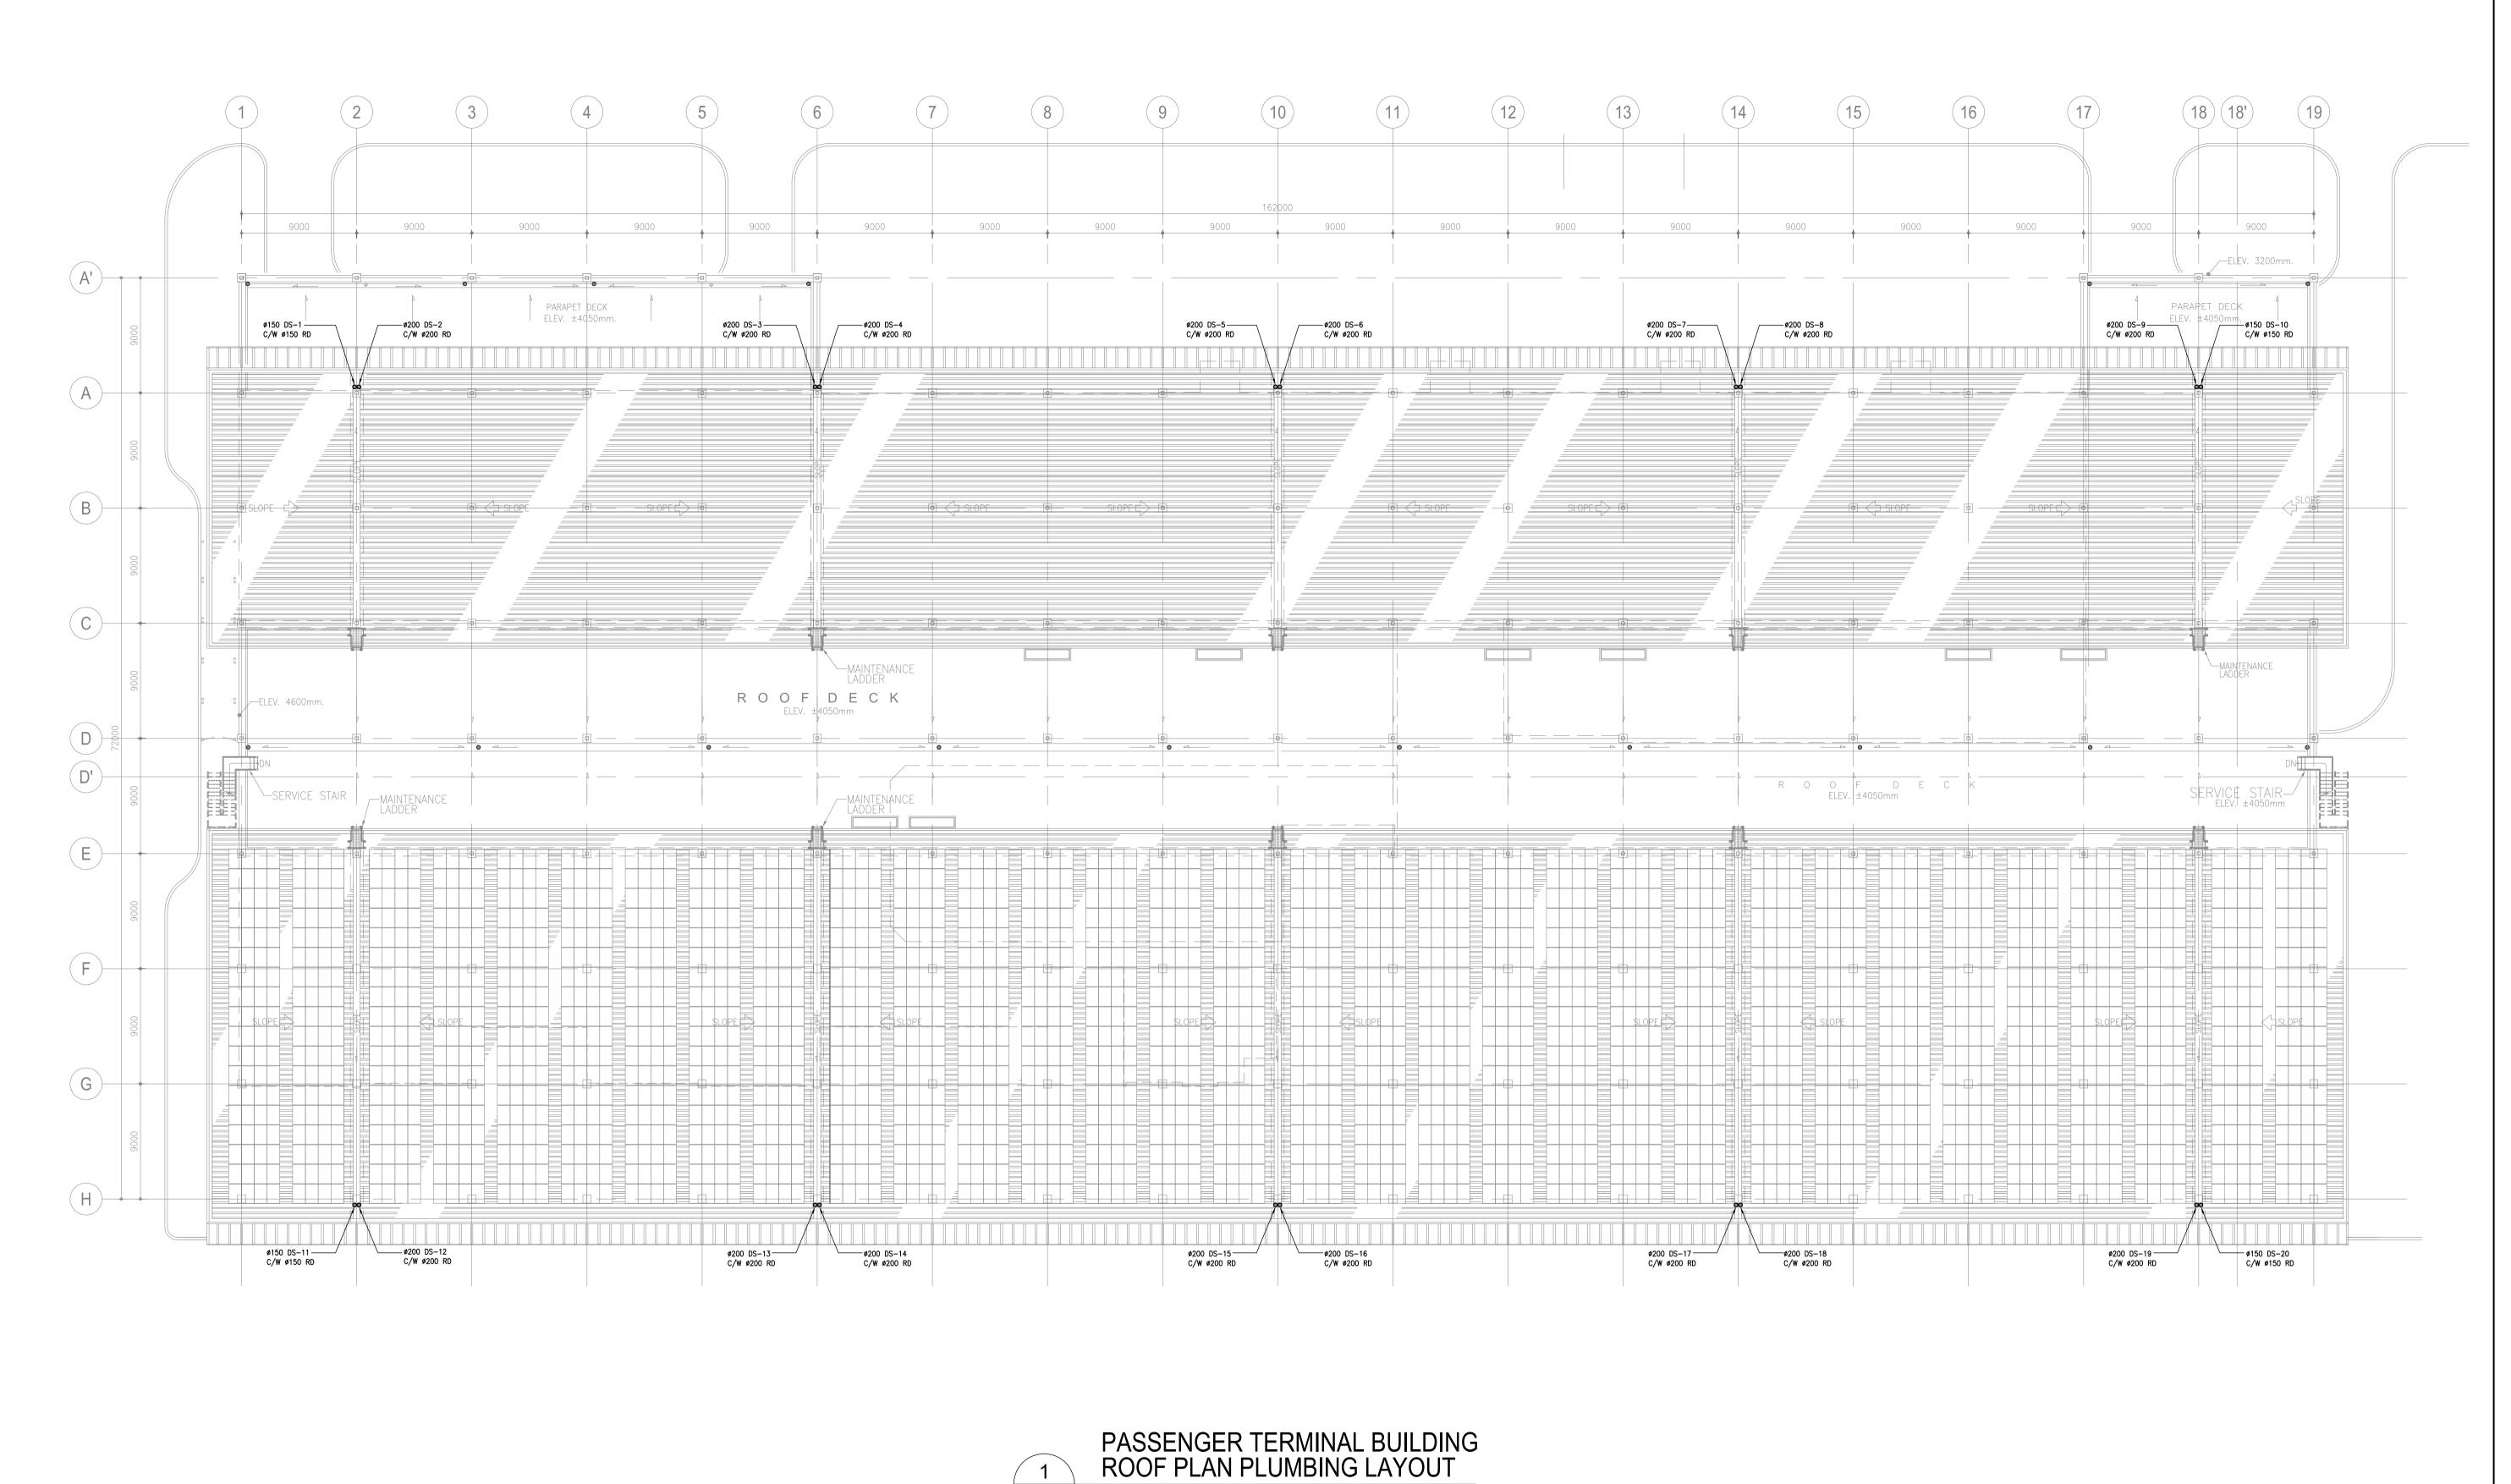





	Augustation 2200			PREPARED BY:	RECOMMENDNG APPROVAL:	APPROVED:	PROJECT TITLE:				SHEET CONTENTS:	SHEET NO:
	Republic of the Philippines DEPARTMENT OF TRANSPORTATION		JAPAN INTERNATIONAL COOPERATION	LEOVIMEL J. VINELES							COMPONENT-4: BUILDING WORKS (B)	B1-5100-08
	COMMUNICATIONS	JICA	AGENCY	Filipino Registered Engineer PROF: SANITARY ENGINEER PTR. 2024236			NEW BOHOL AIRPORT CONSTRUCTION AND				SUBCOMPONENT-4-1: (B1) PASSENGER TERMINAL BUILDING (PTB)	DI 3100 00
İ	JICA DESIGN CONSULT	TANT JOINT VENTUR	E	REG. NO.: 0002435 DATE: 07-09-2013 T.I.N. 237-652-602-000 PLACE: MANILA			SUSTAINABLE ENVIRONMENT PROTECTION PROJECT				(C) Trioderioetti Terminine Bolesino (C)	DRAWING SCALE:
	JAC S JAPAN AIRPORT CONSULTANTS, INC.		NJS CONSULTANTS	TADASHI AOI	ILDEFONSO T. PATDU, JR.	JULIANITO G. BUCAYAN, JR.		JUNE 2013		WIM HC	MECHANICAL SANITARY AND PLUMBING ROOF PLUMBING PLAN	1: 250M
	INC.	CO., LID.	CO., LTD.	Team Leader	Assistant Secretary for Project Implementation, DOTC	Undersecretary for Project Implementation, DOTC	LOCATION: MUNICIPALITY OF PANGLAO, PROVINCE OF BOHOL, PHILIPPINES	DATE INDE	AMENDMENTS Prepared by	Checked Validated by	TOOL LOWDING LOW	

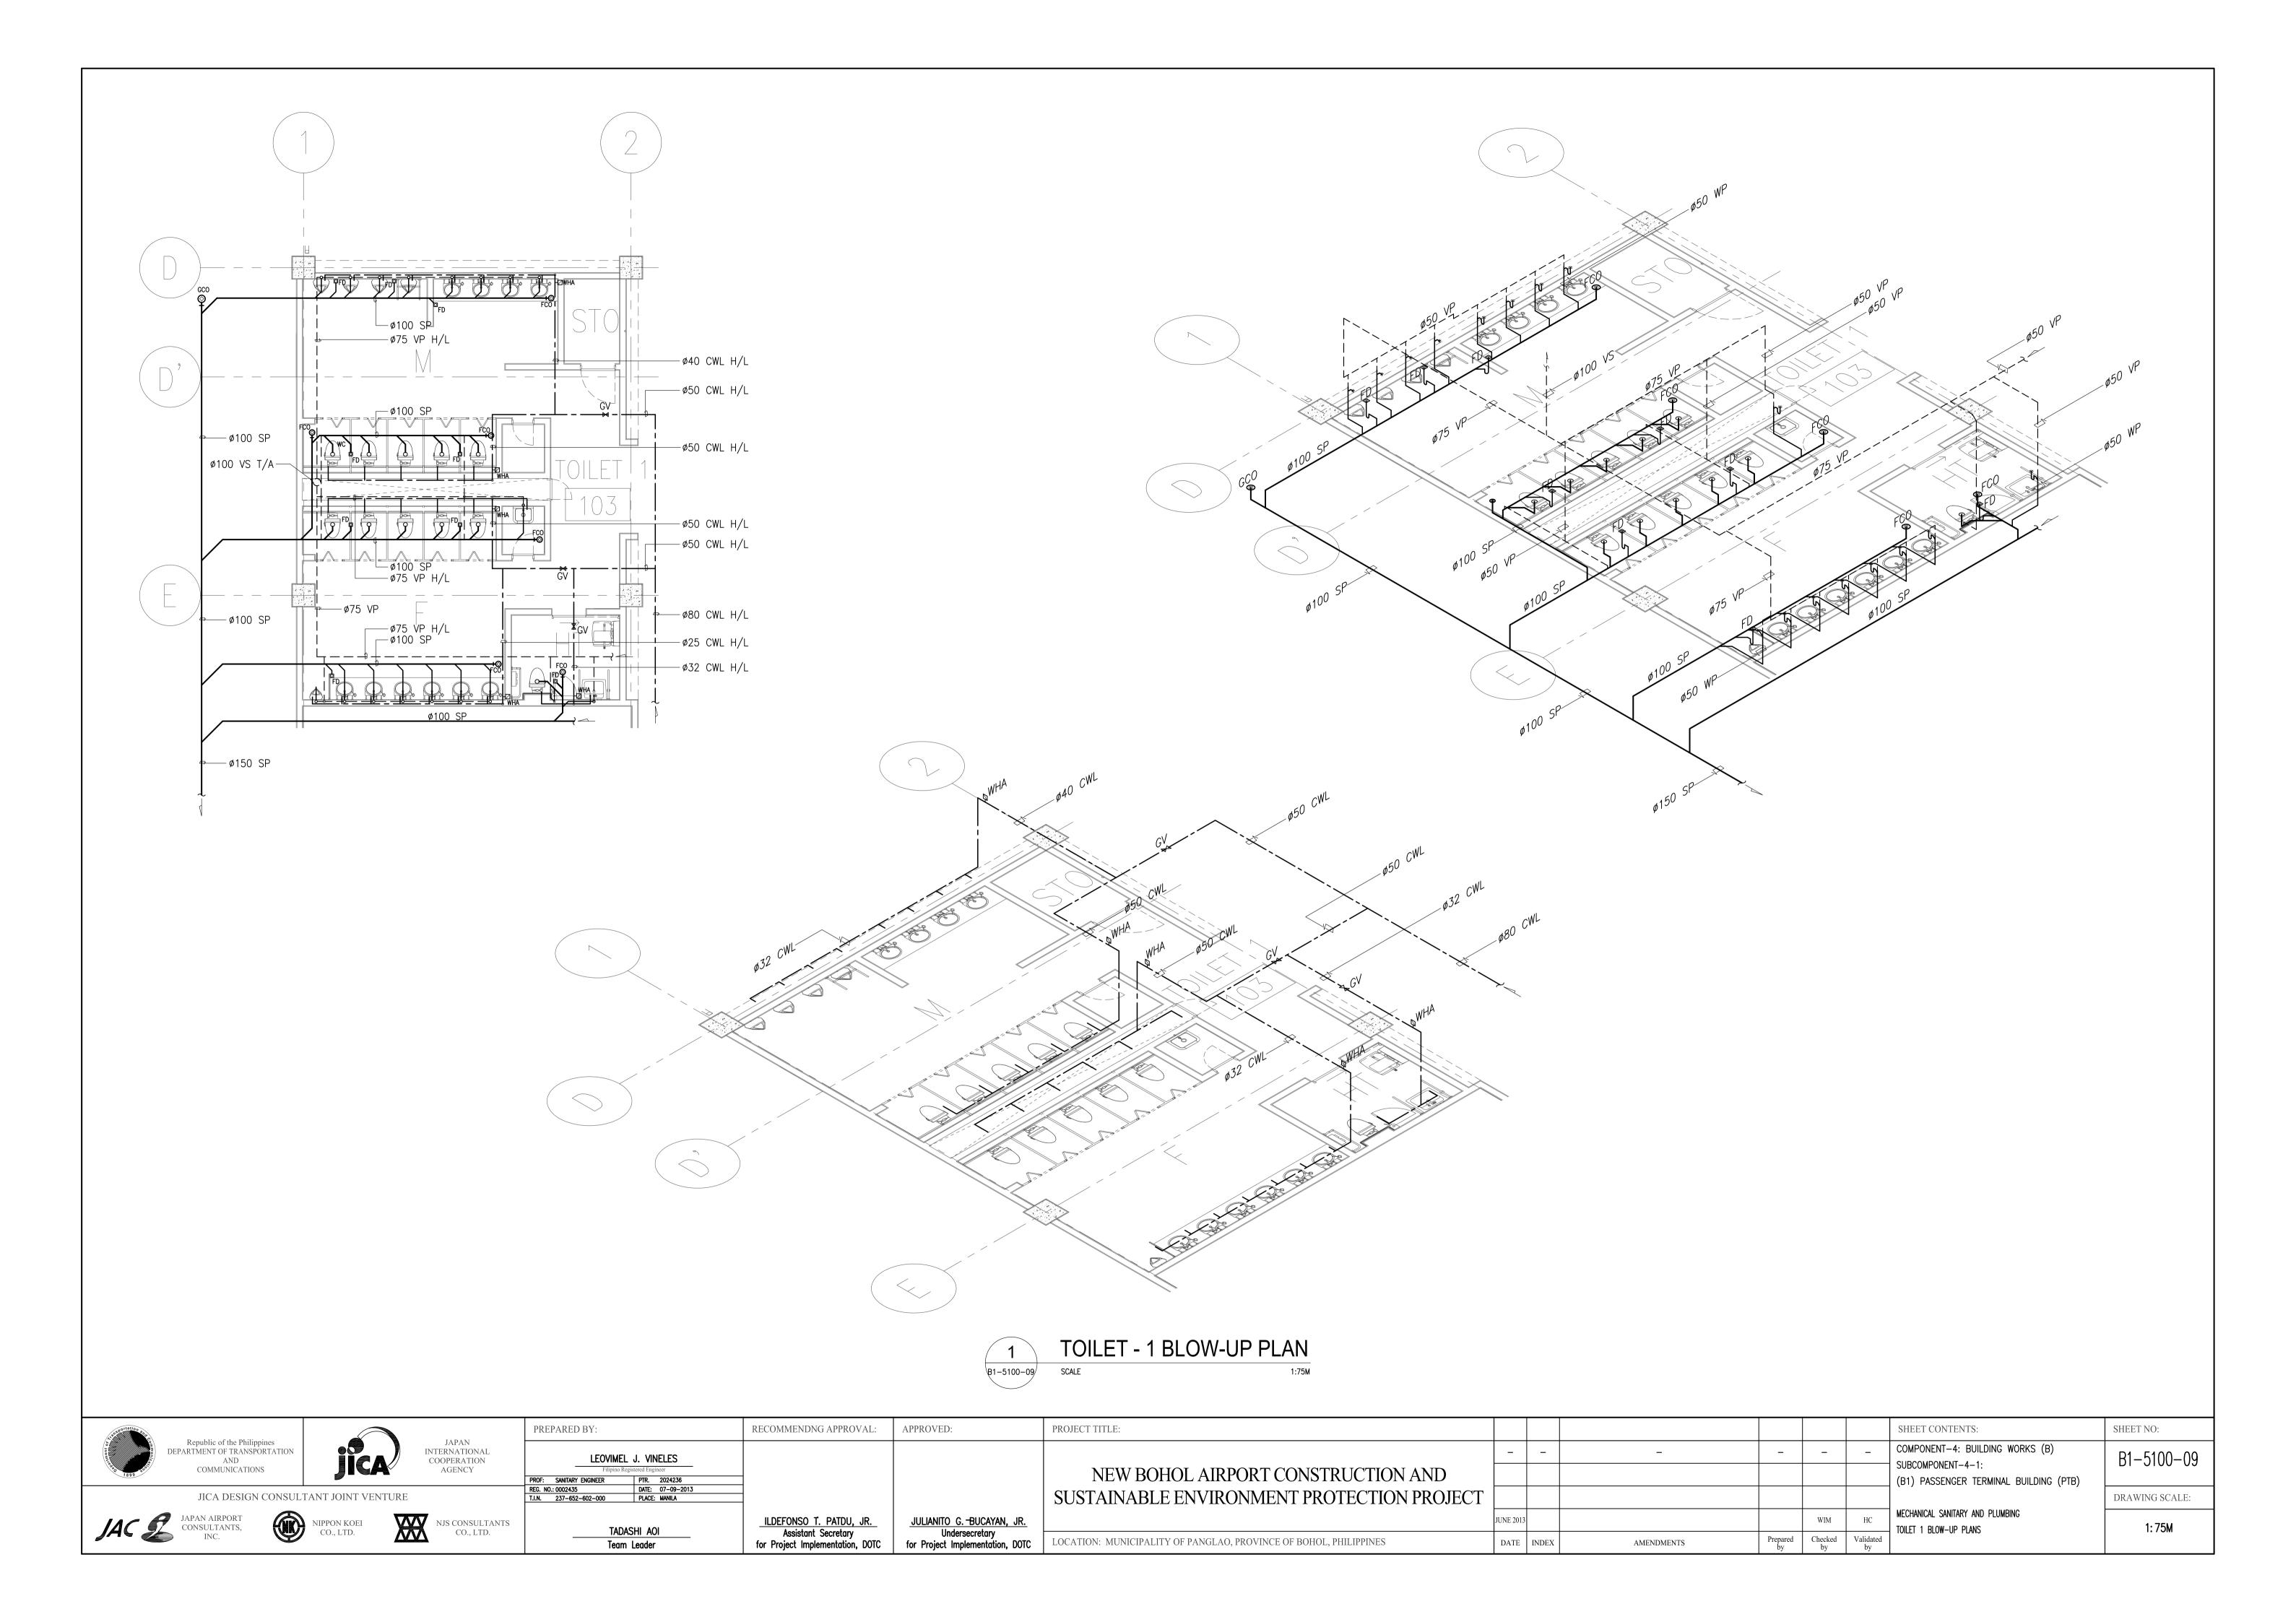


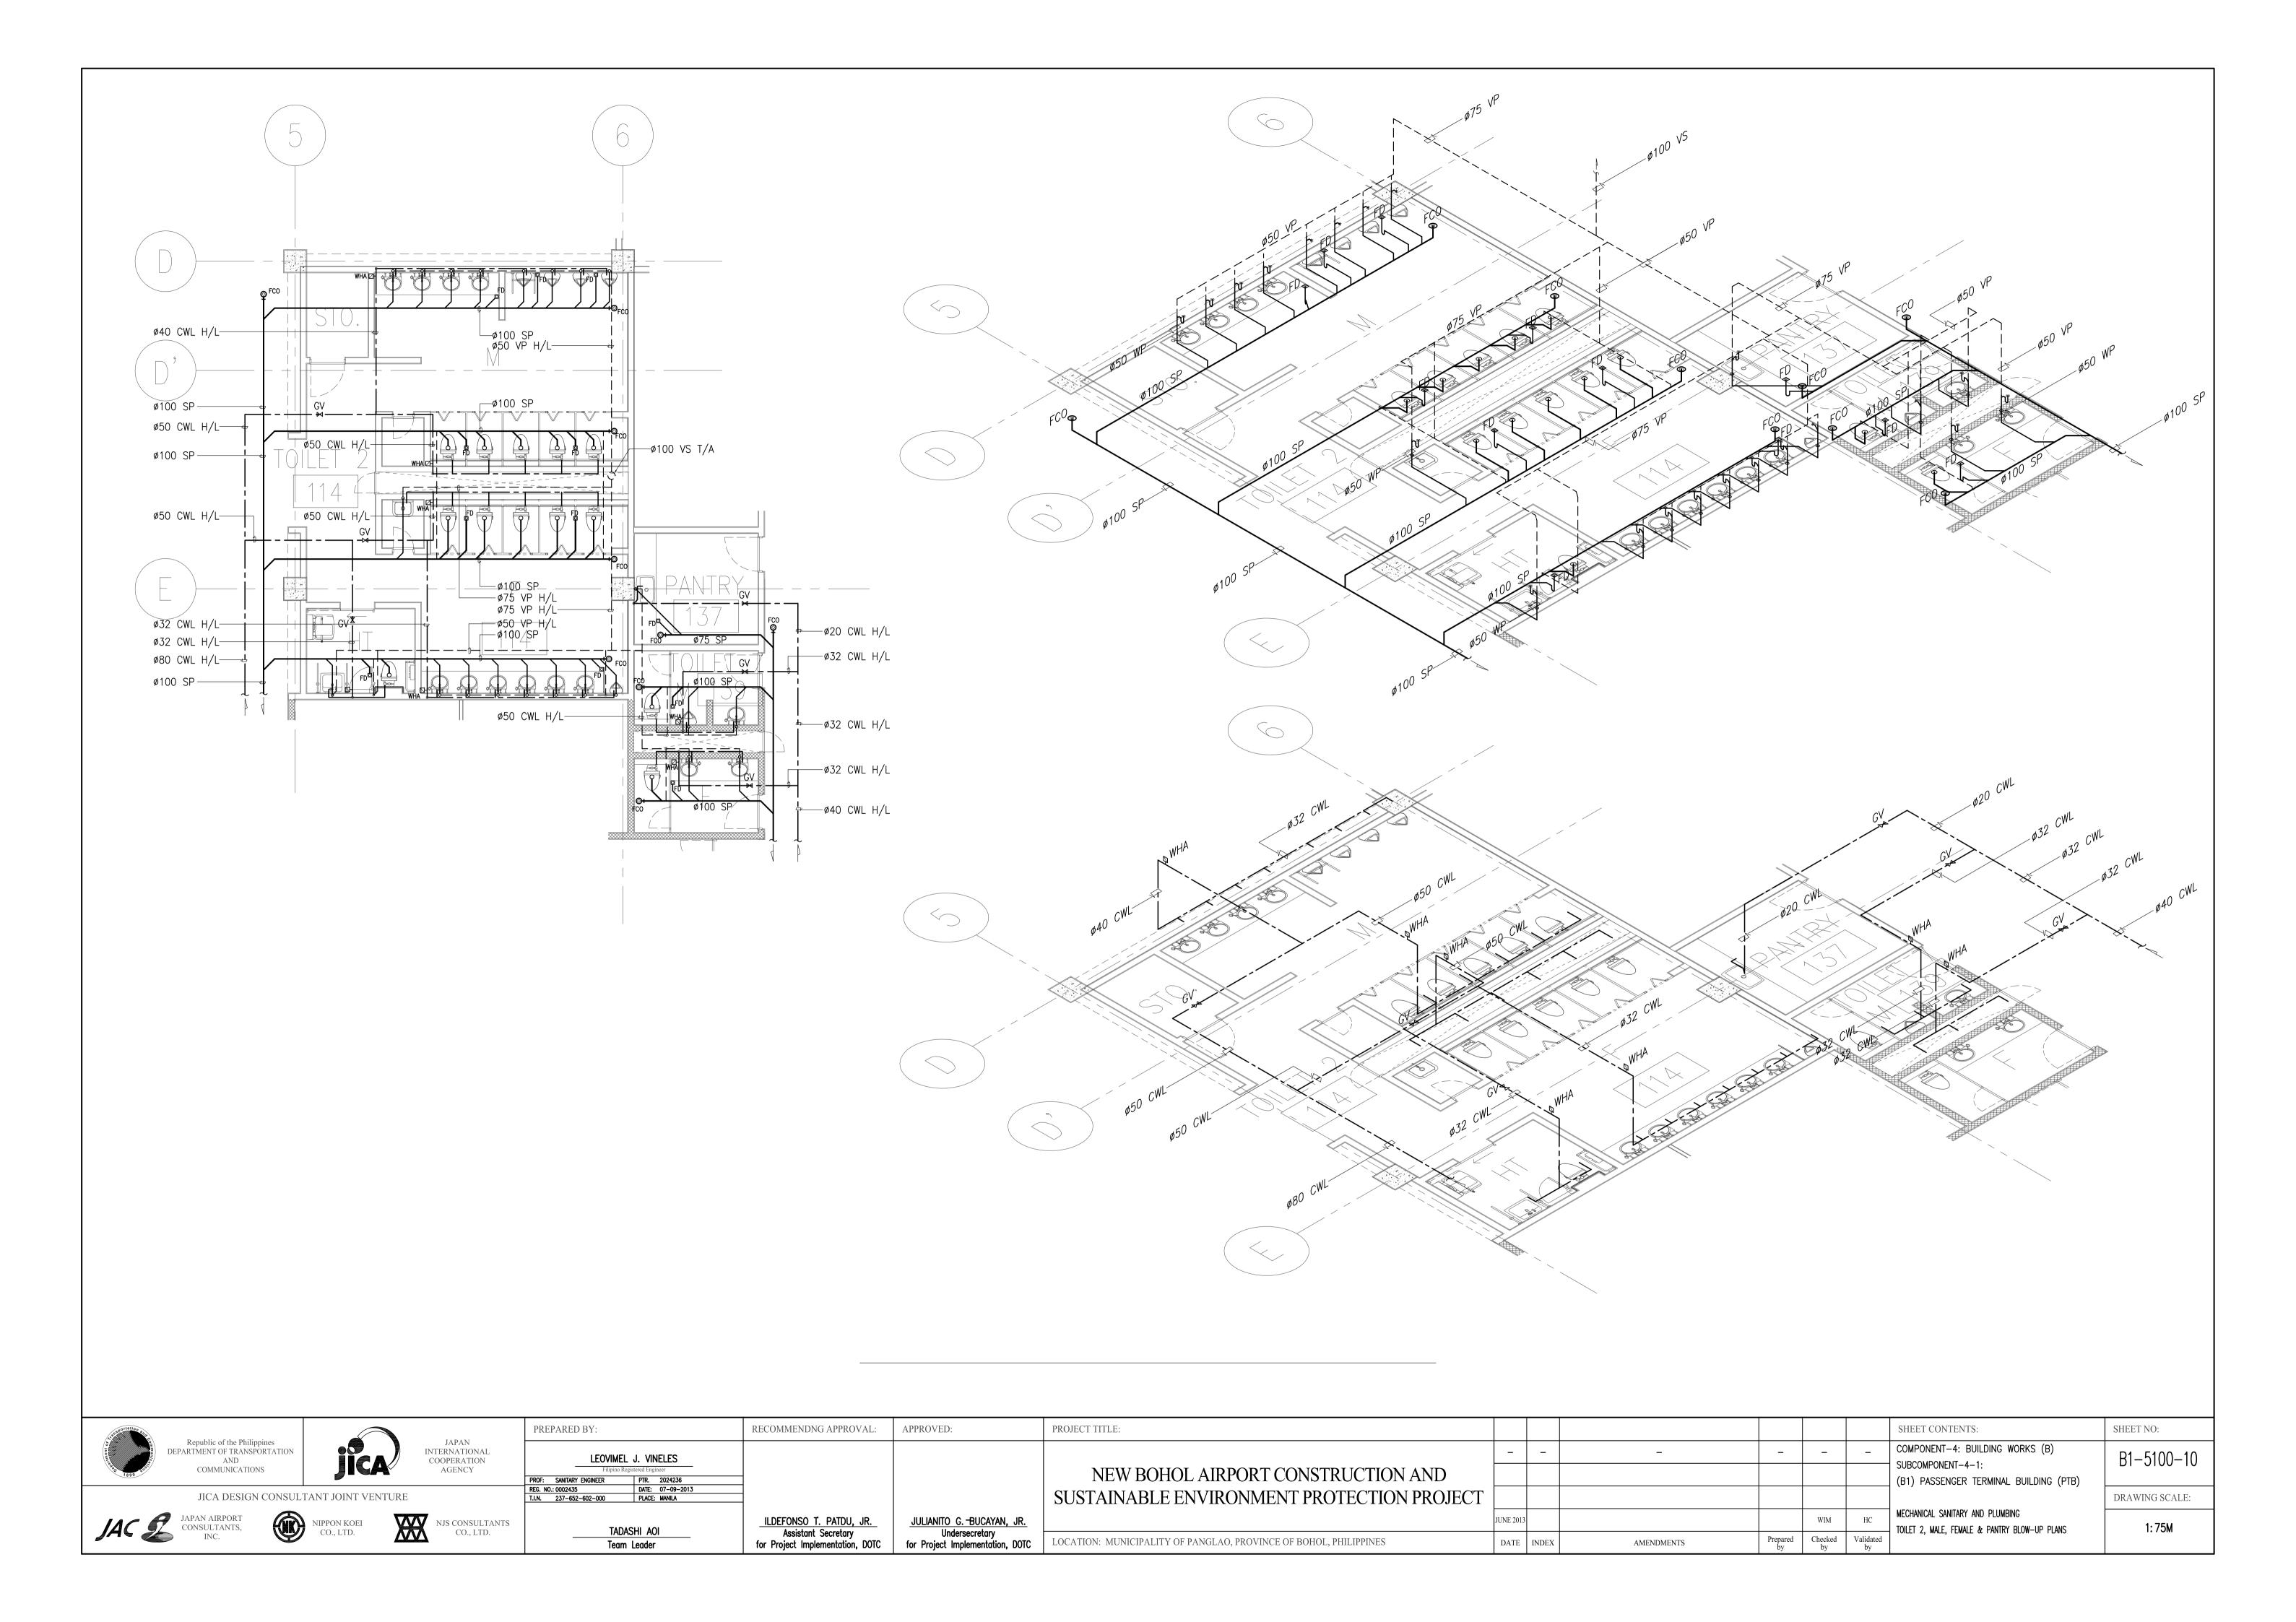

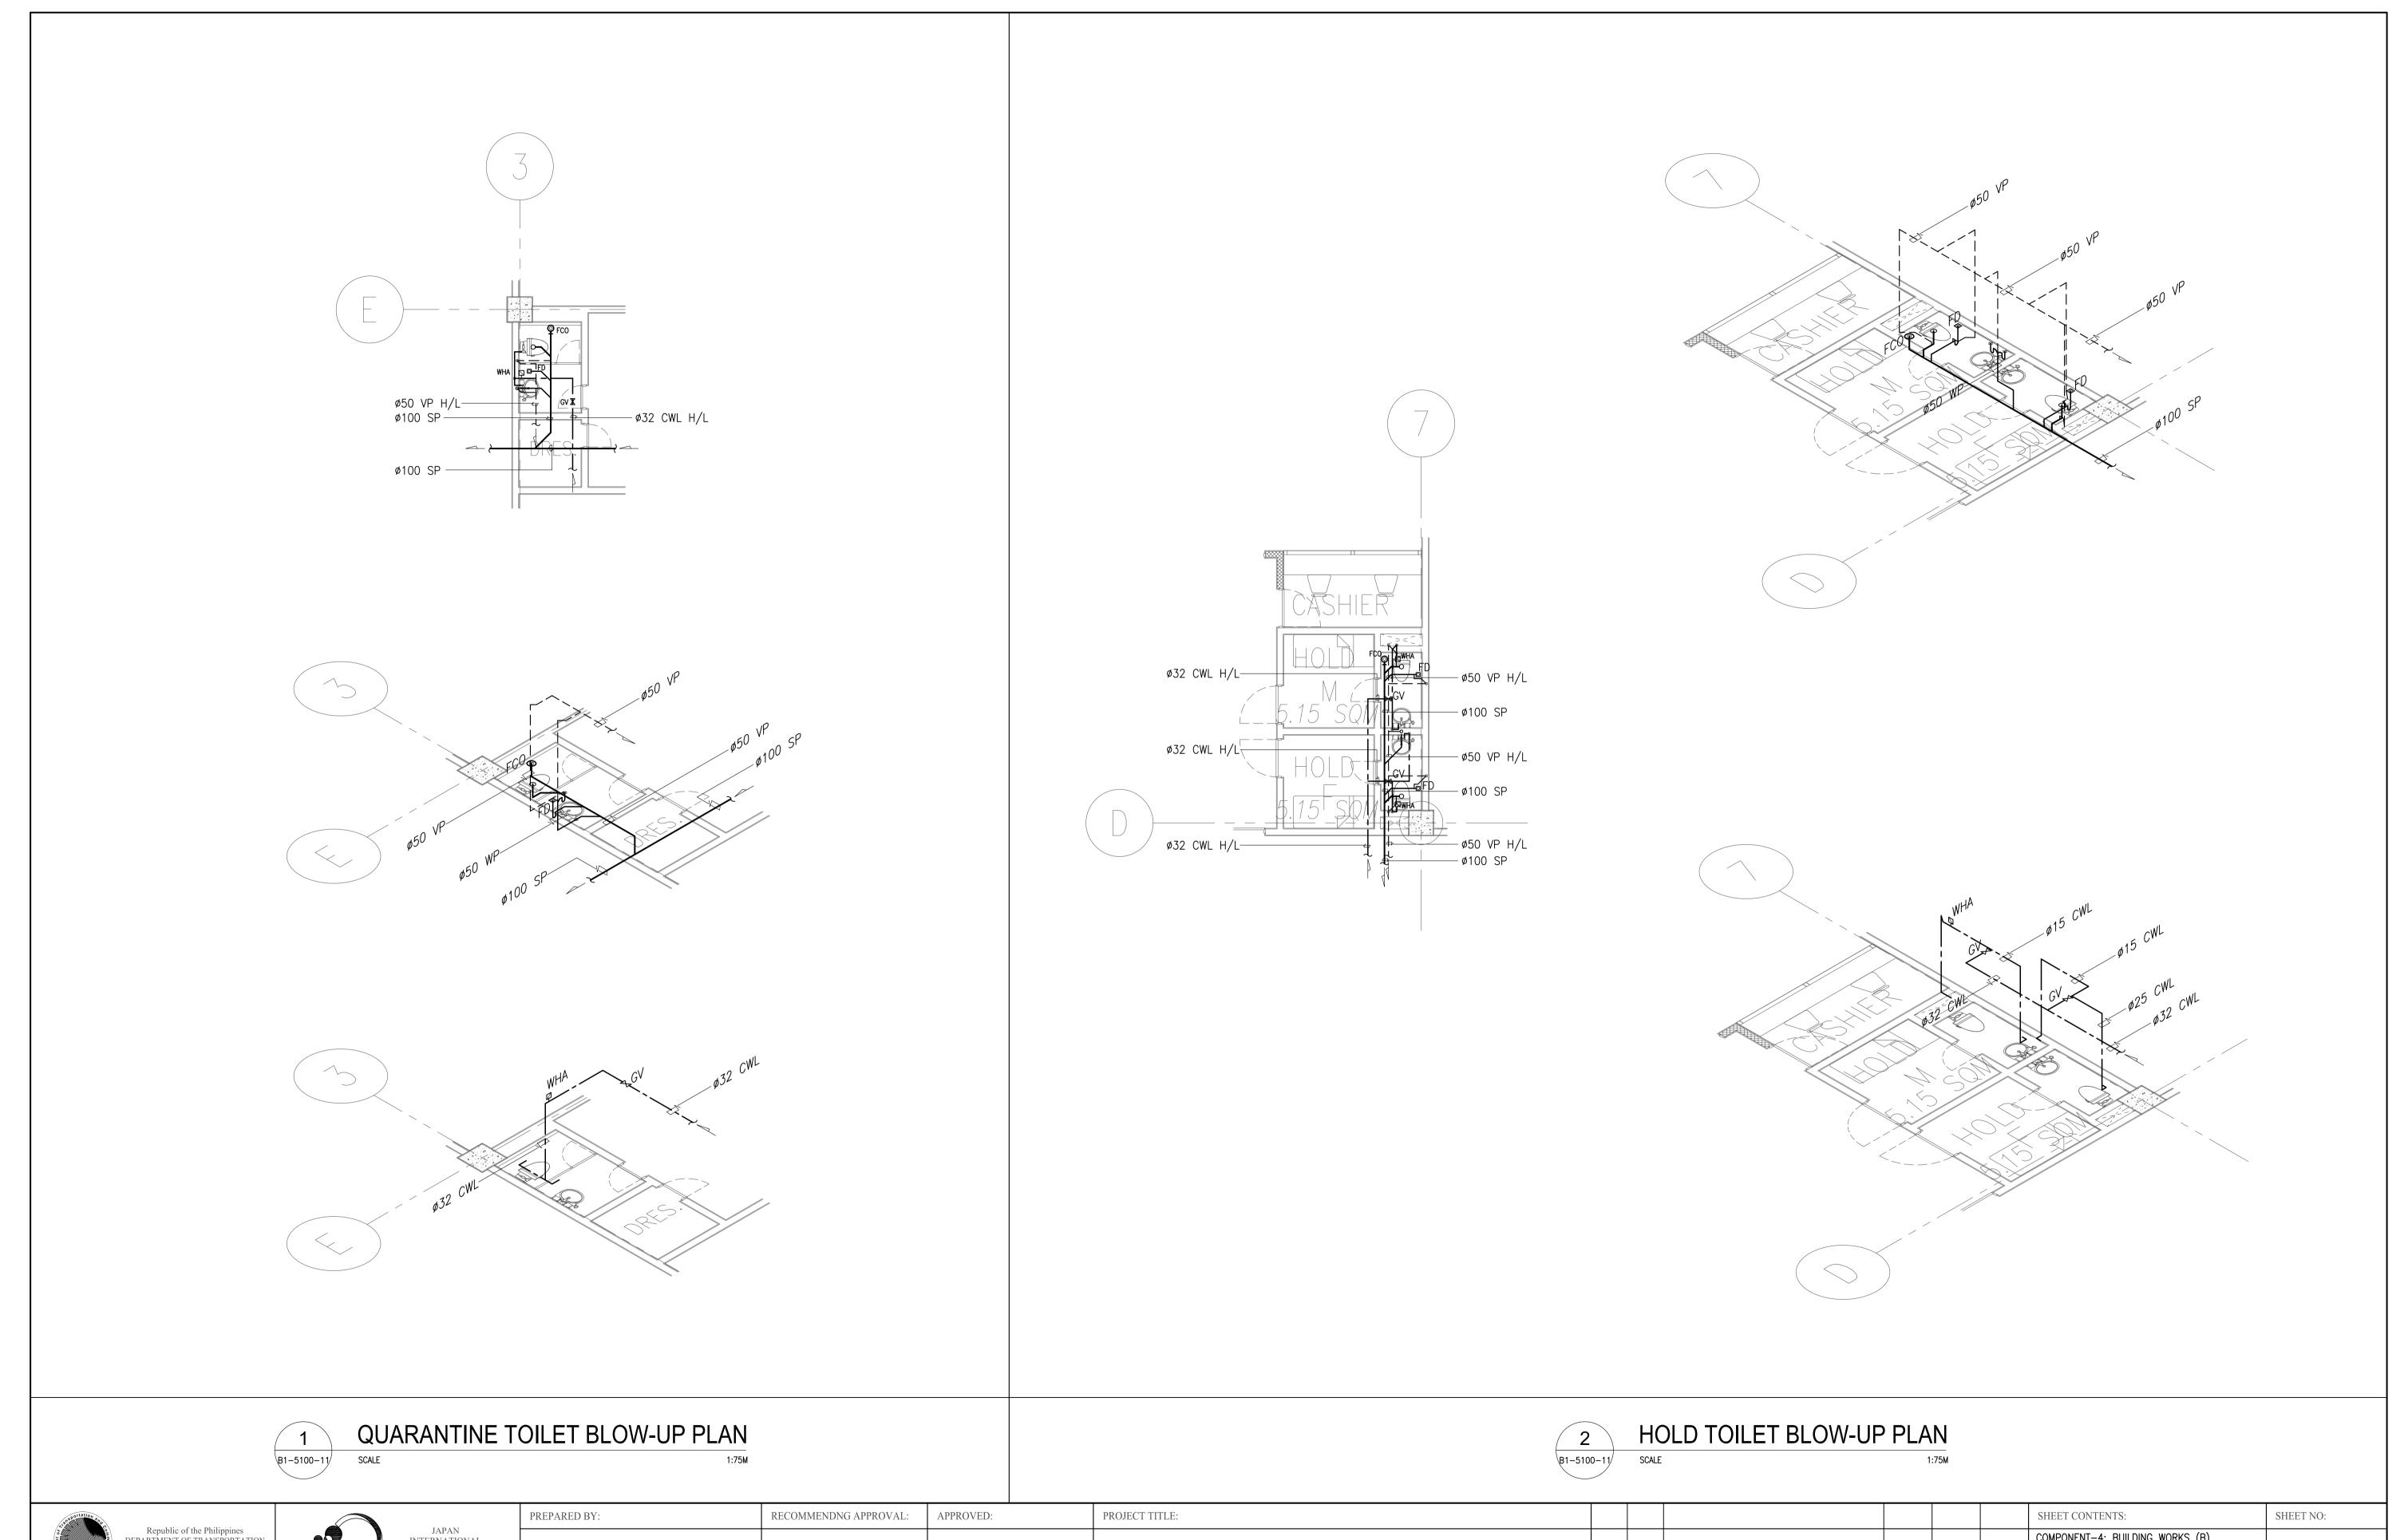



Zion.	ortation and			PREPARED BY:	RECOMMENDING APPROVAL:	APPROVED:	PROJECT TITLE:						SHEET CONTENTS:	SHEET NO:
thent of	Republic of the Philippines DEPARTMENT OF TRANSPORTATION AND		JAPAN INTERNATIONAL COOPERATION	LEOVIMEL J. VINELES				_	_	_	_		COMPONENT-4: BUILDING WORKS (B)	B1-5100-11
1000	1899 tobi	JICA	AGENCY	Filipino Registered Engineer PROF: SANITARY ENGINEER PTR. 2024236			NEW BOHOL AIRPORT CONSTRUCTION AND						SUBCOMPONENT-4-1: (B1) PASSENGER TERMINAL BUILDING (PTB)	B1 0100 11
	JICA DESIGN CONSULTA	ANT JOINT VENTURI	E	REG. NO.: 0002435 DATE: 07-09-2013 T.I.N. 237-652-602-000 PLACE: MANILA			SUSTAINABLE ENVIRONMENT PROTECTION PROJECT						(DT) TAGGENOEN TENNINAL BOILDING (TTD)	DRAWING SCALE:
	JAPAN AIRPORT	NIPPON KOEI	VV NJS CONSULTANTS		ILDEFONSO T. PATDU, JR.	JULIANITO G. BUCAYAN, JR.		JUNE 2013				WIM HC	MECHANICAL SANITARY AND PLUMBING	4.751
	CONSULTANTS, INC.	CO., LTD.	CO., LTD.	TADASHI AOI Team Leader	Assistant Secretary for Project Implementation, DOTC	Undersecretary for Project Implementation, DOTC	LOCATION: MUNICIPALITY OF PANGLAO, PROVINCE OF BOHOL, PHILIPPINES	DATE	INDEX	AMENDMENTS	Prepared by	Checked Validated	QUARANTINE & HOLD TOILET BLOW-UP PLANS	1: 75M
					· ·						1 -7	-5 -5		

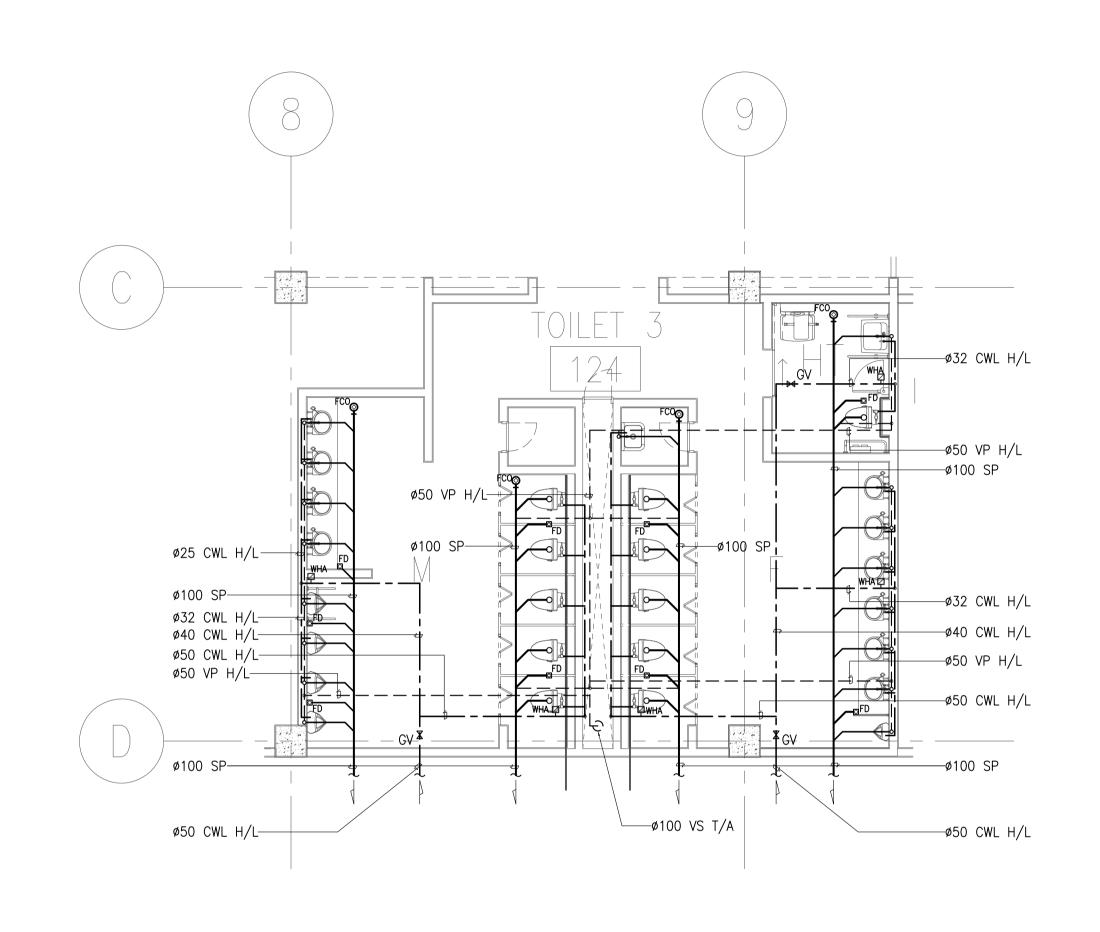

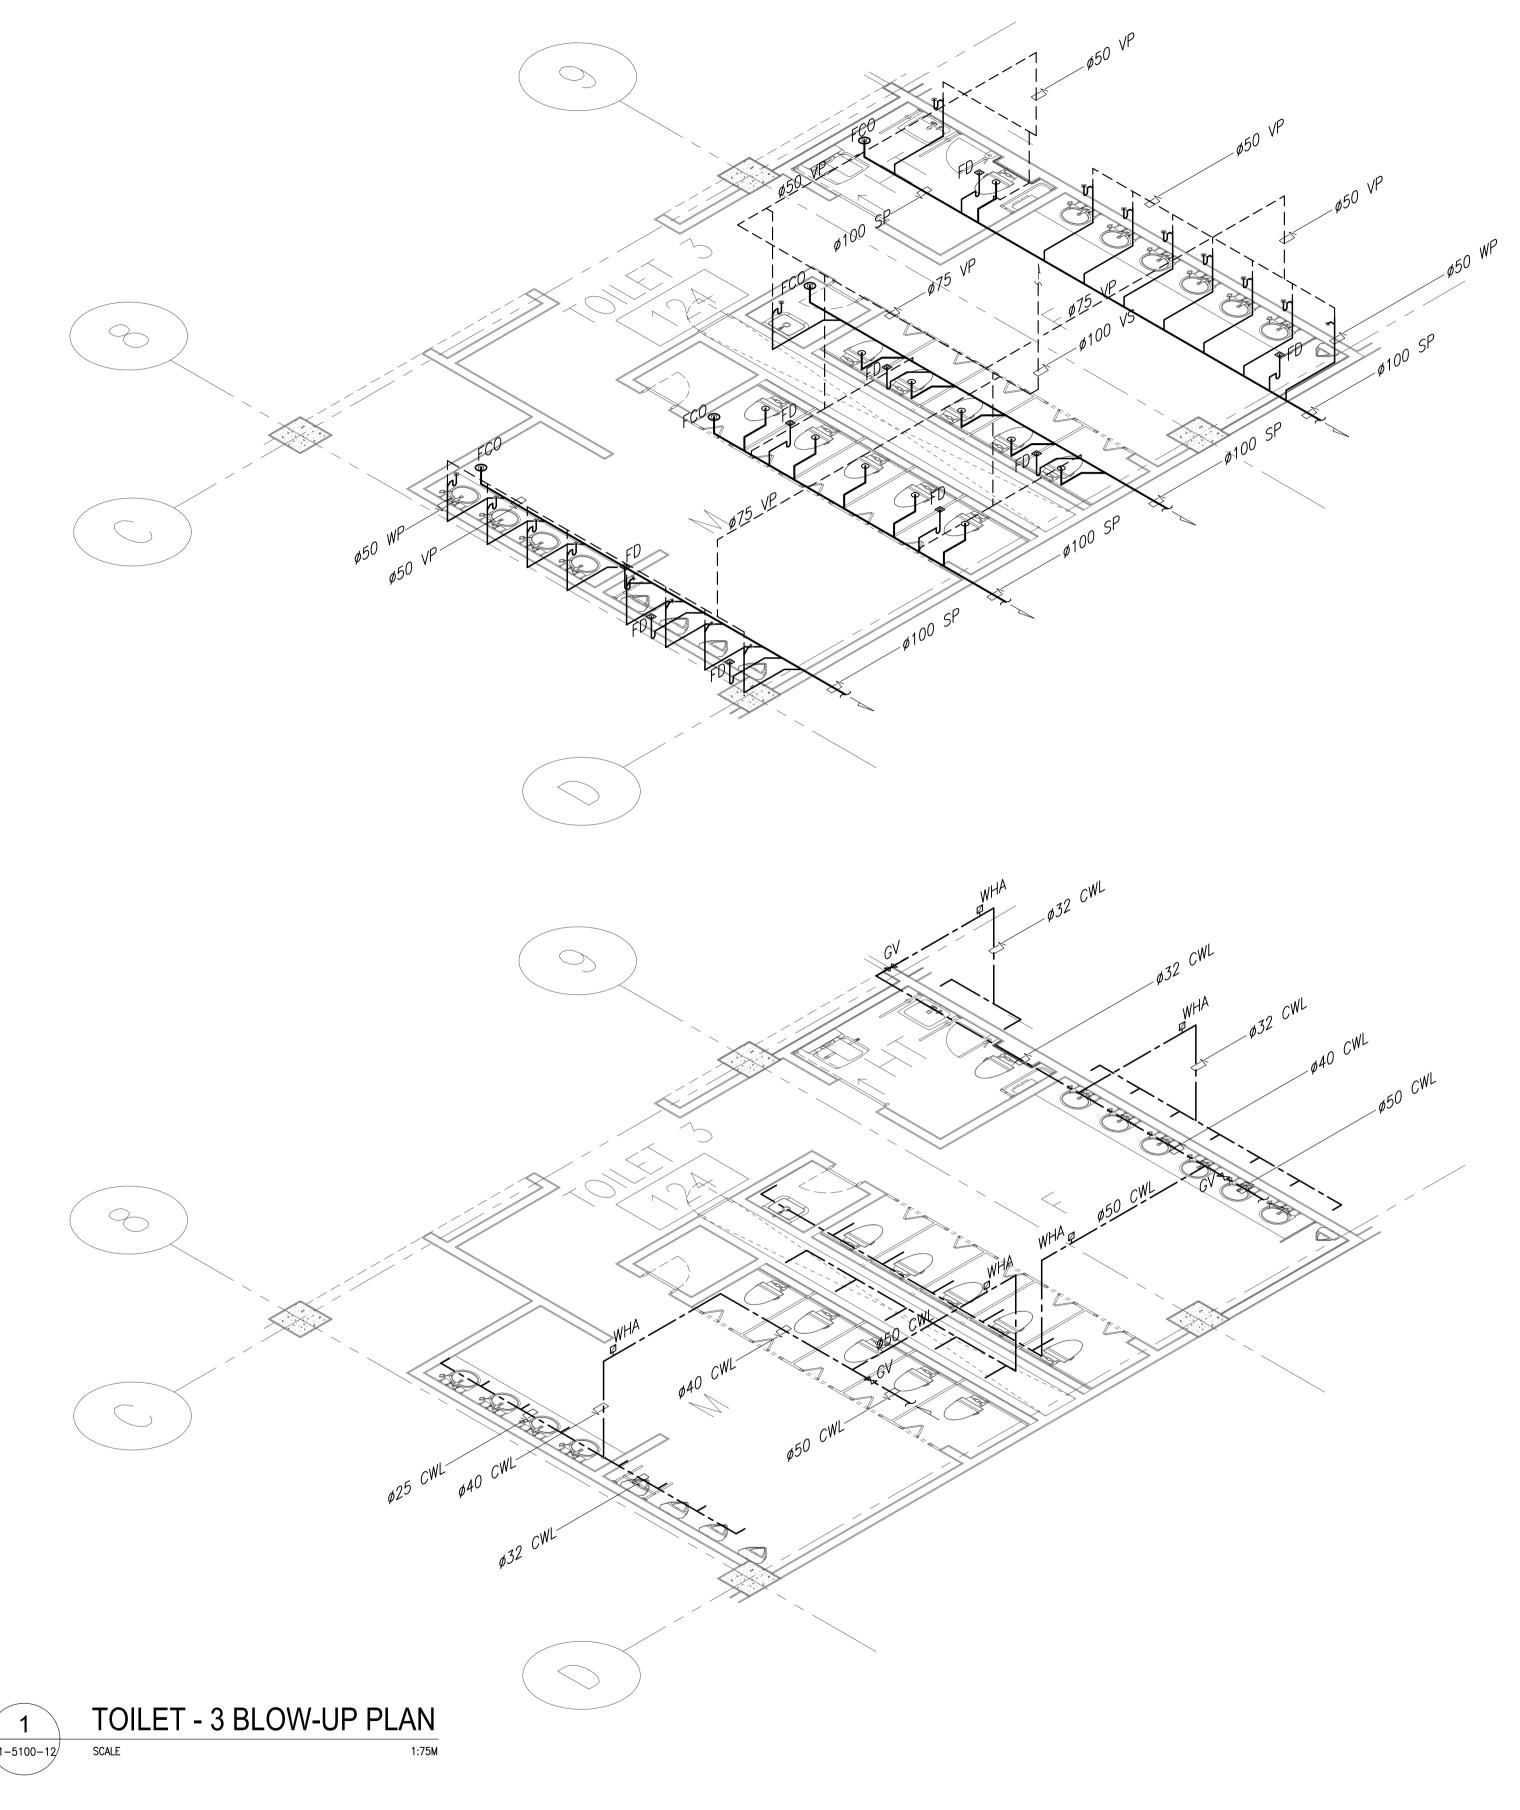

Lasportation			PREPARED BY:	RECOMMENDNG APPROVAL:	APPROVED:	PROJECT TITLE:				SHEET CONTENTS:	SHEET NO:
solument of	Republic of the Philippines DEPARTMENT OF TRANSPORTATION AND	JAPAN INTERNATIONAL COOPERATION AGENCY	LEOVIMEL J. VINELES						_	COMPONENT-4: BUILDING WORKS (B) SUBCOMPONENT-4-1:	B1-5100-12
1899	communications	AGENCY	Filipino Registered Engineer PROF: SANITARY ENGINEER PTR. 2024236 2024236 202423			NEW BOHOL AIRPORT CONSTRUCTION AND				(B1) PASSENGER TERMINAL BUILDING (PTB)	
	JICA DESIGN CONSULT	ANT JOINT VENTURE	REG. NO.: 0002435 DATE: 07-09-2013 T.I.N. 237-652-602-000 PLACE: MANILA			SUSTAINABLE ENVIRONMENT PROTECTION PROJECT					DRAWING SCALE:
JAC	JAPAN AIRPORT CONSULTANTS,	NIPPON KOEI W NJS CONSULTANTS	TADASHI AOI	ILDEFONSO T. PATDU, JR.	JULIANITO G. BUCAYAN, JR.		JUNE 2013	WIM	HC HC	MECHANICAL SANITARY AND PLUMBING TOILET 3 BLOW-UP PLANS	1: 75M
	CONSULTANTS, INC.	CO., LTD.	Team Leader	Assistant Secretary for Project Implementation, DOTC	Undersecretary for Project Implementation, DOTC	LOCATION: MUNICIPALITY OF PANGLAO, PROVINCE OF BOHOL, PHILIPPINES	DATE INDEX AMENDMENTS	Prepared Checked by by		1 TOLLET & DEON OF LENNS	/ 5

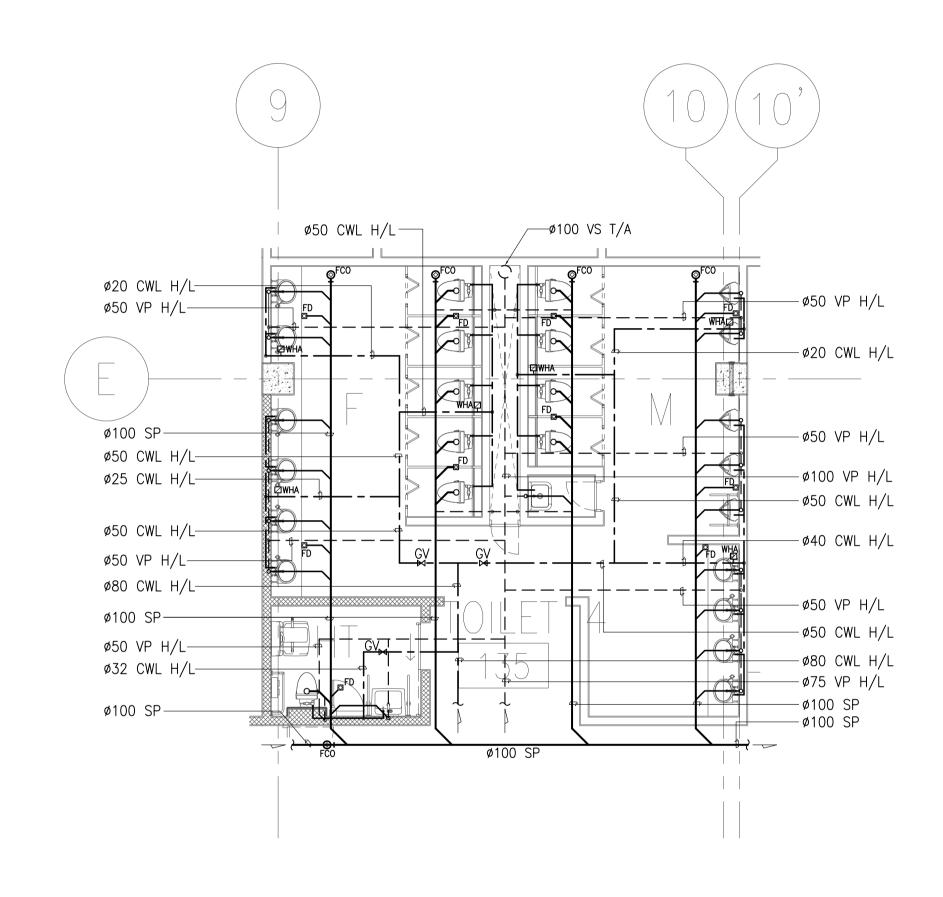

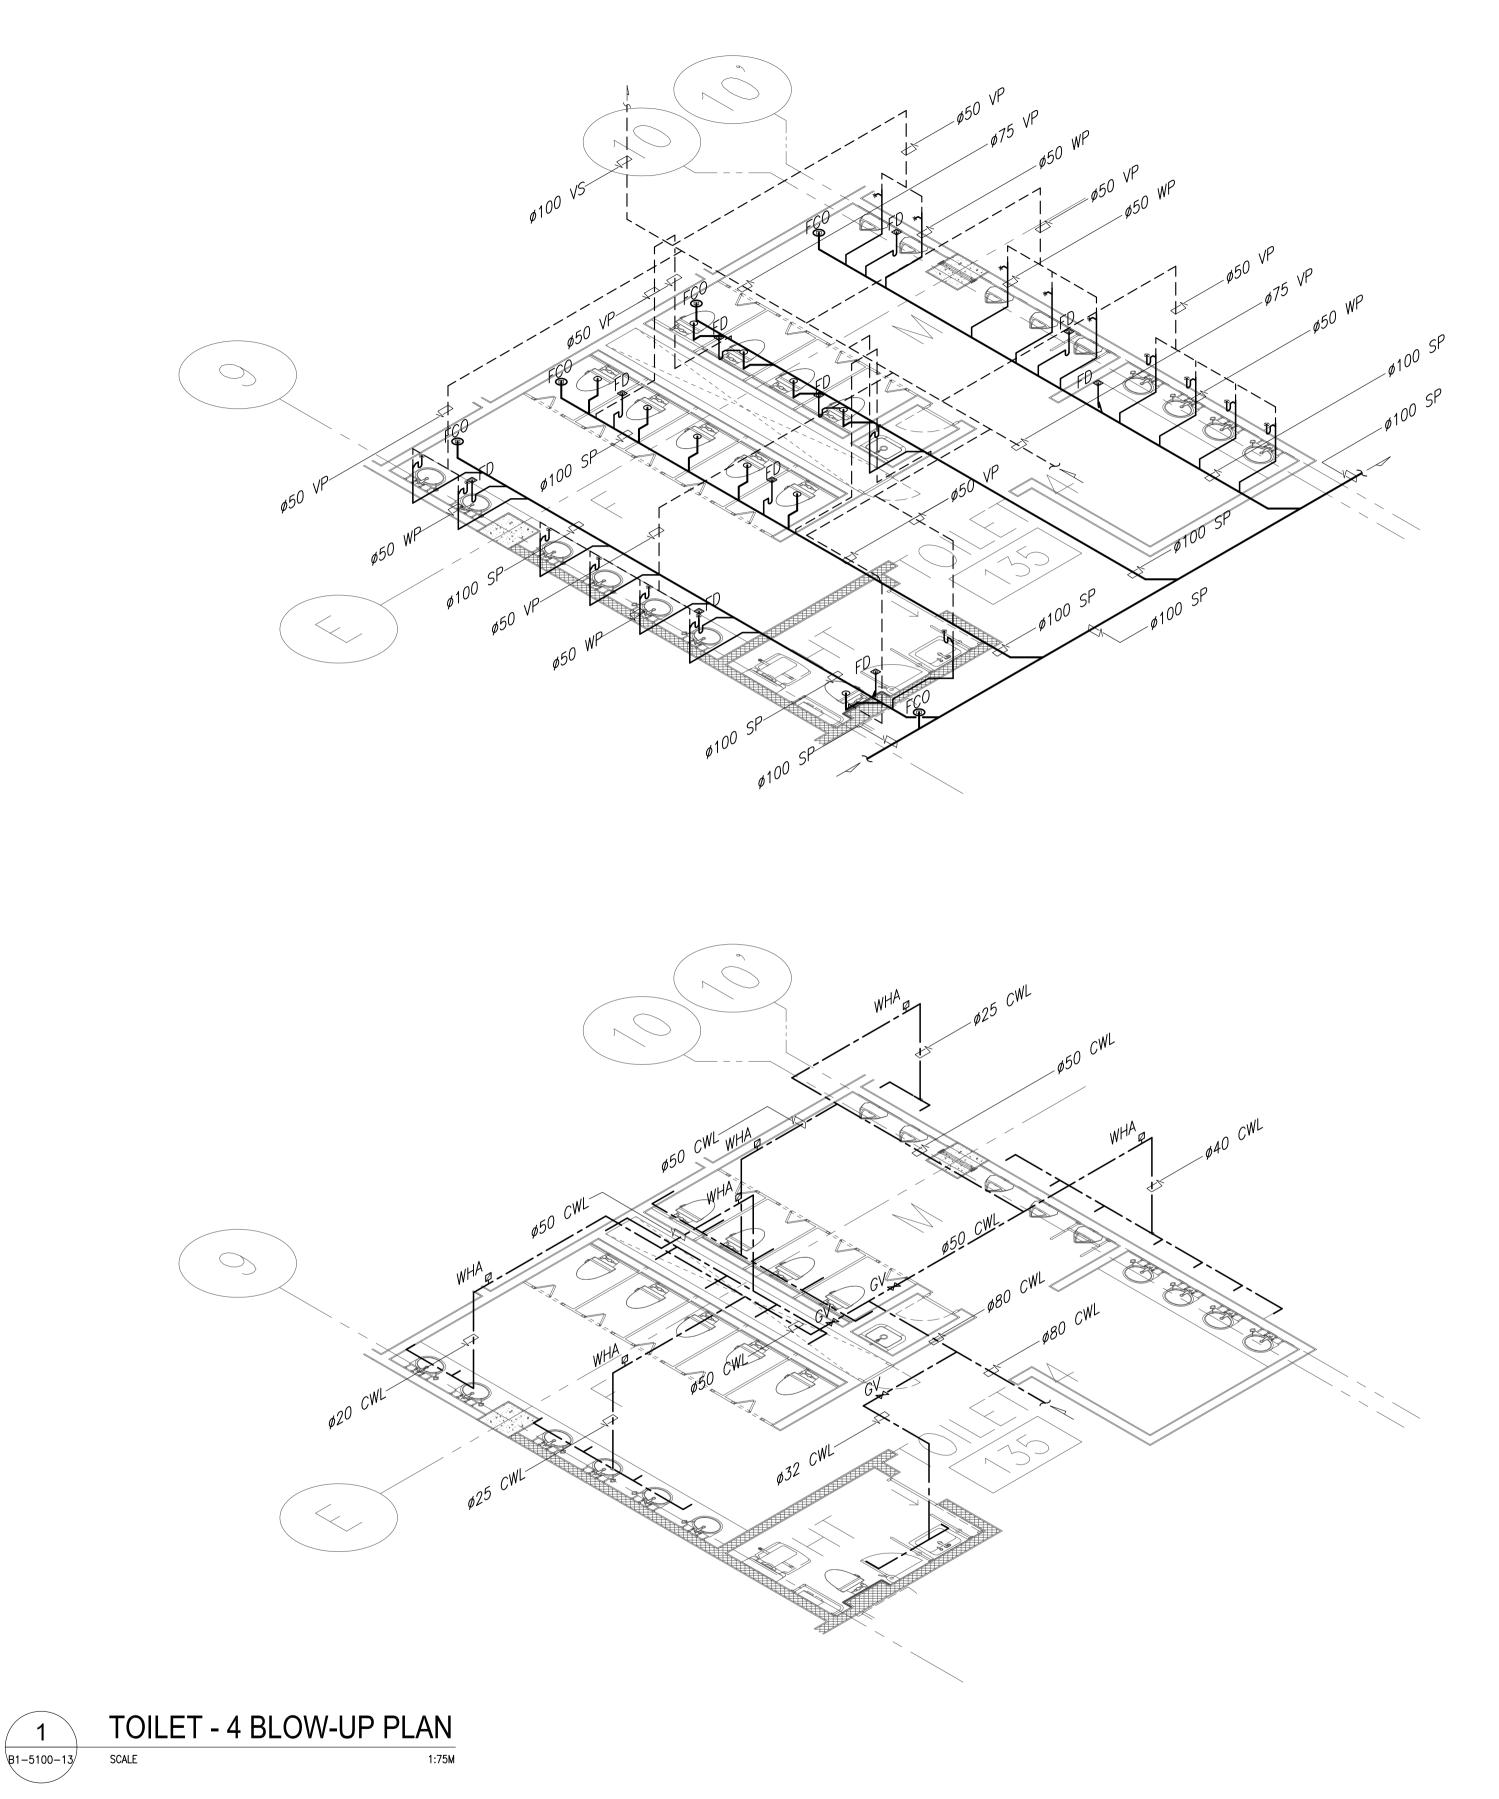


PROJECT TITLE: PREPARED BY: RECOMMENDNG APPROVAL: APPROVED: SHEET CONTENTS: SHEET NO: Republic of the Philippines DEPARTMENT OF TRANSPORTATION AND JAPAN INTERNATIONAL COOPERATION AGENCY COMPONENT-4: BUILDING WORKS (B) B1-5100-13 SUBCOMPONENT-4-1: NEW BOHOL AIRPORT CONSTRUCTION AND COMMUNICATIONS
 PROF:
 SANITARY ENGINEER
 PTR.
 2024236


 REG. NO.: 0002435
 DATE:
 07-09-2013


 T.I.N.
 237-652-602-000
 PLACE:
 MANILA
 (B1) PASSENGER TERMINAL BUILDING (PTB) SUSTAINABLE ENVIRONMENT PROTECTION PROJECT JICA DESIGN CONSULTANT JOINT VENTURE DRAWING SCALE: MECHANICAL SANITARY AND PLUMBING JAC JAPAN AIRPORT CONSULTANTS, INC. NJS CONSULTANTS CO., LTD. ILDEFONSO T. PATDU, JR.
Assistant Secretary
for Project Implementation, DOTC JULIANITO G. BUCAYAN, JR.


Undersecretary


for Project Implementation, DOTC WIM 1:75M TADASHI AOI Team Leader TOILET 4 BLOW-UP PLANS Prepared Checked Validated by by LOCATION: MUNICIPALITY OF PANGLAO, PROVINCE OF BOHOL, PHILIPPINES DATE INDEX AMENDMENTS

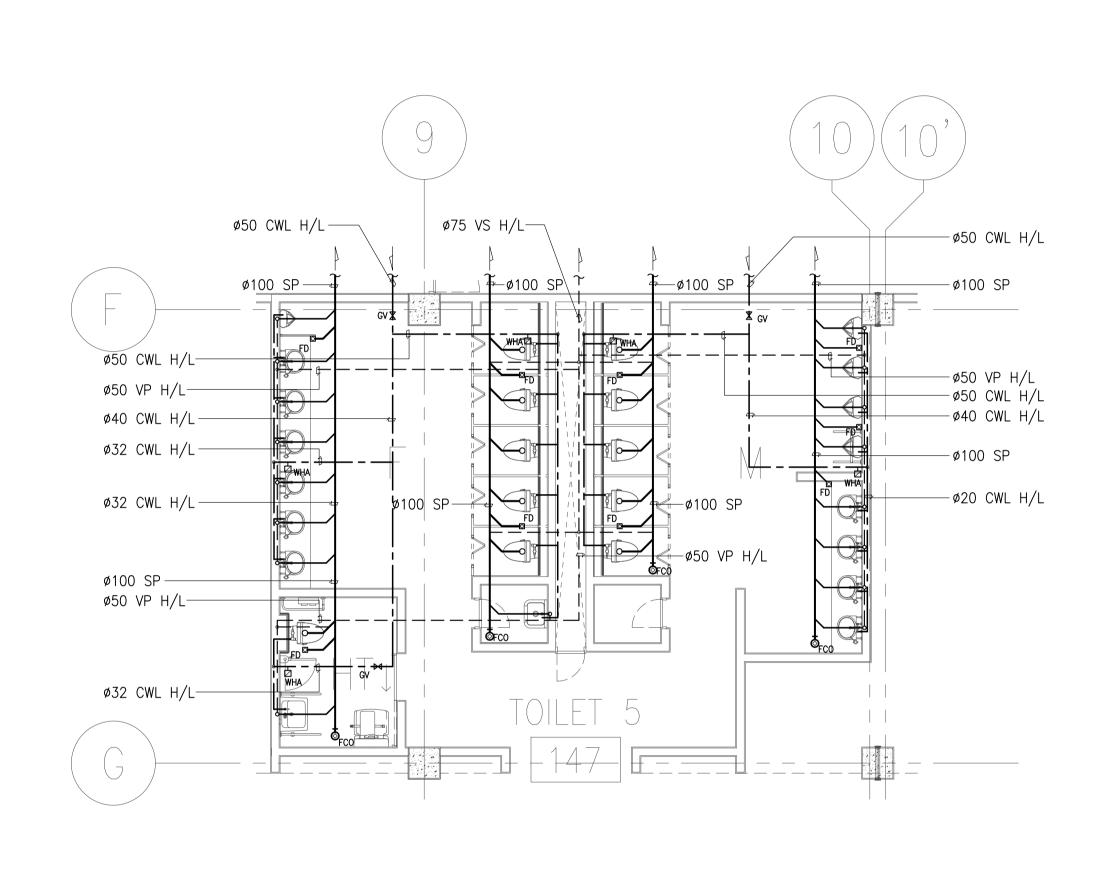

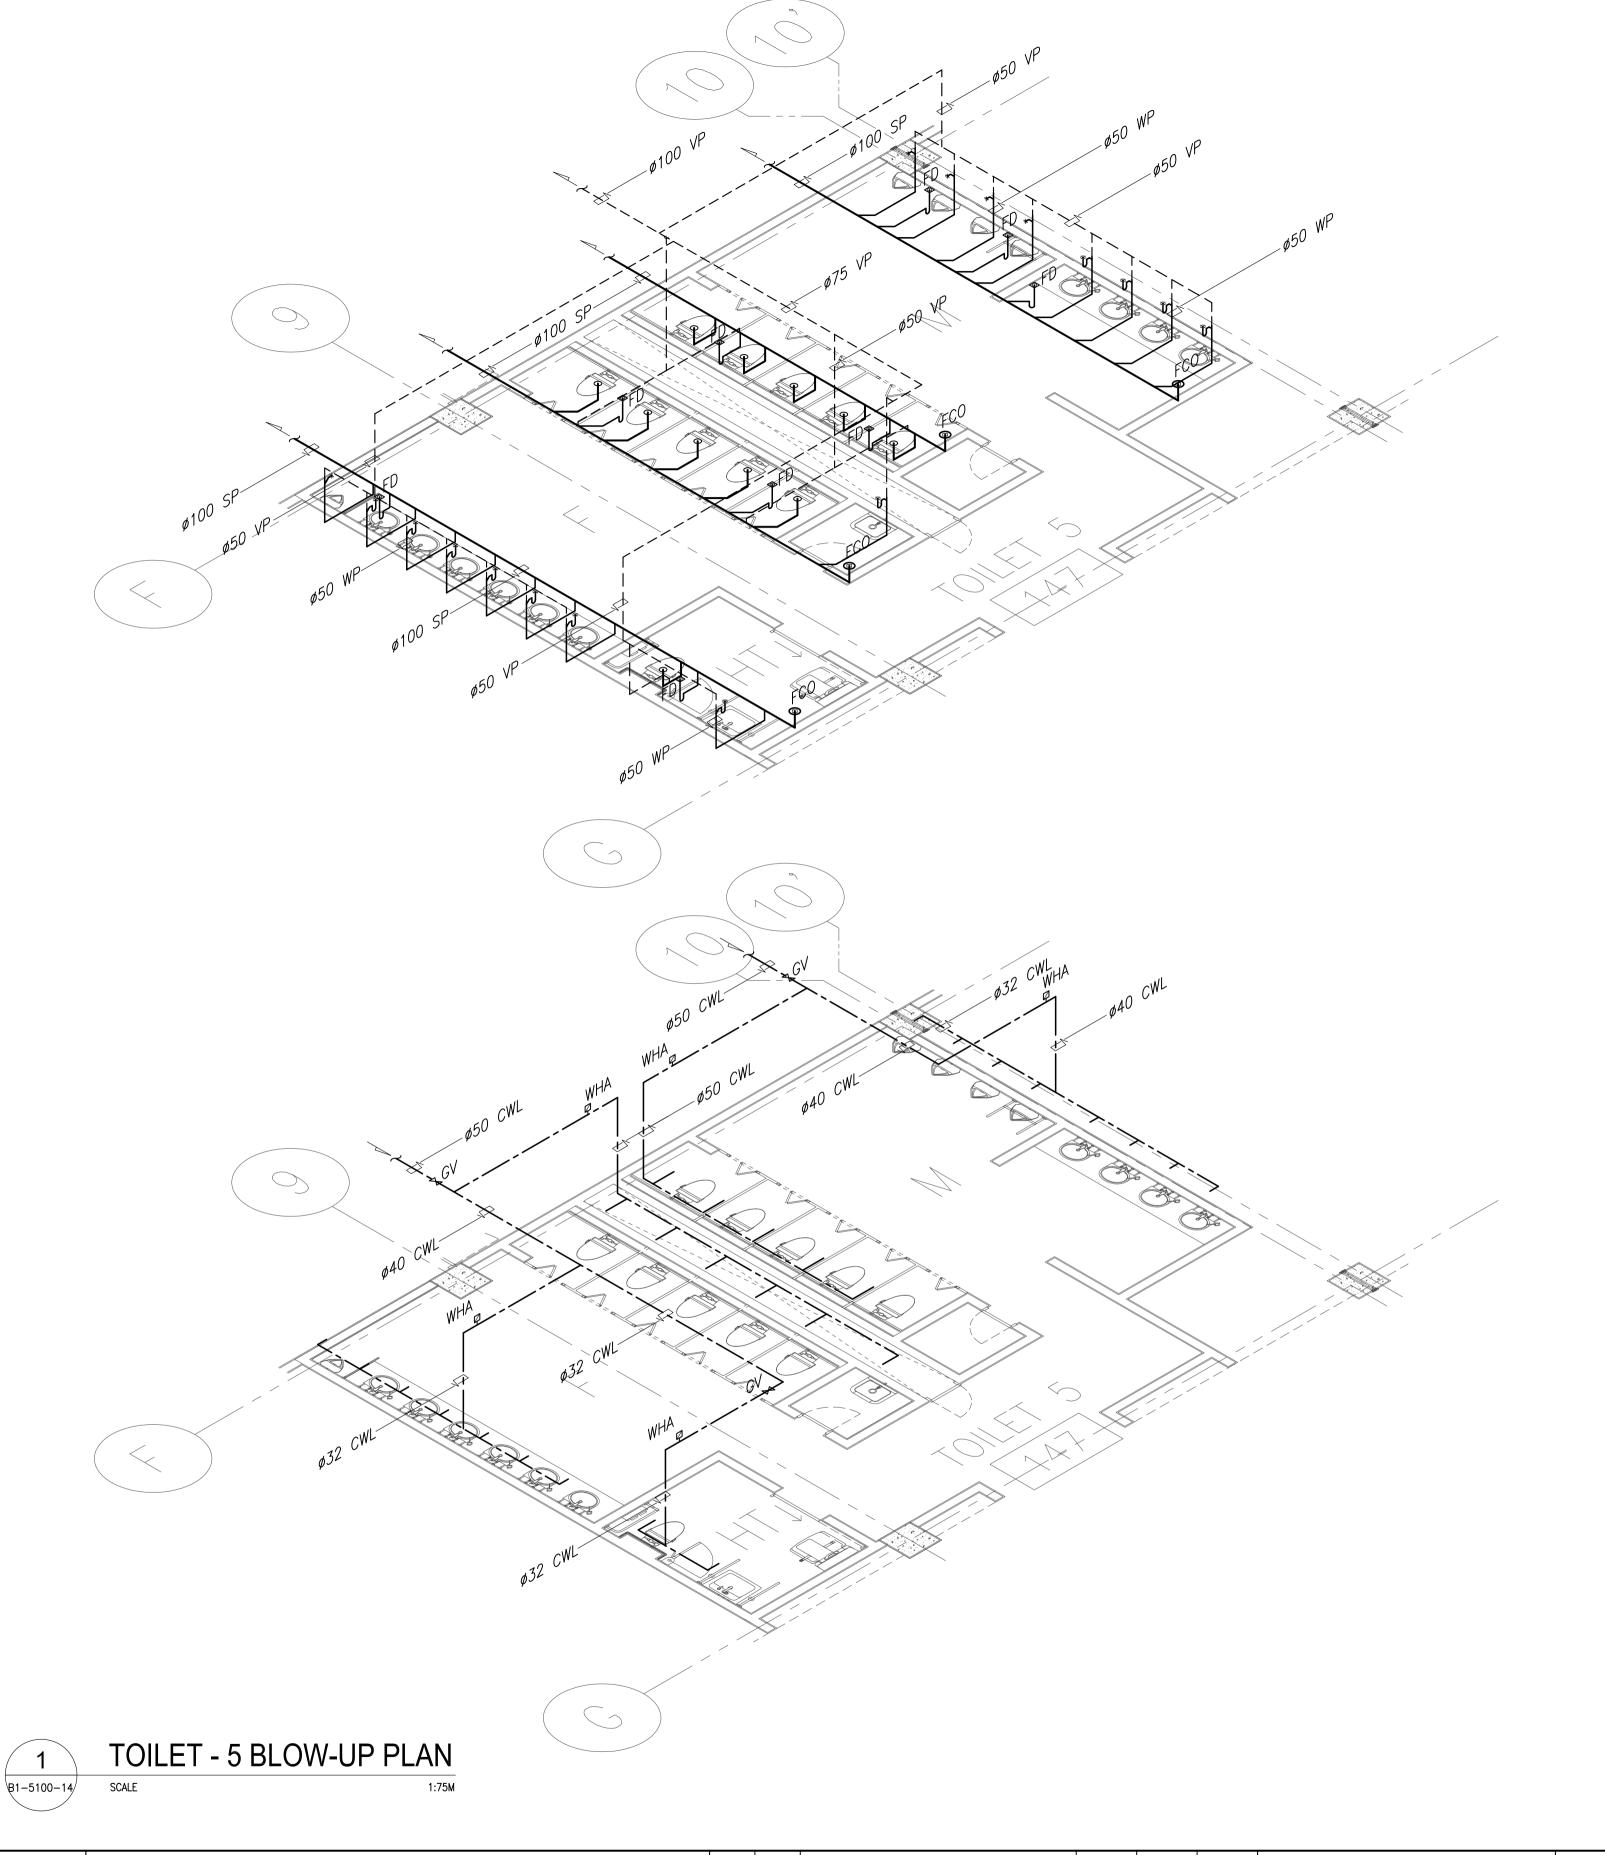


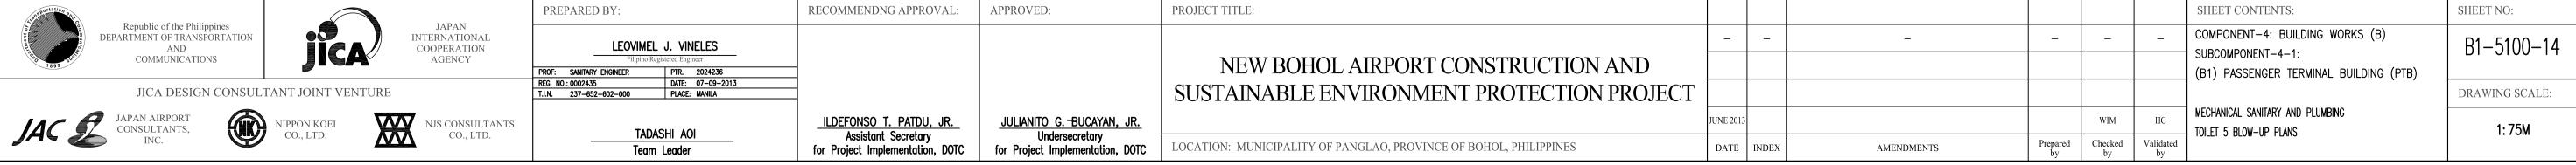

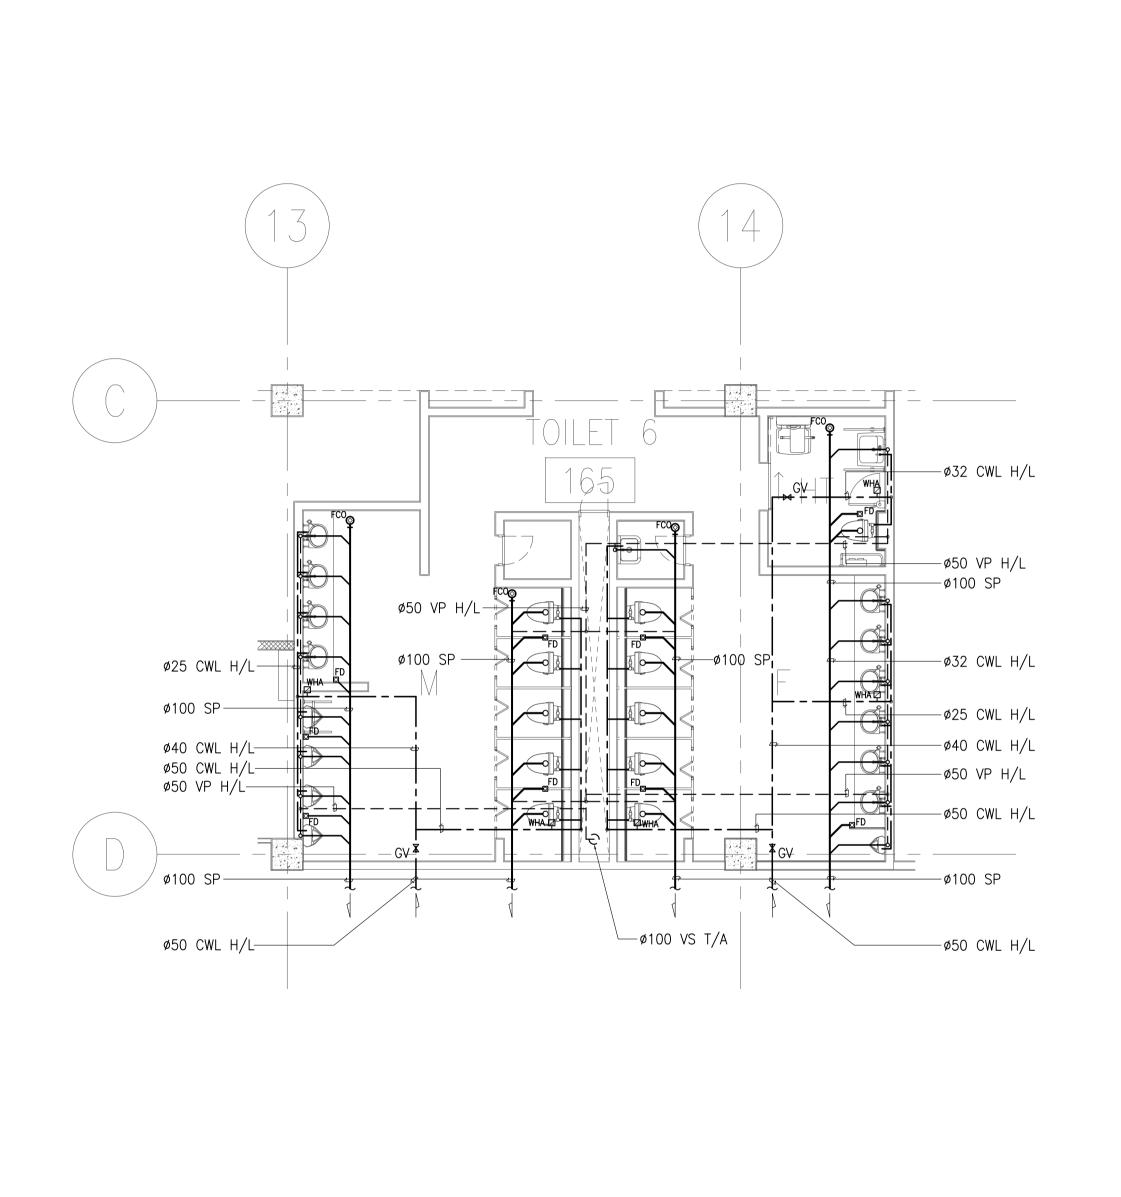

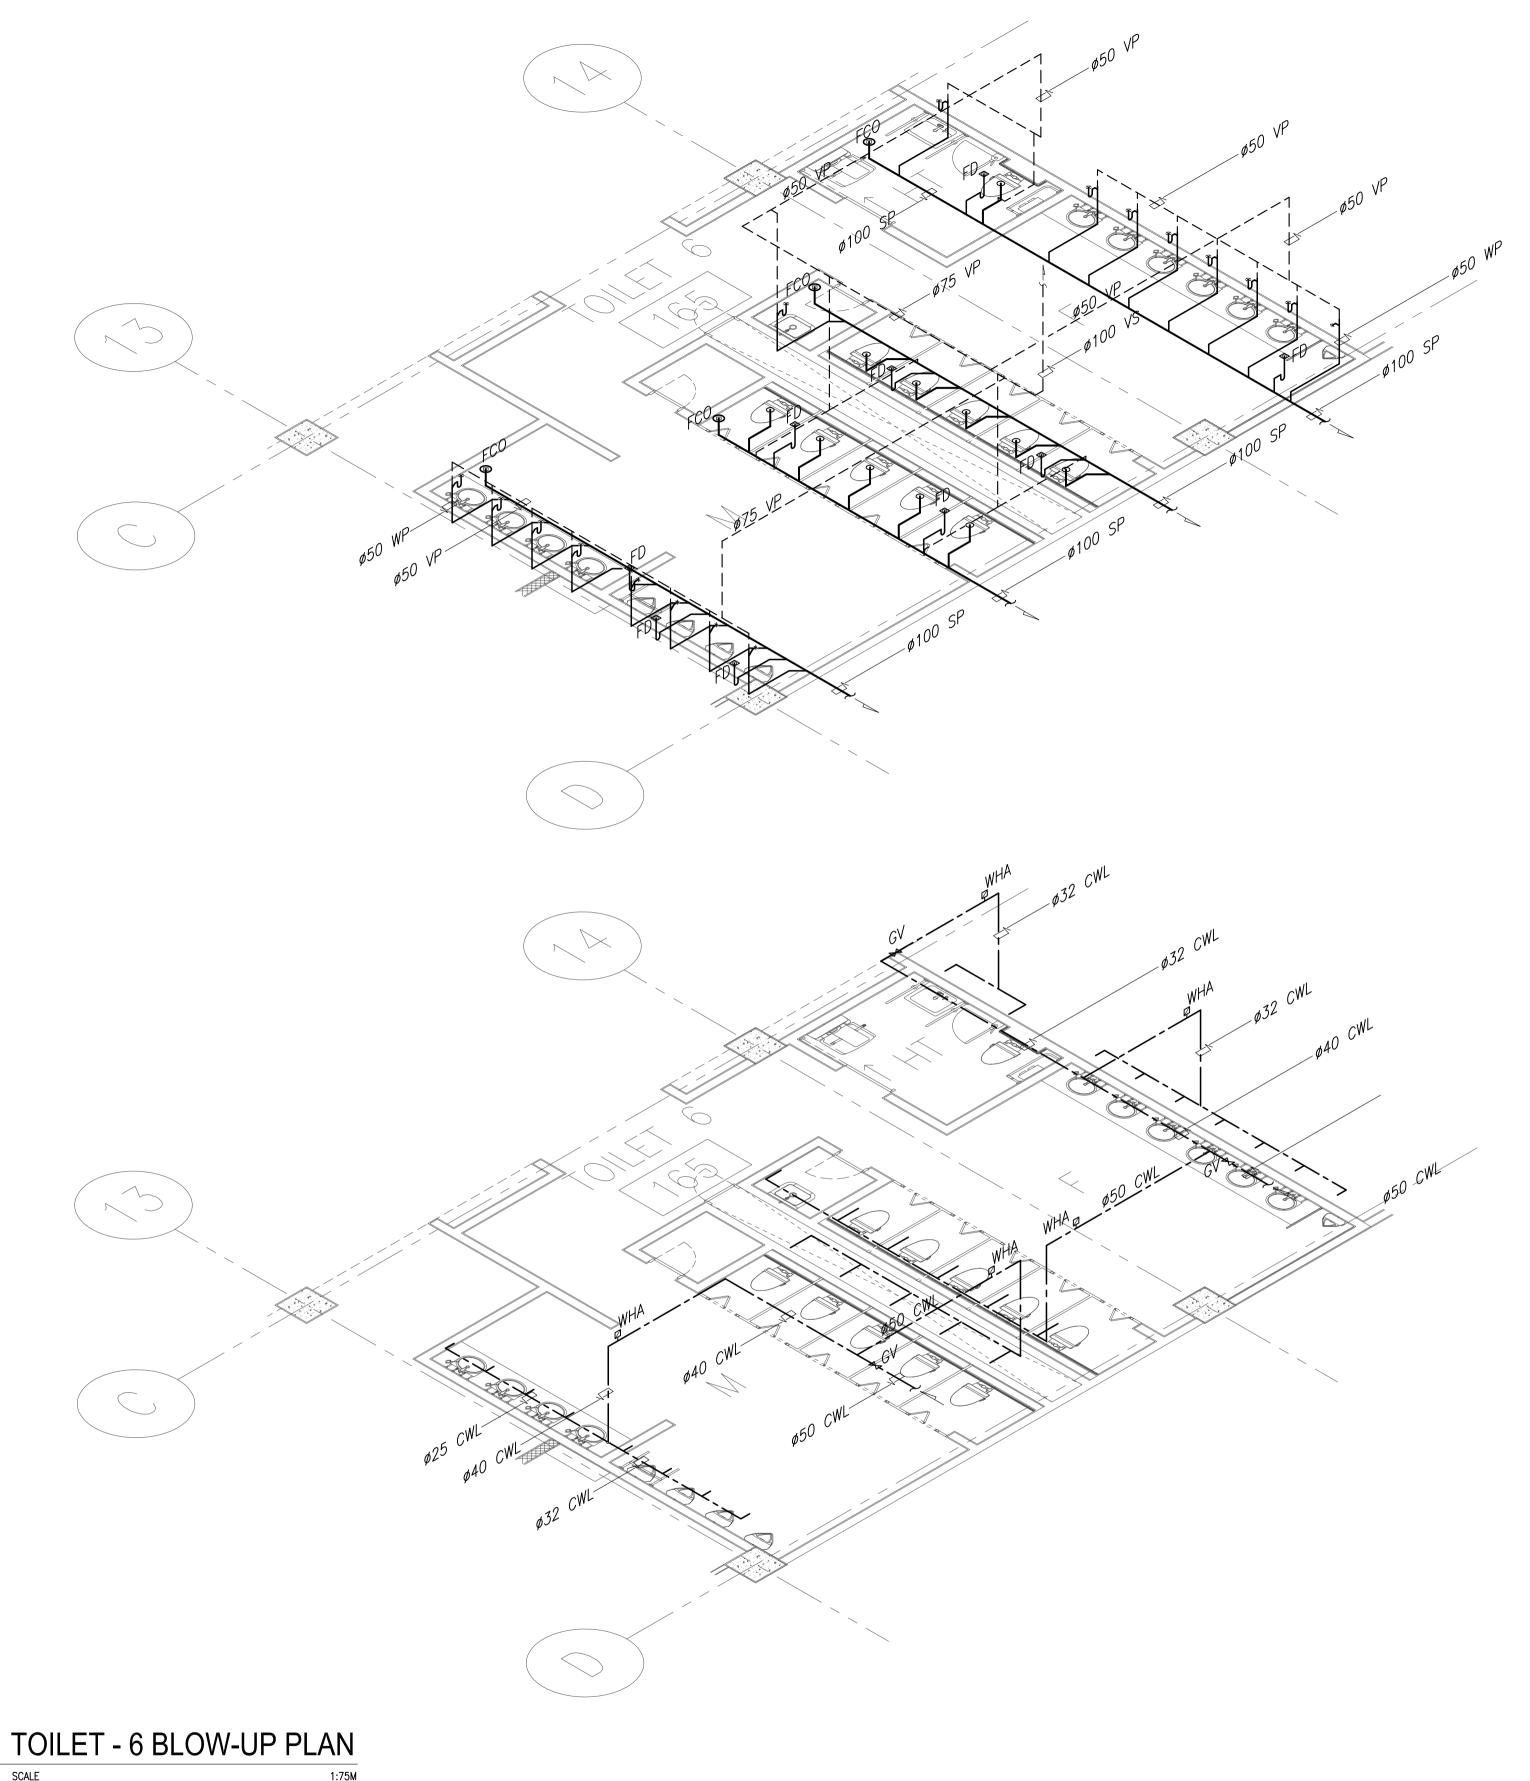

DATE INDEX

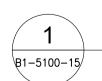

JAPAN INTERNATIONAL COOPERATION AGENCY JICA DESIGN CONSULTANT JOINT VENTURE

Republic of the Philippines DEPARTMENT OF TRANSPORTATION AND

COMMUNICATIONS

NIPPON KOEI CO., LTD.

JAC JAPAN AIRPORT CONSULTANTS, INC.

NJS CONSULTANTS CO., LTD.

PREPARED BY: RECOMMENDNG APPROVAL: APPROVED:
 PROF:
 SANITARY ENGINEER
 PTR.
 2024236

 REG. NO.:
 0002435
 DATE:
 07-09-2013


 T.I.N.
 237-652-602-000
 PLACE:
 MANILA
 ILDEFONSO T. PATDU, JR.
Assistant Secretary
for Project Implementation, DOTC JULIANITO G. BUCAYAN, JR.


Undersecretary
for Project Implementation, DOTC TADASHI AOI Team Leader

PROJECT TITLE: NEW BOHOL AIRPORT CONSTRUCTION AND SUSTAINABLE ENVIRONMENT PROTECTION PROJECT LOCATION: MUNICIPALITY OF PANGLAO, PROVINCE OF BOHOL, PHILIPPINES

SHEET CONTENTS: COMPONENT-4: BUILDING WORKS (B) SUBCOMPONENT-4-1: (B1) PASSENGER TERMINAL BUILDING (PTB) MECHANICAL SANITARY AND PLUMBING WIM TOILET 6 BLOW-UP PLANS Prepared Checked Validated by by AMENDMENTS

SHEET NO: B1-5100-15 DRAWING SCALE: 1:75M

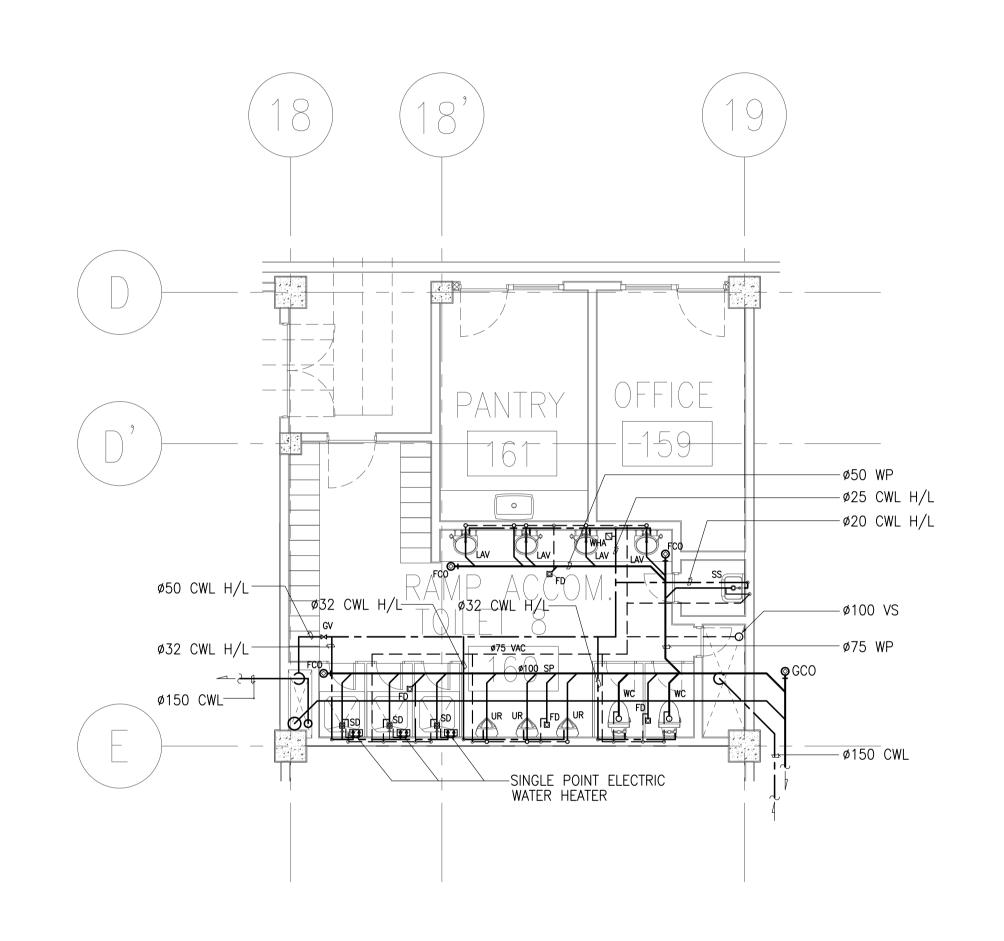

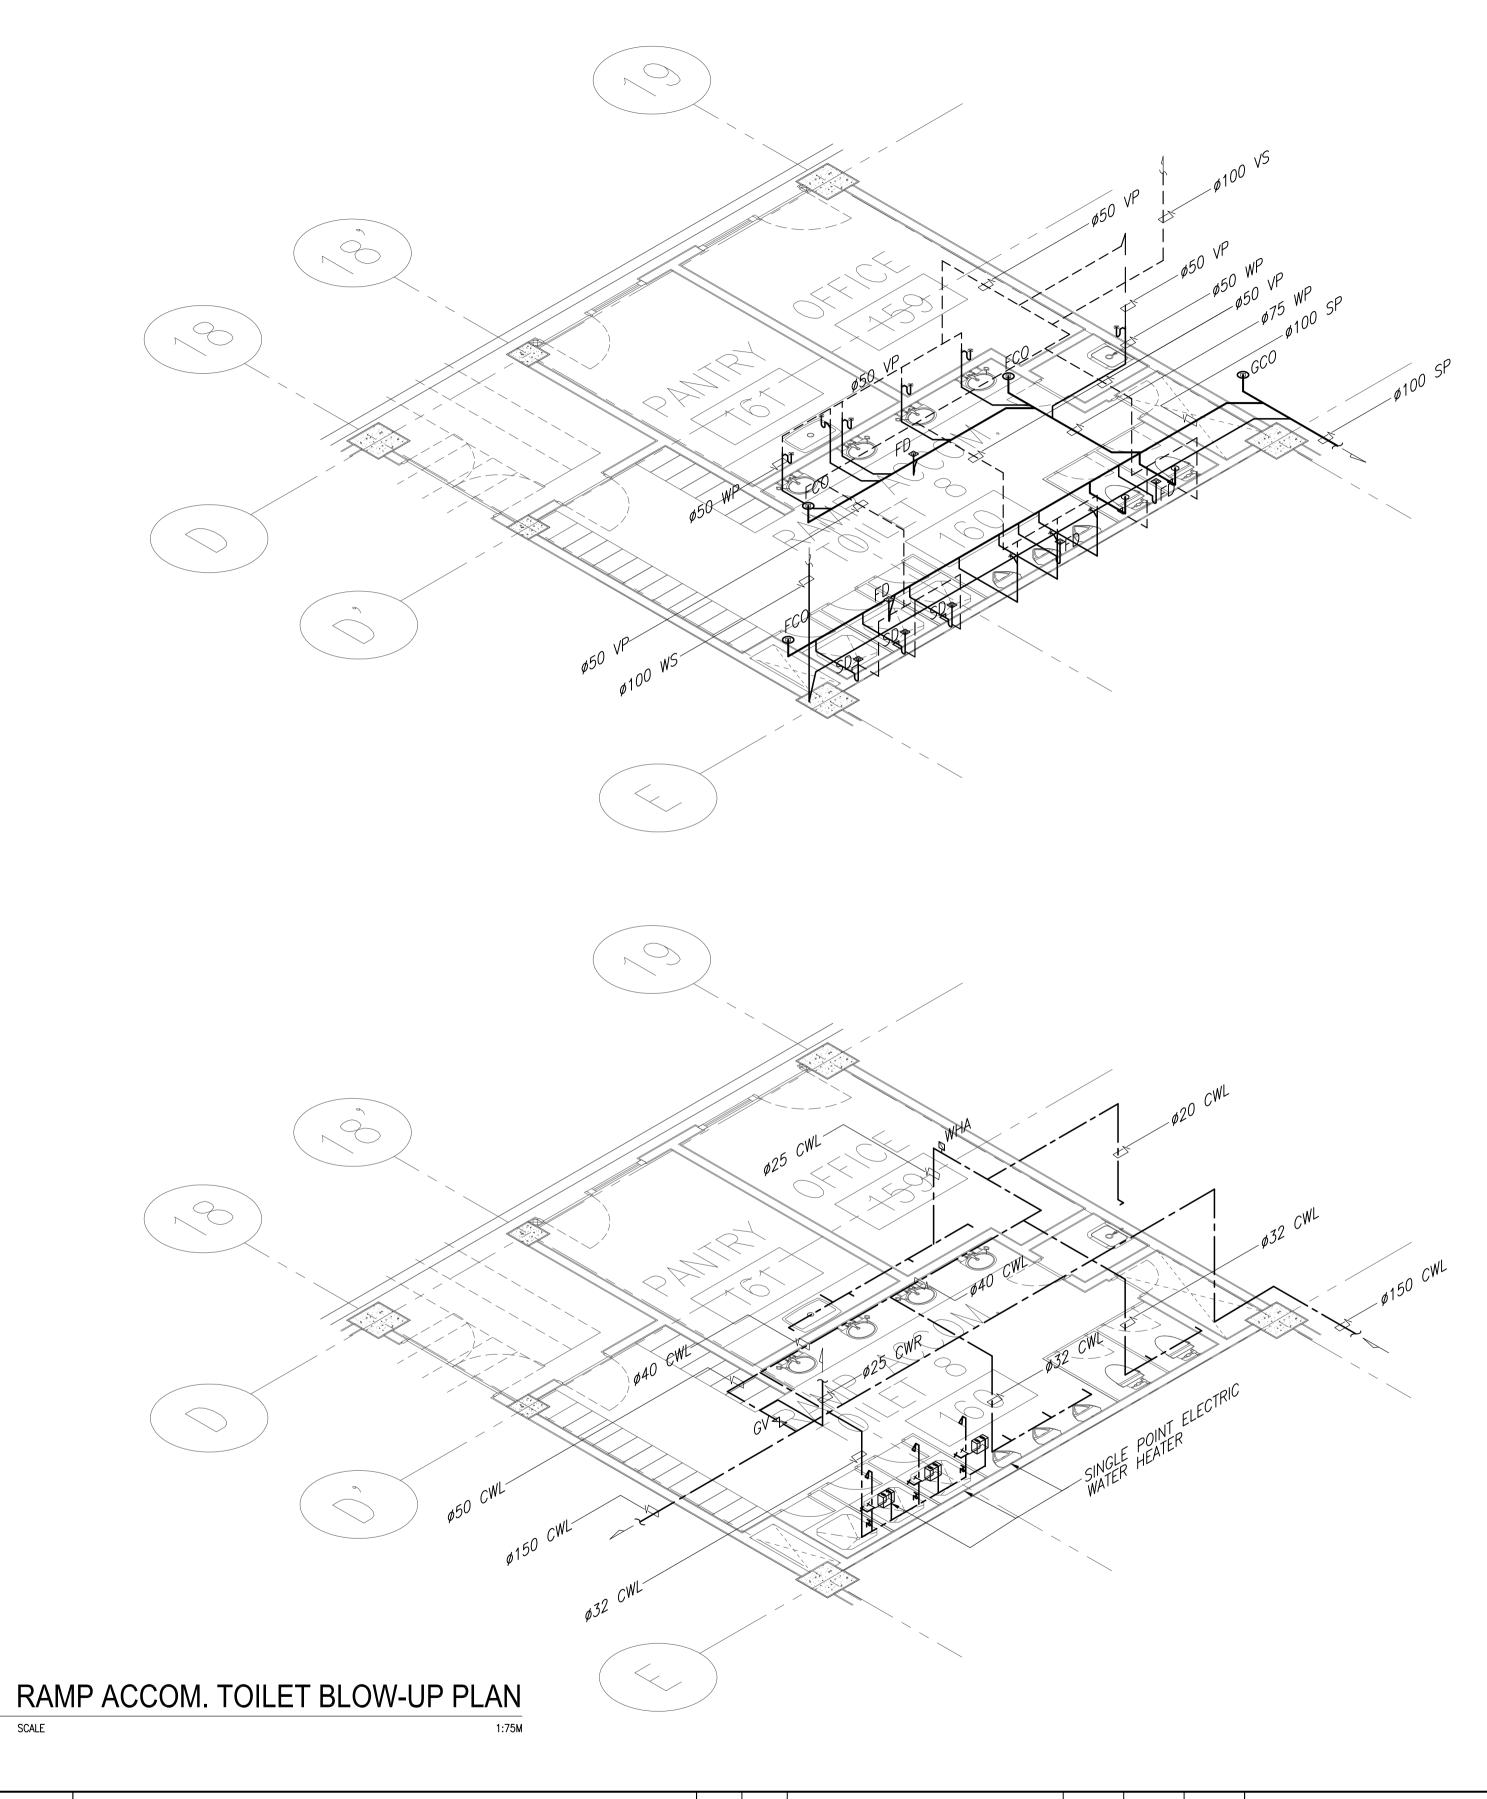

in vortation on pro			PREPARED BY:	RECOMMENDNG APPROVAL:	APPROVED:	PROJECT TITLE:			SHEET CONTENTS:	SHEET NO:
Republic of the Philippi DEPARTMENT OF TRANSPOR	ration JICA	JAPAN INTERNATIONAL COOPERATION	LEOVIMEL J. VINELES						_ COMPONENT-4: BUILDING WORKS (B)	B1-5100-16
COMMUNICATIONS	JICA	COOPERATION AGENCY	Filipino Registered Engineer PROF: SANITARY ENGINEER PTR. 2024236			NEW BOHOL AIRPORT CONSTRUCTION AND			SUBCOMPONENT-4-1: (B1) PASSENGER TERMINAL BUILDING (PTB)	B1 0100 10
JICA DESIGN O	ONSULTANT JOINT VENTURE	-	REG. NO.: 0002435 DATE: 07-09-2013 T.I.N. 237-652-602-000 PLACE: MANILA	-		SUSTAINABLE ENVIRONMENT PROTECTION PROJECT				DRAWING SCALE:
JAC JAPAN AIRPORT CONSULTANTS, INC.	NIPPON KOEI CO., LTD.		TADASHI AOI	ILDEFONSO T. PATDU, JR.	JULIANITO G. BUCAYAN, JR.		JUNE 2013	WIM	HC HC RAMP ACCOM. TOILET BLOW-UP PLANS	1: 75M
INC.	CO., LTD.	CO., LTD.	Team Leader	Assistant Secretary for Project Implementation, DOTC	Undersecretary for Project Implementation, DOTC	LOCATION: MUNICIPALITY OF PANGLAO, PROVINCE OF BOHOL, PHILIPPINES	DATE INDEX AMENDMENTS	Prepared Checked by		, 5

EQUIPMENT LIST (PTB):

INDOOR UNIT		OUTDOOR UNIT							ELECTRICAL CH	HARACTERISTICS		CON	NECTION PIPE	SIZE	EXTERNAL			
UNIT DESIGNATION	QTY.	UNIT DESIGNATION	EQUIPMENT	EQUIPMENT LOCATION & ROOM NO.	LEVEL	TOTAL COOLING CAPACITY (kW)	AIR FLOW (I/s)	POWER INPUT (kW)	VOLTS	PHASE	HERTZ	LEQUID	GAS	DRAIN	STATIC PRESSURE (Pa)	TYPE	REMARKS	ROOM TEMPERATURE
FCU-01A & 01B	2		FAN COIL UNIT	LOST & FOUND BAGGAGE-1	GROUND FLOOR	2.00	191	0.056	230	1	60	6.4	12.7	25		CEILING CASSETTE 4 WAY TYPE FAN COIL UNIT		
FCU-02A TO 02D	4		FAN COIL UNIT	DUTY FREE ON ARRIVAL-1	GROUND FLOOR	2.38	191	0.056	230	1	60	6.4	12.7	25		CEILING CASSETTE 4 WAY TYPE FAN COIL UNIT		
FCU-03A & 03B	2		FAN COIL UNIT	LOST & FOUND BAGGAGE-2	GROUND FLOOR	2.00	191	0.056	230	1	60	6.4	12.7	25		CEILING CASSETTE 4 WAY TYPE FAN COIL UNIT		
FCU-04	1		FAN COIL UNIT	PAHU	GROUND FLOOR	19.50	466	0.380	230	1	60	9.5	19.1	25	205	OUTDOOR AIR PROCESSING UNIT, CEILING SUSPENDED DUCT		
FCU-05A & 05B	2		FAN COIL UNIT	CONCESSION-2	GROUND FLOOR	4.35	225	0.056	230	1	60	6.4	12.7	25		CEILING CASSETTE 4 WAY TYPE FAN COIL UNIT		
FCU-06	1		FAN COIL UNIT	OFFICE-1	GROUND FLOOR	6.70	300	0.056	230	1	60	9.5	15.9	25		CEILING CASSETTE 4 WAY TYPE FAN COIL UNIT		
FCU-07	1		FAN COIL UNIT	OFFICE-2	GROUND FLOOR	6.70	300	0.056	230	1	60	9.5	15.9	25		CEILING CASSETTE 4 WAY TYPE FAN COIL UNIT		
FCU-08	1	VRF-1	FAN COIL UNIT	OFFICE-3	GROUND FLOOR	6.70	300	0.056	230	1	60	9.5	15.9	25		CEILING CASSETTE 4 WAY TYPE FAN COIL UNIT		
FCU-09	1		FAN COIL UNIT	OFFICE-4	GROUND FLOOR	6.70	300	0.056	230	1	60	9.5	15.9	25		CEILING CASSETTE 4 WAY TYPE FAN COIL UNIT		
FCU-10	1		FAN COIL UNIT	TICKETING OFFICE	GROUND FLOOR	4.70	225	0.056	230	1	60	6.4	12.7	25		CEILING CASSETTE 4 WAY TYPE FAN COIL UNIT		
FCU-11	1		FAN COIL UNIT	BANK	GROUND FLOOR	4.70	225	0.056	230	1	60	6.4	12.7	25		CEILING CASSETTE 4 WAY TYPE FAN COIL UNIT		
FCU-12	1		FAN COIL UNIT	CAR RENTAL-2	GROUND FLOOR	4.70	225	0.056	230	1	60	6.4	12.7	25		CEILING CASSETTE 4 WAY TYPE FAN COIL UNIT		
FCU-13A & 13B	2		FAN COIL UNIT	CONCESSION-7	GROUND FLOOR	4.60	225	0.056	230	1	60	6.4	12.7	25		CEILING CASSETTE 4 WAY TYPE FAN COIL UNIT		
FCU-14	1		FAN COIL UNIT	MEETING ROOM	GROUND FLOOR	6.70	300	0.056	230	1	60	9.5	15.9	25		CEILING CASSETTE 4 WAY TYPE FAN COIL UNIT		
FCU-15	1		FAN COIL UNIT	COPY ROOM	GROUND FLOOR	5.10	275	0.056	230	1	60	9.5	15.9	25		CEILING CASSETTE 4 WAY TYPE FAN COIL UNIT		
FCU-16A TO 16D	4		FAN COIL UNIT	CONCESSION-6	GROUND FLOOR	2.70	191	0.056	230	1	60	6.4	12.7	25		CEILING CASSETTE 4 WAY TYPE FAN COIL UNIT		
FCU-17B	1		FAN COIL UNIT	INTERNATIONAL GATE LOUNGE	GROUND FLOOR	24.30	1200	0.760	230	1	60	9.5	22.2	25	270	CEILING MOUNTED DUCT TYPE		
FCU-17D	1		FAN COIL UNIT	DOMESTIC GATE LOUNGE	GROUND FLOOR	22.34	1200	0.760	230	1	60	9.5	22.2	25	270	CEILING MOUNTED DUCT TYPE		
FCU-18D	1		FAN COIL UNIT	PAHU	GROUND FLOOR	24.50	583	0.380	230	1	60	9.5	22.2	25	205	OUTDOOR AIR PROCESSING UNIT, CEILING SUSPENDED DUCT		
FCU-19	1	VRF-2	FAN COIL UNIT	FOBS	GROUND FLOOR	2.50	191	0.056	230	1	60	6.4	12.7	25		CEILING CASSETTE 4 WAY TYPE FAN COIL UNIT		
FCU-20	1		FAN COIL UNIT	SECURITY OFFICE	GROUND FLOOR	2.30	191	0.056	230	1	60	6.4	12.7	25		CEILING CASSETTE 4 WAY TYPE FAN COIL UNIT		
FCU-21	1		FAN COIL UNIT	SECURITY OFFICE	GROUND FLOOR	2.30	191	0.056	230	1	60	6.4	12.7	25		CEILING CASSETTE 4 WAY TYPE FAN COIL UNIT		
FCU-22A TO 22D	4		FAN COIL UNIT	CONCESSION-5	GROUND FLOOR	1.98	191	0.056	230	1	60	6.4	12.7	25		CEILING CASSETTE 4 WAY TYPE FAN COIL UNIT		
FCU-23A TO 23D	4		FAN COIL UNIT	CONCESSION-8	GROUND FLOOR	4.00	225	0.056	230	1	60	6.4	12.7	25		CEILING CASSETTE 4 WAY TYPE FAN COIL UNIT		24 C+/DB
FCU-24A & 24B	2		FAN COIL UNIT	CONCESSION-9	GROUND FLOOR	2.45	191	0.056	230	1	60	6.4	12.7	25		CEILING CASSETTE 4 WAY TYPE FAN COIL UNIT		17.2 C WB
FCU-17F & 17H	2		FAN COIL UNIT	DOMESTIC GATE LOUNGE	GROUND FLOOR	22.34	1200	0.760	230	1	60	9.5	22.2	25	270	CEILING MOUNTED DUCT TYPE		
FCU-18	1	VRF-3	FAN COIL UNIT	PAHU	GROUND FLOOR	24.50	583	0.380	230	1	60	9.5	22.2	25	205	OUTDOOR AIR PROCESSING UNIT, CEILING SUSPENDED DUCT		
FCU-19A, 19CM, 19E	3		FAN COIL UNIT	CHECK IN LOBBY (SPOT COOLING)	GROUND FLOOR	10.80	466	0.120	230	1	60	9.5	15.9	25		CEILING CASSETTE 4 WAY TYPE FAN COIL UNIT		
FCU-20E & 20F	2		FAN COIL UNIT	SECURITY CHECK (SPOT COOLING)	GROUND FLOOR	3.30	216	0.056	230	1	60	6.4	12.7	25		CEILING CASSETTE 4 WAY TYPE FAN COIL UNIT		
FCU-17J	1		FAN COIL UNIT	DOMESTIC GATE LOUNGE	GROUND FLOOR	22.34	1200	0.760	230	1	60	9.5	22.2	25	270	CEILING MOUNTED DUCT TYPE		
FCU-18K	1		FAN COIL UNIT	PAHU	GROUND FLOOR	24.50	583	0.380	230	1	60	9.5	22.2	25	205	OUTDOOR AIR PROCESSING UNIT, CEILING SUSPENDED DUCT		
FCU-19G, 19I, 19K	3		FAN COIL UNIT	CHECK IN LOBBY (SPOT COOLING)	GROUND FLOOR	10.80	466	0.120	230	1	60	9.5	15.9	25		CEILING CASSETTE 4 WAY TYPE FAN COIL UNIT		
FCU-25	1	VRF-4	FAN COIL UNIT	BHS INLINE SCREENING (SPOT COOLING)	GROUND FLOOR	3.90	216	0.056	230	1	60	6.4	12.7	25		CEILING CASSETTE 4 WAY TYPE FAN COIL UNIT		
FCU-26A & 26B	2		FAN COIL UNIT	CONCESSION-9	GROUND FLOOR	2.45	191	0.056	230	1	60	6.4	12.7	25		CEILING CASSETTE 4 WAY TYPE FAN COIL UNIT		
FCU-27	1		FAN COIL UNIT	RAMP OFFICE	GROUND FLOOR	4.60	225	0.056	230	1	60	6.4	12.7	25		CEILING CASSETTE 4 WAY TYPE FAN COIL UNIT		
FCU-28A TO 28D	4		FAN COIL UNIT	CONCESSION-12	GROUND FLOOR	5.30	275	0.056	230	1	60	9.5	15.9	25		CEILING CASSETTE 4 WAY TYPE FAN COIL UNIT		
FCU-29A & 29B	2		FAN COIL UNIT	QUARANTINE	GROUND FLOOR	2.70	191	0.056	230	1	60	6.4	12.7	25		CEILING CASSETTE 4 WAY TYPE FAN COIL UNIT	EMERGENCY POWER, DUTY	
FCU-30	1		FAN COIL UNIT	AOD	GROUND FLOOR	3.40	216	0.056	230	1	60	6.4	12.7	25		CEILING CASSETTE 4 WAY TYPE FAN COIL UNIT	EMERGENCY POWER, DUTY	
FCU-31	1		FAN COIL UNIT	CUSTOM OFFICE	GROUND FLOOR	2.50	191	0.056	230	1	60	6.4	12.7	25		CEILING CASSETTE 4 WAY TYPE FAN COIL UNIT	EMERGENCY POWER, DUTY	
FCU-32	1		FAN COIL UNIT	CASHIER	GROUND FLOOR	0.90	75	0.040	230	1	60	6.4	12.7	13		WALL MOUNTED	EMERGENCY POWER, DUTY	
FCU-33	1	VRF-5	FAN COIL UNIT	INTELLIGENCE	GROUND FLOOR	2.30	191	0.056	230	1	60	6.4	12.7	25		CEILING CASSETTE 4 WAY TYPE FAN COIL UNIT	EMERGENCY POWER, DUTY	
FCU-34	1		FAN COIL UNIT	ICTS	GROUND FLOOR	1.20	75	0.040	230	1	60	6.4	12.7	25		WALL MOUNTED	EMERGENCY POWER, DUTY	
FCU-35A TO 35D	4		FAN COIL UNIT	cco	GROUND FLOOR	5.95	275	0.056	230	1	60	9.5	15.9	25		CEILING CASSETTE 4 WAY TYPE FAN COIL UNIT	EMERGENCY POWER, DUTY	
FCU-18A, 18I, 18J	3		FAN COIL UNIT	PAHU	GROUND FLOOR	24.50	583	0.380	230	1	60	9.5	22.2	25	205	OUTDOOR AIR PROCESSING UNIT, CEILING SUSPENDED DUCT	EMERGENCY POWER, DUTY	
FCU-17A TO 17C	2		FAN COIL UNIT	INTERNATIONAL GATE LOUNGE	GROUND FLOOR	24.30	1200	0.760	230	1	60	9.5	22.2	25	270	CEILING SOSI ENDED BOCT	EMERGENCY POWER, DUTY	
FCU-36A TO 36D	4		FAN COIL UNIT	DUTY FREE CONCESSION-4	GROUND FLOOR	2.60	191	0.056	230	1	60	6.4	12.7	25		CEILING CASSETTE 4 WAY TYPE FAN COIL UNIT	EMERGENCY POWER, DUTY	
FCU-18B & 18C	2	VRF-6	FAN COIL UNIT	PAHU	GROUND FLOOR	24.50	583	0.380	230	1	60	9.5	22.2	25		OUTDOOR AIR PROCESSING UNIT, CEILING SUSPENDED DUCT	EMERGENCY POWER, DUTY	
FCU-37	1		FAN COIL UNIT	ELEC ROOM-2	GROUND FLOOR	5.20	233	0.062	230	1	60	9.5	15,9	13		CEILING SUSPENDED	EMERGENCY POWER, DUTY	
FCU-38A & 38B	2		FAN COIL UNIT	STAFF & GOODS	GROUND FLOOR	3.95	225	0.056	230	1	60	6.4	12.7	25		CEILING CASSETTE 4 WAY TYPE FAN COIL UNIT	EMERGENCY POWER, DUTY	
	ı	ı			1			1	ı	I	ı	<u>I</u>	ı	I	1	1		

representation of the second s	PREPARED BY:	RECOMMENDNG APPROVAL:	APPROVED:	PROJECT TITLE:					SHEET CONTENTS:	SHEET NO:
Republic of the Philippines DEPARTMENT OF TRANSPORTATION AND JAPAN INTERNATIONAL COOPERATION	RENATO A. ARRIOLA					-		_	COMPONENT-4: BUILDING WORKS (B)	B1-5200-01
AND COOPERATION AGENCY	PROF: MECHANICAL ENGINEER PTR. 1725187			NEW BOHOL AIRPORT CONSTRUCTION AND					SUBCOMPONENT-4-1: (B1) PASSENGER TERMINAL BUILDING (PTB)	D1-3200-01
JICA DESIGN CONSULTANT JOINT VENTURE	REG. NO.: 2379 DATE: JANUARY 01, 2013 T.I.N. 150-563-379 PLACE: TAGUIG CITY	_		SUSTAINABLE ENVIRONMENT PROTECTION PROJECT					(BT) TASSENCEN TENNINAL BOILDING (TTD)	DRAWING SCALE:
JAC JAPAN AIRPORT CONSULTANTS, INC. NIPPON KOEI CO., LTD. NJS CONSULTANTS CO., LTD.	TADAÇUI AOI	ILDEFONSO T. PATDU, JR.	JULIANITO G. BUCAYAN, JR.		JUNE 2013		WIM	НС	MECHANICAL VENTILATION AND AIR—CONDITIONING	AS SHOWN
INC. CO., LTD. CO., LTD.	TADASHI AOI Team Leader	Assistant Secretary for Project Implementation, DOTC	Undersecretary for Project Implementation, DOTC	LOCATION: MUNICIPALITY OF PANGLAO, PROVINCE OF BOHOL, PHILIPPINES	DATE INDEX	AMENDMENTS	Prepared Checked by by	Validated by	EQUIPMENT SCHEDULE (PART 1)	AS SHOWN

EQUIPMENT LIST (PTB):

INDOOR UNIT		OUTDOOR UNIT							ELECTRICAL CH	HARACTERISTICS		CON	INECTION PIPE	SIZE	EVTEDNA			
UNIT DESIGNATION	QTY.	UNIT DESIGNATION	EQUIPMENT	EQUIPMENT LOCATION & ROOM NO.	LEVEL	TOTAL COOLING CAPACITY (kW)	AIR FLOW (I/s)	POWER INPUT (kW)	VOLTS	PHASE	HERTZ	LEQUID	GAS	DRAIN	EXTERNAL STATIC PRESSURE (Pa)	TYPE	REMARKS	ROOM TEMPERATURE
FCU-17E, 17G, 17I	3		FAN COIL UNIT	DOMESTIC GATE LOUNGE	GROUND FLOOR	22.34	1200	0.760	230	1	60	9.5	22.2	25	270	CEILING MOUNTED DUCT TYPE	EMERGENCY POWER, DUTY	
FCU-18E	1		FAN COIL UNIT	PAHU	GROUND FLOOR	24.50	583	0.380	230	1	60	9.5	22.2	25	205	OUTDOOR AIR PROCESSING UNIT, CEILING SUSPENDED DUCT	EMERGENCY POWER, DUTY	
FCU-19B	1		FAN COIL UNIT	CHECK IN LOBBY (SPOT COOLING)	GROUND FLOOR	10.80	466	0.120	230	1	60	9.5	15.9	25		CEILING CASSETTE 4 WAY TYPE FAN COIL UNIT	EMERGENCY POWER, DUTY	
FCU-39A	1	\/DE_7	FAN COIL UNIT	AIR LINE OFFICE-1	GROUND FLOOR	1.20	75	0.040	230	1	60	6.4	12.7	13		WALL MOUNTED	EMERGENCY POWER, DUTY	
FCU-39B	1	VRF-7	FAN COIL UNIT	AIR LINE OFFICE-2	GROUND FLOOR	1.20	75	0.040	230	1	60	6.4	12.7	13		WALL MOUNTED	EMERGENCY POWER, DUTY	
FCU-39C	1		FAN COIL UNIT	AIR LINE OFFICE-3	GROUND FLOOR	1.20	75	0.040	230	1	60	6.4	12.7	13		WALL MOUNTED	EMERGENCY POWER, DUTY	
FCU-39D	1		FAN COIL UNIT	AIR LINE OFFICE-4	GROUND FLOOR	1.20	75	0.040	230	1	60	6.4	12.7	13		WALL MOUNTED	EMERGENCY POWER, DUTY	
FCU-39E	1		FAN COIL UNIT	AIR LINE OFFICE-5	GROUND FLOOR	1.20	75	0.040	230	1	60	6.4	12.7	13		WALL MOUNTED	EMERGENCY POWER, DUTY	24 C+/DB
FCU-39F	1		FAN COIL UNIT	AIR LINE OFFICE-6	GROUND FLOOR	1.20	75	0.040	230	1	60	6.4	12.7	13		WALL MOUNTED	EMERGENCY POWER, DUTY	17.2 C WB
FCU-20A TO 20D	4		FAN COIL UNIT	SECURITY CHECK (SPOT COOLING)	GROUND FLOOR	3.30	216	0.056	230	1	60	6.4	12.7	25		CEILING CASSETTE 4 WAY TYPE FAN COIL UNIT	EMERGENCY POWER, DUTY	
FCU-17K & 17L	2		FAN COIL UNIT	DOMESTIC GATE LOUNGE	GROUND FLOOR	22.34	1200	0.760	230	1	60	9.5	22.2	25	270	CEILING MOUNTED DUCT	EMERGENCY POWER, DUTY	
FCU-43A & 43B	2	\\DE_ 0	FAN COIL UNIT	BHS INLINE SCREENING (SPOT COOLING)	GROUND FLOOR	3.65	216	0.056	230	1	60	6.4	12.7	25		CEILING CASSETTE 4 WAY TYPE FAN COIL UNIT	EMERGENCY POWER, DUTY	
FCU-18G	1	VRF-8	FAN COIL UNIT	PAHU	GROUND FLOOR	24.50	583	0.380	230	1	60	9.5	22.2	25	205	OUTDOOR AIR PROCESSING UNIT, CEILING SUSPENDED DUCT	EMERGENCY POWER, DUTY	
FCU-19D, 19F, 19H, 19J	4		FAN COIL UNIT	CHECK IN LOBBY (SPOT COOLING)	GROUND FLOOR	10.80	466	0.120	230	1	60	9.5	15.9	25		CEILING CASSETTE 4 WAY TYPE FAN COIL UNIT	EMERGENCY POWER, DUTY	
FCU-44	1		FAN COIL UNIT	ELEC ROOM-2	GROUND FLOOR	5.20	233	0.062	230	1	60	9.5	15.9	13		WALL MOUNTED	EMERGENCY POWER, STAND-BY	
FCU-45	1	VRF-9	FAN COIL UNIT	ICTS	GROUND FLOOR	1.80	75	0.040	230	1	60	6,4	12.7	25		WALL MOUNTED	EMERGENCY POWER, STAND-BY	
FCU-46A TO 46C	3		FAN COIL UNIT	CCO	GROUND FLOOR	12.20	466	0.120	230	1	60	9.5	15.9	25		CEILING CASSETTE 4 WAY TYPE FAN COIL UNIT	EMERGENCY POWER, STAND-BY	

OUTDOOR UNIT (PTB):

							CONNECTIO	N PIPE SIZE		ELECTRICAL C	HARACTERISTICS	·		
UNIT DESIGNATION	EQUIPMENT	AREA SERVED	EQUIPMENT LOCATION	QTY.	TOTAL COOLING CAPACITY (kW)	REFRIGERANT	LEQUID	GAS	POWER INPUT	VOLTS	PHASE	HERTZ	REMA	RKS
VRF-01	CONDENSING UNIT	GROUND FLOOR	ROOF DECK	1	121	R410A	19.1	41.3	39.6	230	3	60		NORMAL POWER, DUTY
VRF-02	CONDENSING UNIT	GROUND FLOOR	ROOF DECK	1	121	R410A	19.1	41.3	39.6	230	3	60		NORMAL POWER, DUTY
VRF-03	CONDENSING UNIT	GROUND FLOOR	ROOF DECK	1	121	R410A	19.1	41.3	39.6	230	3	60		NORMAL POWER, DUTY
VRF-04	CONDENSING UNIT	GROUND FLOOR	ROOF DECK	1	121	R410A	19.1	41.3	39.6	230	3	60		NORMAL POWER, DUTY
VRF-05	CONDENSING UNIT	GROUND FLOOR	ROOF DECK	1	121	R410A	19.1	41.3	39.6	230	3	60	OUTDOOR TEMP: 35.0°C DB, INDOOR TEMP: 24.0°C DB	
VRF-06	CONDENSING UNIT	GROUND FLOOR	ROOF DECK	1	121	R410A	19.1	41.3	39.6	230	3	60	17.2°C WB	EMERGENCY POWER, DUTY
VRF-07	CONDENSING UNIT	GROUND FLOOR	ROOF DECK	1	121	R410A	19.1	41.3	39.6	230	3	60		EMERGENCY POWER, DUTY
VRF-08	CONDENSING UNIT	GROUND FLOOR	ROOF DECK	1	121	R410A	19.1	41.3	39.6	230	3	60		EMERGENCY POWER, DUTY
VRF-09	CONDENSING UNIT	GROUND FLOOR	ROOF DECK	1	58	R410A	15.9	34.9	15.75	230	3	60		EMERGENCY POWER, STAND-BY

15 stotation and			PREPARED BY:	RECOMMENDNG APPROVAL:	APPROVED:	PROJECT TITLE:					SHEET CONTENTS:	SHEET NO:
Republic of the Philippines DEPARTMENT OF TRANSPORTATION AND		JAPAN INTERNATIONAL COOPERATION	RENATO A. ARRIOLA					-	-		COMPONENT-4: BUILDING WORKS (B)	B1-5200-02
COMMUNICATIONS	JICA	AGENCY	Filipino Registered Engineer PROF: MECHANICAL ENGINEER PTR. 1725187			NEW BOHOL AIRPORT CONSTRUCTION AND					SUBCOMPONENT-4-1: (B1) PASSENGER TERMINAL BUILDING (PTB)	D1 0200 02
JICA DESIGN CONSULT	TANT JOINT VENTURE		REG. NO.: 2379 DATE: JANUARY 01, 2013 T.I.N. 150-563-379 PLACE: TAGUIG CITY			SUSTAINABLE ENVIRONMENT PROTECTION PROJECT					, ,	DRAWING SCALE:
JAC S JAPAN AIRPORT CONSULTANTS, INC.	NIPPON KOEI CO., LTD.	NJS CONSULTANTS CO., LTD.	TADASHI AOI	ILDEFONSO T. PATDU, JR.	JULIANITO G. BUCAYAN, JR.		JUNE 2013		7	/IM HC	MECHANICAL VENTILATION AND AIR—CONDITIONING EQUIPMENT SCHEDULE (PART 2)	AS SHOWN
INC.	CO., LID.	CO., LTD.	Team Leader	Assistant Secretary for Project Implementation, DOTC	Undersecretary for Project Implementation, DOTC	LOCATION: MUNICIPALITY OF PANGLAO, PROVINCE OF BOHOL, PHILIPPINES	DATE INDE	X AMENDMENTS	Prepared Ch by	ecked Validated by by	EQUI MENT CONEDUCE (FAIN 2)	

EXHAUST FANS:

					AID VOULATE	CTATIO DDECCUDE	El	ECTRICAL CI	HARACTERIST	CS		TYPE REMARKS					
UNIT DESIGNATION	EQUIPMENT	LEVEL	AREA SERVED	QTY.	AIR VOULME (m3/hr)	STATIC PRESSURE (Pa)	POWER INPUT (kw)	VOLTS	PHASE	HERTZ	TYPE						
EF-01	EXHAUST FAN	GROUND FLOOR	BHS IN-LINE SCREENING	1	1875	150	0.3	230	3	60	IN-LINE AXIAL FAN	LOW NOISE TYPE					
EF-02	EXHAUST FAN	GROUND FLOOR	ELECTRICAL ROOM-1	1	7420	170	1.6	230	3	60	IN-LINE AXIAL FAN	LOW NOISE TYPE					
EF-03	EXHAUST FAN	GROUND FLOOR	MECHANICAL ROOM-1	1	3103	130	0.45	230	3	60	IN-LINE AXIAL FAN	LOW NOISE TYPE					
55.04	EVIIALICT FAN	ODOLIND FLOOD	ELECTRICAL ROOM-3		0540	150	0.4	070	7		IN THE AVIAL FAN						
EF-04	EXHAUST FAN	GROUND FLOOR	MECHANICAL ROOM-2	1	8519	150	2.4	230	3	60	IN-LINE AXIAL FAN	LOW NOISE TYPE					
EF-05	EXHAUST FAN	GROUND FLOOR	TOILET 1	1	2742	180	0.45	230	3	60	IN-LINE AXIAL FAN	LOW NOISE TYPE	WITH SILENCER				
EF-06	EXHAUST FAN	GROUND FLOOR	TOILET 2	1	2779	180	0.45	230	3	60	IN-LINE AXIAL FAN	LOW NOISE TYPE	WITH SILENCER				
EF-07	EXHAUST FAN	GROUND FLOOR	TOILET 3	1	2647	200	0.45	230	3	60	IN-LINE AXIAL FAN	LOW NOISE TYPE	WITH SILENCER				
EF-08	EXHAUST FAN	GROUND FLOOR	TOILET 4	1	2230	160	0.3	230	3	60	IN-LINE AXIAL FAN	LOW NOISE TYPE	WITH SILENCER				
EF-09	EXHAUST FAN	GROUND FLOOR	TOILET 5	1	2660	200	0.45	230	3	60	IN-LINE AXIAL FAN	LOW NOISE TYPE	WITH SILENCER				
EF-10	EXHAUST FAN	GROUND FLOOR	TOILET 6	1	2647	260	0.45	230	3	60	IN-LINE AXIAL FAN	LOW NOISE TYPE	WITH SILENCER				
EF-11	EXHAUST FAN	GROUND FLOOR	TOILET 7	1	382	150	0.15	230	1	60	IN-LINE AXIAL FAN	LOW NOISE TYPE	WITH SILENCER				
EF-12	EXHAUST FAN	GROUND FLOOR	TOILET 8/RAMP ACCOM.	1	1079	130	0.15	230	3	60	IN-LINE AXIAL FAN	LOW NOISE TYPE	WITH SILENCER				
EF-13	EXHAUST FAN	GROUND FLOOR	TOILET 9	1	103	150	0.15	230	3	60	IN-LINE AXIAL FAN	LOW NOISE TYPE	WITH SILENCER				
EF-14	EXHAUST FAN	GROUND FLOOR	TOILET 10	1	112	150	0.15	230	3	60	IN-LINE AXIAL FAN	LOW NOISE TYPE	WITH SILENCER				
EF-15	EXHAUST FAN	GROUND FLOOR	PANTRY-2	1	360	60	0.045	230	1	60	CEILING CASSET FAN	LOW NOISE TYPE					
							BONDED STORE										
			ELECTRICAL ROOM-2														
EF-16	EXHAUST FAN	GROUND FLOOR	FM-200	1	1460	240	0.28	230	3	60	IN-LINE AXIAL FAN	LOW NOISE TYPE	WITH SILENCER				
			COPY ROOM														
			STO.														
			PANTRY-1														
SF-01	EXHAUST FAN	GROUND FLOOR	BHS IN-LINE SCREENING	1	1875	150	0.3	230	3	60	IN-LINE AXIAL FAN	LOW NOISE TYPE					
SF-02	EXHAUST FAN	GROUND FLOOR	ELECTRICAL ROOM-1	1	7420	170	1.6	230	3	60	IN-LINE AXIAL FAN	LOW NOISE TYPE					
SF-03	EXHAUST FAN	GROUND FLOOR	MECHANICAL ROOM-1	1	3103	130	0.45	230	3	60	IN-LINE AXIAL FAN	LOW NOISE TYPE					

FRESH AIR FILTER UNIT:

LIAUT			FOLUDIAFNIT		AIR FLOE EXTERNAL	EXTERNAL STATIC	EL	ECTRICAL C	IARACTERISTI	ICS	REMARKS		
UNIT DESIGNATION	EQUIPMENT	AREA SERVED	EQUIPMENT LOCATION	QTY.	(I/s)	PRESSURE (Pa)	POWER INPUT (KW)	VOLTS	PHASE	HERTZ			
FFU-01	FRESH AIR FILTER UNIT	MECHANICAL ROOM GROUND FLOOR	GROUND FLOOR	1	11,990	300	18.5	230	3	60	PRE FILTER ARI 80% ABOVE: MEDIUM FILTER NBS 80% ABOVE	EMERGENCY POWER, DUTY	
FFU-02	FRESH AIR FILTER UNIT	MECHANICAL ROOM SECOND FLOOR	GROUND FLOOR	1	9,620	300	15	230	3	60	PRE FILTER ARI 80% ABOVE: MEDIUM FILTER NBS 80% ABOVE	EMERGENCY POWER, DUTY	

true portation and		PREPARED BY:	RECOMMENDNG APPROVAL:	APPROVED:	PROJECT TITLE:				SHEET CONTENTS:	SHEET NO:
Republic of the Philippines DEPARTMENT OF TRANSPORTATION	JAPAN INTERNATIONAL COOPERATION	RENATO A. ARRIOLA					_		_ COMPONENT-4: BUILDING WORKS (B)	B1-5200-03
COMMUNICATIONS	INTERNATIONAL COOPERATION AGENCY	Filipino Registered Engineer PROF: MECHANICAL ENGINEER PTR. 1725187	-		NEW BOHOL AIRPORT CONSTRUCTION AND				SUBCOMPONENT-4-1: (B1) PASSENGER TERMINAL BUILDING (PTB)	D1 0200 00
JICA DESIGN CONSUL	TANT JOINT VENTURE	REG. NO.: 2379 DATE: JANUARY 01, 2013 T.I.N. 150-563-379 PLACE: TAGUIG CITY			SUSTAINABLE ENVIRONMENT PROTECTION PROJECT					DRAWING SCALE:
JAC S JAPAN AIRPORT CONSULTANTS, INC.	NIPPON KOEI CO., LTD. NJS CONSULTANTS CO., LTD.	TADASHI AOI	ILDEFONSO T. PATDU, JR.	JULIANITO G. BUCAYAN, JR.		JUNE 2013		WIM	MECHANICAL VENTILATION AND AIR—CONDITIONING EQUIPMENT SCHEDULE (PART 3)	AS SHOWN
INC.	CO., LTD.	Team Leader	Assistant Secretary for Project Implementation, DOTC	Undersecretary for Project Implementation, DOTC	LOCATION: MUNICIPALITY OF PANGLAO, PROVINCE OF BOHOL, PHILIPPINES	DATE INDEX	AMENDMENTS	Prepared Checked by	Validated by	

AIR TERMINAL DEVICE:

UNIT DESIGNATION	QTY.	EQUIPMENT LOCATION	DIMENSION	TYPE	CAPACITY (lps)	NOISE CRITERIA LEVEL	REMARKS
FAG-01	12	DOMESTIC BAGGAGE CLAIM AREA INTERNATIONAL BAGGAGE CLAIM AREA	450ø	JET DIFFUSER	644	20	
FAG-02	4	DOMESTIC EXIT	350ø	JET DIFFUSER	410	20	
FAG-03	14	CHECK-IN LOBBY	350ø	JET DIFFUSER	447	20	
		DOMESTIC GATE LOUNGE					
FAG-04	168	INTERNATIONAL GATE LOUNGE	225ø	JET DIFFUSER	238	20	
510.05		CONCESSION 172	450 V 450		001		
FAG-05	2	BHS IN-LINE SCREENING	450mm X 450mm	FRESH AIR GRILLE	261	20	
FAG-06	4	INTERNATIONAL GATE LOUNGE	450mm X 450mm	FRESH AIR GRILLE	272	20	
FAG-07	2	PASSPORT CONTROL 2	400mm X 400mm	FRESH AIR GRILLE	233	20	
FAG-08	2	DOMESTIC GATE LOUNGE	350mm X 350mm	FRESH AIR GRILLE	135	20	
FAG-09	2	DOMESTIC GATE LOUNGE	400mm X 400mm	FRESH AIR GRILLE	237	20	
FAG-10	6	DOMESTIC GATE LOUNGE	450mm X 450mm	FRESH AIR GRILLE	265	20	
		CONCESSION 172					
		AIRLINE OFFICE 1					
		AIRLINE OFFICE 2					
FAG-11	6	AIRLINE OFFICE 3	250mm X 250mm	FRESH AIR GRILLE	15	20	
140-11		AIRLINE OFFICE 4	23011111 × 23011111	TRESH AIR GRIELE		20	
		AIRLINE OFFICE 5					
		AIRLINE OFFICE 6					
FAG-12	1	SECURITY CHECK	450mm X 450mm	FRESH AIR GRILLE	260	20	
FAG-13	1	STAFF & GOODS	300mm X 300mm	FRESH AIR GRILLE	64	20	
FAG-14	1	CASHIER	250mm X 250mm	FRESH AIR GRILLE	10	20	
FAG-15	2	HOLD M	250mm X 250mm	FRESH AIR GRILLE	15	20	
FAG-16	1	INTELLIGENCE	250mm X 250mm	FRESH AIR GRILLE	27	20	
FAG-17	1	ICTS	250mm X 250mm	FRESH AIR GRILLE	13	20	
FAG-18	1	AOD	250mm X 250mm	FRESH AIR GRILLE	39	20	
		MTG.					
FAG-19	1		250mm X 250mm	FRESH AIR GRILLE	81	20	
FAG-20	1	OFFICE 1	250mm X 250mm	FRESH AIR GRILLE	42	20	
FAG-21	1	OFFICE 2 OFFICE 3	250mm X 250mm	FRESH AIR GRILLE	44	20	
FAG-22	1	COMMAND AND CONTROL OFFICE	350mm X 350mm	FRESH AIR GRILLE	188	20	
FAG-23	1	FOBS	250mm X 250mm	FRESH AIR GRILLE	30	20	
FAG-24	1	ELECTRICAL ROOM 2	250mm X 250mm	FRESH AIR GRILLE	14	20	
FAG-25	2	SECURITY OFFICE	250mm X 250mm	FRESH AIR GRILLE	27	20	
FAG-26	1	CONCESSION 134	300mm X 300mm	FRESH AIR GRILLE	118	20	
FAG-27	1	CONCESSION 148	300mm X 300mm	FRESH AIR GRILLE	151	20	
FAG-28	1	CONCESSION 146	250mm X 250mm	FRESH AIR GRILLE	92	20	
		CAR RENTAL					
		BANK					
FAG-29	5	TICKETING OFFICE	250mm X 250mm	FRESH AIR GRILLE	33	20	
		COPY					
FAG-30	1	OFFICE 4	250mm X 250mm	FRESH AIR GRILLE	42	20	
FAG-31	1	CUSTOM OFFICE	250mm X 250mm	FRESH AIR GRILLE	27	20	
FAG-32	1	CONCESSION 105	250mm X 250mm	FRESH AIR GRILLE	68	20	
02	,	LOST AND FOUND BAGGAGE 109					
FAG-33	2	LOST AND FOUND BAGGAGE 110	250mm X 250mm	FRESH AIR GRILLE	64	20	
FAG-34	2	QUARANTINE	250mm X 250mm	FRESH AIR GRILLE	63	20	
FAG-35	1	CONCESSION 111	250mm X 250mm	FRESH AIR GRILLE	137	20	
FAG-36	1	MECHANICAL ROOM 1	800mm X 800mm	FRESH AIR GRILLE	861	20	
FAG-37	2	ELECTRICAL ROOM 1	850mm X 850mm	FRESH AIR GRILLE	1030	20	

AIR TERMINAL DEVICE:

UNIT DESIGNATION	QUANTITY	EQUIPMENT LOCATION	DIMENSION	TYPE	CAPACITY (lps)	NOISE CRITERIA LEVEL	REMARKS
EAG-01	6	TOILET 1	300mm X 300mm	EXHAUST AIR GRILLE	114	20	
EAG-02	1	TOILET 1 STORAGE	250mm X 250mm	EXHAUST AIR GRILLE	28	20	
EAG-03	1	HANDICAP TOILET 1	250mm X 250mm	EXHAUST AIR GRILLE	53	20	
EAG-04	1	TOILET 9 / QUARANTINE TOILET	250mm X 250mm	EXHAUST AIR GRILLE	29	20	
EAG-05	1	MECHANICAL ROOM 1	800mm X 800mm	EXHAUST AIR GRILLE	861	20	
EAG-06	6	TOILET 2	300mm X 300mm	EXHAUST AIR GRILLE	115	20	
EAG-07	1	TOILET 2 STORAGE	250mm X 250mm	EXHAUST AIR GRILLE	31	20	
EAG-08	1	HANDICAP TOILET 2	250mm X 250mm	EXHAUST AIR GRILLE	53	20	
EAG-09	2	TOILET 7 M/F	250mm X 250mm	EXHAUST AIR GRILLE	53	20	
EAG-10	2	ELECTRICAL ROOM 1	850mm X 850mm	EXHAUST AIR GRILLE	1030	20	
EAG-11	1	BONDED STORE	250mm X 250mm	EXHAUST AIR GRILLE	62	20	
EAG-12	1	COPY	300mm X 300mm	EXHAUST AIR GRILLE	125	20	
EAG-13	1	STO.	250mm X 250mm	EXHAUST AIR GRILLE	69	20	
EAG-14	1	FM 200	250mm X 250mm	EXHAUST AIR GRILLE	36	20	
EAG-15	1	ELECTRICAL ROOM 2	250mm X 250mm	EXHAUST AIR GRILLE	40	20	
EAG-16	2	TOILET 10 M/F	250mm X 250mm	EXHAUST AIR GRILLE	16	20	
EAG-17	6	TOILET 3	300mm X 300mm	EXHAUST AIR GRILLE	114	20	
EAG-18	1	HANDICAP TOILET 3	250mm X 250mm	EXHAUST AIR GRILLE	53	20	
EAG-19	6	TOILET 5	300mm X 300mm	EXHAUST AIR GRILLE	115	20	
EAG-20	1	HANDICAP TOILET 5	250mm X 250mm	EXHAUST AIR GRILLE	53	20	
EAG-21	6	TOILET 4	300mm X 300mm	EXHAUST AIR GRILLE	95	20	
EAG-22	1	HANDICAP TOILET 4	250mm X 250mm	EXHAUST AIR GRILLE	53	20	
EAG-23	5	TOILET 6	300mm X 300mm	EXHAUST AIR GRILLE	137	20	
EAG-24	1	HANDICAP TOILET 6	250mm X 250mm	EXHAUST AIR GRILLE	53	20	
EAG-25	2	BHS IN-LINE SCREENING	450mm X 450mm	EXHAUST AIR GRILLE	261	20	
EAG-26	3	TOILET 8 / RAMP ACCOM.	300mm X 300mm	EXHAUST AIR GRILLE	100	20	
EAG-27	2	ELECTRICAL RM. 3 / MECHANICAL RM. 2	850mm X 850mm	EXHAUST AIR GRILLE	991	20	

	EPARED BY:	RECOMMENDNG APPROVAL: APPROVED:	PROJECT TITLE:			SHEET CONTENTS:	SHEET NO:
Republic of the Philippines DEPARTMENT OF TRANSPORTATION AND COMMUNICATIONS Republic of the Philippines JAPAN INTERNATIONAL COOPERATION AGENCY PROF:	Filipino Registered Engineer PTR.		NEW BOHOL AIRPORT CONSTRUCTION AND			COMPONENT-4: BUILDING WORKS (B) SUBCOMPONENT-4-1: (B1) PASSENGER TERMINAL BUILDING (PTB)	B1-5200-04
JICA DESIGN CONSULTANT JOINT VENTURE REG. NO.: T.I.N.	NO.: DATE: PLACE:		SUSTAINABLE ENVIRONMENT PROTECTION PROJECT				DRAWING SCALE:
JAC JAPAN AIRPORT CONSULTANTS, INC. NIPPON KOEI CO., LTD. NJS CONSULTANTS CO., LTD.	TADASHI AOI	ILDEFONSO T: PATDU, JR. Assistant Secretary JULIANITO G. BUCAYAN, JR. Undersecretary		JUNE 2013	WIM	HC MECHANICAL VENTILATION AND AIR—CONDITIONING EQUIPMENT SCHEDULE (PART 4)	AS SHOWN
INC.	Team Leader	for Project Implementation, DOTC for Project Implementation, DOTC	LOCATION: MUNICIPALITY OF PANGLAO, PROVINCE OF BOHOL, PHILIPPINES	DATE INDEX AMENDMENTS	Prepared Checked by by	Validated by	

