MINISTRY OF FINANCE
MINISTRY OF LOCAL GOVERNMENT, RURAL DEVELOPMENT AND
CO-OPERATIVES
KHULNA WATER SUPPLY AND SEWERAGE AUTHORITY (KWASA)
THE PEOPLE'S REPUBLIC OF BANGLADESH

FEASIBILITY STUDY FOR KHULNA WATER SUPPLY IMPROVEMENTPROJECT IN THE PEOPLE'S REPUBLIC OF BANGLADESH

FINAL REPORT

VOLUME IV DRAWINGS

MARCH 2011

JAPAN INTERNATIONAL COOPERATION AGENCY NJS CONSULTANTS CO., LTD.


GED


CR(3)


11-038


List of Drawing for Khulna Water Supply Improvement Project


Drawing No.		Drawing Title		Scale	Drawing No.		Drawing Title		Scale
<general></general>					<clear pipe="" transmission="" water=""></clear>		on Pipe>		
1	GE-LM-001	General Drawing	Location Map of Water Supply System	1:100,000	57	CWT-G-001	Clear Water Transmission Pipe	General Map of Clear Water Transmission Pipe	NON
2	GE-LM-002	General Drawing	Location Map of Impounding Reservoir & SWTP	NON	58 - 69	CWT-PP-001 to 012	Clear Water Transmission Pipe	Plan & Profile -1 to 12	H-1:2000, V-1:200
3	GE-HP-001	General Drawing	Hydraulic Profile	V- 1:200	70- 74	CWT-CS-001 to 005	Clear Water Transmission Pipe	Cross Section -1 to 5	1:400
4	GE-PFD-001	General Drawing	Process Schematic & Flow Diagram -1	NON	75	CWT-RC-001	Clear Water Transmission Pipe	River Crossing Plan & Section	1:1,000
5	GE-PFD-002	General Drawing	Process Schematic & Flow Diagram -2	NON					
6	GE-IFD-001	General Drawing	Instrument Flow Diagram -1	NON	<distr< td=""><td colspan="2"><distribution reservoir=""></distribution></td><td></td><td></td></distr<>	<distribution reservoir=""></distribution>			
7	GE-IFD-002	General Drawing	Instrument Flow Diagram -2	NON	76	DR-LP-001	Distribution Reservoir	Location Map of Distribution Reservoir & Overhead Tank	1:85,000
					77	DR-G-001	Distribution Reservoir	Layout Plan of Deana West Para Reservoir & Overhead Tank	1:400
<water facility="" intake=""></water>					78 DR-G-002		Distribution Reservoir	Layout Plan of Ward No. 16 Office Reservoir & Overhead Tank	1:400
8	IF-G-001	Water Intake Facility	Layout Plan	1:1,500	79	DR-G-003	Distribution Reservoir	Layout Plan of Beside of Sonadanga Moha Sarak Reservoir & Overhead Tank	1:500
9	IF-PS-001	Water Intake Facility	Top & Bottom Plan	1:300	80	DR-G-004	Distribution Reservoir	Layout Plan of Beside of No.7 Ward Office Reservoir & Overhead Tank	1:400
10	IF-PS-002	Water Intake Facility	Section A-A	1:300	81	DR-G-005	Distribution Reservoir	Layout Plan of Khalishpur Charerhat Reservoir & Overhead Tank	1:400
11	IF-SLD-001	Water Intake Facility	Single Line Diagram	NON	82	DR-PS-001	Distribution Reservoir	Plan & Section (V= 18,000m ³)	1:400
					83	DR-PS-002	Distribution Reservoir	Plan & Section (V= 15,000m ³)	1:400
<raw \<="" td=""><td>Water Transmission</td><td>n Pipe></td><td></td><td></td><td>84</td><td>DR-PS-003</td><td>Distribution Reservoir</td><td>Plan & Section (V=9,000m³)</td><td>1:300</td></raw>	Water Transmission	n Pipe>			84	DR-PS-003	Distribution Reservoir	Plan & Section (V=9,000m ³)	1:300
12	RWT-G-001	Raw Water Transmission Pipe	General Map of Raw Water Transmission Pipe	1:80,000	85	DR-PS-004	Distribution Reservoir	Plan & Section (V=8,000m ³)	1:300
13 -35	RWT-PP-001 to 023	Raw Water Transmission Pipe	Plan & Profile -1 to 23	H-1:2000, V-1:200	86	DR-PS-005	Distribution Reservoir	Plan & Section (V= 5,000m ³)	1:300
36 - 41	RWT-CS-001 to 006	Raw Water Transmission Pipe	Cross Section -1 to 6	1:400					
42	RWT-PB-001	Raw Water Transmission Pipe	Standard Drawings of Water Bridge-1	1:50, 100	<over< td=""><td>head Tank></td><td></td><td></td><td>-</td></over<>	head Tank>			-
43	RWT-PB-002	Raw Water Transmission Pipe	Standard Drawings of Water Bridge-2	1:50, 100, 200	87	OHT-G-001	Overhead Tank	Layout Plan of Rab Sarani Overhead Tank	1:400
					88	OHT-G-002	Overhead Tank	Layout Plan of Mujgunni Overhead Tank	1:400
Impounding Reservoir>					89	OHT-G-003	Overhead Tank	Layout Plan of Andir Pukur Overhead Tank	1:400
44	IP-PS-001	Impounding Reservoir	Plan & Section	1:3000	90	OHT-G-004	Overhead Tank	Layout Plan of South Side of Ward No.31 Office Overhead Tank	1:400
45	IP-PS-002	Impounding Reservoir	Pump Pit Plan & Section	1:200	91	OHT-G-005	Overhead Tank	Layout Plan of Ferry Ghat Power House Overhead Tank	1:400
46	IP-SLD-001	Impounding Reservoir	Single Line Diagram	NON	92	OHT-G-006	Overhead Tank	Layout Plan of DPHE Rupsha Overhead Tank	1:400
		,			93	OHT-D-001	Overhead Tank	Plan & Section	1:200
<surface (swtp)="" plant="" treatment="" water=""></surface>									
47	SWTP-G-001	Surface Water Treatment Plant	Layout Plan (up to Year 2025)	1:1,250	<distr< td=""><td colspan="2"><pre><distribution network="" pipe=""></distribution></pre></td><td></td><td></td></distr<>	<pre><distribution network="" pipe=""></distribution></pre>			
48	SWTP-G-002	Surface Water Treatment Plant	Layout Plan (after Year 2025)	1:1,250	94	DPN-G-001	Distribution Pipe Network	General Map of Distribution Network	1:40,000
49	SWTP-MT-001	Surface Water Treatment Plant	Mixing Tank Plan & Section	1:200	95	DPN-PNP-001	Distribution Pipe Network	Pipe Network Plan (Zone -1)	1:30,000
50	SWTP-SB-001	Surface Water Treatment Plant	Sedimentation Basin Plan & Section	1:400	96	DPN-PNP-002	Distribution Pipe Network	Pipe Network Plan (Zone -2)	1:30,000
51	SWTP-RP-001	Surface Water Treatment Plant	Rapid Sand Filter Plan & Section	1:300	97	DPN-PNP-003	Distribution Pipe Network	Pipe Network Plan (Zone -3)	1:30,000
52	SWTP-CWR-001	Surface Water Treatment Plant	Clear Water Reservoir & Clear Water Pump Station Plan & Section	1:300	98	DPN-PNP-004	Distribution Pipe Network	Pipe Network Plan (Zone -4)	1:30,000
53	SWTP-SDB-001	Surface Water Treatment Plant	Sludge Drying Bed Plan & Section	1:300, 100, 50	99	DPN-PNP-005	Distribution Pipe Network	Pipe Network Plan (Zone -5)	1:30,000
54	SWTP-AB-001	Surface Water Treatment Plant	Administration Building Plan -1	1:100	100	DPN-TCM-001	Distribution Pipe Network	Tube Well Pipe Connection Map	1:50,000
55	SWTP-AB-002	Surface Water Treatment Plant	Administration Building Plan -1	1:100					
56	SWTP-SLD-001	Surface Water Treatment Plant	Single Line Diagram	NON					

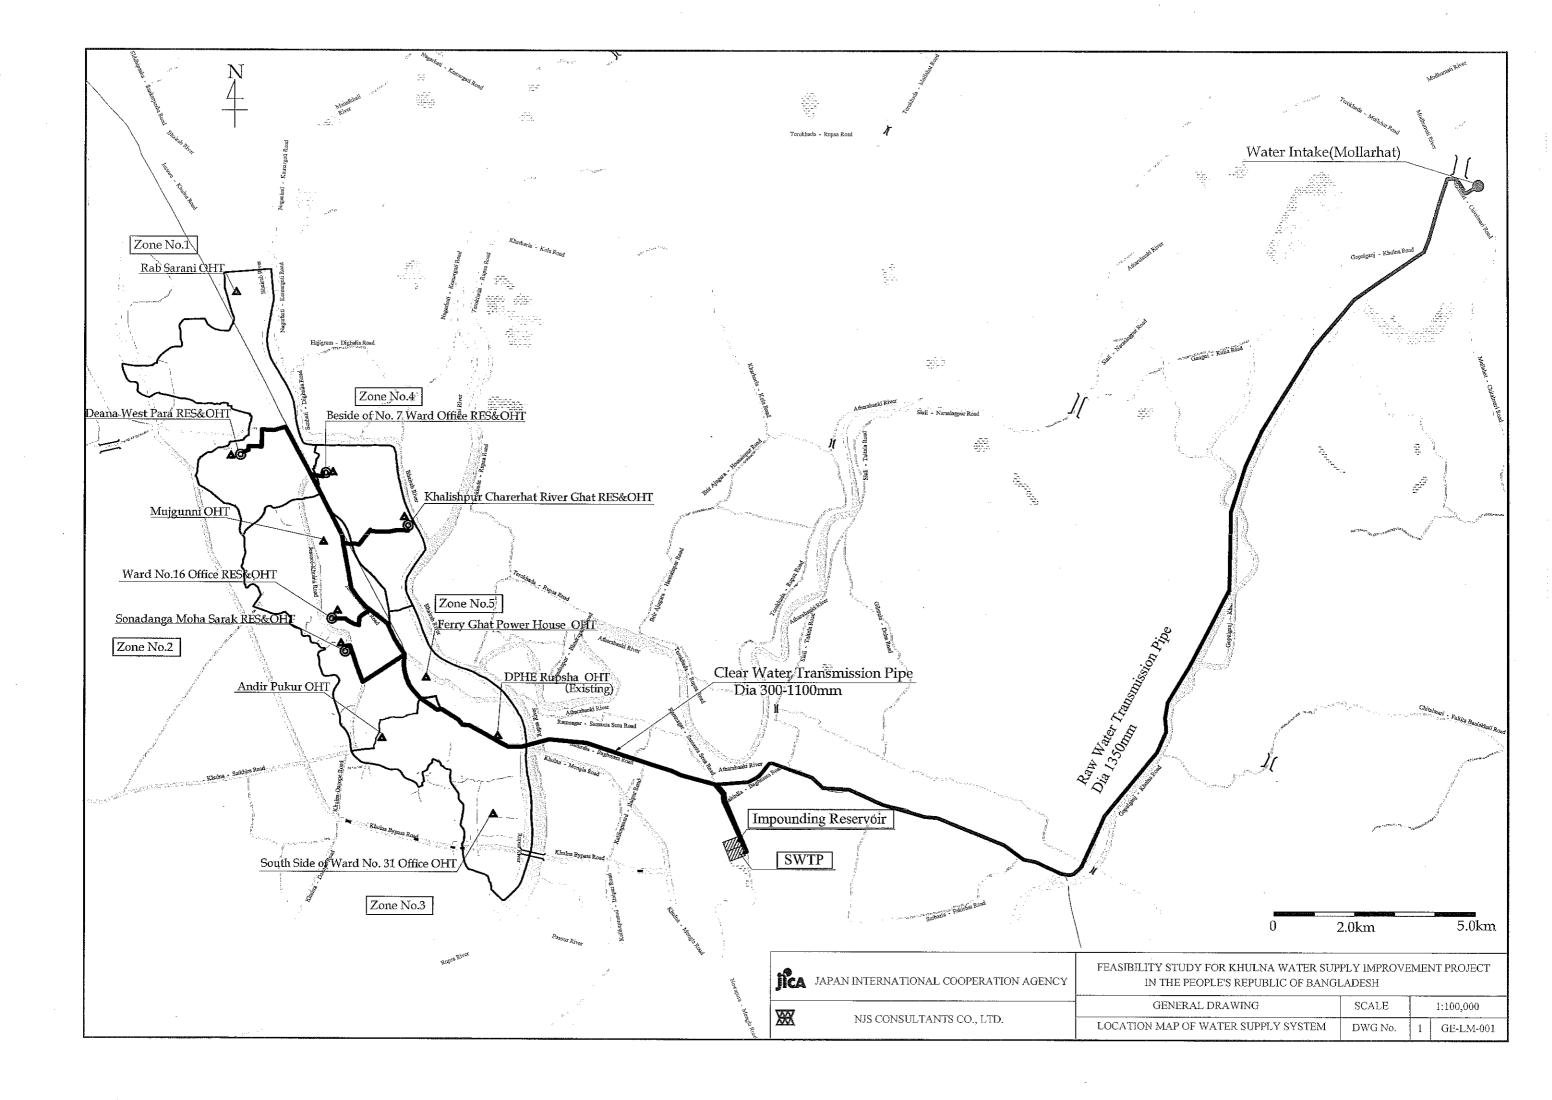


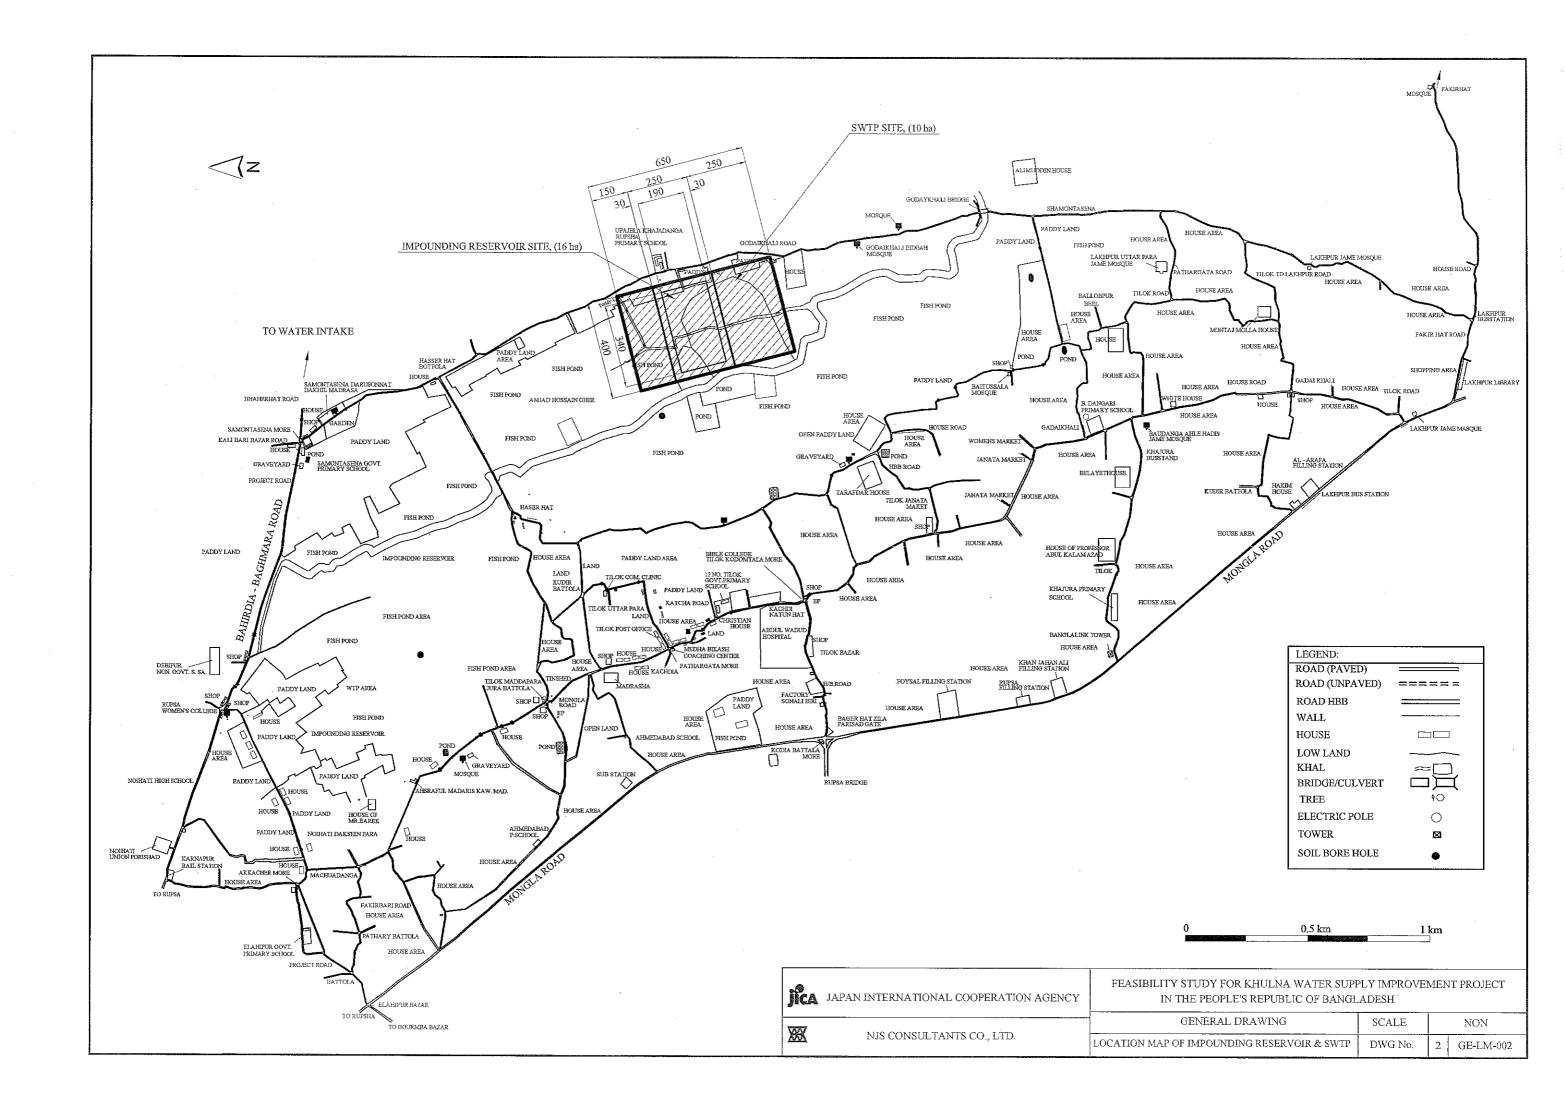


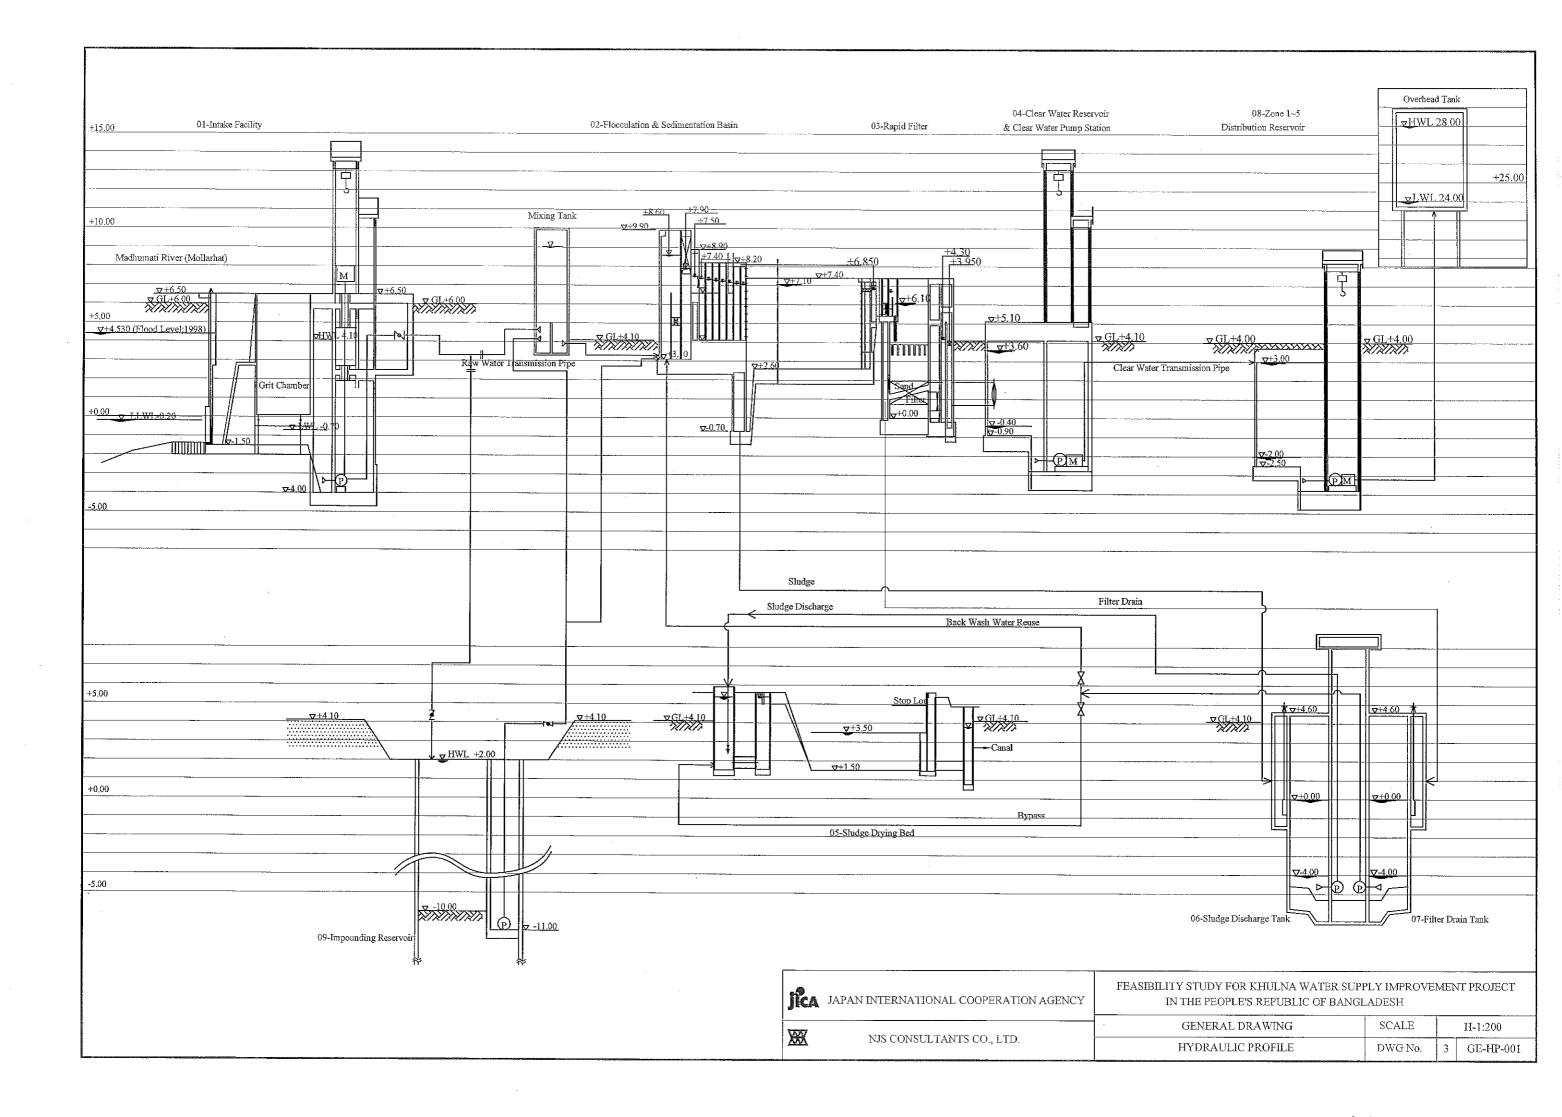


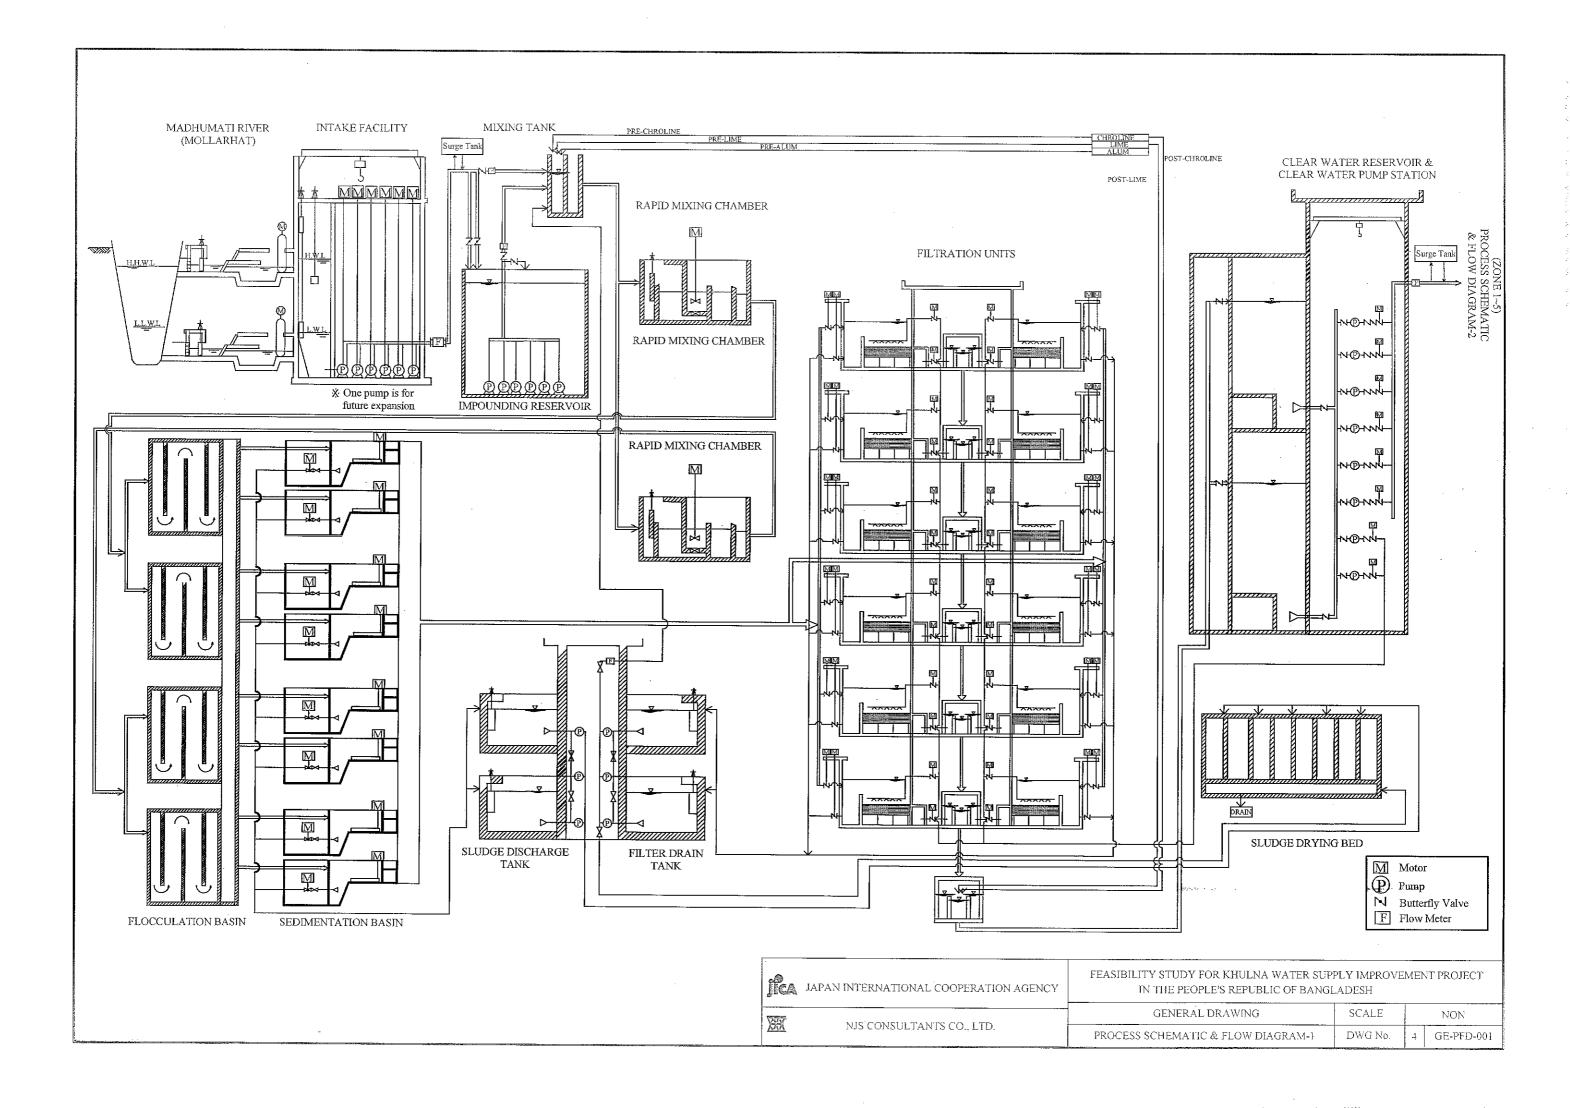


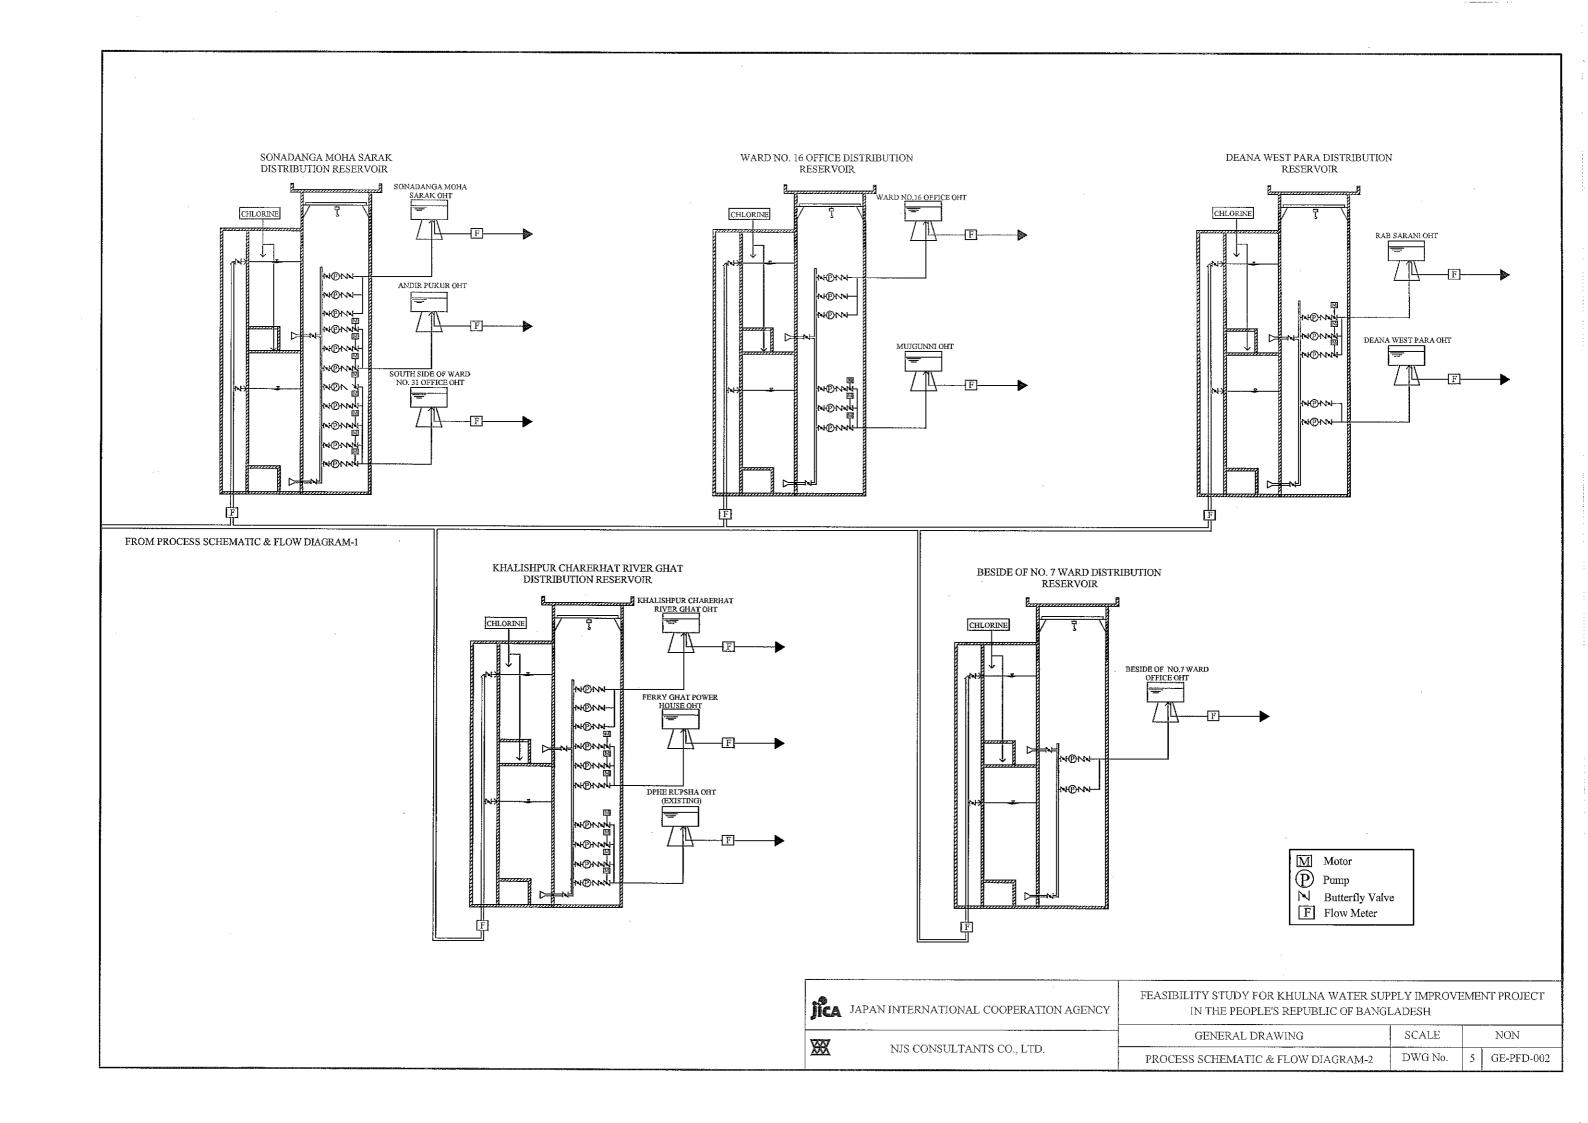


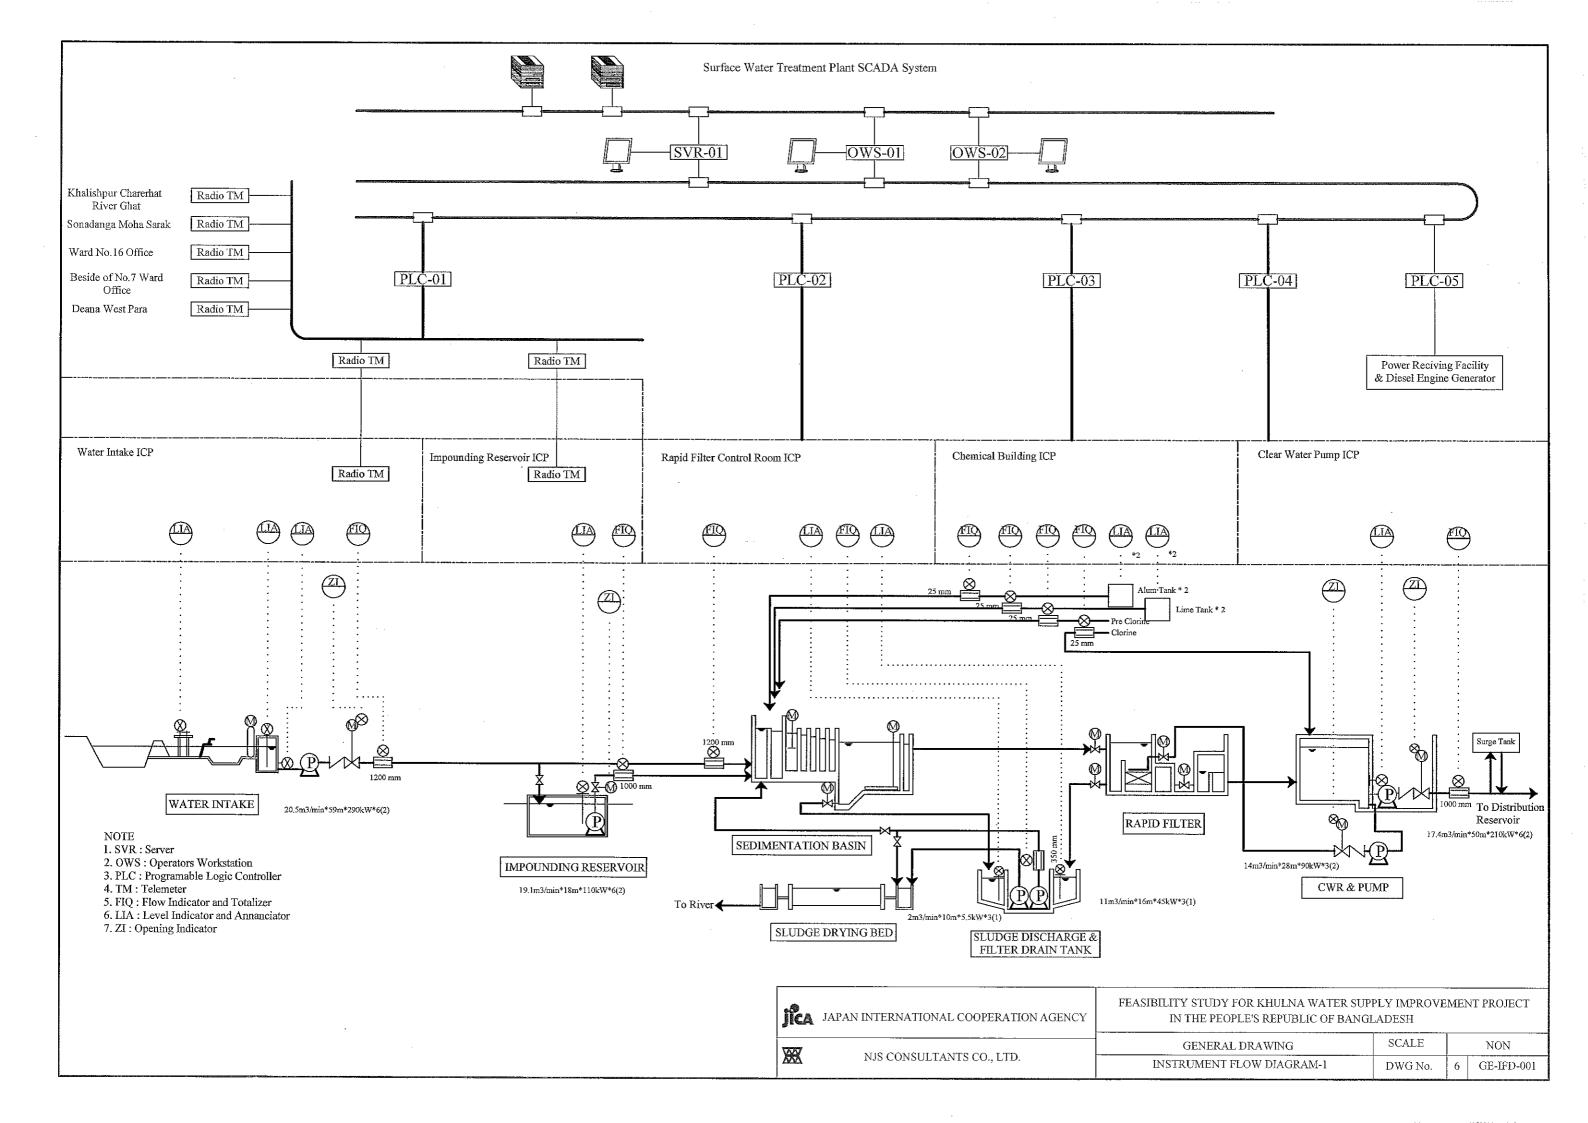

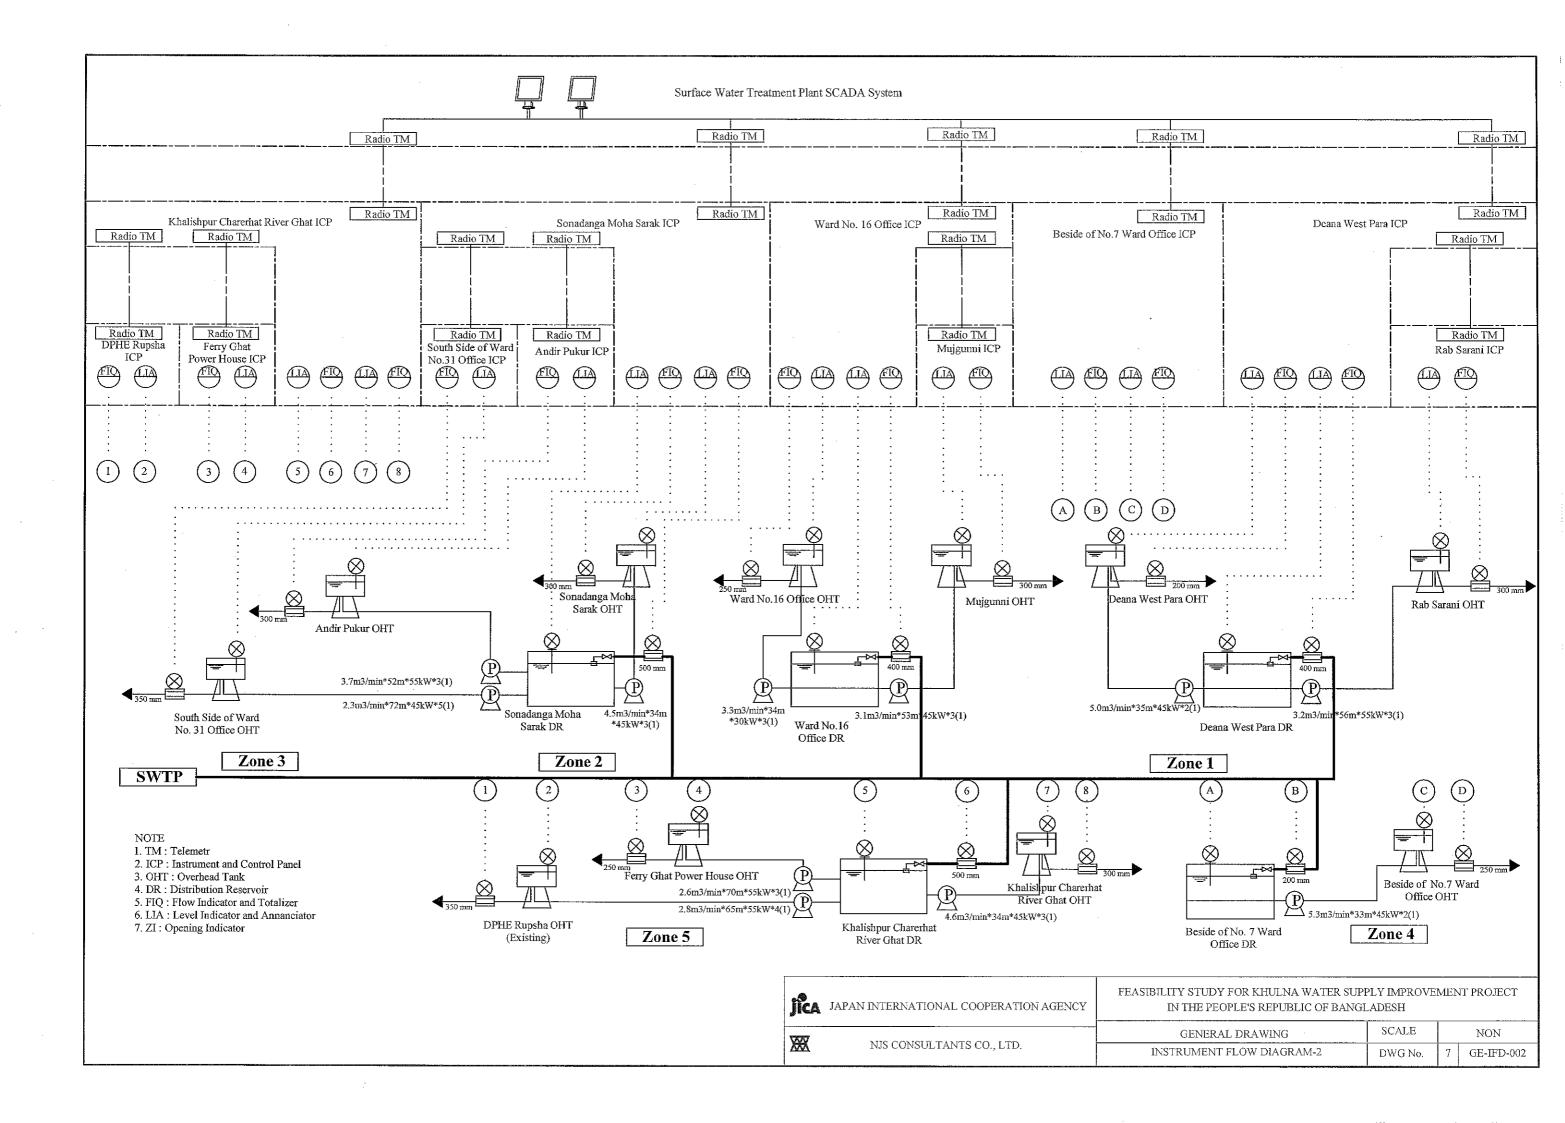

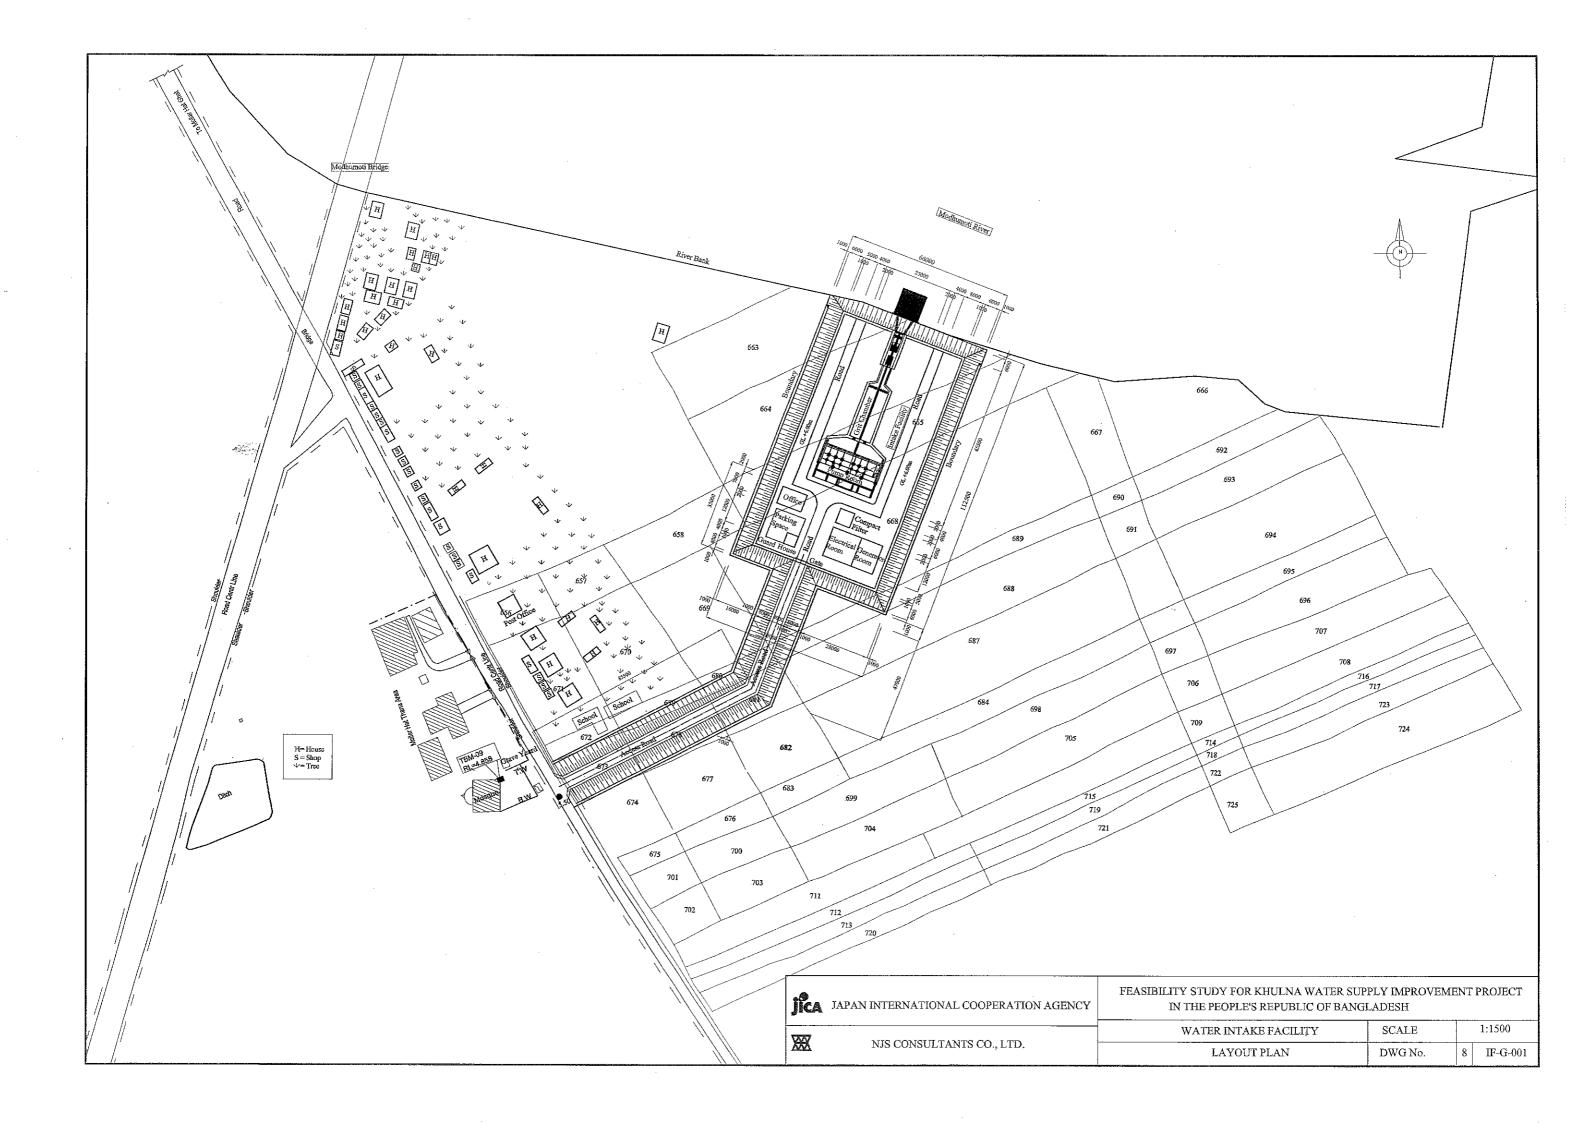


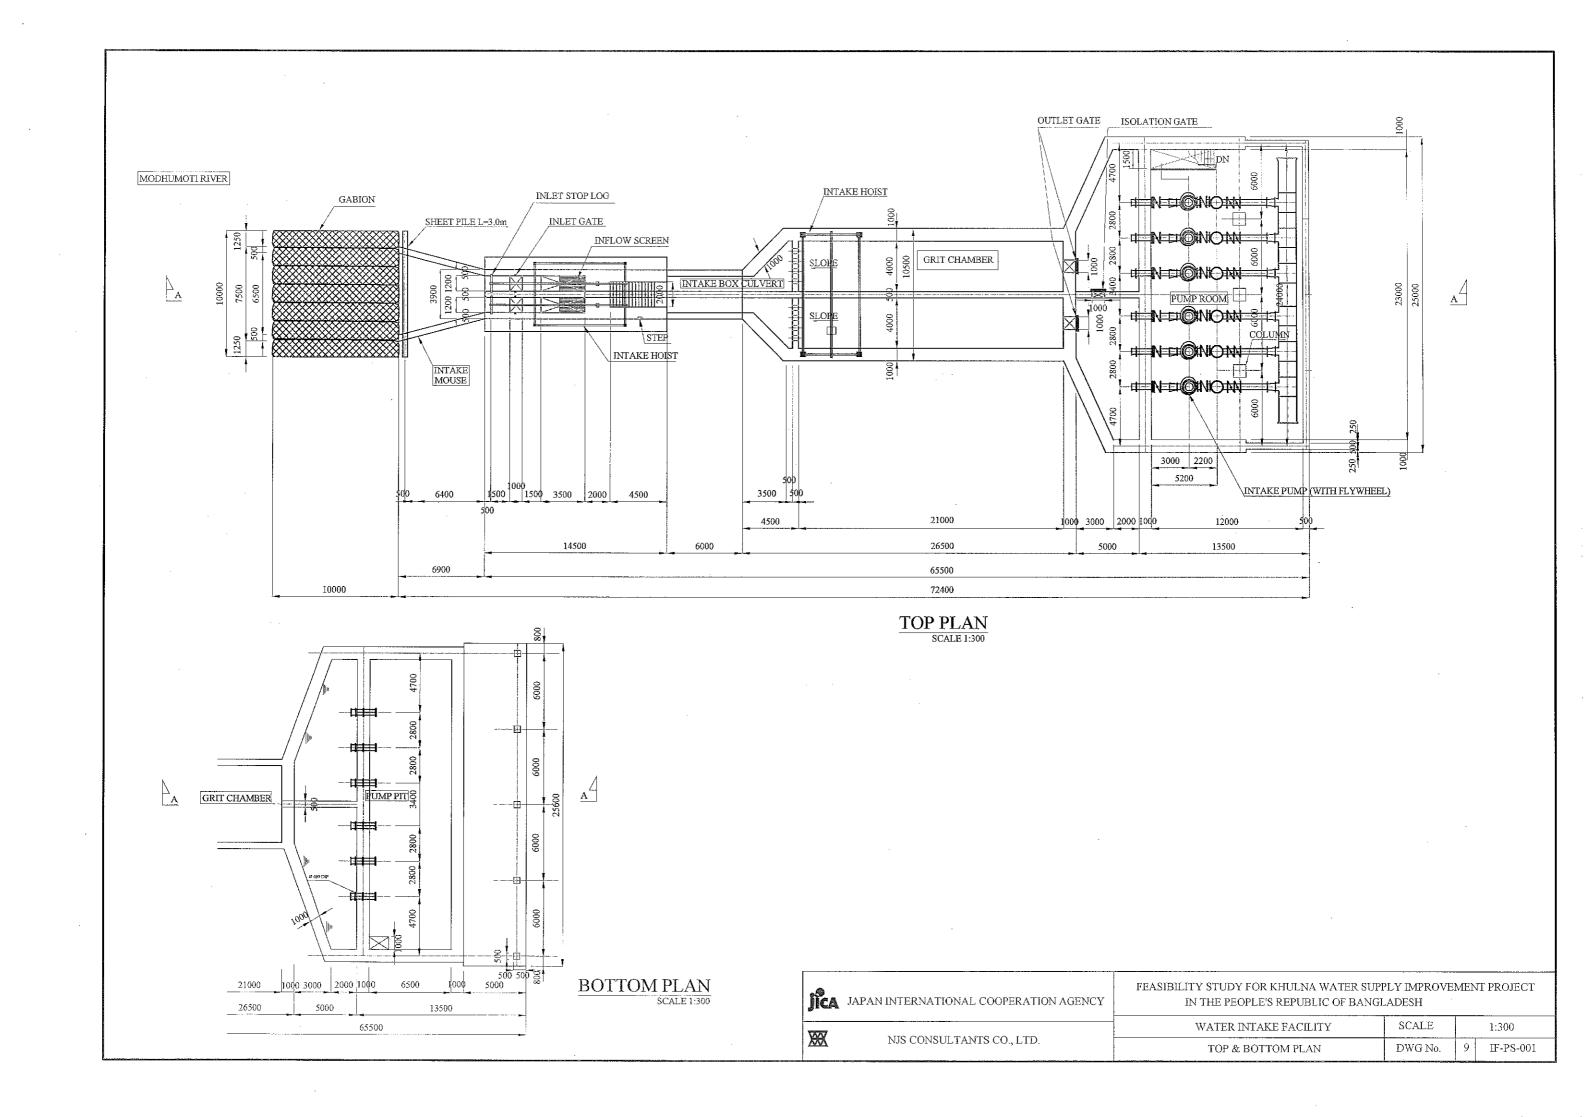


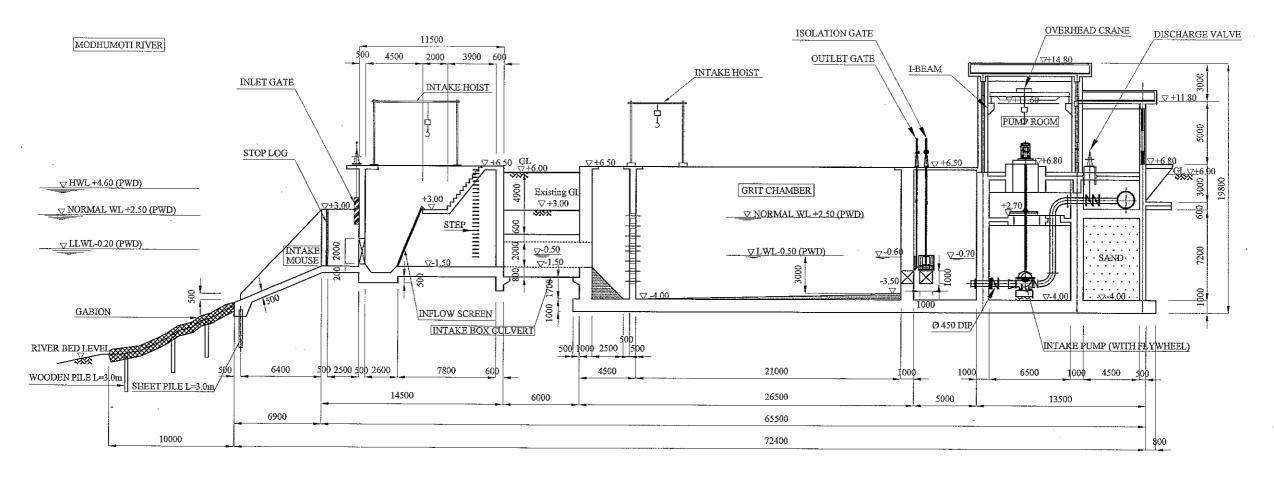



SECTION A-A
SCALE 1:300


jica	JAPAN INTERNATIONAL COOPERATION AGENCY	FEASIBILITY STUDY FOR KHULNA WATER SUPPLY IMPROVEMENT PROJECT IN THE PEOPLE'S REPUBLIC OF BANGLADESH					
XX	NJS CONSULTANTS CO., LTD.	WATER INTAKE FACILITY	SCALE 1:300		1:300		
<u>w</u> v		SECTION A-A	DWG No.	10	IF-PS-002		

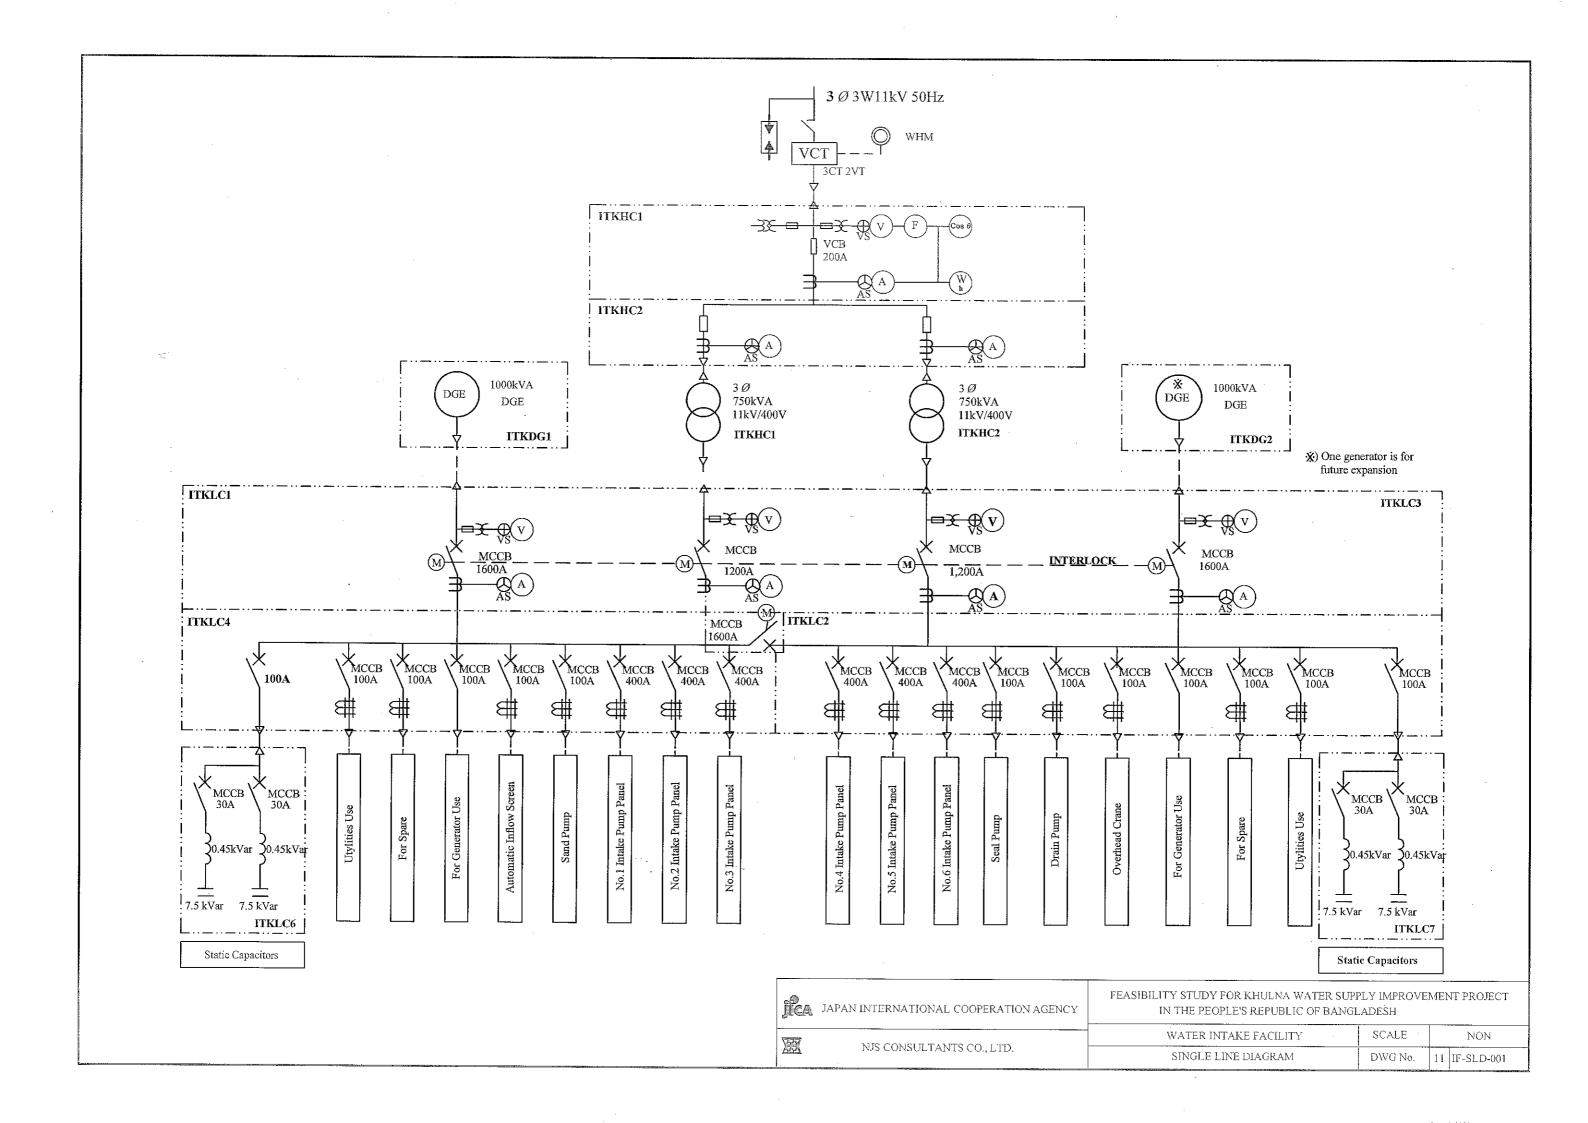


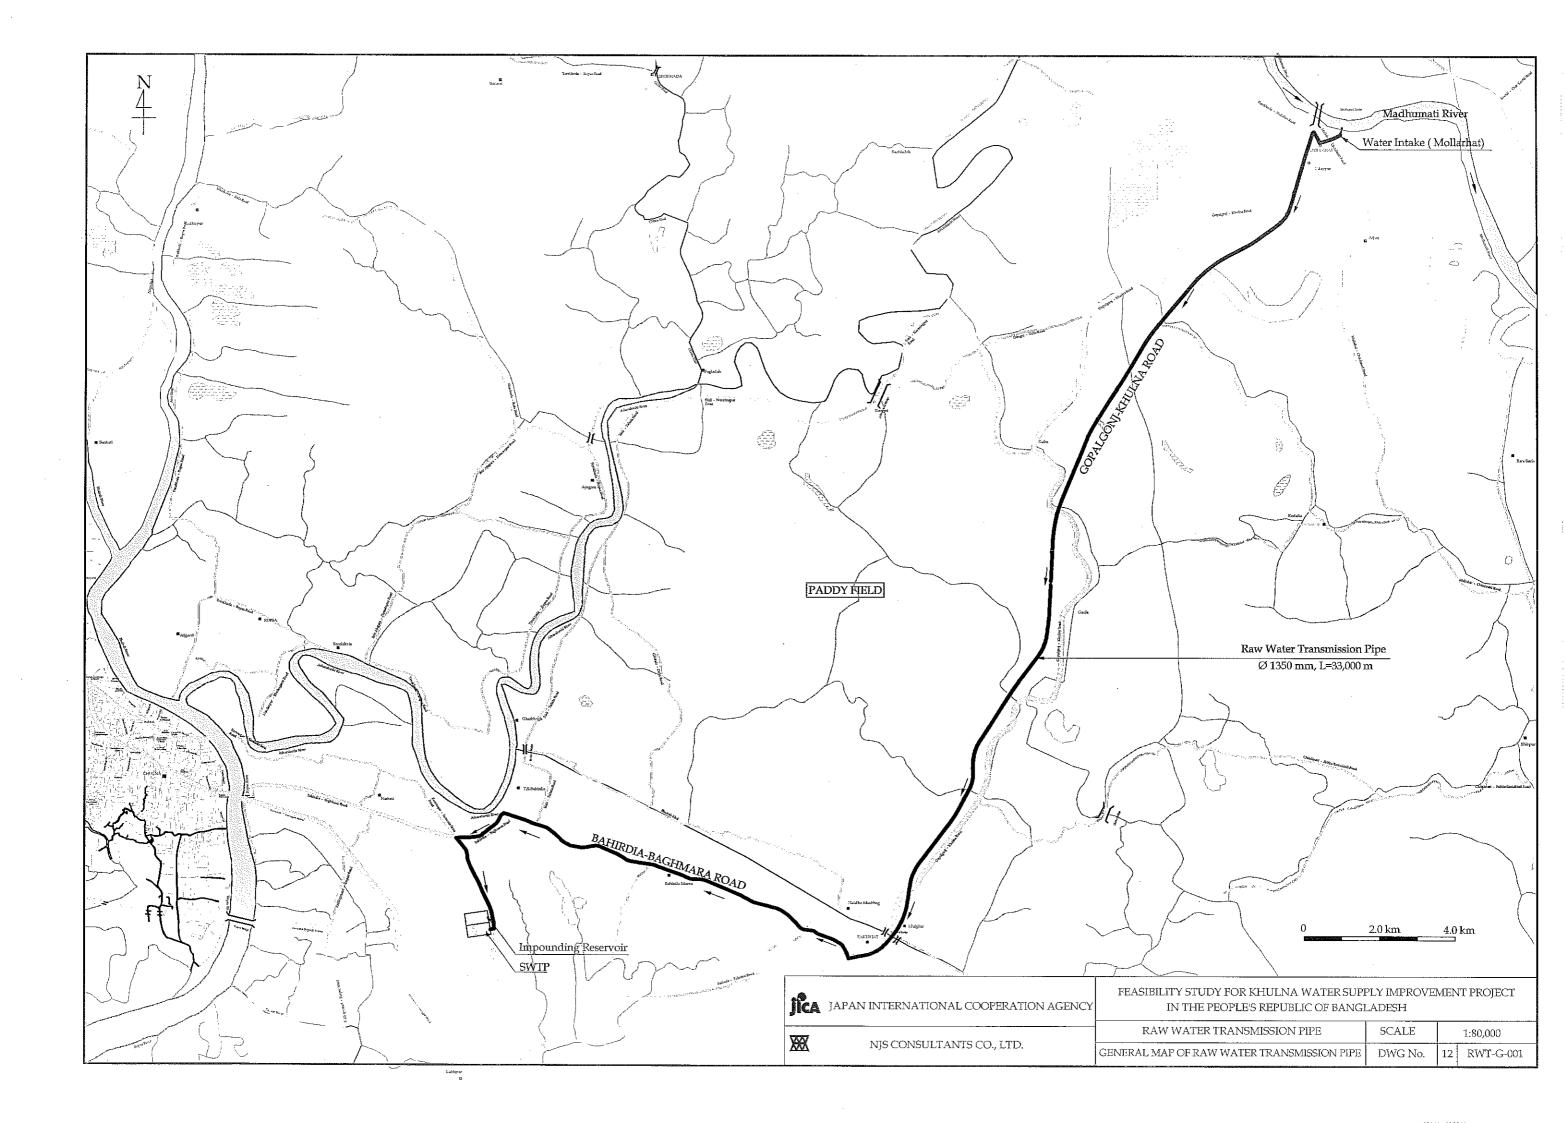


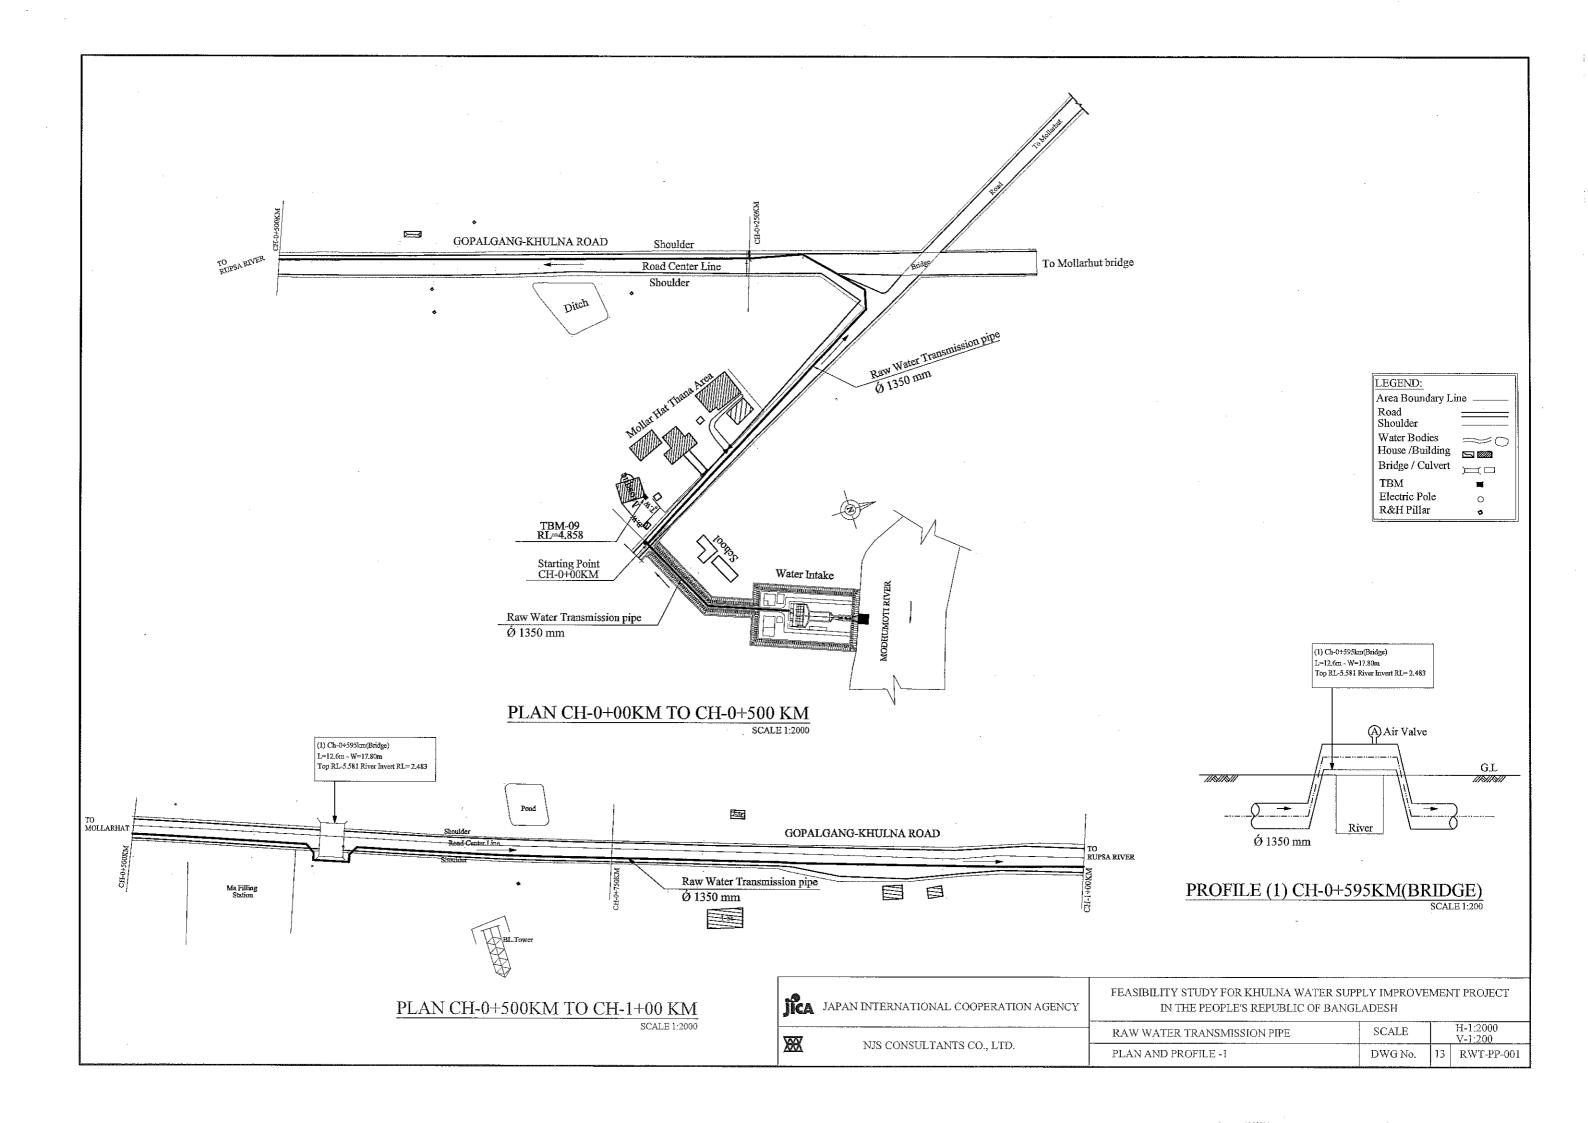


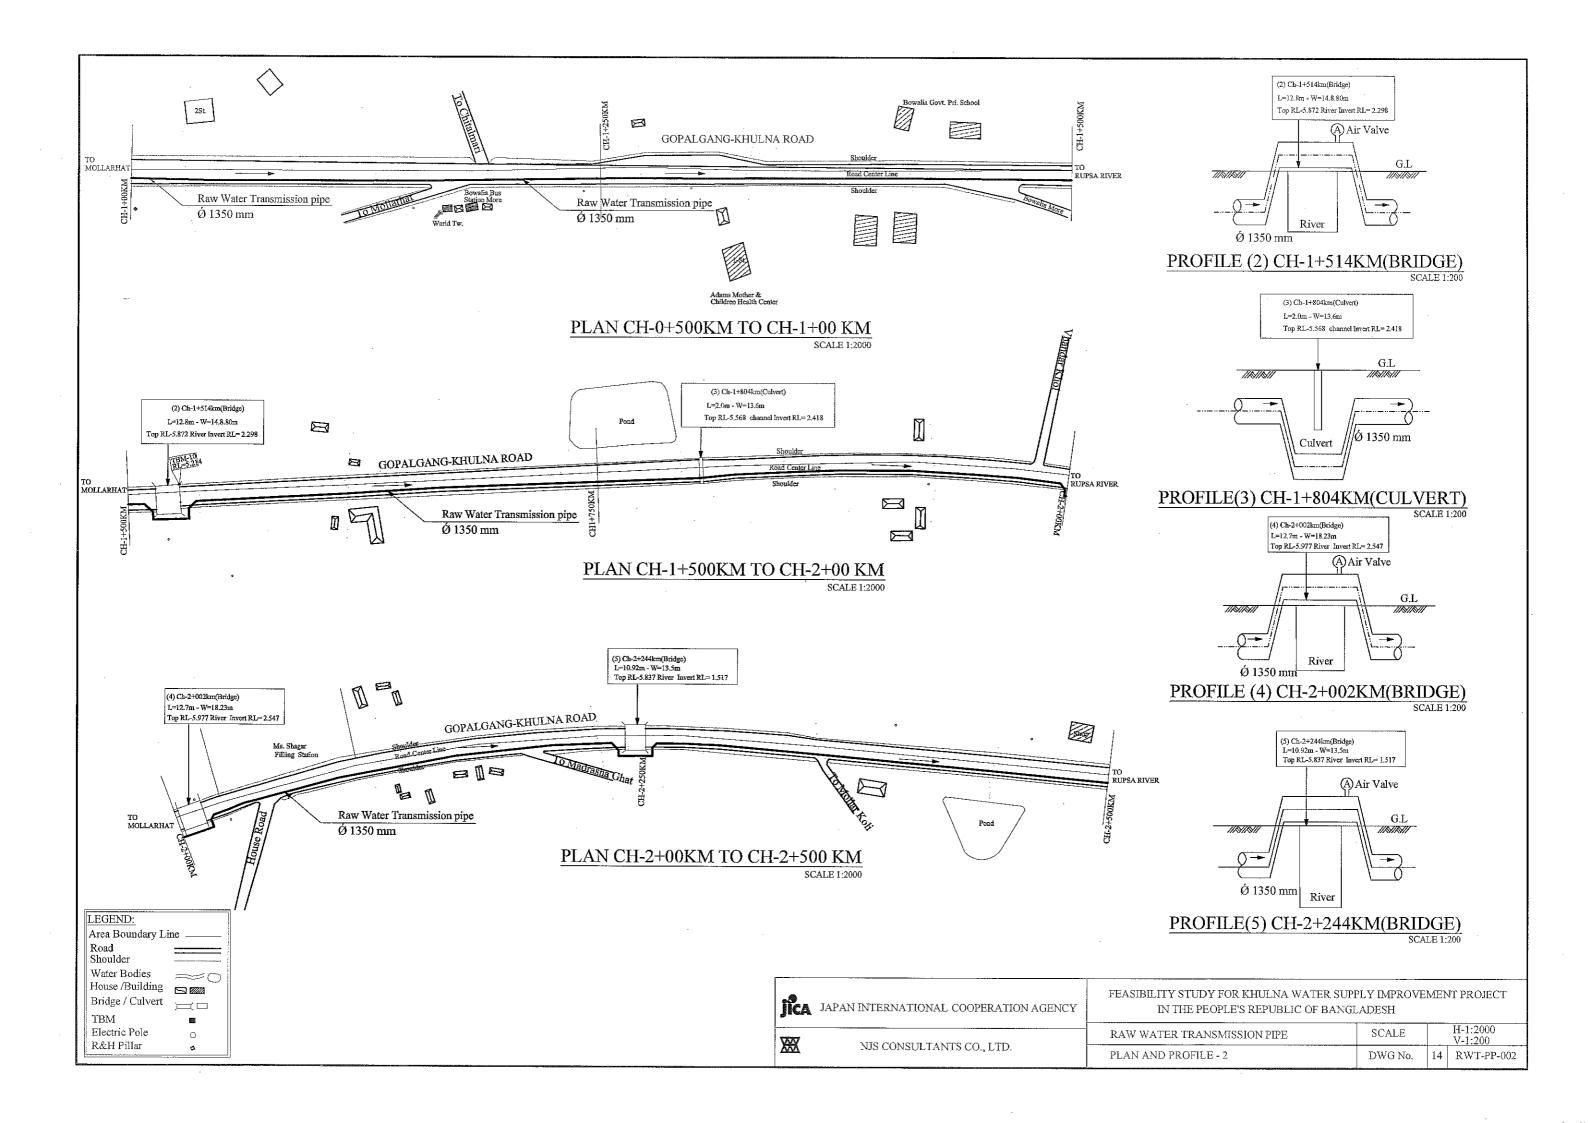


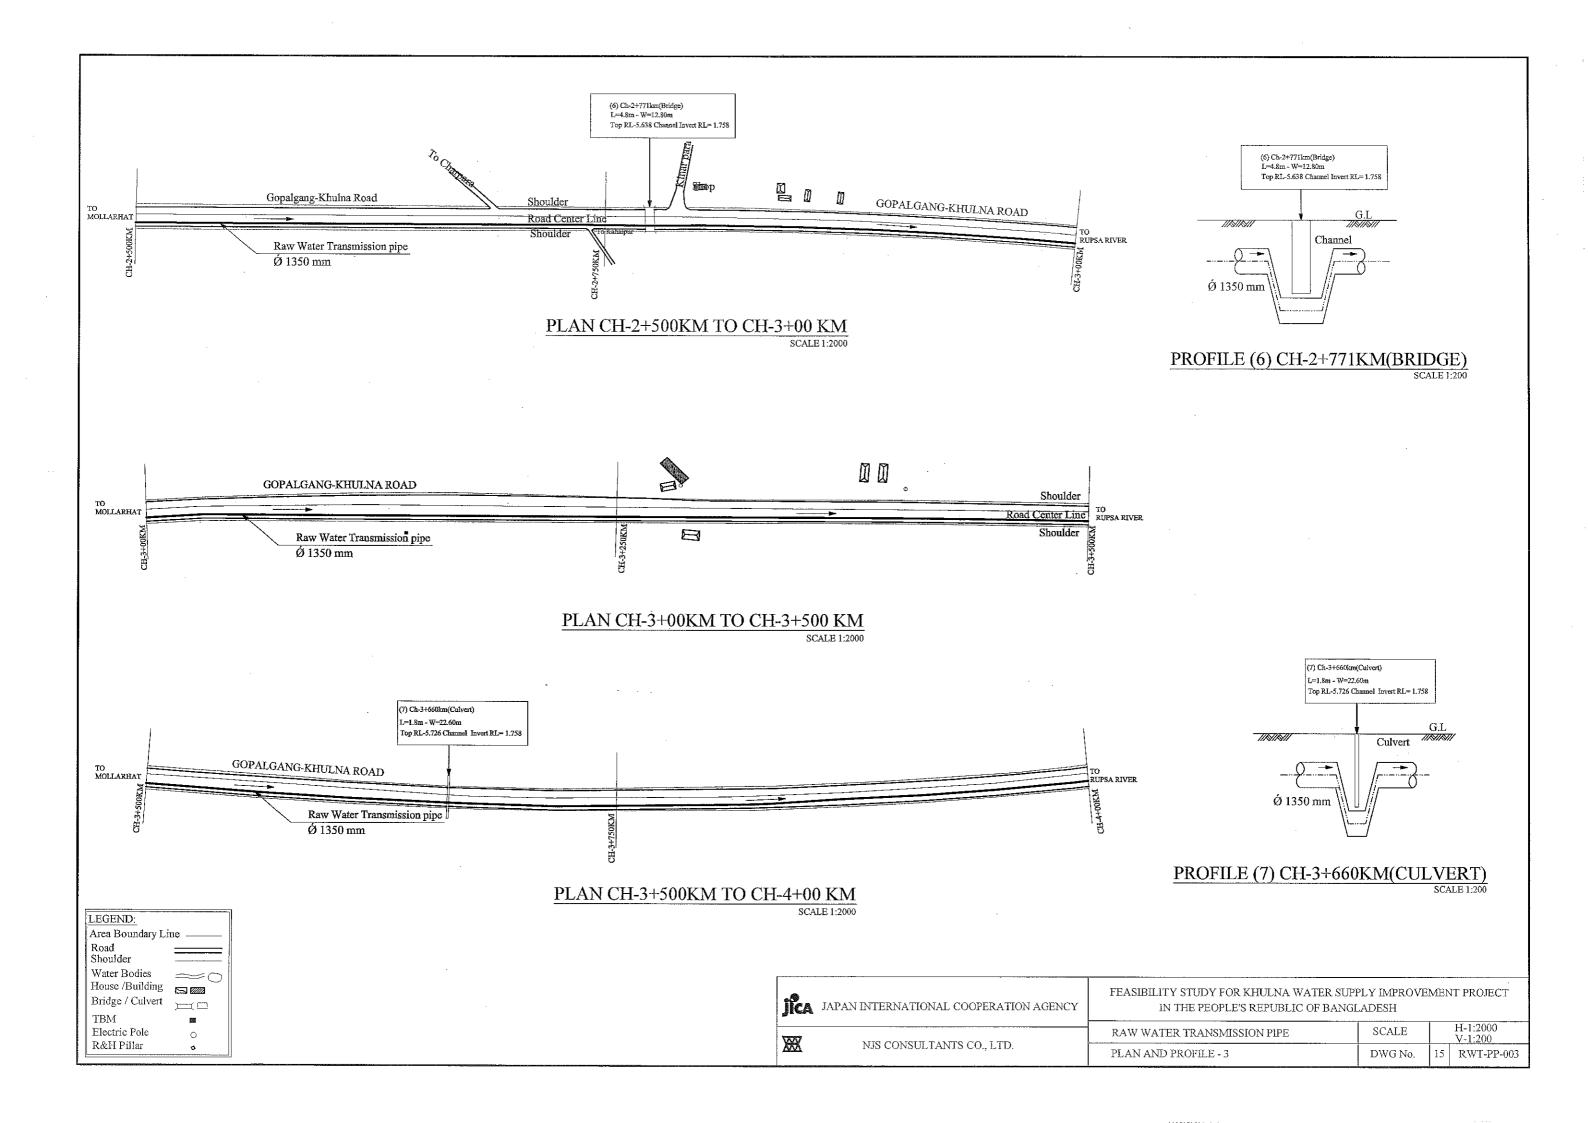

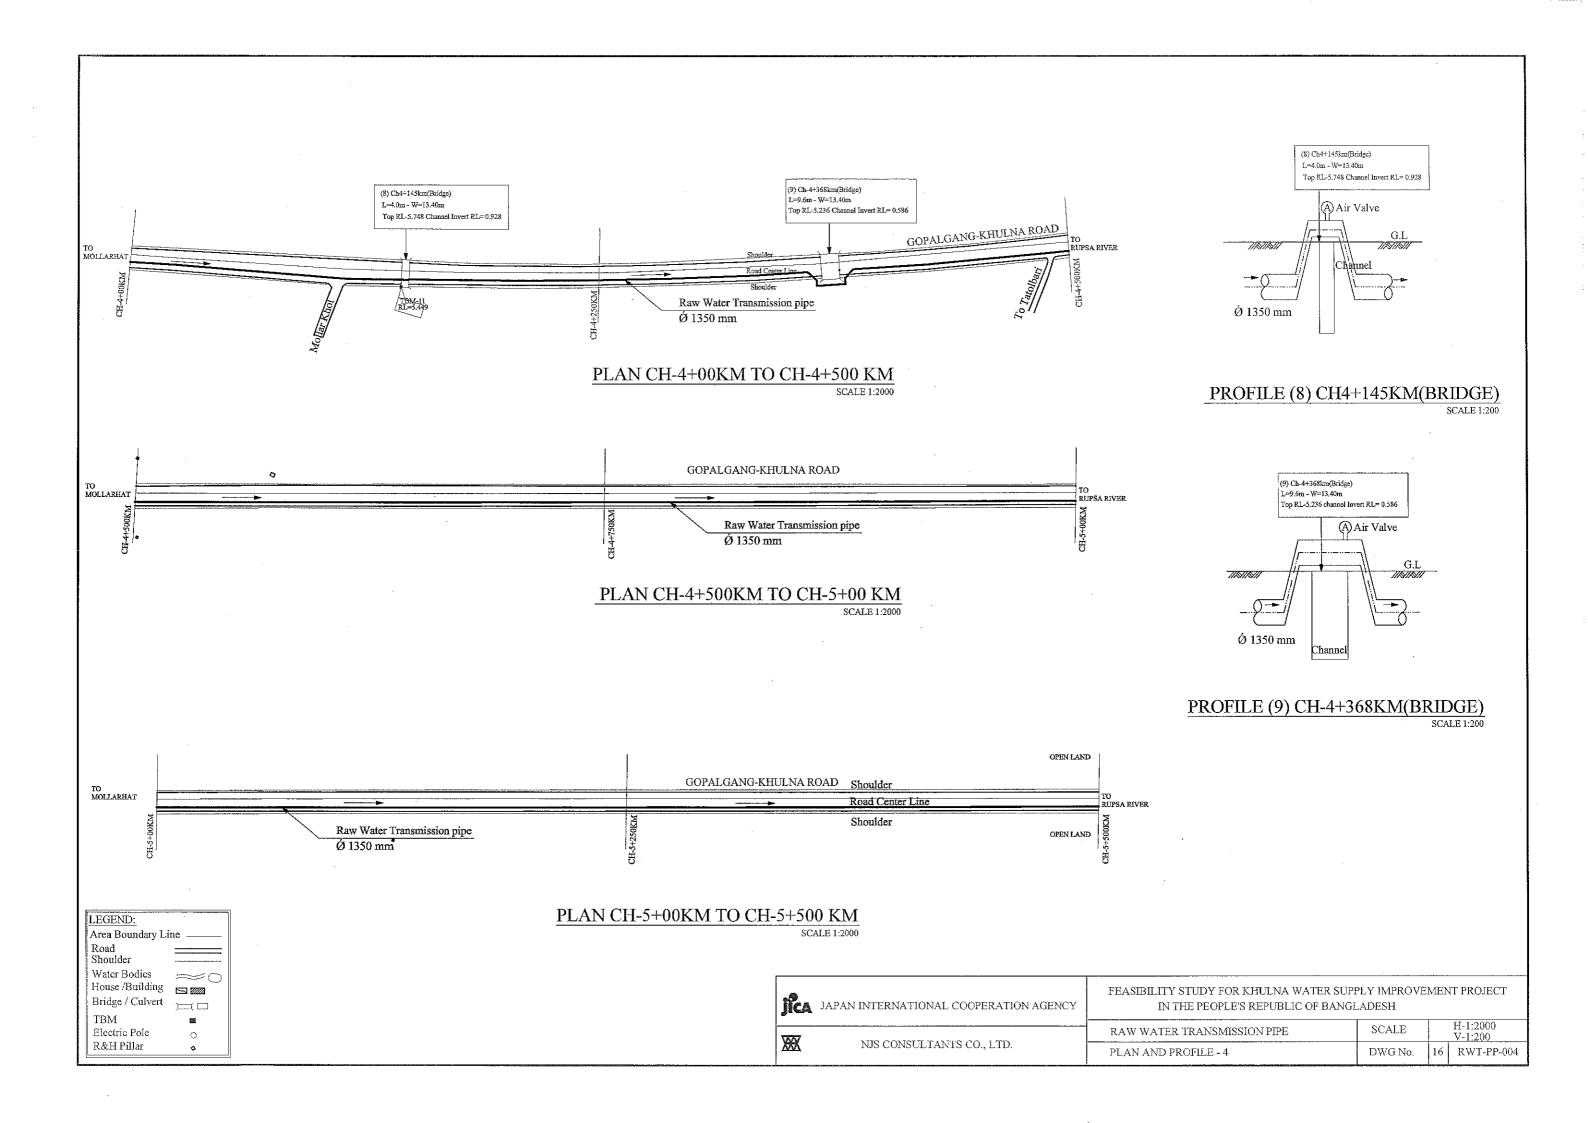

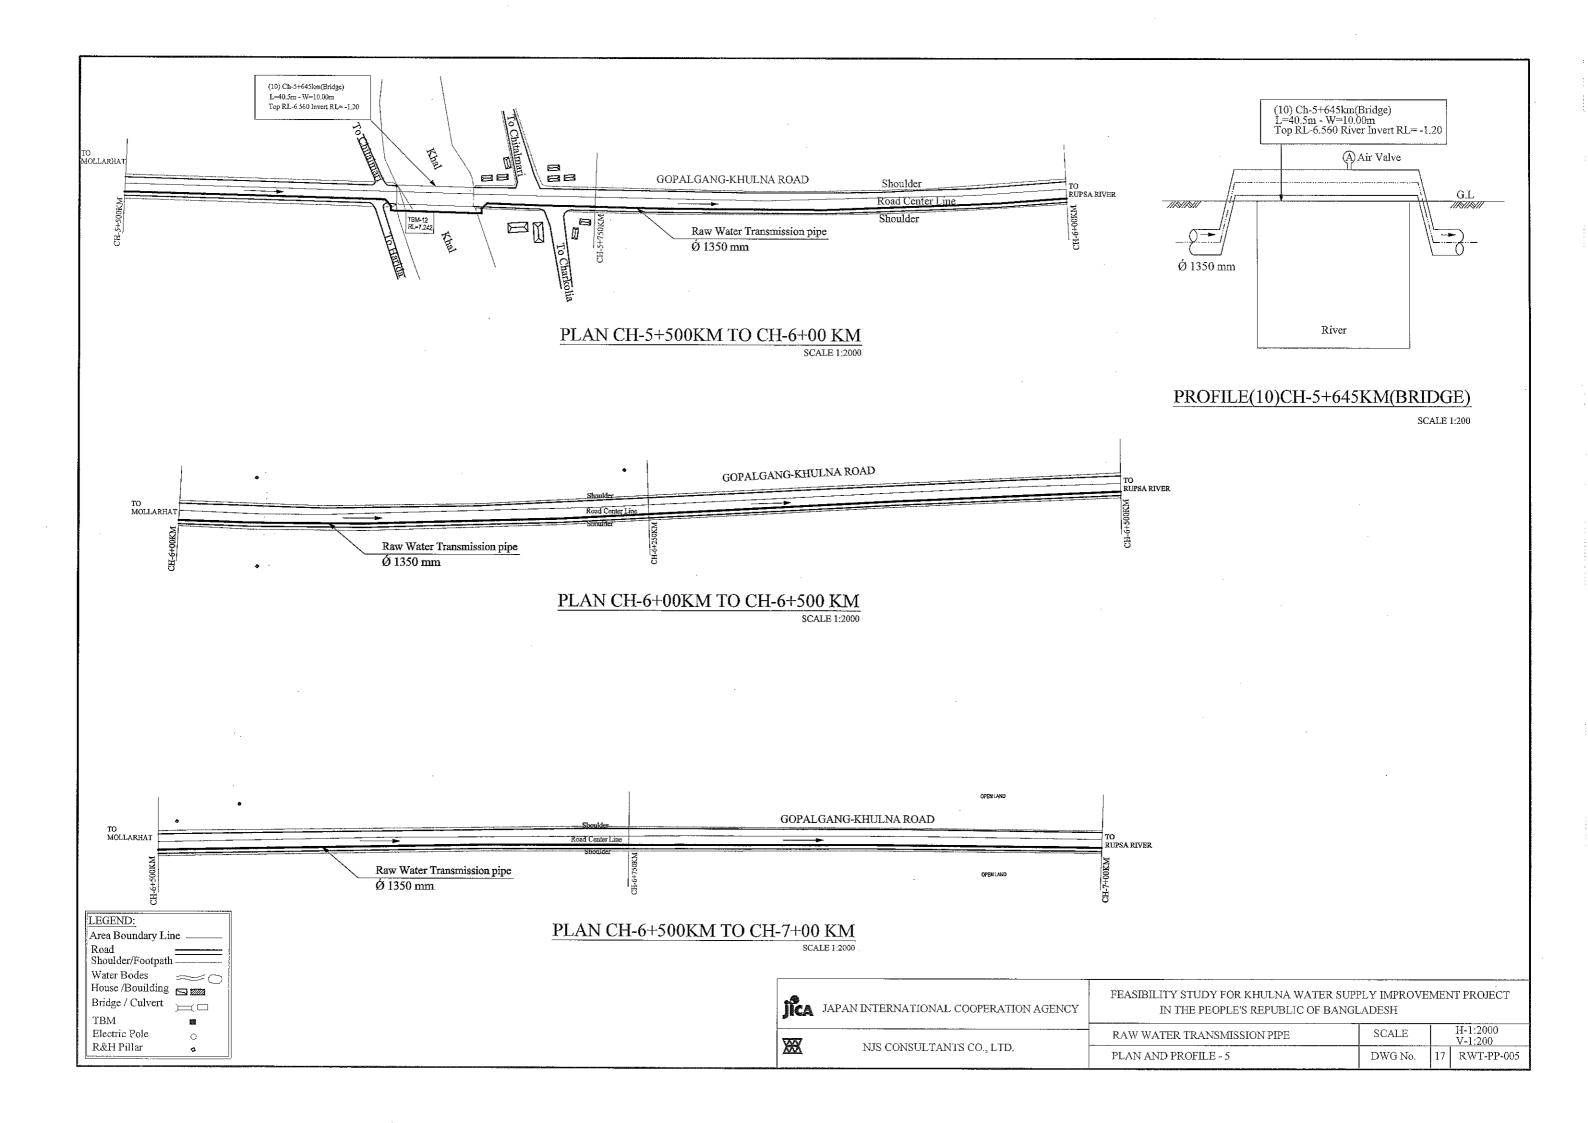


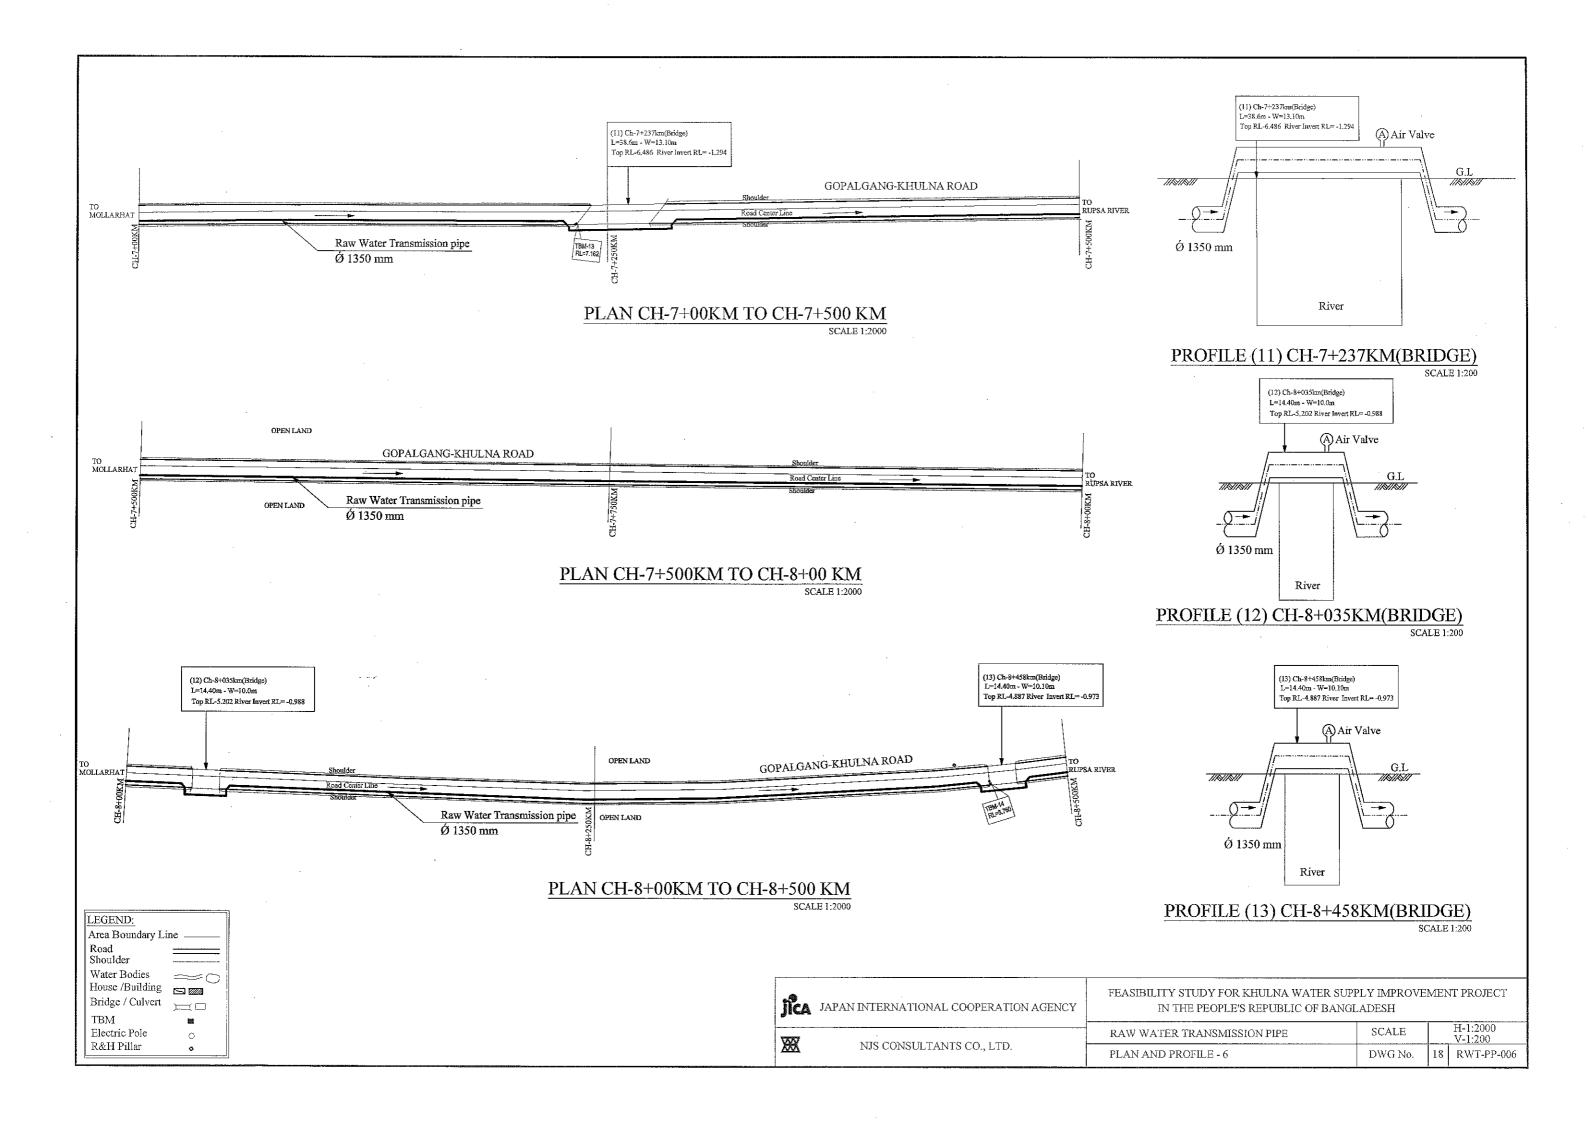

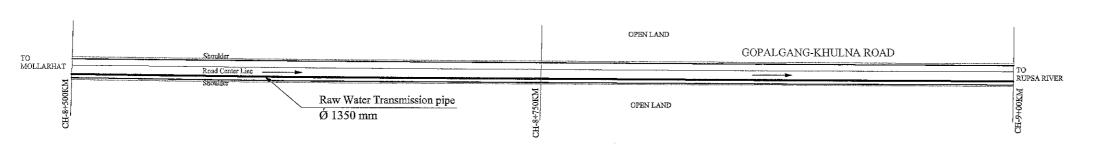

PLAN CH-8+500KM TO CH-9+00 KM

SCALE 1:2000

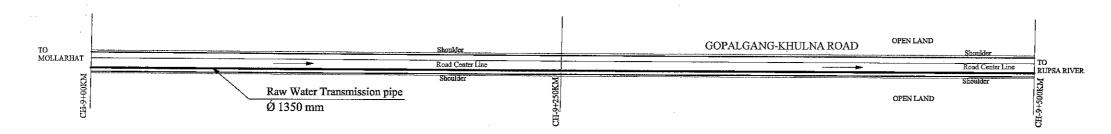

PLAN CH-9+00KM TO CH-9+500 KM


CHULNA ROAD


Shoulder


Road Center Line
Shoulder


Rupsa river


то	GOPALGANG-KHULNA ROAD				
MOLLARHAT	>	Shoulder Road Center Line	TO RUPSA RIVER		
CH-9+500KM	Raw Water Transmission pipe Ø 1350 mm	Shoulder OPEN LAND	CH-10+00KM		
LEGEND: Area Boundary Line Road Shoulder Water Bodies		-500KM TO CH-10+00 KM SCALE 1:2000			
House /Building Bridge / Culvert		JAPAN INTERNATIONAL COOPERATION AGENCY	FEASIBILITY STUDY FOR KHULNA WATER S IN THE PEOPLE'S REPUBLIC OF BAY		MENT PROJECT
Electric Pole o		NJS CONSULTANTS CO., LTD.	RAW WATER TRANSMISSION PIPE	SCALE	H-1:2000 V-1:200
R&H Pillar &		NJS CONSULTANTS CO., LTD.	PLAN AND PROFILE - 7	DWG No.	19 RWT-PP-007

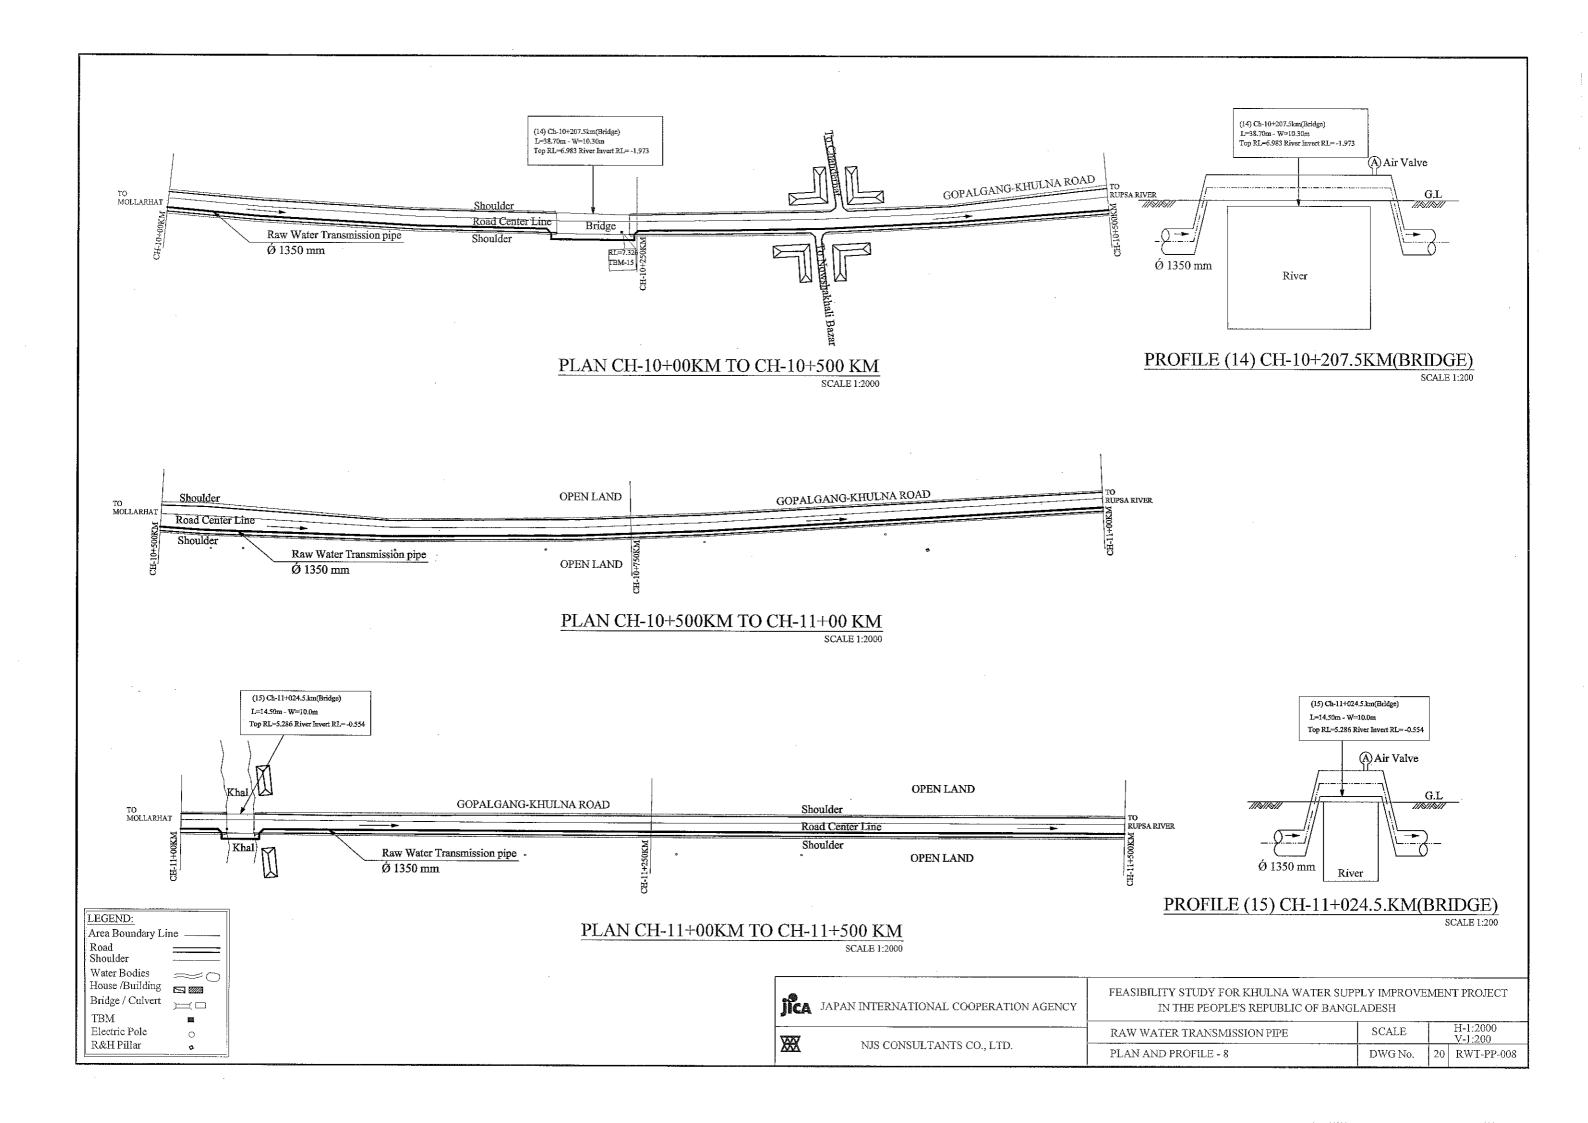


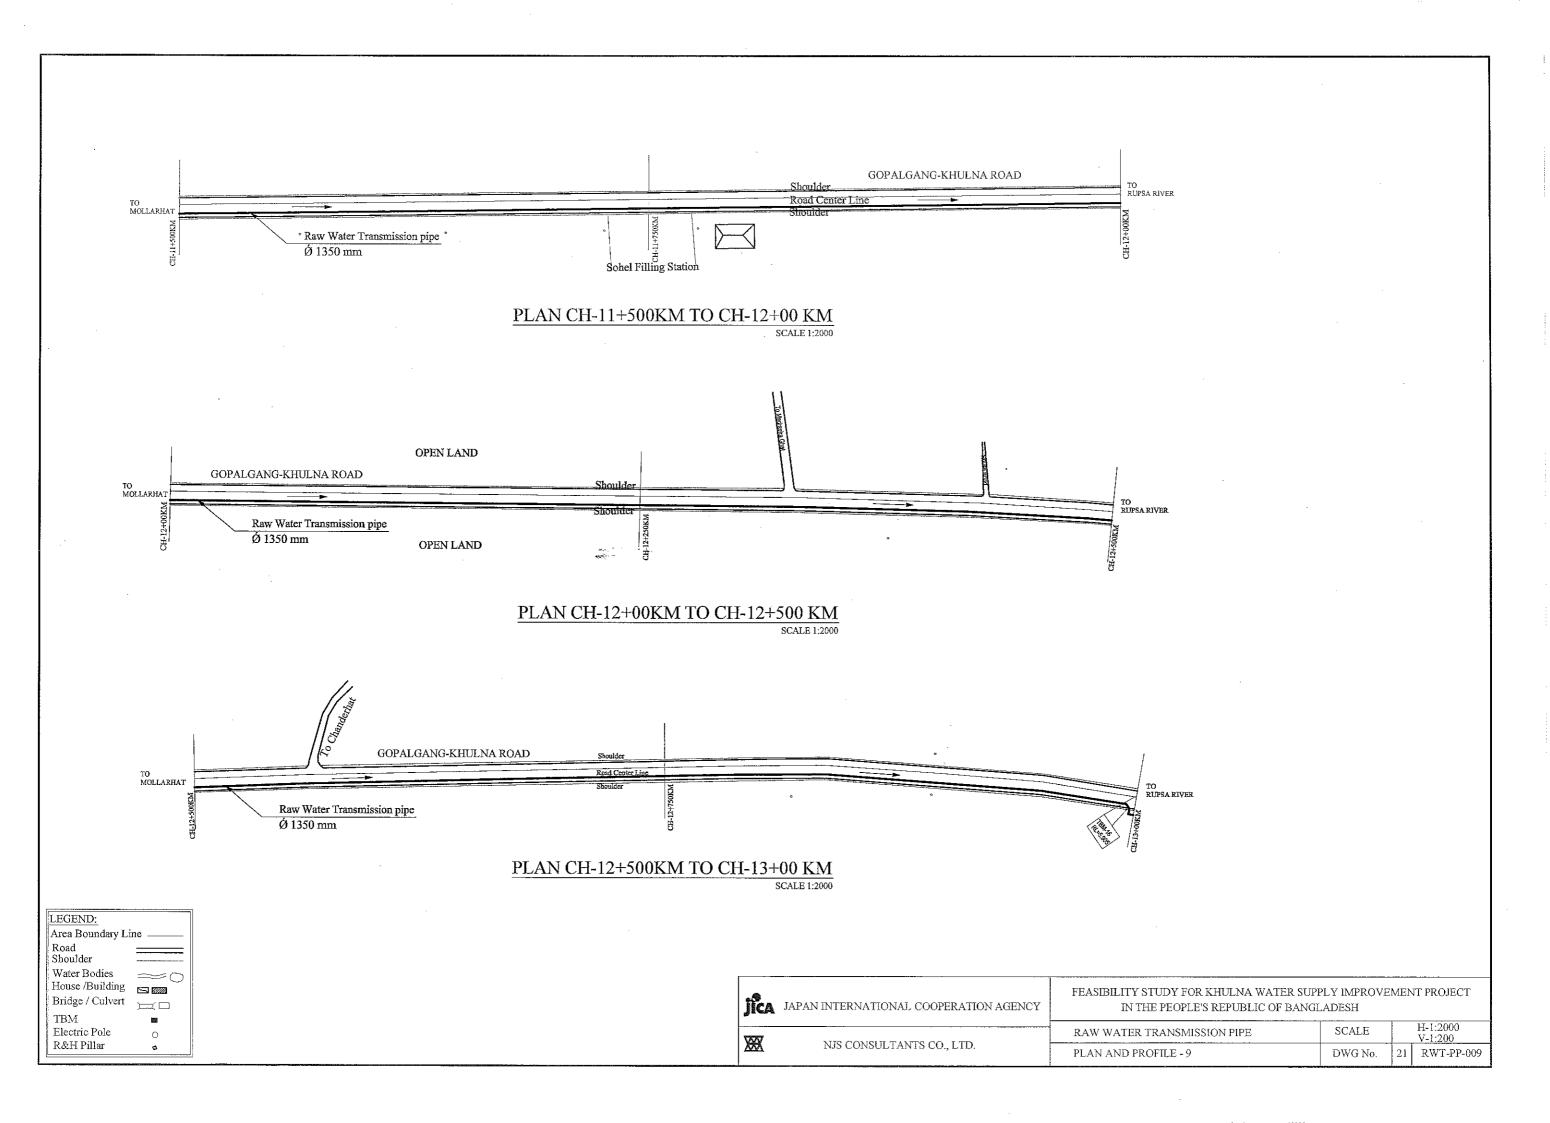


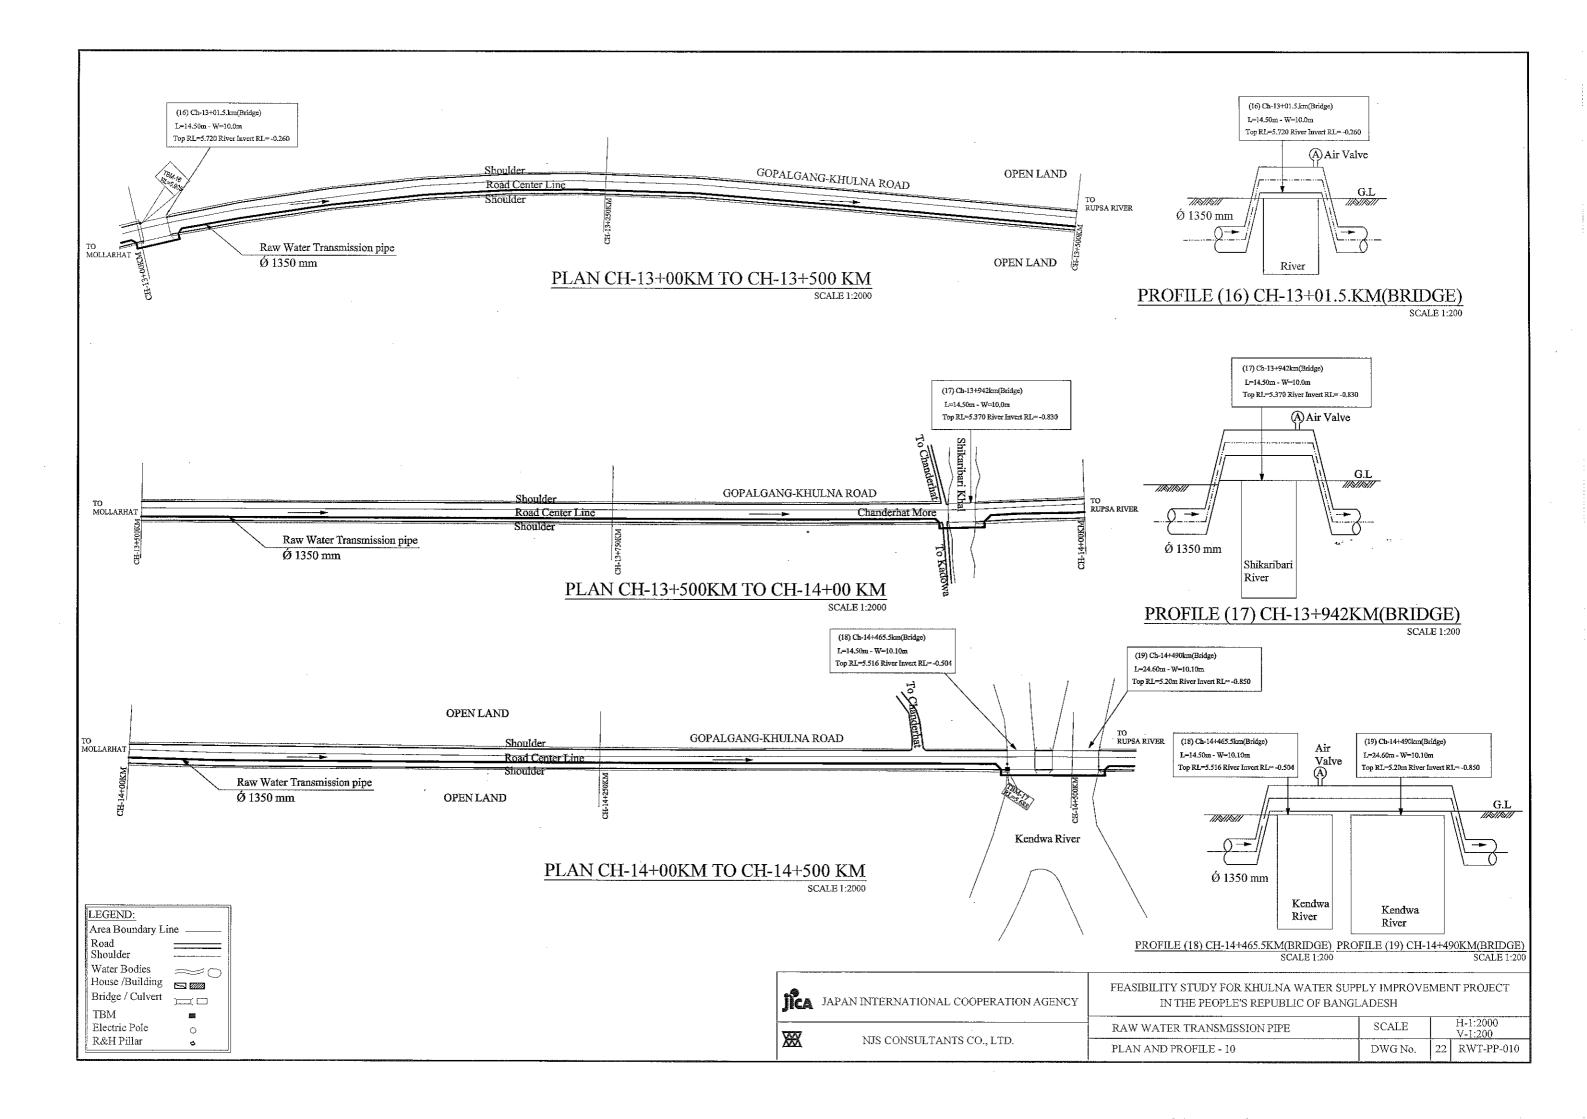


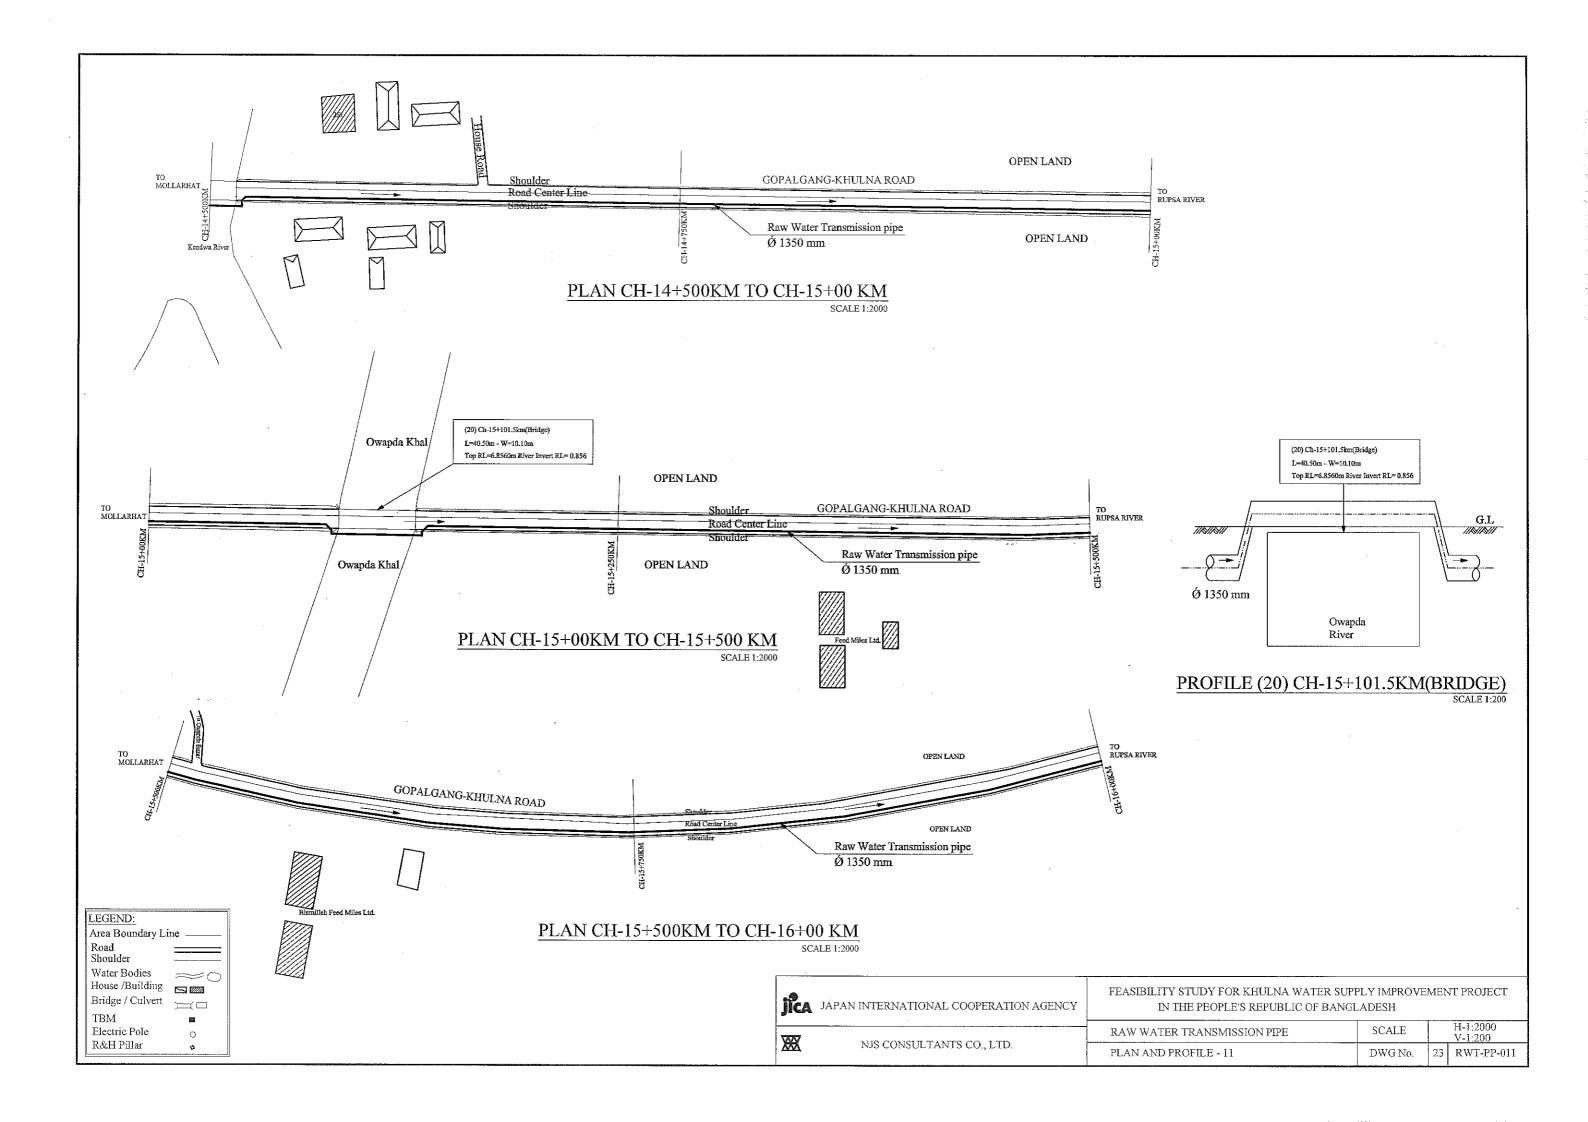


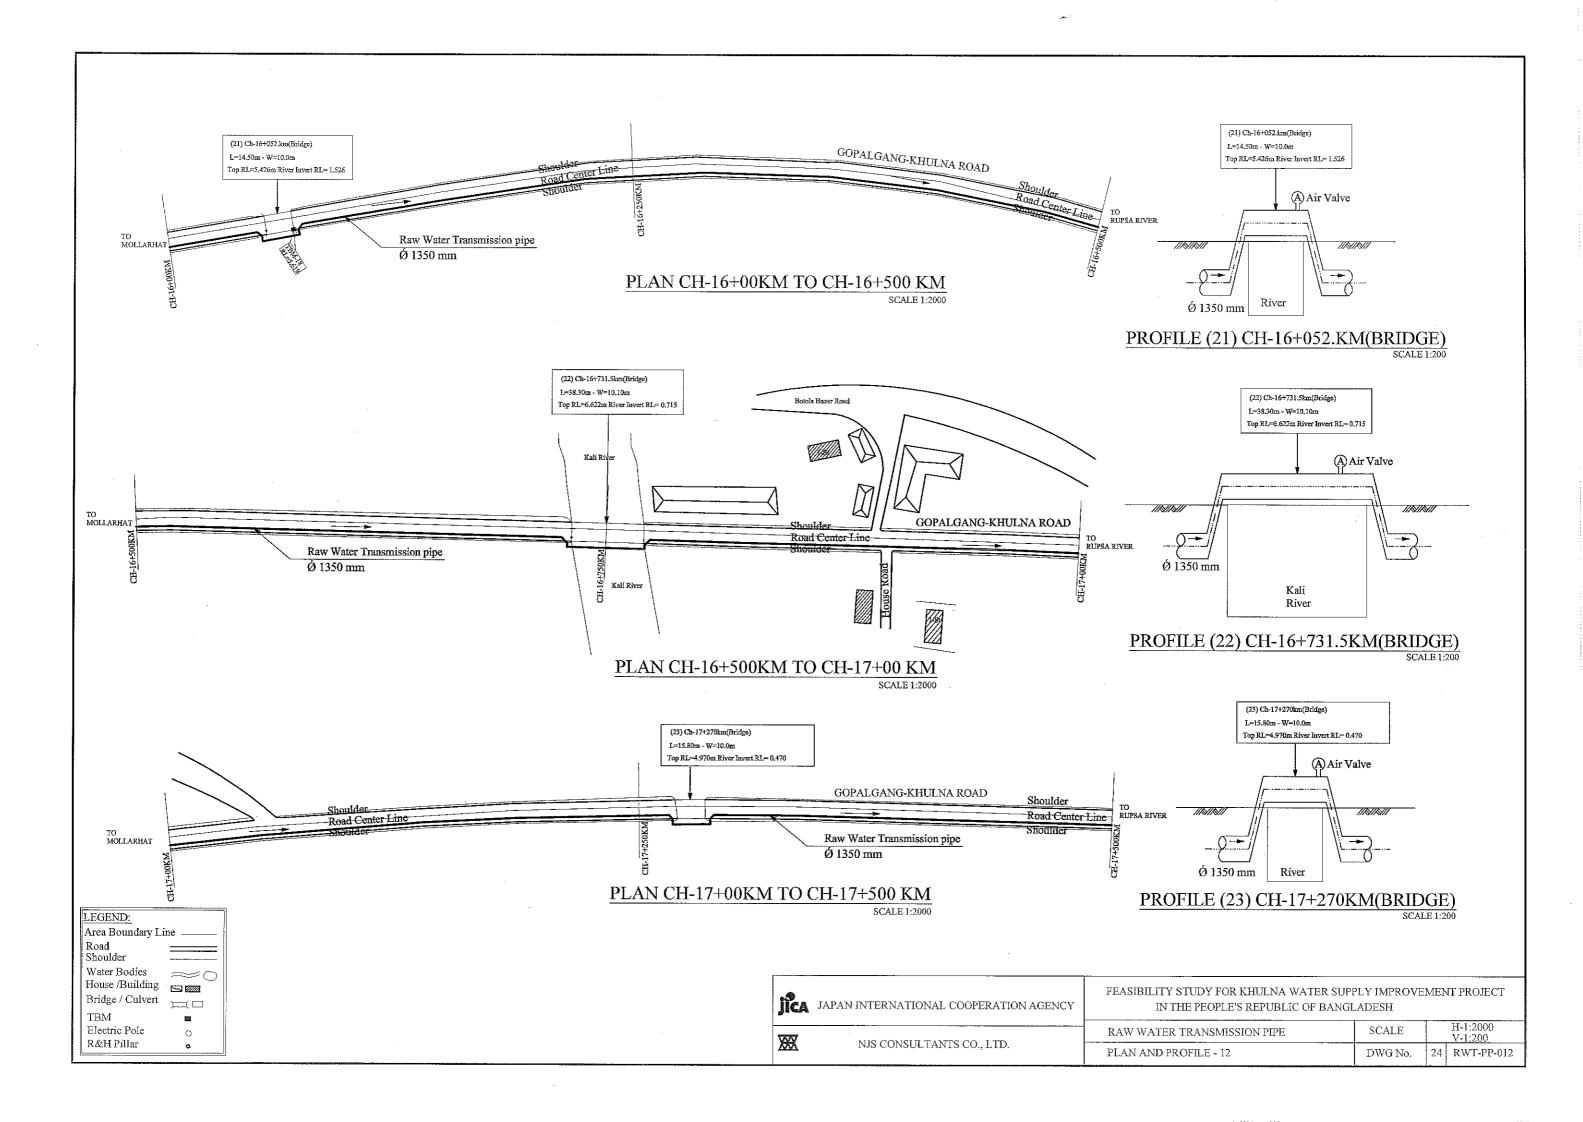


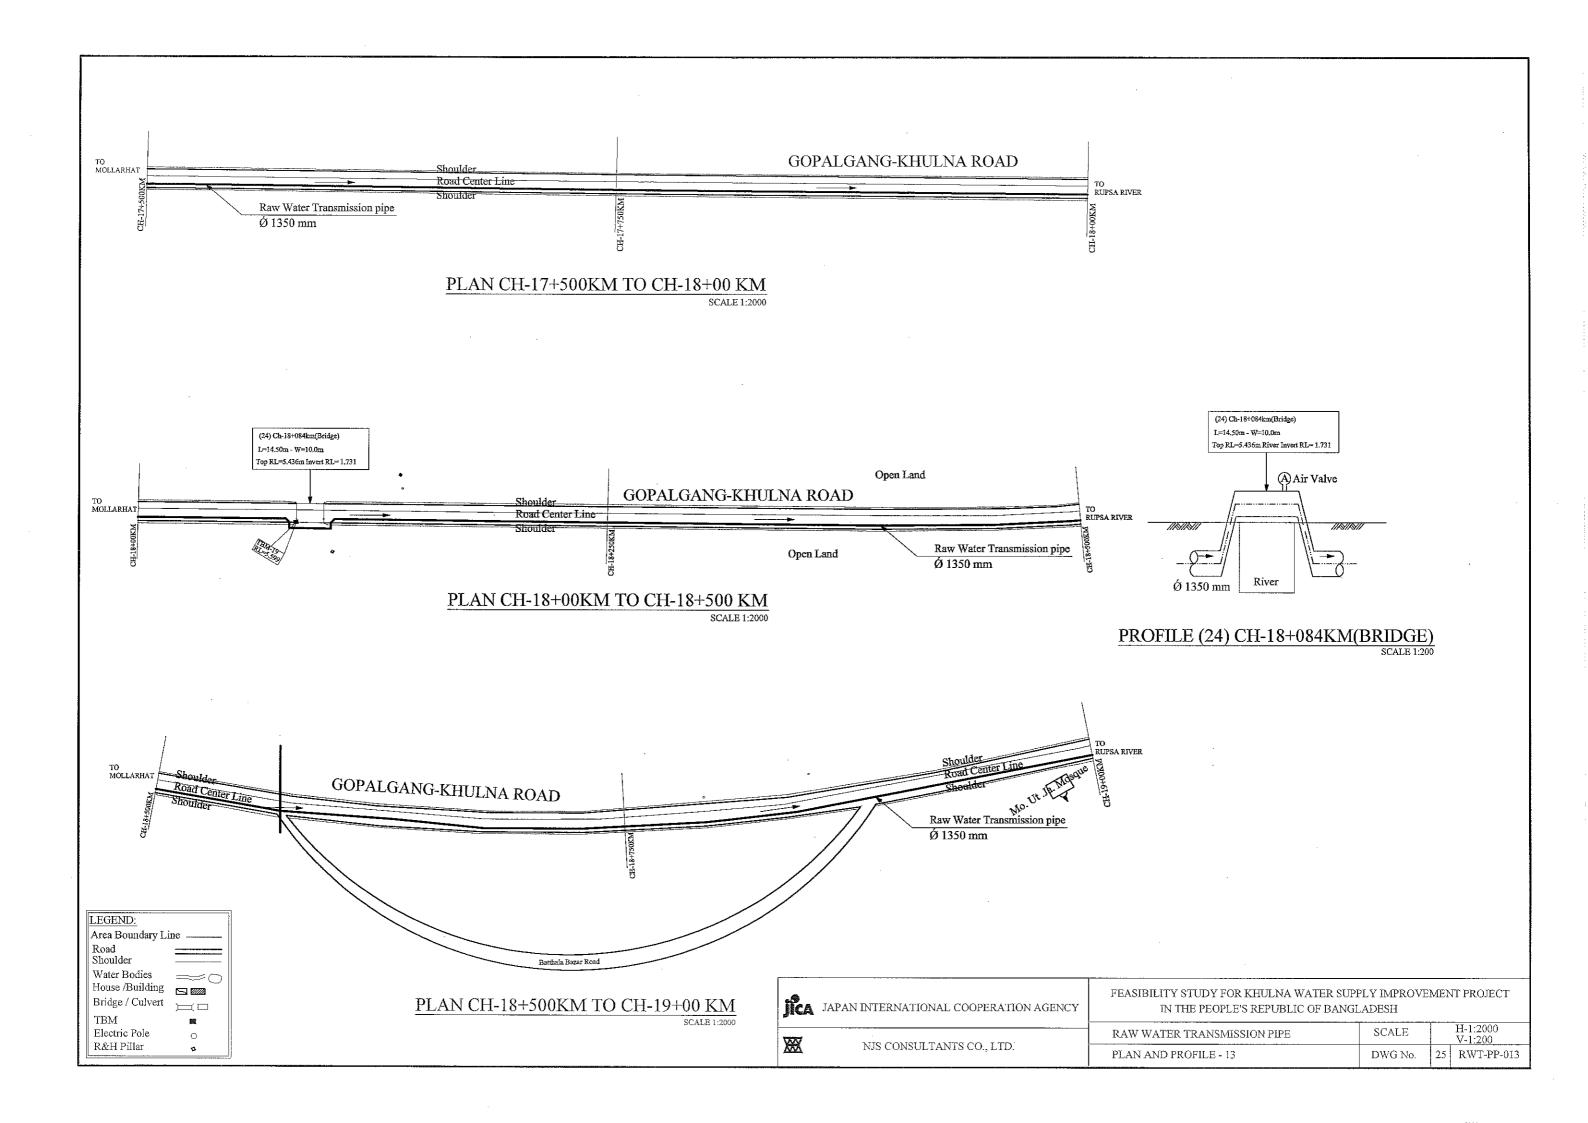


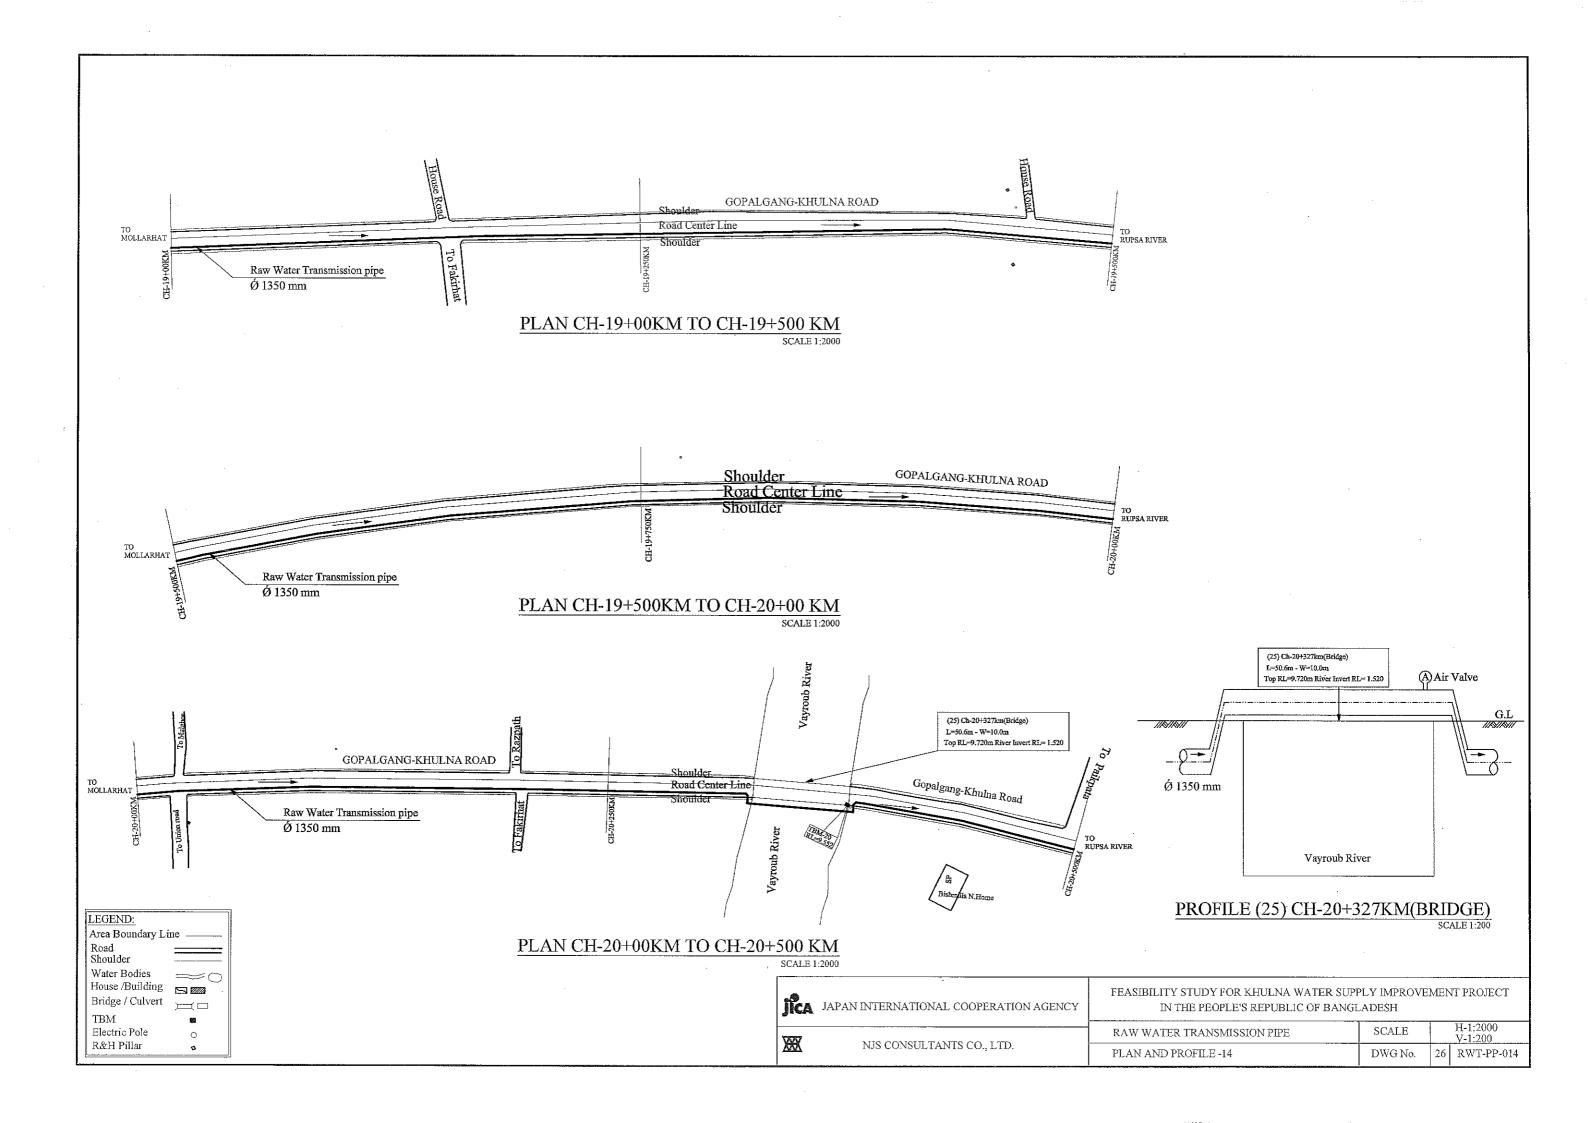


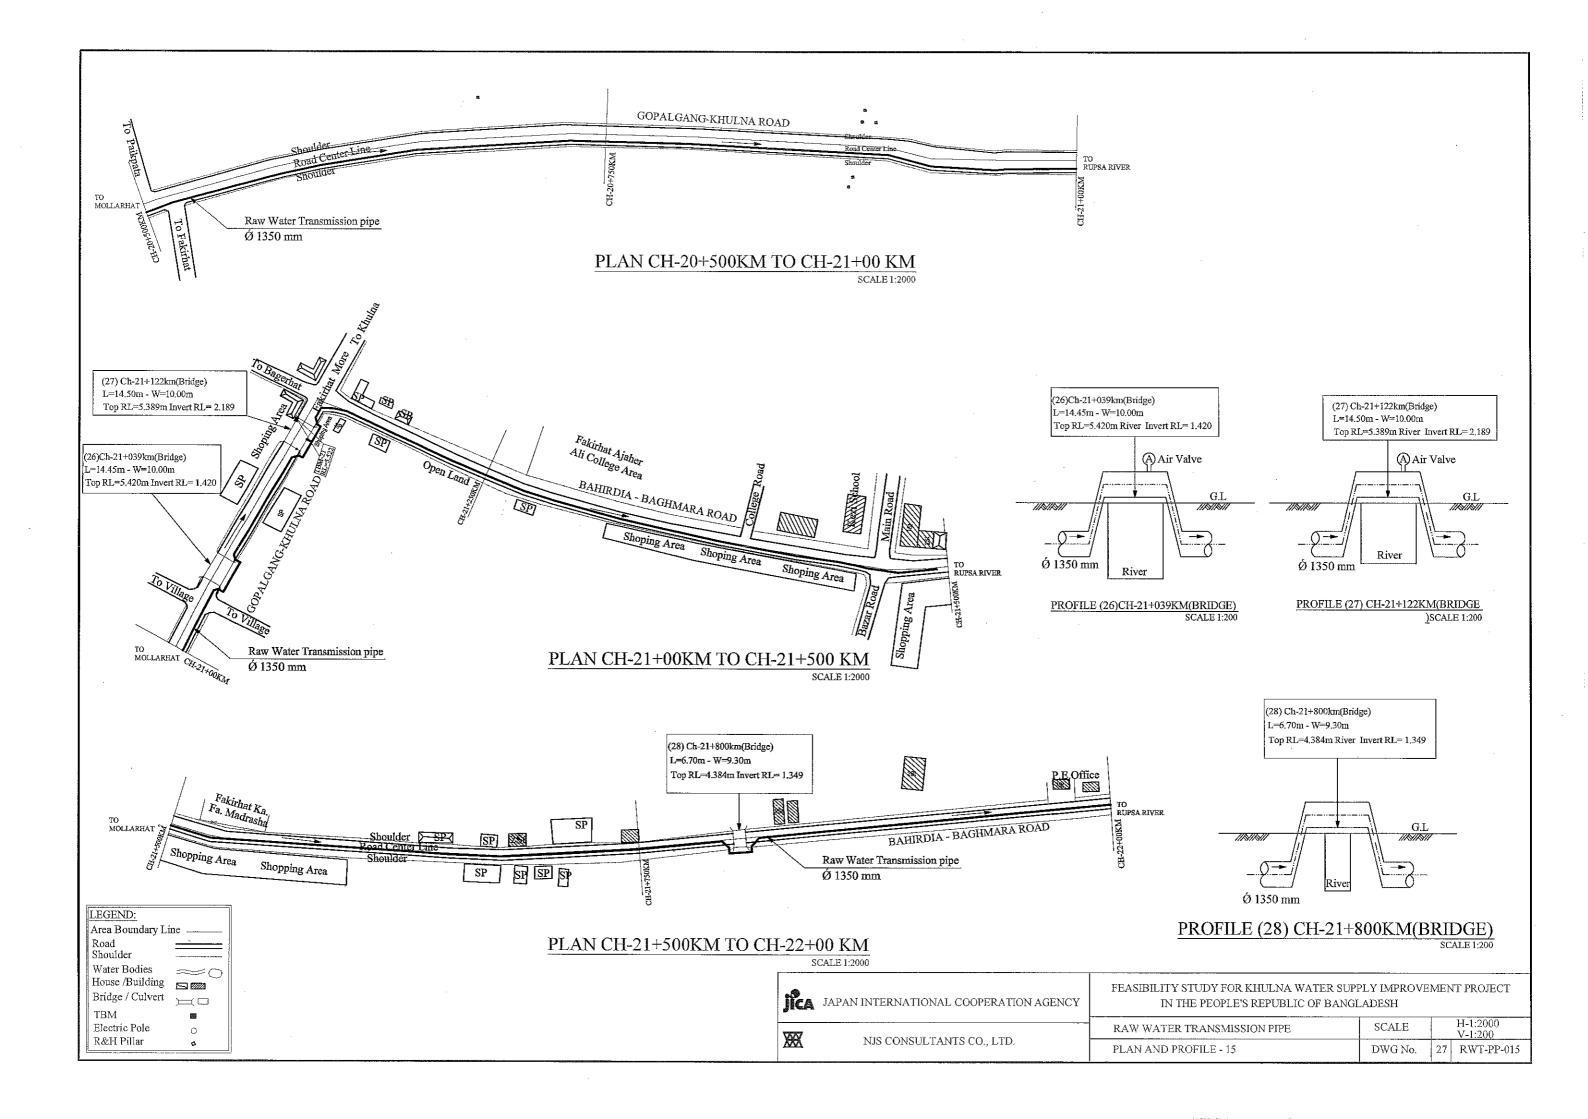


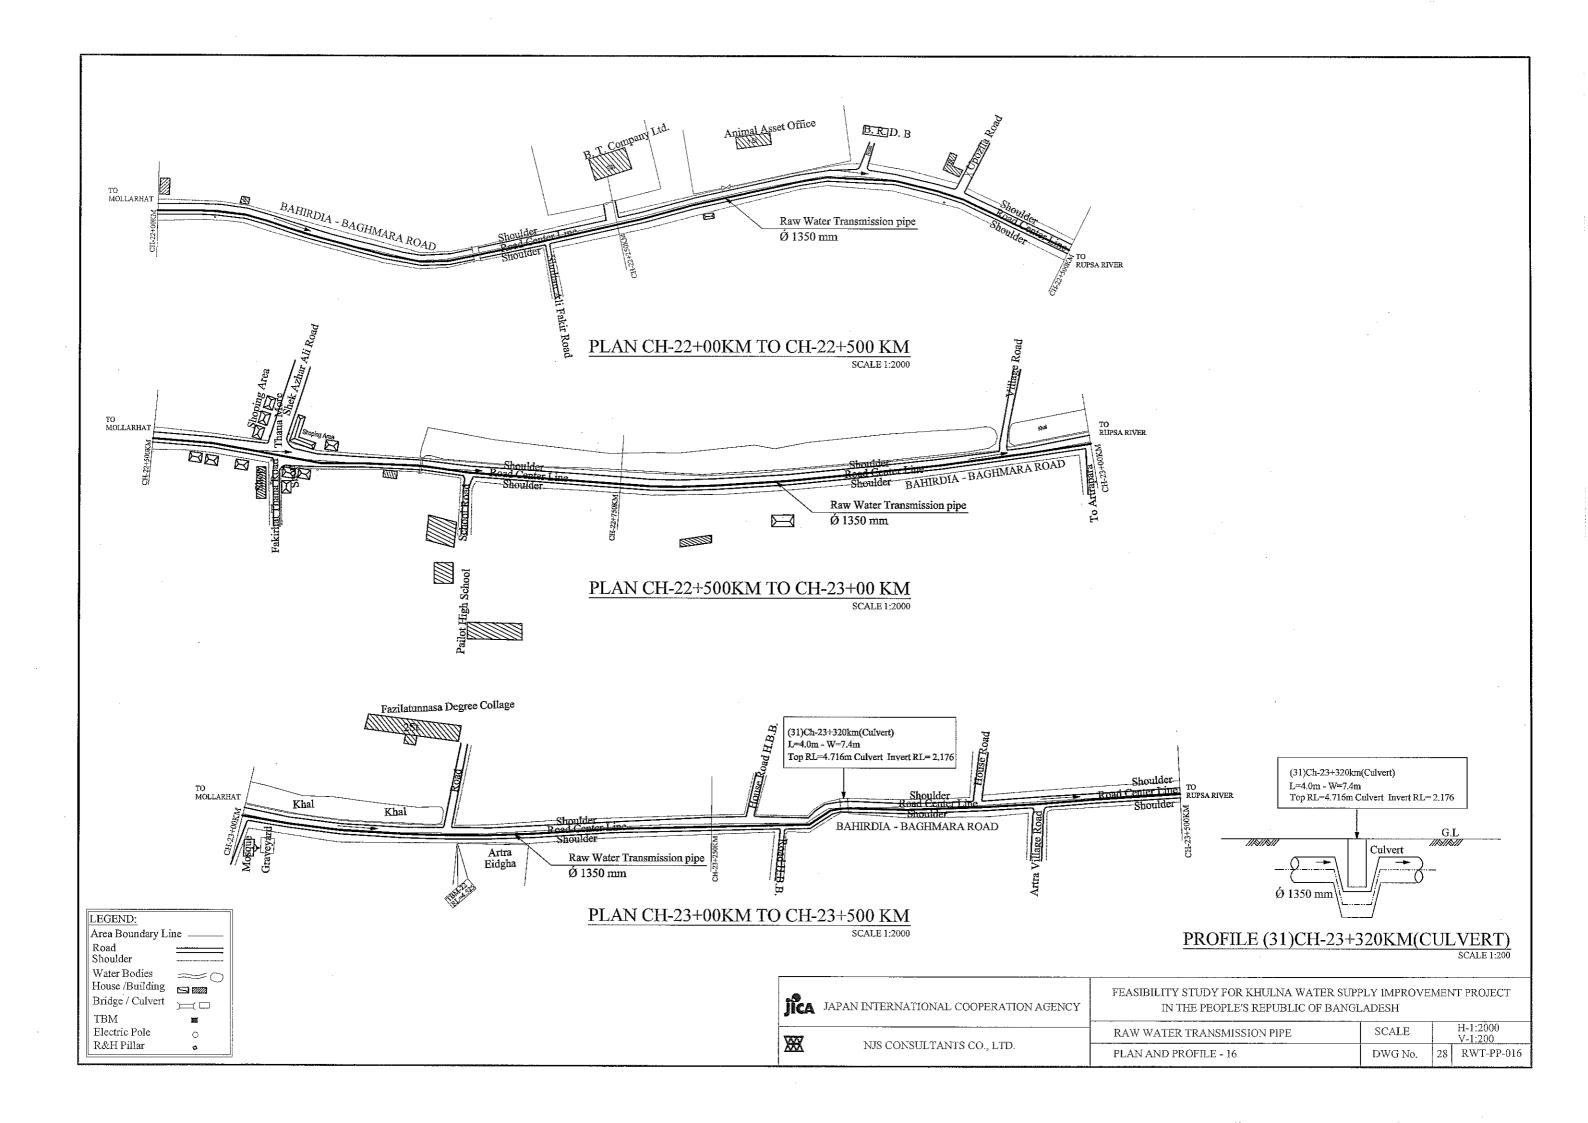


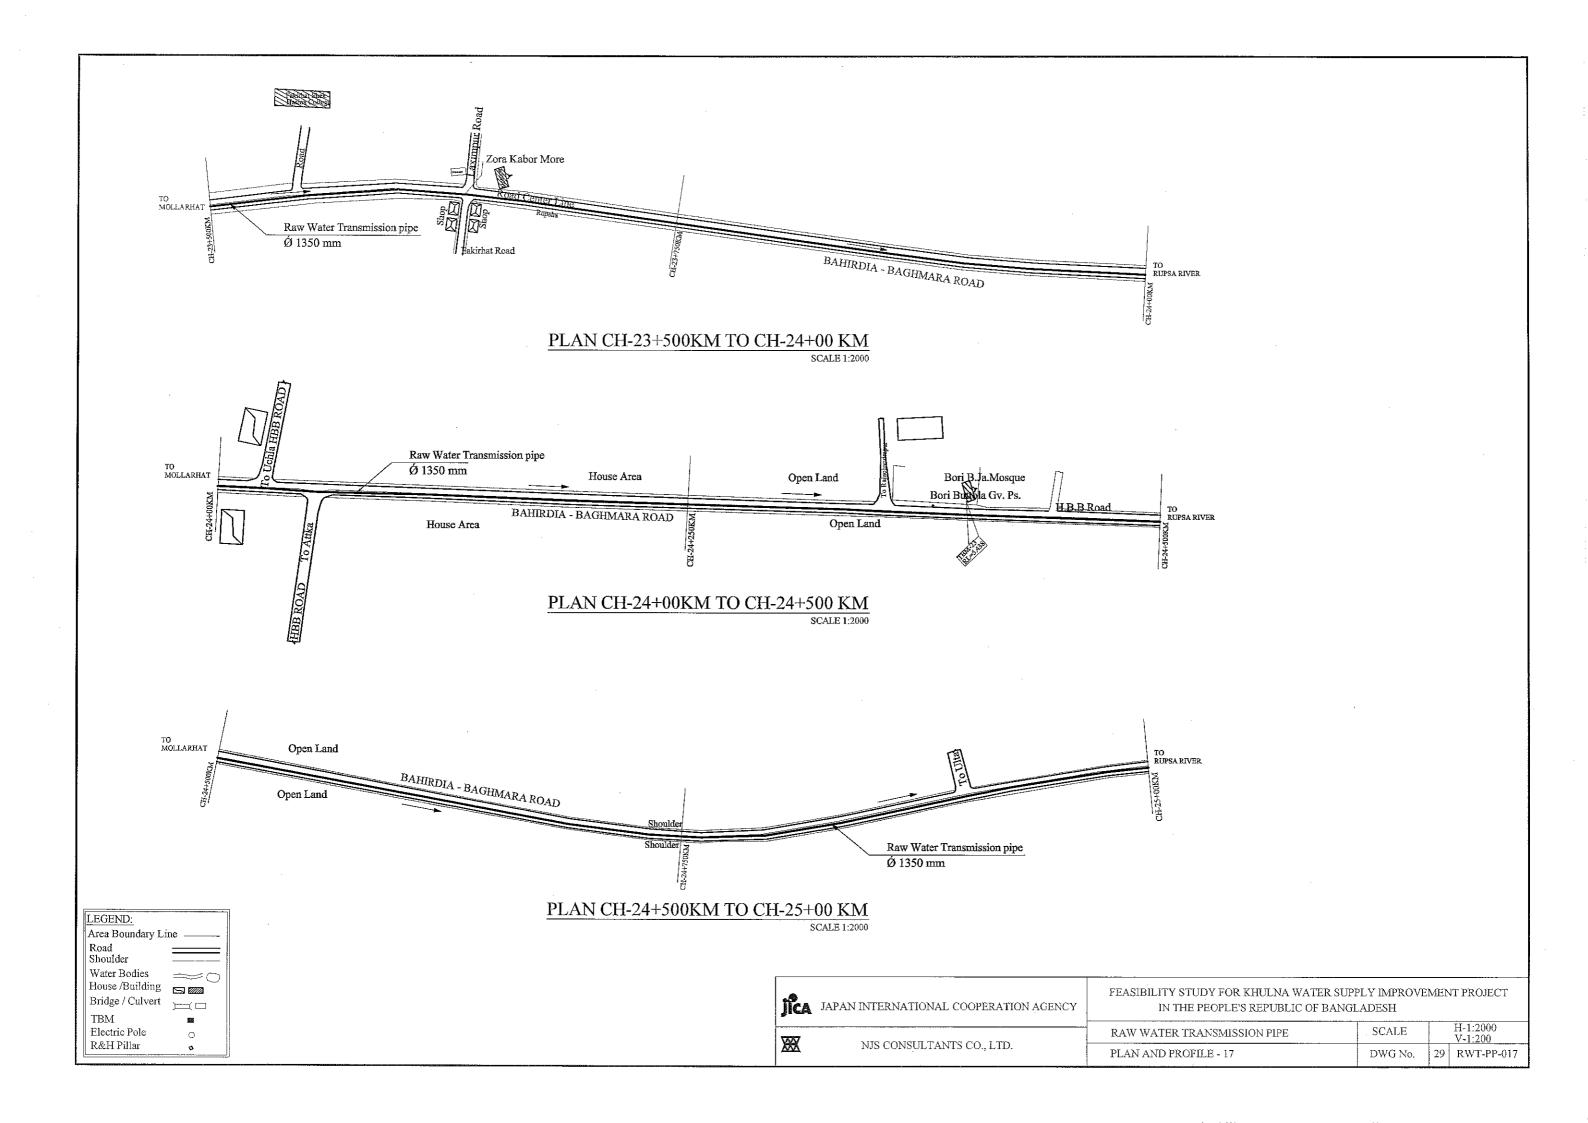


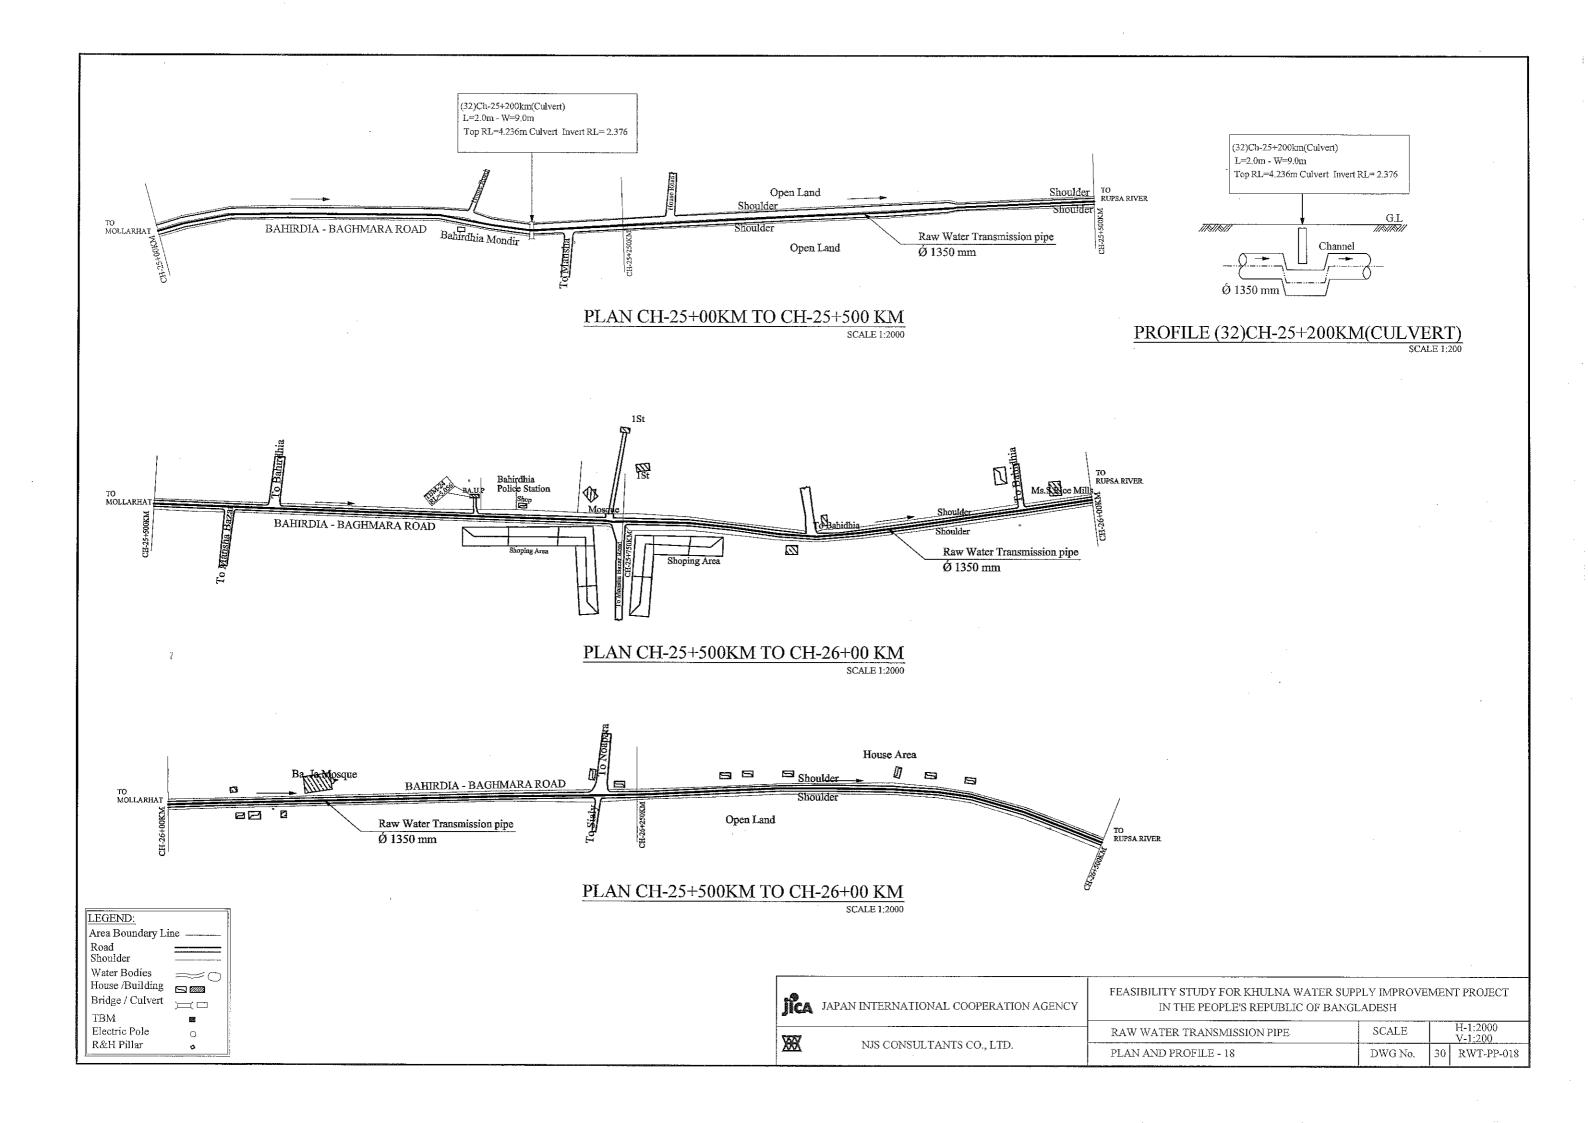


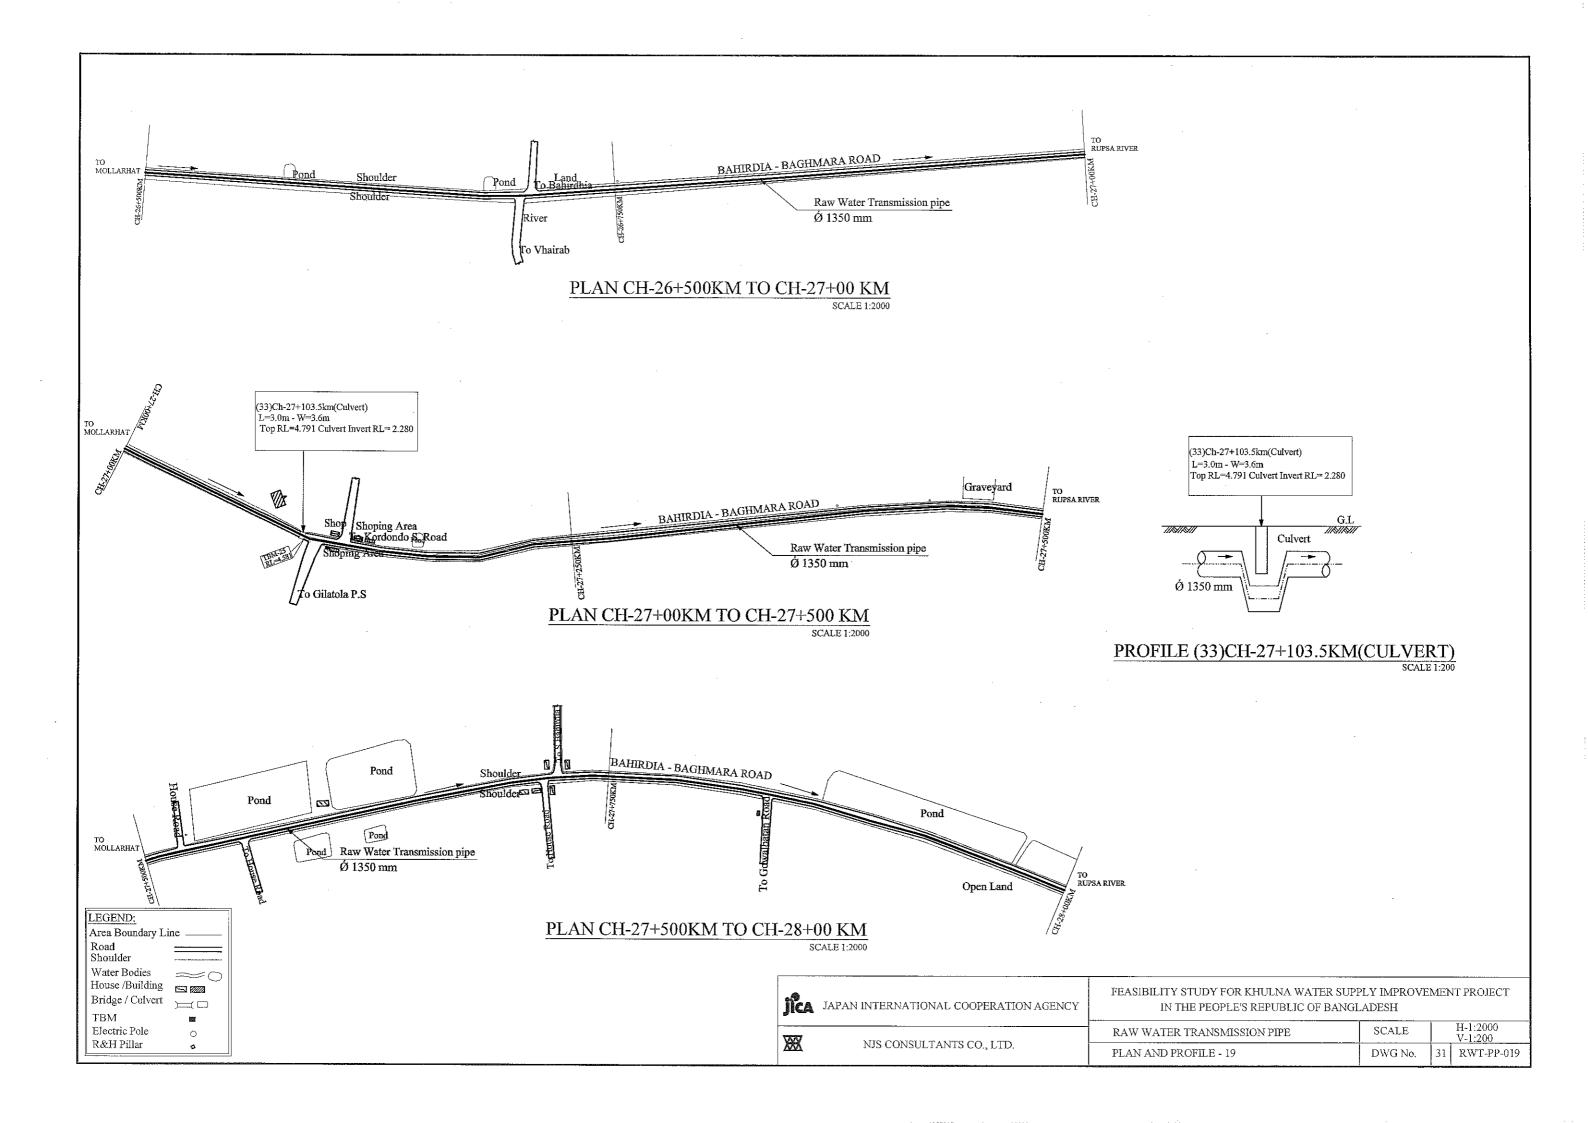

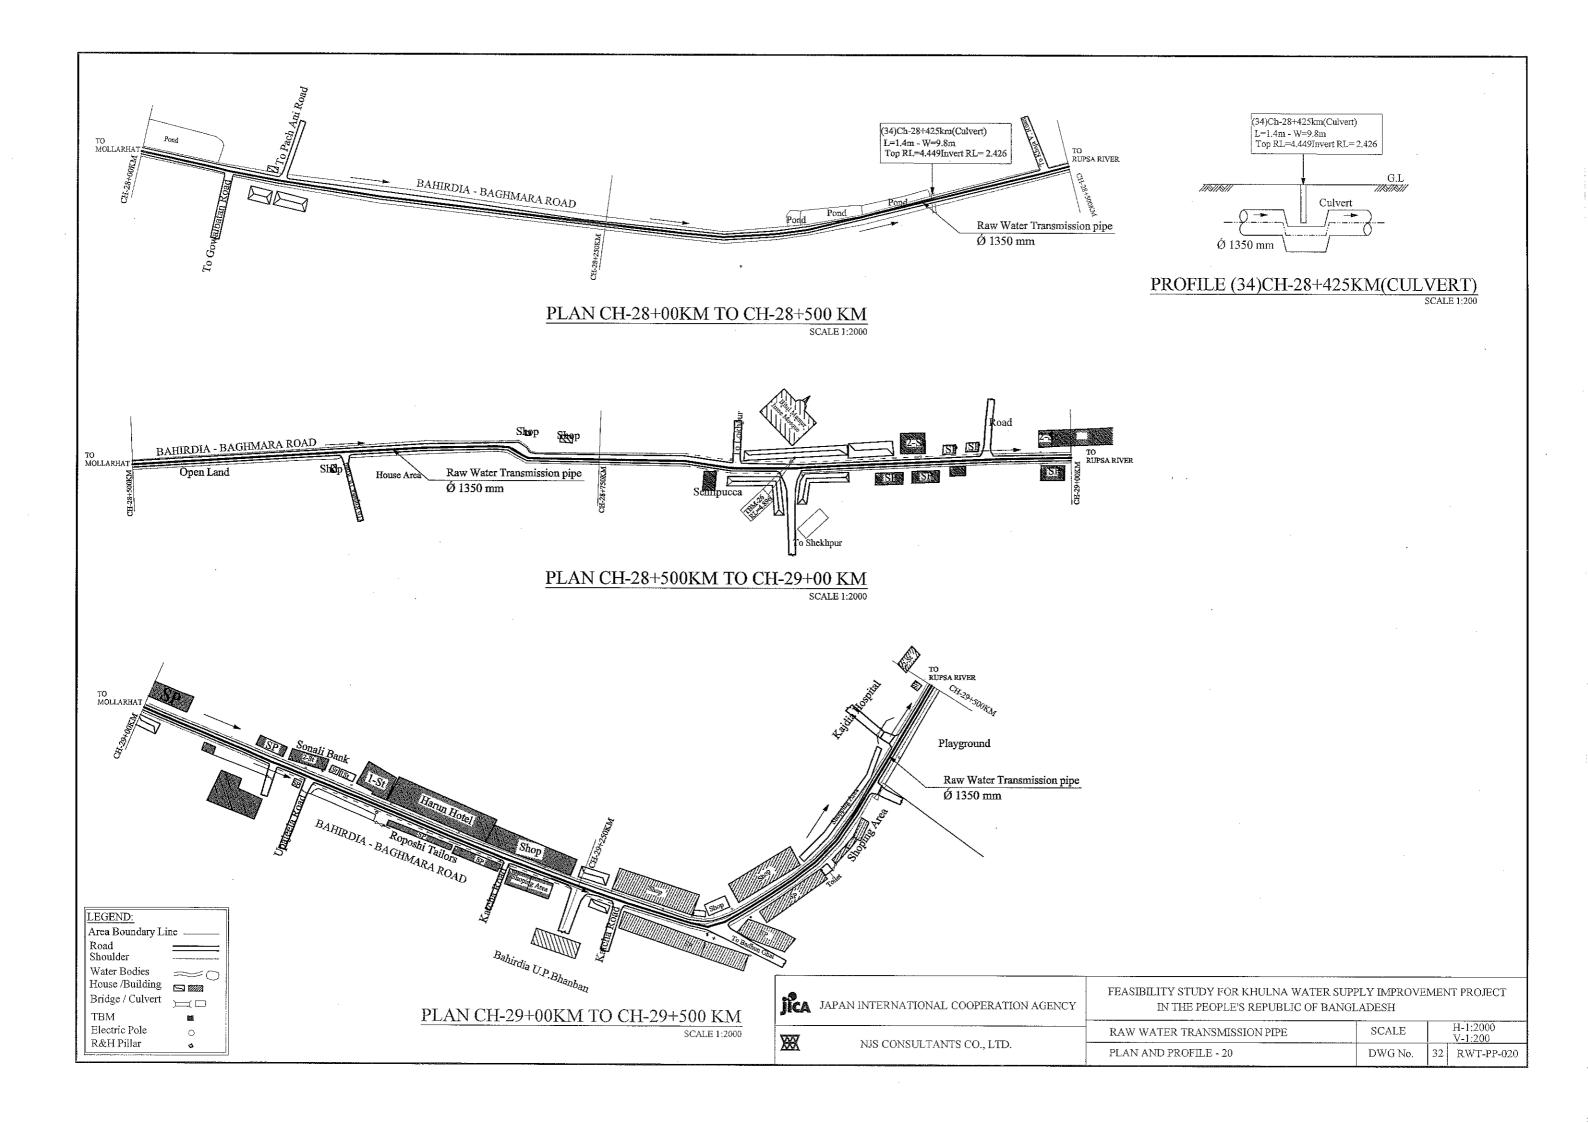

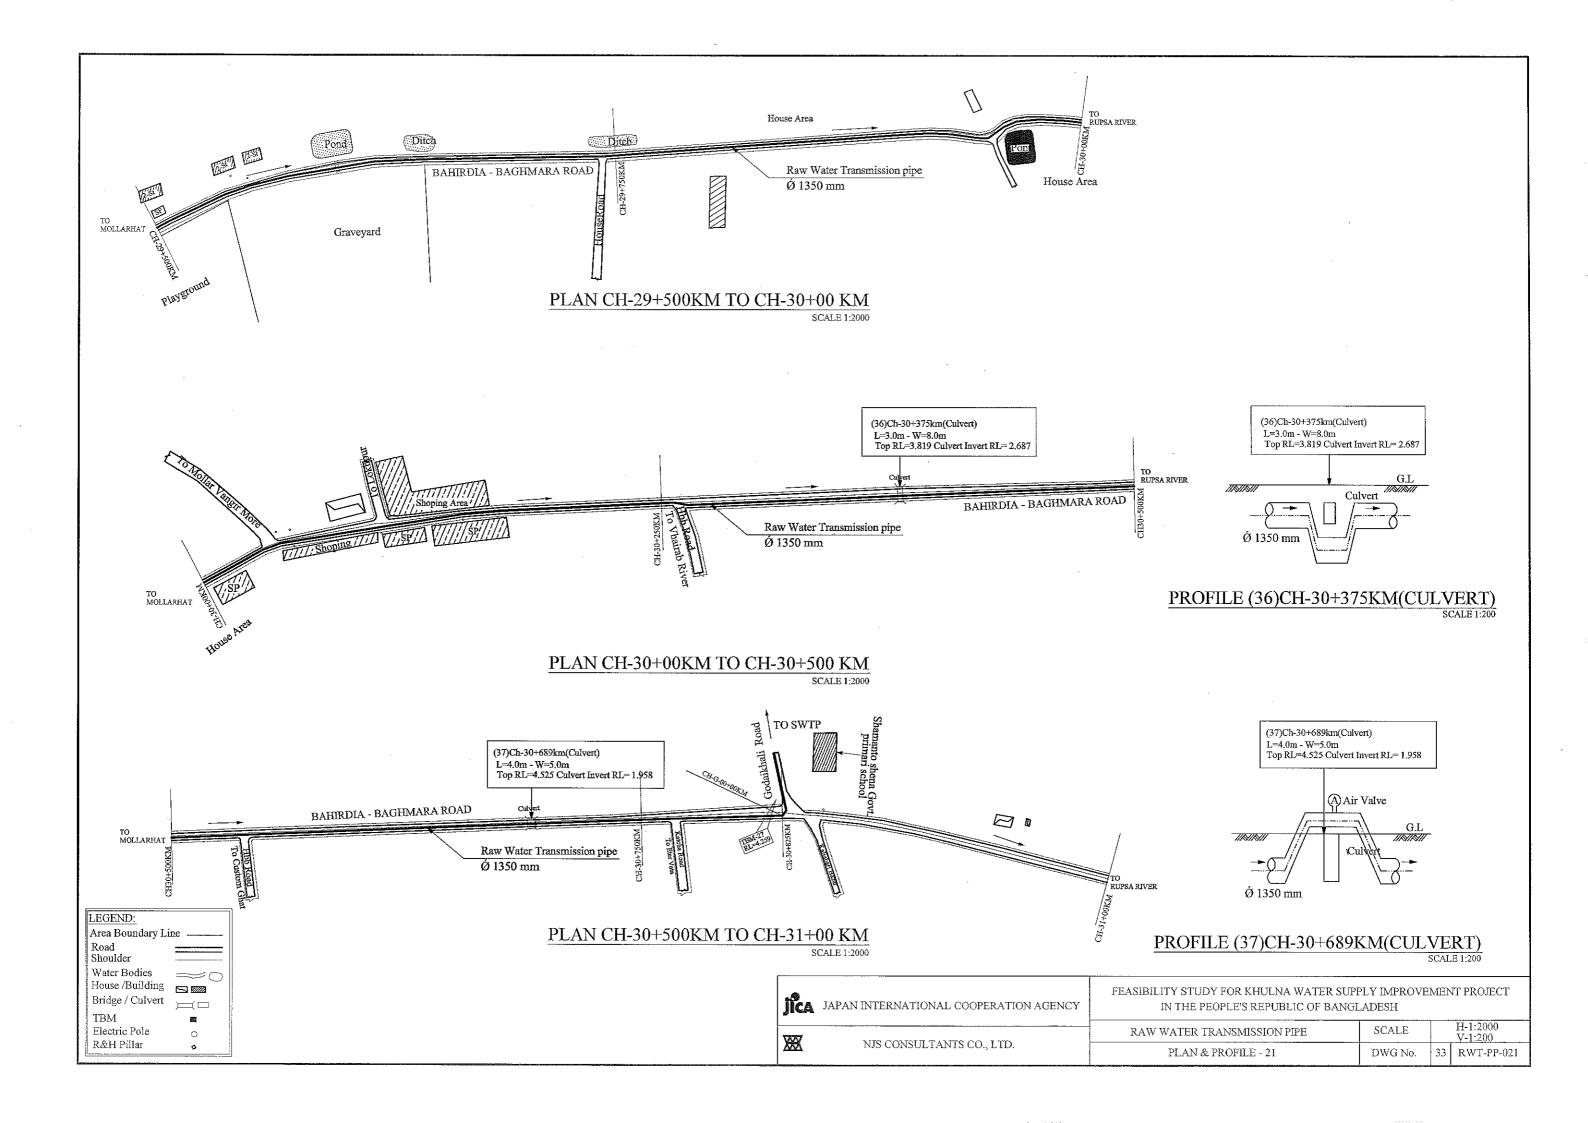

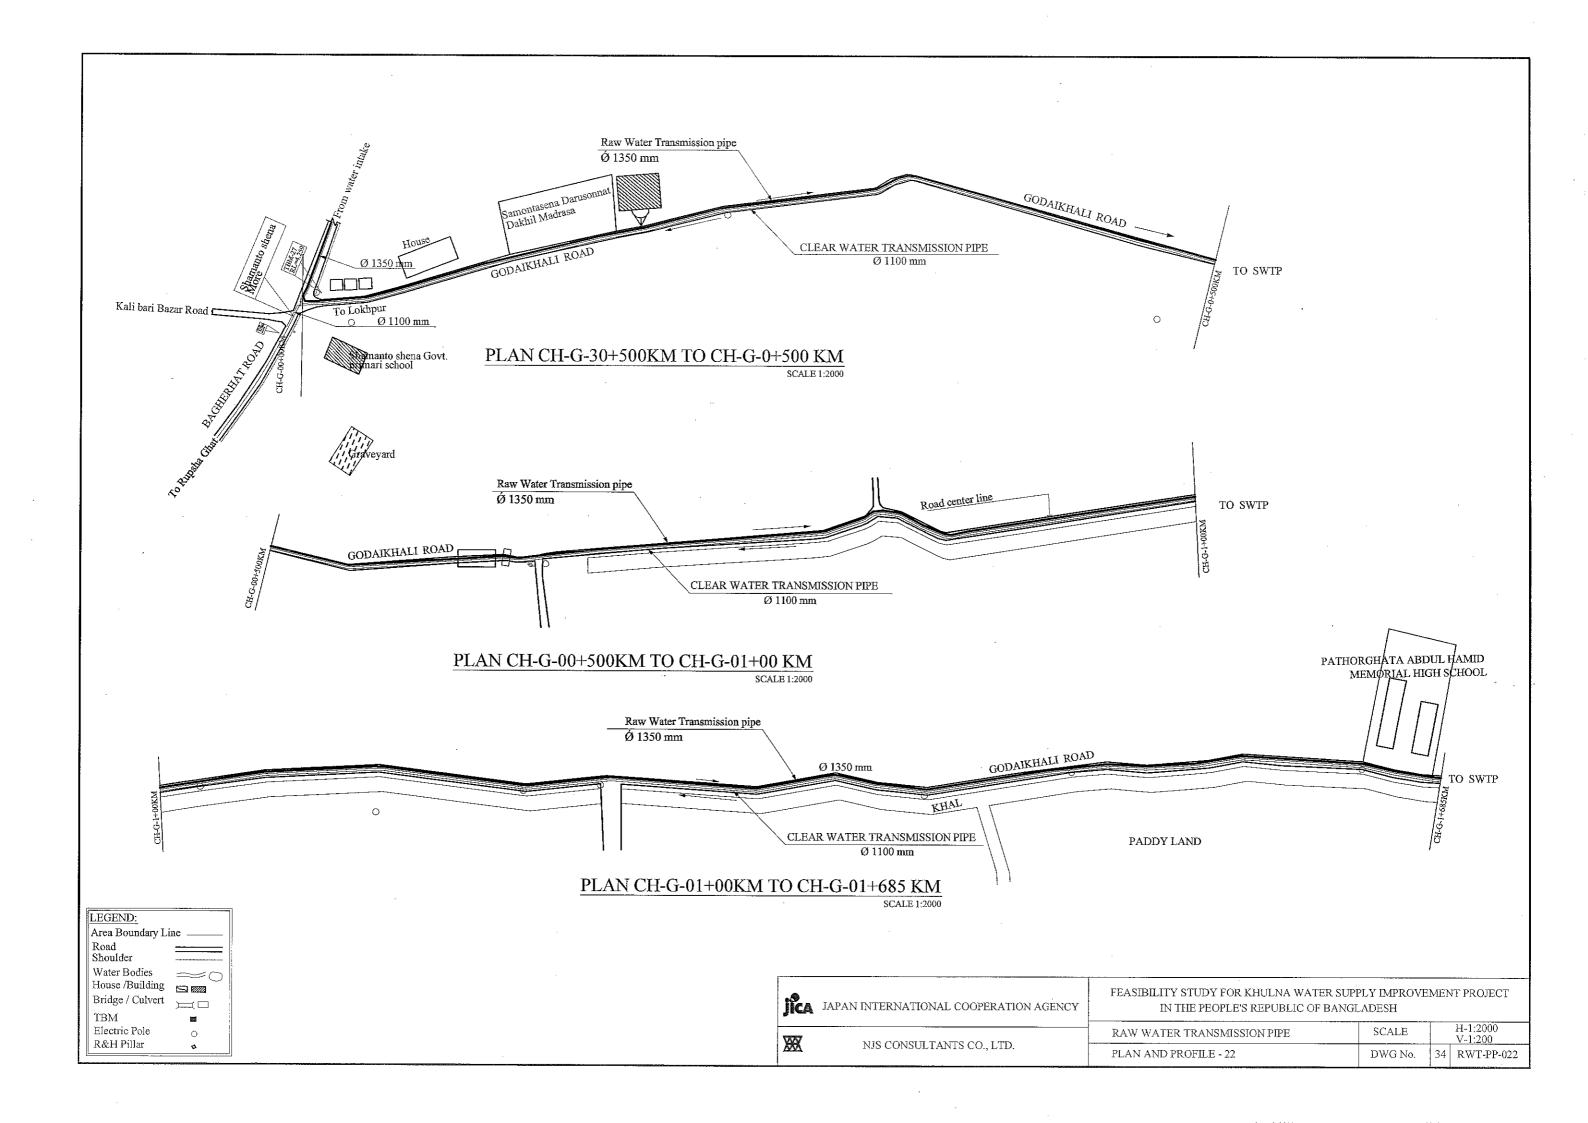

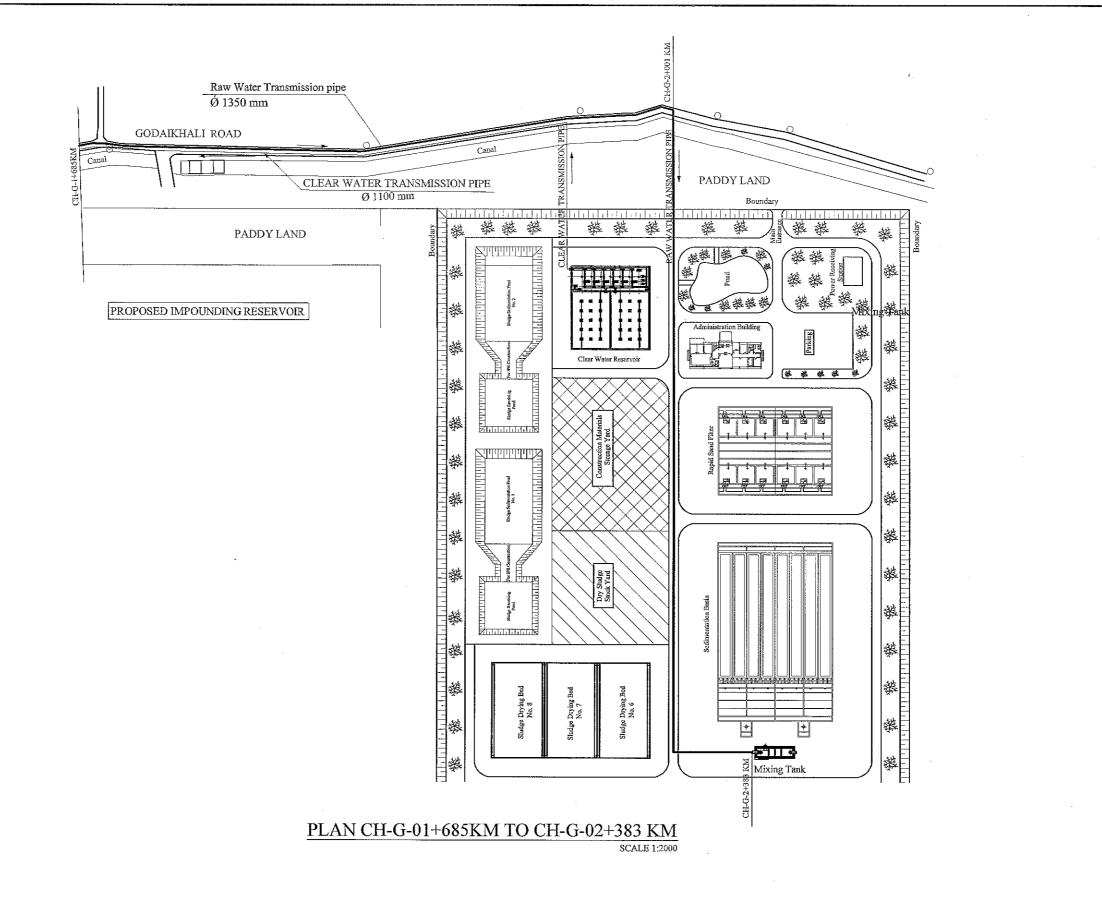

ı	LEGEND:	
	Area Boundary Li	ne
	Road Shoulder	
l	Water Bodies	≈0
ı	House /Building	
	Bridge / Culvert	$\sqsubseteq \Box$
ı	TBM	805
	Electric Pole	0
	R&H Pillar	ه

JAPAN INTERNATIONAL COOPERATION AGENCY


FEASIBILITY STUDY FOR KHULNA WATER SUPPLY IMPROVEMENT PROJECT
IN THE PEOPLE'S REPUBLIC OF BANGLADESH

RAW WATER TRANSMISSION PIPE


SCALE


H-1:2000
V-1:200
PLAN AND PROFILE - 23

DWG No. 35
RWT-PP-023

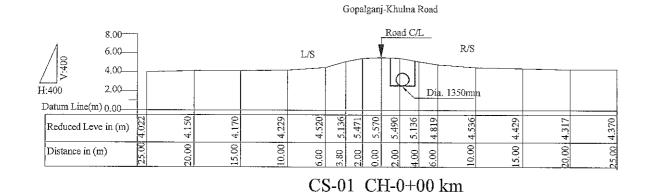



SCALE I:400

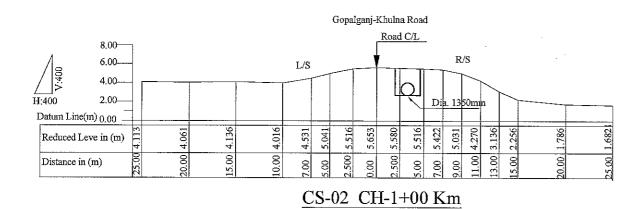


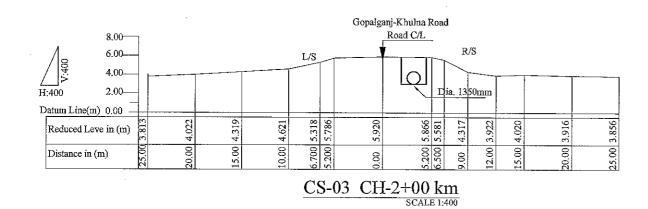



L/S = Left Side R/S = Right Side C/L = Center Line

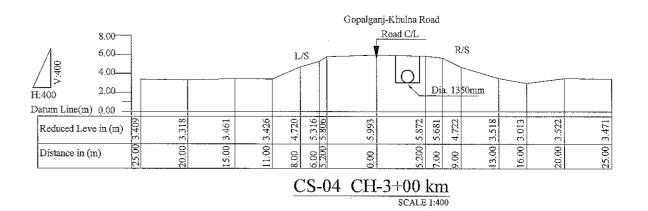


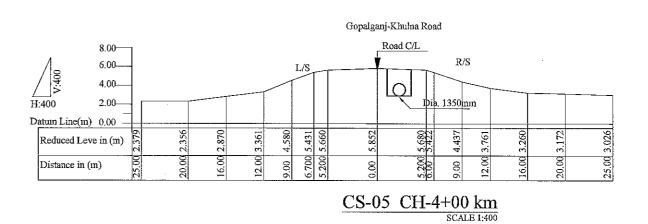


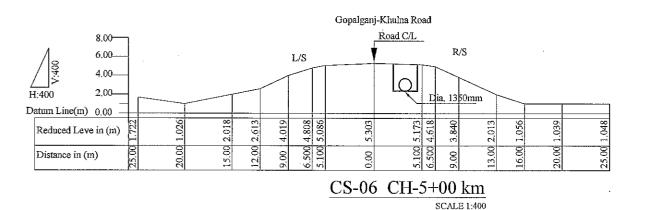

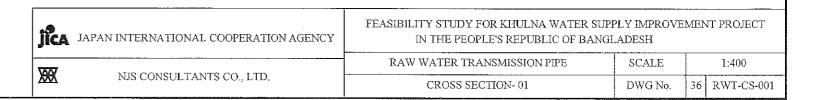

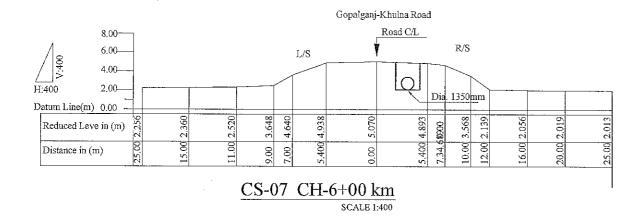


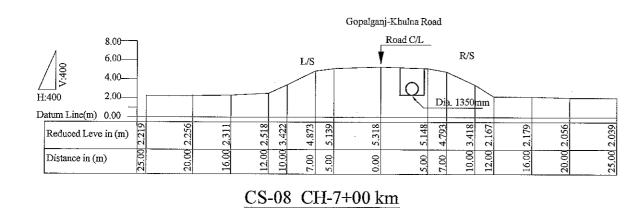

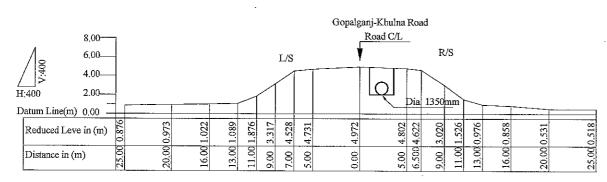





L/S = Left Side R/S = Right Side C/L = Center Line

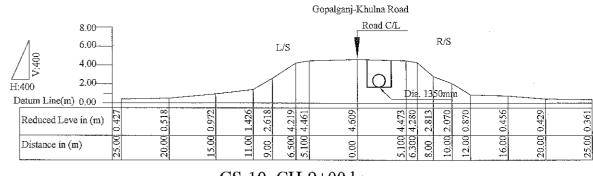


CS-10 CH-9+00 km

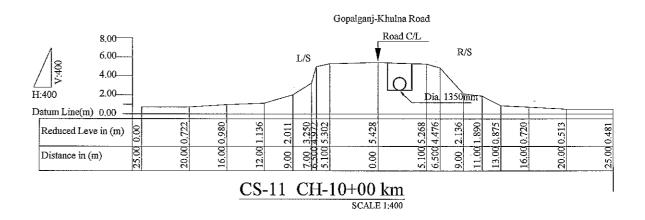

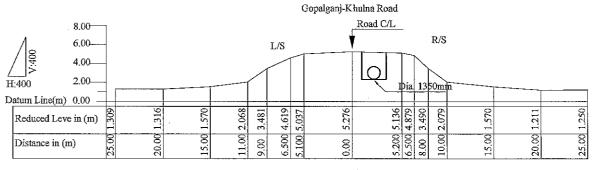


CS-12 CH-11+00 km


jica	JAPAN INTERNATIONAL COOPERATION AGENCY	FEASIBILITY STUDY FOR KHULNA WATER SUPPLY IMPROVEMENT PROJECT IN THE PEOPLE'S REPUBLIC OF BANGLADESH				
7007	NI 00 THE DATE OF THE	RAW WATER TRANSMISSION PIPE	SCALE	1:400		
XX	NJS CONSULTANTS CO., LTD.	CROSS SECTION- 02	DWG No.	37 RWT-CS-002		

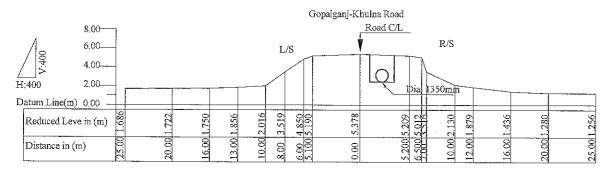

CS-13 CH-12+00 km SCALE 1:400

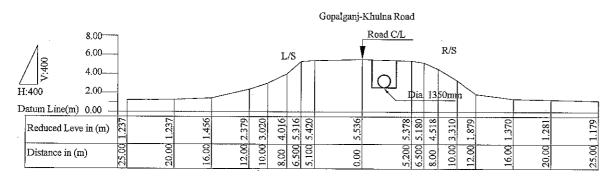


 $\frac{\text{CS-14 CH-13+00 km}}{\text{SCALE 1:400}}$

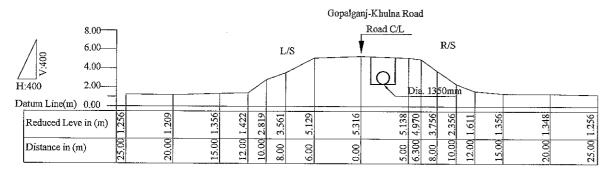


CS-15 CH-14+00 km



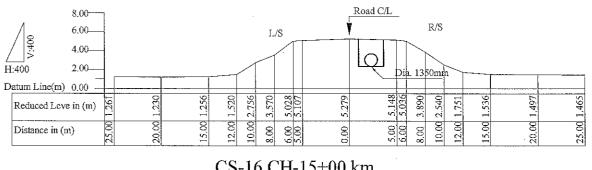


Gopalganj-Khulna Road

CS-16 CH-15+00 km

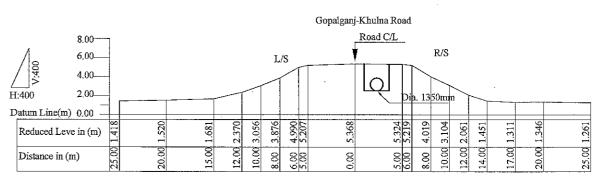



CS-17 CH-16+00 km

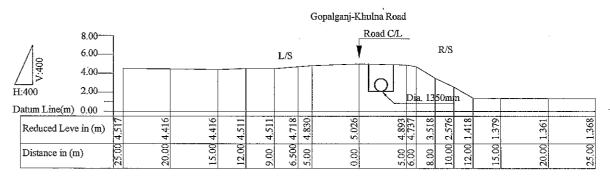


CS-18 CH-17+00 km

JICA	JAPAN INTERNATIONAL COOPERATION AGENCY	FEASIBILITY STUDY FOR KHULNA WATER SUPPLY IMPROVEMENT PROJECT IN THE PEOPLE'S REPUBLIC OF BANGLADESH			
VVV	NYO CONTONY THE CO. LTD.	RAW WATER TRANSMISSION PIPE	SCALE		1:400
XX	NJS CONSULTANTS CO., LTD.	· CROSS SECTION 03	DWG No.	38	RWT-CS-003

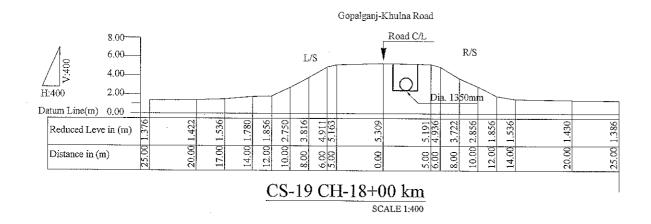


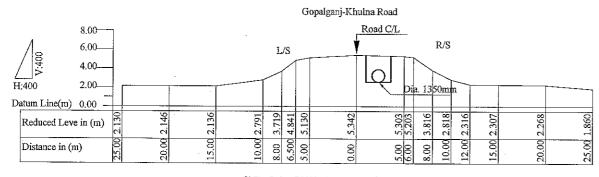


CS-20 CH-19+00 km SCALE 1:400

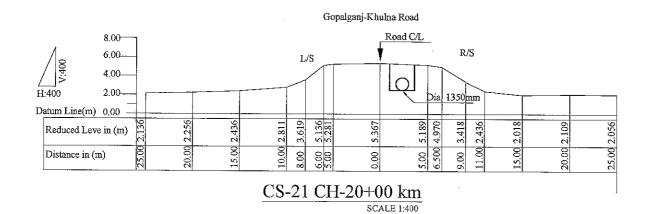


L/S = Left Side R/S = Right Side C/L = Center Line

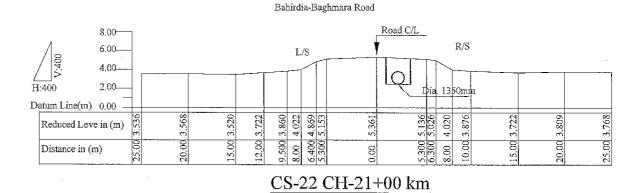

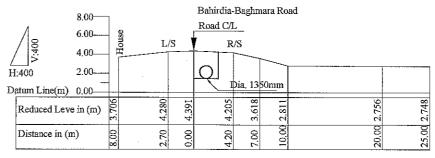



CS-23 CH-22+00 km

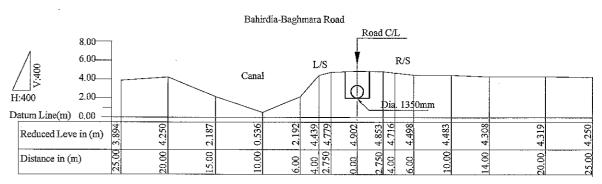


CS-24 CH-23+00 Km

jica	JAPAN INTERNATIONAL COOPERATION AGENCY	FEASIBILITY STUDY FOR KHULNA WATER SUPPLY IMPROVEMENT PROJECT IN THE PEOPLE'S REPUBLIC OF BANGLADESH				
707		RAW WATER TRANSMISSION PIPE	SCALE	1:400		
XX	NJS CONSULTANTS CO., LTD.	CROSS SECTION 04	DWG No.	39 RWT-CS-004		

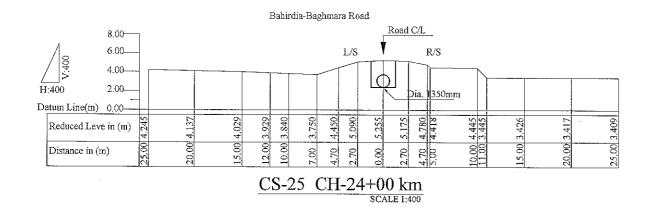


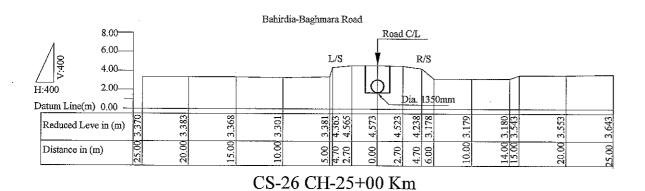

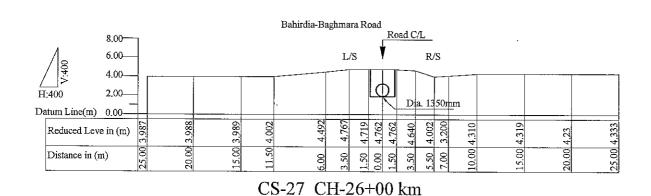


SCALE 1;400




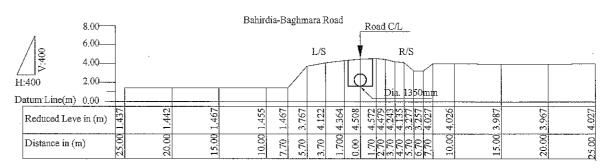

CS-28 CH-27+00 Km

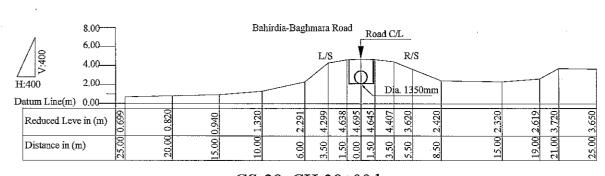


CS-29 CH-28+00 km SCALE 1:400

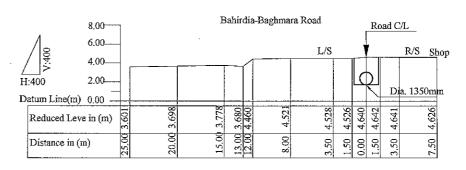

CS-30 CH-29+00 Km

FEASIBILITY STUDY FOR KHULNA WATER SUPPLY IMPROVEMENT PROJE IN THE PEOPLE'S REPUBLIC OF BANGLADESH					T PROJECT
7887		RAW WATER TRANSMISSION PIPE	SCALE		1:400
***	NJS CONSULTANTS CO., LTD.	CROSS SECTION 05	DWG No.	40	RWT-CS-005

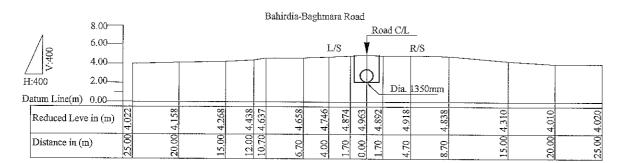


 $\frac{\text{CS-31 CH-30+00 km}}{\text{\tiny SCALE 1:400}}$


L/S = Left Side


R/S = Right Side


C/L = Center Line

jica	JAPAN INTERNATIONAL COOPERATION AGENCY	FEASIBILITY STUDY FOR KHULNA WATER SUPPLY IMPROVEMENT PROJECT IN THE PEOPLE'S REPUBLIC OF BANGLADESH			
XX	NIC CONCLUTANTS CO. LTD	RAW WATER TRANSMISSION PIPE	SCALE		1:400
∆ ∑∑ \	NJS CONSULTANTS CO., LTD.	CROSS SECTION 06	DWG No.	41	RWT-CS-006

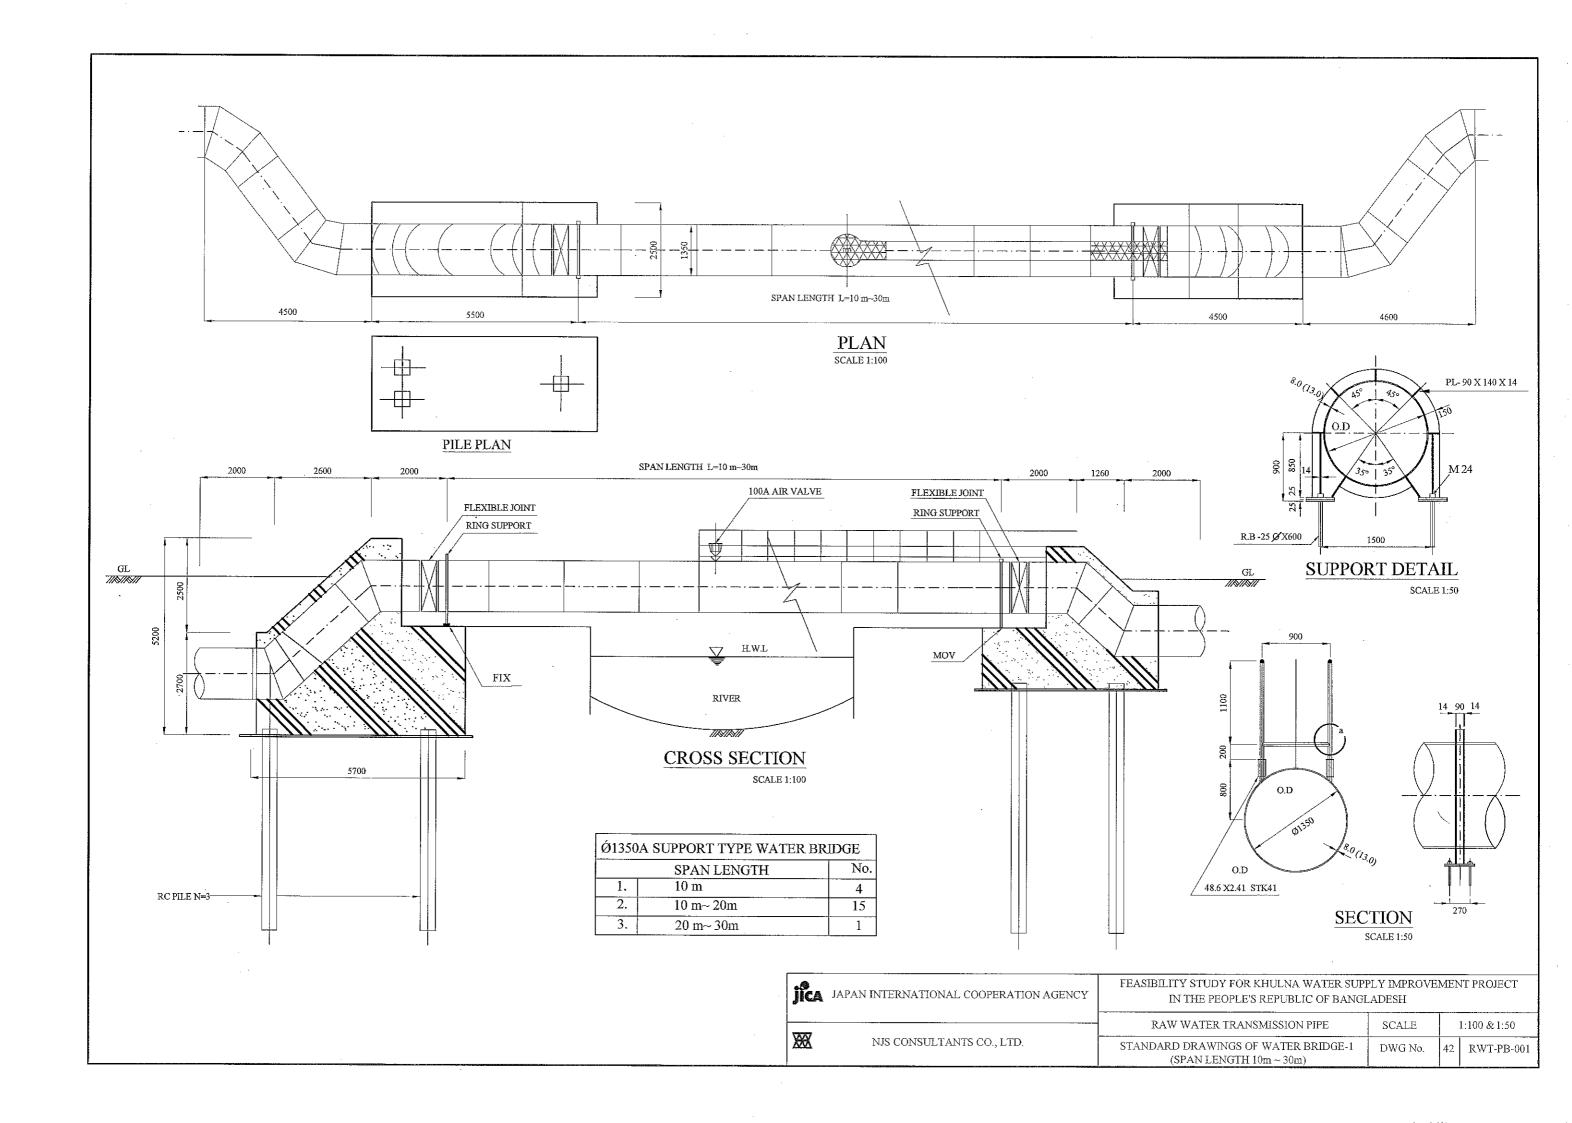


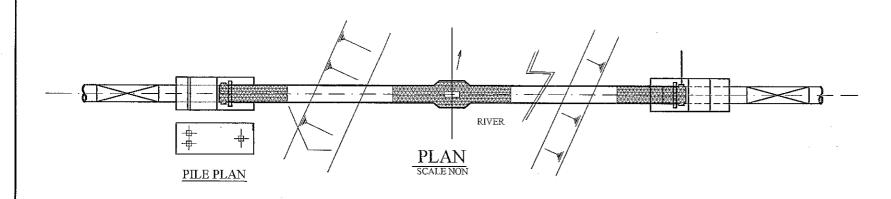


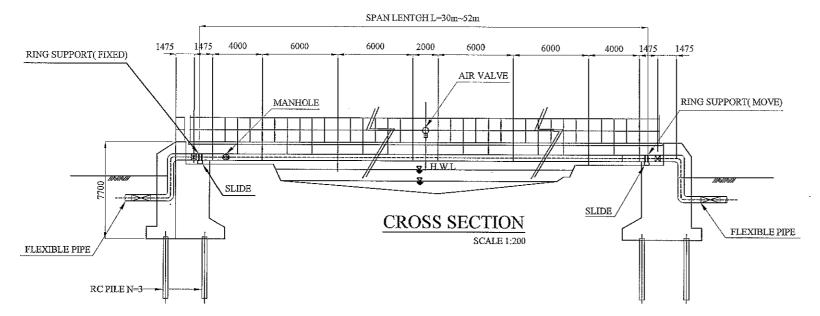

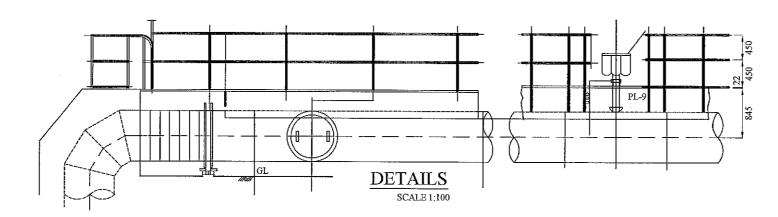


Ø1350A SUPPORT TYPE WATER BRIDGE						
	Span length	No.				
1.	30 m~ 40m	3				
2.	40 m∼ 50m	2				
3.	50 m∼ 52m	1				

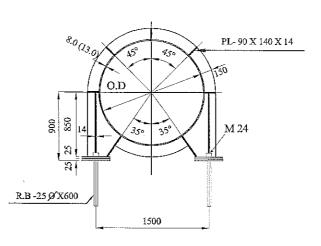

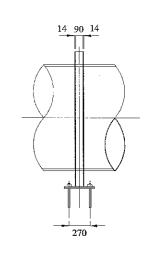

SUPPORT DETAIL

SCALE 1:50

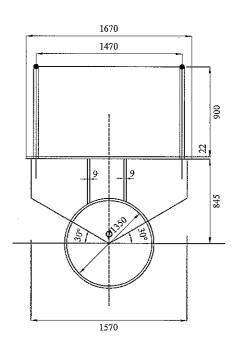

SECTION SCALE 1:50

jica


JAPAN INTERNATIONAL COOPERATION AGENCY


FEASIBILITY STUDY FOR KHULNA WATER SUPPLY IMPROVEMENT PROJECT IN THE PEOPLE'S REPUBLIC OF BANGLADESH


翠

NJS CONSULTANTS CO., LTD.


1:200, 1:100 &1:50 RAW WATER TRANSMISSION PIPE SCALE STANDARD DRAWINGS FOR WATER BRIDGE-2 (SPAN LENGTH 30m~52m) 43 RWT-PB-002 DWG No.

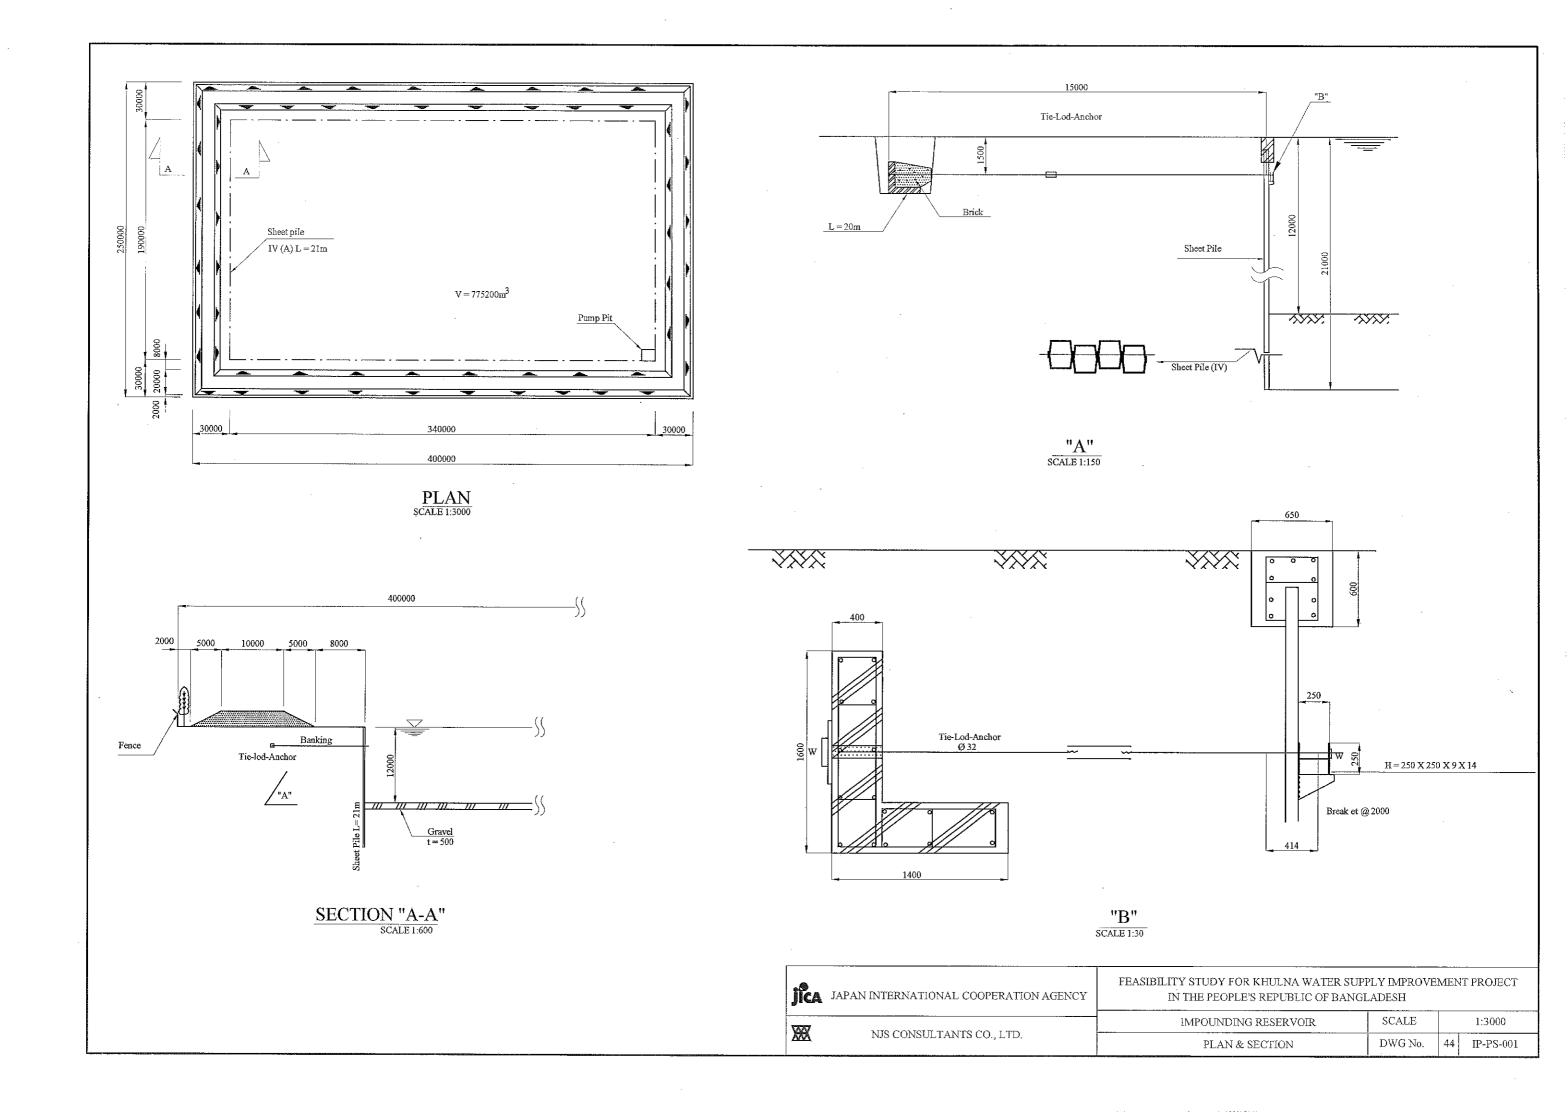


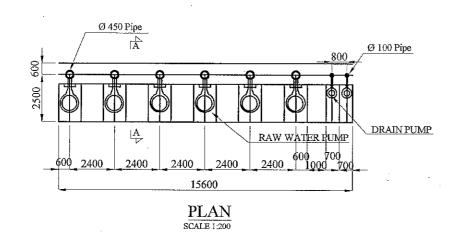

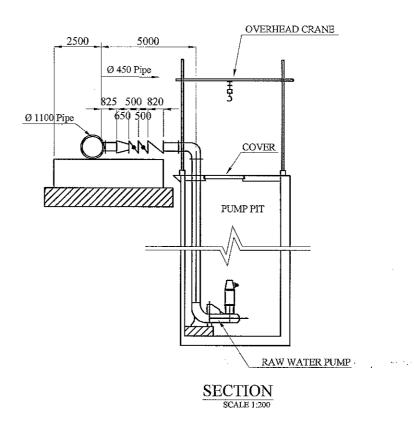

jica	JAPAN INTERNATIONAL COOPERATION AGENCY	FEASIBILITY STUDY FOR KHULNA WATER SUPPLY IMPROVEMENT PROJECT IN THE PEOPLE'S REPUBLIC OF BANGLADESH			
VAV	AND CONCLUENCE OF A CONC	IMPOUNDING RESERVOIR	SCALE	SCALE 1:200	
XX	NJS CONSULTANTS CO., LTD.	PUMP PIT PLAN & SECTION	DWG No.	45 IP-PS-002	

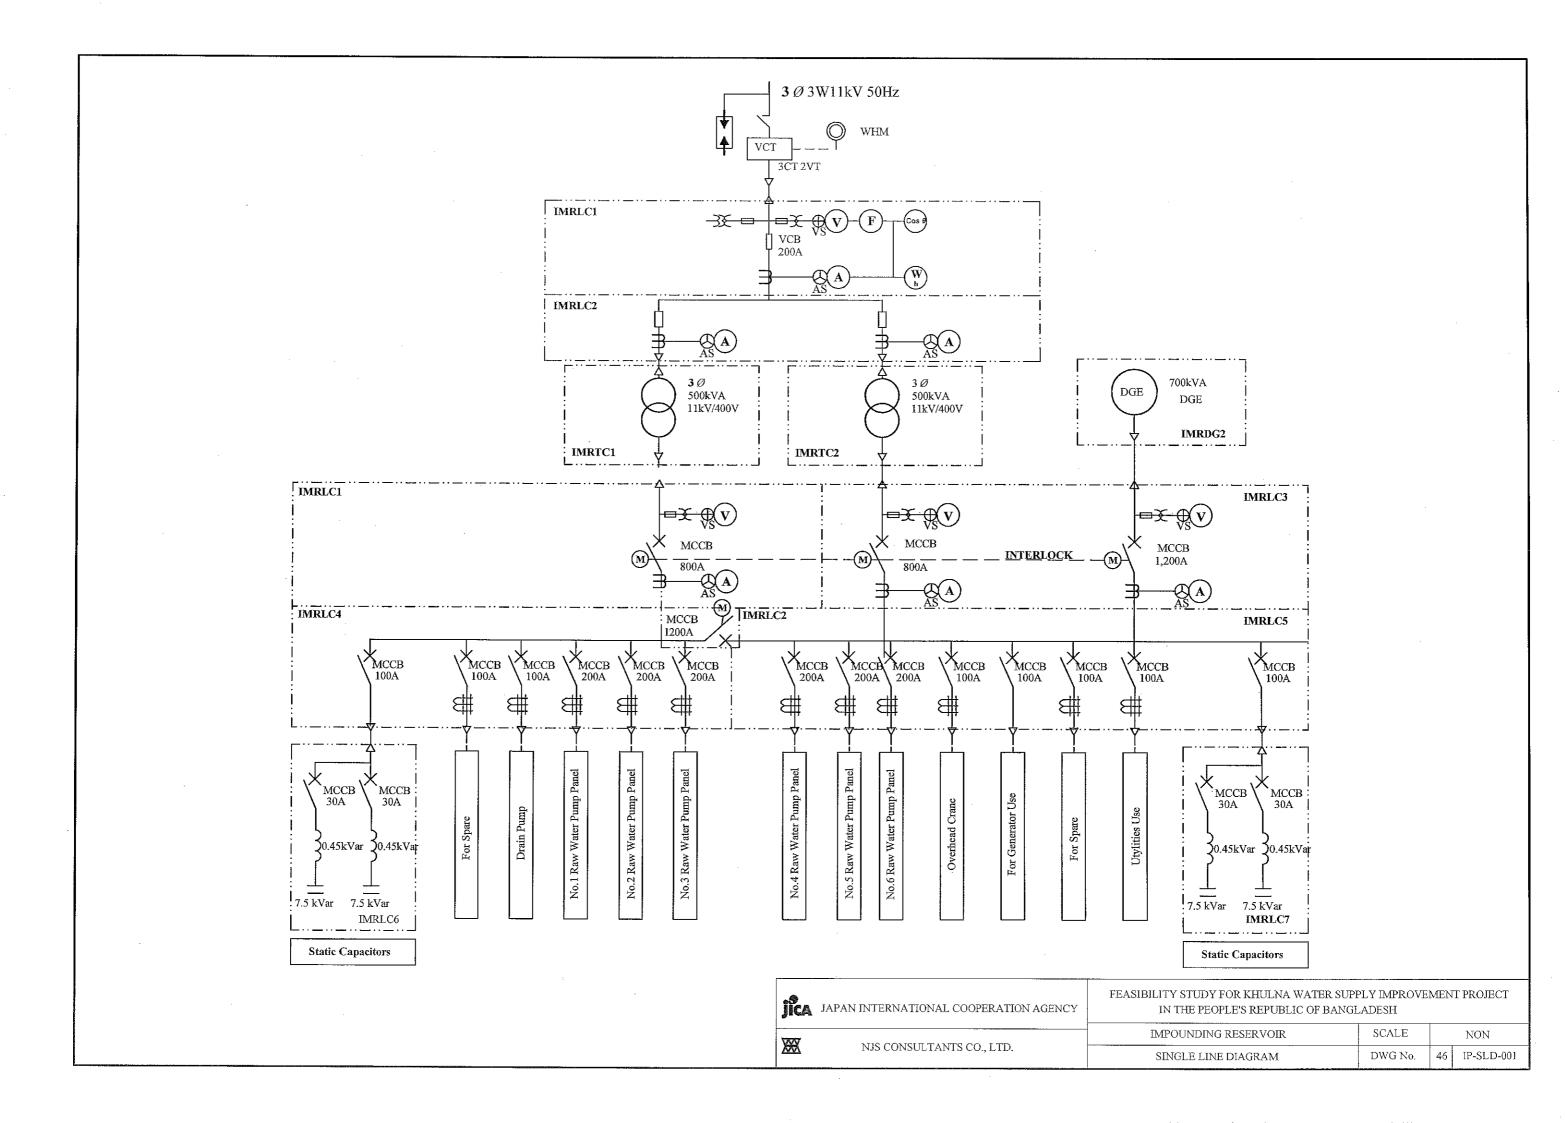


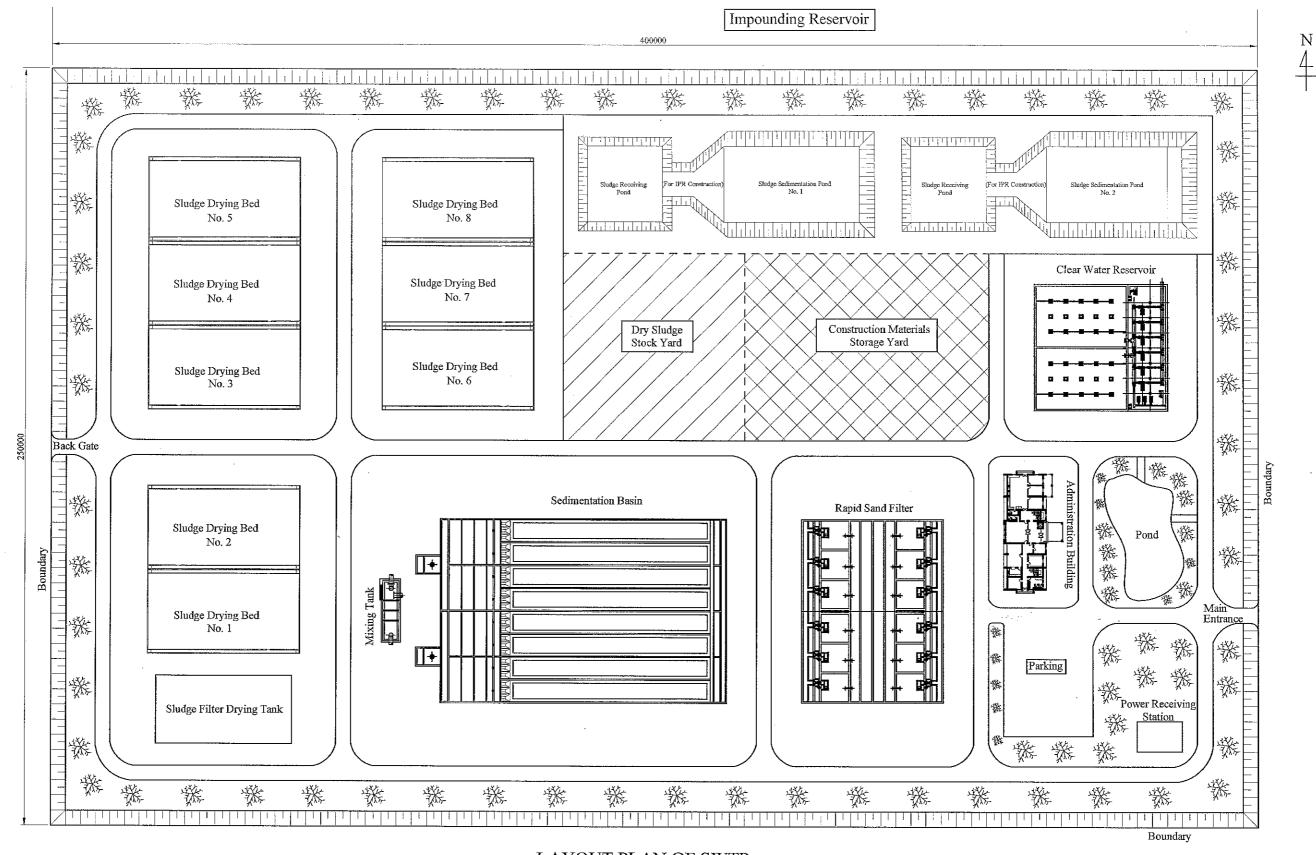

LAYOUT PLAN OF SWTP

SCALE 1:1250


jica	JAPAN INTERNATIONAL COOPERATION AGENCY	FEASIBILITY STUDY FOR KHULNA WATER SUPPLY IMPROVEMENT PROJECT IN THE PEOPLE'S REPUBLIC OF BANGLADESH					
7877		SURFACE WATER TREATMENT PLANT	SCALE		1:1250		
XX	NJS CONSULTANTS CO., LTD.	LAYOUT PLAN (UP TO YEAR 2025)	DWG No.	47	SWTP-G-001		

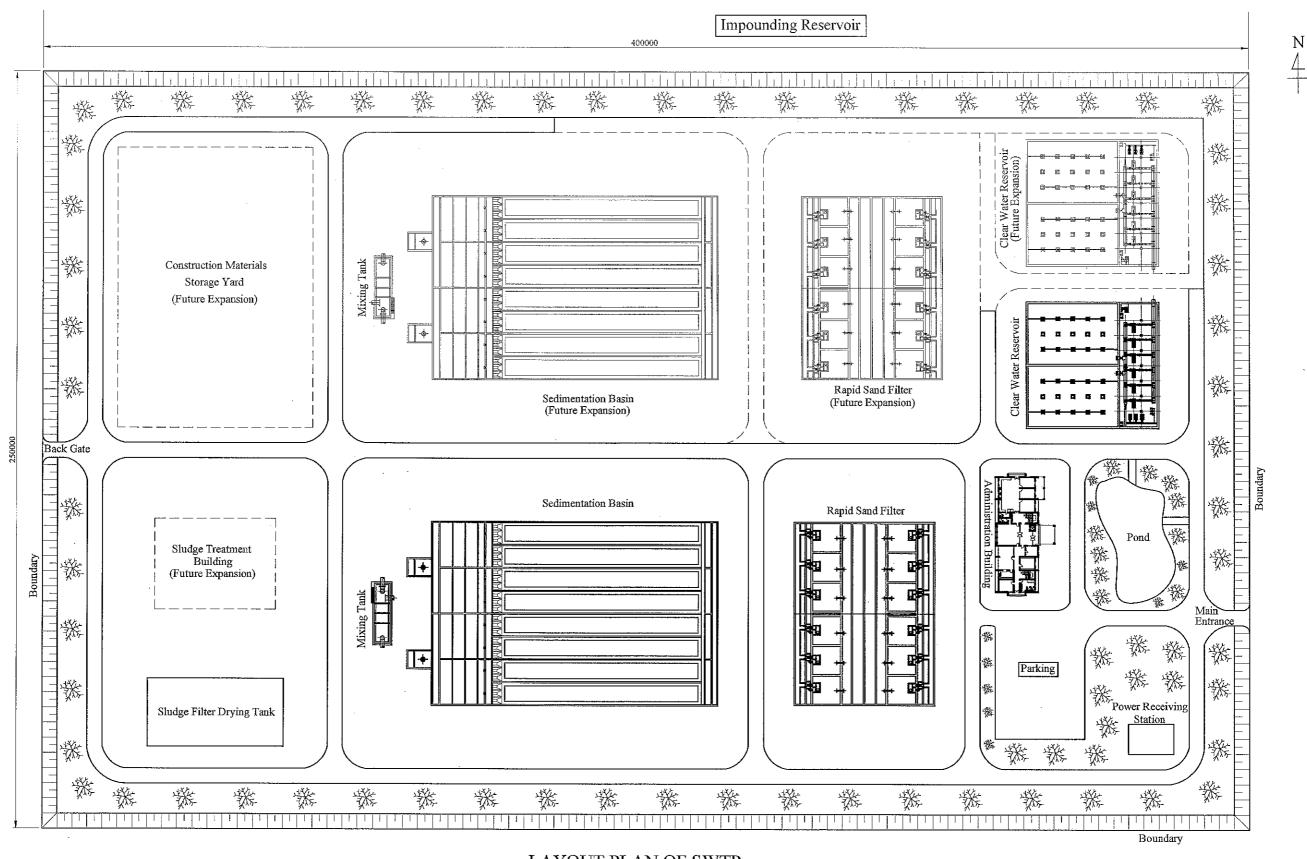



LAYOUT PLAN OF SWTP


SCALE 1:1250

jica	JAPAN INTERNATIONAL COOPERATION AGENCY	FEASIBILITY STUDY FOR KHULNA WATER SUPPLY IMPROVEMENT PROJECT IN THE PEOPLE'S REPUBLIC OF BANGLADESH			
7577	170 001 01 T 1 T 1 T 1 T 1 T 1 T 1 T 1 T 1	SURFACE WATER TREATMENT PLANT	SCALE		1:1250
XX	NJS CONSULTANTS CO., LTD.	LAYOUT PLAN (AFTER YEAR 2025)	DWG No.	48	SWTP-G-002

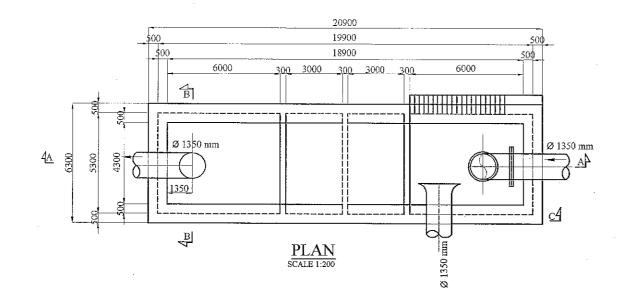

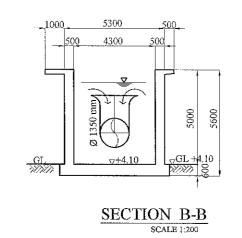


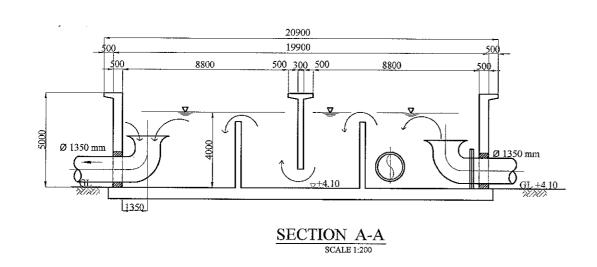


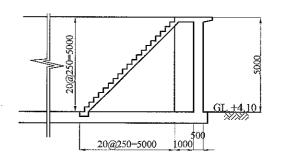



 $\frac{\text{SECTION C-C}}{\text{SCALE 1;200}}$


jica	JAPAN INTERNATIONAL COOPERATION AGENCY	FEASIBILITY STUDY FOR KHULNA WATER SUPPLY IMPROVEMENT PROJECT IN THE PEOPLE'S REPUBLIC OF BANGLADESH				
XX	NIO CONOLI MANTO COLI I TO	SURFACE WATER TREATMENT PLANT	SCALE		1:200	
AAA	NJS CONSULTANTS CO., LTD.	MIXING TANK PLAN & SECTION	DWG No.	49	SWTP-MT-001	

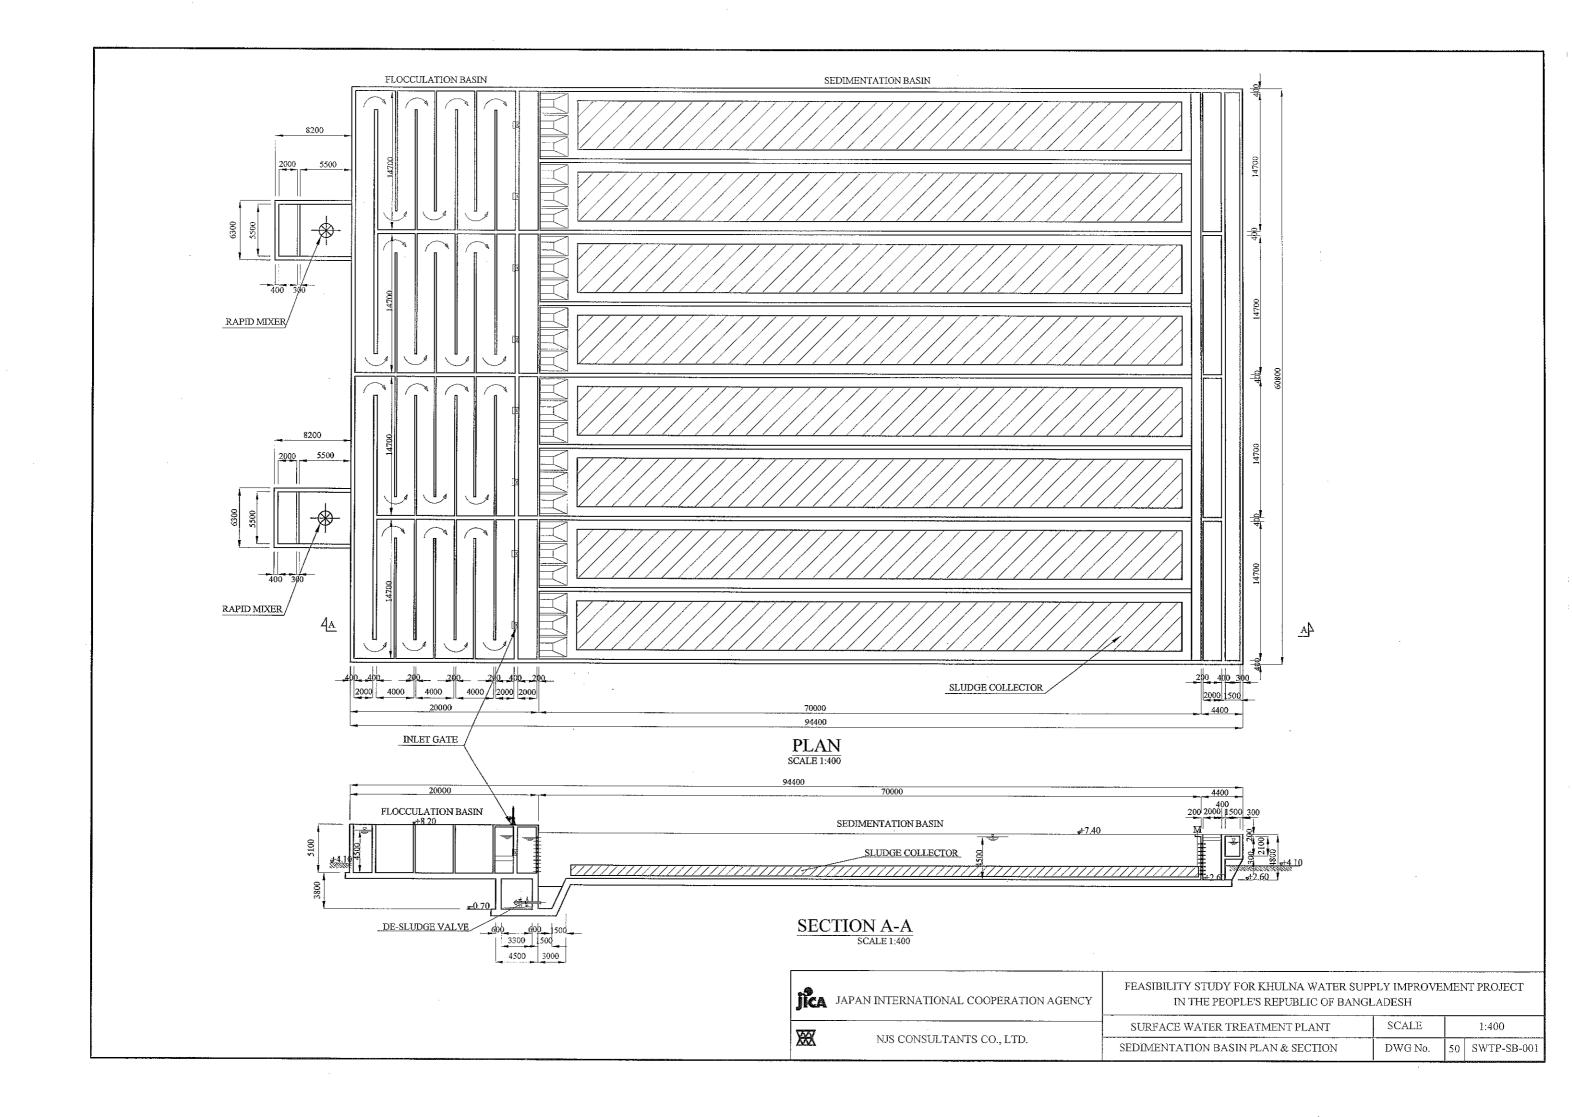


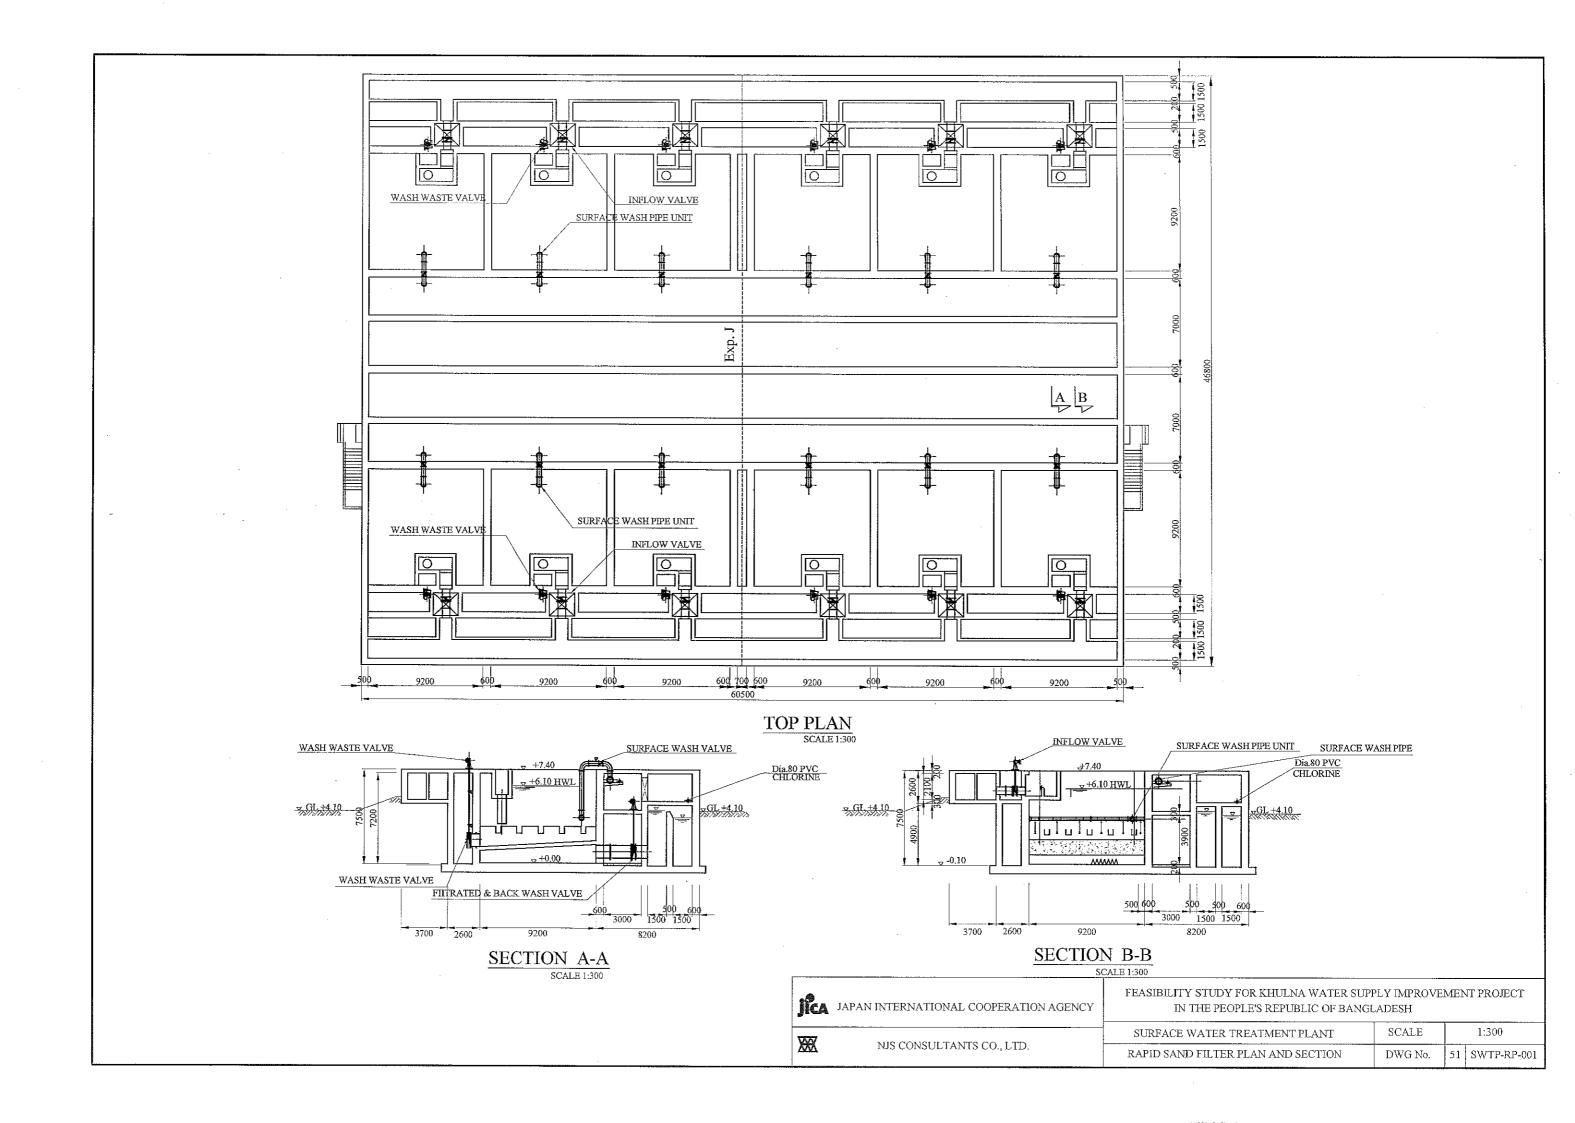


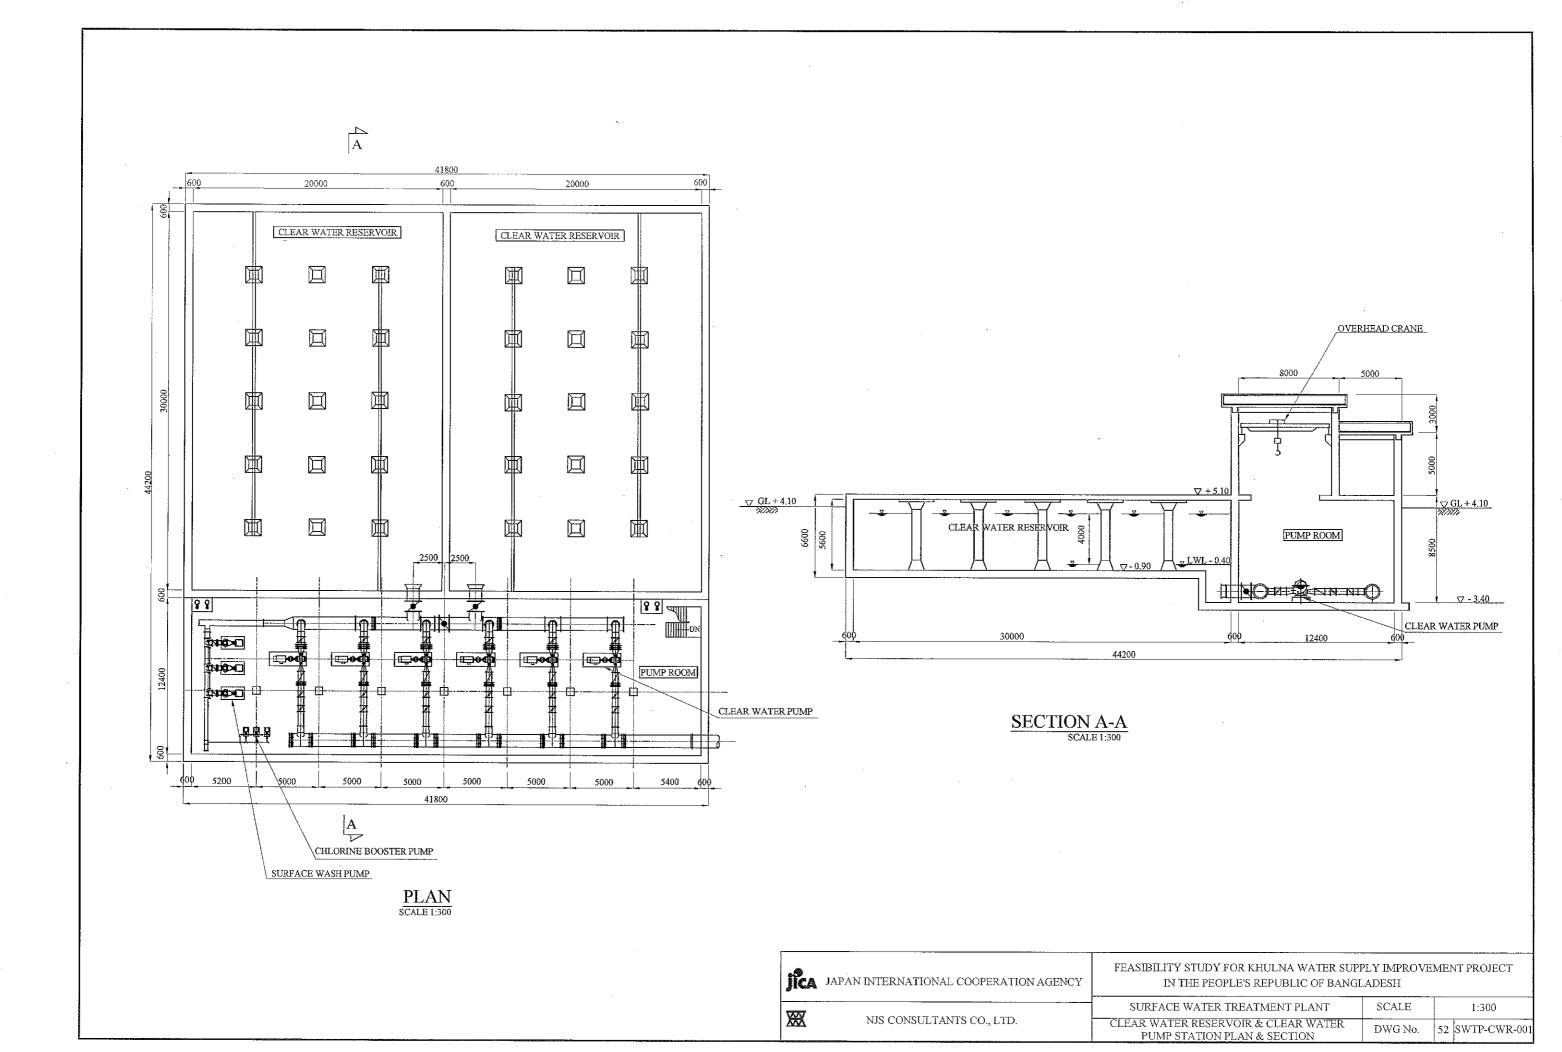


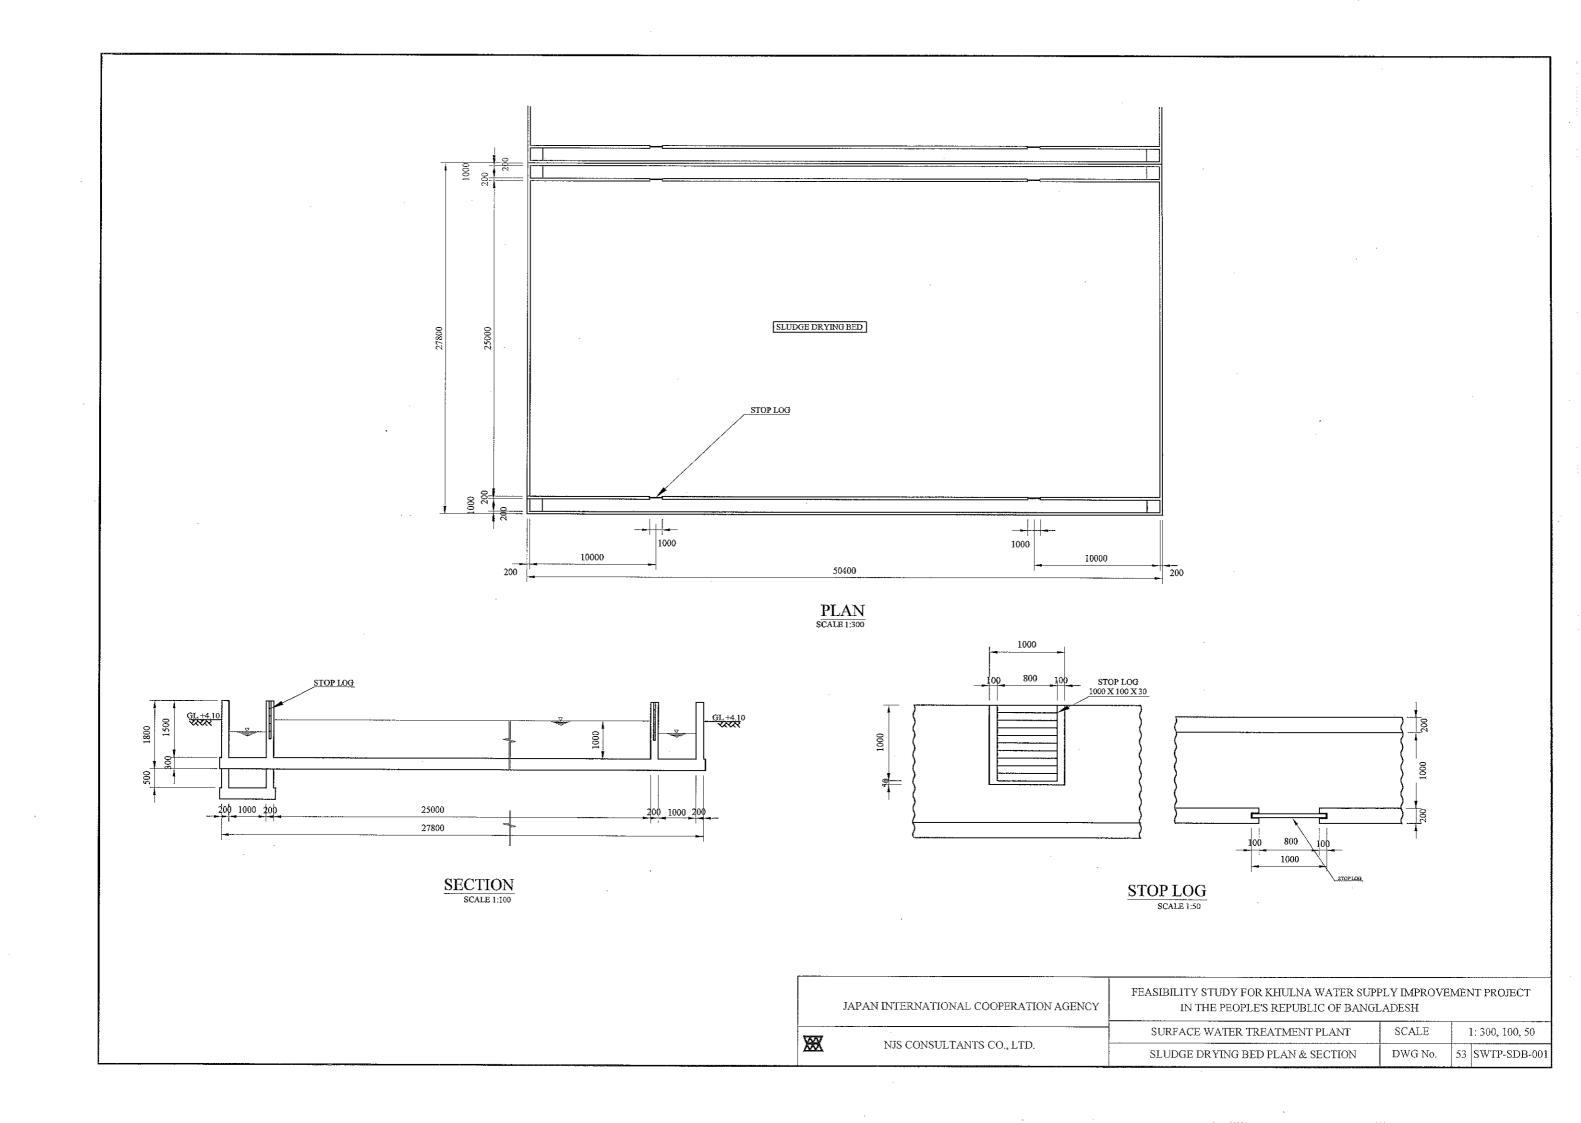


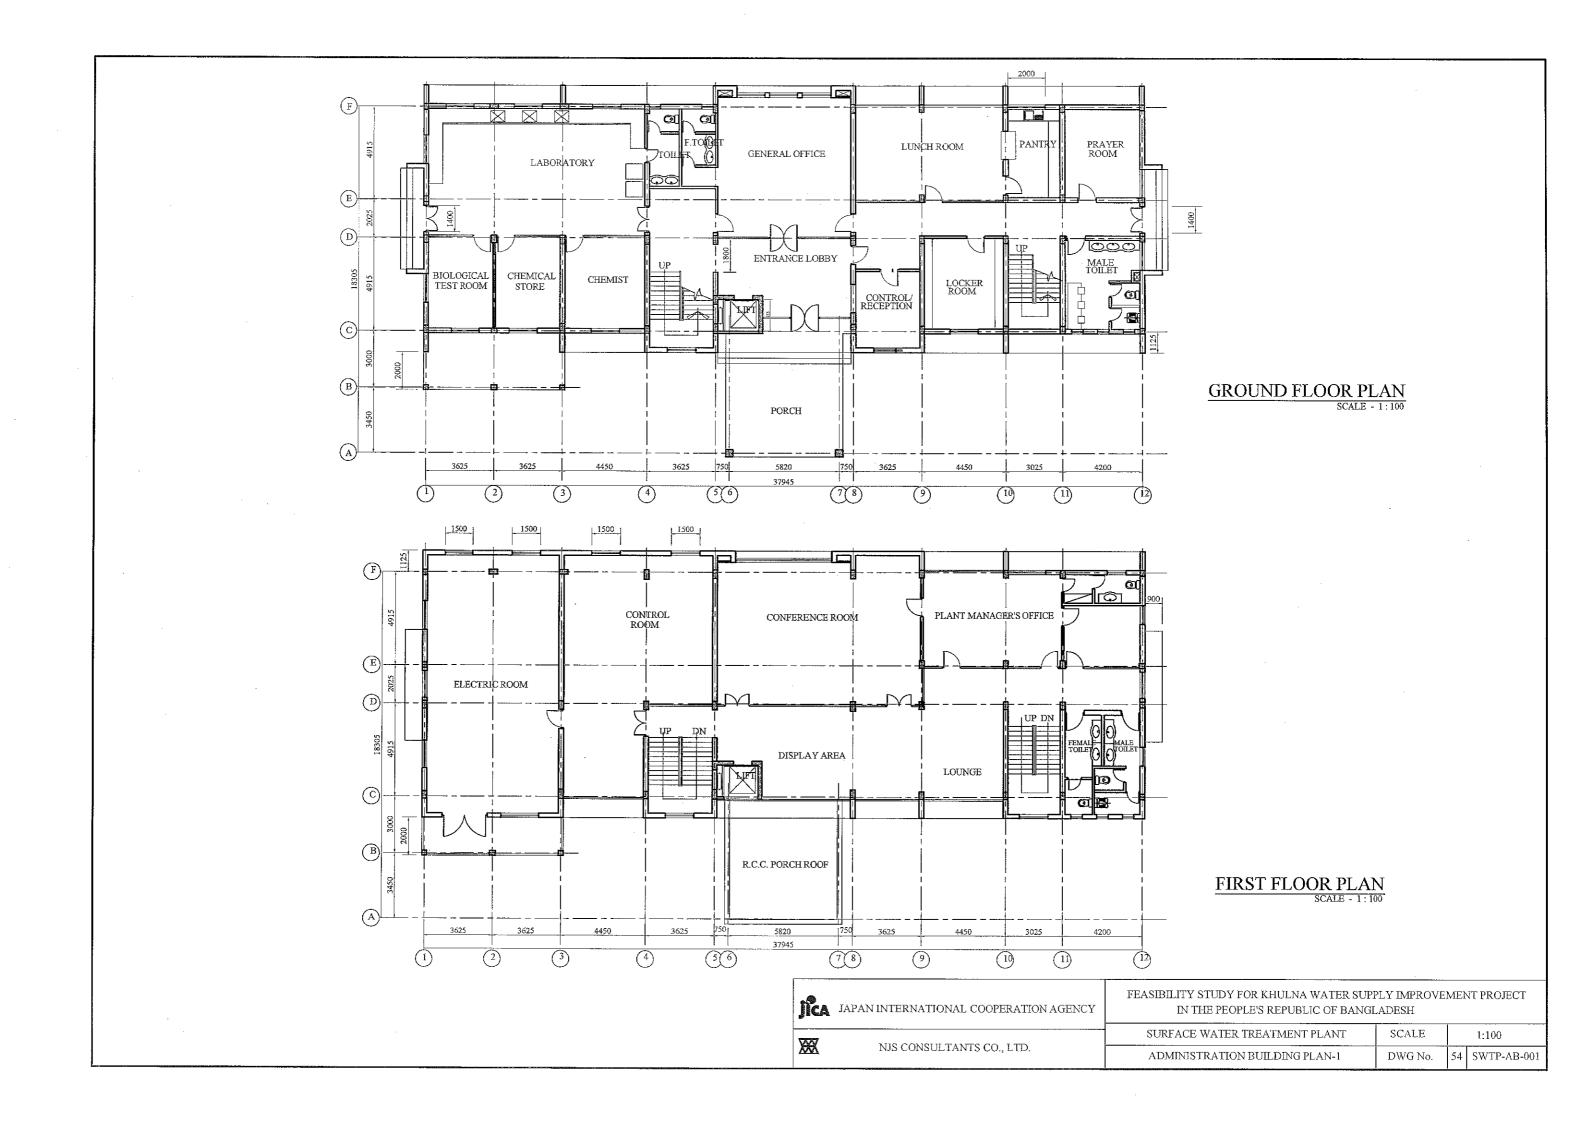


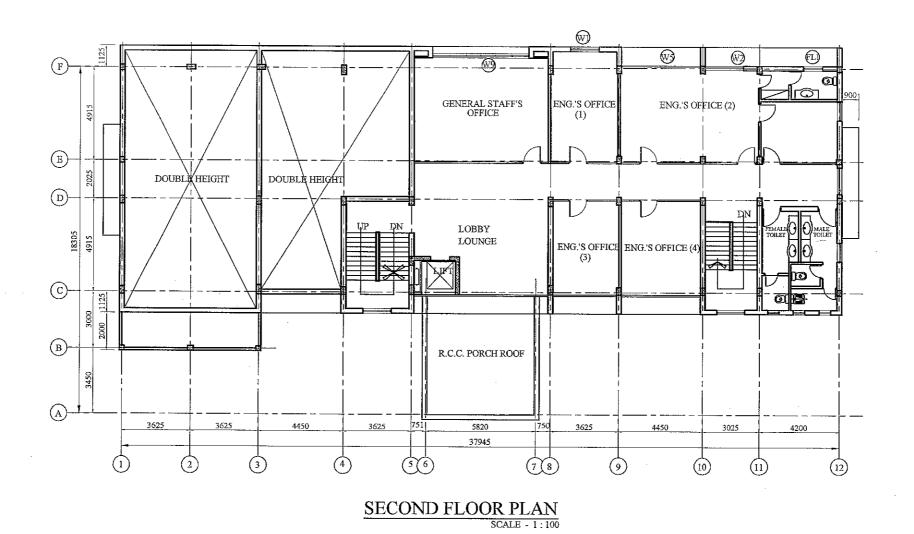


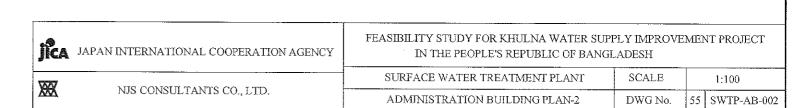


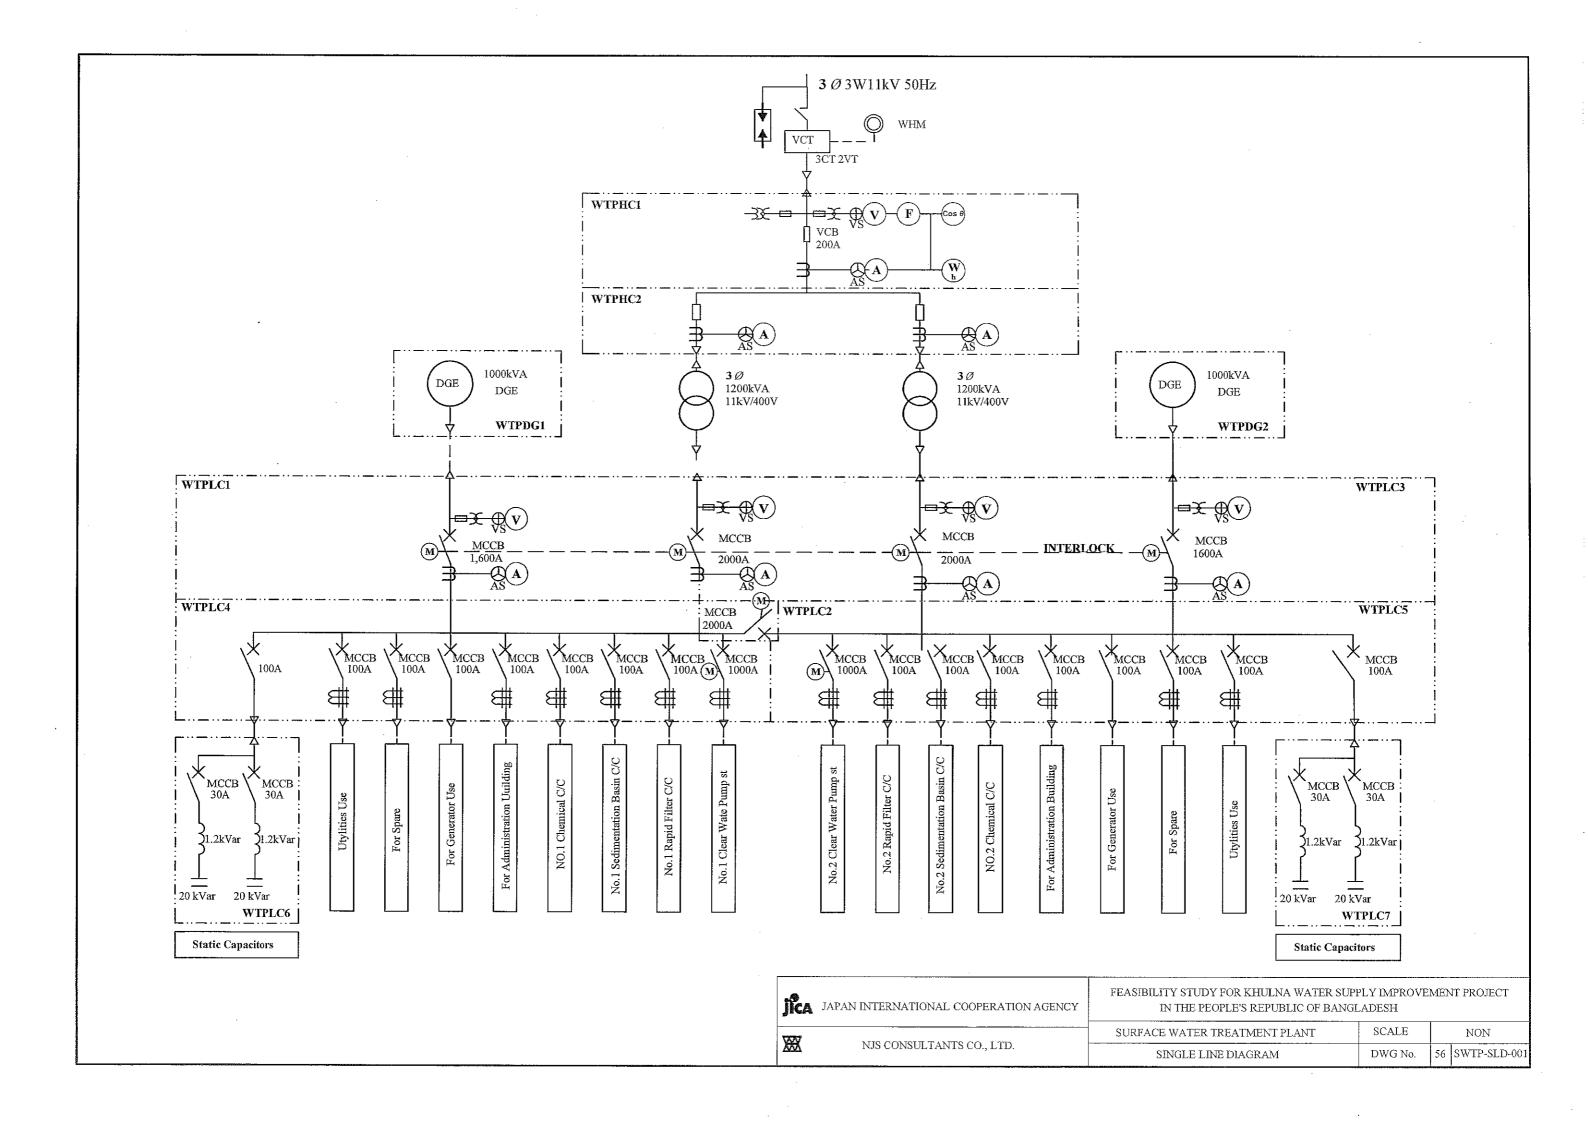


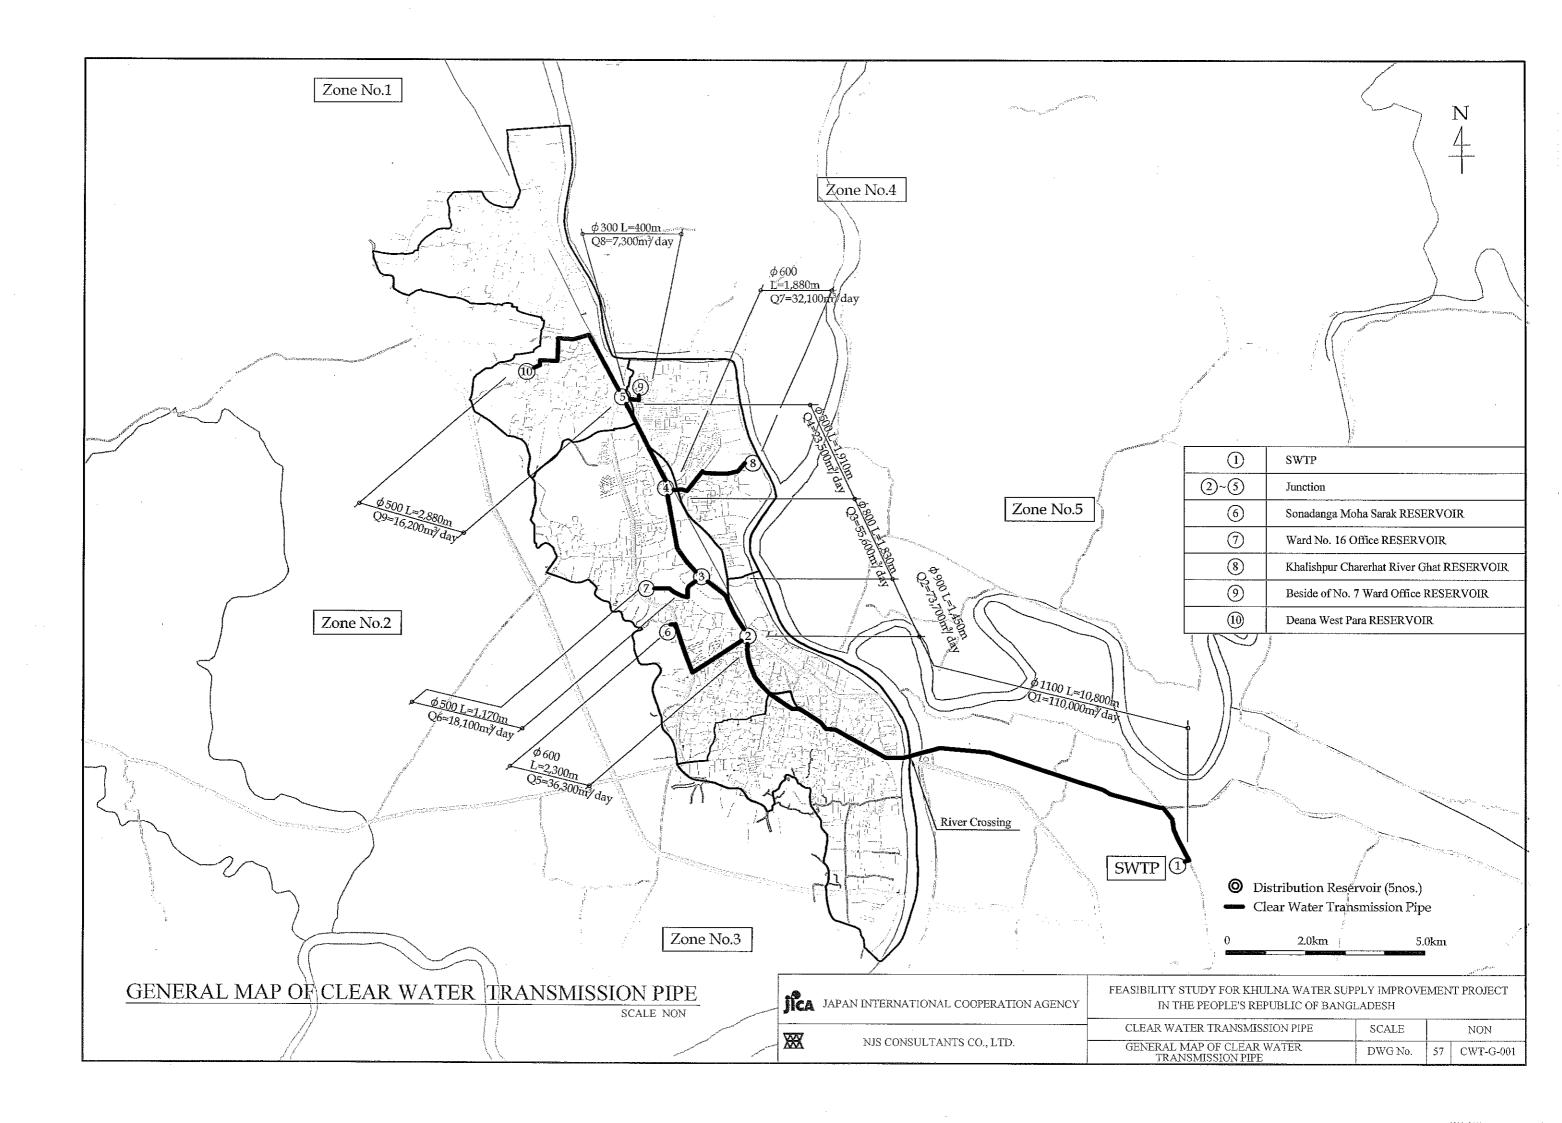


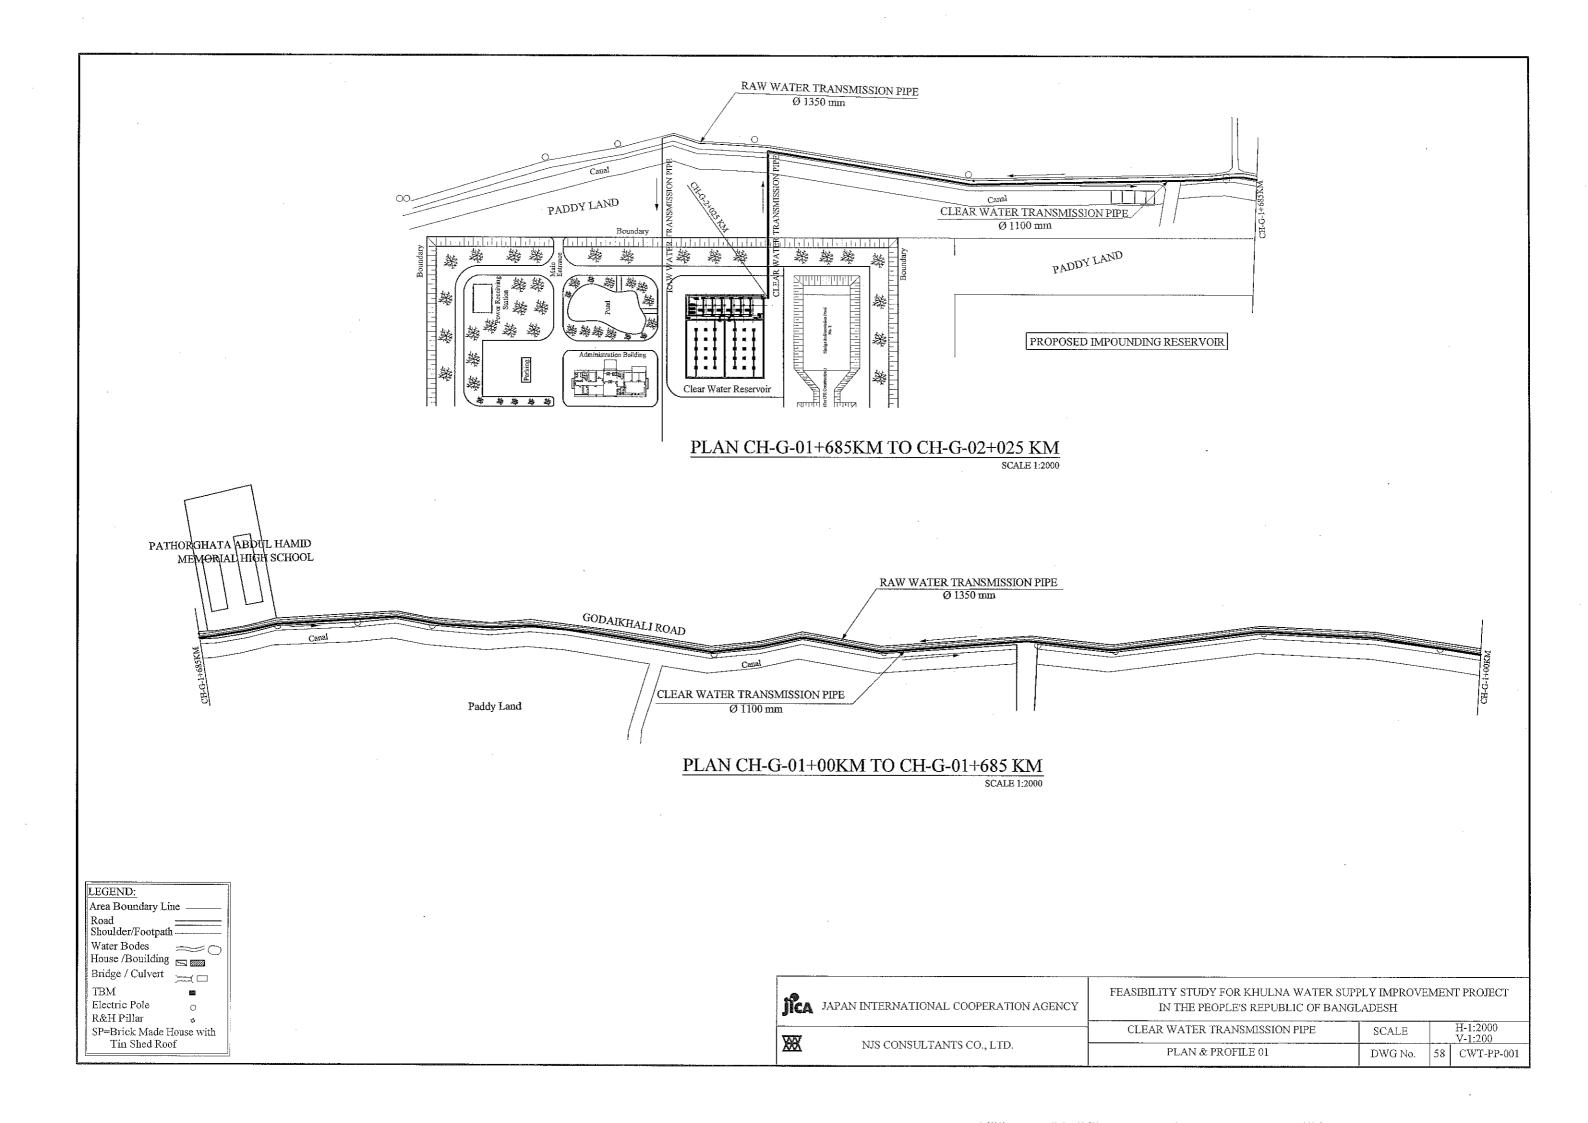


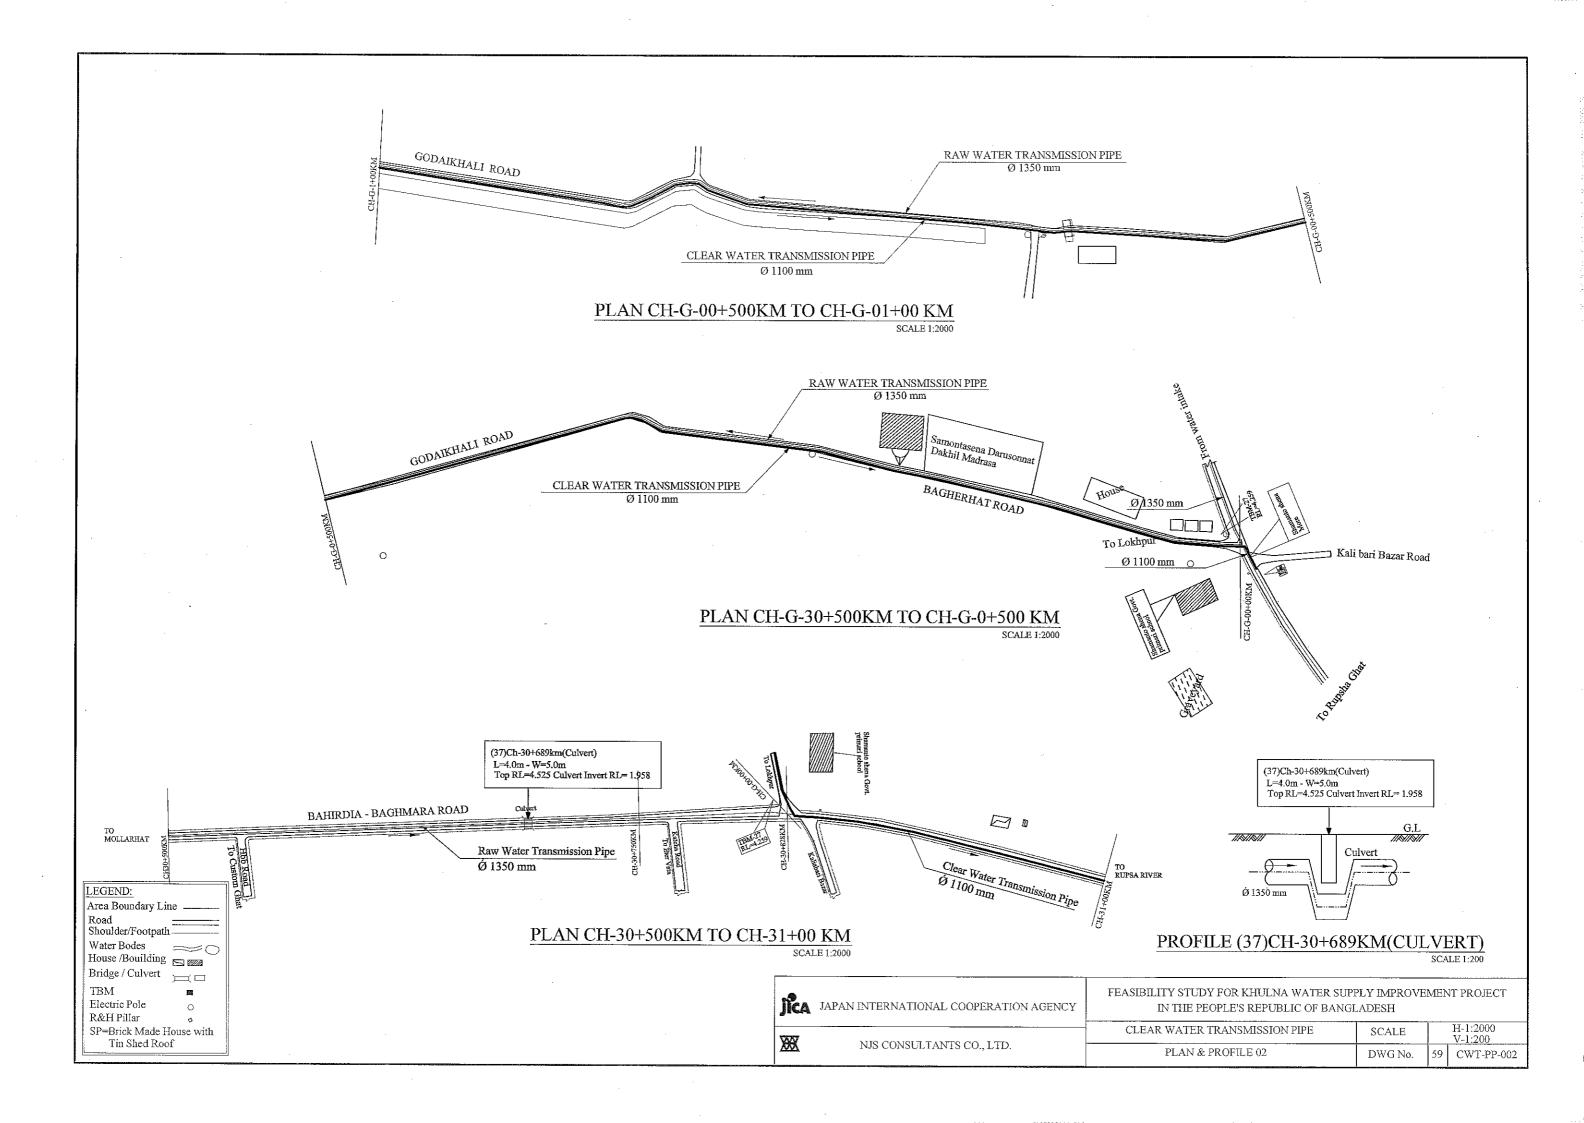


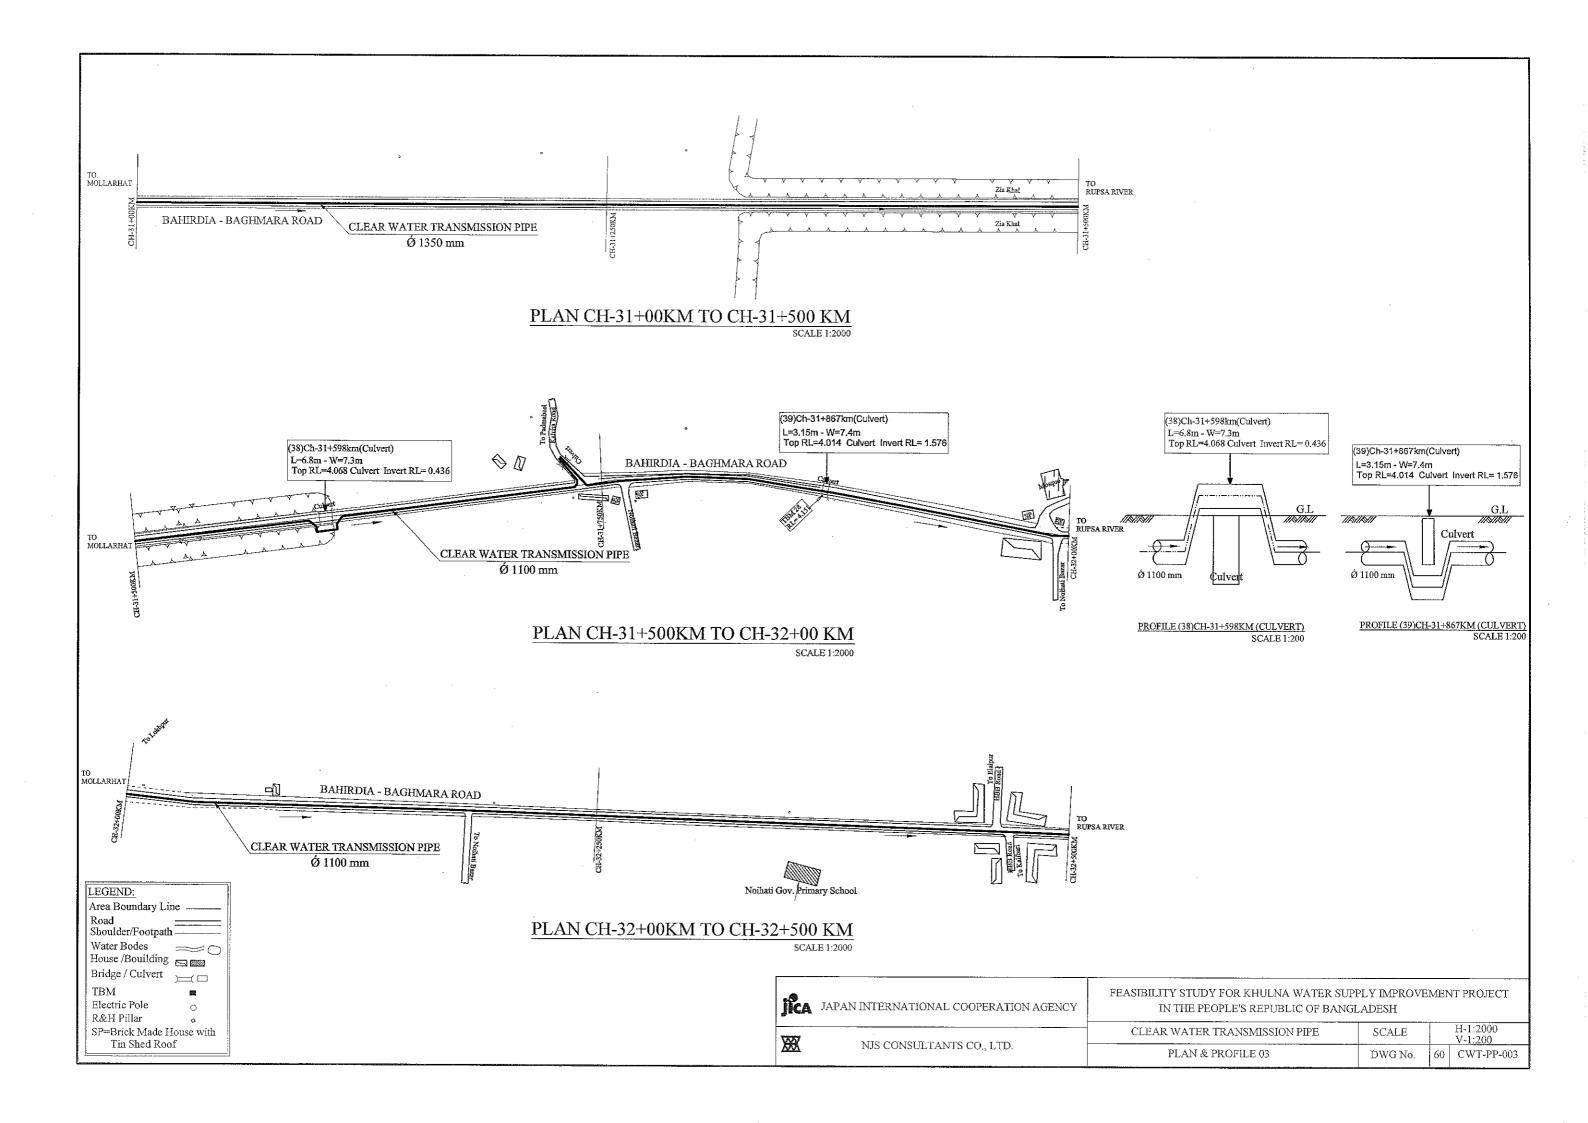


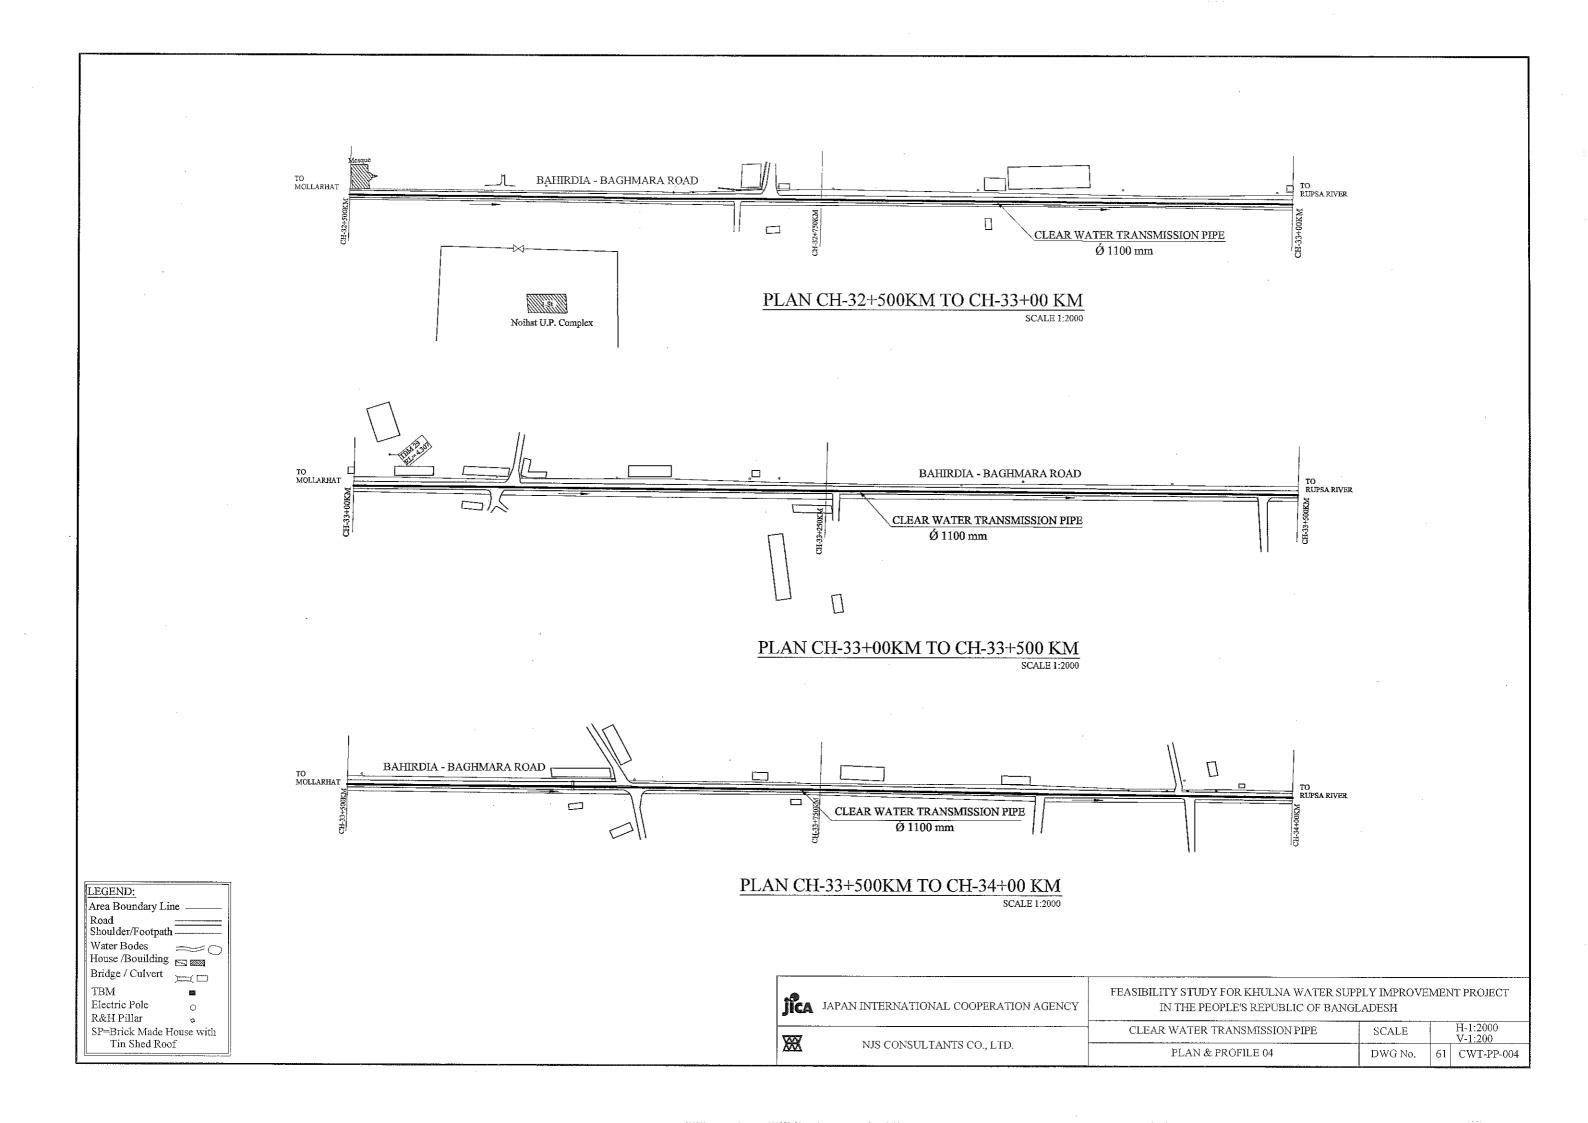


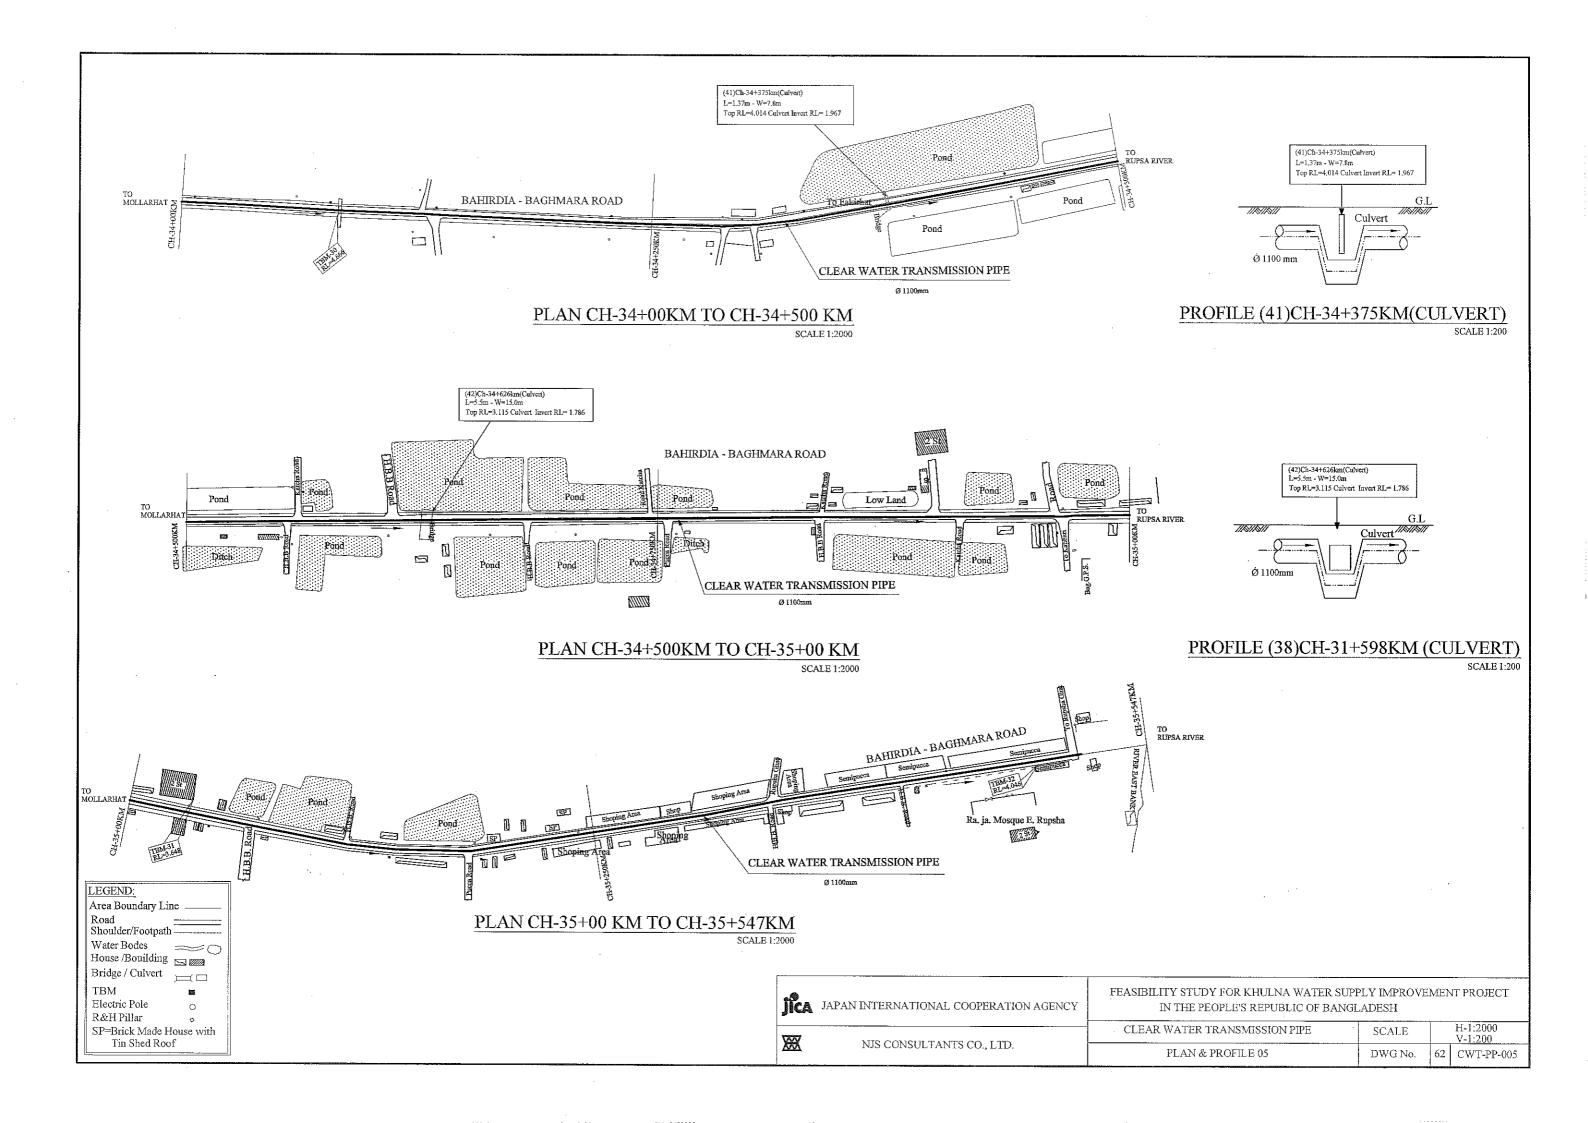


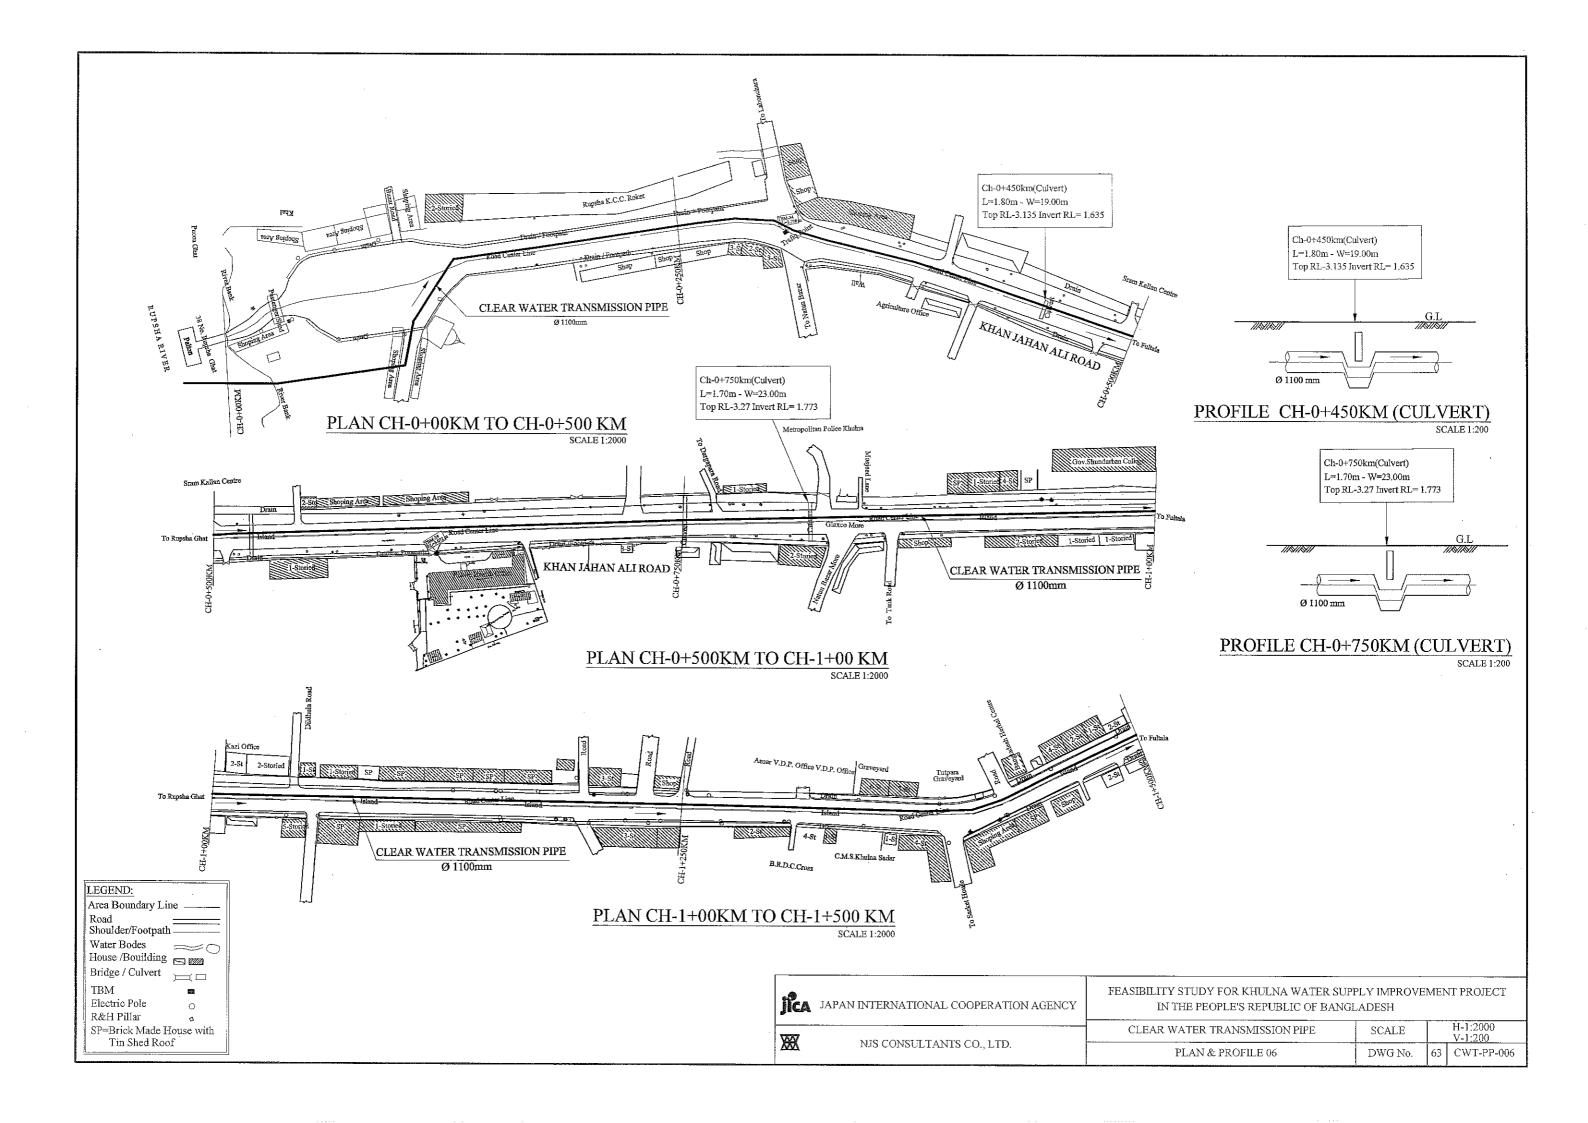


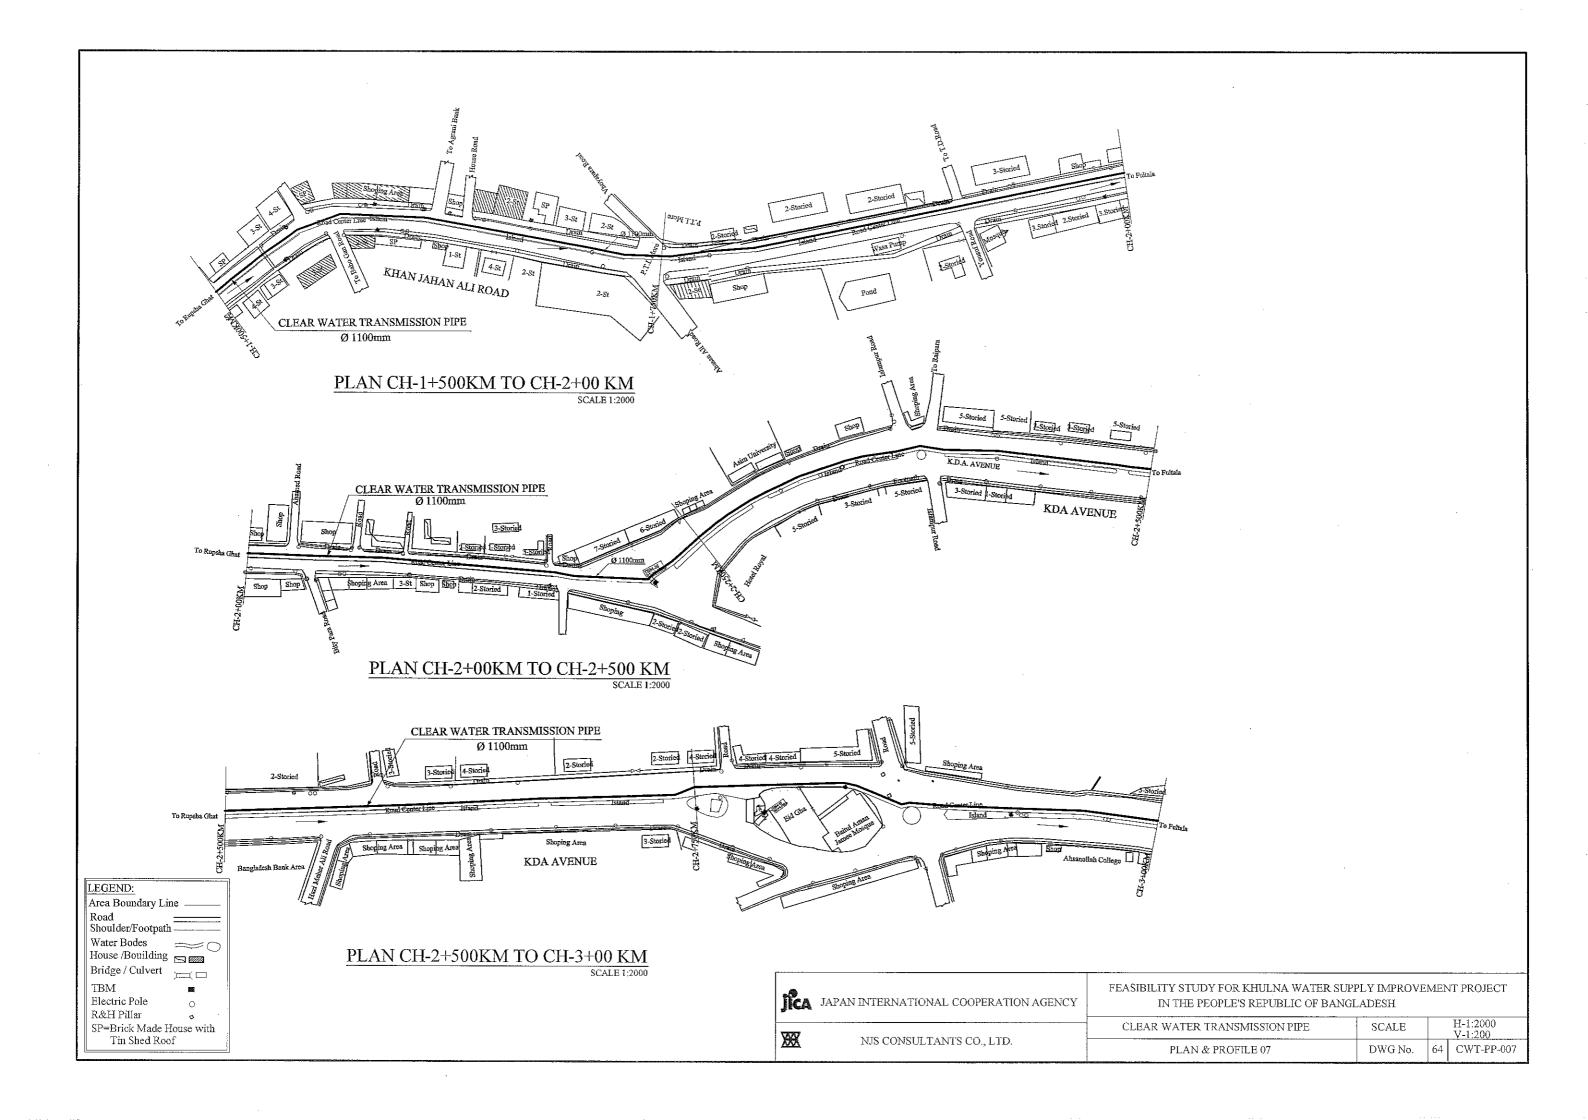


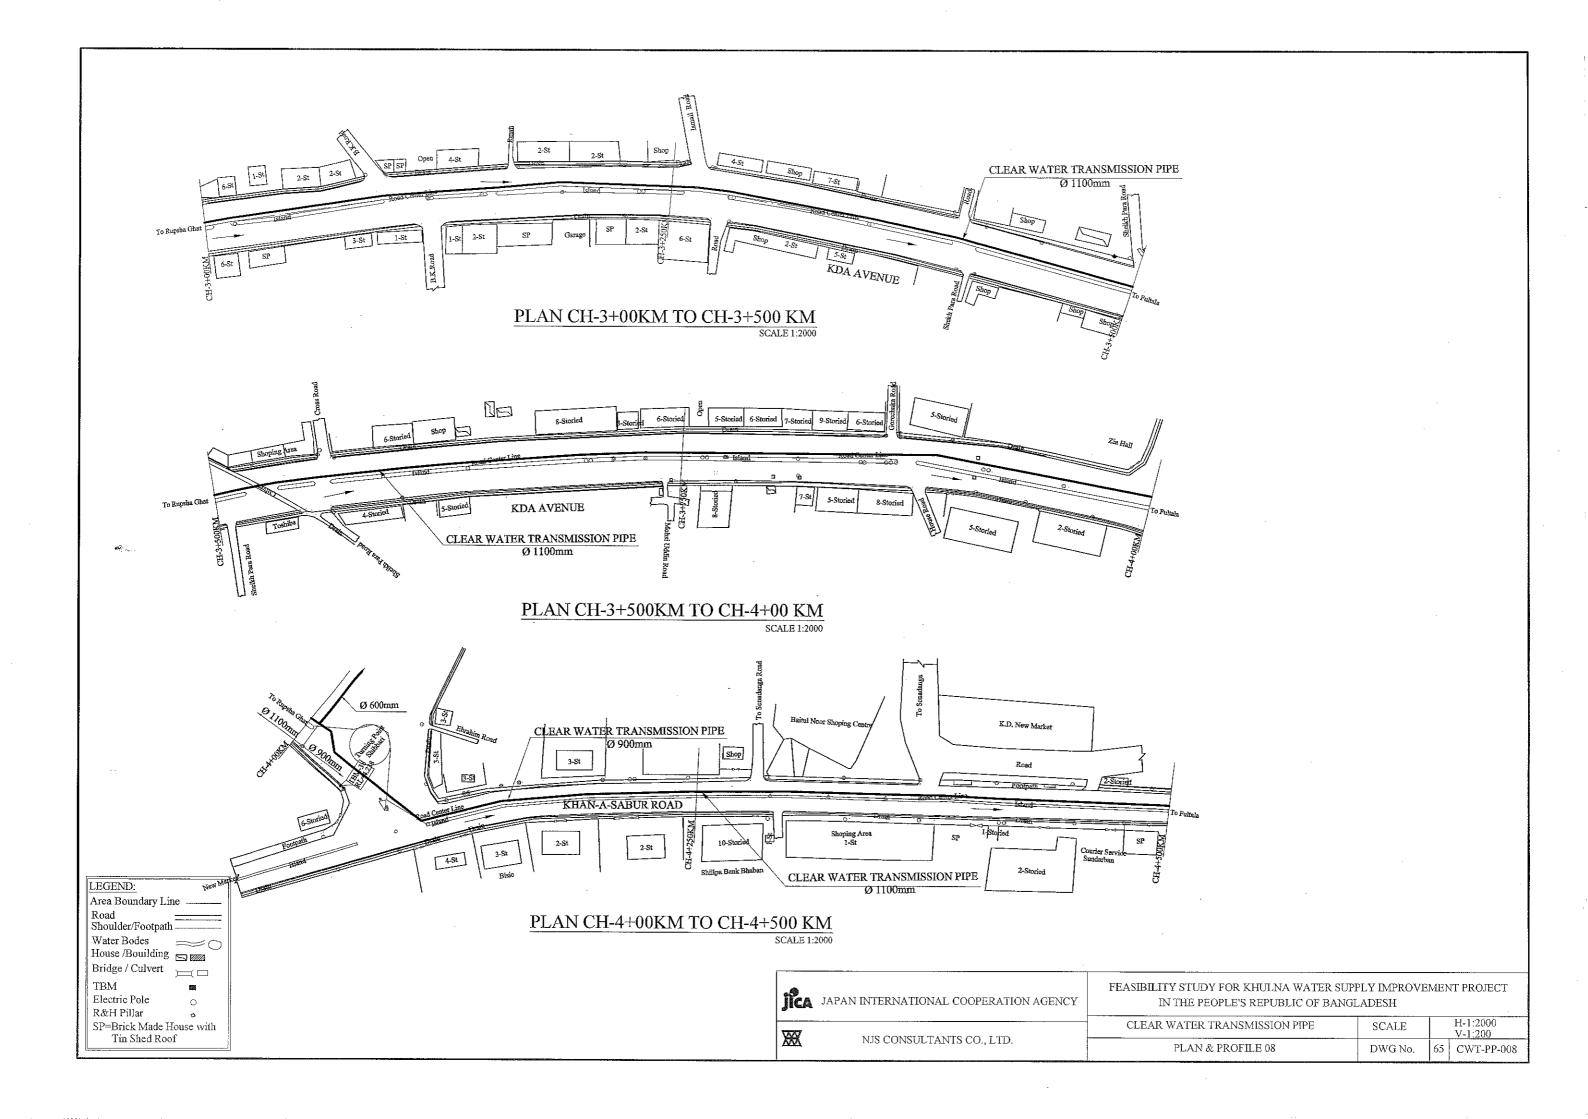


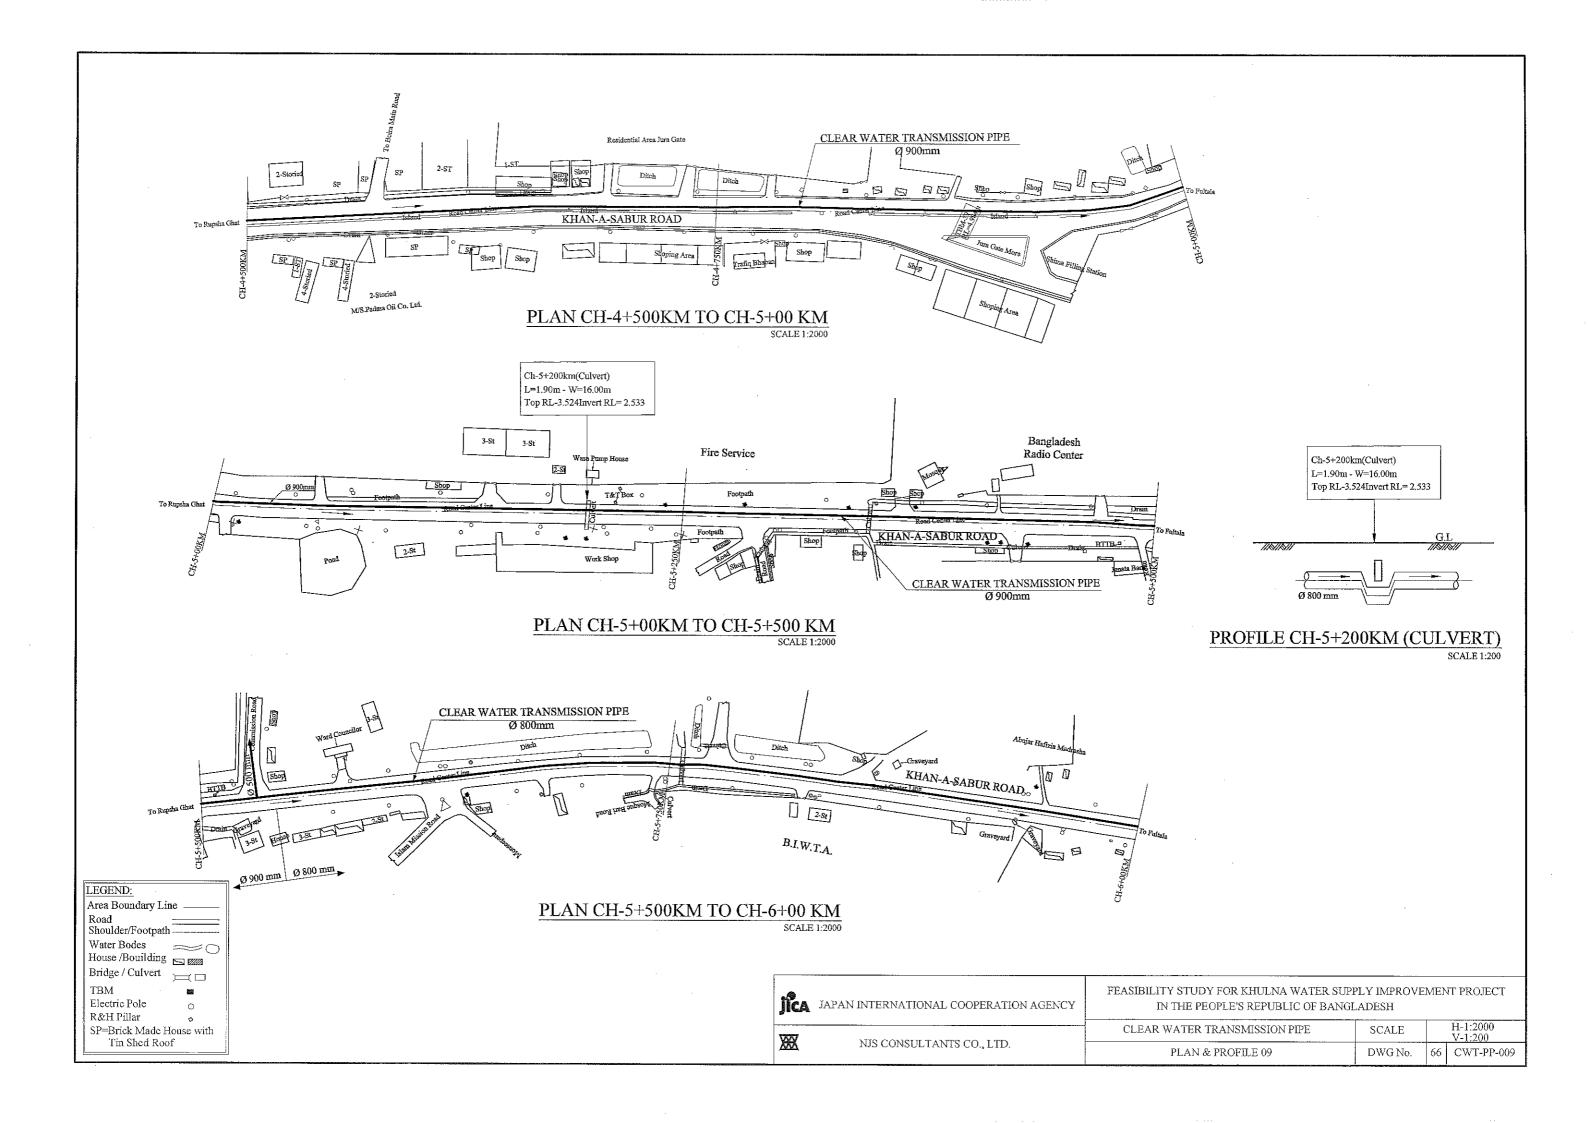


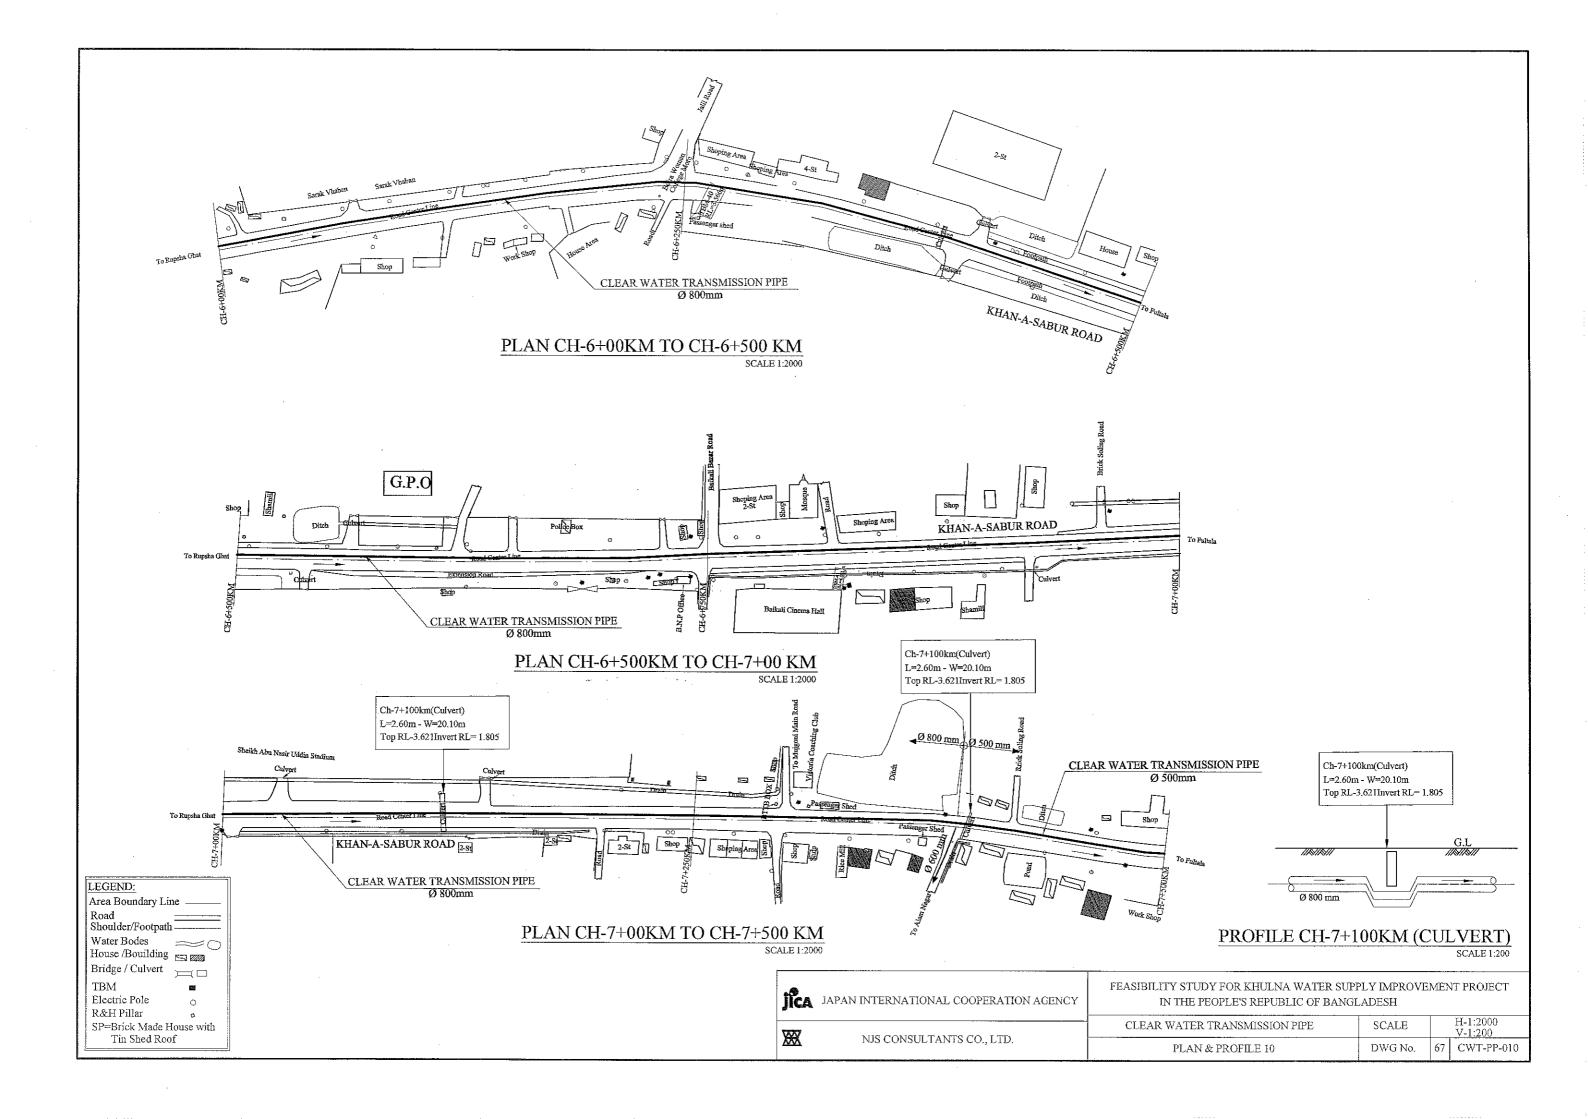


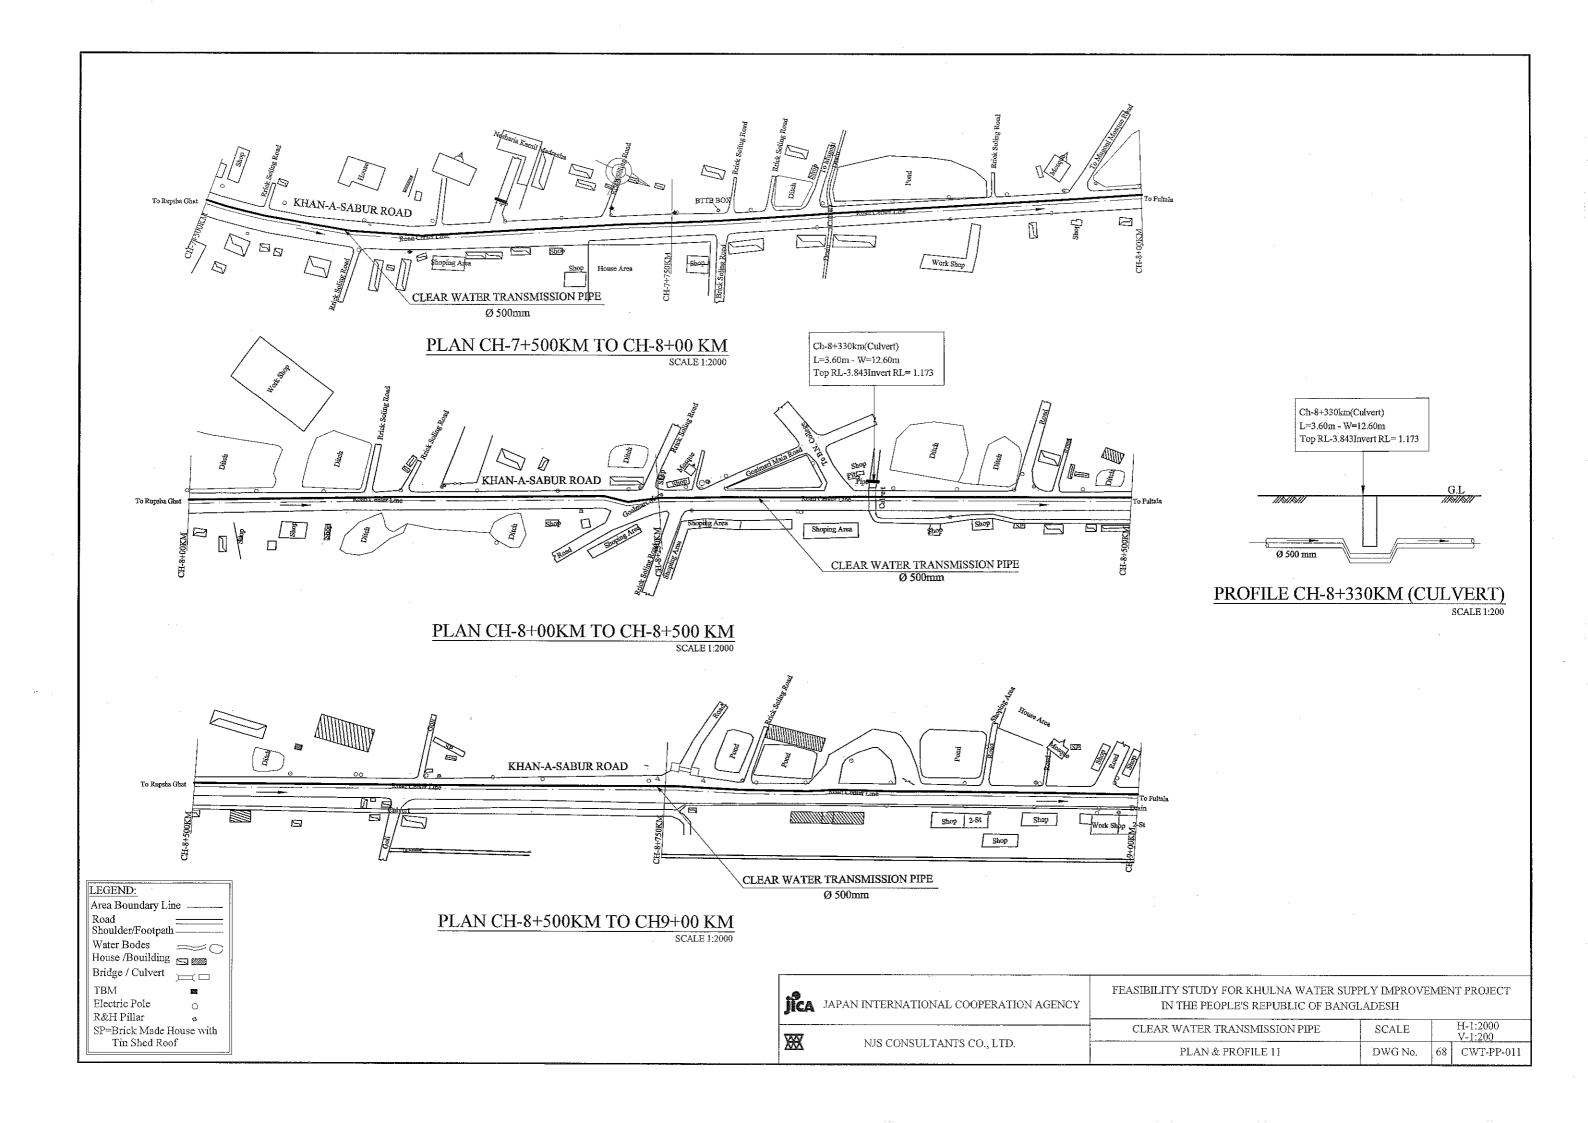


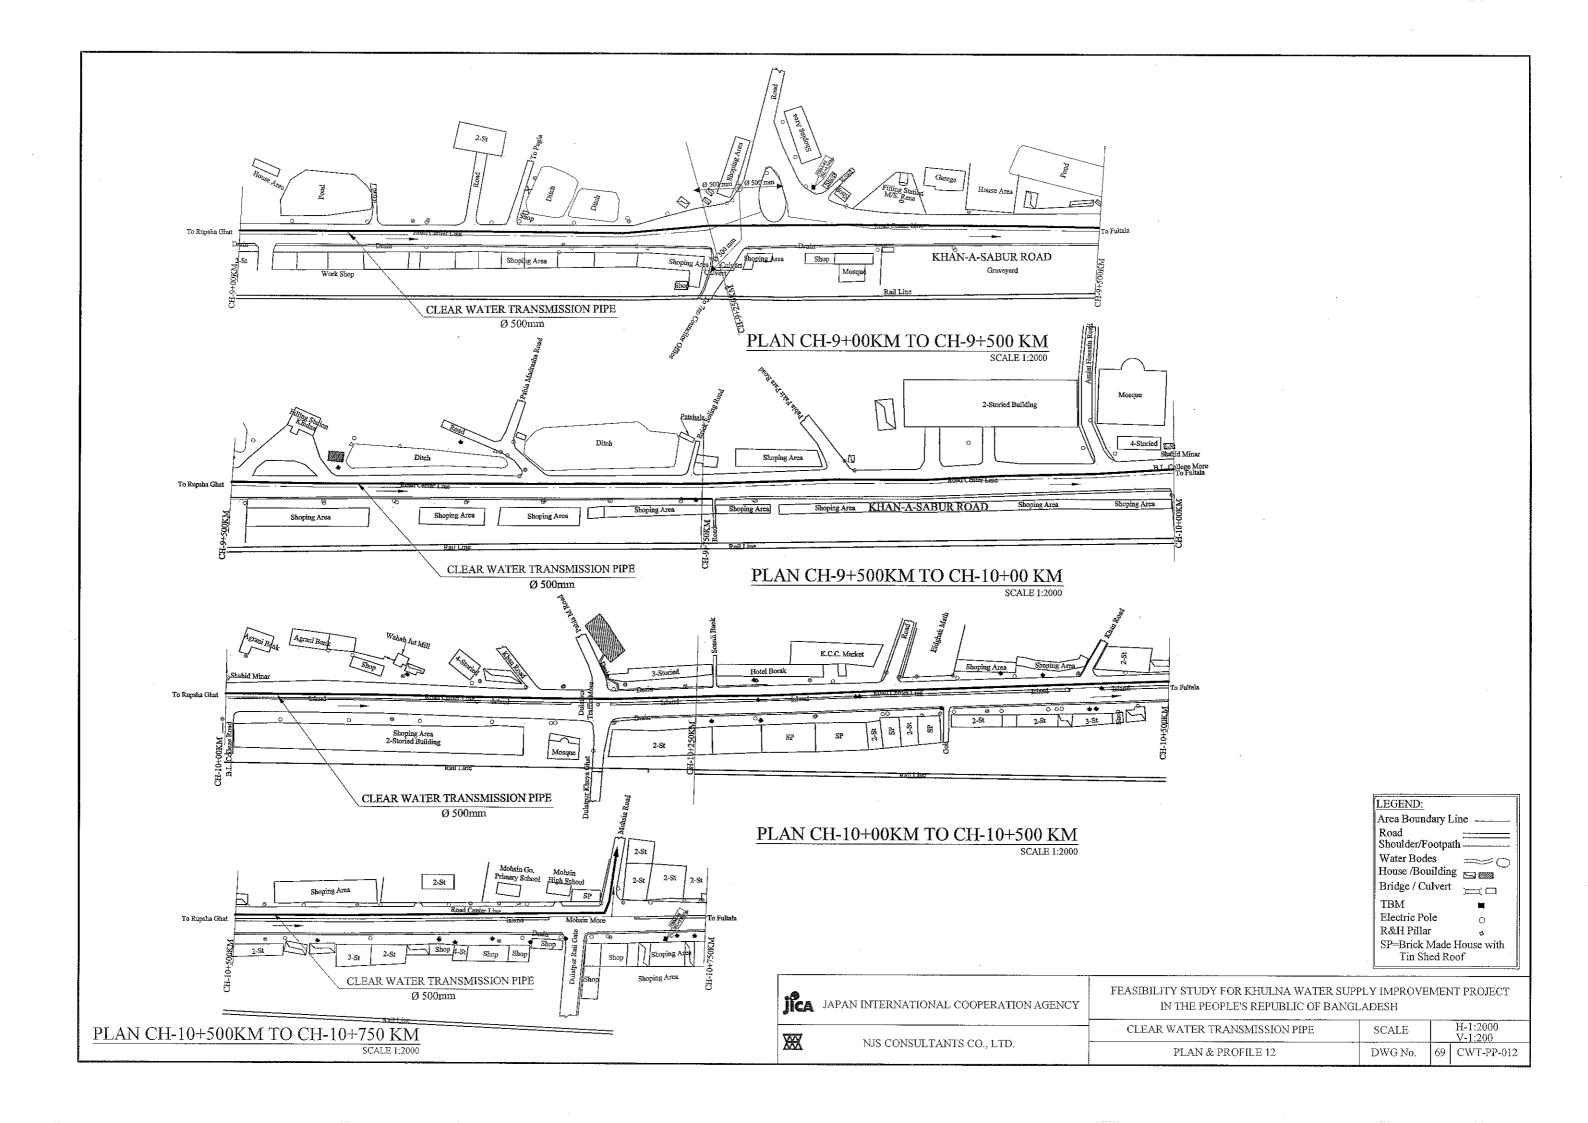

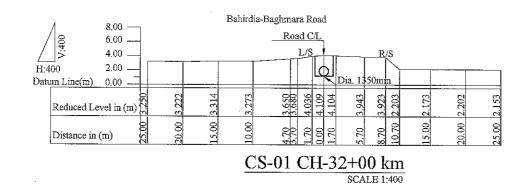

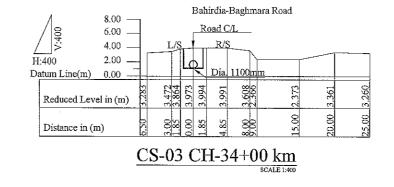


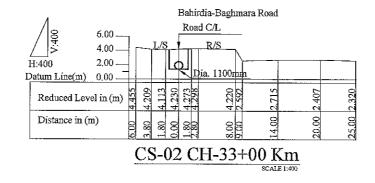

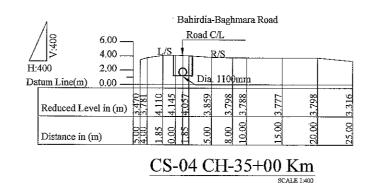


L/S = Left Side
R/S = Right Side
C/L = Center Line

	.e Jica	JAPAN INTERNATIONAL COOPERATION AGENCY	FEASIBILITY STUDY FOR KHULNA WATER SUPPLY IMPROVEMENT PROJECT IN THE PEOPLE'S REPUBLIC OF BANGLADESH			
1	XX	NJS CONSULTANTS CO., LTD.	CLEAR WATER TRANSMISSION PIPE	SCALE	1:400	
1			CROSS SECTION-01	DWG No.	70	CWT-CS-001

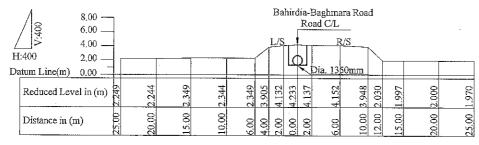


 $\frac{\text{CS-05 CH-31+00 Km}}{\text{SCALE 1:400}}$

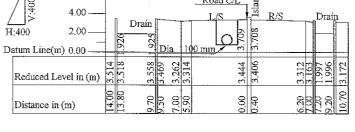


CS-07 CH-1+00Km SCALE 1:400

Khan Jahan Ali Road

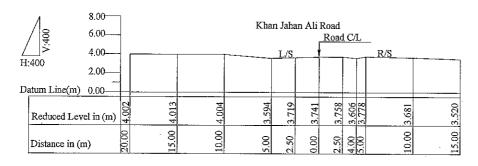


CS-06 CH-0+00 km SCALE 1:400

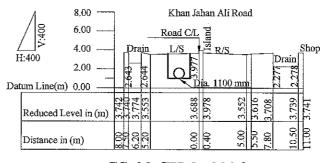


CS-08 CH-2+000 km SCALE 1:400


L/S = Left S	ide
R/S = Right	Sid

100	reight blue
C/L =	= Center Line

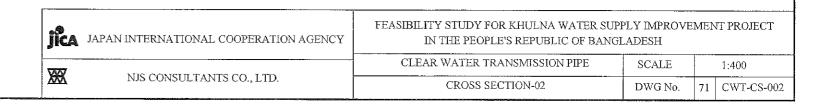

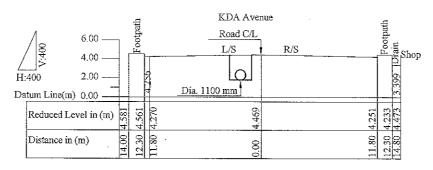


CS-09 CH-3+000 km SCALE 1:400

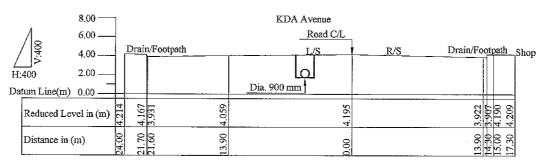


CS-10 CH-4+000 km SCALE 1:400

$L/S = Le\pi Side$
R/S = Right Side
C/L = Center Line

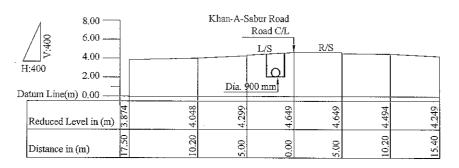

CS-11 CH-5+000 km SCALE 1:400

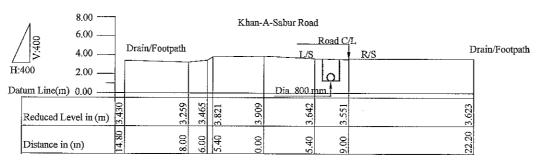

CS-12 CH-6+000 km SCALE 1:400

L/S = Left Side R/S = Right Side C/L = Center Line



JAPAN INTERNATIONAL COOPERATION AGENCY


FEASIBILITY STUDY FOR KHULNA WATER SUPPLY IMPROVEMENT PROJECT IN THE PEOPLE'S REPUBLIC OF BANGLADESH

XX

NJS CONSULTANTS CO., LTD.


CLEAR WATER TRANSMISSION PIPE SCALE 1:400

CROSS SECTION-04 DWG No. 73 CWT-CS-004

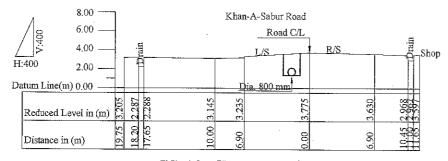


CS-13 CH-7+000 km

SCALE 1;400

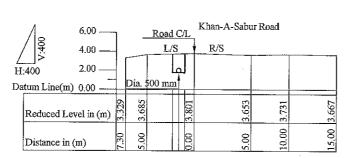


 $\frac{\text{CS-14 CH-8+000 km}}{\text{\tiny SCALE 1:400}}$

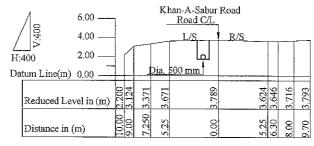

CS-15 CH-9+000 km


SCALE 1:400

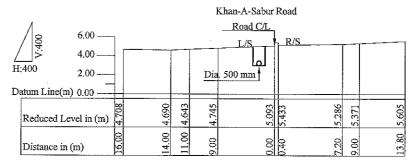



CS-16 CH-10+000 km SCALE 1:400


L/S = Left Side
R/S = Right Side
C/L = Center Line


jic	JAPAN INTERNATIONAL COOPERATION AGENCY	FEASIBILITY STUDY FOR KHULNA WATER SUPPLY IMPROVEMENT PROJECT IN THE PEOPLE'S REPUBLIC OF BANGLADESH			
**	NJS CONSULTANTS CO., LTD.	CLEAR WATER TRANSMISSION PIPE	SCALE		1:400
<u>₩</u>		CROSS SECTION-05	DWG No.	74	CWT-CS-005

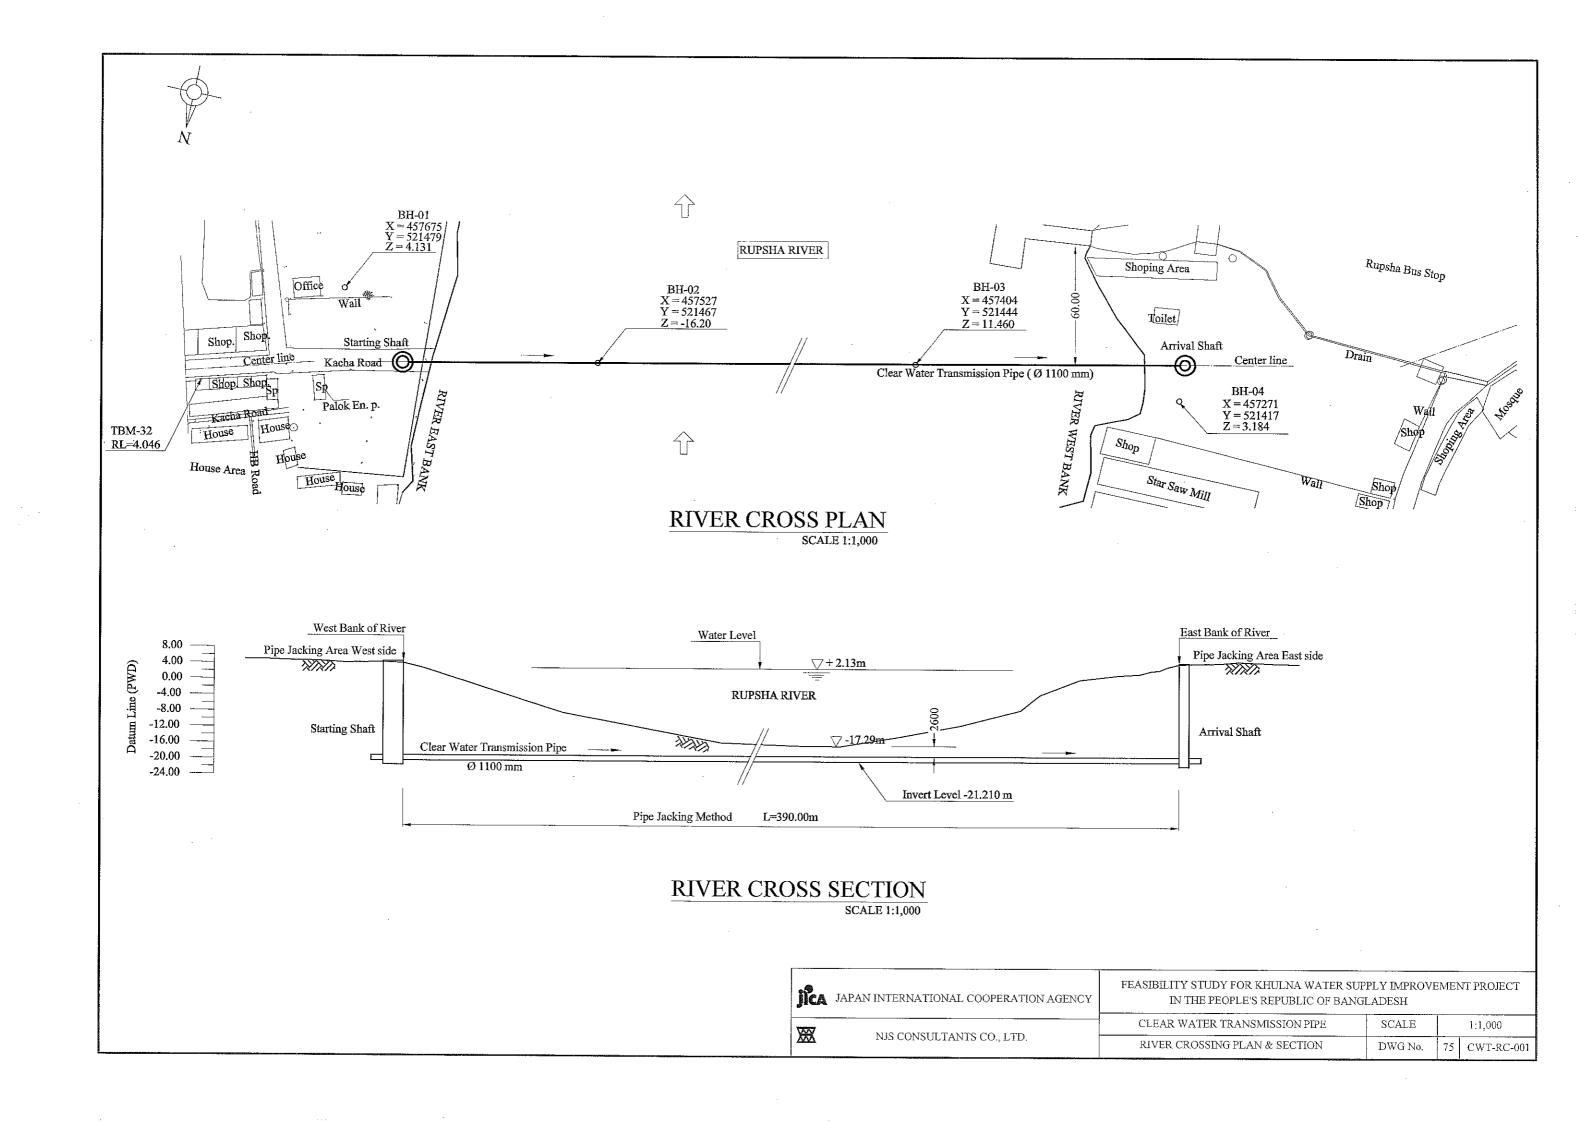


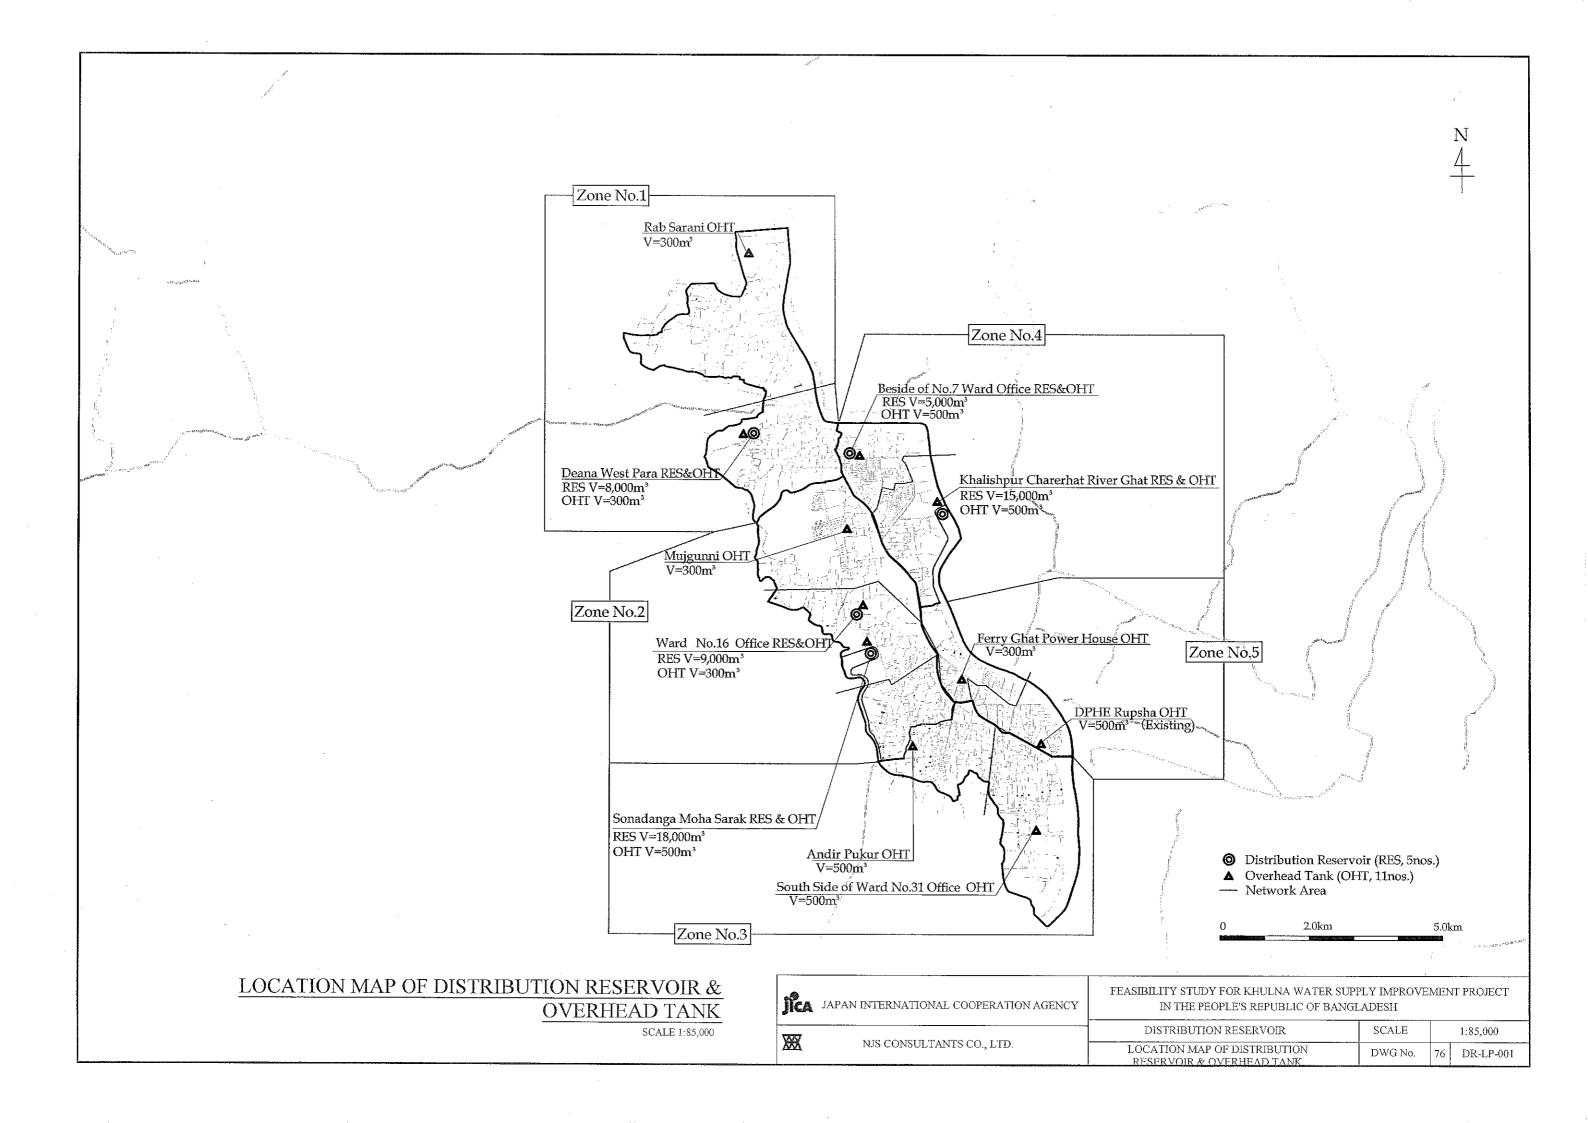


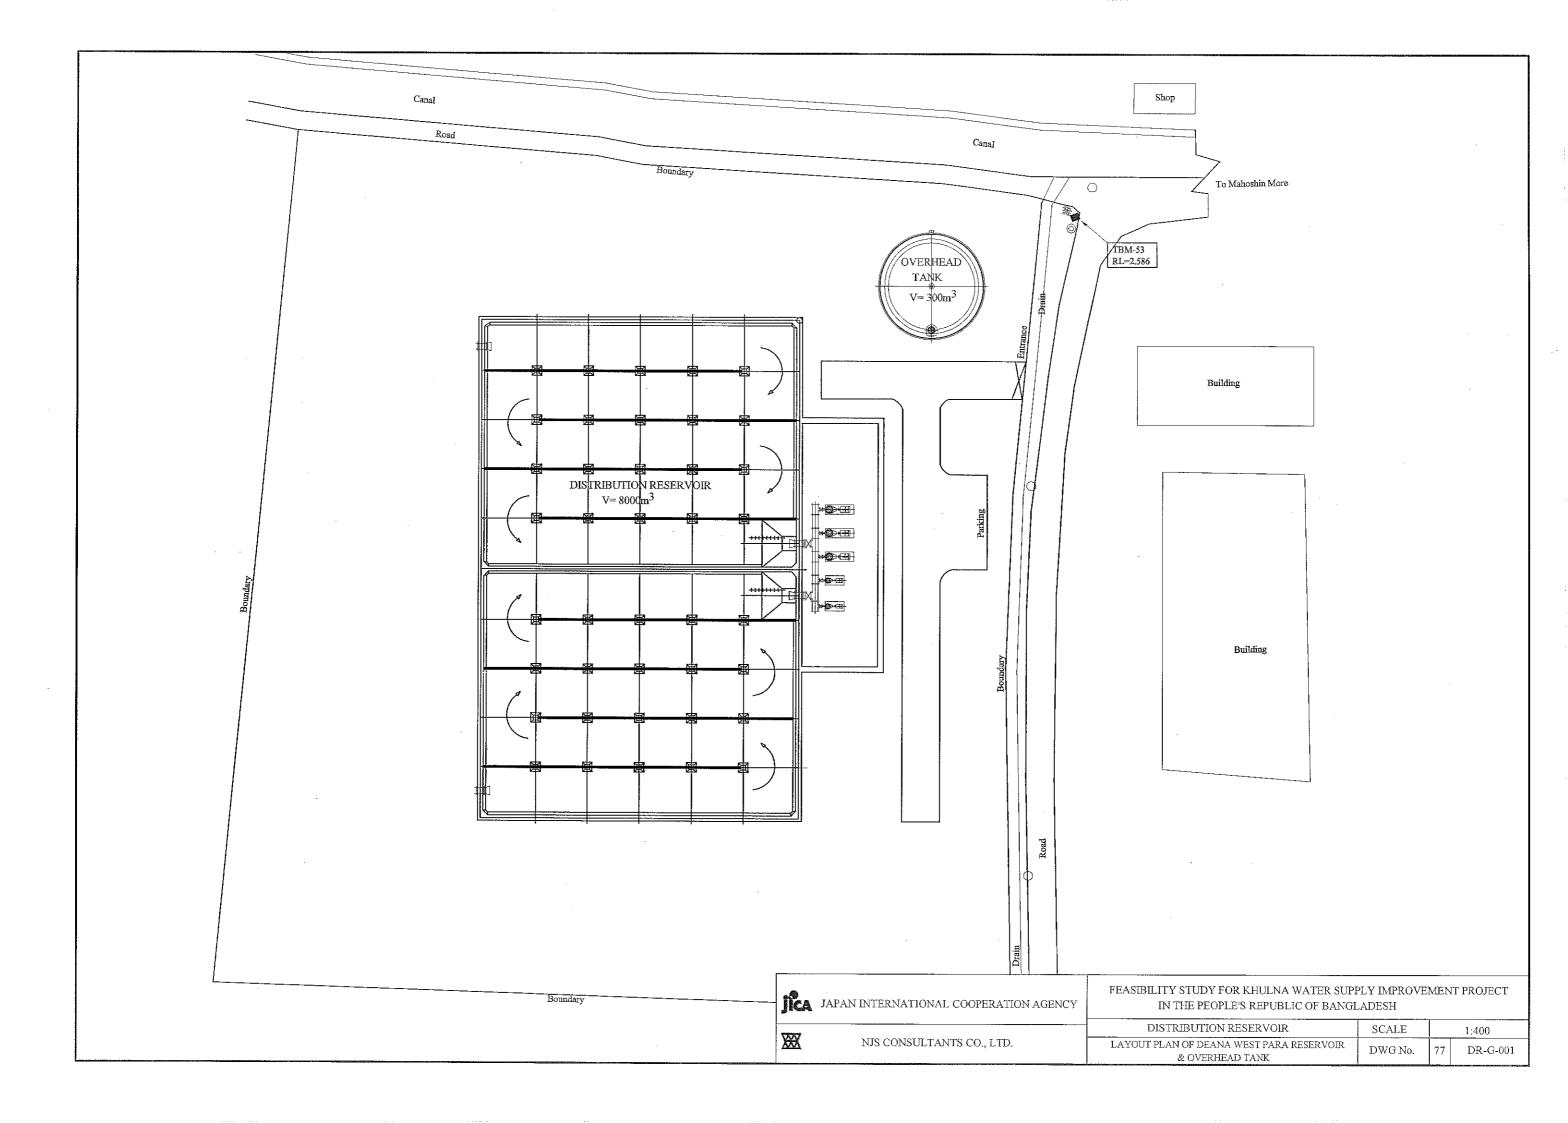


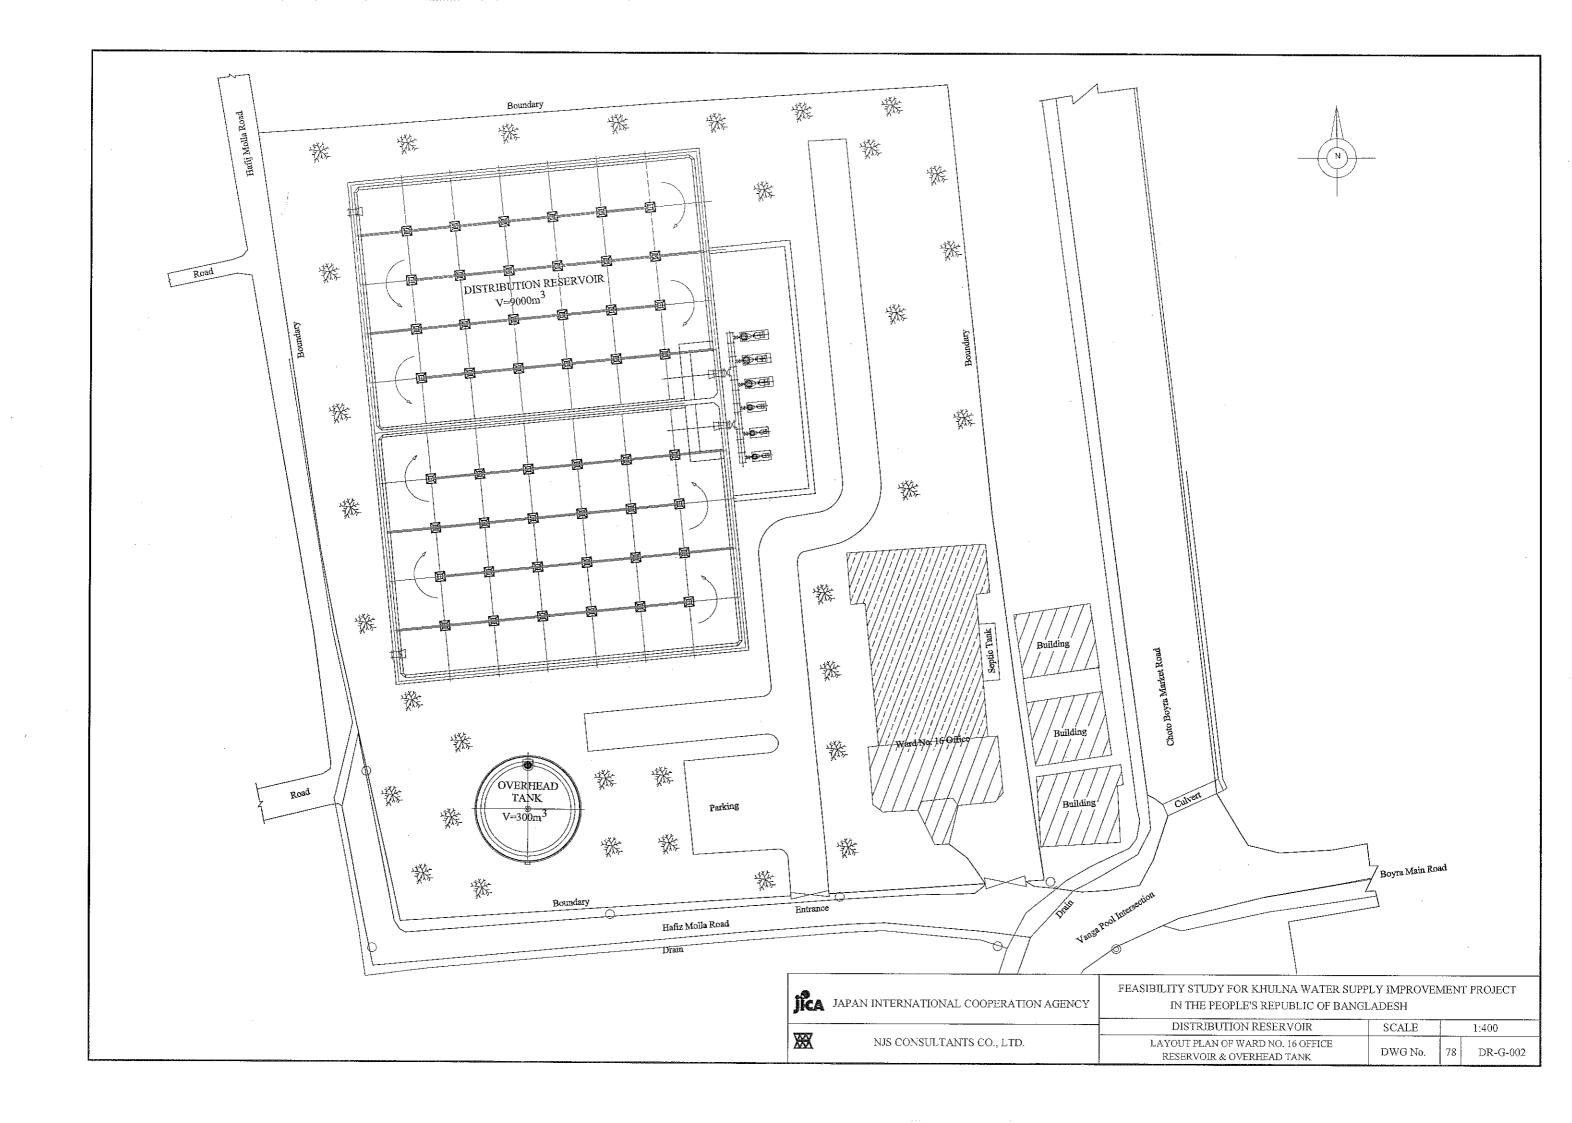


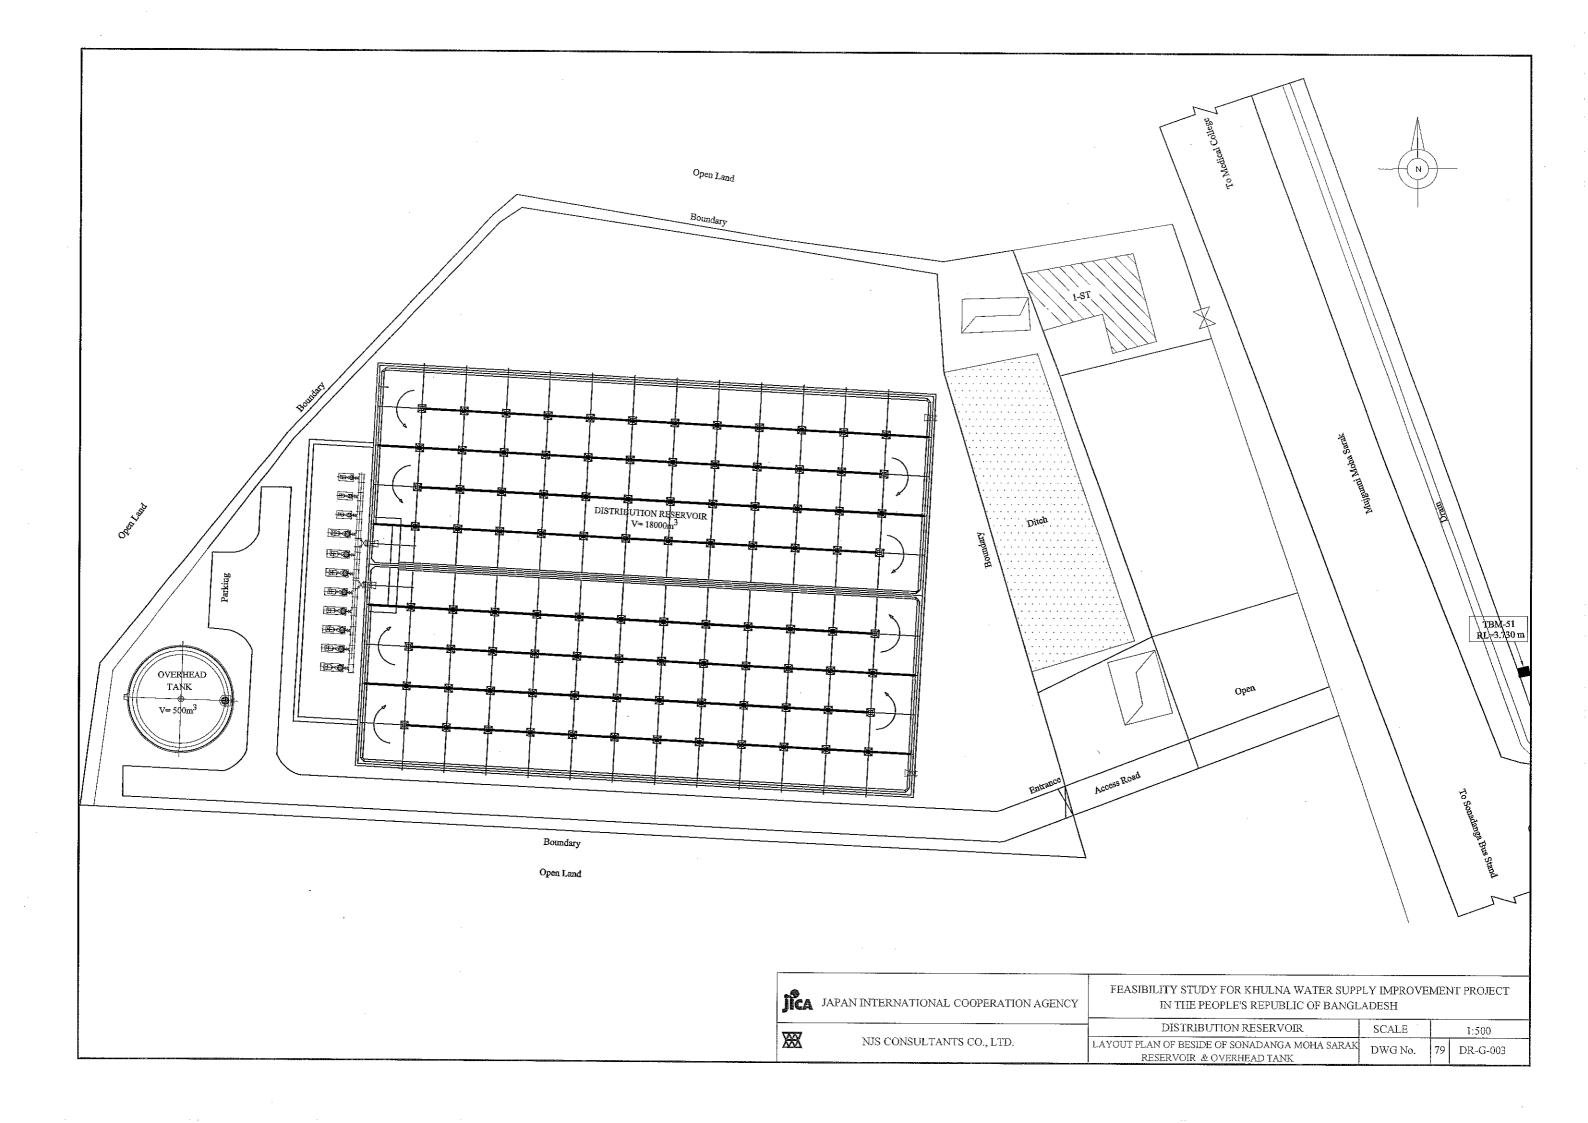


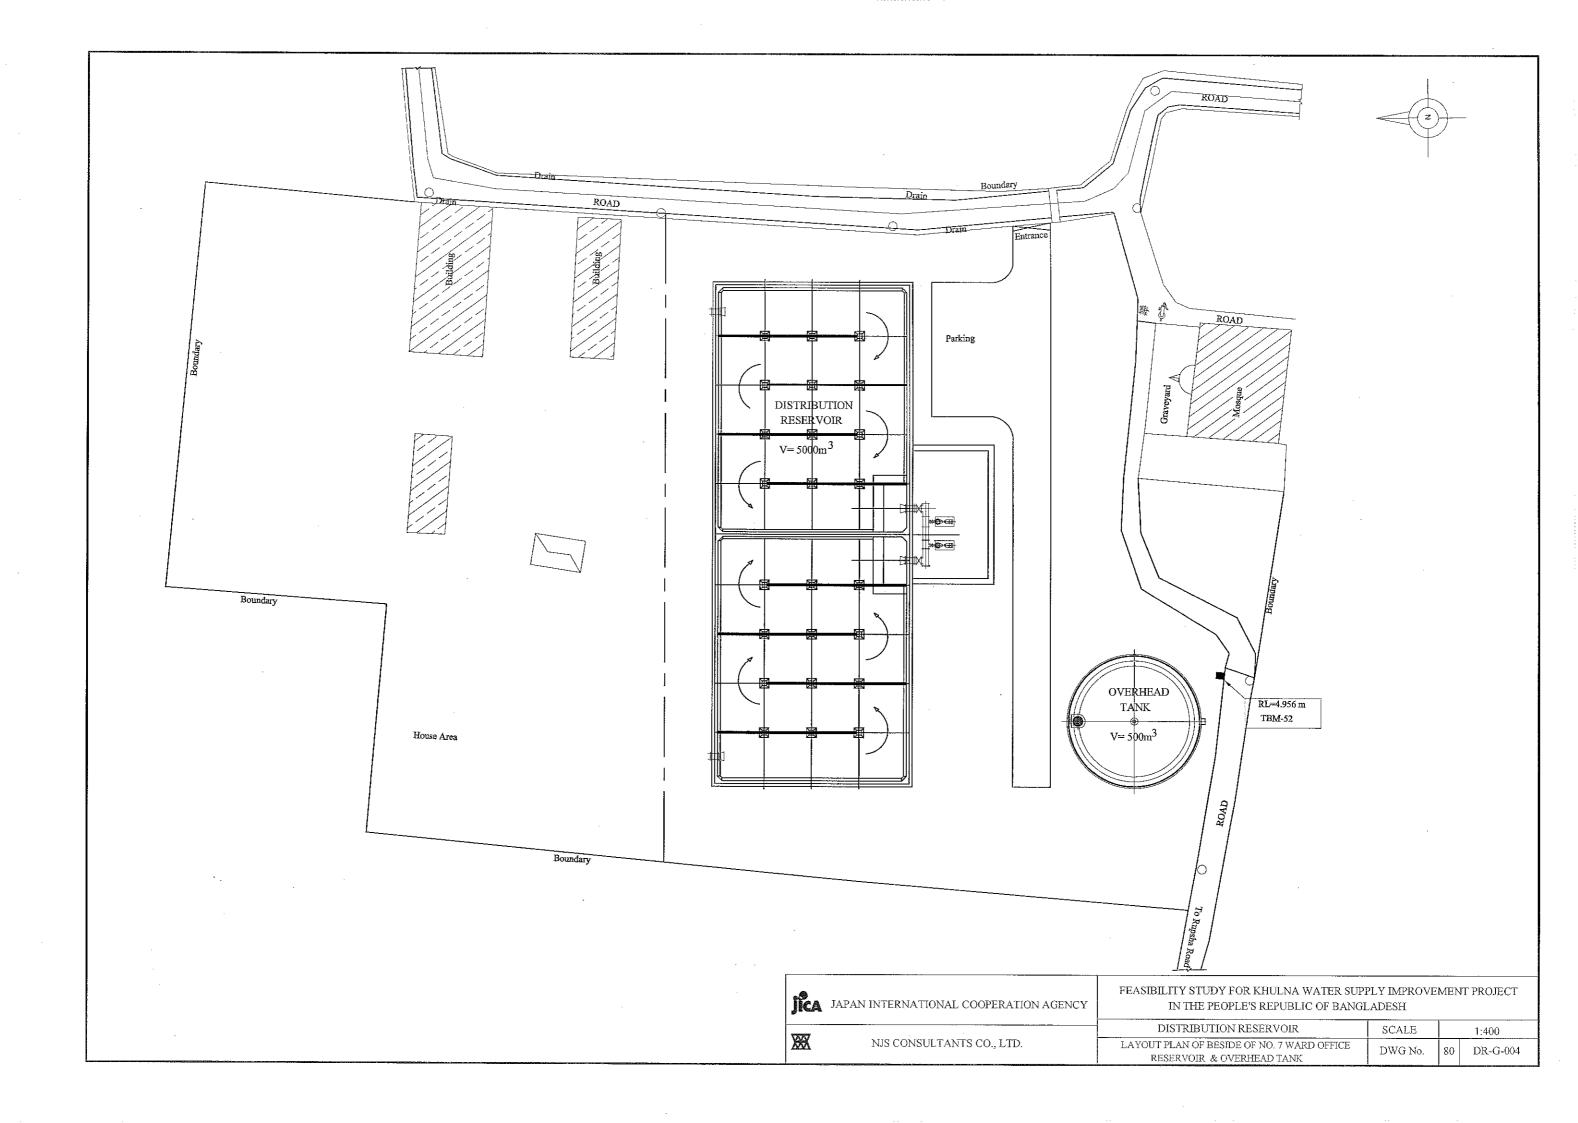

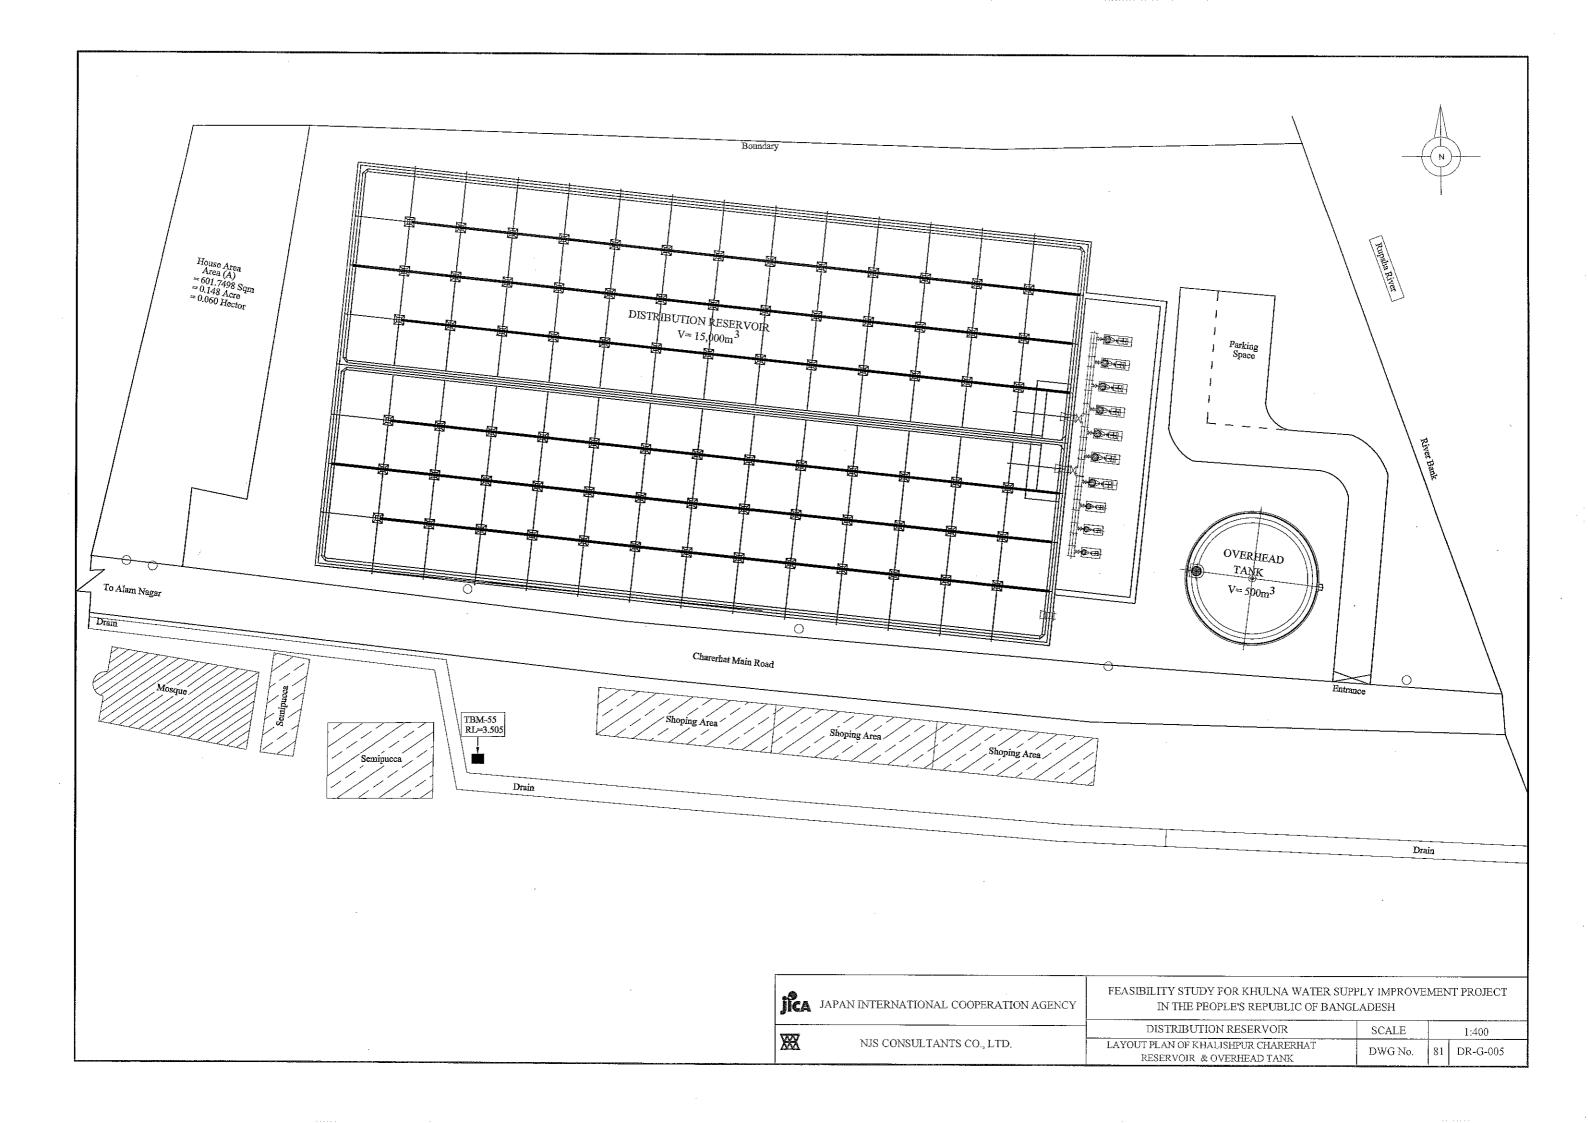

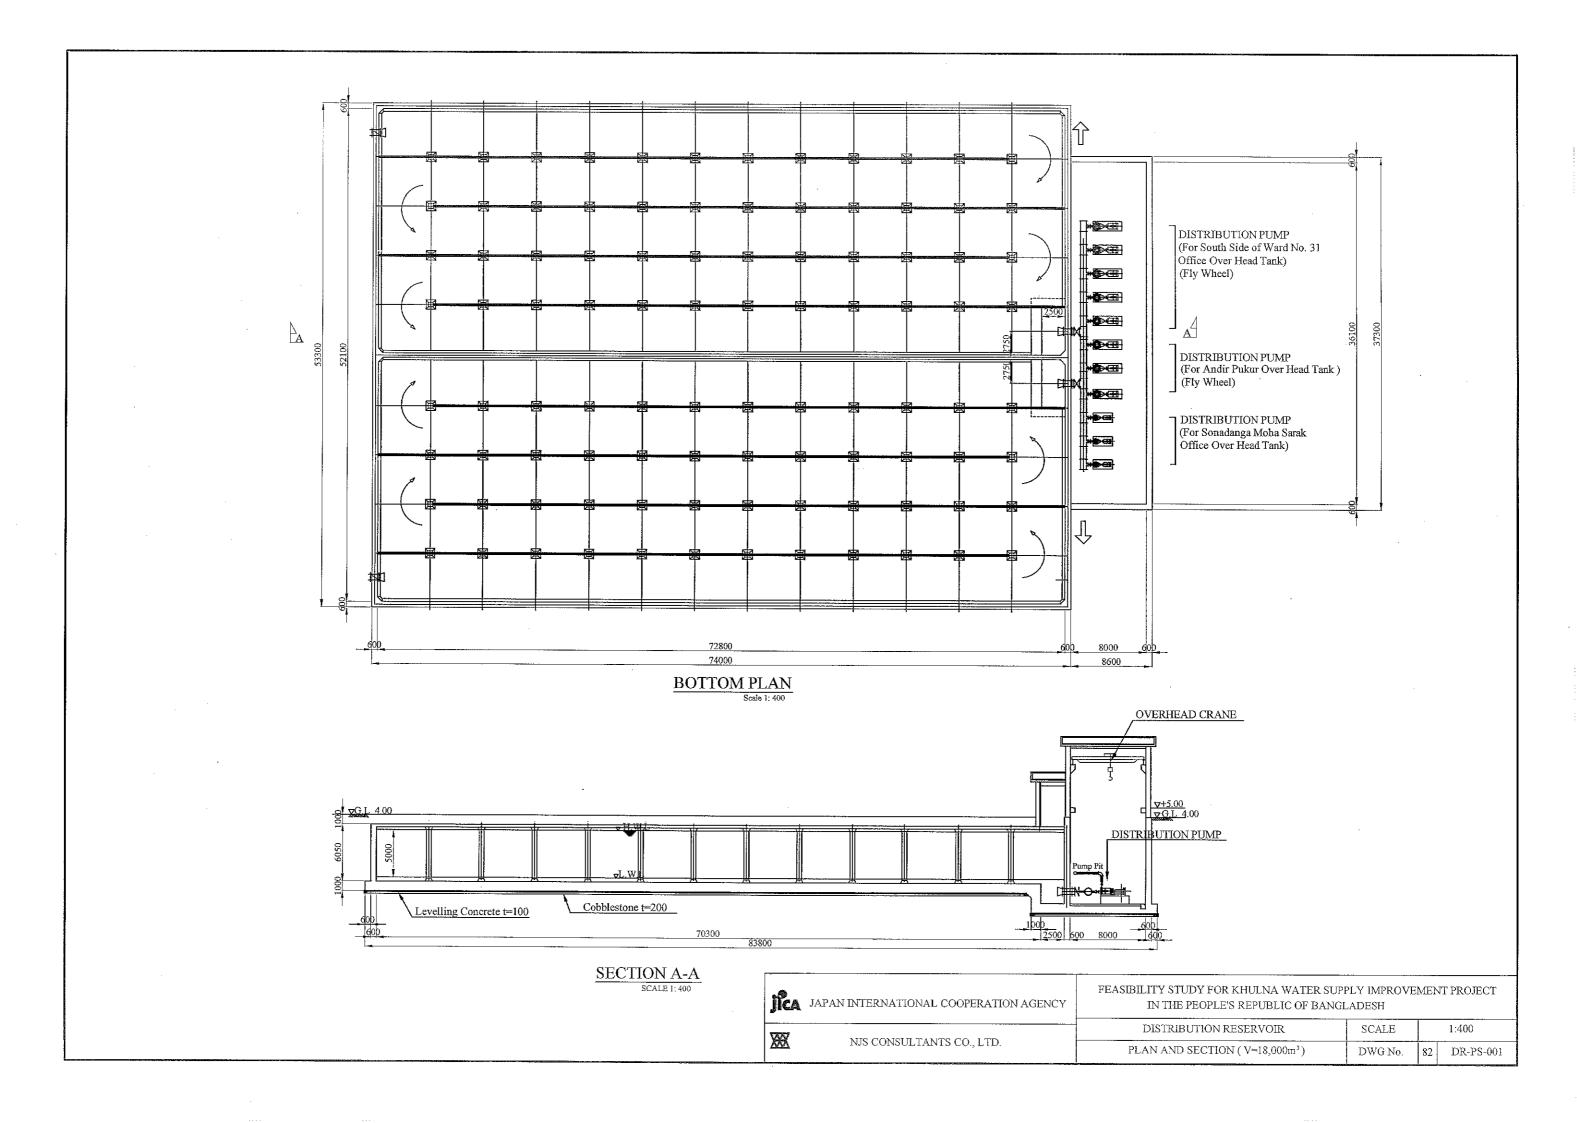


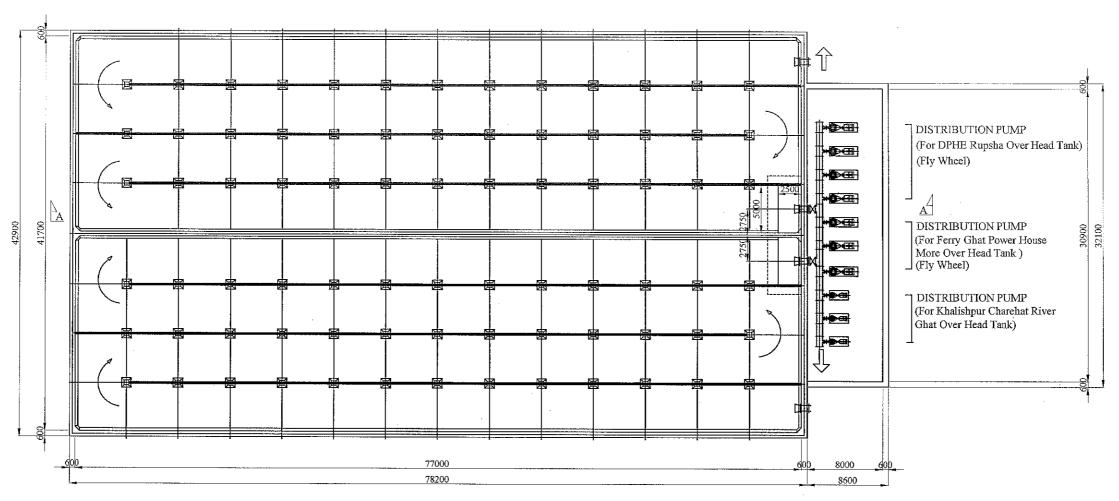


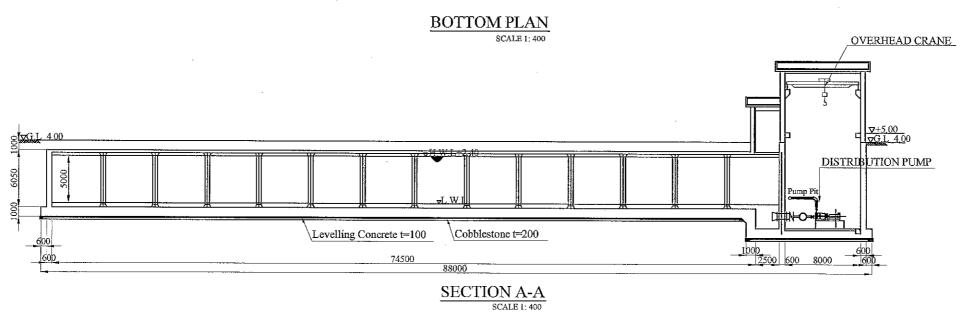



FEASIBILITY STUDY FOR KHULNA WATER SUPPLY IMPROVEMENT PROJECT IN THE PEOPLE'S REPUBLIC OF BANGLADESH

DISTRIBUTION RESERVOIR
SCALE
1:400
PLAN AND SECTION (V=15,000m⁻³)
DWG No. 83 DR-PS-002

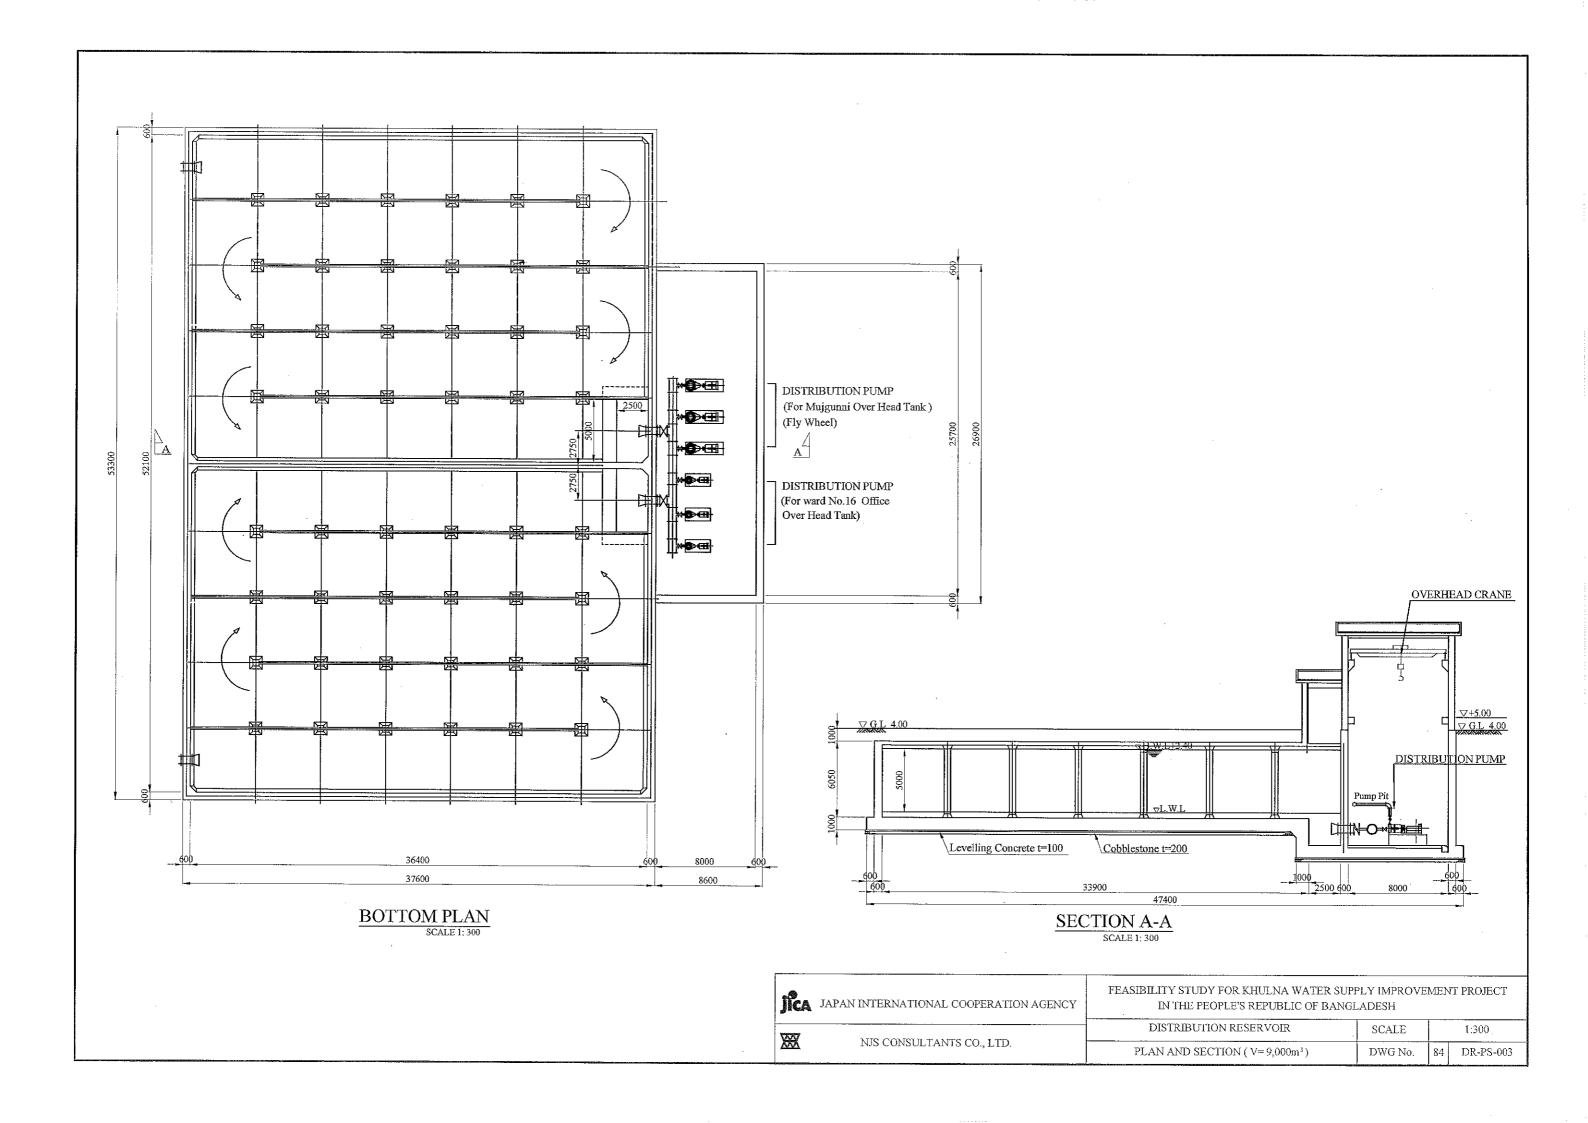

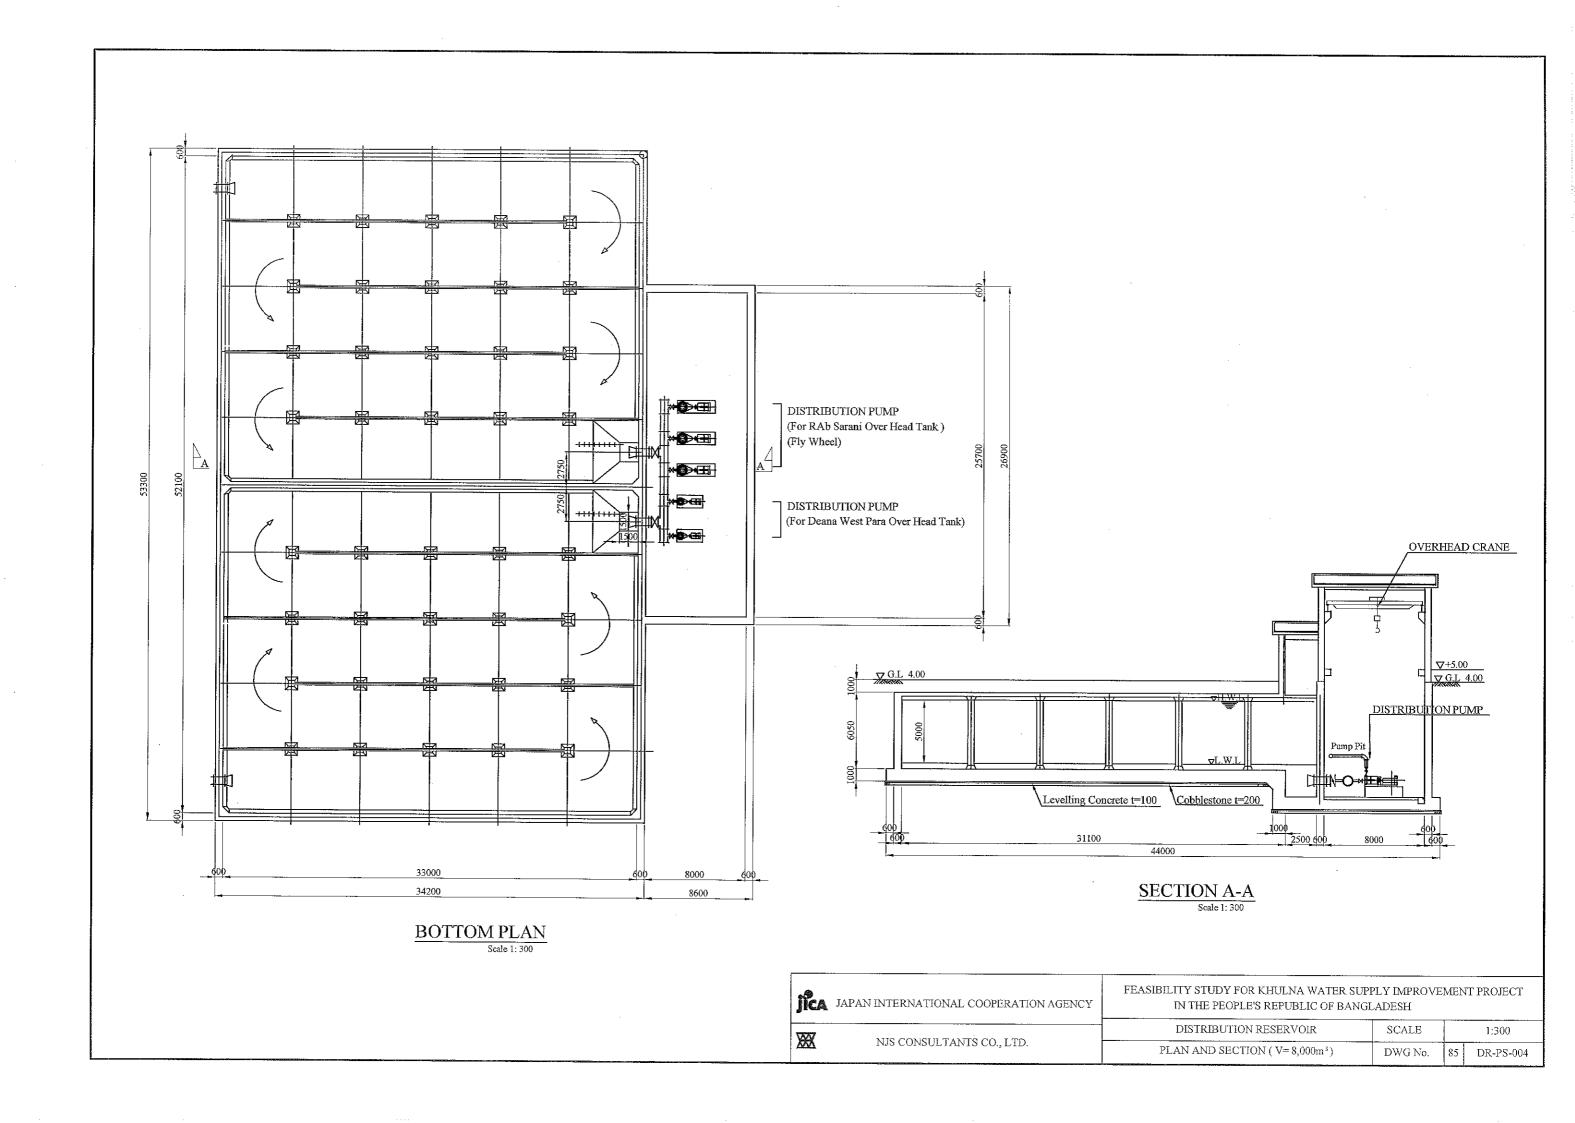

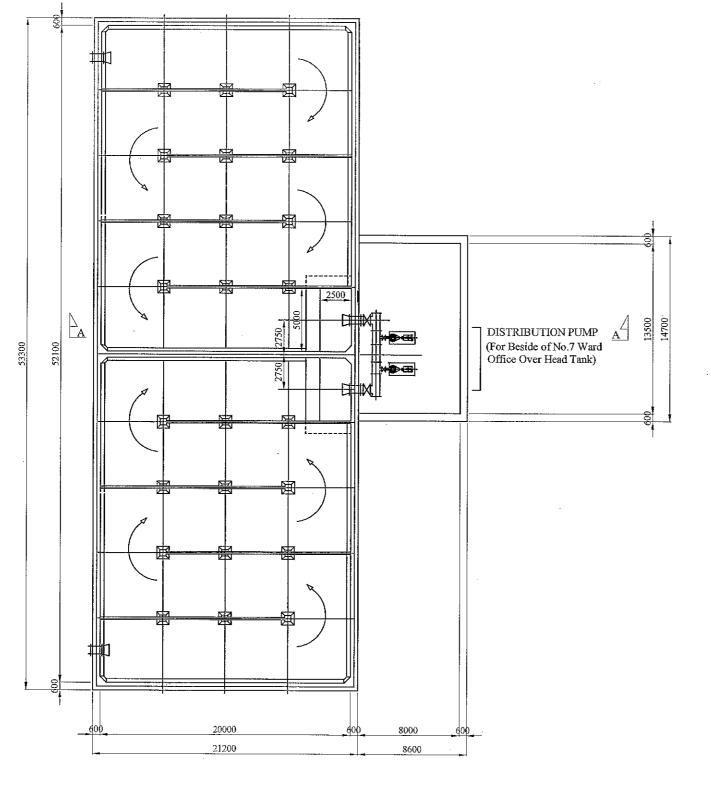

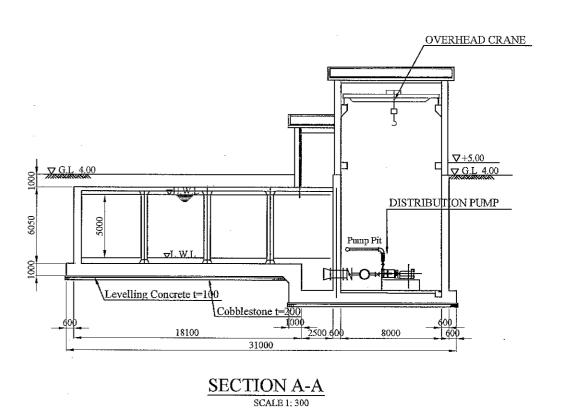

 $\frac{BOTTOM\ PLAN}{\text{SCALE 1: 300}}$

JAPAN INTERNATIONAL COOPERATION AGENCY

FEASIBILITY STUDY FOR KHULNA WATER SUPPLY IMPROVEMENT PROJECT IN THE PEOPLE'S REPUBLIC OF BANGLADESH


1:300


DR-PS-005

XX


NJS CONSULTANTS CO., LTD.


DISTRIBUTION RESERVOIR SCALE PLAN AND SECTION (V=5,000m³) DWG No.

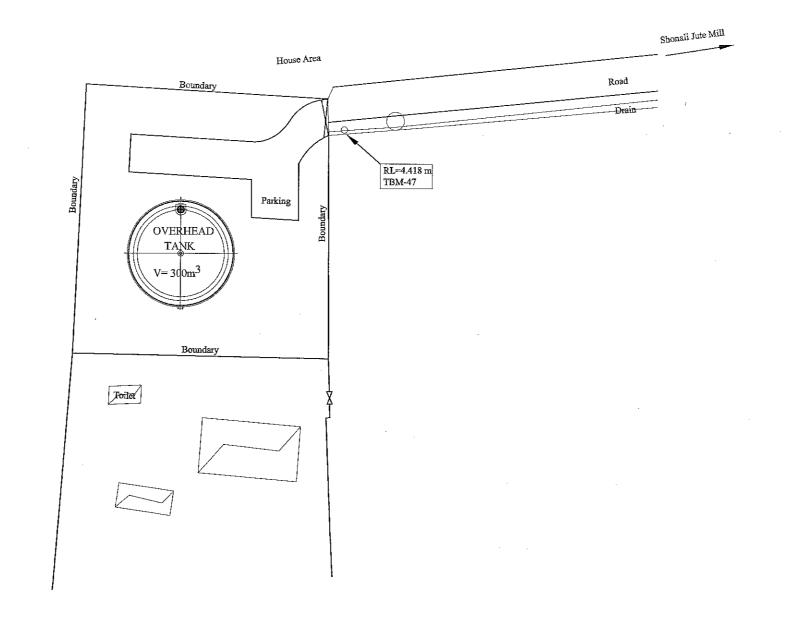


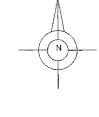



jica	JAPAN INTERNATIONAL COOPERATION AGENCY	FEASIBILITY STUDY FOR KHULNA WATER SUPPLY IMPROVEMENT PROJECT IN THE PEOPLE'S REPUBLIC OF BANGLADESH			
7277		OVERHEAD TANK	SCALE		1:400
X	NJS CONSULTANTS CO., LTD.	LAYOUT PLAN OF RAB SARANI OVERHEAD TANK	DWG No.	87	OHT-G-001

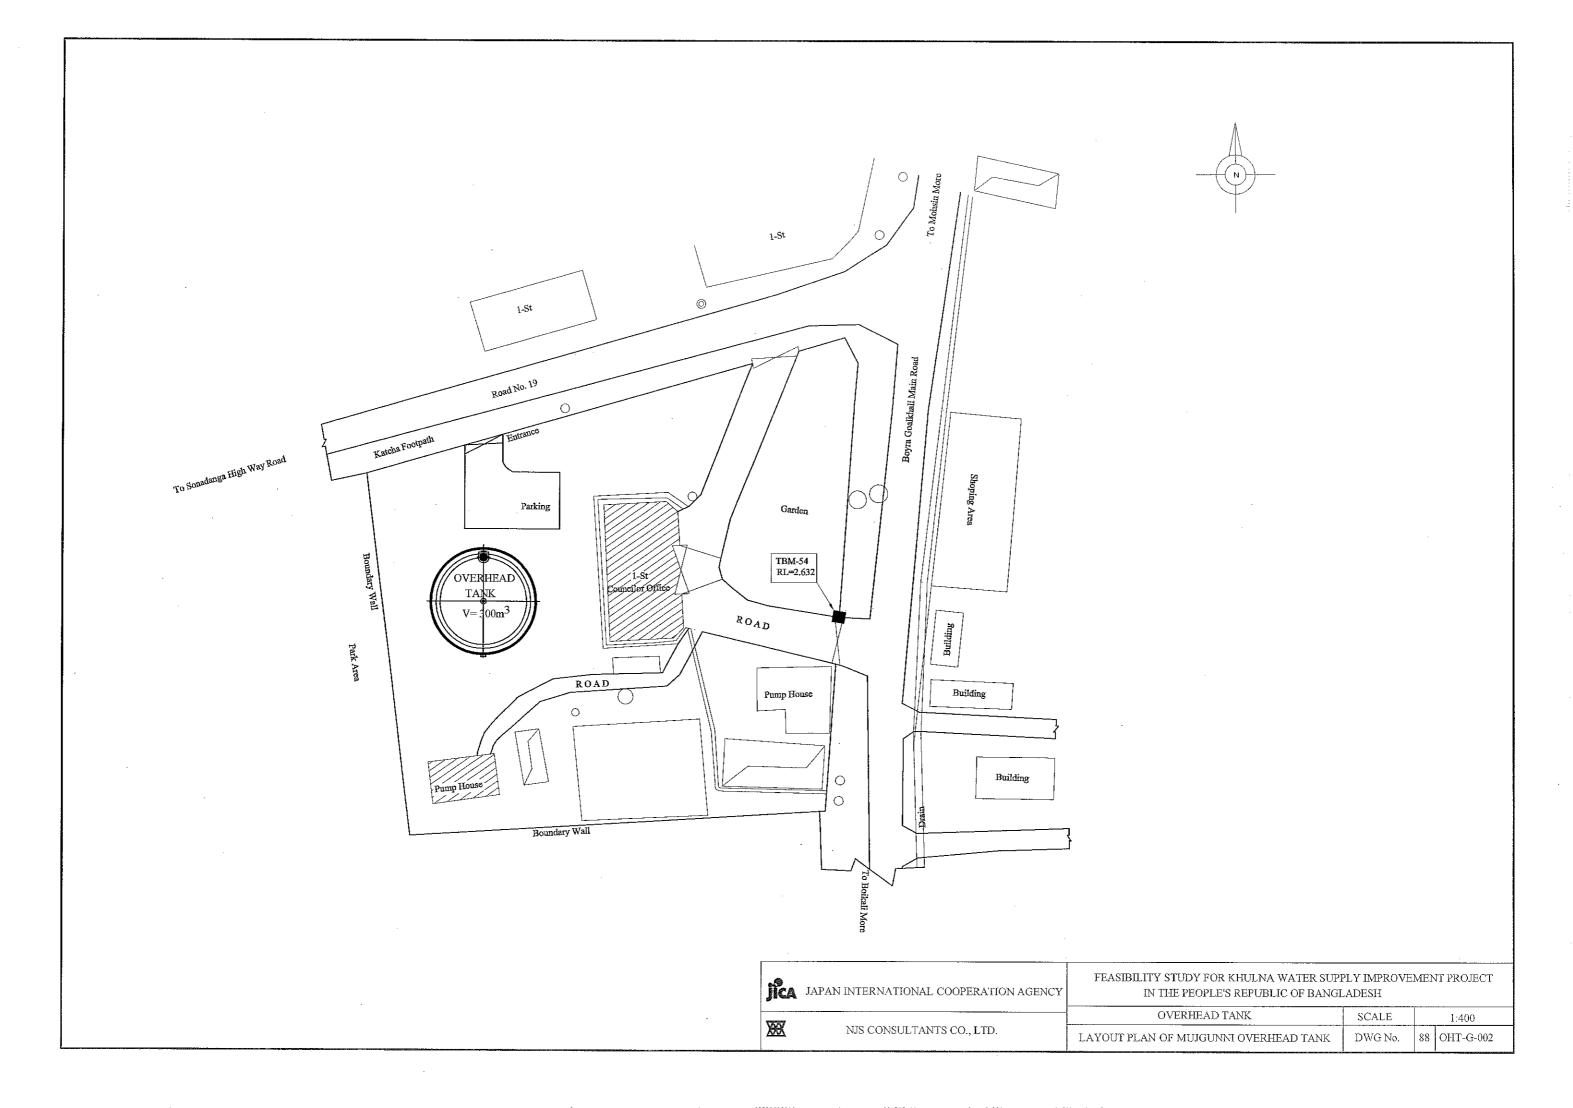


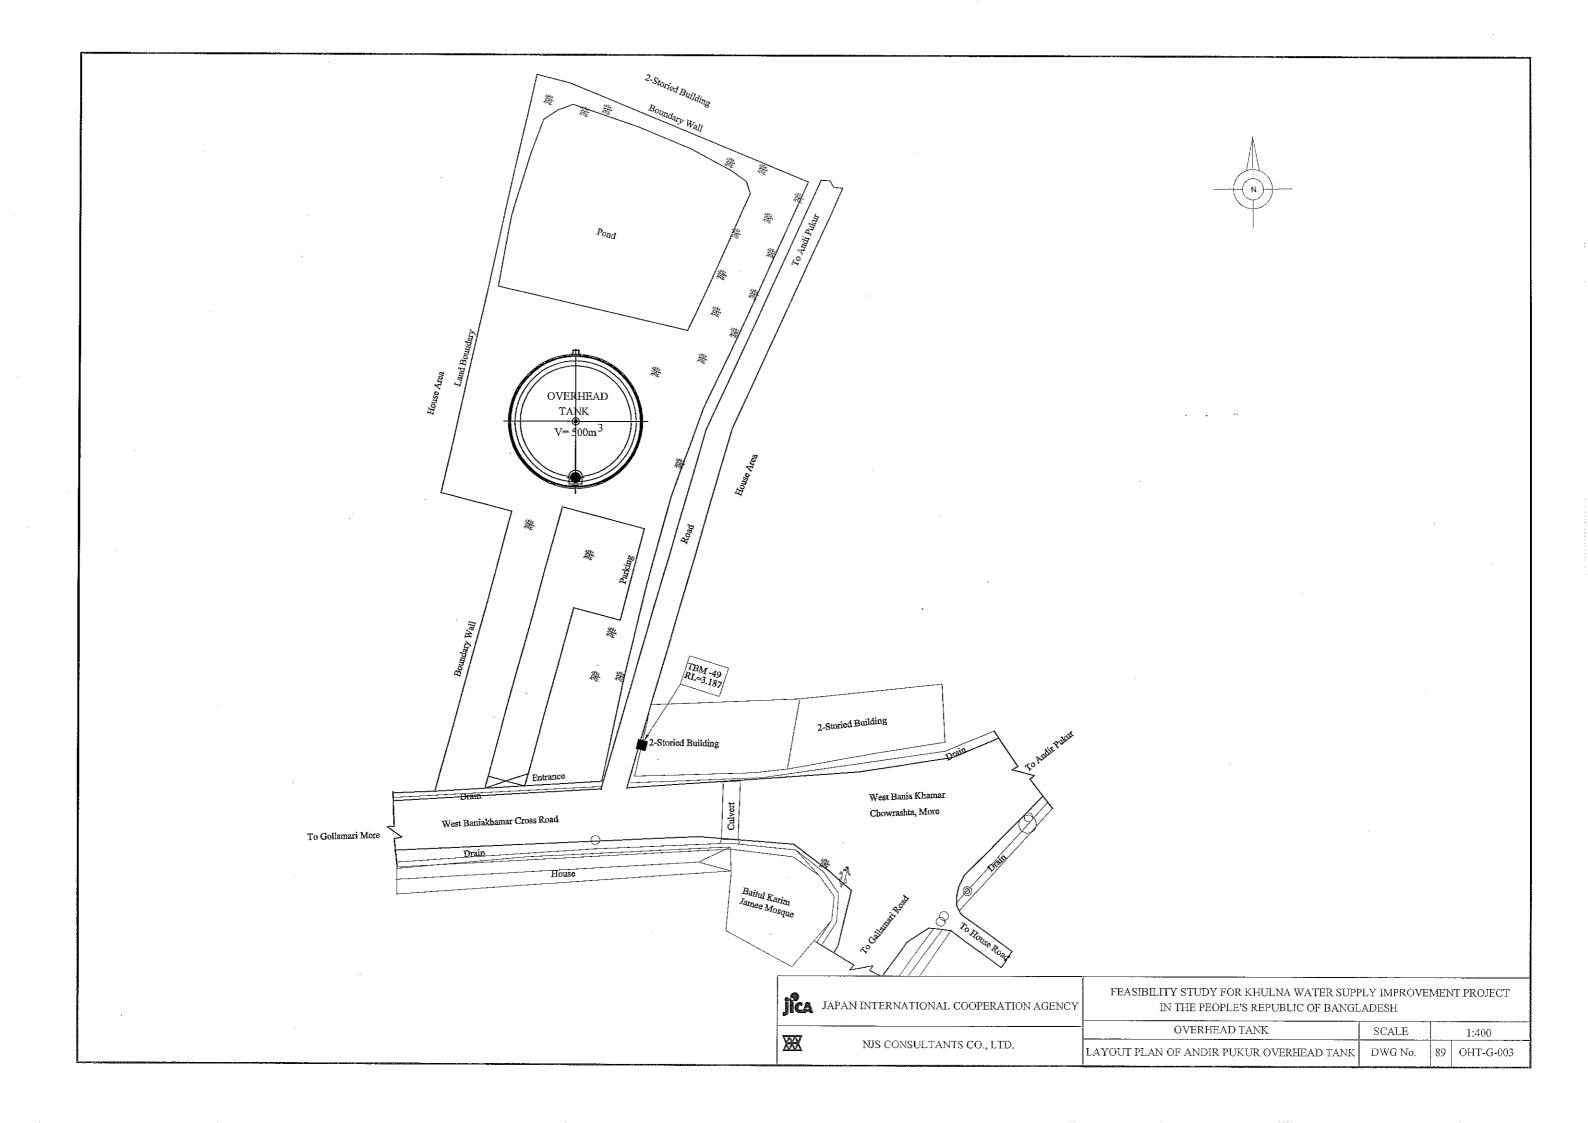


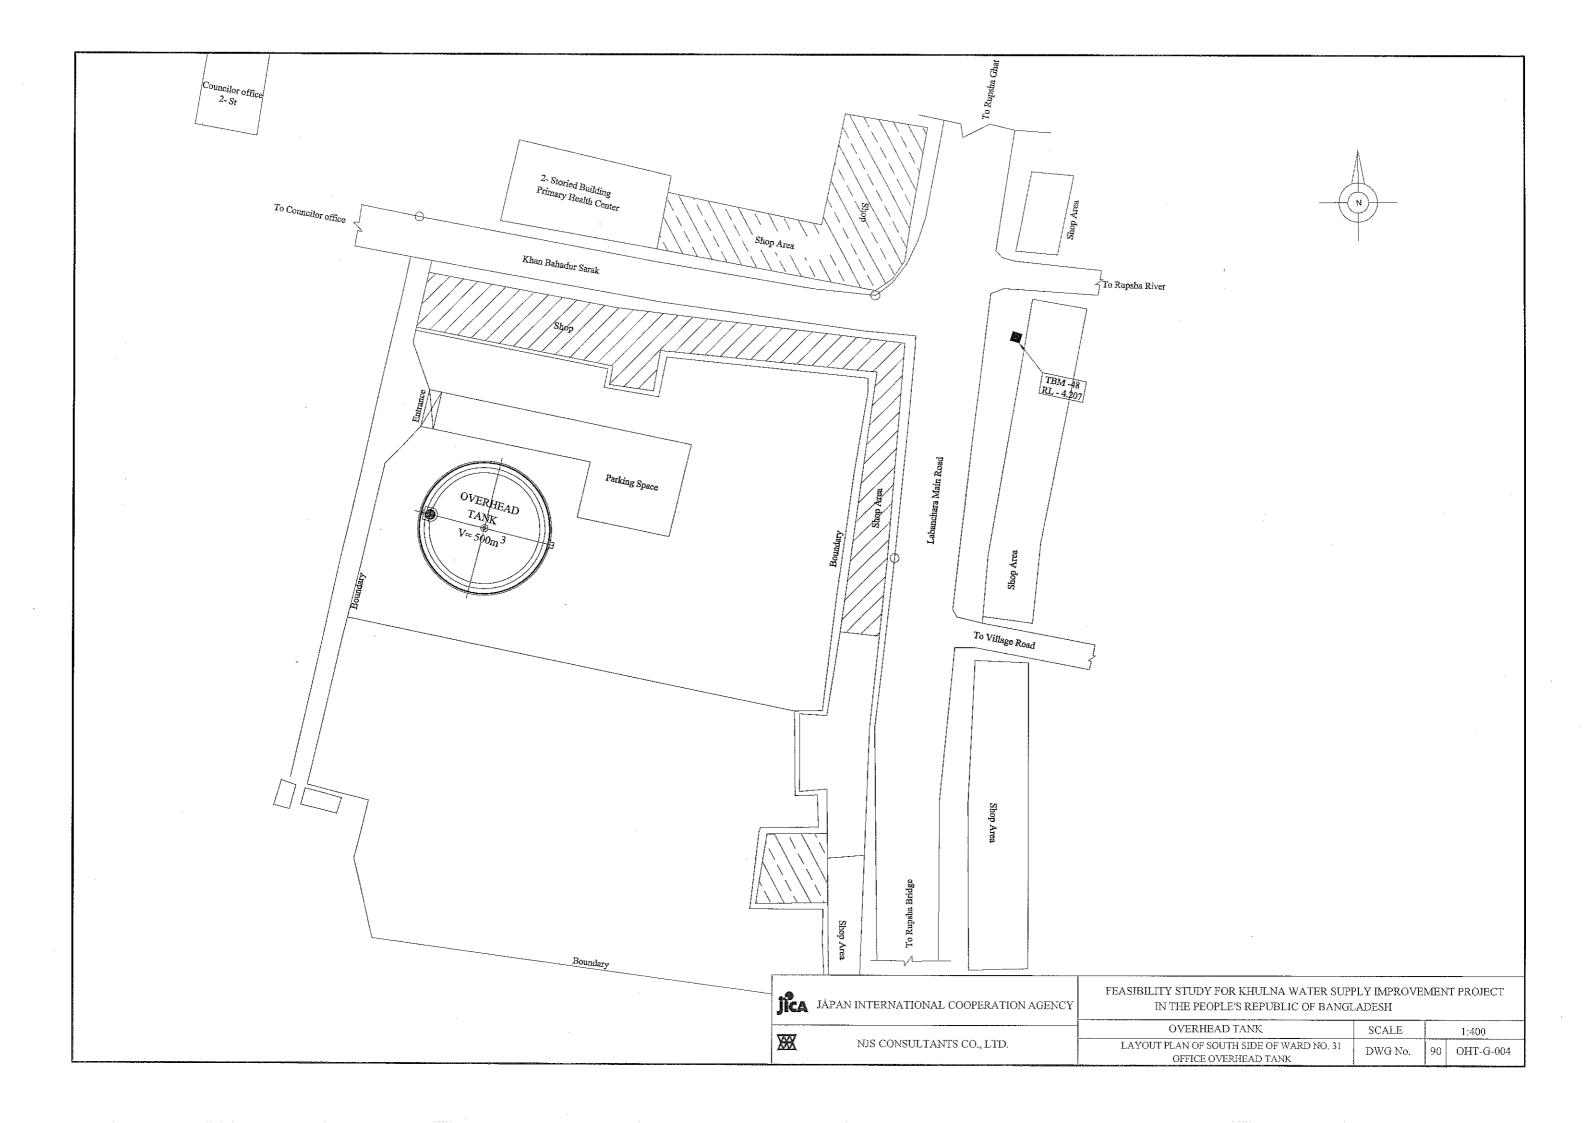


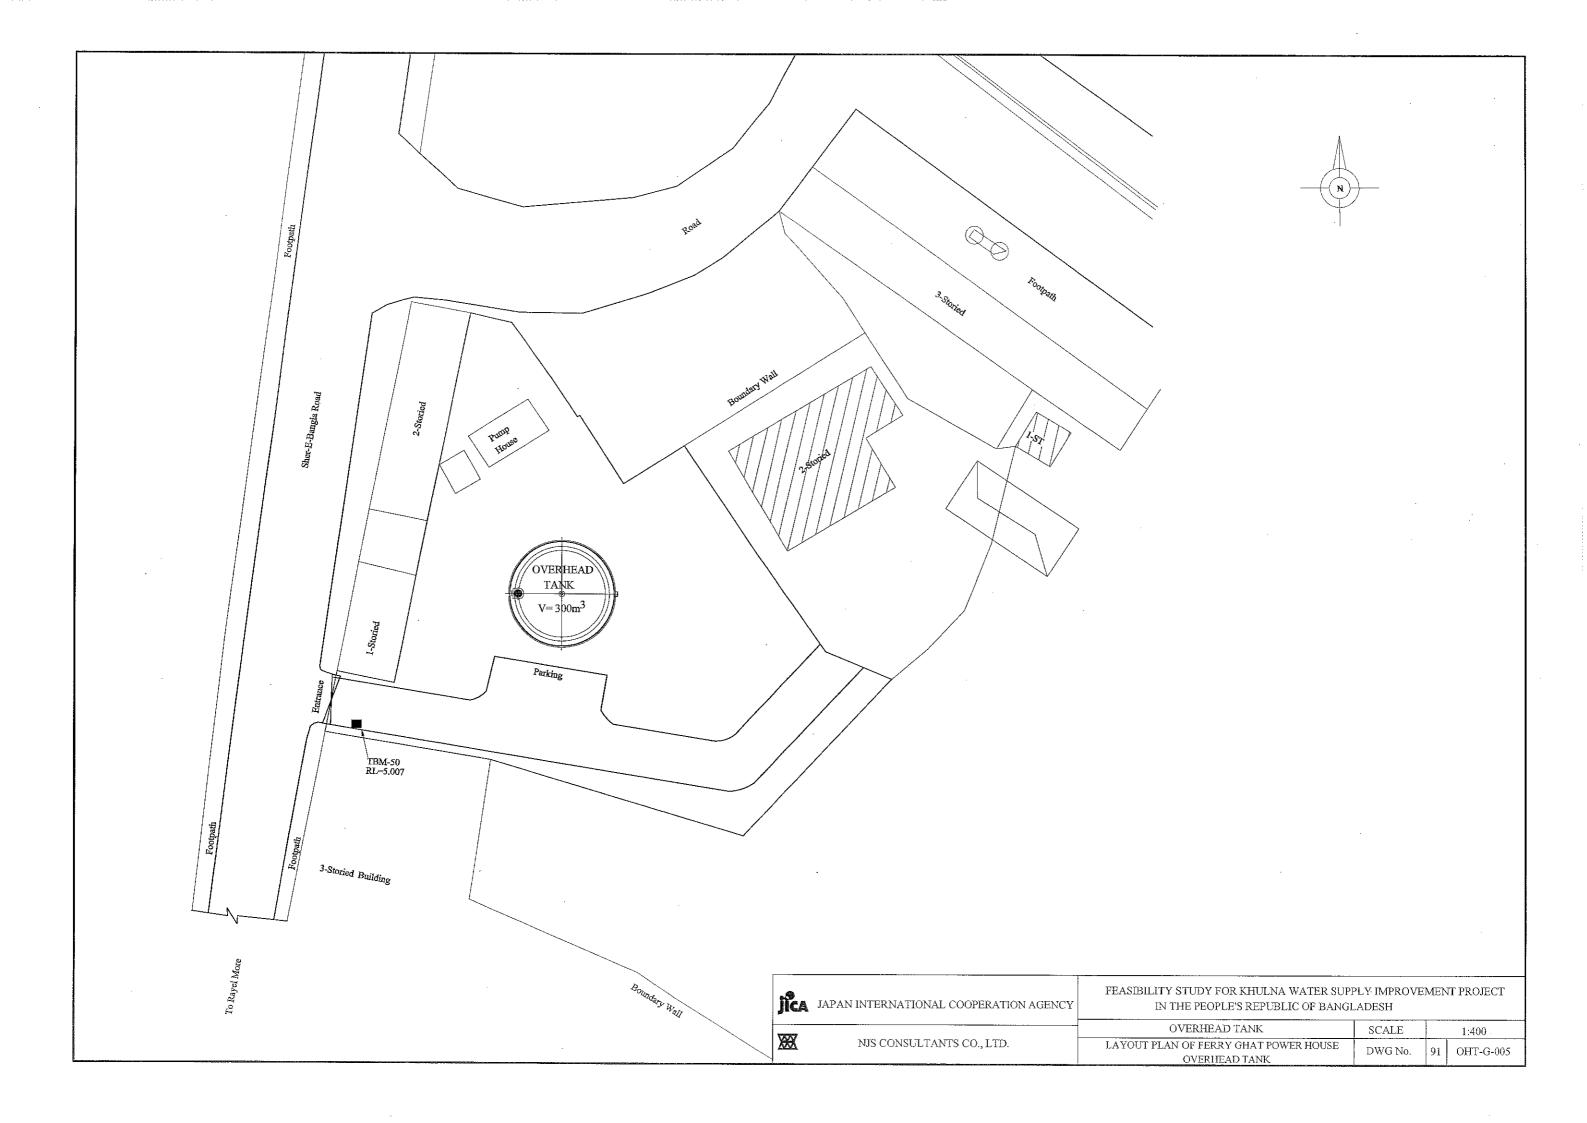

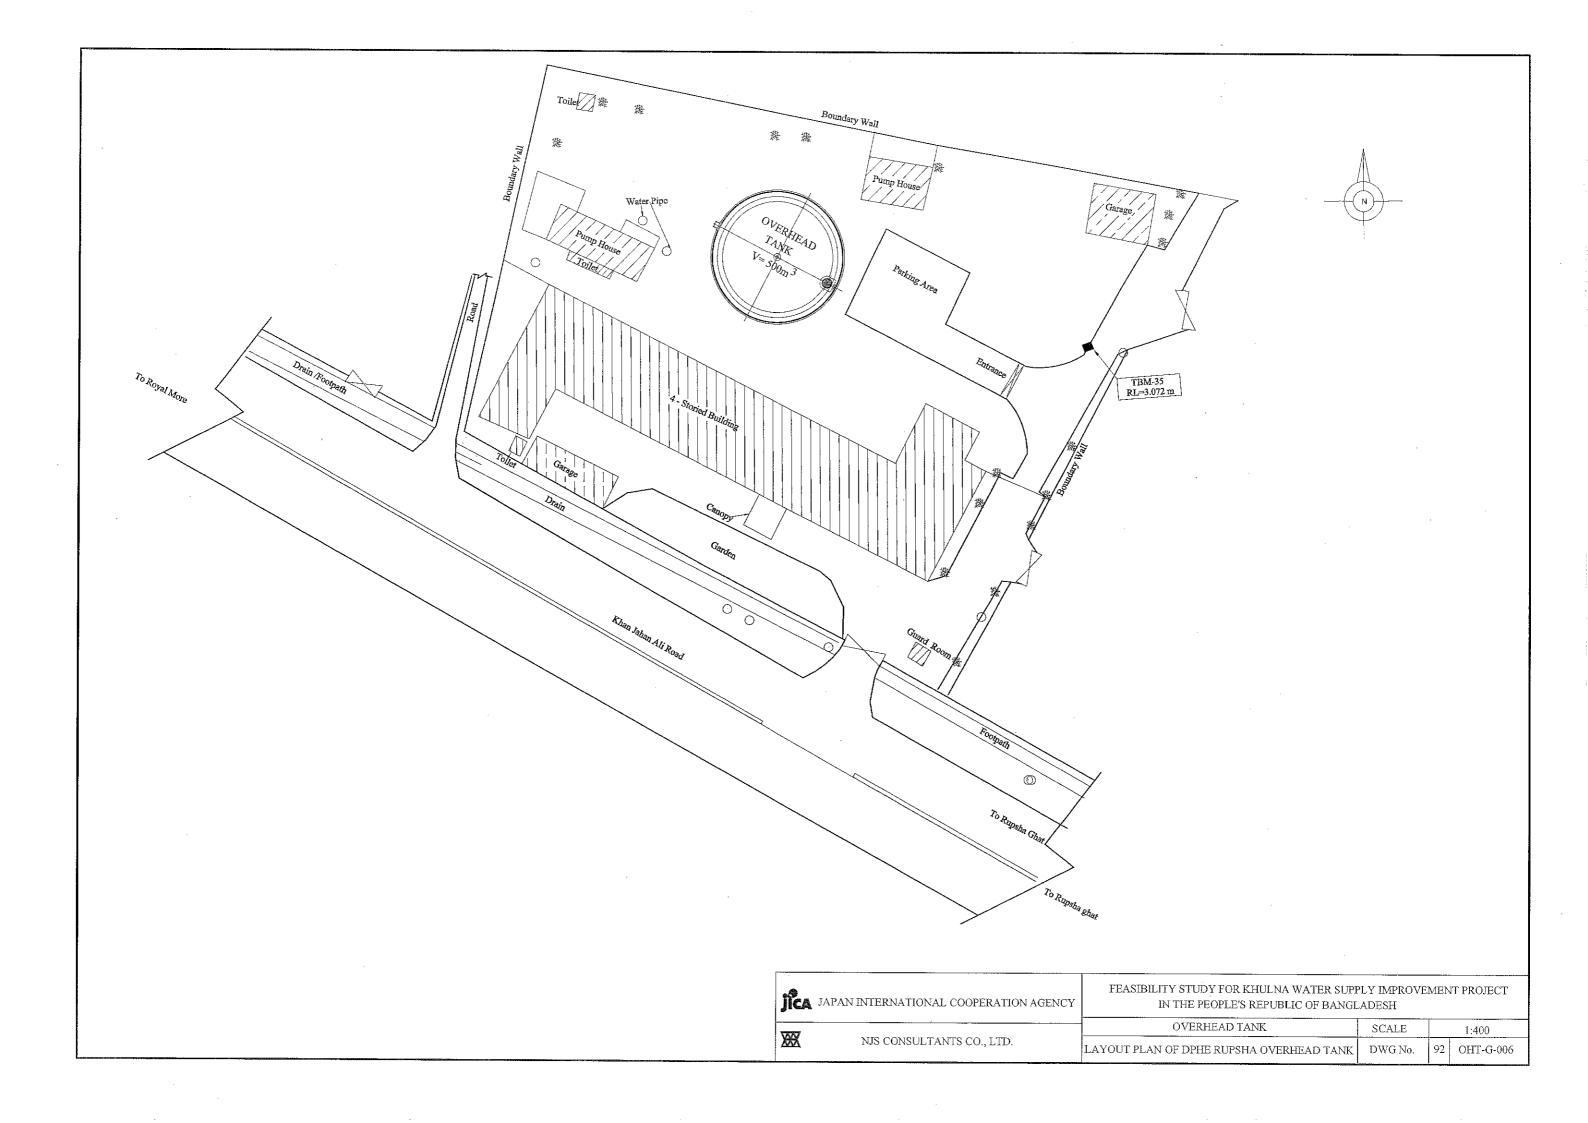

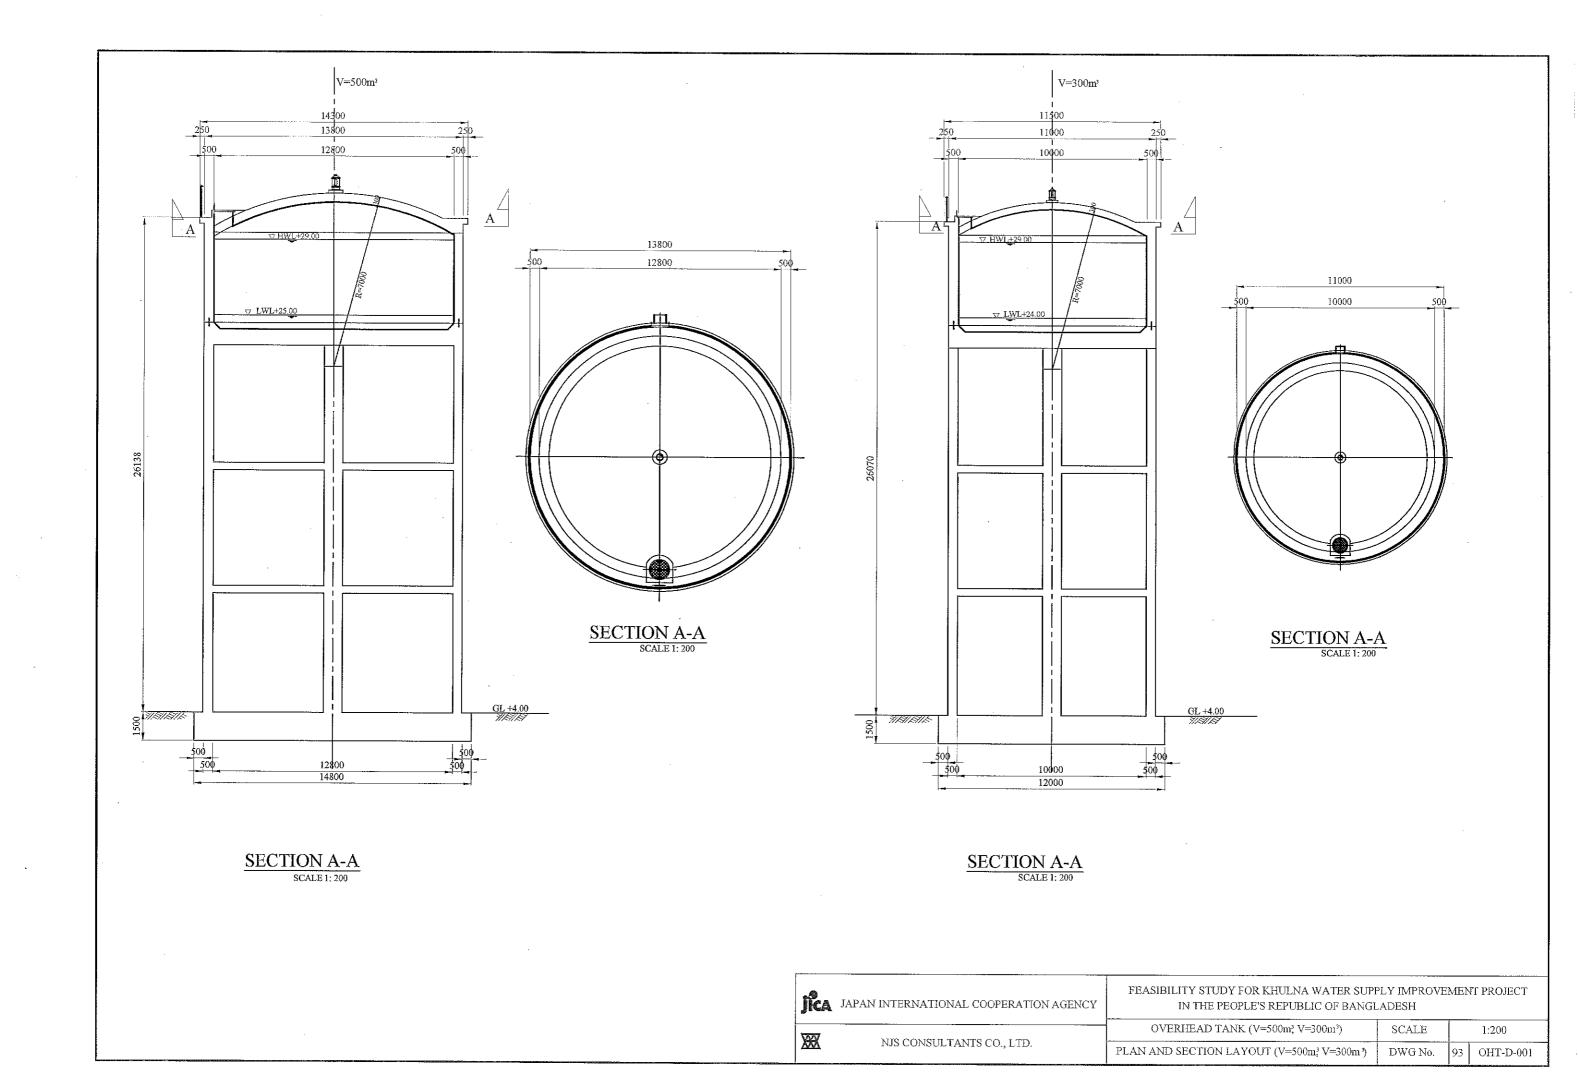

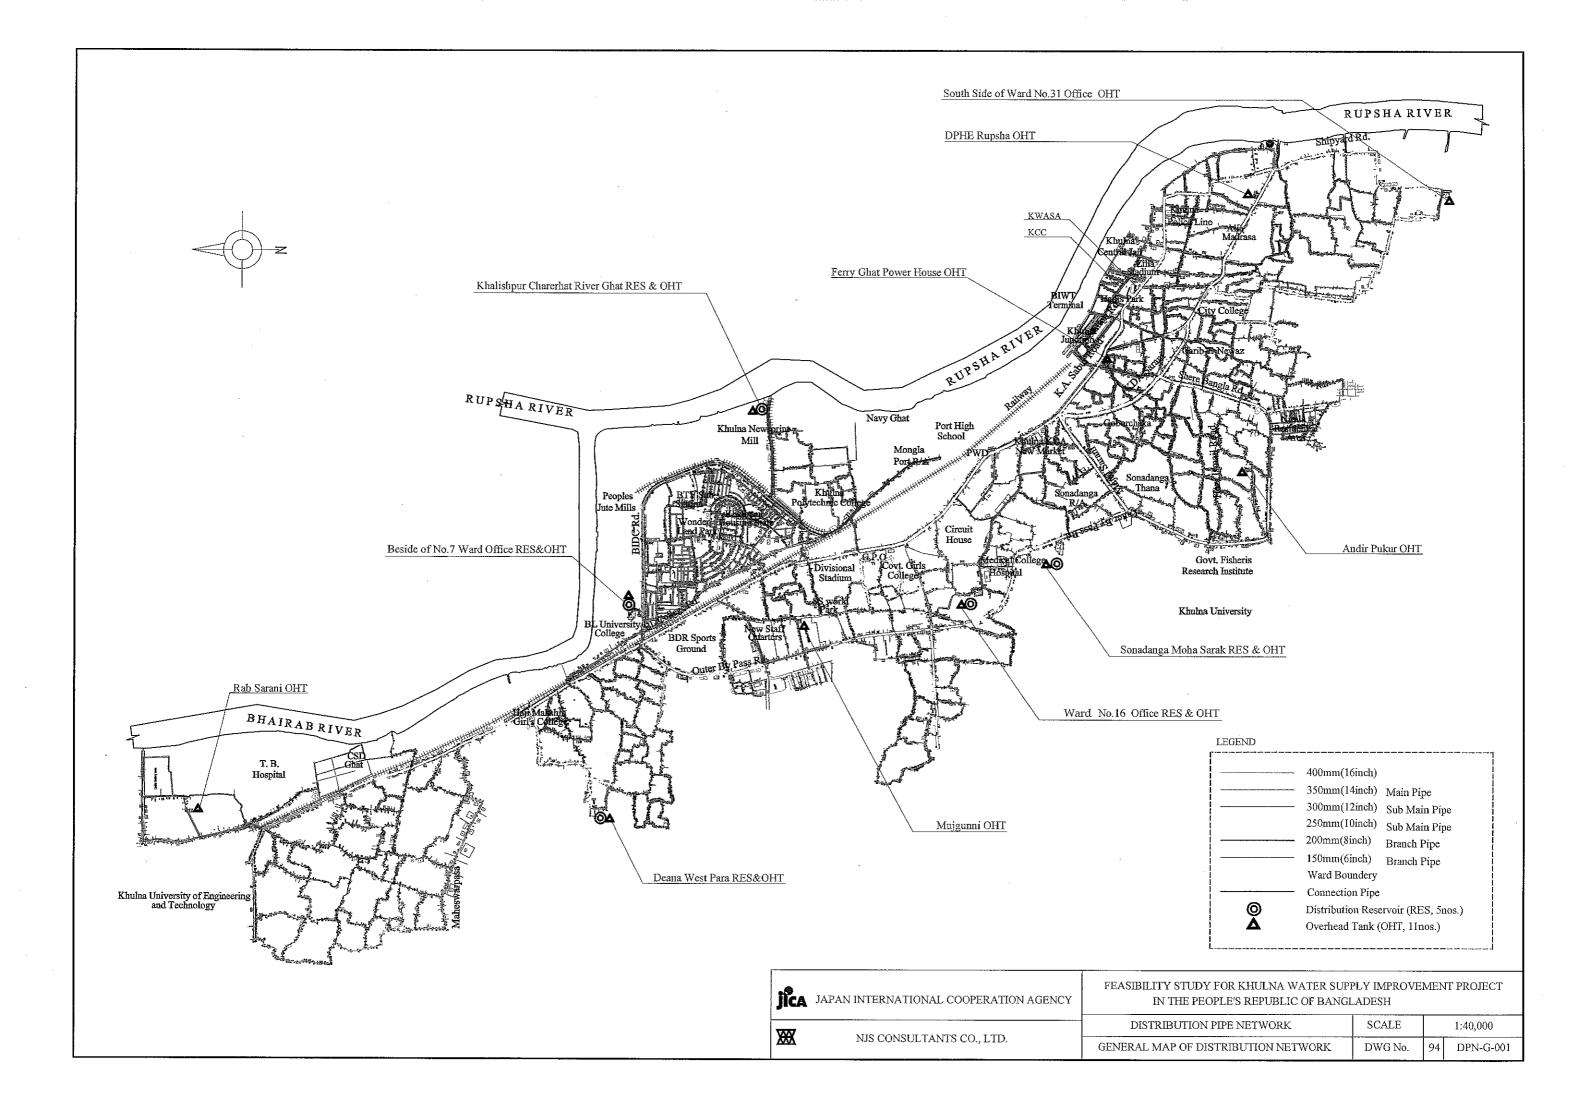


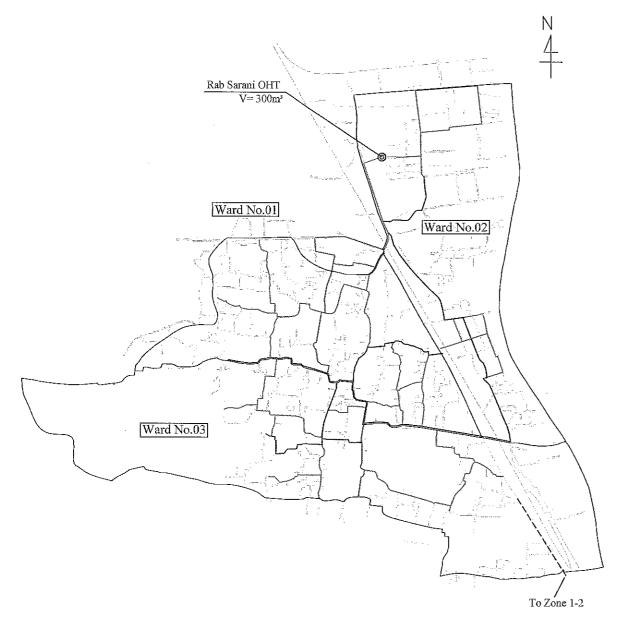


PIPE NETWORK PLAN (ZONE 1-1).

Water Service Area: Ward No.1, 2 & 3 SCALE 1:30,000

LEGEND

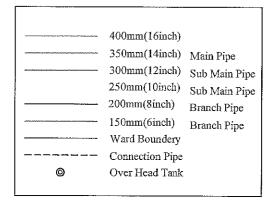


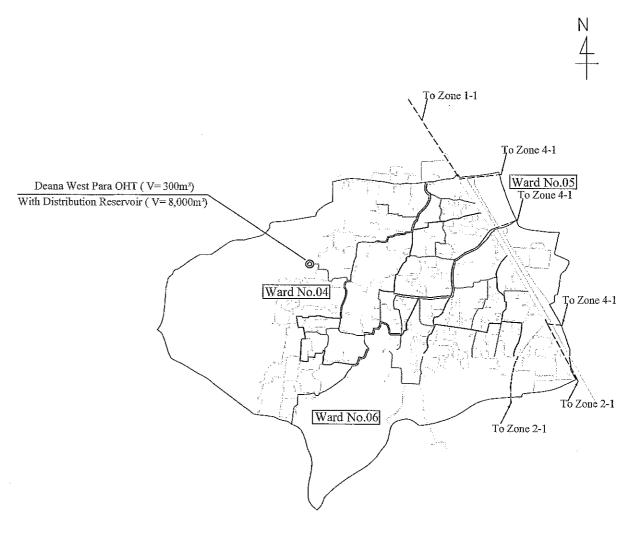


PIPE NETWORK PLAN (ZONE 1-2)

Water Service Area: Ward No.4, 5 & 6
SCALE 1:30,000

jica	JAPAN INTERNATIONAL COOPERATION AGENCY	FEASIBILITY STUDY FOR KHULNA WATER SUPPLY IMPROVEMENT PROJECT IN THE PEOPLE'S REPUBLIC OF BANGLADESH			
700	NYS CONTENTS OF STATE	DISTRIBUTION PIPE	SCALE	1:30,000	
XX	NJS CONSULTANTS CO., LTD.	PIPE NETWORK PLAN (ZONE-1) (MORE THAN Ø 50mm)	DWG No.	95 DPN-PNP-001	

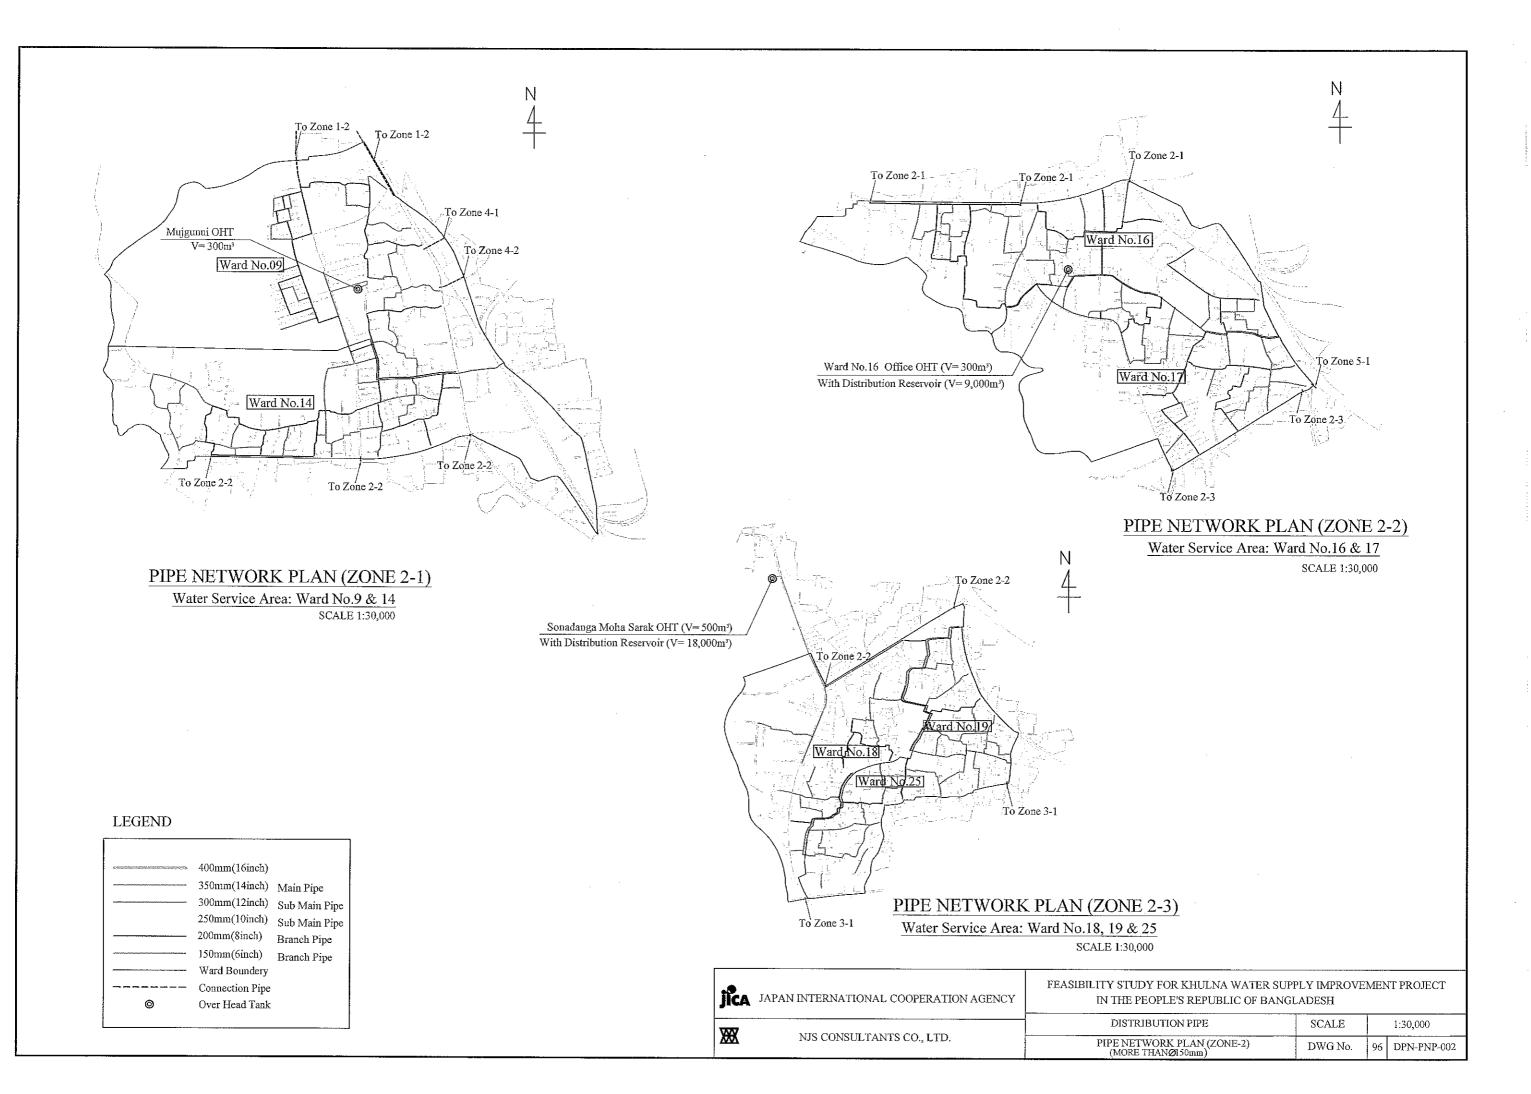


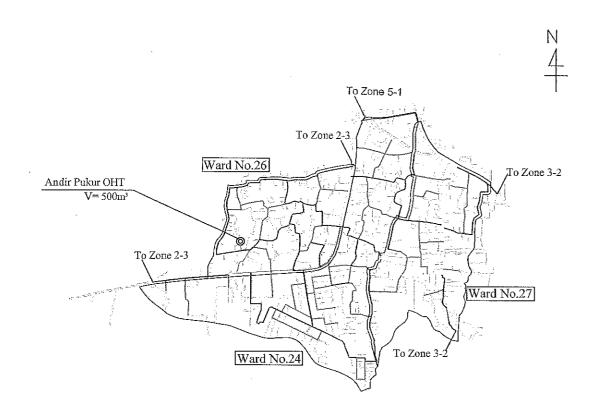

PIPE NETWORK PLAN (ZONE 3-1)

Water Service Area: Ward No.24, 26 & 27 SCALE 1:30,000


LEGEND		
· · · · · · · · · · · · · · · · · · ·	400mm(16inch) 350mm(14inch) 300mm(12inch) 250mm(10inch) 200mm(8inch) 150mm(6inch) Ward Boundery Connection Pipe Over Head Tank	Main Pipe Sub Main Pipe Sub Main Pipe Branch Pipe Branch Pipe

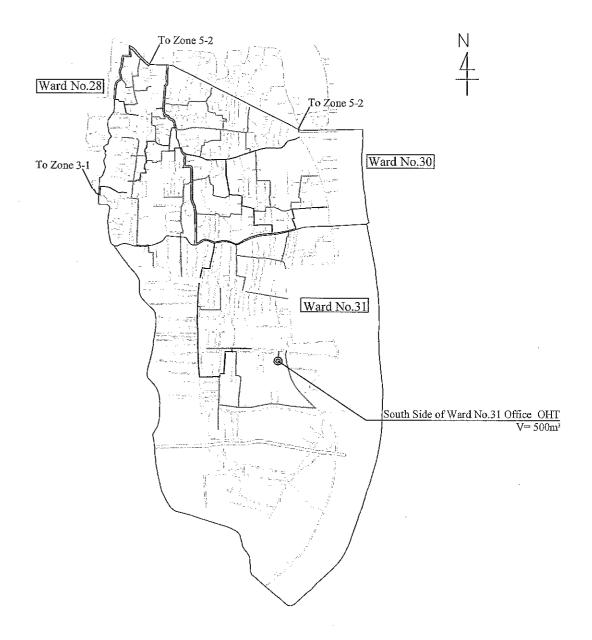

PIPE NETWORK PLAN ZONE (3-2)

Water Service Area: Ward No.28, 30 & 31
SCALE 1:30,000

jica	JAPAN INTERNATIONAL COOPERATION AGENCY	FEASIBILITY STUDY FOR KHULNA WATER SUPPLY IMPROVEMENT PROJECT IN THE PEOPLE'S REPUBLIC OF BANGLADESH		
707	NIA GONAVA TA TRA COLUMN	DISTRIBUTION PIPE	SCALE	1:30,000
XX	NJS CONSULTANTS CO., LTD.	PIPE NETWORK PLAN (ZONE-3) (MORE THANØ150mm)	DWG No.	97 DPN-PNP-003

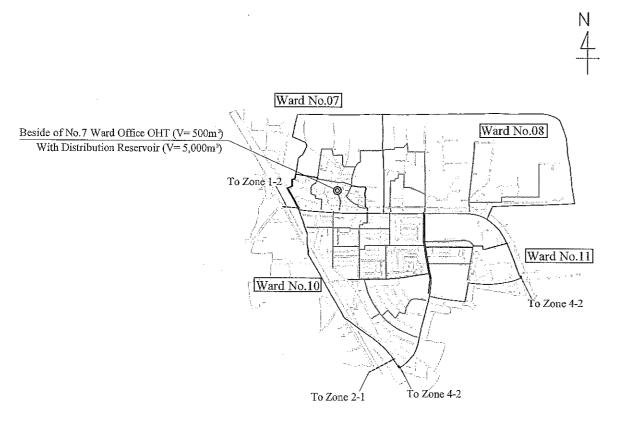


PIPE NETWORK PLAN (ZONE 4-1)

Water Service Area: Ward No.7, 8, 10 & 11

SCALE 1:30,000


LEGEND 400mm(16inch) 350mm(14inch) Main Pipe 300mm(12inch) Sub Main Pipe 250mm(10inch) Sub Main Pipe 200mm(8inch) Branch Pipe 150mm(6inch) Branch Pipe Ward Boundery Connection Pipe Over Head Tank

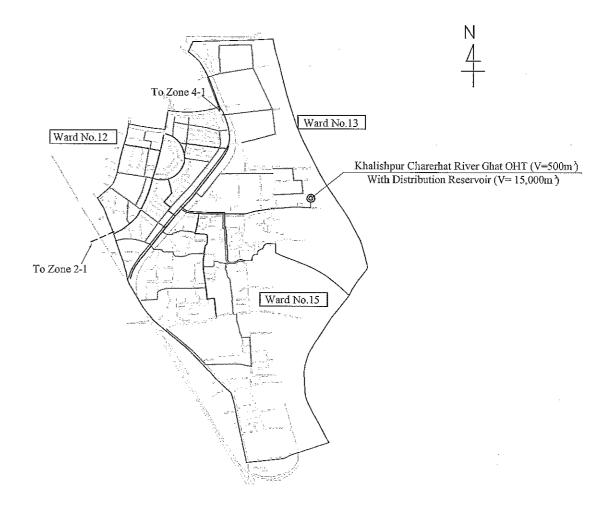

PIPE NETWORK PLAN (ZONE 4-2)

Water Service Area: Ward No.12, 13 & 15
SCALE 1:30,000

JAPAN INTERNATIONAL COOPERATION AGENCY FEASIBILITY STUDY FOR KHULNA WATER SUPPLY IMPROVEMENT IN THE PEOPLE'S REPUBLIC OF BANGLADESH			EMENT PROJECT	
7877		DISTRIBUTION PIPE	SCALE	1:30,000
XX	NJS CONSULTANTS CO., LTD.	PIPE NETWORK PLAN (ZONE-4)	DWG No.	98 DPN-PNP-004

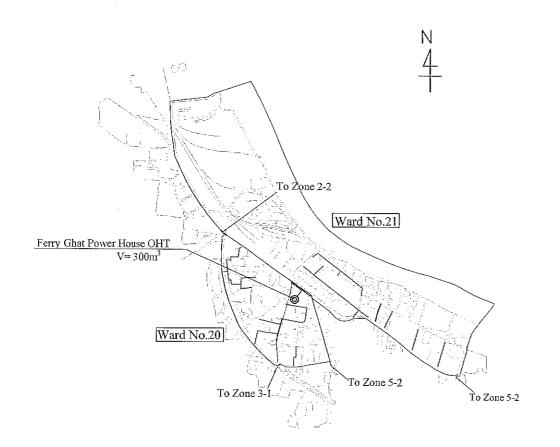

PIPE NETWORK PLAN (ZONE 5-1)

Water Service Area: Ward No.20 & 21 SCALE 1:30,000

PIPE NETWORK PLAN (ZONE 5-2)

To Zone 3-2

Ward No.23

Water Service Area: Ward No.22, 23 & 29

Ward No.29

DPHE Rupsha OHT V= 300m³ (Existing)

SCALE 1:30,000

To Zone 3-2

LEGEND

400mm(16inch)

350mm(14inch) Main Pipe

300mm(12inch) Sub Main Pipe

250mm(10inch) Sub Main Pipe

200mm(8inch) Branch Pipe

150mm(6inch) Branch Pipe

Ward Boundery

Connection Pipe

Over Head Tank

JAPAN INTERNATIONAL COOPERATION AGENCY

FEASIBILITY ST

FEASIBILITY STUDY FOR KHULNA WATER SUPPLY IMPROVEMENT PROJECT IN THE PEOPLE'S REPUBLIC OF BANGLADESH

Ward No.22

DISTRIBUTION PIPE SCALE 1:30,000

NJS CONSULTANTS CO., LTD.

PIPE NETWORK PLAN (ZONE-5) (MORE THANØ150mm)

DWG No. 99 DPN-PNP-005

