PACKAGE-A

THE PROJECT FOR IMPROVEMENT OF NATIONAL ROAD NO.57


LIST OF DRAWING					
SN	DRAWING TITLE	DRAWING No.			
1	DRAWING INDEX	A-01			
2	LOCATION MAP	A-02			
3	ABBREVIATIONS	A-03			
4	4 TYPICAL CROSS SECTIONS A-0				
5	PLAN AND PROFILE	A-05 TO A-34			
6	CROSS SECTIONS	A-35 TO A-40			
7	BRIDGE No. 1 STA. 40+693 & BRIDGE No. 2 STA. 41+788	A-41			
′	ELEVATION AND SECTION				
8	BRIDGE No. 3 STA. 51+724 & BRIDGE No. 4 STA. 58+814	A-42			
	ELEVATION AND SECTION				
9	BRIDGE No. 5 STA. 59+991 & BRIDGE No. 6 STA. 63+089	A-43			
9	ELEVATION AND SECTION				
10	BRIDGE No. 7 STA. 65+279 & BRIDGE No. 8 STA. 68+198	A-44			
10	ELEVATION AND SECTION				
11	BRIDGE No. 9 STA. 72+946 & BRIDGE No. 10 STA. 81+945	A-45			
	ELEVATION AND SECTION				
12	BRIDGE No. 11 STA. 83+060 & BRIDGE No. 12 STA.89+838	A-46			
12	ELEVATION AND SECTION				

LIST OF DRAWING					
SN	DRAWING TITLE	DRAWING No.			
13	BOREHOLE LOGS	A - 47			
14	TYPE 1 BOX CULVERT (RCBC-1)	A-48			
	PLAN AND ELEVATION	A-40			
15	TYPE 2 BOX CULVERT (RCBC-2)	A-49			
15	PLAN AND ELEVATION	A-49			
16	TYPE 3 BOX CULVERT (RCBC-3)	A-50			
	PLAN AND ELEVATION	A-30			
17	STANDARD PIPE CULVERTS	A - 51			
17	PLAN AND ELEVATIONS	A-51			
18	SIDE DITCH AND BRIDGE SLOPE PROTECTION	A-52			
19	GUARDRAIL	A-53			
19	TYPICAL DETAILS	A-33			
20	DELINEATION AND GUIDE POSTS INSTALLATION DETAILS	A-54			
21	KILOMETER POST	A-55			
22	ROADSIDE SIGN	A-56			
23	RUMBLE STRIPS	A-57			
24	TRANSVERSE AND LONGITUDINAL MARKINGS	A-58			



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Cnr Norodom Blvd & St 106, Phnom Penh, Kingdom Cambodia Tel : (855) 23 426099 - Fax : (855) 23 426098 TITLE:

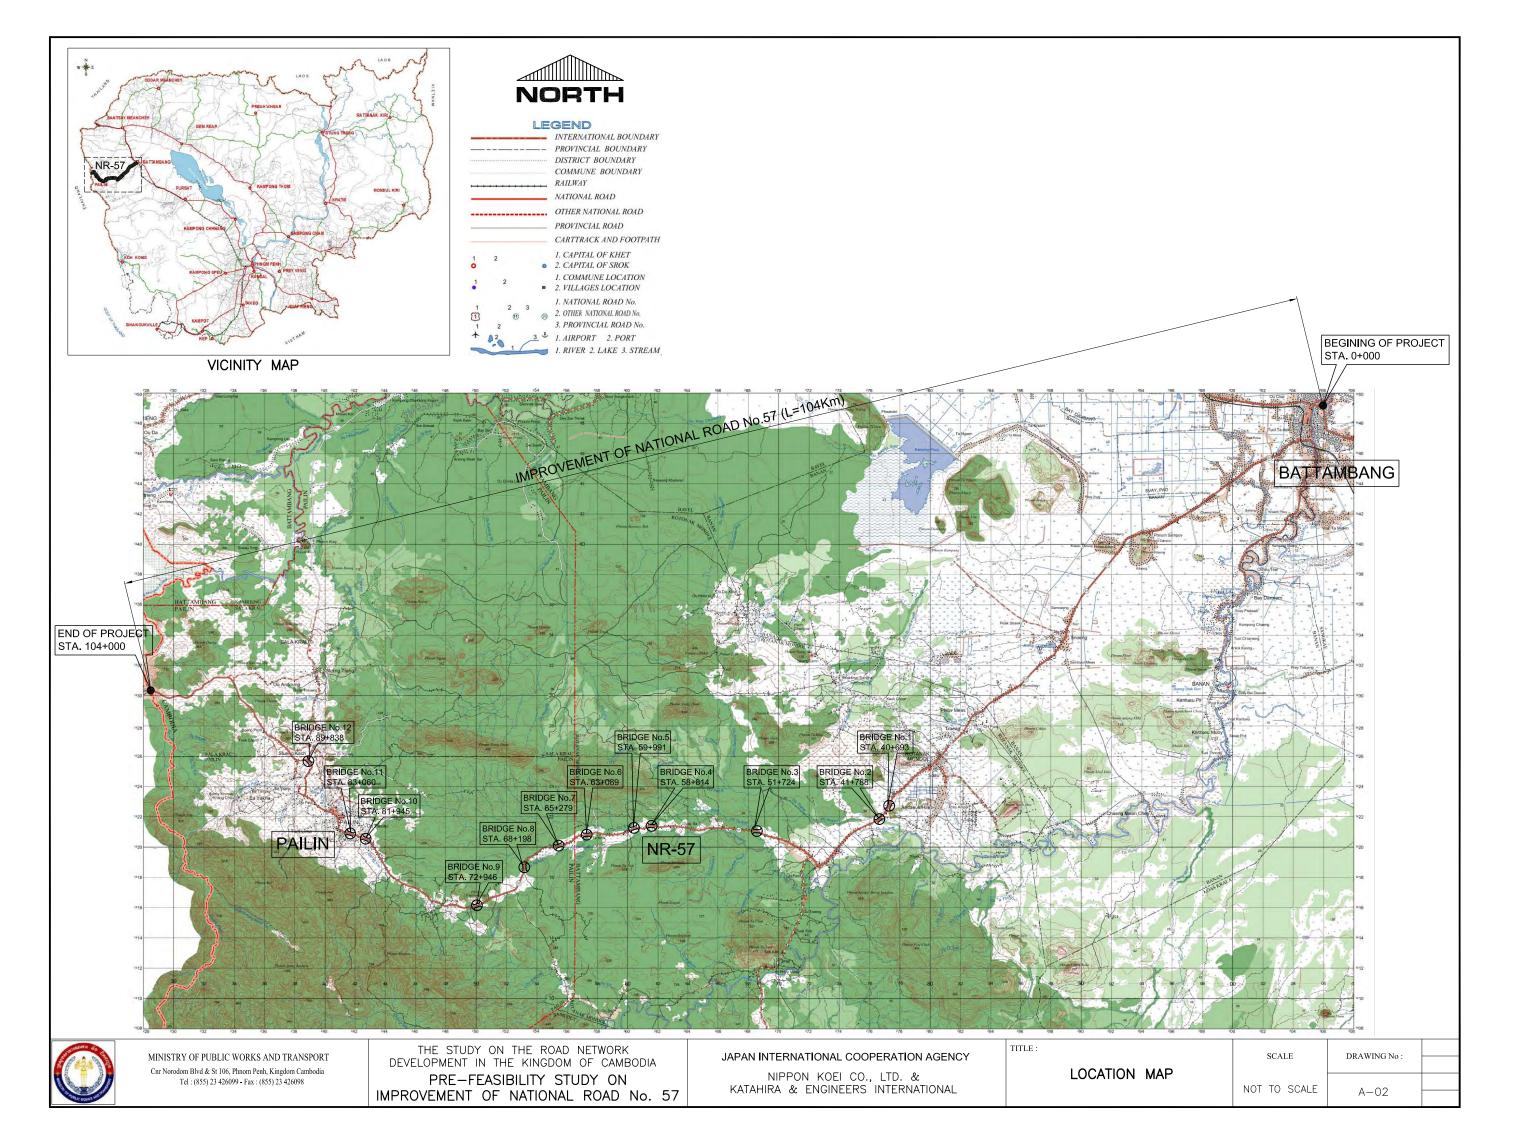



ABBREVIATIONS


AMP	AMPERE	DWG	DRAWING	L.V.C	LENGTH OF VERTICAL CURVE	RERD	RELOCATION OF ROAD
Α	CLOTHOID PARAMETER	Ε	EASTING	М	METER	REWY	RELOCATION OF WATERWAY
AC	ALTERNATING CURRENT	EB	EAST BOUND	м ² , м2	SQUARE METER	R.O.W	RIGHT OF WAY
AC	ASPHALT CONCRETE	ELEV(EL)	ELEVATION	м ³ , м3	CUBIC METER	RP	RADIUS POINT
AD	ABSOLUTE DIFFERENCE	EGL	EXISTING GROUND LEVEL	MAX	MAXIMUM	RT	RIGHT SIDE OF ALIGNMENT
AIFB	ASPHALT-IMPREGNATED FIBERBOARD	EP	END POINT	MIN	MINIMUM	RW	RETAINING WALL
APPR	APPROACH	EQ	EQUAL	ММ	MILLIMETER	SB	SOUTH BOUND
ASPH	ASPHALT	EXC	EXCAVATION	МО	MIDDLE ORDINATE	SC	SPIRAL CURVE TO CIRCULAR CURVE
вс	BOX CULVERT	EXP	EXPANSION	N	NORTHING	SD	SIDE DICTH
BOR	BORING	EVCS	ENDING OF VERTICAL CURVE STATION	NA, N/A	NOT APPLICABLE	SDBT	SAND BLANKET
BR	BRIDGE	EVCE	ENDING OF VERTICAL CURVE ELEVATION	NB	NORTH BOUND	SM	STONE MANSORY
BRG	BEARING	F	FILL	NC	NORMAL CROWN	SP	SLOPE PROTECTION
BVCS	BEGINING OF VERTICAL CURVE STATION	F	FIXED	NGL	NATURAL GROUND LEVEL	SQ.M	SQUARE METER
BVCE	BEGINING OF VERTICAL CURVE ELEVATION	FF	FACE TO FACE	NH	NATIONAL HIGHWAY	SSP	SURFACE SETTLEMENT PLATE
c/c	CENTER TO CENTER	FG	FINISHED GRADE	NO	NUMBER	ST	SPIRAL CURVE TO TANGENT
CB	CATCH BASIN	FR	FRONTAGE ROAD	NTS	NOT TO SCALE	STA	STATION
CIP	CAST-IN-PLACE	GF	GUARD FENCE	OGL	ORIGINAL GROUND LEVEL	STRUC	STRUCTURE
CL	CENTERLINE	GIR	GIRDER	OV	OVER BRIDGE	STS	SPIRAL TO SPIRAL POINT
СМ	CENTIMETER	GL	GROUND LEVEL	Р	PIPE CULVERT	SURG	SUR-CHARGE
CONC	CONCRETE	GR	GUARD RAIL	PC	BEGINING POINT OF SIMPLE CURVE	SV	SUPERVISION
CONST	CONSTRUCTION	Have	AVERAGE HEIGHT	P.C	PRESTRESSED CONCRETE	Т	THICKNESS
CONT	CONTINUOUS	H.W.L	HIGH WATER LEVEL	PCCP	PORTLAND CEMENT CONCRETE PAVEMENT	TS	TANGENT TO SPIRAL
cs	CIRCULAR CURVE TO SPIRAL CURVE	HWY	HIGHWAY	PH	PLAN HEIGHT	TYP	TYPICAL
CU.M	CUBIC METER	G1,G2	GRADIENT	PI	POINT OF HORIZONTAL INTERSECTION	V	DESIGN SPEED IN kph
CJ	CONSTRUCTION JOINT	INV	INVERT	PR	PROVINCIAL ROAD	VOLT	VOLTAGE
CWB	COUNTER WEIGHT BERM	JT	JOINT	PRC	POINT OF REVERSE CURVE	VC	VERTICAL CURVE
DC	DRAINAGE CATCH BASIN	K	VERTICAL CURVE COEFICIENT	PT	ENDPOINT OF SIMPLE CURVE	W	WIDTH
DFL	DESIGN FLOOD LEVEL	kg	KILOGRAM	PVD	PREFABRICATED VERTICAL DRAIN	WB	WEST BOUND
DI	DRAINAGE INLET	km	KILOMETER	PVI	POINT OF VERTICAL INTERSECTION	WHM	WATT HOUR METER
DIA or Ø	DIAMETER	kph	KILOMETER PER HOUR	P.W	PARAPET WALL	X	EASTING COORDINATE IN METERS
DL	DATUM LINE	L	LEFT	R	RIGHT	Υ	NORTHING COORDINATE IN METERS
DO	DRAINAGE OUTLET	L	LENGTH	R	RADIUS OF CIRCULAR CURVE	0	AT
DS	DRAINAGE SIDE DITCH	LA	LAND ACQUISITION	R.C	REINFORCED CONCRETE	&	AND
DSP	DEEP SETTLEMENT PLATE	L.M	LINEAR METER	R.C.B.C	REINFORCED CONCRETE BOX CULVERT	%	PERCENT
DW	MOTARED RUBBLE PAVED WATERWAY	LT	LEFT SIDE OF ALIGNMENT	R.C.P.C	REINFORCED CONCRETE PIPE CULVERT		




ITLE:	SCALE	DRAWING No :	
	SCALE	DRAWING NO:	
ABBREVIATIONS	NTS	4 07	
	1113	A-03	

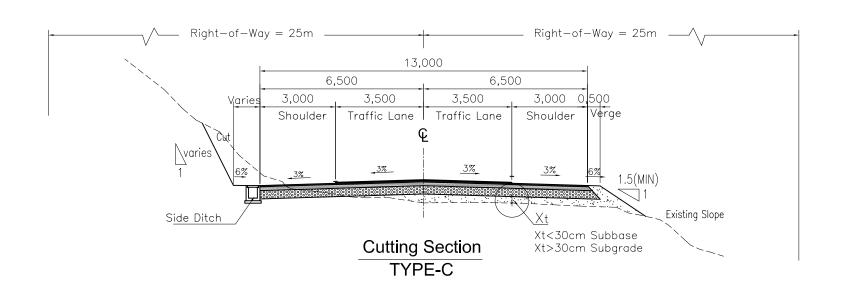

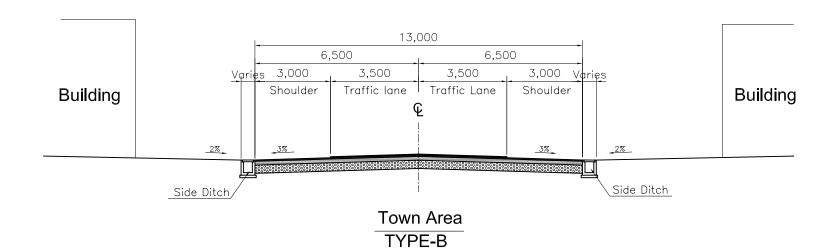

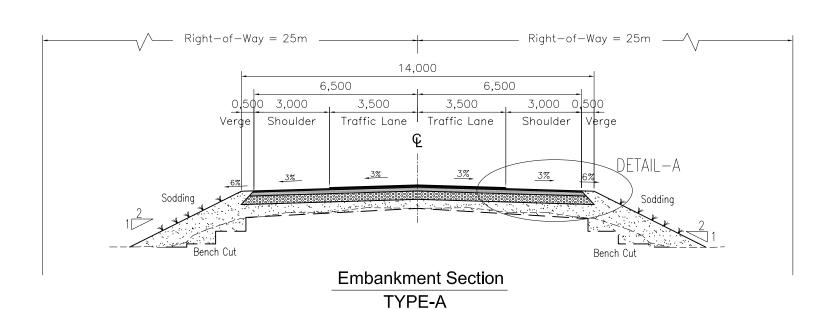

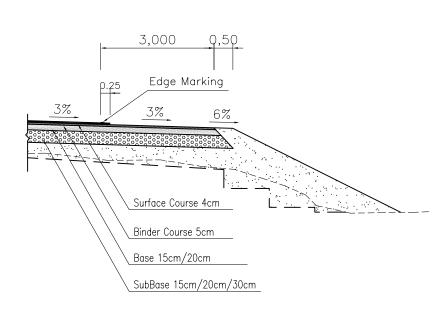

DETAIL-A

Scale 1:100

Section		Asphalt (Concrete	D. a. a.	Clab as a	
From	To	Surface	Binder	Base	Subbase	
Km0	Km17	4 cm	5 cm	20 cm	25 cm	
Km17	Km50	4 cm	5 cm	15 cm	20 cm	
Km50	Km104	4 cm	5 cm	15 cm	15 cm	



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THE STUDY ON THE ROAD NETWORK DEVELOPMENT IN THE KINGDOM OF CAMBODIA

PRE-FEASIBILITY STUDY ON IMPROVEMENT OF NATIONAL ROAD NO.57 JAPAN INTERNATIONAL COOPERATION AGENCY NIPPON KOEI CO., LTD. & KATAHIRA & ENGINEERS INTERNATIONAL

SCALE DRAWING No: TYPICAL CROSS SECTIONS 1:150 A-04

