



1 PLAN SCALE 1:100

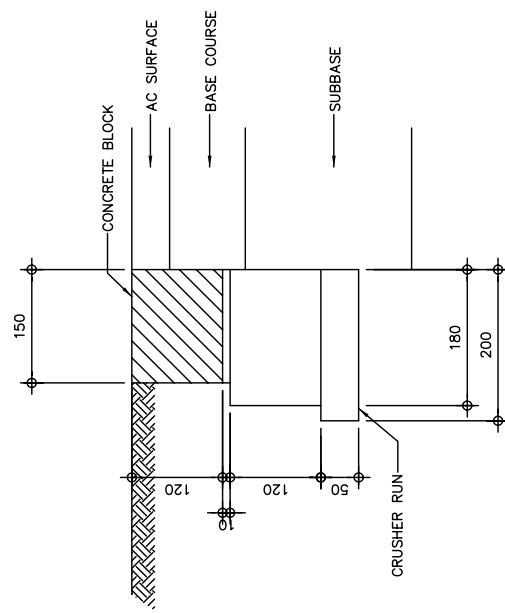


3 DETAIL "A" SCALE 1:100

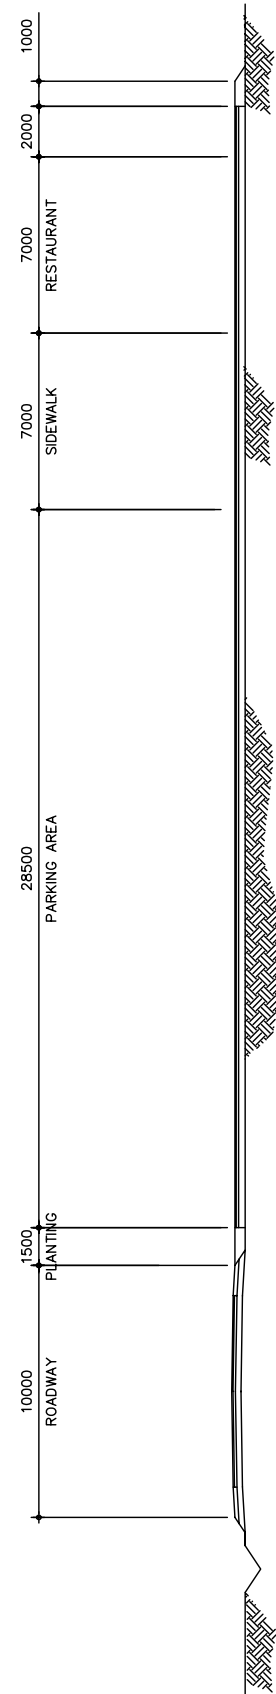


2 CROSS SECTION "A" SCALE 1:600

図 3-2-3-27 道の駅 (Section II 新設区間)


THE BASIC DESIGN STUDY ON CONSTRUCTION OF EASTERN ARTERIAL ROAD IN MONGOLIA	
JAPAN INTERNATIONAL COOPERATION AGENCY (JICA)	DEPARTMENT OF ROADS, MINISTRY OF INFRASTRUCTURE, THE GOVERNMENT OF MONGOLIA
PACIFIC CONSULTANTS INTERNATIONAL JAPAN OVERSEAS CONSULTANTS	Scale
Drawing title	Sheet No.
ROAD STATION (STAGE-I)	AS SHOWN
	G-1 1/1

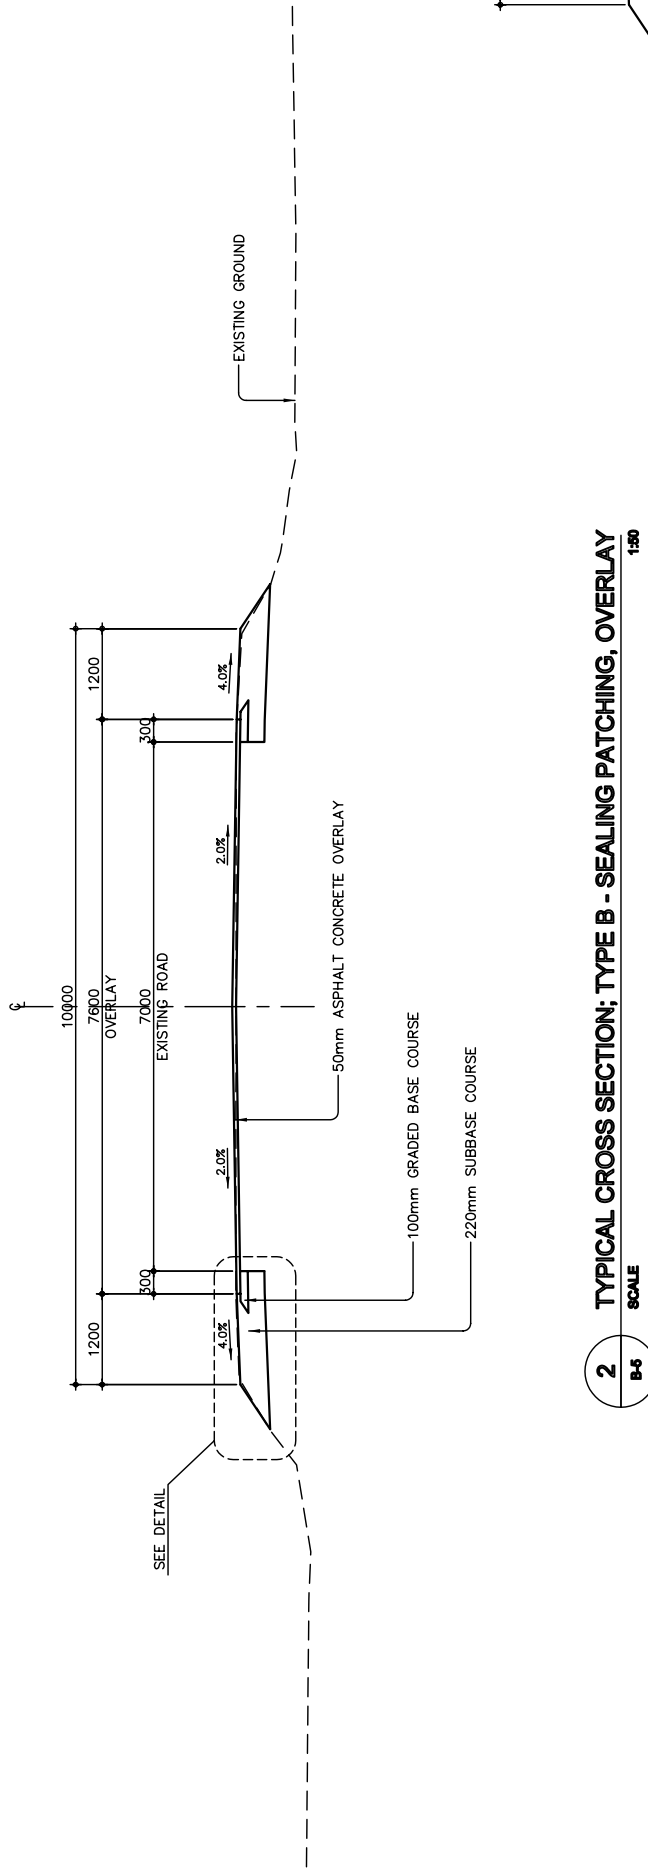

2 TYPICAL CROSS SECTION; TYPE B - SEALING PATCHING, OVERLAY
SCALE 1:50

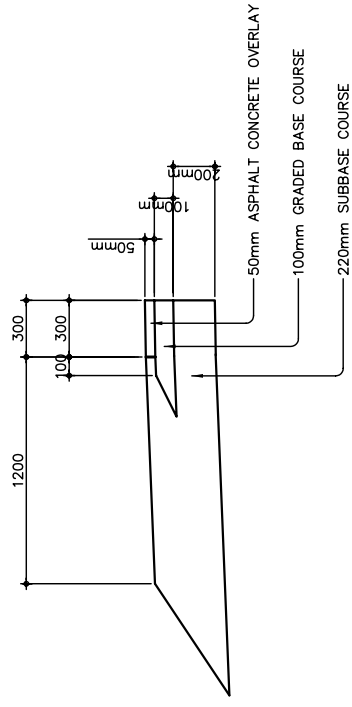


3 DETAIL
SCALE 1:40

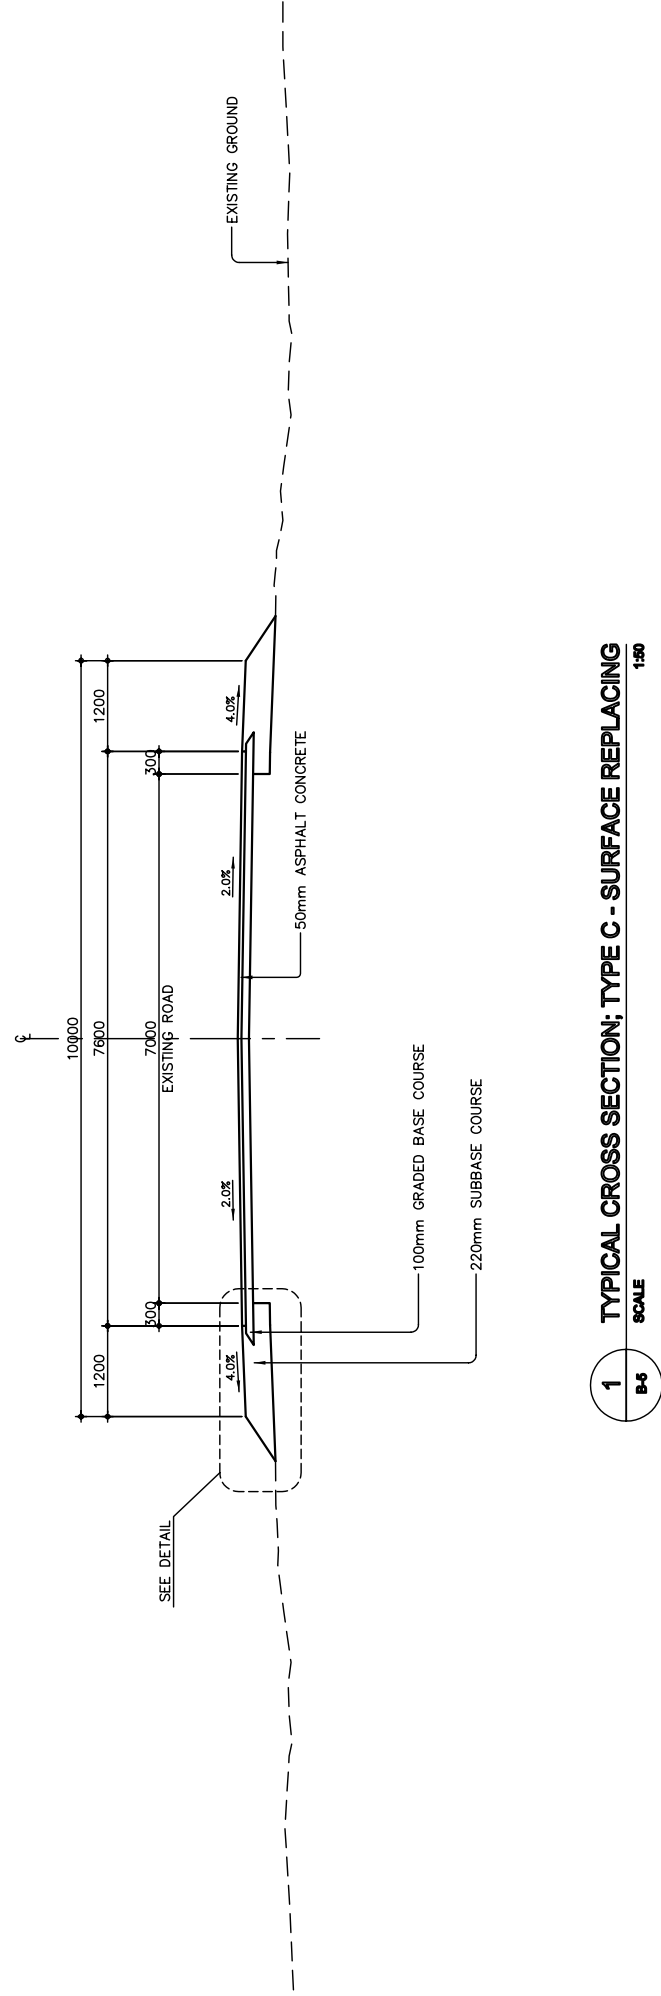


1 TYPICAL CROSS SECTION; TYPE C - SURFACE REPLACING
SCALE 1:50

図 3-2-3-28 道路標準断面図(1)タイプBおよびC (Section II 現道補修区間)

THE BASIC DESIGN STUDY ON CONSTRUCTION OF EASTERN ARTERIAL ROAD IN MONGOLIA	
JAPAN INTERNATIONAL COOPERATION AGENCY (JICA)	DEPARTMENT OF ROADS, MINISTRY OF INFRASTRUCTURE, THE GOVERNMENT OF MONGOLIA
PACIFIC CONSULTANTS INTERNATIONAL JAPAN OVERSEAS CONSULTANTS	Scale AS SHOWN
Drawing title TYPICAL ROADWAY SECTION TYPE "B" AND TYPE "C" (STAGE-2)	Sheet No. B-5 5/6

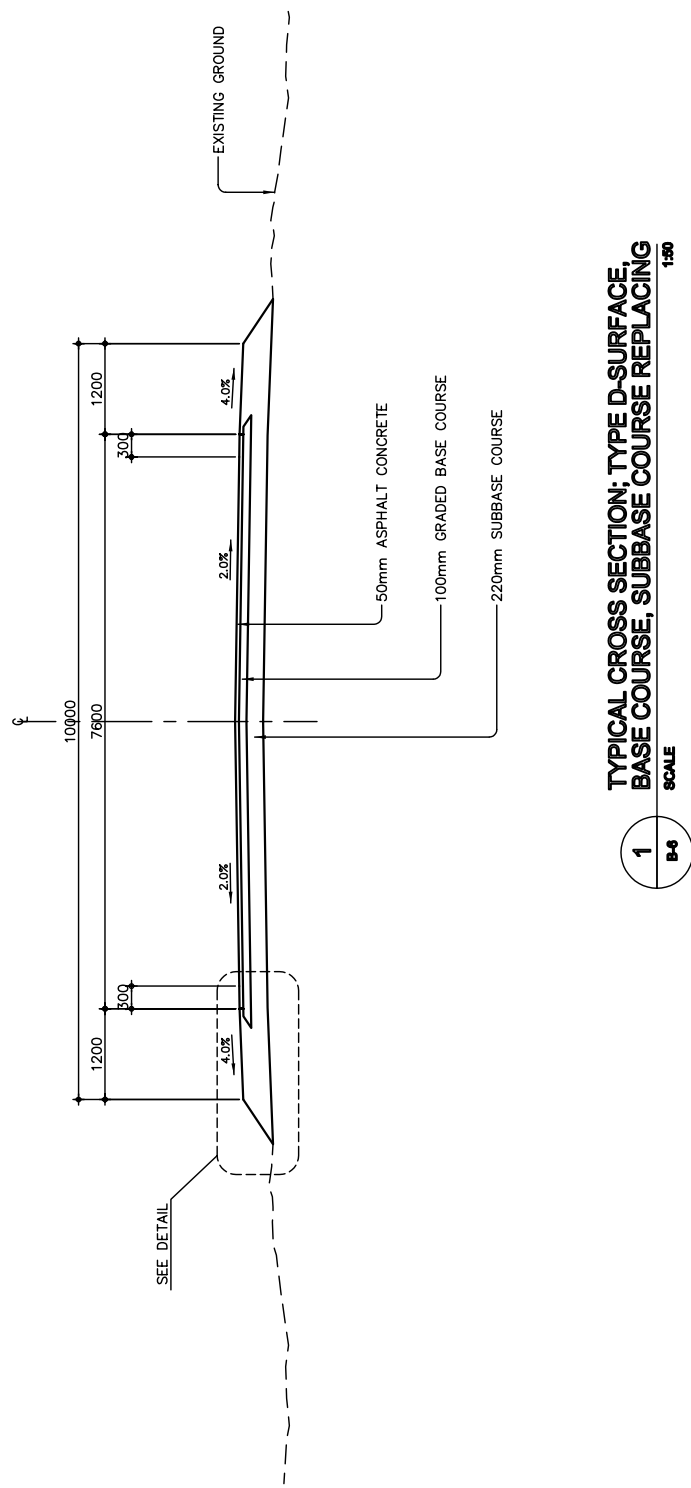

1
B-5
SCALE 1:40

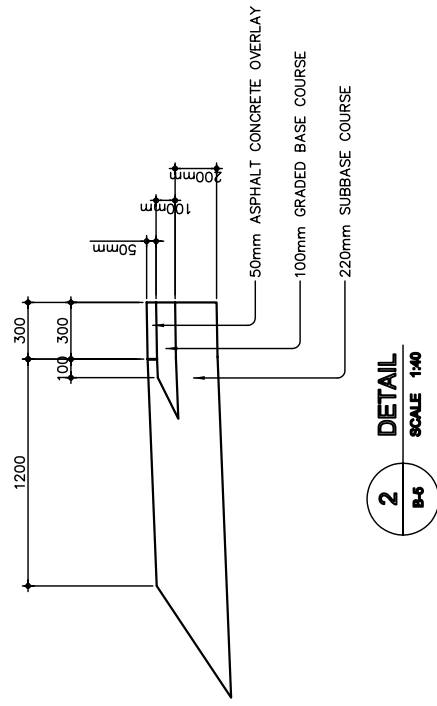


2
B-5
SCALE 1:40

図 3-2-3-29 道路標準断面図(2)タイプD (Section II 現道補修区間)


THE BASIC DESIGN STUDY ON CONSTRUCTION OF EASTERN ARTERIAL ROAD IN MONGOLIA	
JAPAN INTERNATIONAL COOPERATION AGENCY (JICA)	DEPARTMENT OF ROADS, MINISTRY OF INFRASTRUCTURE, THE GOVERNMENT OF MONGOLIA
PACIFIC CONSULTANTS INTERNATIONAL JAPAN OVERSEAS CONSULTANTS	Scale AS SHOWN
Drawing title TYPICAL ROADWAY SECTION (TYPE-D) (STAGE-2)	Sheet No. B-6 6/6

CONSTRUCTION PLAN (1/3) (KHUJIRT BRIDGE)

PLAN scale 1:600

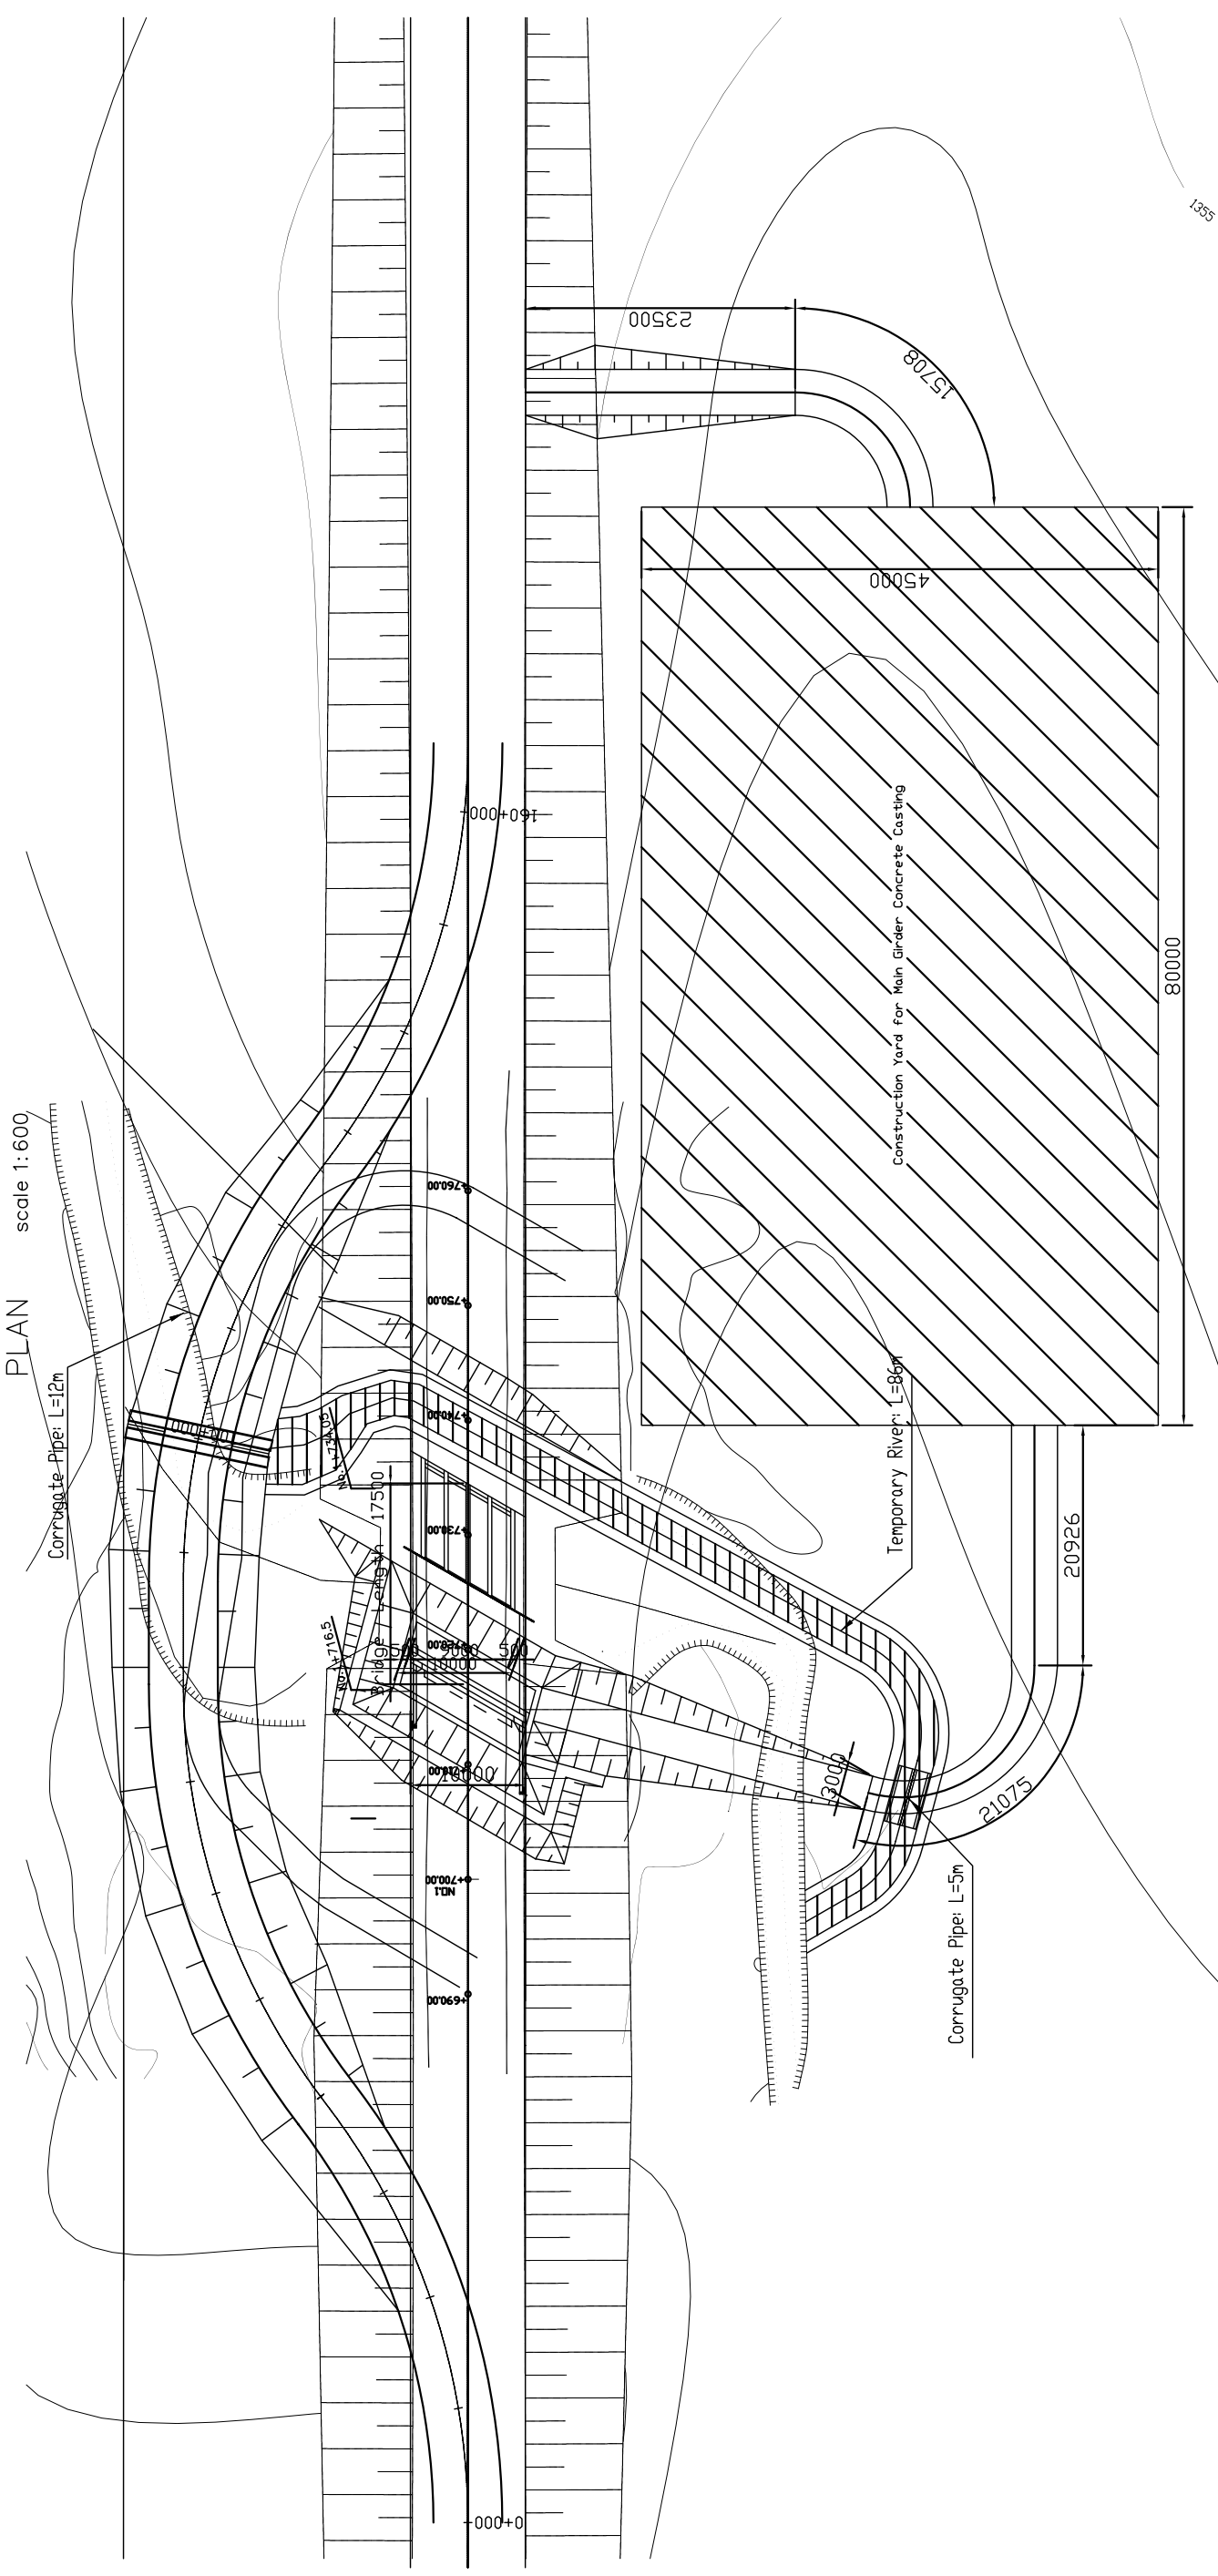

PROFILE scale 1:600

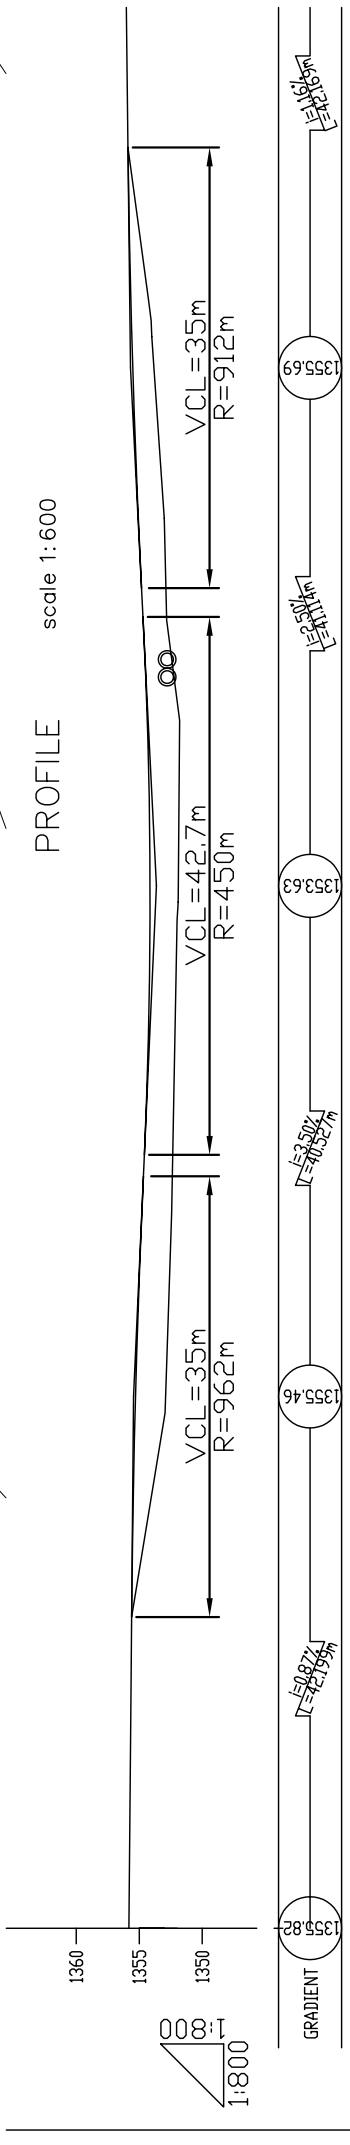

STATION NO.	ACC. DISTANCE	GROUND HEIGHT	SUPPOSED HEIGHT
0+000		1355.82	1355.82
0+010	10.00	1355.73	
0+020	10.00	1355.65	
0+030	10.00	1354.74	
0+040	10.00	1353.30	1355.46
0+050	10.00	1352.65	
0+060	10.00	1352.37	
0+070	10.00	1352.19	
0+080	10.00	1352.00	1353.63
0+090	10.00	1351.84	
0+097.479		1352.33	
0+100	10.00	1352.97	
0+110	10.00	1352.97	
0+120	10.00	1353.57	1355.69
0+130	10.00	1354.37	
0+140	10.00	1355.71	
0+150	10.00	1355.99	

THE BASIC DESIGN STUDY ON CONSTRUCTION OF EASTERN ARTERIAL ROAD IN MONGOLIA

JAPAN INTERNATIONAL COOPERATION AGENCY (JICA)

PACIFIC CONSULTANTS INTERNATIONAL
JAPAN OVERSEAS CONSULTANTS

DEPARTMENT OF ROADS,
MINISTRY OF INFRASTRUCTURE,
THE GOVERNMENT OF MONGOLIA

Drawing title
CONSTRUCTION PLAN (1)
(KHUJIRT BRIDGE)
(STAGE-2)


Scale
AS SHOWN

Sheet No.
D-4
4/6


図 3-2-3-33 フジルト橋施工計画(1)

CONSTRUCTION PLAN (2/3) (KHUJIRT BRIDGE)

PLAN scale 1:600

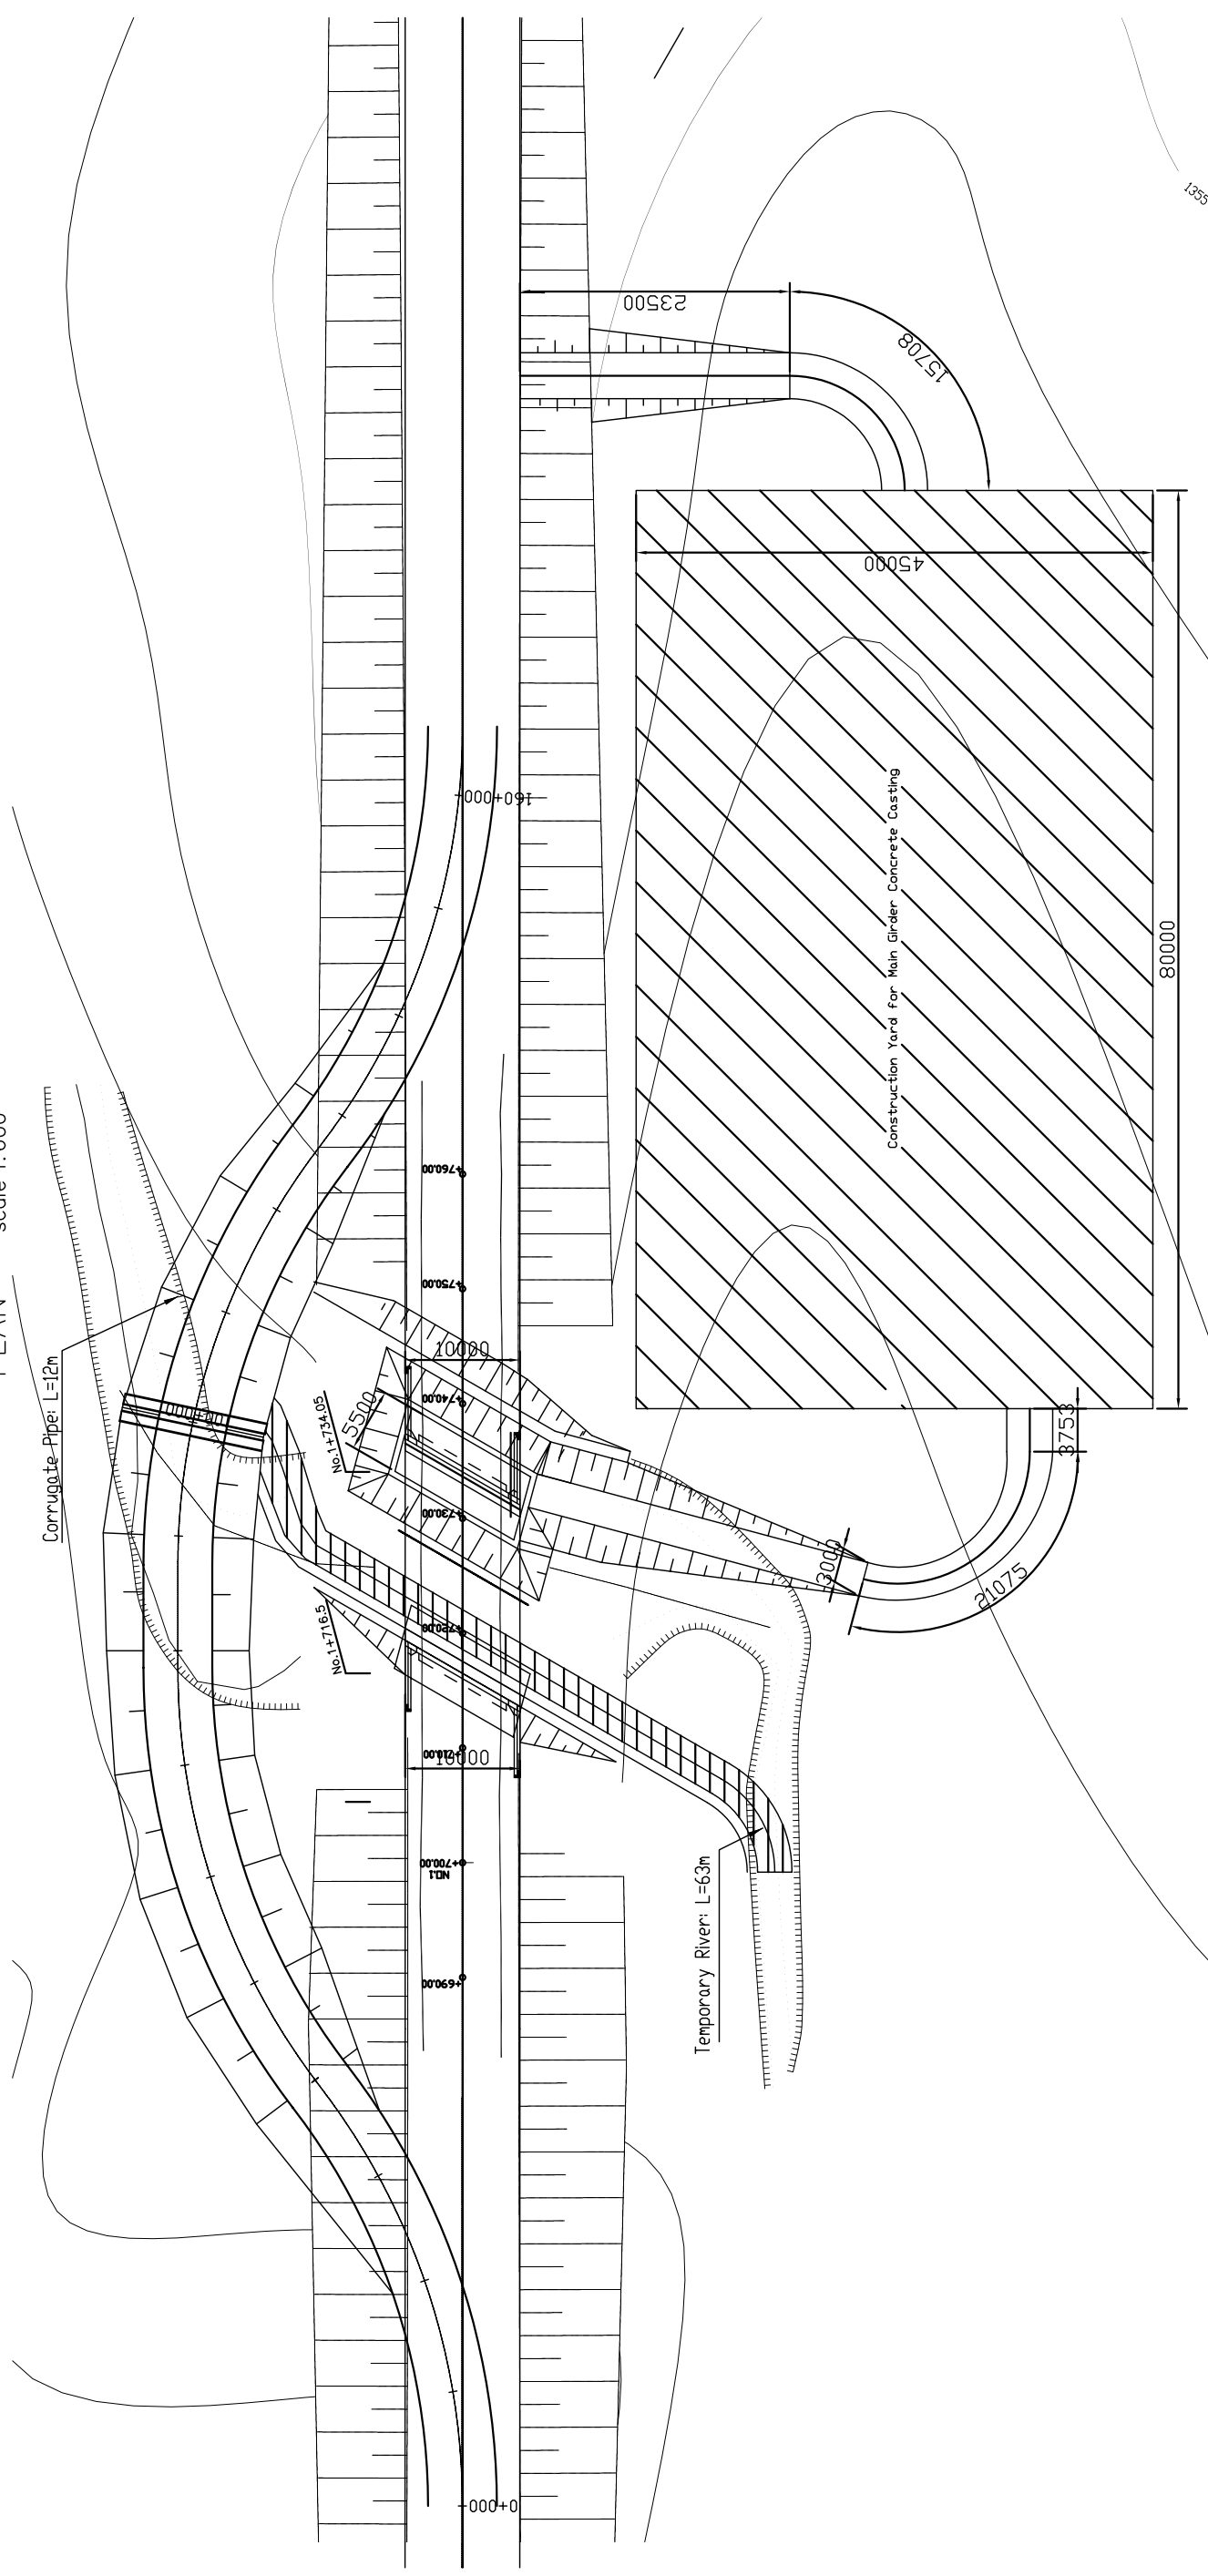

PROFILE scale 1:600

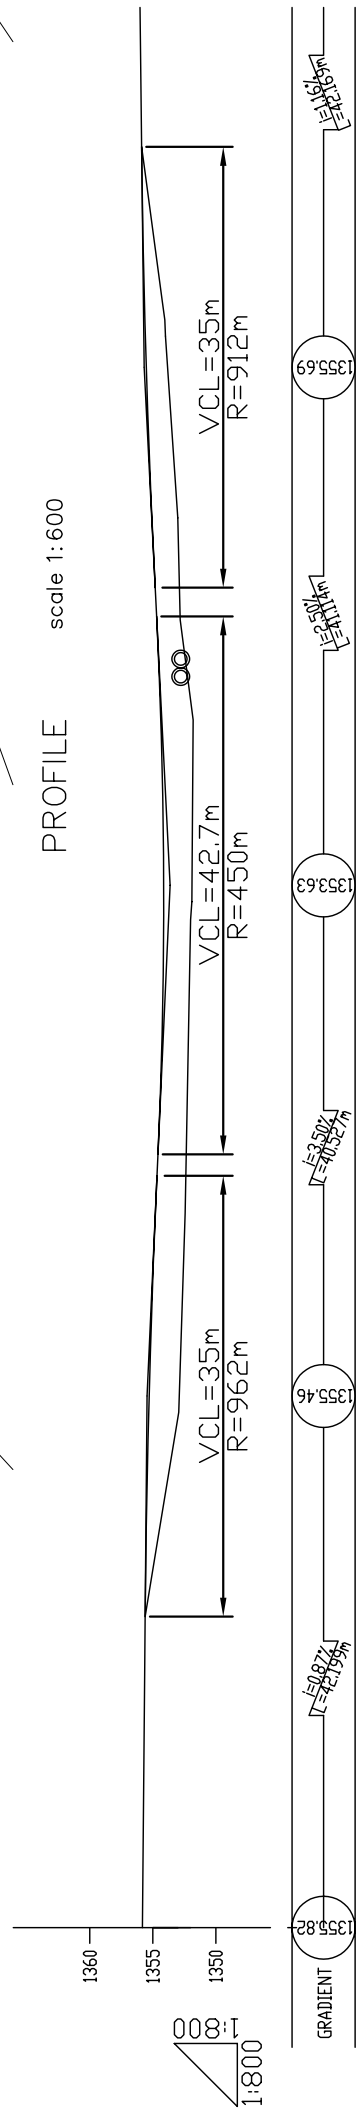

STATION NO.	ACC. DISTANCE	GROUND HEIGHT	SUPPOSED HEIGHT
0+000	1355.82		
10.00	1355.73		
0+010	1355.65		
10.00	1352.19		
0+020	1352.37		
10.00	1352.00		
0+030	1354.74		
10.00	1353.30		
0+040	1354.74		
10.00	1352.65		
0+050	1352.37		
10.00	1352.19		
0+060	1352.37		
10.00	1352.00		
0+070	1352.19		
10.00	1351.84		
0+080	1352.00		
10.00	1352.33		
0+090	1351.84		
10.00	1352.97		
0+100	1352.33		
10.00	1352.97		
0+110	1352.97		
10.00	1353.57		
0+120	1353.57		
10.00	1354.37		
0+130	1354.37		
10.00	1355.71		
0+140	1355.71		
10.00	1355.99		
0+150	1355.99		

THE BASIC DESIGN STUDY ON CONSTRUCTION OF EASTERN ARTERIAL ROAD IN MONGOLIA

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DEPARTMENT OF ROADS,
MINISTRY OF INFRASTRUCTURE,
THE GOVERNMENT OF MONGOLIA

PACIFIC CONSULTANTS INTERNATIONAL
JAPAN OVERSEAS CONSULTANTS

Drawing title
CONSTRUCTION PLAN (2)
(KHUJIRT BRIDGE)
(STAGE-2)


Scale
AS SHOWN

Sheet No.
D-5
5/6


図 3-2-3-34 フジルト橋施工計画(2)

CONSTRUCTION PLAN (3/3) (KHUJIRT BRIDGE)

PLAN scale 1:600

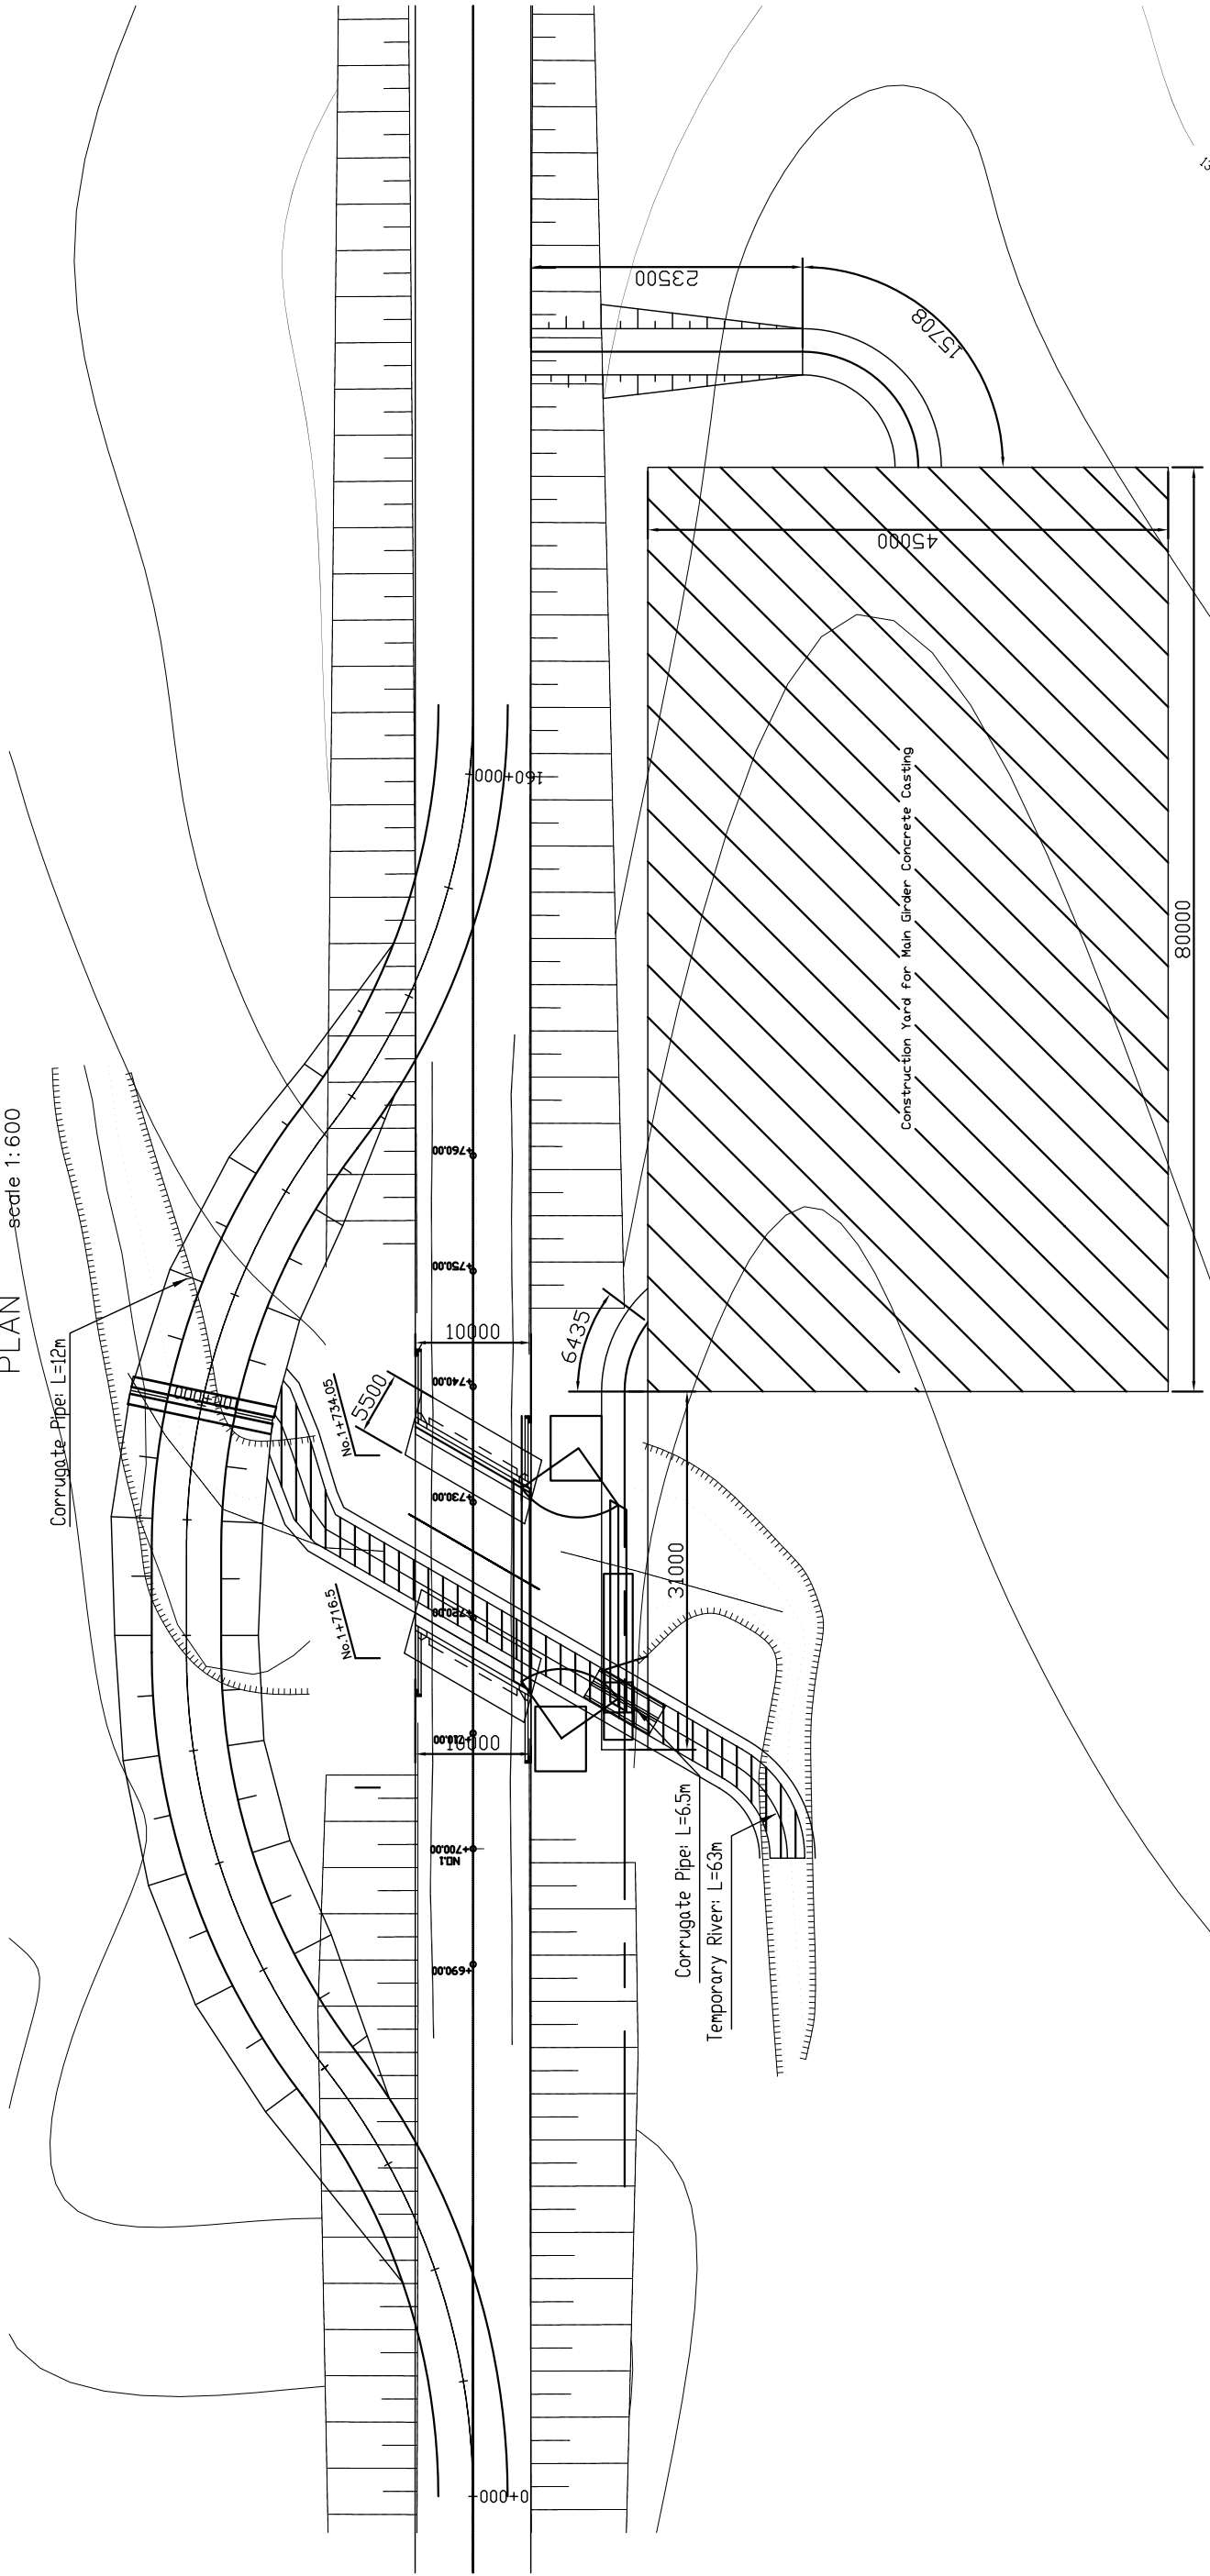

PROFILE scale 1:600

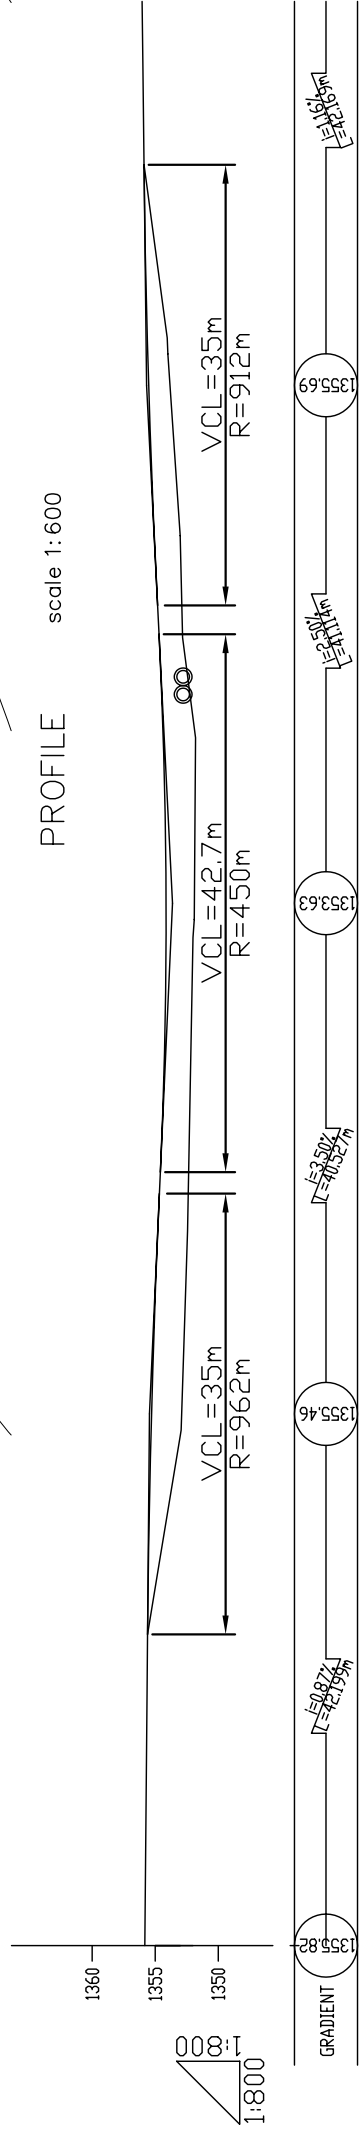

STATION NO.	ACC. DISTANCE	GROUND HEIGHT	SUPPOSED HEIGHT	GRADIENT
0+000		1355.82		1355.82
0+010	10.00	1355.73		
0+020	20.00	1355.65		
0+030	30.00	1354.74		
0+040	40.00	1353.30		1355.46
0+050	50.00	1352.65		
0+060	60.00	1352.37		
0+070	70.00	1352.19		
0+080	80.00	1352.00		1353.63
0+090	90.00	1351.84		
0+097.479	97.479	1352.33		
0+100	100.00	1352.97		
0+110	110.00	1352.97		
0+120	120.00	1353.57		1355.69
0+130	130.00	1354.37		
0+140	140.00	1355.71		
0+150	150.00	1355.99		

THE BASIC DESIGN STUDY ON CONSTRUCTION OF EASTERN ARTERIAL ROAD IN MONGOLIA

JAPAN INTERNATIONAL COOPERATION AGENCY (JICA)

DEPARTMENT OF ROADS,
MINISTRY OF INFRASTRUCTURE,
THE GOVERNMENT OF MONGOLIA



PACIFIC CONSULTANTS INTERNATIONAL
JAPAN OVERSEAS CONSULTANTS

Drawing title
CONSTRUCTION PLAN (3)
(KHUJIRT BRIDGE)
(STAGE-2)

Scale
AS SHOWN

Sheet No.
D-6
6/6

図 3-2-3-35 フジルト橋施工計画(3)

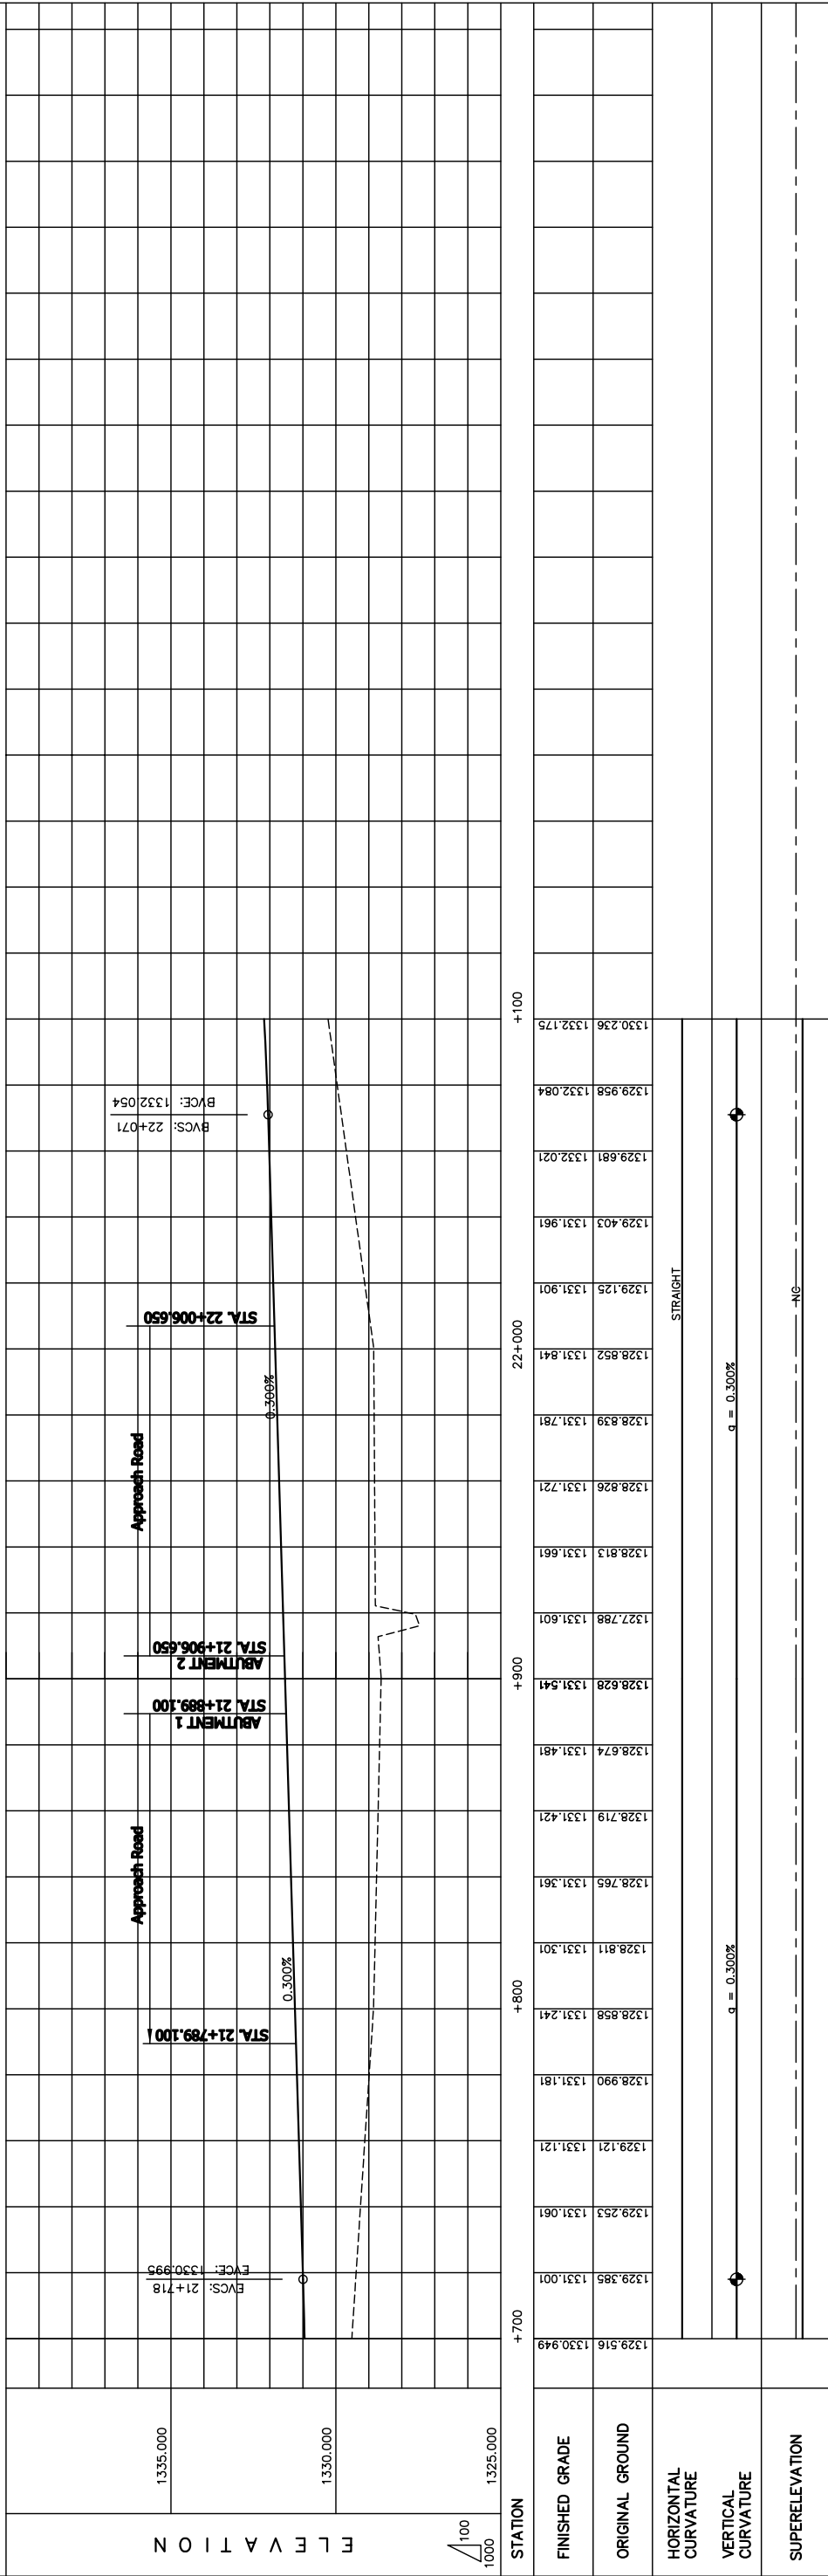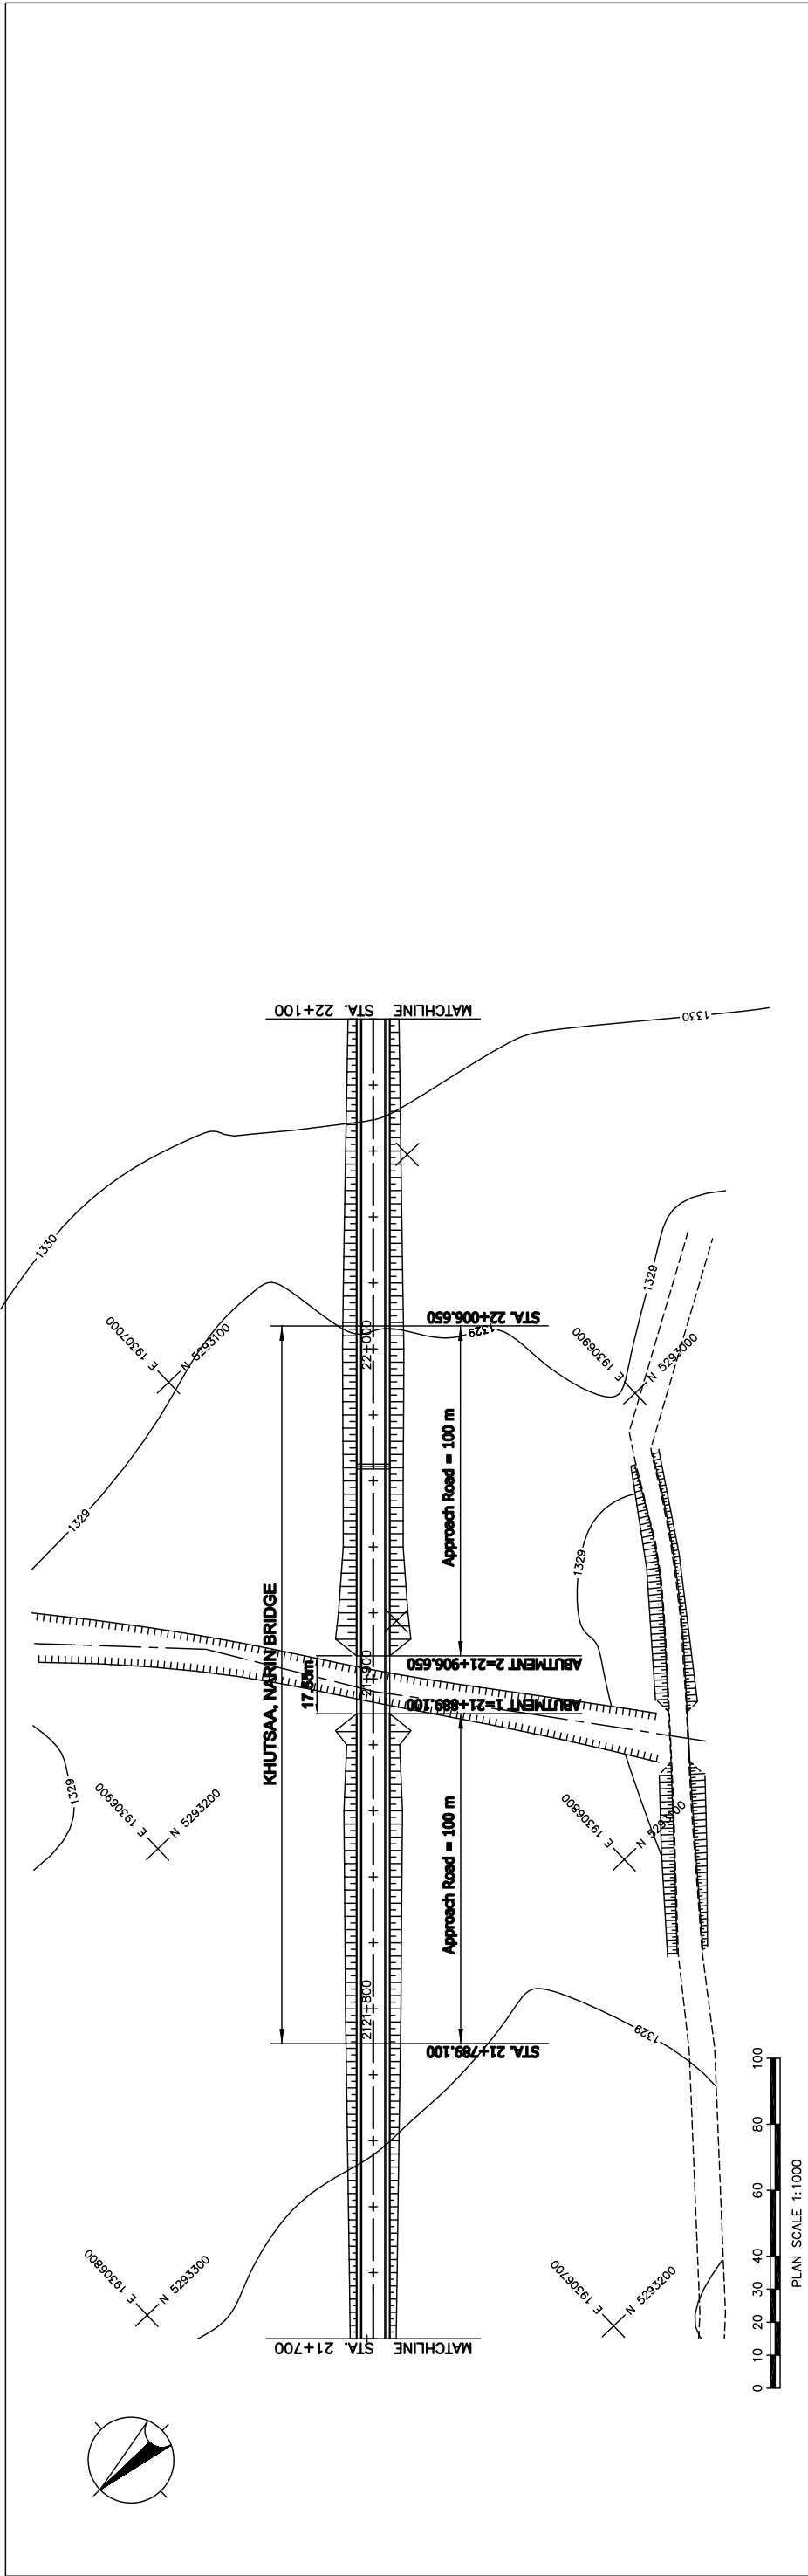


THE BASIC DESIGN STUDY ON CONSTRUCTION OF EASTERN ARTERIAL ROAD IN MONGOLIA	
JAPAN INTERNATIONAL COOPERATION AGENCY (JICA)	DEPARTMENT OF ROADS, MINISTRY OF INFRASTRUCTURE, THE GOVERNMENT OF MONGOLIA
PACIFIC CONSULTANTS INTERNATIONAL JAPAN OVERSEAS CONSULTANTS	Scale
Drawing title PLAN AND PROFILE (STA.21+700 TO STA.22+100) (STAGE-2)	AS SHOWN
Sheet No.	B-1 1/5

図 3-2-3-36 フッサー・ナリン橋全体平面・縦断面 (Section II 新設区間)

CONSTRUCTION PLAN (1/2) (KHUTSAA NARIN BRIDGE)

PLAN 1:500

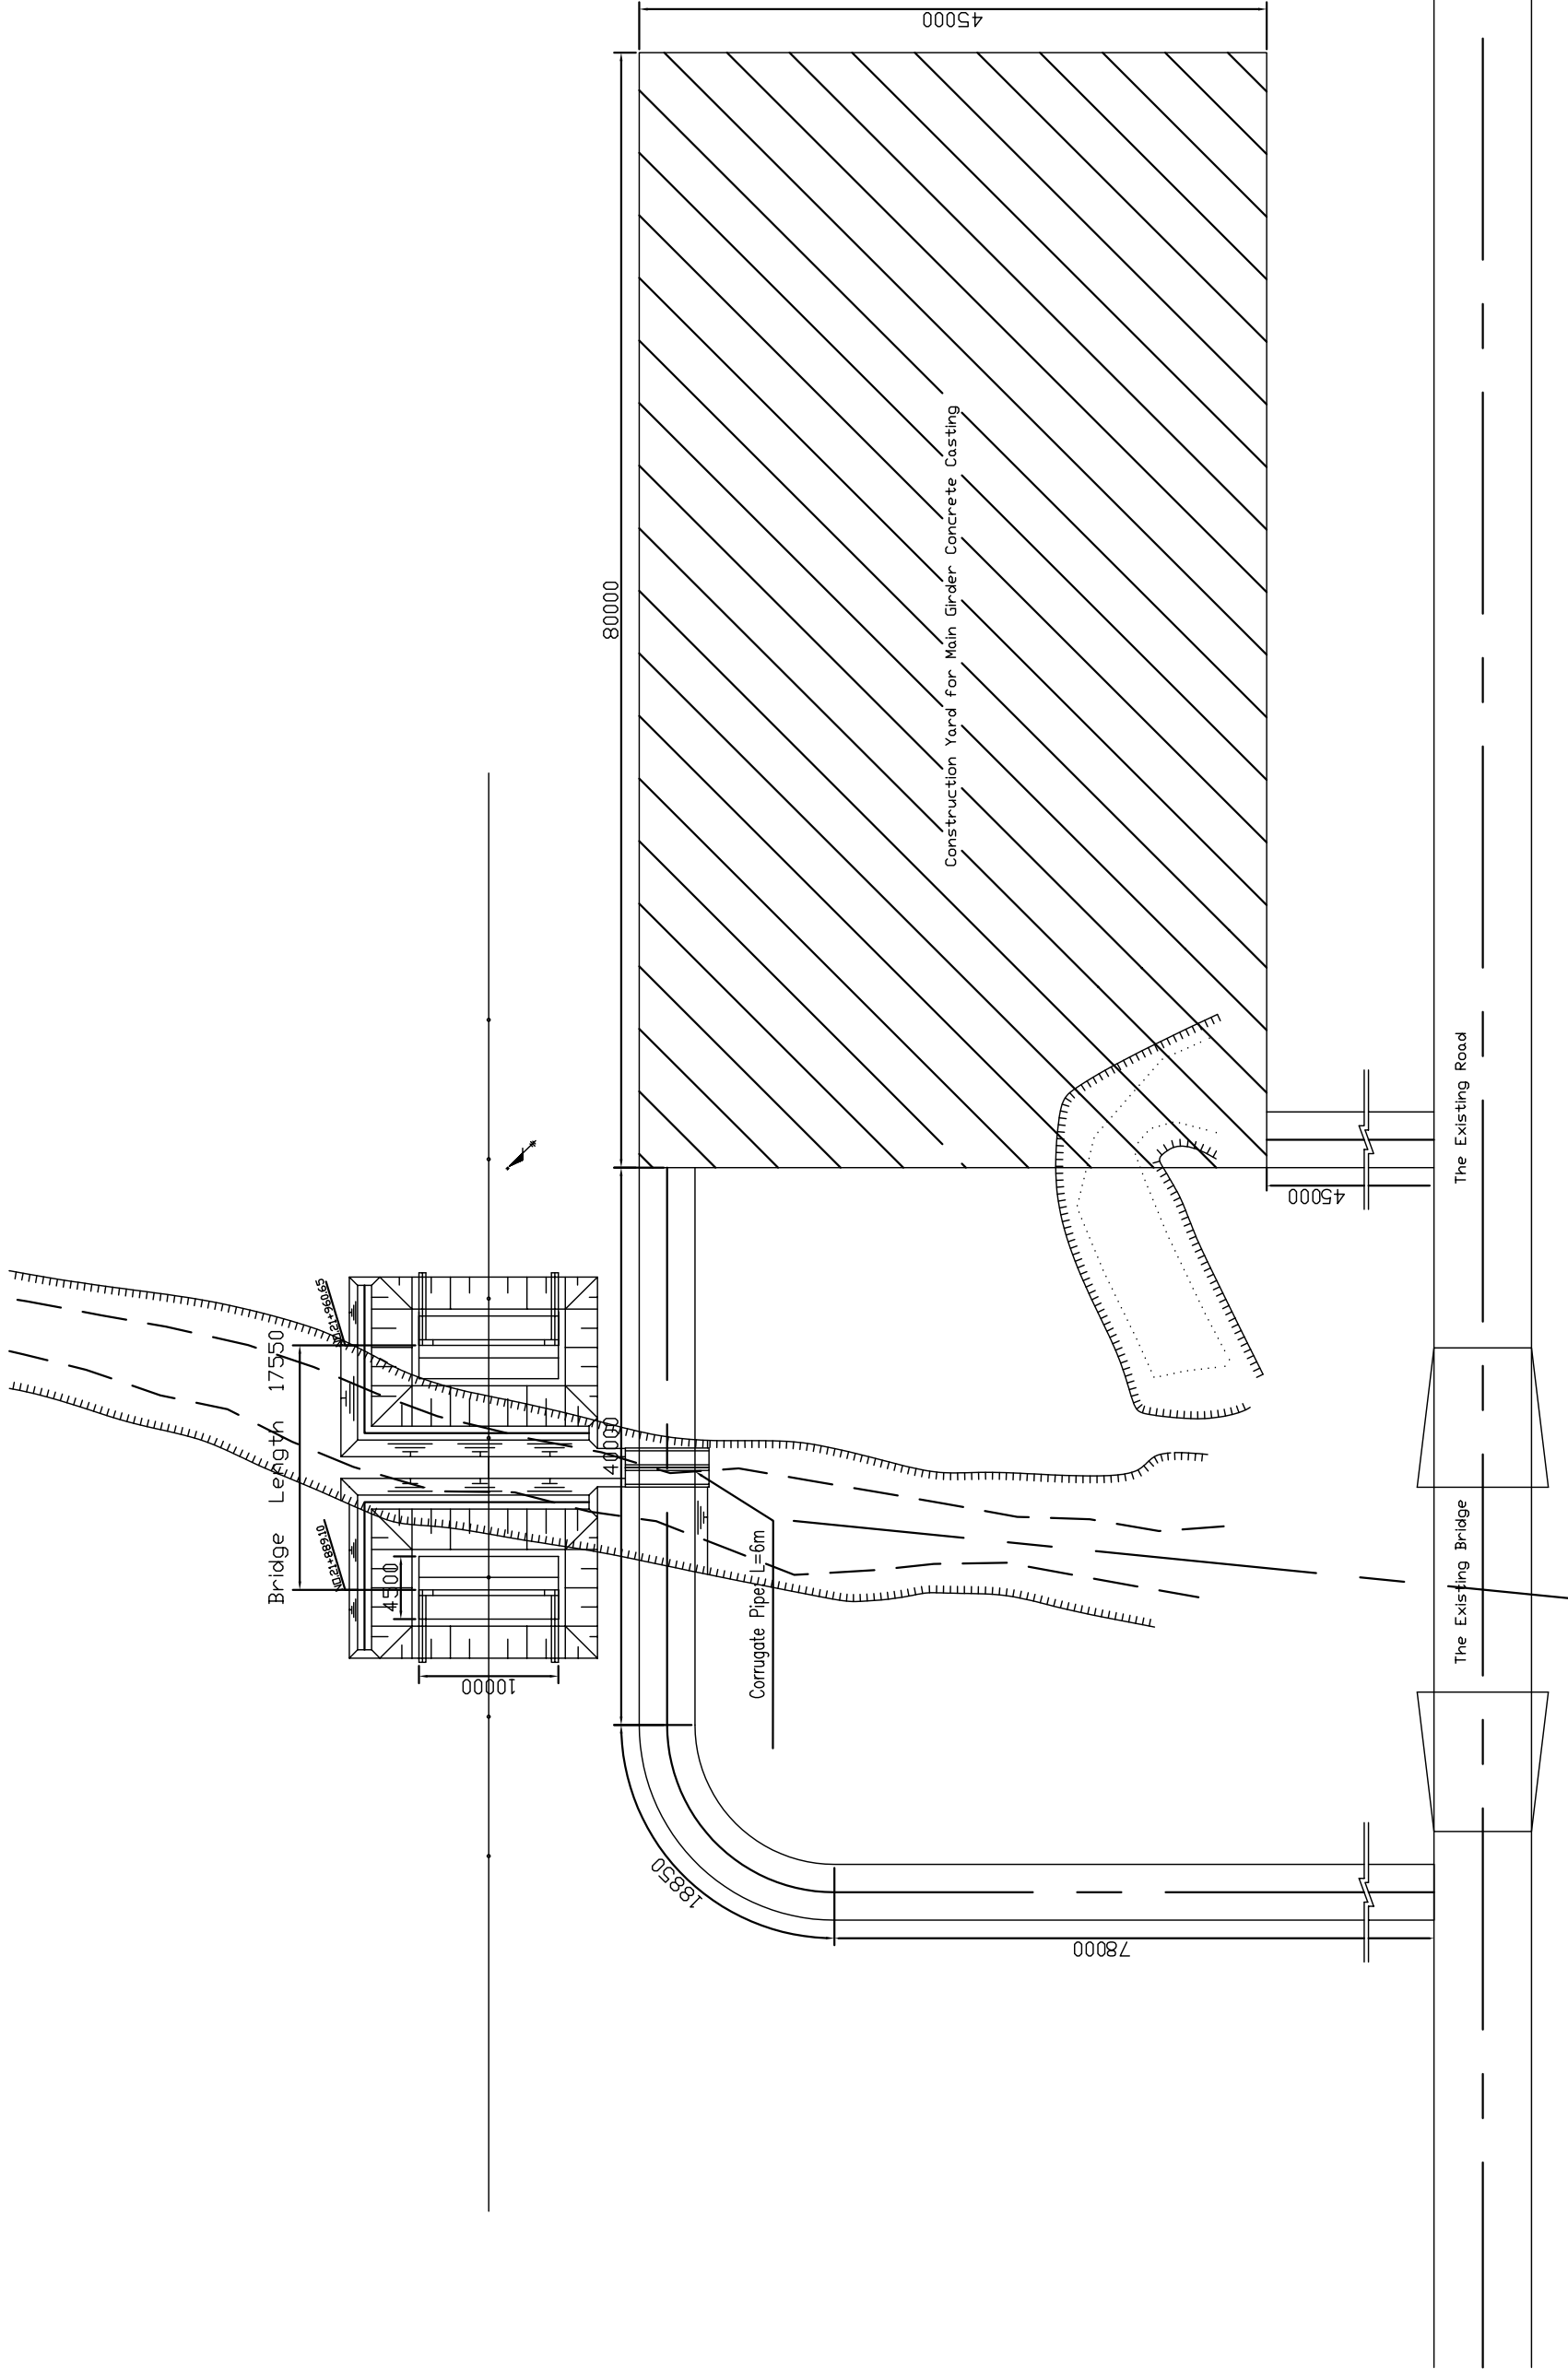


THE BASIC DESIGN STUDY ON CONSTRUCTION OF EASTERN ARTERIAL ROAD IN MONGOLIA	
JAPAN INTERNATIONAL COOPERATION AGENCY (JICA)	DEPARTMENT OF ROADS,
PACIFIC CONSULTANTS INTERNATIONAL JAPAN OVERSEAS CONSULTANTS	MINISTRY OF INFRASTRUCTURE, THE GOVERNMENT OF MONGOLIA
Drawing title	Scale
CONSTRUCTION PLAN (1) (KHUTSAA NARIN BRIDGE) (STAGE-2)	AS SHOWN
Sheet No.	Sheet No.
E-4	4/5

図 3-2-3-39 フッサー・ナリン橋施工計画(1)

CONSTRUCTION PLAN (2/2) (KHUTSAA NARIN BRIDGE)

PLAN 1:500

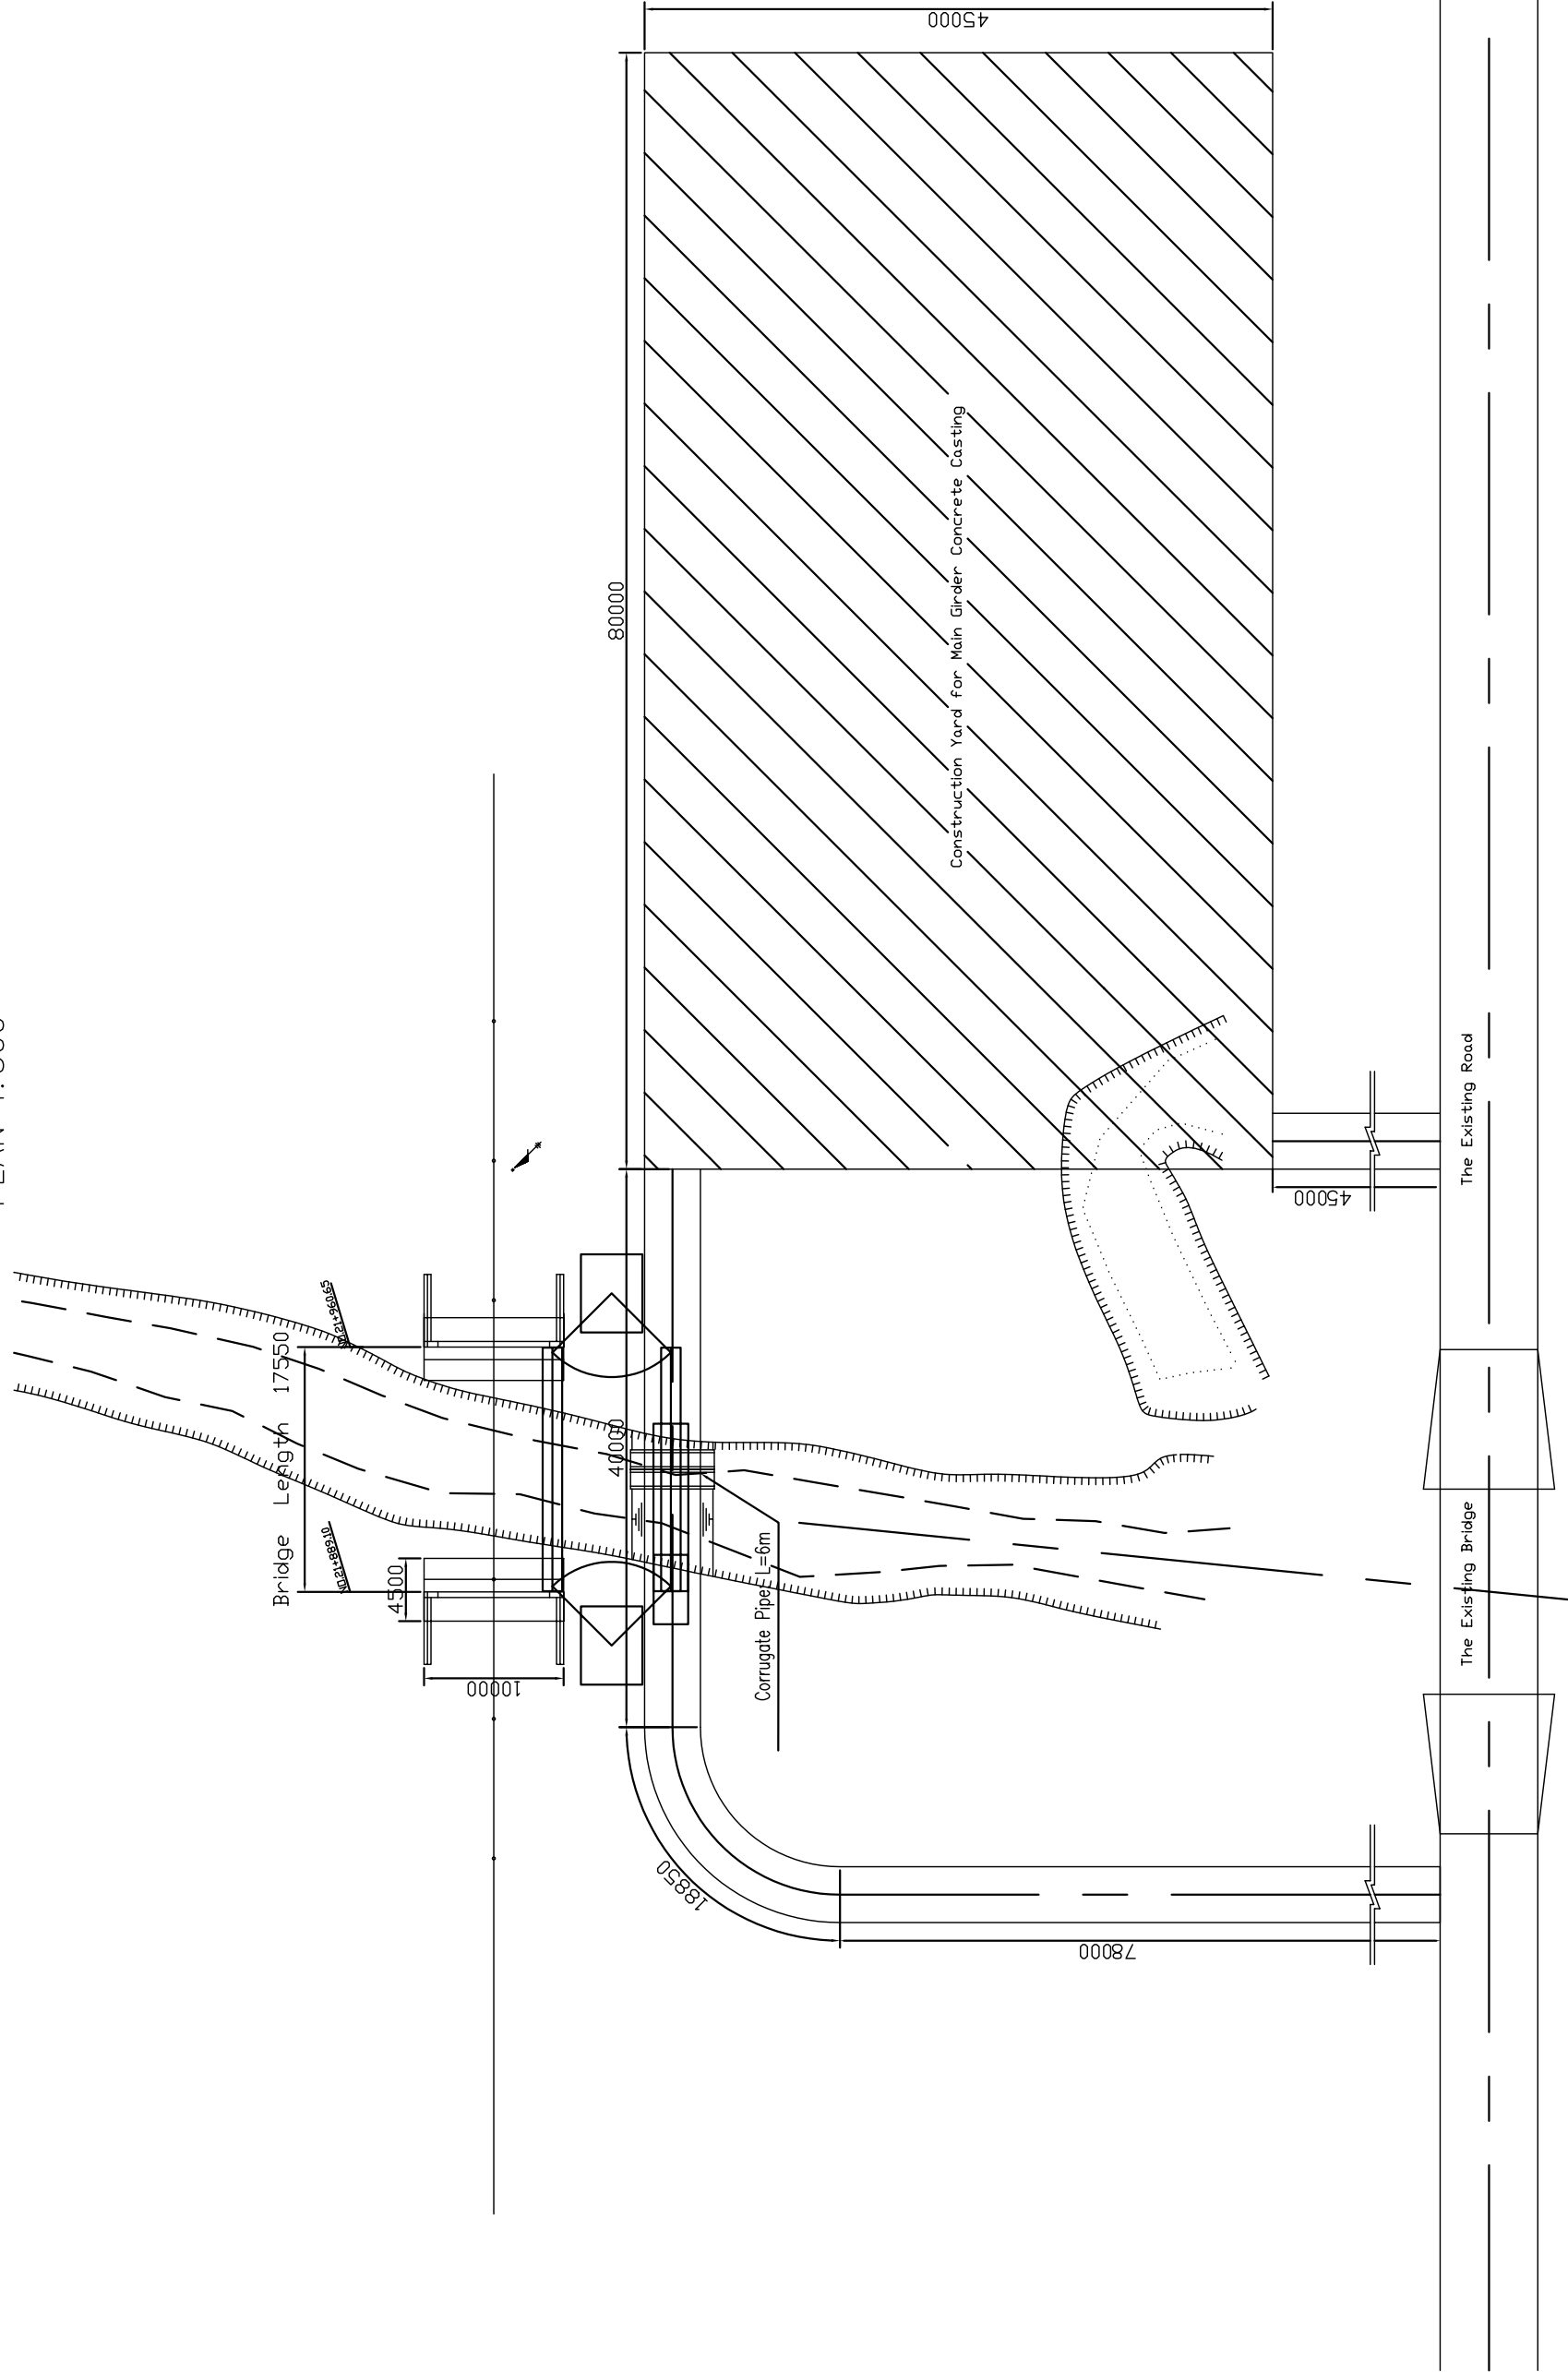

THE BASIC DESIGN STUDY ON CONSTRUCTION OF EASTERN ARTERIAL ROAD IN MONGOLIA	
JAPAN INTERNATIONAL COOPERATION AGENCY (JICA)	DEPARTMENT OF ROADS, MINISTRY OF INFRASTRUCTURE, THE GOVERNMENT OF MONGOLIA
PACIFIC CONSULTANTS INTERNATIONAL JAPAN OVERSEAS CONSULTANTS	
Drawing title	Scale
CONSTRUCTION PLAN (2) (KHUTSAA NARIN BRIDGE) (STAGE-2)	AS SHOWN
Sheet No.	Sheet No.
E-5	5/5

図 3-2-3-40 フッサー・ナリン橋施工計画(2)