



ISOMETRIC VIEW




SECTION A

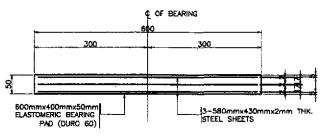

1 ELASTOMERIC BEARING PAD DETAILS
SCALE AS SHOWN

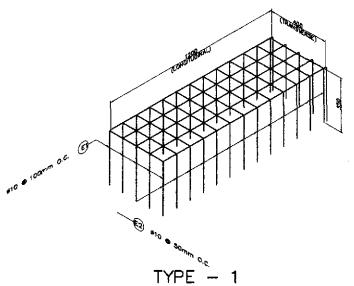




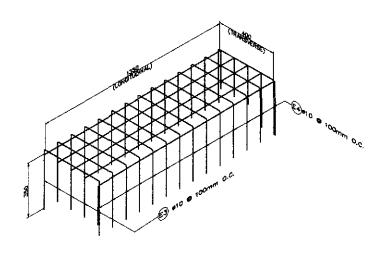


TYPE - 2

RR-2 (DOWEL)
PIER (FIX-FIX)


RISER REINFORCEMENT DETAILS

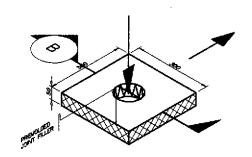

ISOMETRIC VIEW

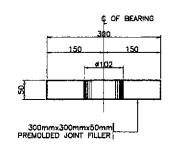

SECTION A

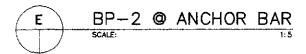

PREMOLDED JOINT FILLER DETAILS

SCALE

AS
SHOW

		BAR BEN	DING DIAGRAM	Λ	
A	• [a	8	\emptyset	1

SCHEDULE OF REINFORCEMENT

	BAR	SIZE	ann.	DIMEN	ISION(mm)	OUT	TC	OUT	LENGTH	NO.	THOU	WEIGHT(kga.)		REMARKS
LOCATION	MARK	(mm)	BEDID TYPE	•	Ь	¢		d	•	(mm)	NO. REQ'D.	WEIGHT (kg/m)	Grade 40		REMARKS
	E1	10	A	350	700				1	1400	48	0.617	42	1	. ESTIMATED
RESER (PRER	E2	10	A	350	500	Ī	T.,		i	1200	64	0.617	48		QUANTITY FOR ONE(1) PIER
FIX-FD()							\Box		Ι						ONLY.
GIRDER		Ι		Ī								TOTAL=	90	⅃₂	. ESTIMATED
	Ę١	10	Α	350	700					1400	48	0.617	42	╝	QUANTITY FOR
RISER (PIER	E.2	10	A	350	500					1200	64	0.617	48	╝	ONE(1) ABUT.
DIP-EXP)									1	<u> </u>	<u> </u>	<u> </u>			
CHROER '		L	<u> </u>	<u> </u>	<u> </u>					<u> </u>		TOTAL=	90	┙	
	E1	10	. A _	350	700	<u> </u>	1		<u> </u>	1400	24	0.617	21	╛	
RISER	E2	10	A	350	500					1200	32	0.617	24	_	
(ABUT EXP)				1			1_		<u> </u>					4	
												TOTAL-	45	_	
RUSER	E1	10	Α	350	1350	<u> </u>				2050	15	0.617	19	_	
(PIER	E2	10	A	350	400				<u> </u>	1100	42	0.617	29	_	
1 & 2) WICHOR BAR		ļ		ļ					<u> </u>					_	
ANCINE DIST		L	<u> </u>	L			1					TOTAL=	48	_	
DICCO	Ē1	10	Α	350	1200	L				1700	15	D.617	16	_	
RISER (PIER +	E2	10	A	350	40 0		$oldsymbol{\perp}$			1100	39	0.617		_	
5, 7 & 8) WICHOR BAR	. — — — — — — — — — — — — — — — — — — —	ļ <u></u> .	<u> </u>	ļ <u>.</u>										_	
AND NO. CO.				<u> </u>	ļ <u></u>	<u> </u>	4					TOTAL=	43	_	
SPIRAL	A1	6	8	50	250					15163	6	0.222	20	_	
(PIER 4,	A2	6	В	50	200	L			1	13058	6	0.222	17	4	
5, 7 & 8) NCHOR BAR				<u> </u>		<u> </u>			<u> </u>					4	
					1							TOTAL=		_	
SPIRAL	EA.	6	8	50	250	<u> </u>			<u> </u>	15163	9	0.222	30	_	
(PER	A4	6	В	50	200	Ļ				15571	9	0.222	31	4	
1 & 2) WICHOR BAR					<u> </u>	L	\bot		<u> </u>			 		_	
ALCINIC DIST				1	1	<u> </u>	┸		1			TOTAL=	81		

THE REINFORCEMENT SHOWN ON THIS TABLE IS FOR REFERENCE ONLY. THE CONTRACTOR SHOULD CHECK AND VERIFY ALL DIMENSIONS, SIZES AND QUANTITIES OF REINFORCEMENT.

JAPAN INTERNATIONAL COOPERATION AGENCY

CI

KATAHIRA & ENGINEERS

CO., LTD.

SI

Ī		DATE	SIGNATURE		DEPARTMEN	REPUBLIC OF THE PHIL T OF PUBLIC WOR	JPPINES RKS AND HIGHWAYS	
Į	DESIGNED	10/12/01	F. P. DE JESUS	PJHL ~ PMO	BUREAU C			IE SECRETARY
1	CHECKED	10/19/02	J. Z. KANTOS	Submitted By:	Reviewed By:	Recommended By:	Recommended By: (See cover sheet for	Approved By: (See cover sheet for
	SUBMITTED	10/silor	My Killer	DANILO C. TRAJANO	ADRIANO N. DOROY	GILBERTO S. REYES	Signature) MANUEL M. BONDAN	Signature/Approval) SIMEON A. DATUMANONG
1		1.141.2	TEAM LEADER	Project Director	Chief, Bridgee Division	Director IV (OIC)	Undergecretary	Secretory

PROJECT AND LOCATION: SCALE:

THE DETAILED DESIGN STUDY ON

UPGRADING INTER-URBAN HIGHWAY SYSTEM

ALONG THE PAN-PHILIPPINE HIGHWAY

(Plaridel, Cabanatuan and San Jose Bypasses)

CABANATUAN BYPASS - CONTRACT PACKAGE IV


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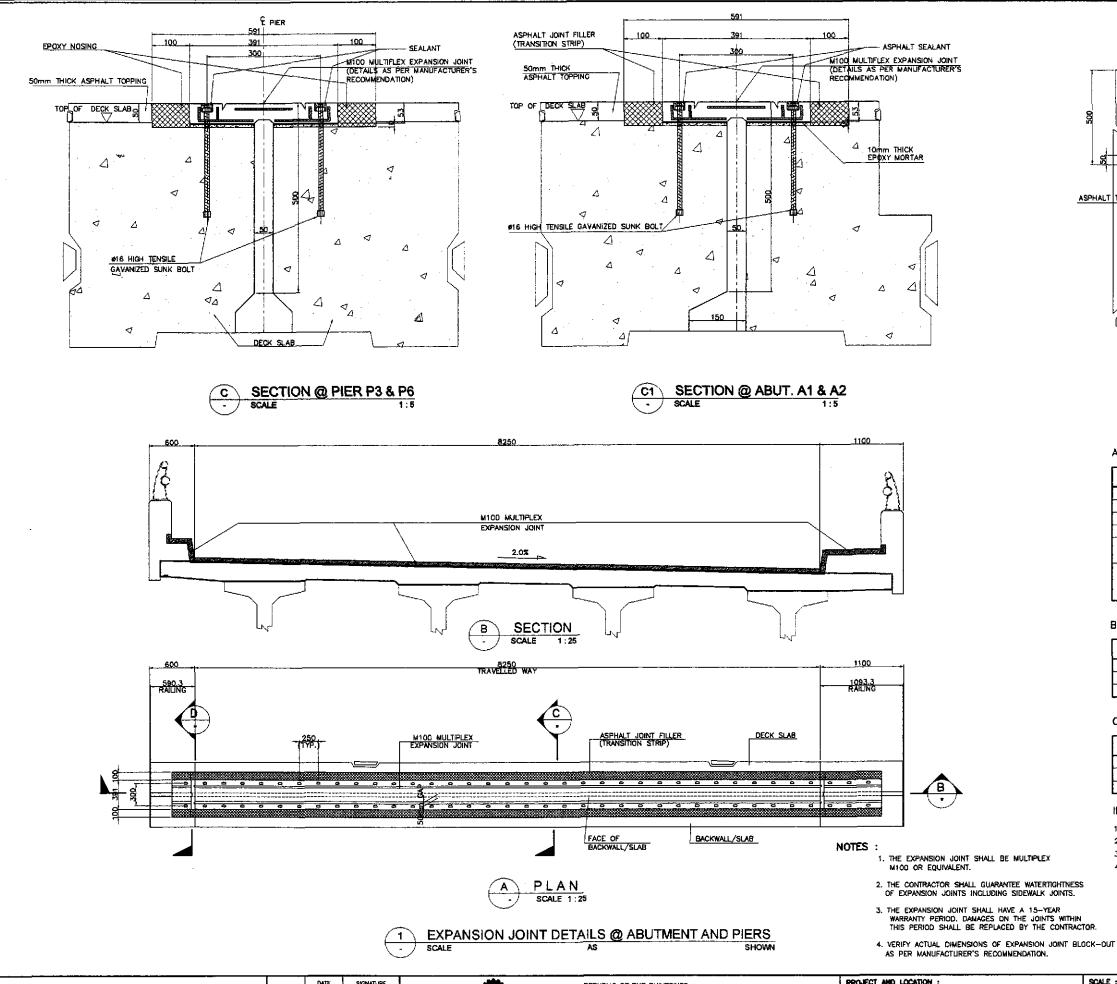
BRIDGE NO.14 TALAVERA RIVER BRIDGE
AS SHOWN
RISER REINF. & BEARING PADS DET.


(INITIAL STAGE)

B14M-82

SHEET NO. :



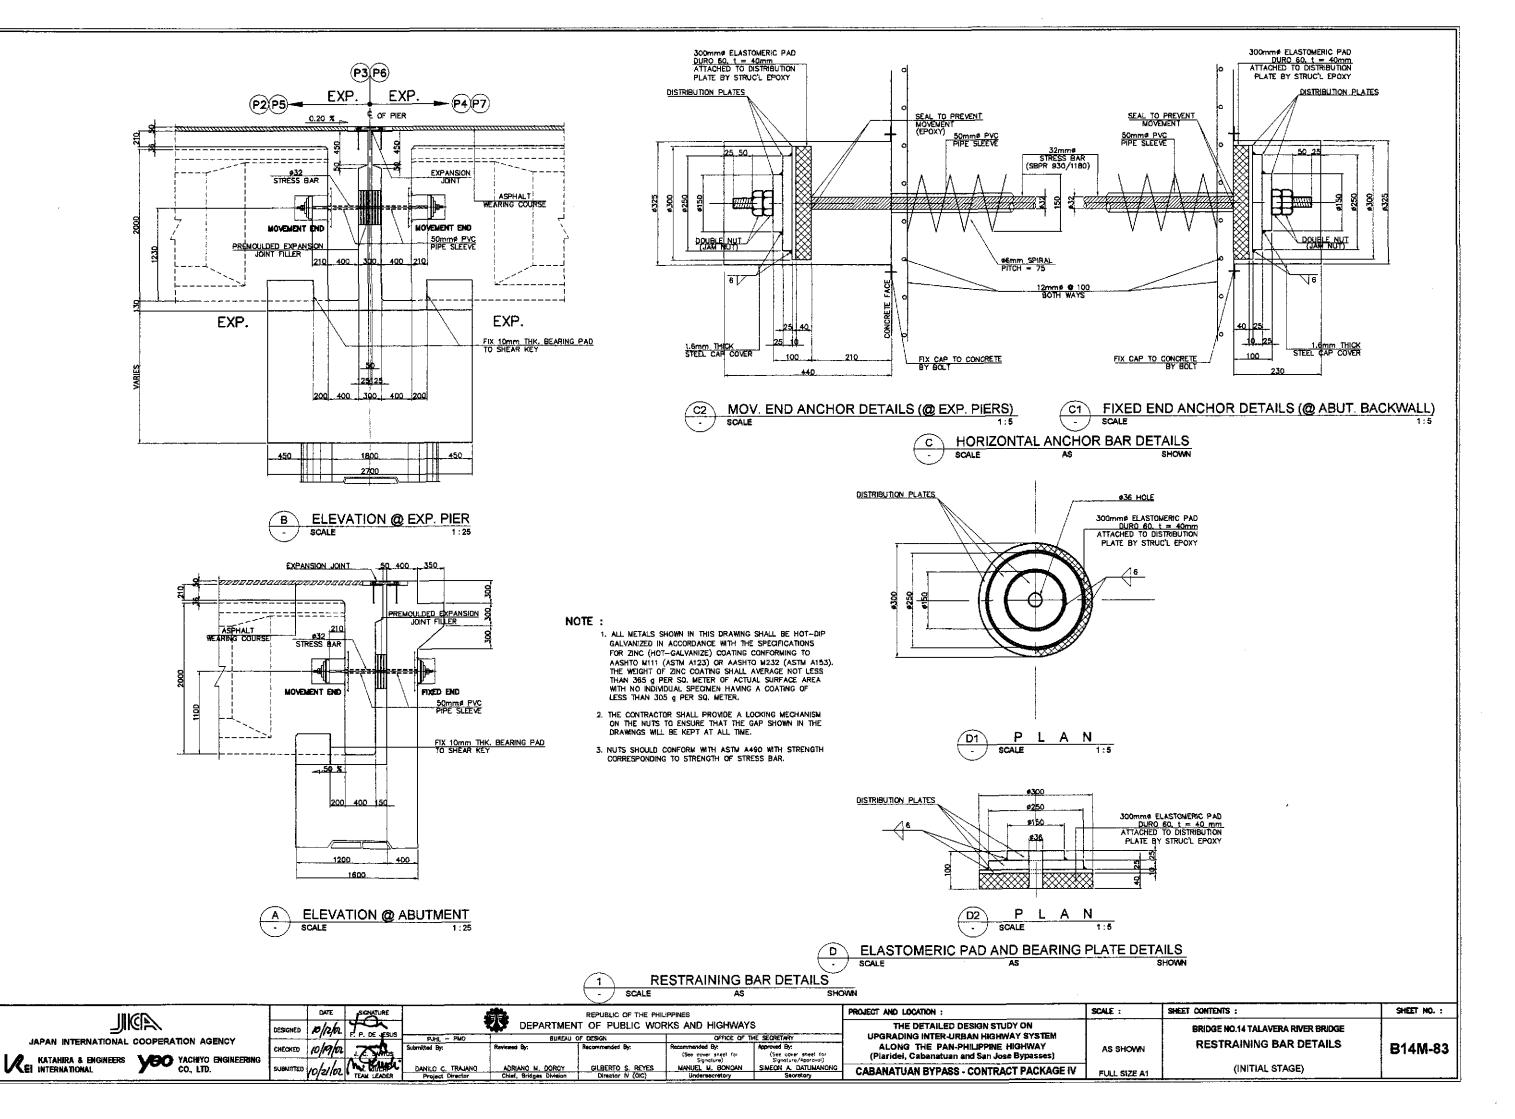

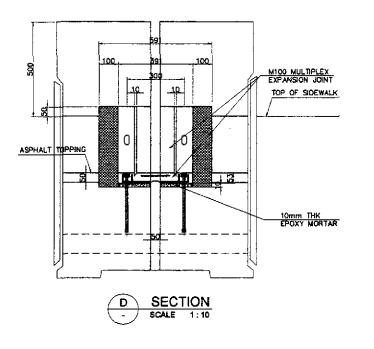

A.) QUALITY TESTING OF RUBBER COMPOUND

PROPERTIES	SPECIFICATION
HARDNESS (SHORE A)	50 ± 5
TENSILE STRENGTH (MPA)	13 MIN
ELONGATION AT BREAK (%)	400 MIN
COMPRESSION SET (AFTER 22h AT 70°C)	20% MAX
OZONE RESISTANCE (AFTER 72h AT 40°C, 20% STRAIN 100 pphm)	NO CRACK
OIL RESISTANCE IN ASTM NO. 3 OIL (168h AT 25°C. VOLUME CHANGE)	15% MAX

B.) DIMENSION CHECK ON METAL PLATES

DIMENSION	SPECIFICATION
LENGTH	± 1
WEDTH	0 TO -1.5 MIN
THICKNESS	± 0.5 MIN

C.) QUALITY CHECK


PROPERTY	SPECIFICATION
DIMENSION	ACCORDING TO PRODUCT DRAWING
SURFACE APPEARANCE	NO VISIBLE CRACK
RUBBER COVER HARDNESS (SHORE A)	50 ± 5


INSTALLATION MATERIALS


- 1. EPOXY BEDDING
- 2. EPOXY NOSING
- 3. BOLT / NUTS
- 4. SEALANT


LOCATION	EXPANSION JOINT TYPE	MOVEMENT (mm)	LENGTH (m)
ABUT. At	MULTIPLEX M100	±50(TOTAL=100mm)	10.20
ABUT. A2	NULTIPLEX M108	±50(TOTAL=100mm)	10.20
PIER 3	MULTIPLEX M100	±50(T0TAL=100mm)	10.20
PIER 6	MULTIPLEX M100	±50(T0TAL=100mm)	10.20


SHEET CONTENTS : SHEET NO. : PROJECT AND LOCATION : SCALE : REPUBLIC OF THE PHILIPPINES DEPARTMENT OF PUBLIC WORKS AND HIGHWAYS THE DETAILED DESIGN STUDY ON UPGRADING INTER-URBAN HIGHWAY SYSTEM BRIDGE NO.14 TALAVERA RIVER BRIDGE OFFICE OF THE SECRETARY JAPAN INTERNATIONAL COOPERATION AGENCY **EXPANSION JOINT DETAILS** Approved By:
(See cover sheet for Signoture/Approve)
SIMEON A. DATUMANONG
Secretory ALONG THE PAN-PHILIPPINE HIGHWAY B14M-84 (See cover sheet for Signature)
MANUEL M. BONOAN
Undersecratury (Plaridel, Cabanatuan and San Jose Bypasses) AT ABUTMENT & PIERS KATAHIRA & ENGINEERS YEO YACHIYO ENGINEERING CO., LTD. (INITIAL STAGE) CABANATUAN BYPASS - CONTRACT PACKAGE IV

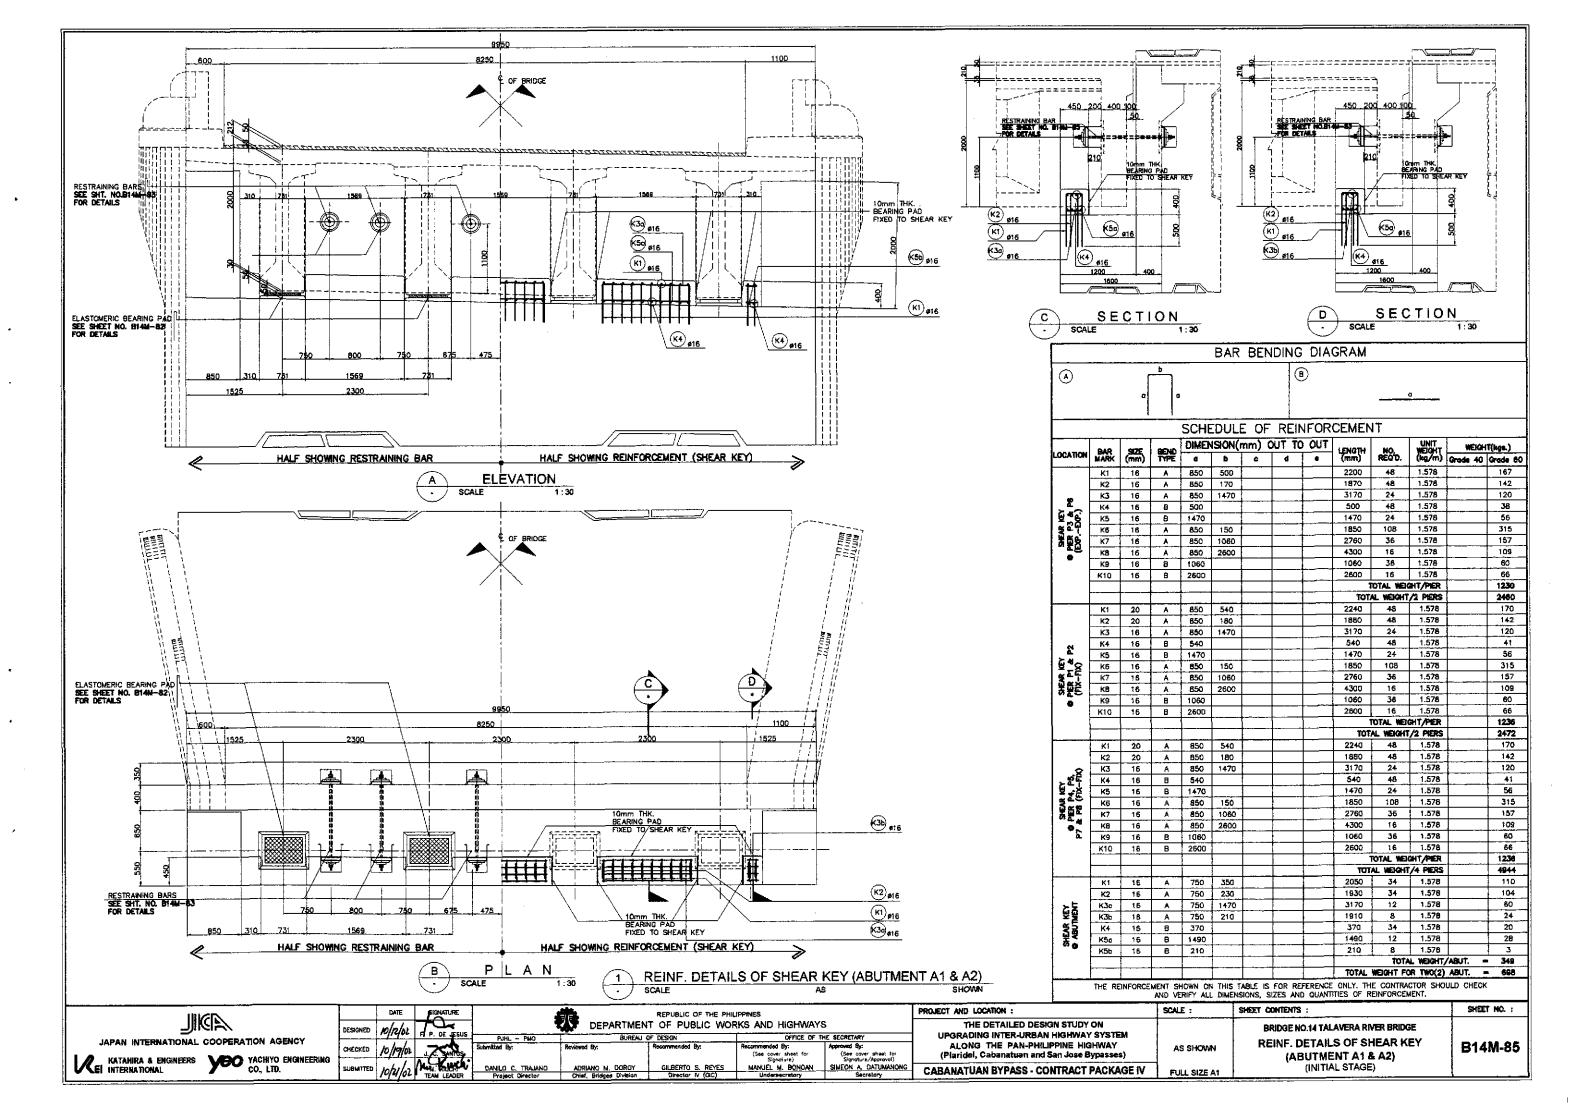


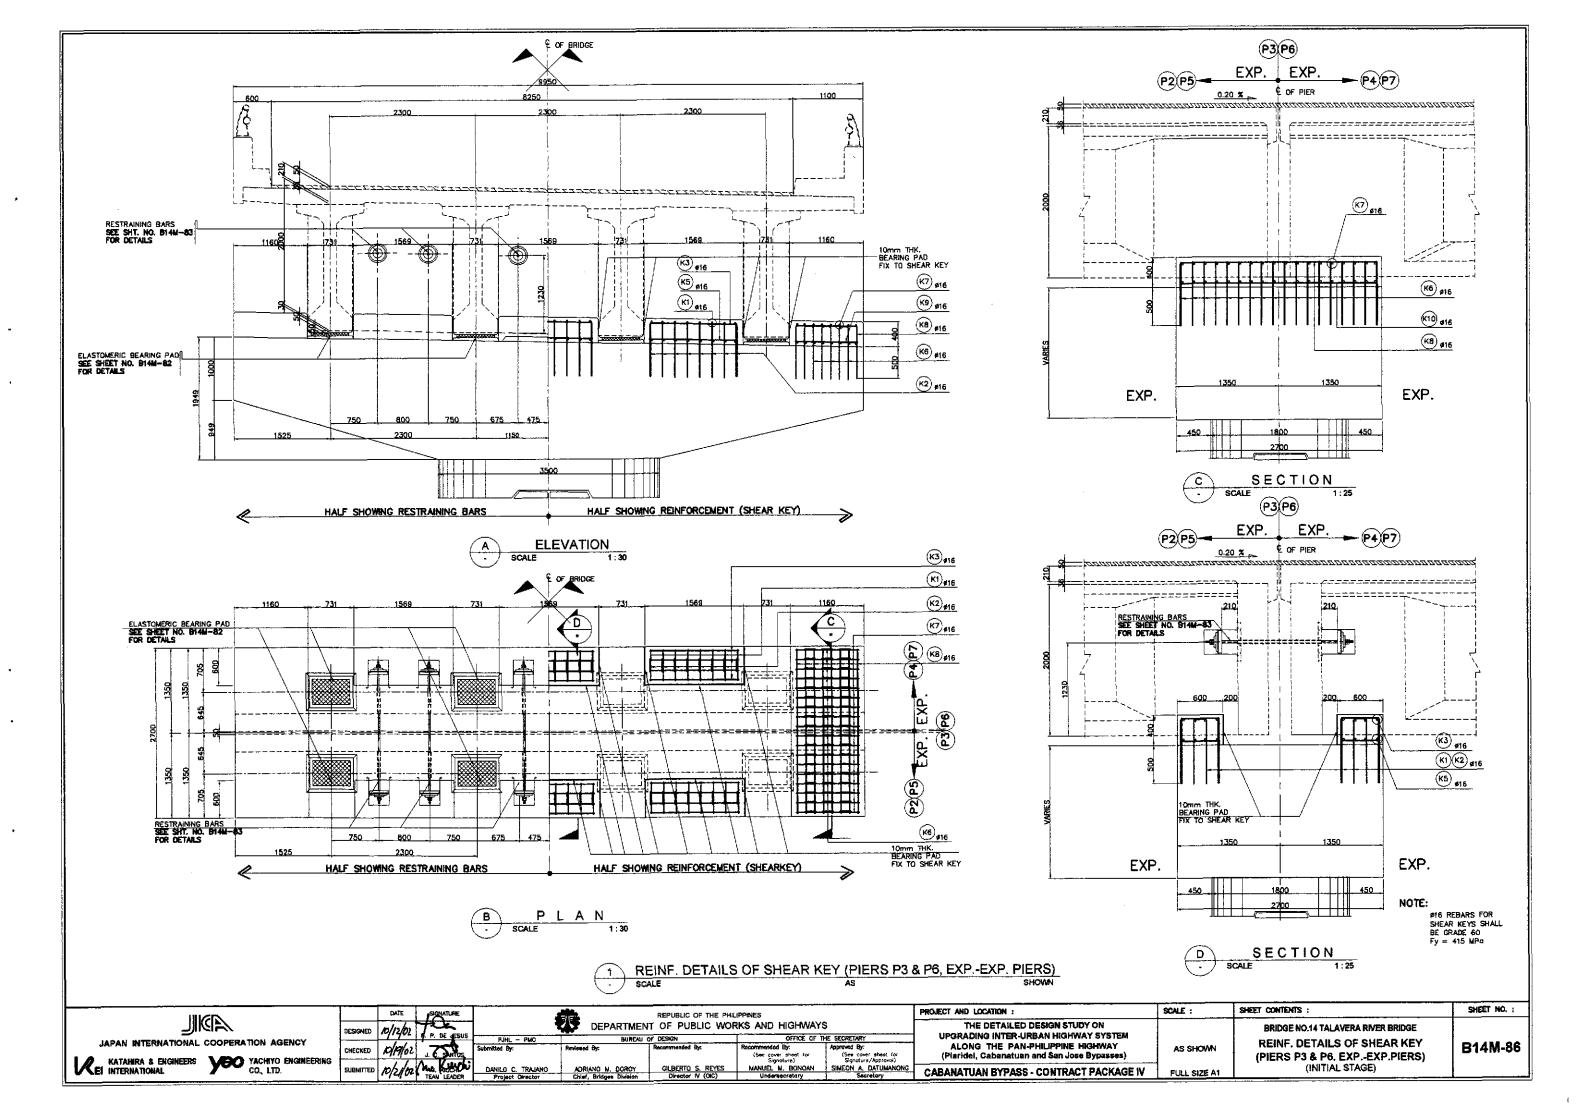


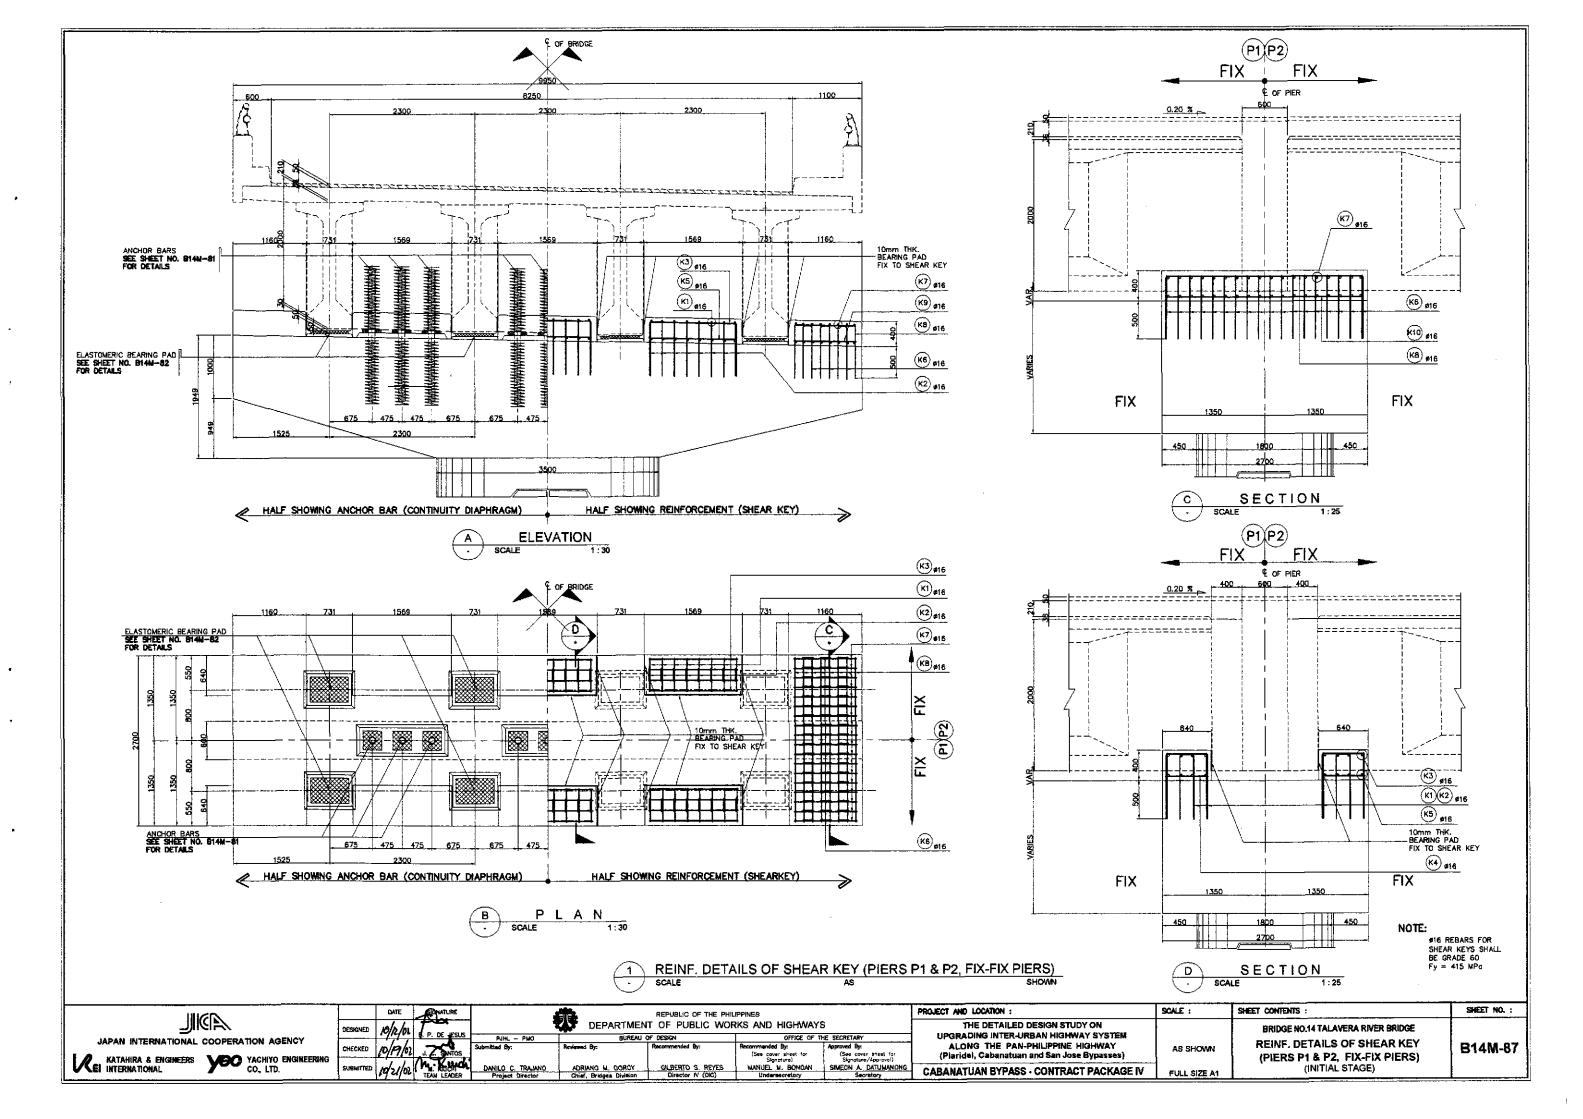


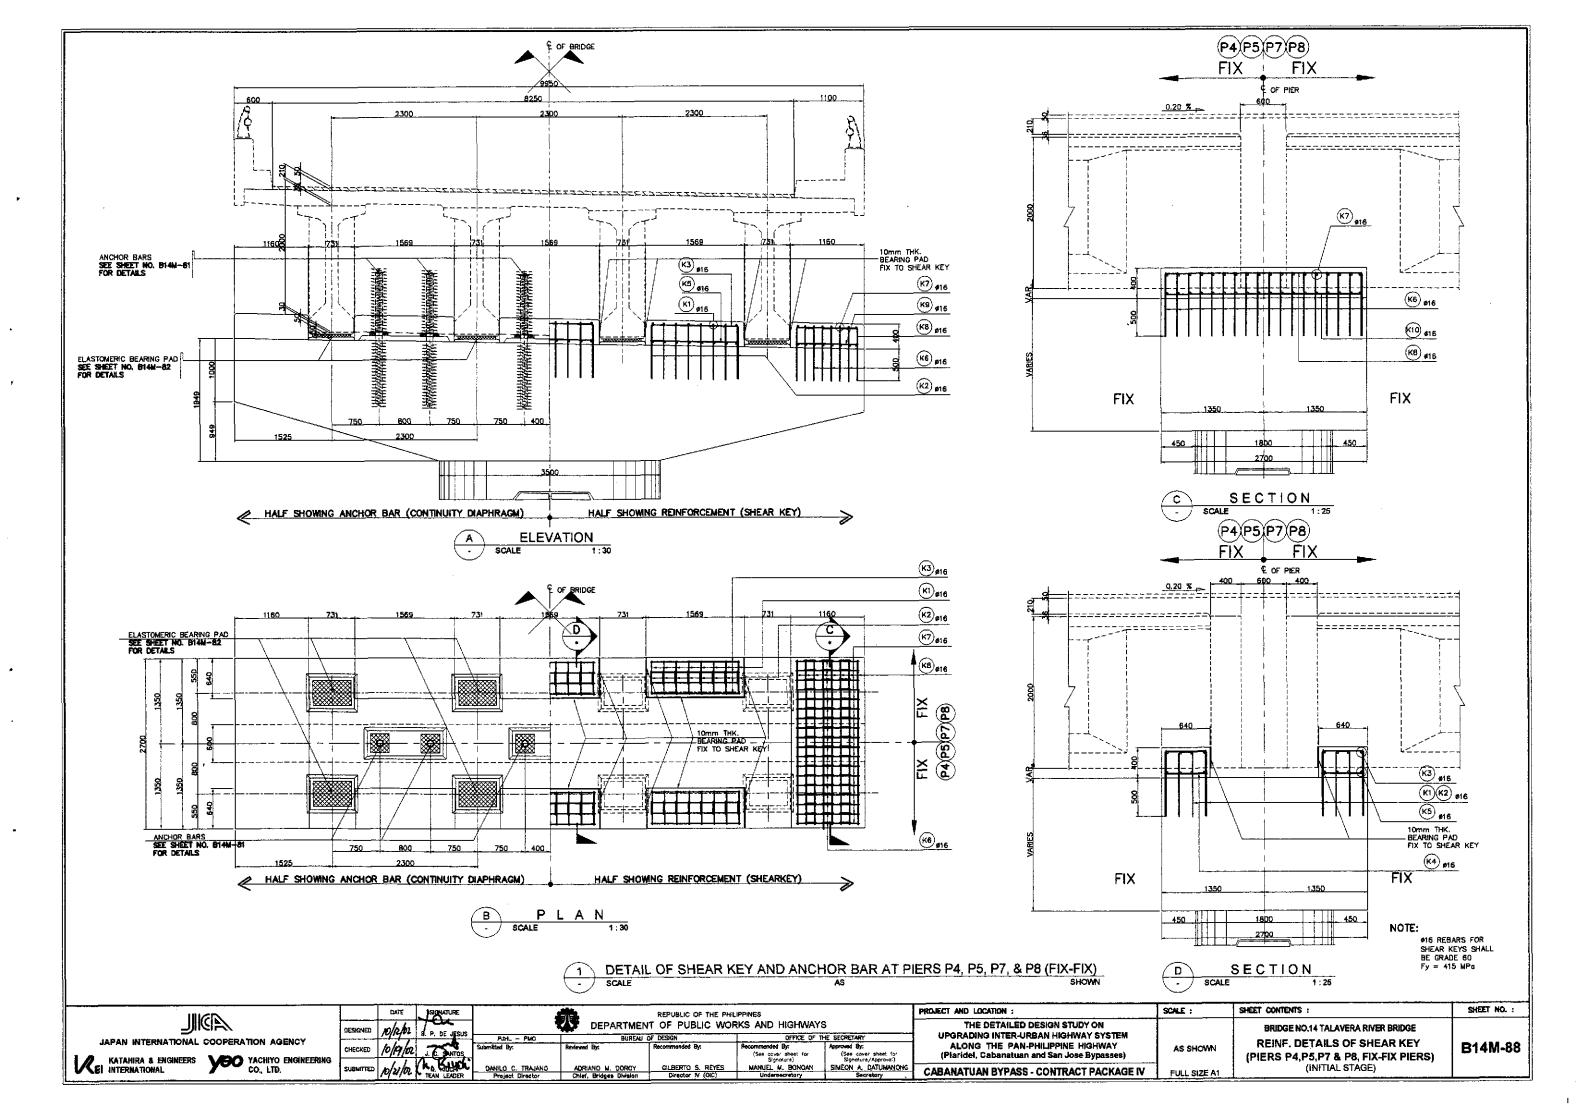


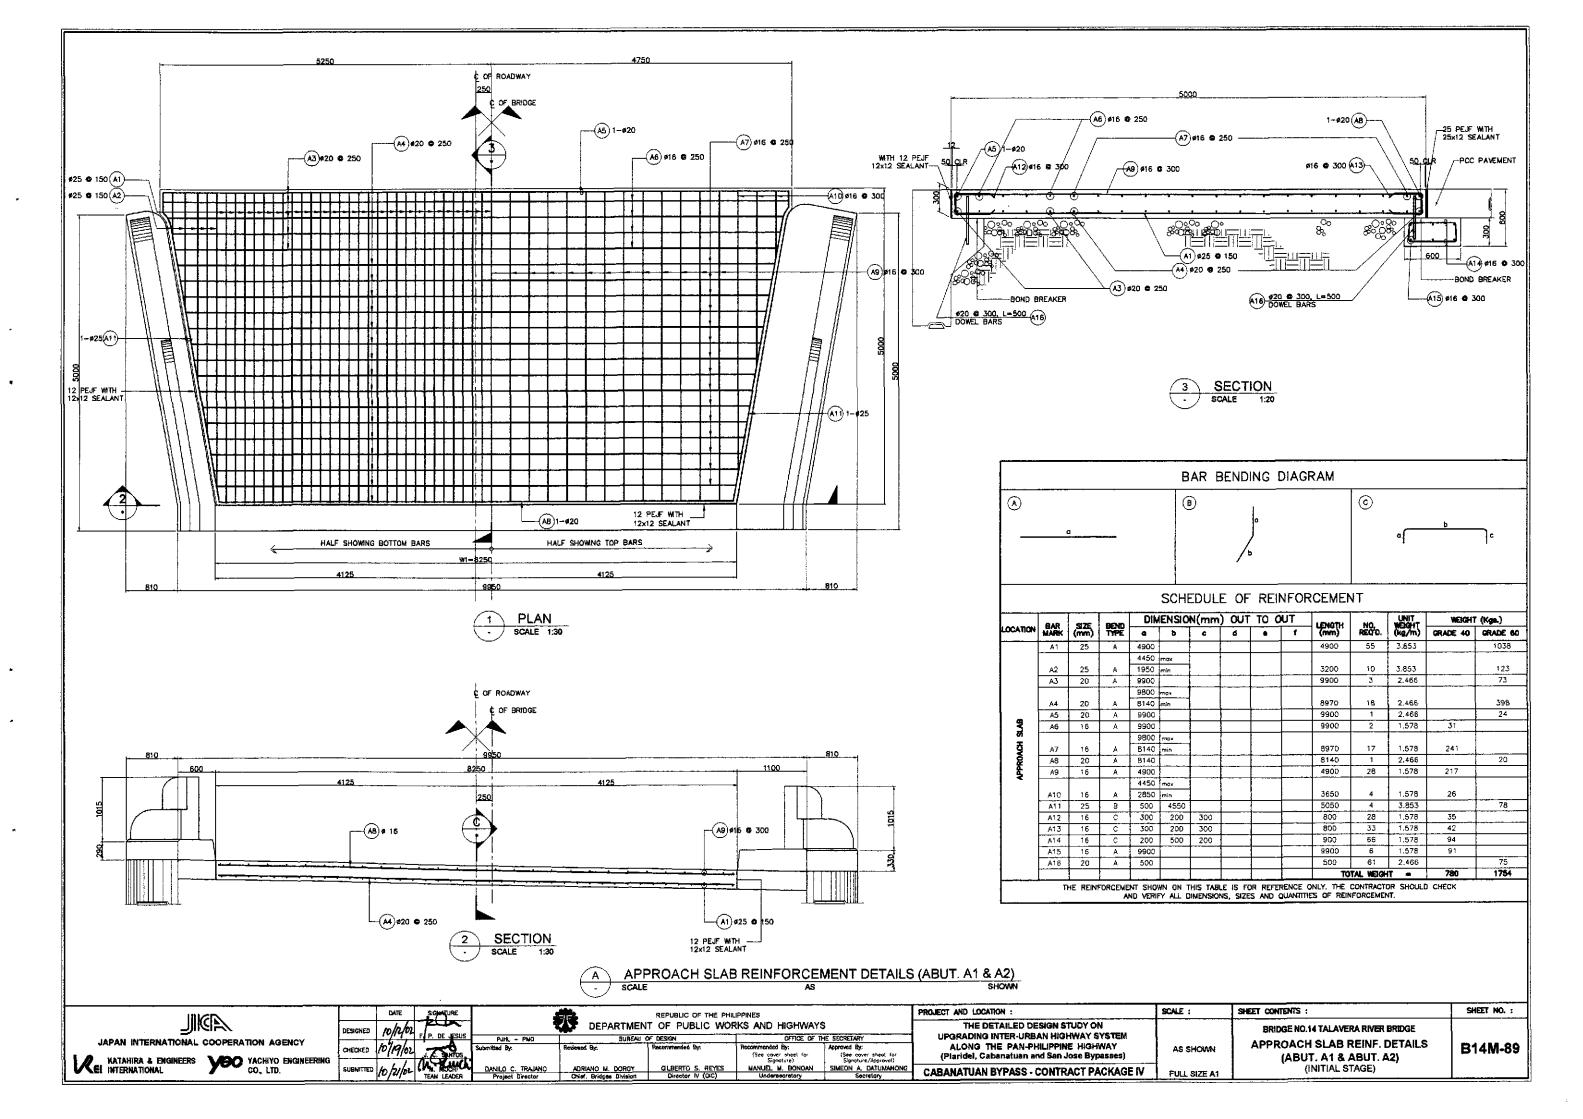


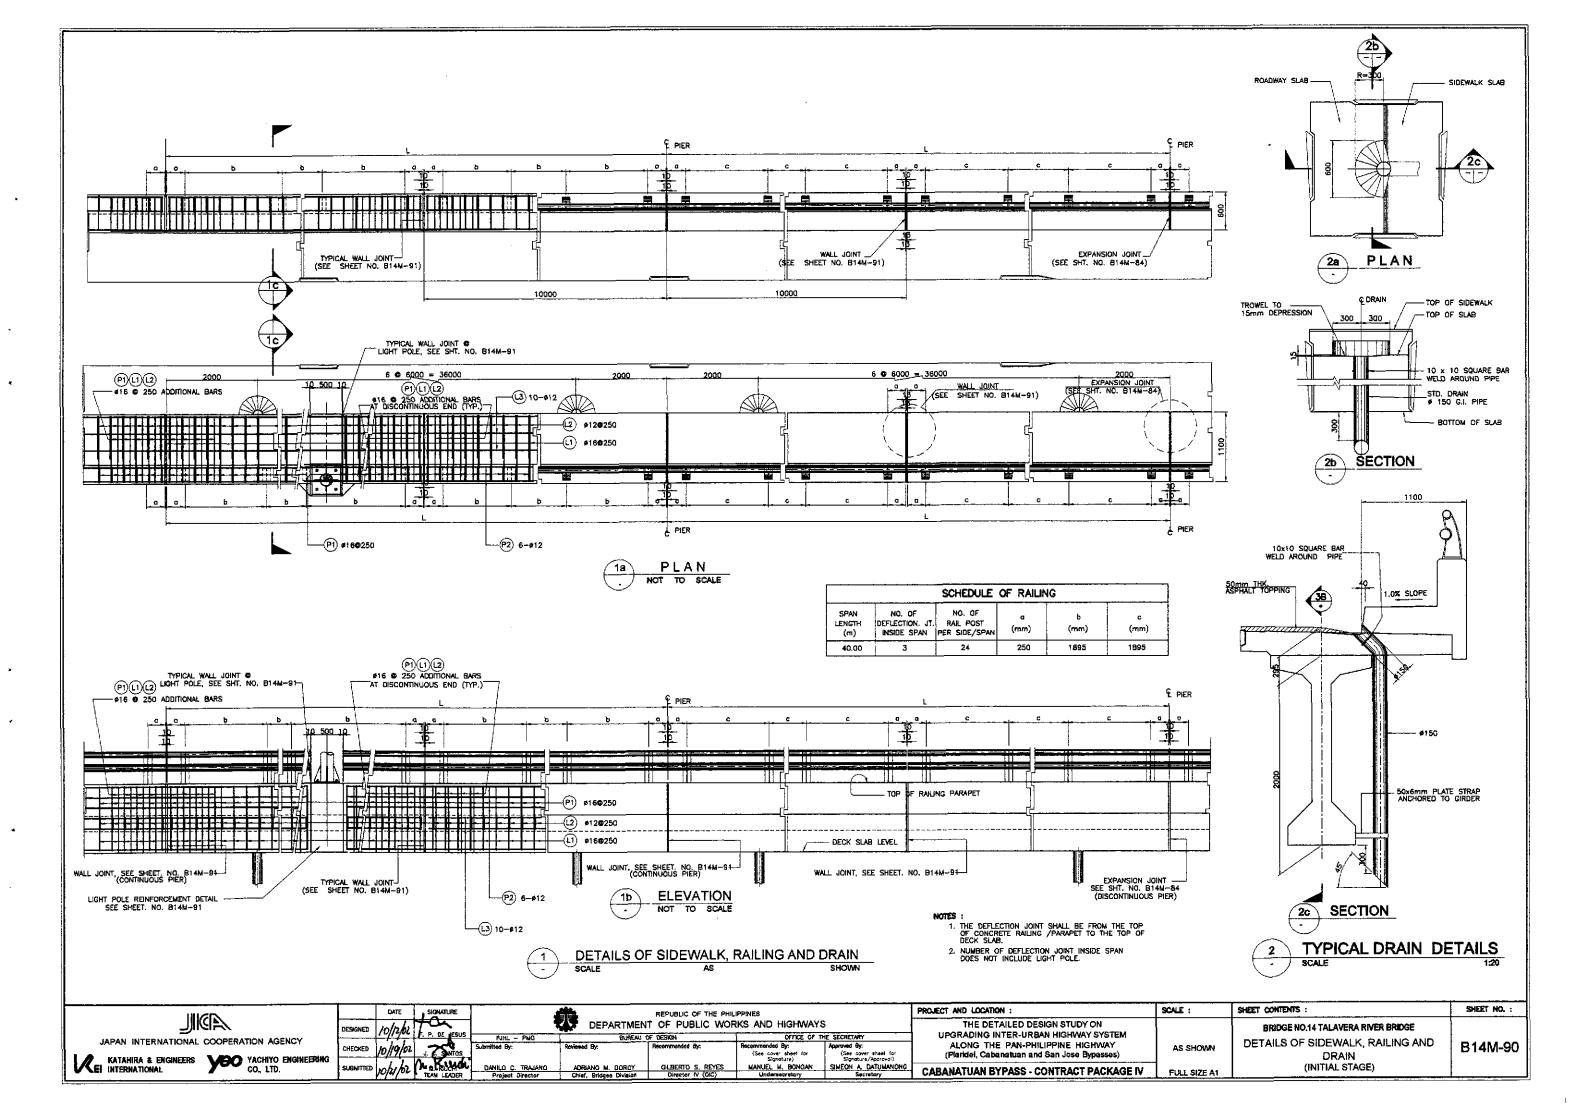


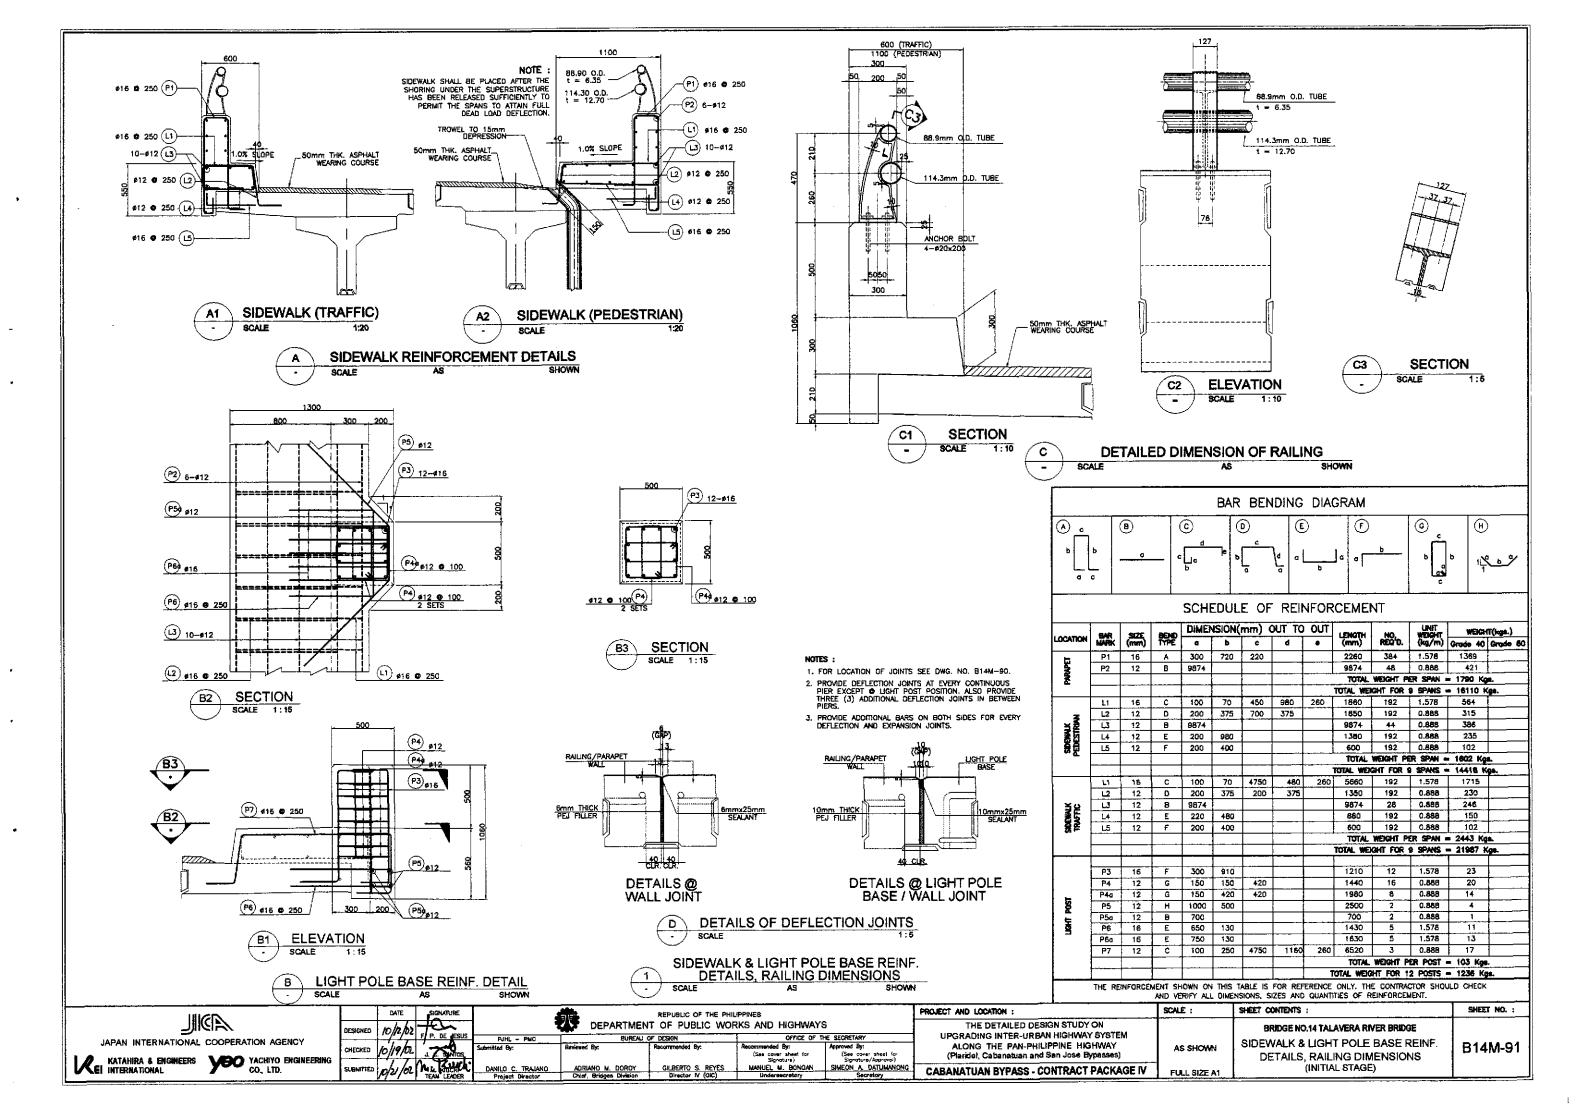


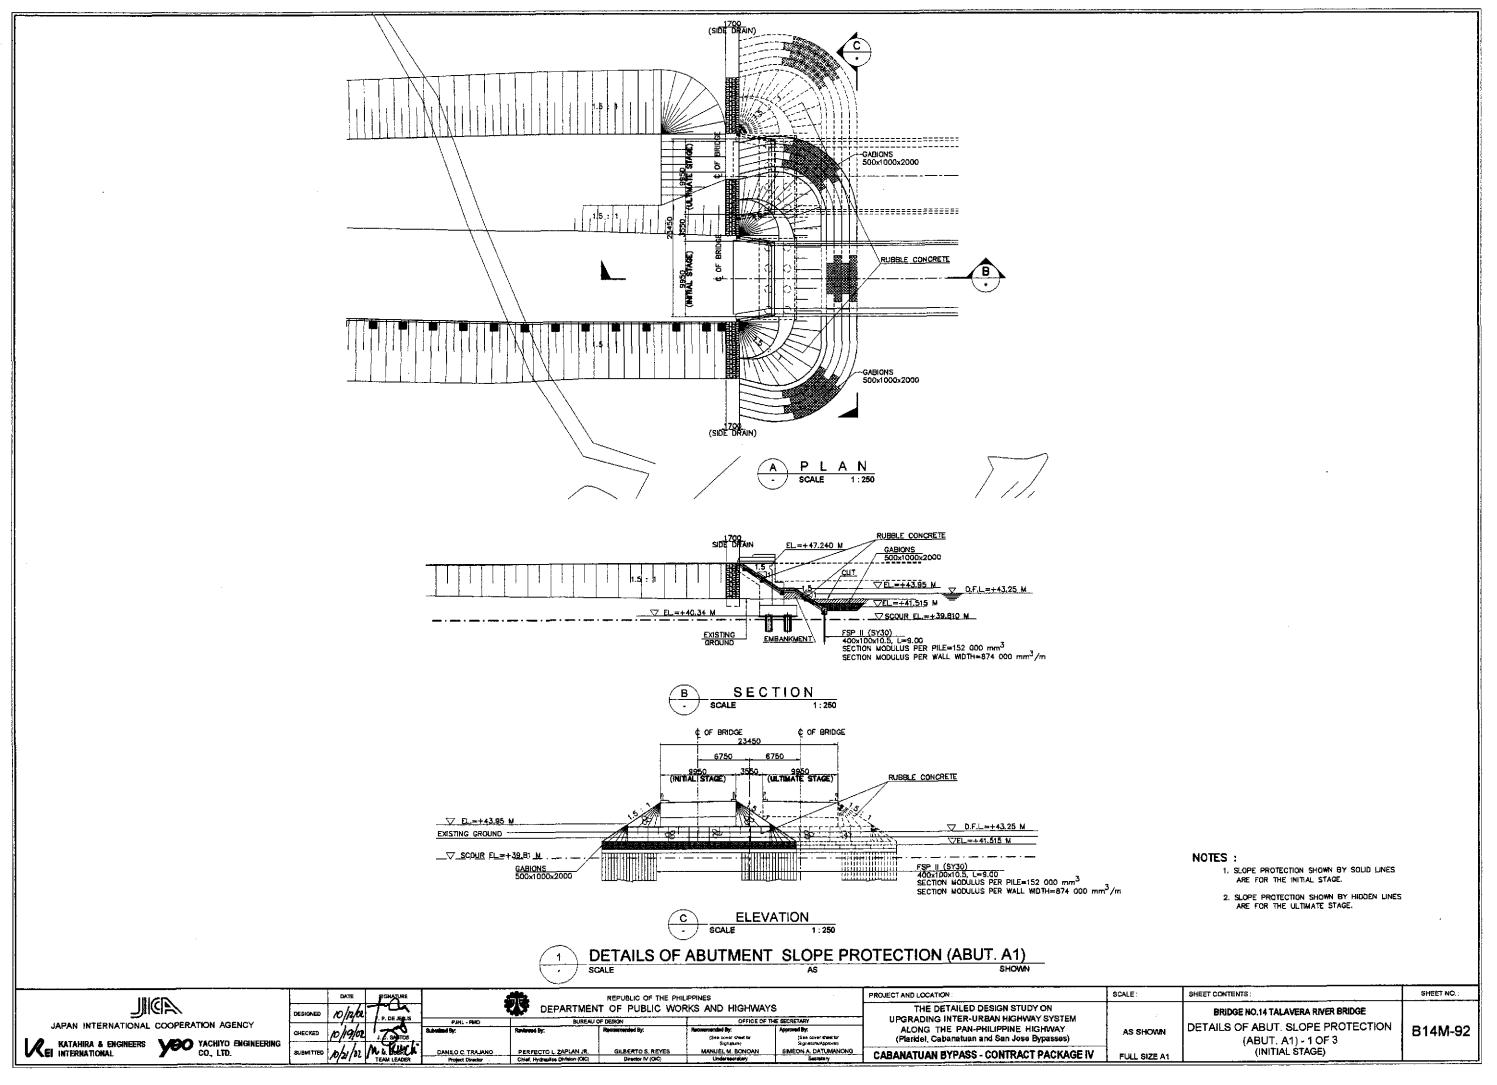


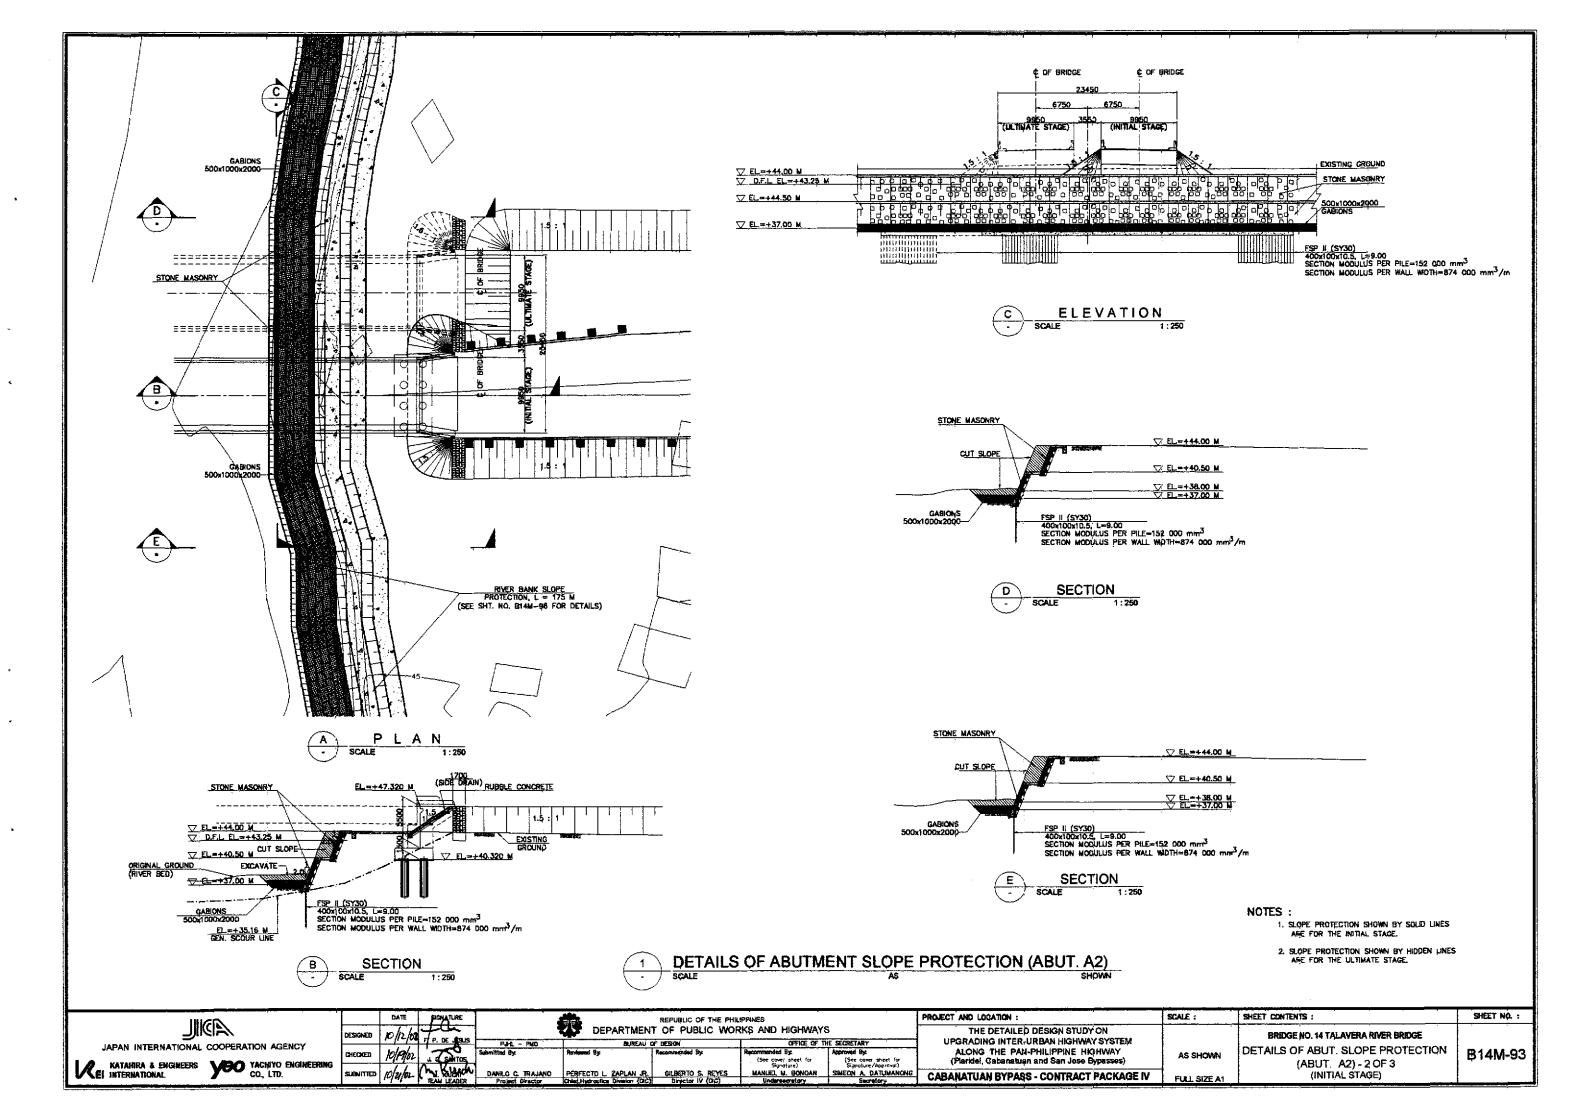


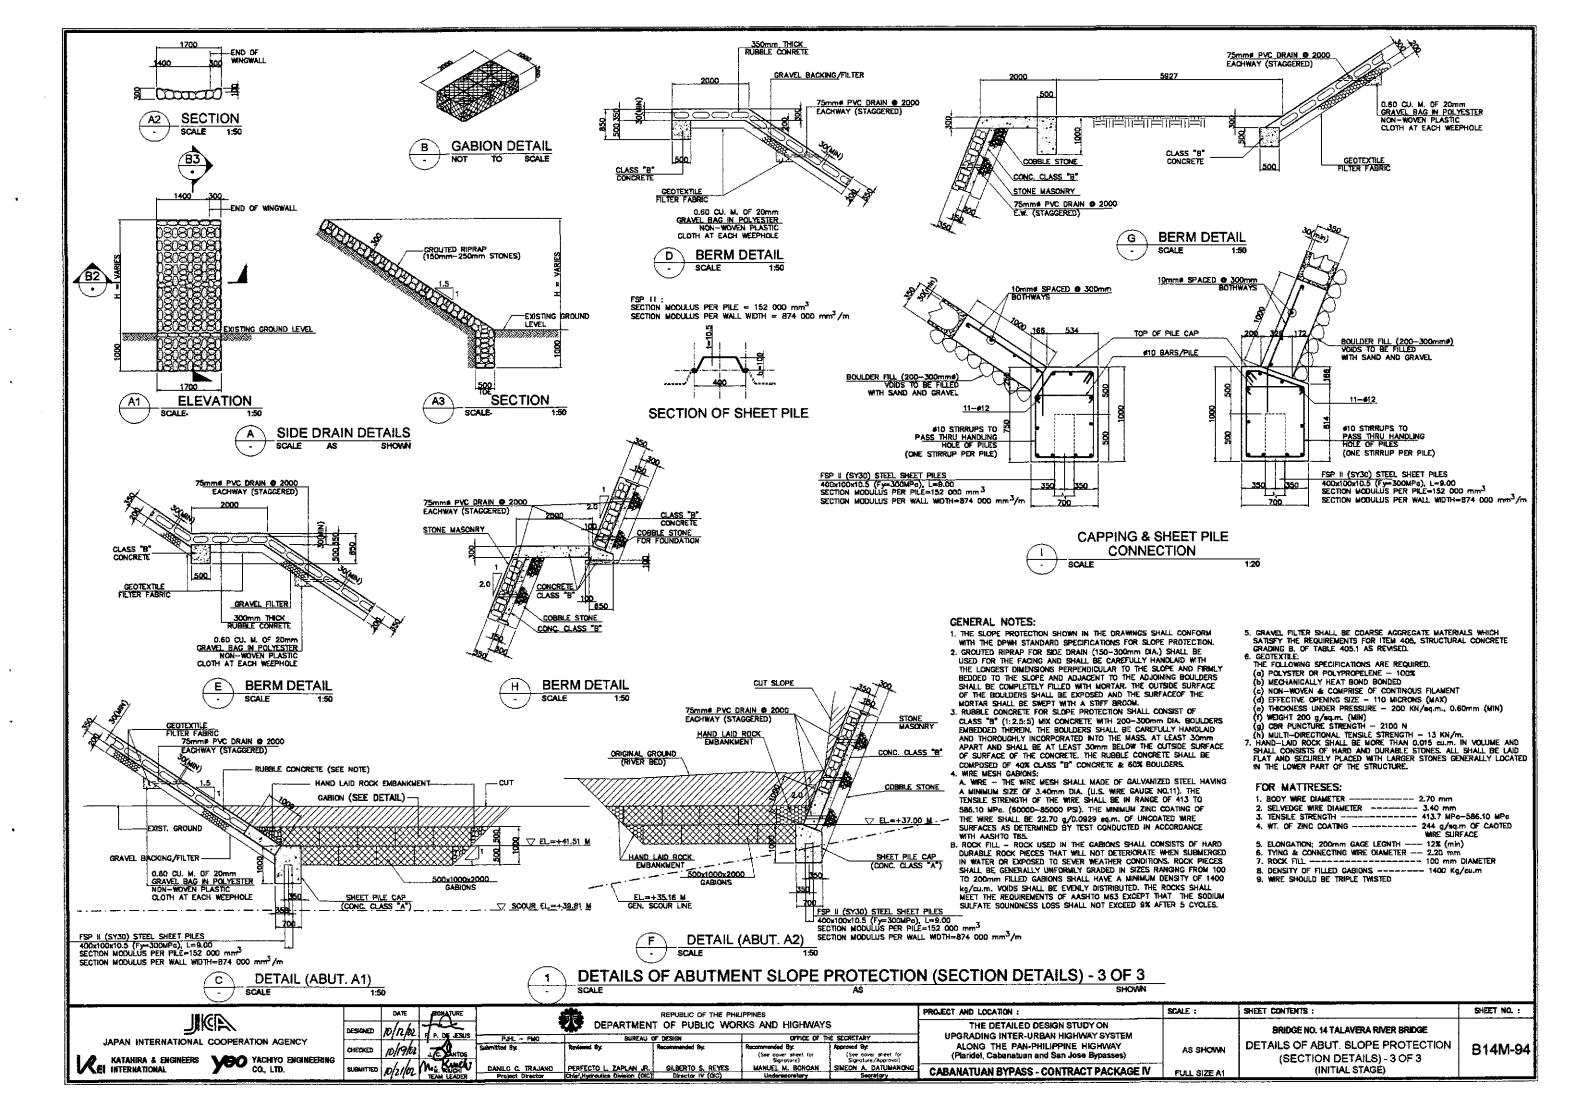


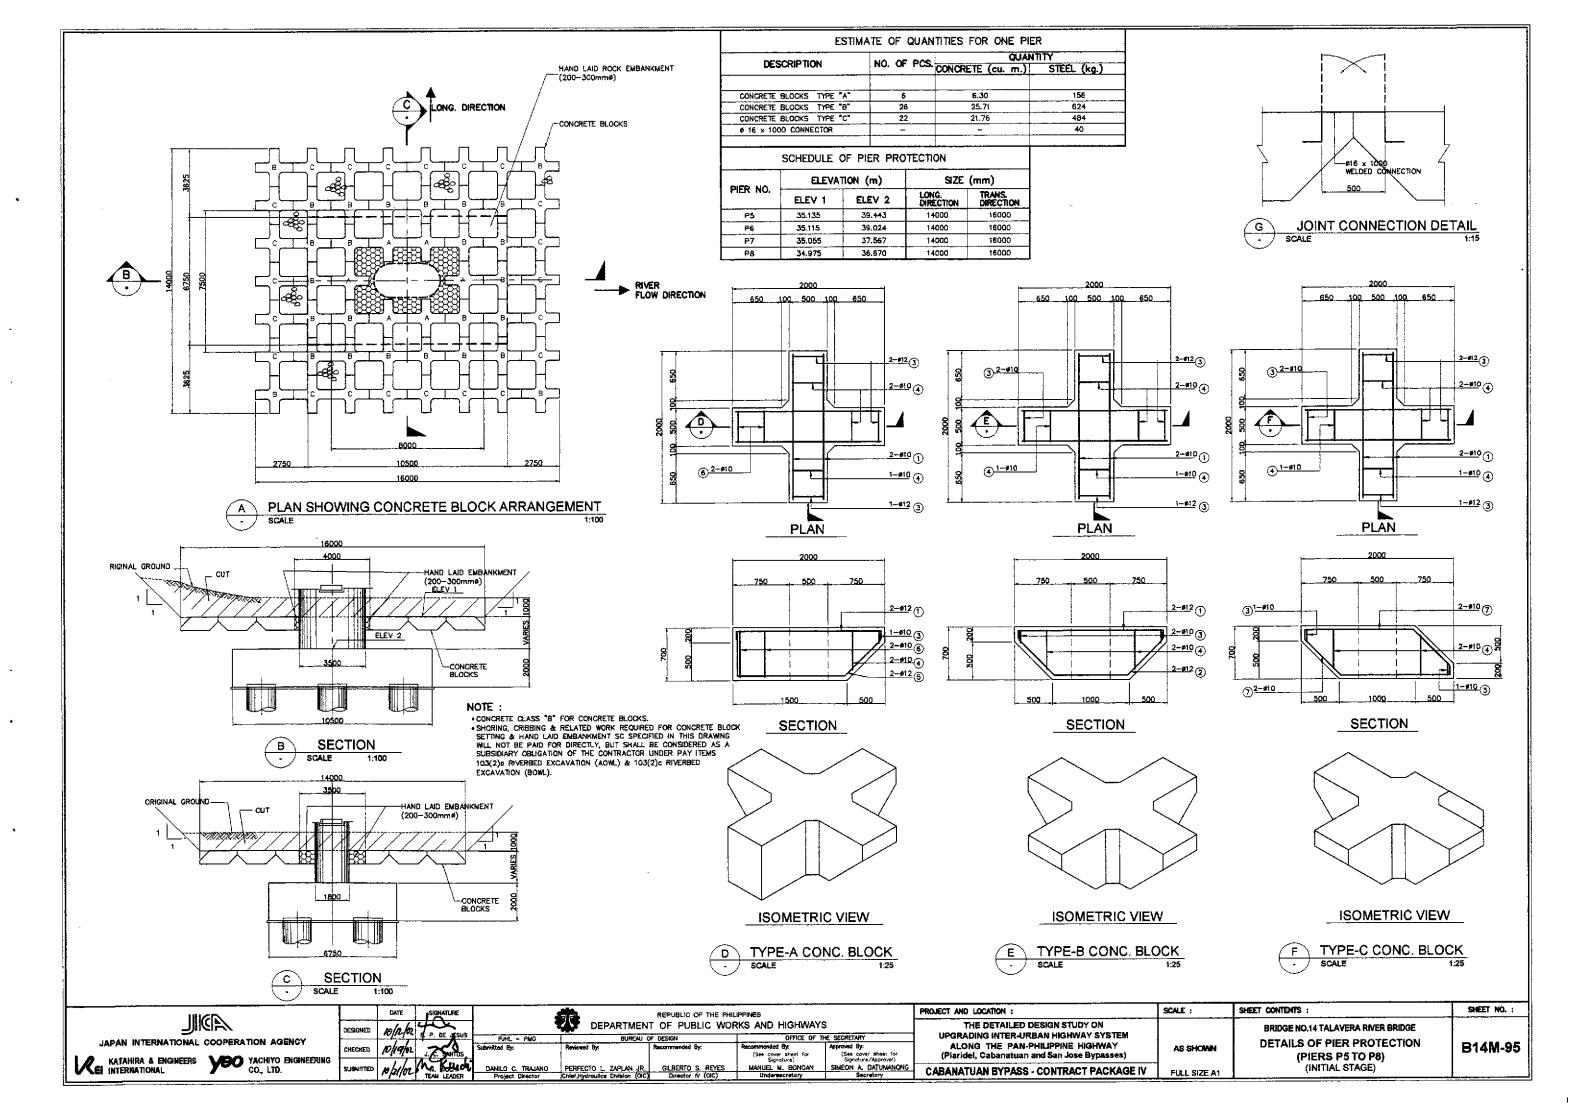


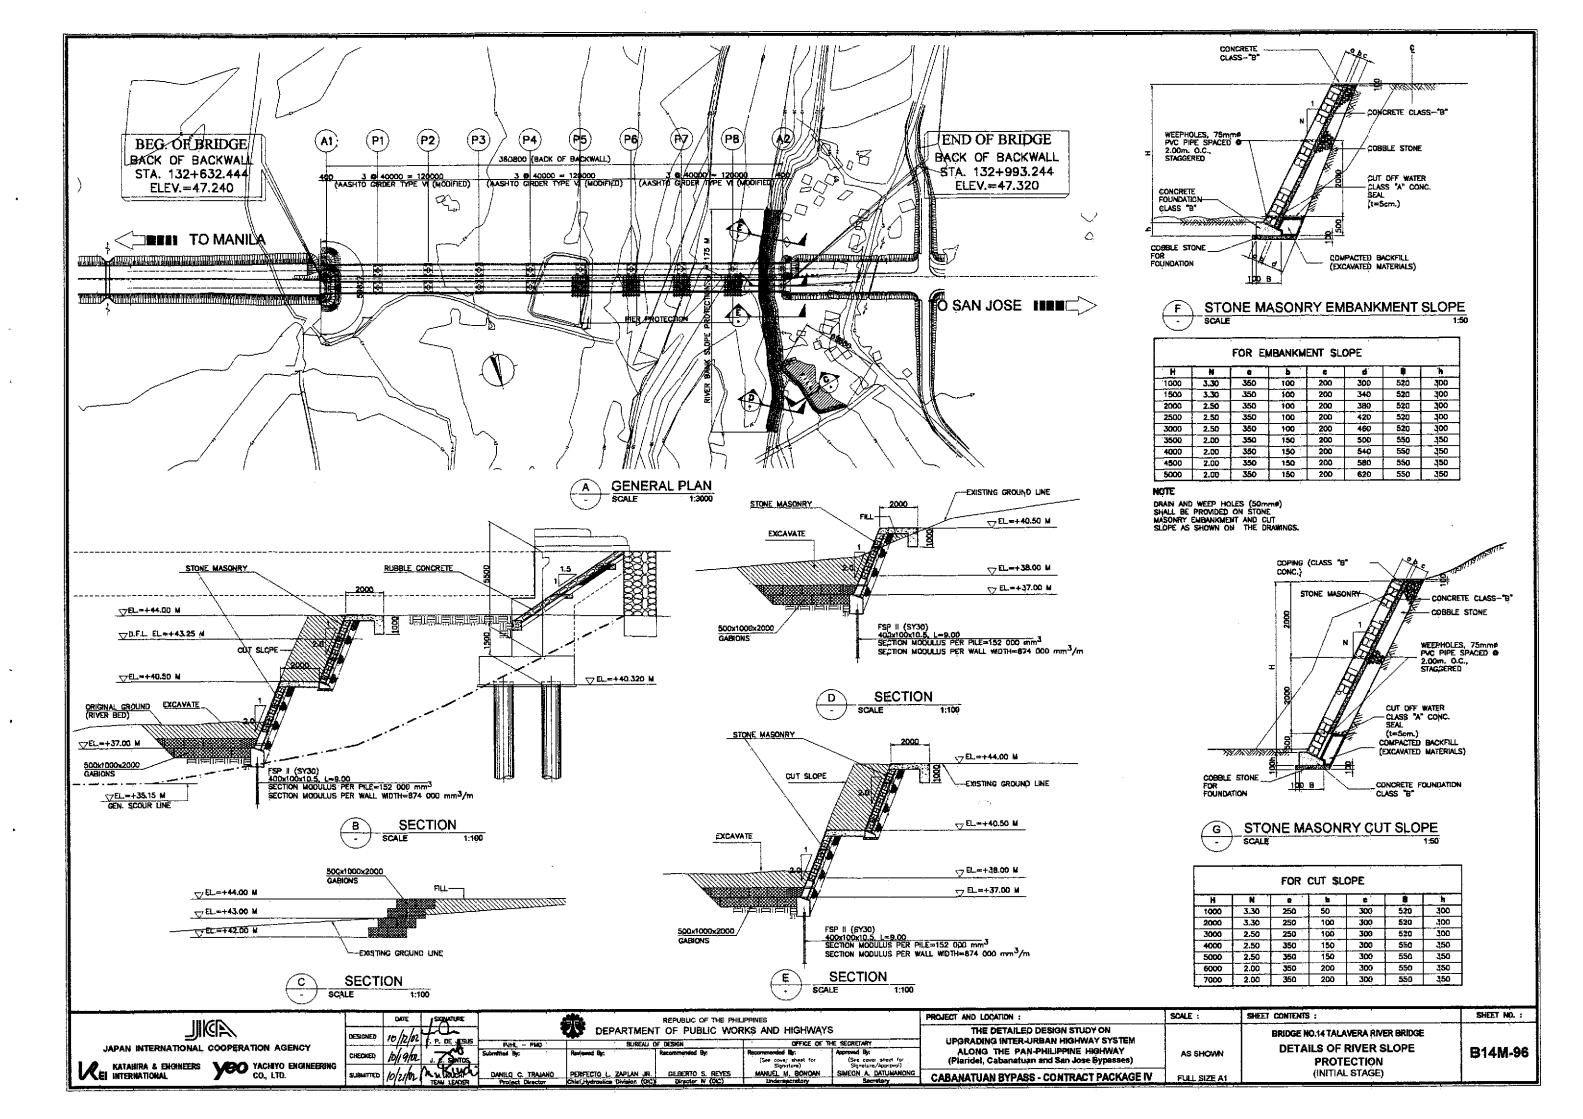


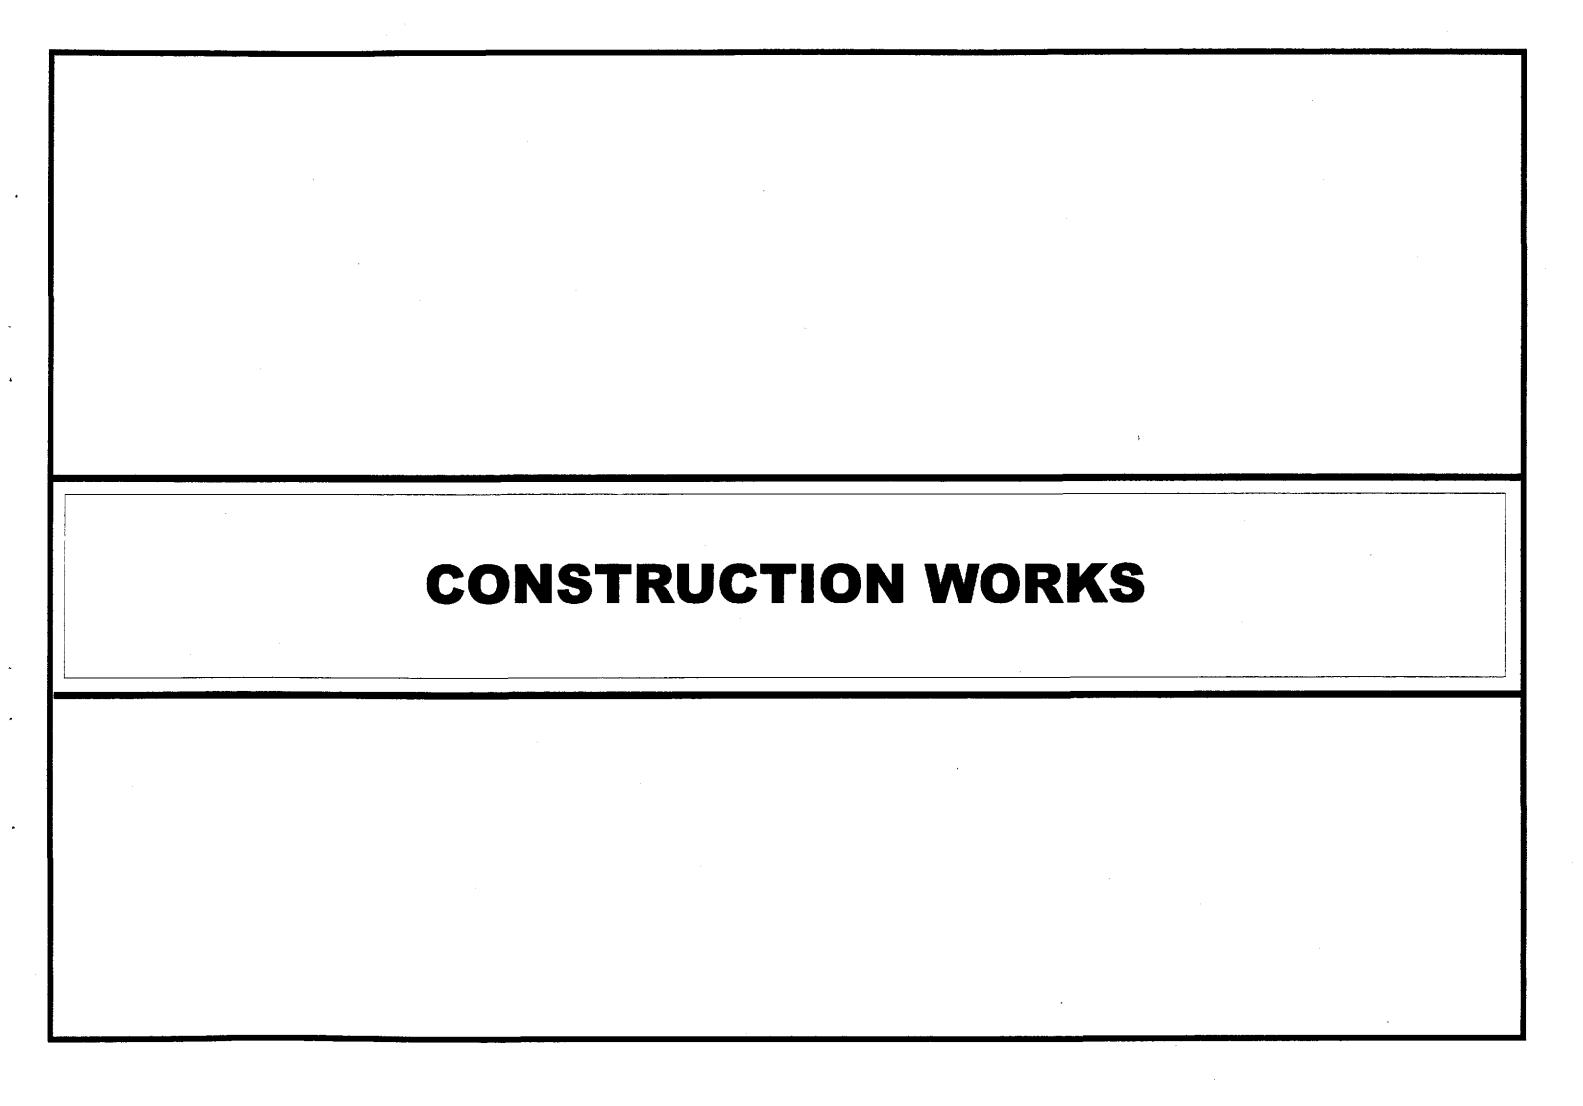

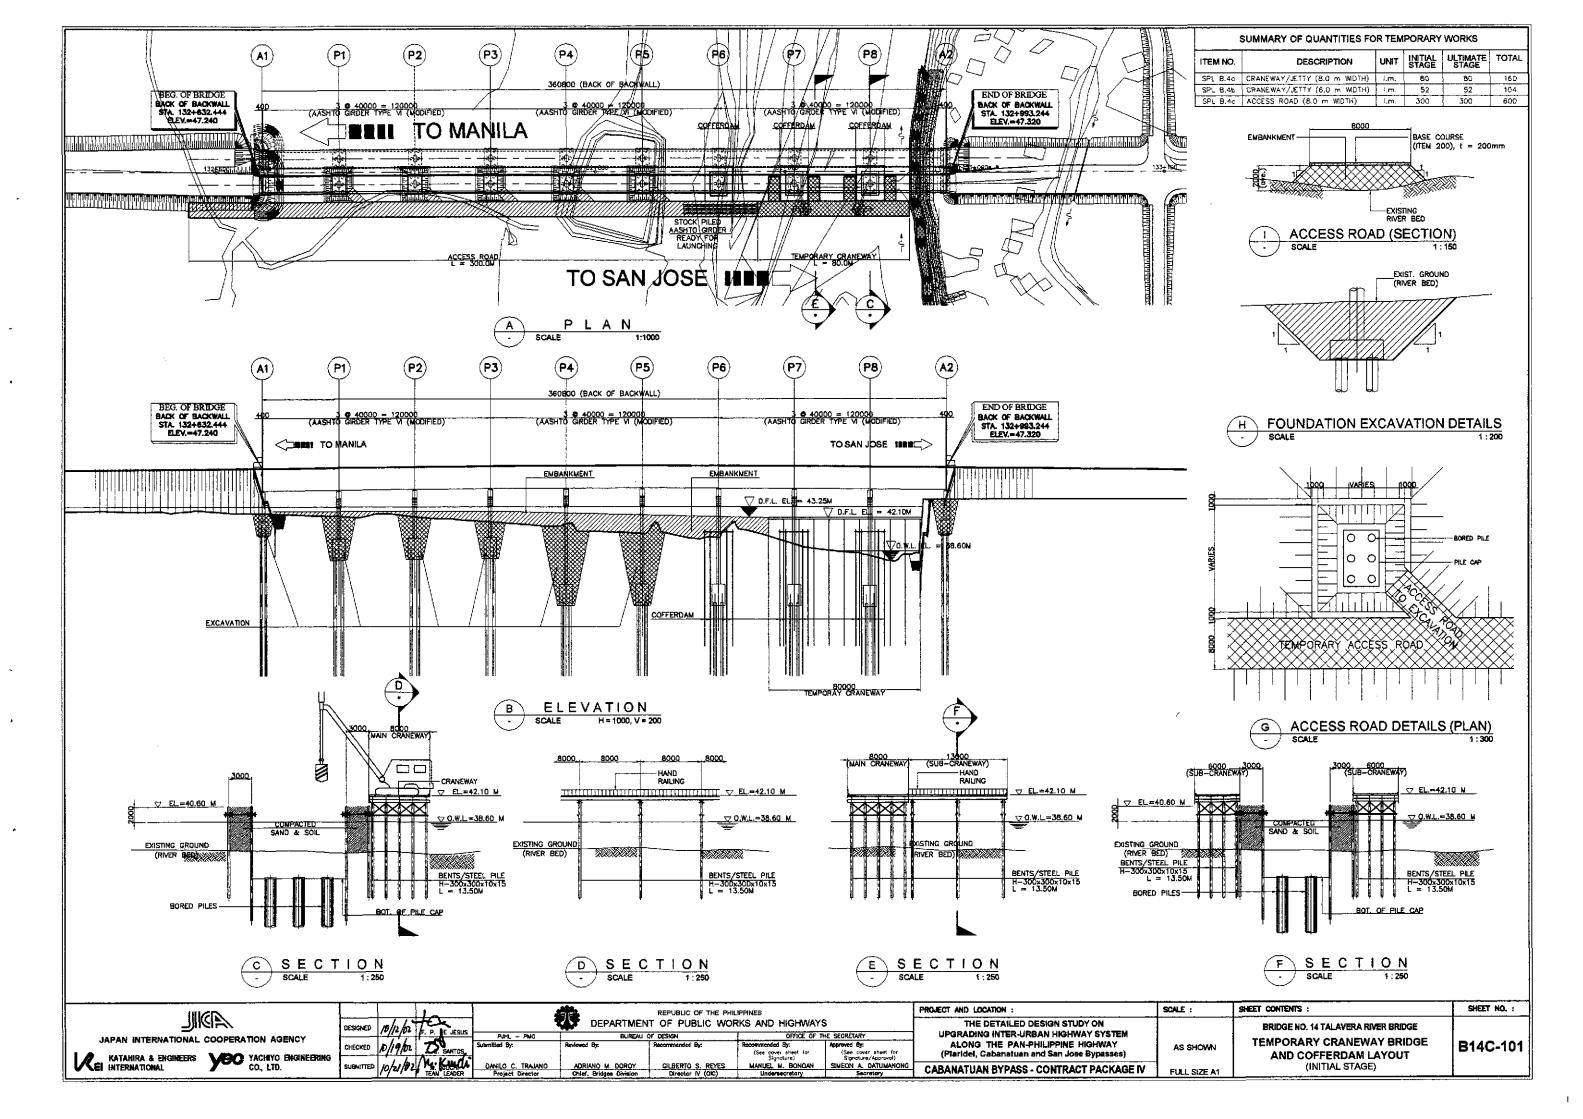

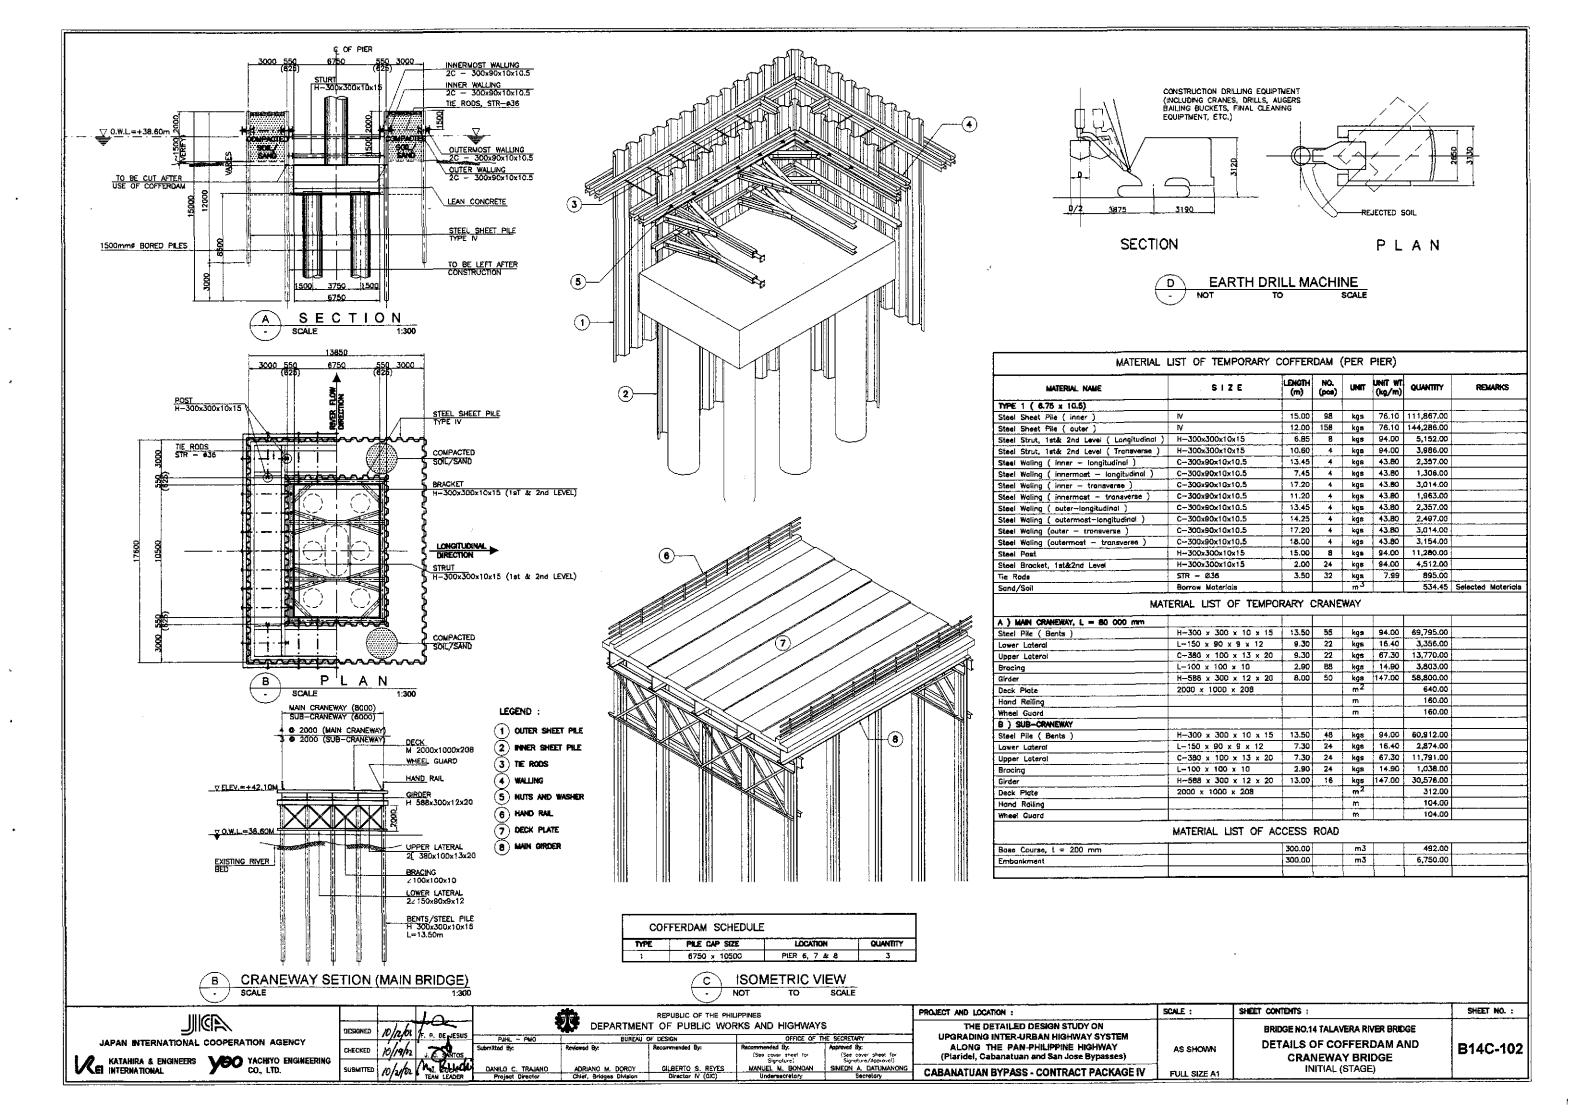

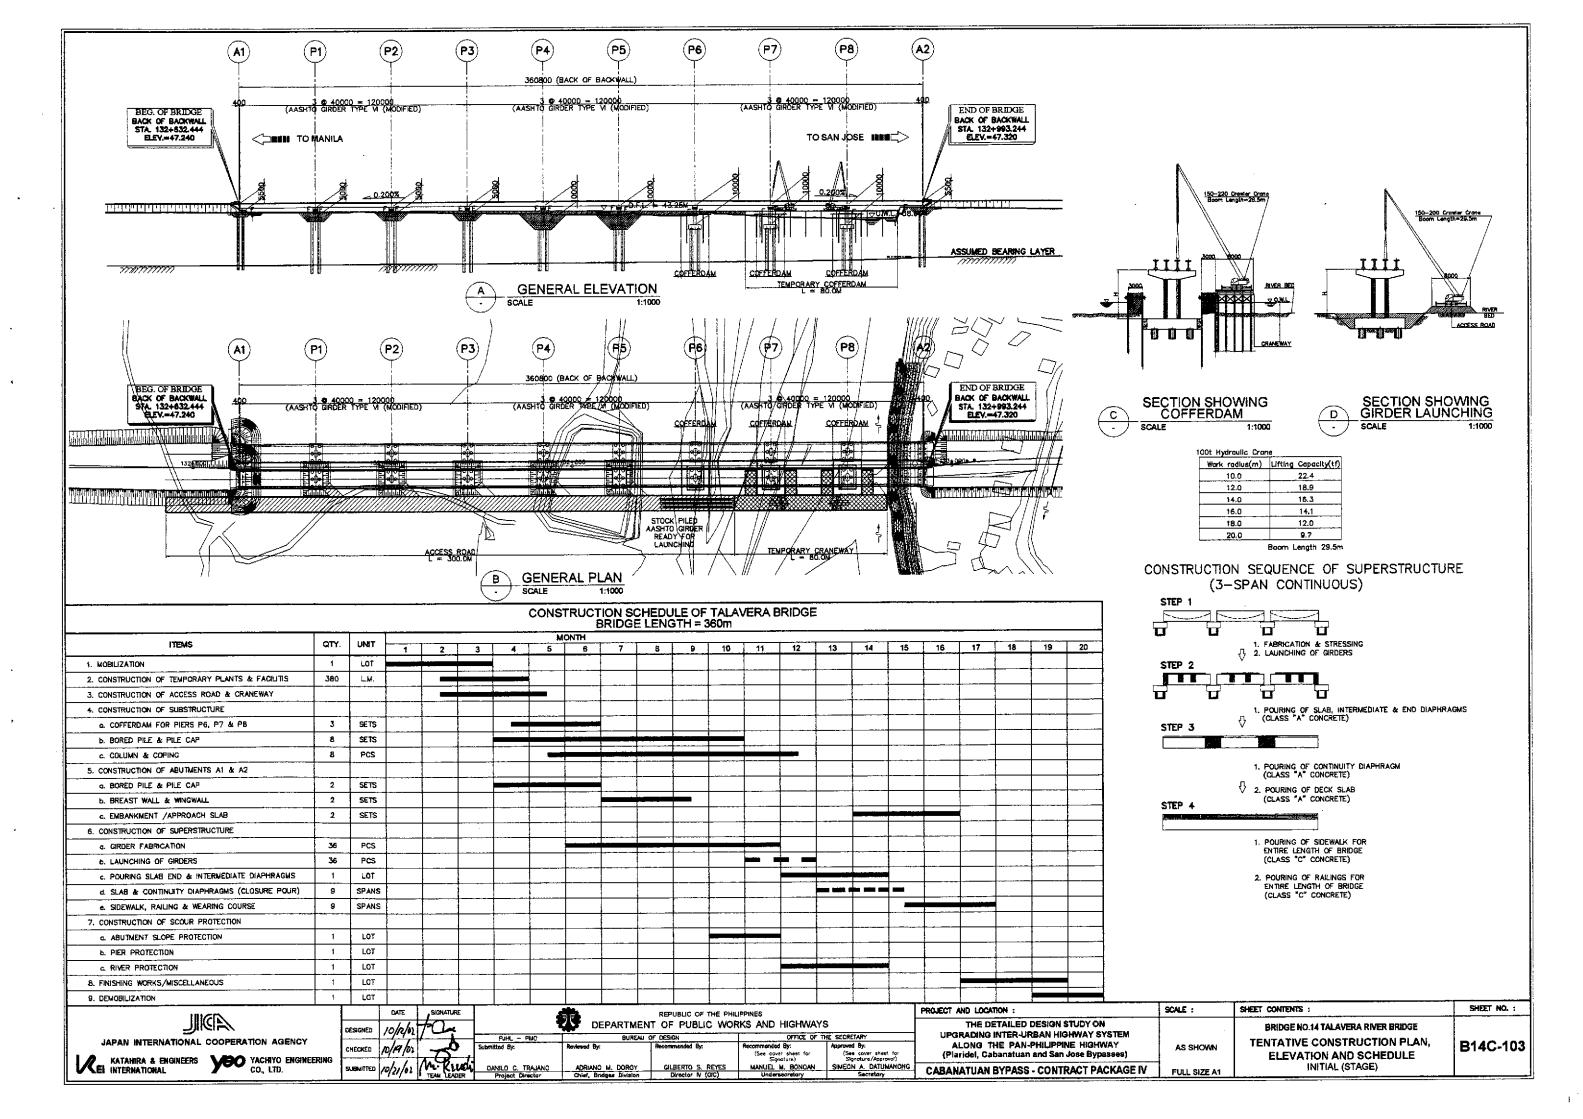

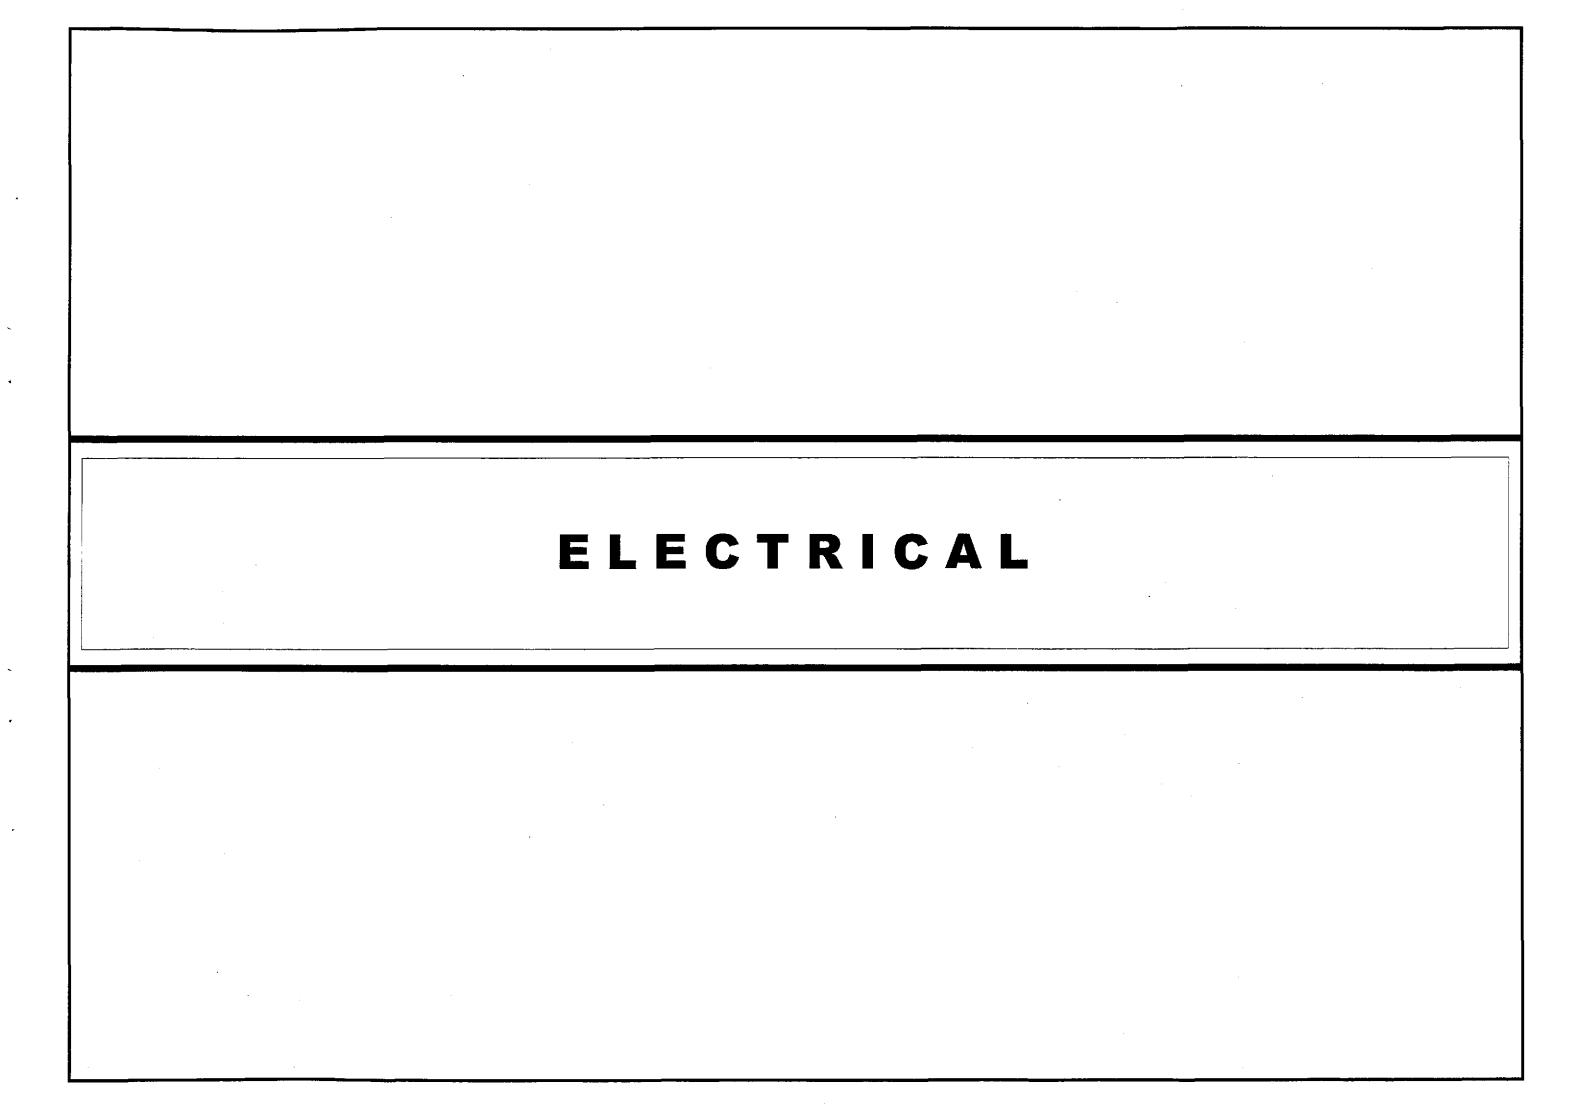

LEGEND AND SYMBOLS:

STREET LIGHTING POLE WITH 1 x 250 WATTS, 240 VOLTS HIGH PRESSURE SODIUM LUMINAIRE SINGLE BRACKET / SINGLE ARM, LOCATED AT 180° ON CENTER IES TYPE III MEDIUM SEMI CUT-OFF, SIMILAR TO GE M250A2

-DITTO- DOUBLE ARM LIGHT POLE WITH 2 x 250 WATTS HPS LAMP

SERVICE ENTRANCE AND METERING PEDESTAL WITH LIGHTING CONTACTOR PANEL AS SHOWN IN THE DRAWINGS.

_____ CIRCUIT BREAKER, RATING AS SHOWN

_____ UNDERGROUND CONDUIT WITH CONCRETE ENVELOPE


UNDERGROUND CONDUIT WITH STEEL REINFORCED CONCRETE ENVELOPE

(M) KILOWATT HOUR WETER, SINGLE-PHASE, 240V, 60 Hz

____ CIRCUIT HOMERUN

GENERAL NOTES:

- ALL ELECTRICAL WORKS SHALL BE DONE IN ACCORDANCE WITH THE PROVISIONS OF THE LATEST EDITION OF THE PHILIPPINE ELECTRICAL CODE, THE LAWS AND ORDINANCES OF THE LOCAL CODE, ENFORCING AUTHORITIES AND THE REQUIREMENTS OF THE LOCAL POWER COMPANY. THE ELECTRICAL WORK SHALL BE DONE UNDER THE DIRECT SUPERVISION OF A DULY REGISTERED ELECTRICAL FINISHER.
- THE CONTRACTOR SHALL SECURE ALL PERMITS AND PAY ALL FEES REQUIRED FOR THE WORK AND FURNISH THE OWNER, THROUGH THE ENGINEERS FINAL CERTIFICATES OF ELECTRICAL INSPECTION AND APPROVAL FROM PROPER COVERNMENT AUTHORITIES FOR COMPLETED WORK.
- THE POWER SERVICE VOLTAGE SHALL BE 240V, 16, 2W, 60 Hz. ALL MATERIALS TO BE USED AND EQUIPMENT TO BE INSTALLED SHALL BE BRAND NEW AND MUST BE OF THE APPROVED TYPES FOR THE PARTICULAR LOCATION AND PURPOSE INTENDED.
- ALL WIRES SHALL BE COPPER, THERMOPLASTIC INSULATED TYPE THW, 600V, UNLESS OTHERWISE INDICATED. BRAND SHALL BE PHELPS DODGE, DURAFLEX DR APPROVED EQUAL.
- UNLESS OTHERWISE INDICATED, THE MINIMUM SIZE OF CIRCUIT CONDUCTORS FROM STEEL POLE
 JUNCTION BOX/HANDHOLE TO EACH LUMINAIRE SHALL BE 2-3.5mm²THW & 1-3.5mm²TW(GND)
 INSIDE STEEL POLE.
- 6. UNLESS OTHERWISE INDICATED ALL CONDUIT PIPES SHALL BE UNPLASTICIZED POLYYMYL CHLORIDE CONDUIT SCHEDULE 40 OR POLYTHELENE PIPE AS MANUFACTURED BY MOLDEX, NELTEX OR APPROVED EQUAL. THE CONDUIT SIZE INDICATED IS THE INSIDE DIAMETER OF CONDUIT.
- THE CONTRACTOR SHALL VERIFY AND COORDINATE TO LOCAL UTILITY COMPANY THE ACTUAL LOCATION
 OF THE SERVICE ENTRANCE FOR CONNECTION TO THE POWER SUPPLY. LIKEWISE, THE CONCRETE
 PEDESTAL SHALL BE PROVIDED BY THE CONTRACTOR.
- ALL NON-CURRENT CARRYING PARTS OF EVERY ELECTRICAL EQUIPMENT/FIXTURE SHALL BE GROUNDED EFFECTIVELY.
- 9. UNDERGROUND CONDUIT RUN SHALL BE BURIED A MINIMUM OF 480mm BELOW GROUND LEVEL UNLESS OTHERWISE INDICATED, CONDUIT RUN CROSSING STREET SHALL BE ENCASED IN STEEL REINFORCED 2500 PSI CONCRETE WITH MINIMUM OF 75mm (3 INCHES) THICKNESS COVERED ALL AROUND.
- 10. UNPROTECTED CONDUIT RISERS AND EXPOSED CONDUIT RUNS SHALL BE RIGID STEEL CONDUIT.
- ALL PANELBOARD ENCLOSURES SHALL BE RAINTIGHT, NEWA 4X ENCLOSURE (1.5mm THICK MINIMUM GAUGE 14 FOR BOX AND COVER) WITH CONCEALED HINGE AND FLUSH LOCK KEY.
- ALL STREET LUMINAIRE ASSEMBLY INCLUDING POLE AND FOUNDATION SHALL WITHSTAND WINDS UP TO 250 KPH PER HOUR GUSTING WITHOUT PERMANENT DEFORMATION.
- 13. DO NOT INSTALL POLE WITHOUT COMPLETE INSTALLATION/CONNECTION OF THE LUMINAIRE ASSEMBLY.
- 14. ALL CIRCUIT BREAKERS SHALL BE UL LISTED AS SWD (SWITCHING DUTY) SUITABLE FOR HIGH INITIAL INRUSH CURRENT FOR SWITCHING THE PRESSURE SODIUM LUMINAIRES. SIEMENS-ITE, SQUARE D, WESTINGHOUSE BRANDS SHALL BE USED OR APPROVED EQUIVALENT.
- 15. CONCRETE HANDHOLES OR OUTDOOR TYPE PULLBOXES OF CODE 1.61mm (GAGE 16) MINIMUM SHALL BE PROVIDED BY THE CONTRACTOR, WHENEVER NECESSARY, TO FACILITATE WIRE PULLING EVEN IF THESE ITEMS ARE NOT SHOWN IN THE PLANS.

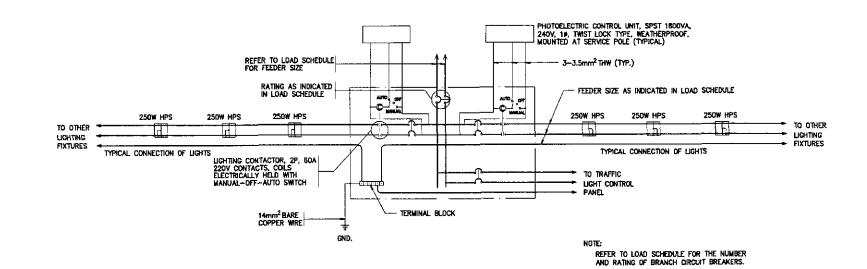


2 SCHEMATIC CONTROL DIAGRAM
1-20

NOTES:

SCALE :

- UNLESS OTHERWISE SPECIFIED, TOP OF CONCRETE ENVELOPE SHALL NOT BE LESS THAN 450mm BELOW FINISHED GRADE LINE EXCEPT, THAT UNDER ROAD AND PAYEMENT, IT SHALL BE NOT LESS THAN 600mm.
- 2. PROVIDE STEEL REBAR REINFORCEMENT ON PAVED AREA.
- 3. ULTIMATE COMPRESSIVE STRENGTH OF CONCRETE Fig SHALL BE 13.8MPo (2000PSI)
- 4. REINFORCING BARS SHALL CONFORM TO PS GRADE 227, FY=227MPd (33,000PSI)
- 5. MAXIMUN SPACING OF PRECAST SPACER SHALL BE 1.5 METERS.
- 6. ALL DIMENSIONS ARE IN MILLIMETER, UNLESS OTHERWISE SPECIFIED.

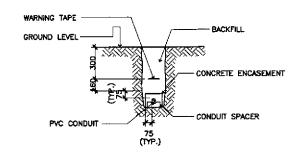



ERNESTO M. ANTIQUIA

DIGNETO

PTR. NO. 7403864 P.E. NO. 2913

SSUED ON 01/00/1802 SSUED AT CHRIVAO LABUMA
TAA 198-382-378

JAPAN INTERNATIONAL COOPERATION AGENCY

KATAHIRA & ENGINEERS

KATAHIRA & ENGINEERING
CO., LTD.

DESIGNED P/12/32 E ANTIQUIA

CHECKED 10/9/02 E ANTIQUIA

SUBMITTED 10/21/01 TEAM LEADER

PJHL — P Submitted By:

REPUBLIC OF THE PHILIPPINES

DEPARTMENT OF PUBLIC WORKS AND HIGHWAYS

BUREAU OF DESIGN

OFFICE OF THE SE

OFFICE OF THE SECRETARY

By: Approved By:
(See cover sheet for Signeture/Approved)
BONDAN SIMEON A. DATUMANONG

THE DETAILED DESIGN STUDY ON UPGRADING INTER-URBAN HIGHWAY SYSTEM ALONG THE PAN-PHILIPPINE HIGHWAY (Plaridel, Cabanatuan and San Jose Bypasses)

CABANATUAN BYPASS - CONTRACT PACKAGE IV

PROJECT AND LOCATION :


AS SHOWN


NOTES & LEGENDS, SCHEMATIC
CONTROL DIAG. & DUCT SECTION
(INITIAL STAGE)

SHEET CONTENTS :


ES-01


SHEET NO. :

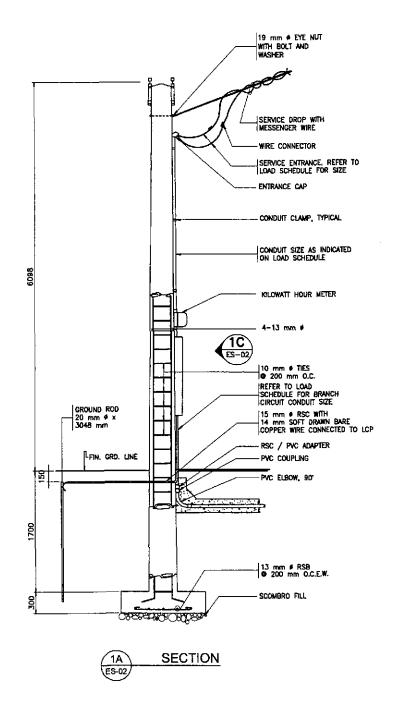

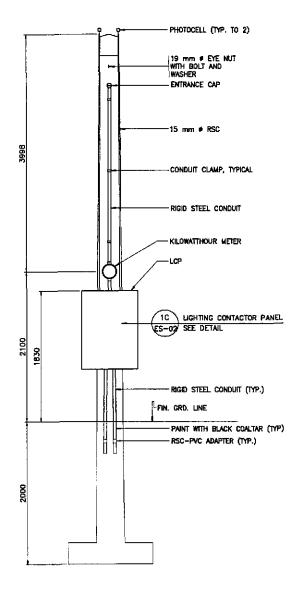




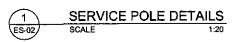

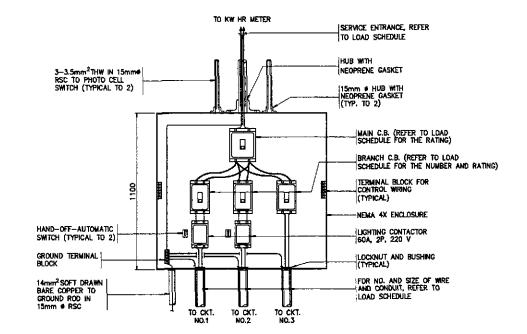



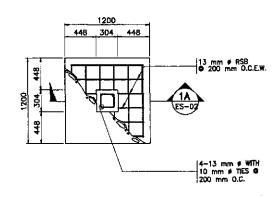

1D FOOTING PLAN

ERNESTO M. ANTIQUIA


BYGA-629

PTR. NO. 746/3864 P.E. NO. 2813

PSUED ON 01/08/2002 SSUED AT CARRYOL LAZAMA

T.I.H. 108-382-279

ISICD	1	DATE	SIGNATURE			REPUBLIC OF THE PHI	LIPPINES		PROJECT AND LOCATION :	SCALE :	SHEET CONTENTS :	SHEET NO. :
	DESIGNED	10/2/01	W W				RKS AND HIGHWAY	S HE SECRETARY	THE DETAILED DESIGN STUDY ON UPGRADING INTER-URBAN HIGHWAY SYSTEM			
JAPAN INTERNATIONAL COOPERATION AGENCY	CHECKED	10/19/02		PJHL - PMO Submitted By:	SUREAU (Reviewed By:	Recommended By:	Recommended By: (See cover sheet for	Approved By: (See cover sheet for	ALONG THE PAN-PHILIPPINE HIGHWAY (Plaridal, Cabanatuan and San Jose Bypasses)	AS SHOWN	SERVICE POLE DETAILS (INITIAL STAGE)	ES-02
KATAHIRA & ENGINEERS YEO YACHIYO ENGINEERING CO., LTD.	SUBMITTED	10/21/02	TEAM LEADER	DANRLO C. TRAJANO Project Director	FE M. BARRIENTOS Chief, Mech'l-Elect'l Division	GILBERTO S. REYES OIC, Director N	Signeture) MANUEL M. BONOAN Undersecretory	Signature/Approval) SIMEON A. DATUMANONG Secretary	CABANATUAN BYPASS - CONTRACT PACKAGE IV	FULL SIZE A1		

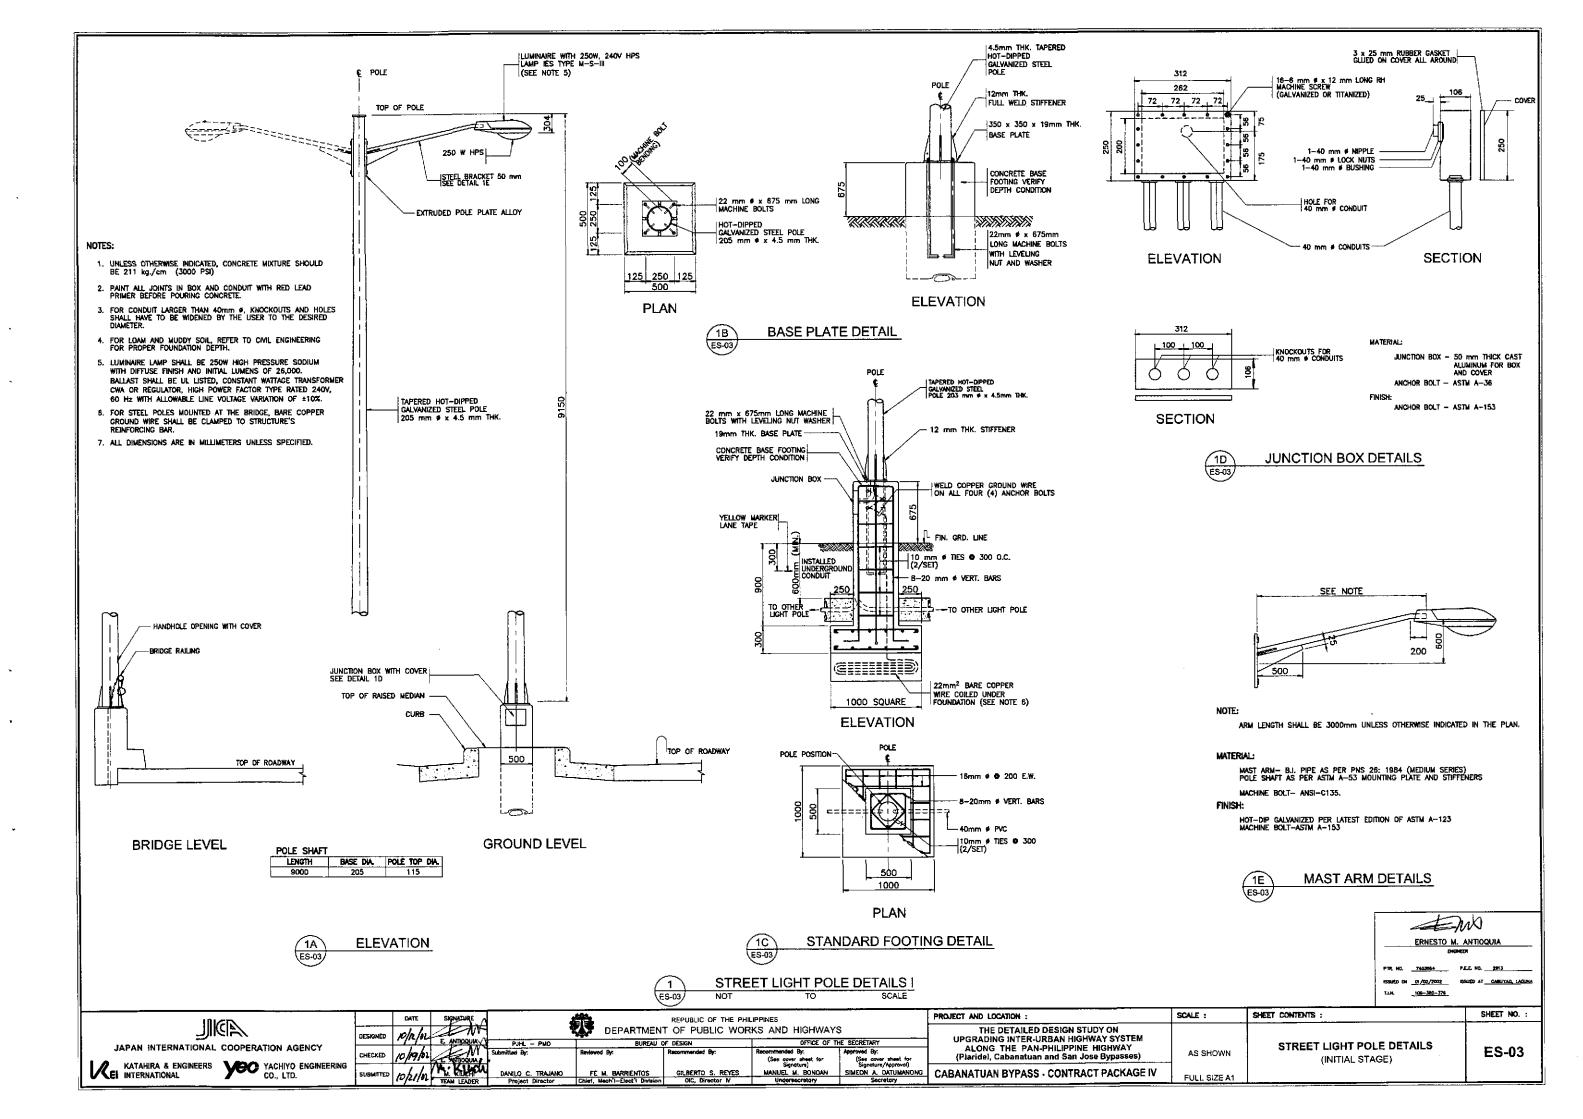


NOTE:

UNLESS OTHERWISE INDICATED, THE MINIMUM SIZE OF CIRCUIT CONDUCTORS FROM STEEL POLE JUNCTION BOX/HANDHOLE TO EACH LIMINAIRE SHALL BE 2-3.5mm² THW AND 1-3.5mm² TW(GND) INSIDE STEEL POLE.

LOAD SCHEDULE

FI	ANEL ID : LCPC14 EED : TOP OUNTING : SURFACE	LIGHTING CONTA PANEL NO.1			ENCLOSURE : NEMA 43 MIN. KAIC : 10 MAIN CB : 80 AT,		, 2P	
CKT.	LOAD DESCRIPTION	CONNECTED LOAD			NO. & SIZE OF	PROTECTION		
NO.	LOAD DESCRIPTION	VOLTS	(VA)	AMPERE	WIRES & CONDUIT	AT	AF	Р
	L201 (1 x 250 W HPS)	220	310	1.41	SEE NOTE 1			
	L200 (1 x 250 W HPS)	220	310	1.41	SEE NOTE 1			
	L199 (2 x 250 W HPS)	220	620	2.82	SEE NOTE 1			
	L189 (2 x 250 W HPS)	220	620	2.82	SEE NOTE 1			
	L188 (2 x 250 W HPS)	220	620	2.82	SEE NOTE 1			[_
1	L187 (2 x 250 W HPS)	220	620	2.82	SEE NOTE 1			
	L186 (2 x 250 W HPS)	220	620	2.82	SEE NOTE 1			
	L185 (2 x 250 W HPS)	220	620	2.82	SEE NOTE 1			
			<u></u>	,		. <u>.</u>		
	SUB-TOTAL		4340	19.74	2-30 mm ² THW & 1-8.0 mm ² TW(G) IN 40 mm# CONDUIT	30	100	2
_	L190 (2 x 250 W HPS)	22D	620	2.82	SEE NOTE 1			
	L191 (2 x 250 W HPS)	220	620	2.82	SEE NOTE 1			
	L192 (2 x 250 W HPS)	220	620	2.82	SEE NOTE 1			
	L193 (2 x 250 W HPS)	220	620	2.82	SEE NOTE 1			
	L194 (2 x 250 W HPS)	220	620	2.82	SEE NOTE 1			
2	L195 (2 x 250 W HPS)	220	620	2.82	SEE NOTE 1			
	L196 (2 x 250 W HPS)	220	620	2.82	SEE NOTE 1			
	L197 (1 x 250 W HPS)	220	310	1.41	SEE NOTE 1			
	L198 (1 x 250 W HPS)	220	310	1.41	SEE NOTE 1			_
	SUB-TOTAL		4960	22.56	2-30 mm ² THW &: 1-8.0 mm ² TW(G) IN 40 mm# CONDUIT	30	100	2
3	TRAFFIC LIGHTS	220	3450	15	WIRES AND CONDUIT (BY OTHERS)	30	100	2
	TOTAL		12750	57.30	2-38 mm²THW IN 40 mm# CONDUIT	80	100	2

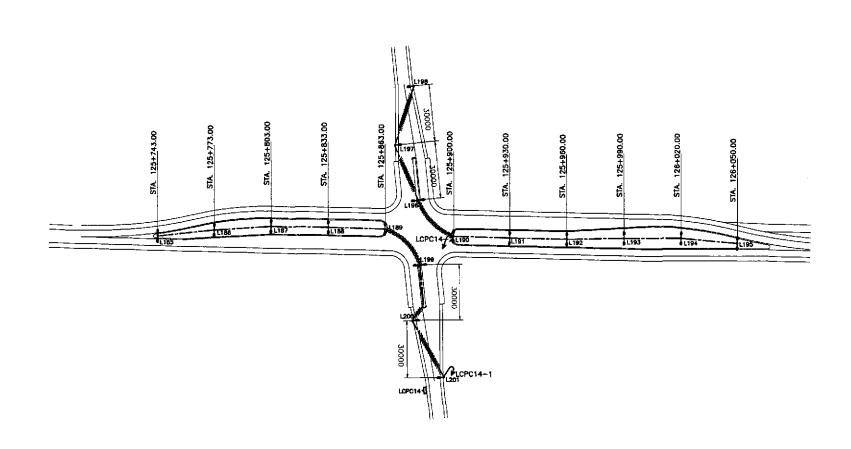

1 ROADWAY LIGHTING PLAN SCALE 1:1000

- TW ERNESTO M. ANTIQUIA ISSUED ON 01/02/2002 ISSUED AT CABUTAD, LAGUNA T.I.N. 108-362-379

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	SUBMITTED	robelor	W. Kind
	•	h - / est /	# TEAM LEADER

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į	京	_ DEPARTMEN	REPUBLIC OF THE PHIL T OF PUBLIC WOR		HIGHWAYS	;
		BUREAU (OF DESIGN		OFFICE OF TH	ı
	Reviewed	Byr:	Recommended By:	Recommended	By:	ĺ

OFFICE OF THE SECRETARY						
Recommended By:	Approved By:	l				
(See cover sheet for	(See cover sheet for Signature/Approval)	L				
Signature)		Г				
MANUEL M. BONDAN	SIMEON A. DATUMANONG	ı				
Undersecretory	Secretary	l.				

PROJECT AND LOCATION :	SCALE :
THE DETAILED DESIGN STUDY ON UPGRADING INTER-URBAN HIGHWAY SYSTEM ALONG THE PAN-PHILIPPINE HIGHWAY (Plaridel, Cabanatuan and San Jose Bypasses)	1:1000
CABANATUAN BYPASS - CONTRACT PACKAGE IV	FULL SIZE A1

SHEET CONTENTS :
ROADWAY LIGHTING PLAN
AND LOAD SCHEDULE
INTERSECTION A-25 (INITIAL STAGE)
1

EI-01

SHEET NO. :


NOTE:

1. UNLESS OTHERWISE INDICATED, THE MINIMUM SIZE OF CIRCUIT CONDUCTORS FROM STEEL POLE JUNCTION BOX/HANDHOLE TO EACH LUMINAIRE SHALL BE 2-3.5mm² THW AND 1-3.5mm² TW(GND) INSIDE STEEL POLE.



LOAD SCHEDULE

FI	ANEL ID : LCPC15 EED : TOP OUNTING : SURFACE	LIGHTING CONTA PANEL NO.1		MIN.	LOSURE : NEMA 4X KAIC : 10 N CB : 80 AT, 100 A	AF, 2P		
CKT. NO.	LOAD DESCRIPTION	VOLTS	CONNECTE (VA)	ED LOAD AMPERE	NO. & SIZE OF WIRES & CONDUIT	PRO	TECTIO AF	N P
NU.			• •				~	_
	L219 (1 x 250 W HPS)	220	310	1.41	SEE NOTE 1			
	1218 (2 x 250 W HPS)	220	620	2.82	SEE NOTE 1			
	1,217 (2 x 250 W HPS)	220	620 620	2.82	SEE NOTE 1			
	1207 (2 x 250 W HPS)	220			SEE NOTE 1			
	L206 (2 x 250 W HPS)	220	620 620	2.82	.			
1	L205 (2 x 250 W HPS)	220		2.82	SEE NOTE 1		\vdash	
	L204 (2 x 250 W HPS)	220 220	620	2.82	SEE NOTE 1			
	L203 (2 x 250 W HPS)				SEE NOTE 1			
	L202 (2 x 250 W HPS)	220	62D	2.82	SEE NUIE I			
	SUBTOTAL		5270	23.97	2-30 mm ² THW & 1-8.0 mm ² TW(G) IN 40 mm# CONDUIT	30	100	2
	1208 (2 x 250 W HPS)	220	6 20	2.82	SEE NOTE 1			
	L2D9 (2 x 250 W HPS)	220	62D	2.82	SEE NOTE 1			
	L210 (2 x 250 W HPS)	220	620	2.82	SEE NOTE 1			
	L211 (2 x 250 W HPS)	220	620	2.82	SEE NOTE 1			
	L212 (2 x 250 W HPS)	220	620	2.82	SEE NOTE 1			
2	L213 (2 x 250 W HPS)	220	620	2.82	SEE NOTE 1			
	L214 (2 x 250 W HPS)	220	B20	2.82	SEE NOTE 1			
	L215 (2 x 250 W HPS)	220	520	2.82	SEE NOTE 1	L		
	L216 (1 x 250 W HPS)	220	310	1,41	SEE NOTE 1			
	SUB-TOTAL		5270	23.97	2-30 mm ² THW & 1-8.0 mm ² TW(G) IN 40 mm# CONDUIT	30	100	2
3	TRAFFIC LIGHTS	220	3450	15	WIRES AND CONDUIT (BY OTHERS)	30	100	2
	TOTAL		13990	62.94	2-38 mm ² THW IN 40 mm# CONDUIT	80	100	2

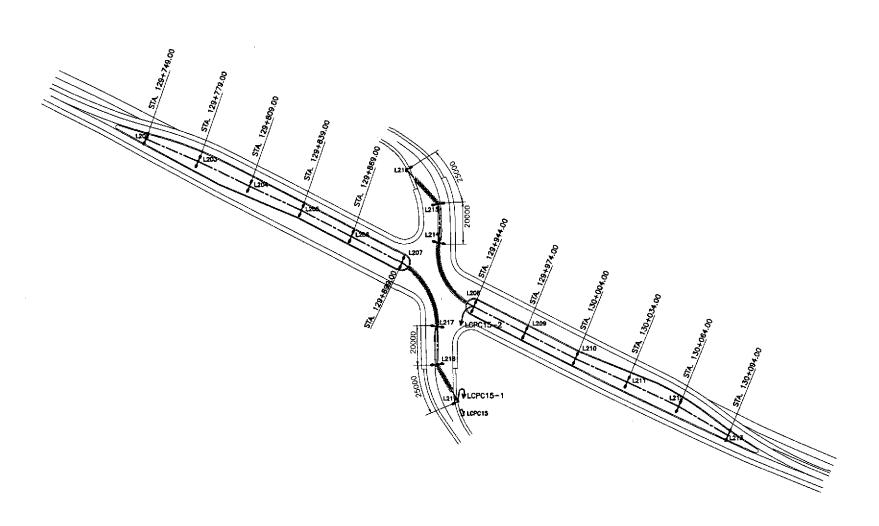

ROADWAY LIGHTING PLAN
SCALE 1:1000

ERNESTO M. ANTIOQLIIA


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SSUED ON 01/02/2002 ISSUED AT CABUYAG, LAGANA


TUN. 100-362-579

I ST C D	1	DATE	SIGNATURE /	\		REPUBLIC OF THE PHI	LIPPINES		PROJECT AND LOCATION :	SCALE :	SHEET CONTENTS :	SHEET NO. :
	DESIGNED	plake	1 W	3	DEPARTMEN		RKS AND HIGHWAY	s ·	THE DETAILED DESIGN STUDY ON UPGRADING INTER-URBAN HIGHWAY SYSTEM		DOADWAY LIGHTING DIAN	
JAPAN INTERNATIONAL COOPERATION AGENCY		10/19/10	E ANTOGUN	PJHL — PMO Submitted By:	SUREAU (Reviewed By:	OF DESIGN Recommended By:		Approved By: (See cover sheet for	ALONG THE PAN-PHILIPPINE HIGHWAY (Plaridel, Cabanatuan and San Jose Bypasses)	1:1000	ROADWAY LIGHTING PLAN AND LOAD SCHEDULE	EI-02
KATAHIRA & ENGINEERS YEC YACHIYO ENGINEERING CO., LTD.	SUBMITTED	10/21/0	h Kiw	DANILO C. TRAJANO	FE M. BARRIENTOS	GILBERTO S. REYES	(SBS cover sheet for Signature) MANUEL M. BONDAN	Signature/Approval)	CABANATUAN BYPASS - CONTRACT PACKAGE IV	51111 5275 84	INTERSECTION A-30 (INITIAL STAGE)	
Co., Elb.	SORMALIED	10/21/01	TEAM LEADER	Project Director	Chief, Mech !- Elect ! Division	OIC, Director M	Undersecretory	Secretary	CADAMATUAN DIT AUG-CONTINUET ACCIDENT	FULL SIZE A1		




NOTE:

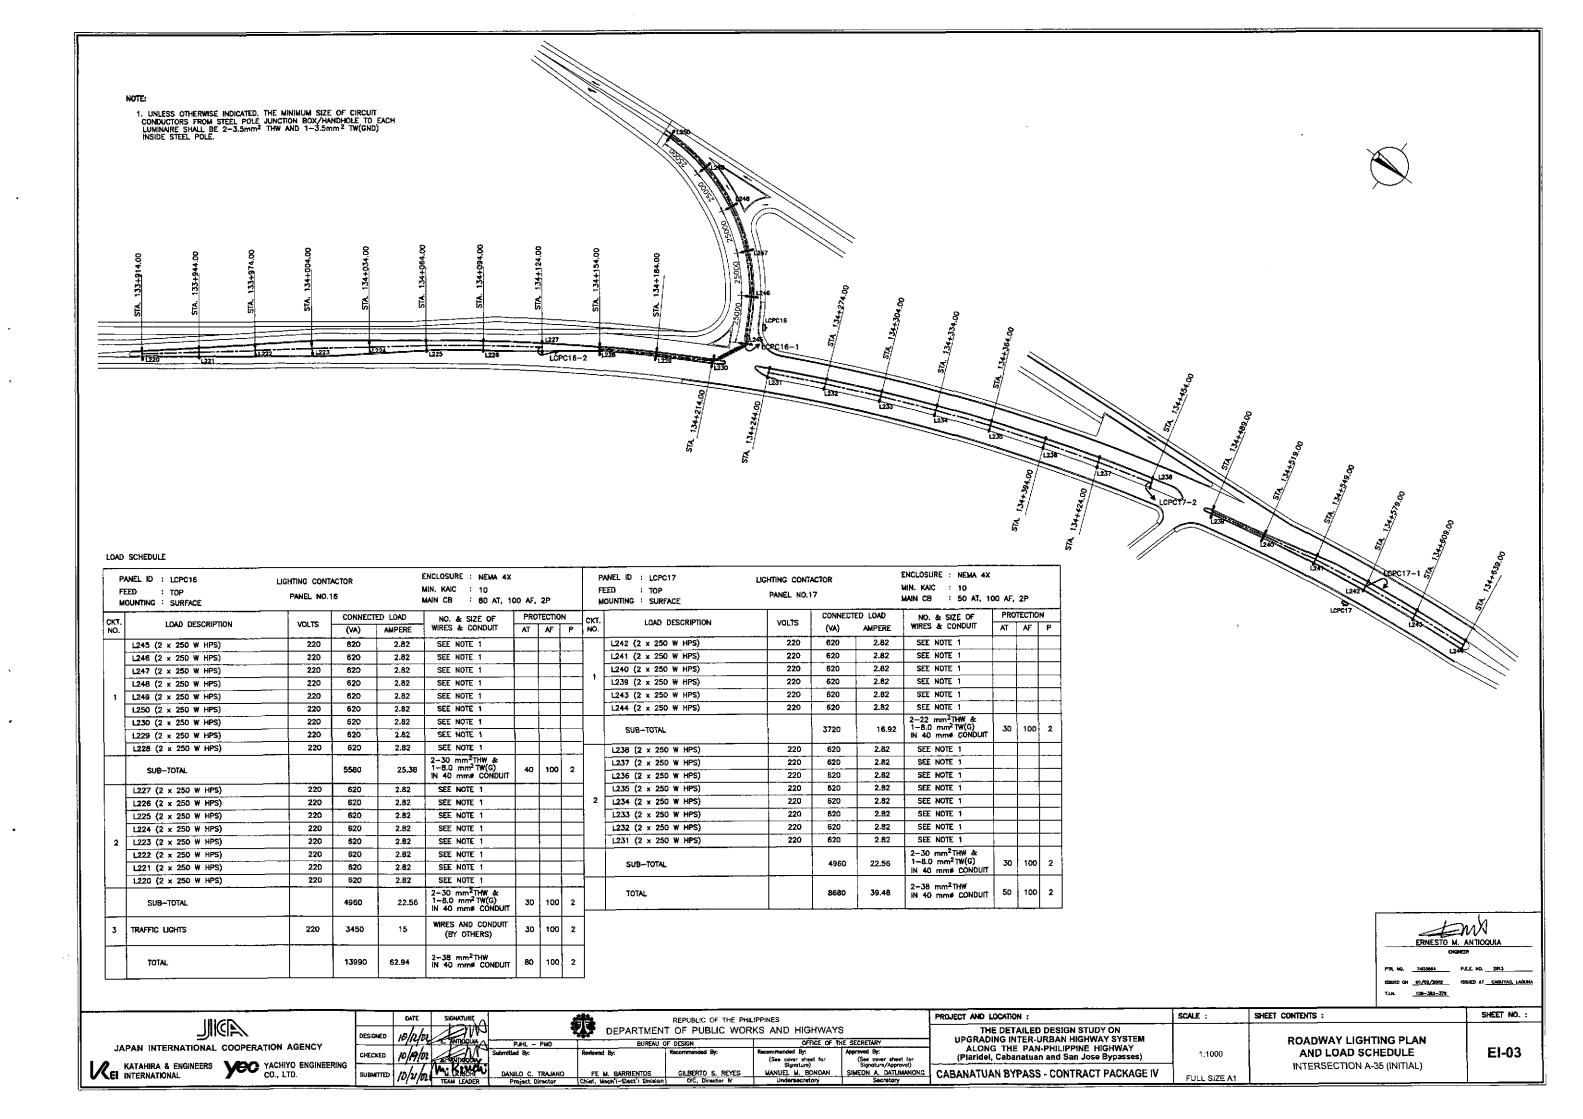1. UNLESS OTHERWISE INDICATED, THE MINIMUM SIZE OF CIRCUIT CONDUCTORS FROM STEEL POLE JUNCTION BOX/HANDHOLE TO EACH LUMINAIRE SHALL BE 2-3.5mm² THW AND 1-3.5mm² TW(GND) INSIDE STEEL POLE.

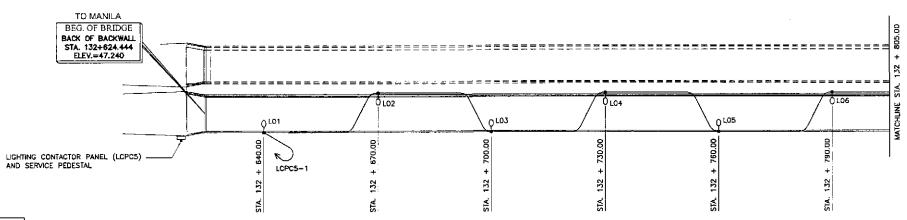

LOAD SCHEDULE

F	ANEL ID : LCPC5 EED : TOP OUNTING : SURFACE	LIGHTING CON PANEL N			ENCLOSURE: N MIN. KAIC : 1 MAIN CB : 3	0		', 2P
скт.	LOAD DESCRIPTION	VOLTS	CONNEC	TED LOAD	NO. & SIZE OF	PRO	TECTIO	N
NO.	EOAD DESCRIPTION	VULIS	(VA)	AMPERE	WIRES & CONDUIT	ΑT	Ą	P
	LO1 (1 x 250 W HPS)	220	310	1.41	SEE NOTE 1			
	LO2 (1 x 250 W HPS)	220	310	1.41	SEE NOTE 1		F -	
	LO3 (1 x 250 W HPS)	220	310	1.41	SEE NOTE 1			
	L04 (1 x 250 W HPS)	220	310	1.41	SEE NOTE 1			
	LO5 (1 x 250 W HPS)	220	310	1.41	SEE NOTE 1			
1	L06 (1 x 250 W HPS)	220	310	1.41	SEE NOTE 1			
	L07 (1 x 250 W HPS)	220	310	1.41	SEE NOTE 1			
	L08 (1 x 250 W HPS)	220	310	1.41	SEE NOTE 1			
	L09 (1 x 250 W HPS)	220	310	1.41	SEE NOTE 1			
	L10 (1 x 250 W HPS)	220	310	1.41	SEE NOTE 1			
	L11 (1 x 250 W HPS)	220	310	1.41	SEE NOTE 1		Í	
	L12 (1 x 250 W HPS)	220	310	1.41	SEE NOTE 1		i	
	SUB-TOTAL		3720	16.92	2-30 mm ² THW & 1-8.0 mm ² TW(G) IN 40 mmø CONDUIT			
	TOTAL		3720	16.92	2-30 mm² THW & IN 40 mmø CONDUIT	30	100	2

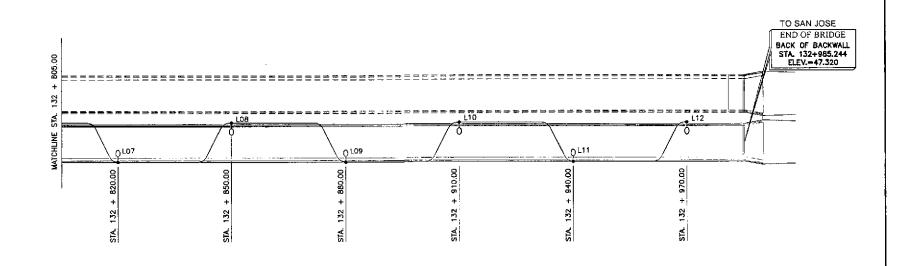

1 ROADWAY LIGHTING PLAN SCALE 1:500

SCALE :

1.500

EWX.							
ERNESTO M	. ANTIOQUIA						
ENG	INEER						
PTR. NO. 7403664	P.E.E. NO						
ISSUED ON <u>01/02/2002</u>	SSUED AT CABUYAG, LAGANA						
T.I.M. 109-382-378							

SHEET NO. :

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l	JAPAN INTERNATIONAL COOPERATION AGENCY
ļ	KATAHIRA & ENGINEERS YEC YACHIYO ENGINE.

COOPERATION AGENCY					
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;	CHECKED	10/19/02	E ANTIOSUUM
	SUBMITTED	10/21/02	TEAM LEADER

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ıbz	W		541	T OF PUBLIC WOR		
170	TO THE TAX A	PJHL — PMD		DF DESIGN	OFFICE OF TH	IE SE
1/02		Submitted By:	Reviewed By:	Recommended By:	Recommended By: (See cover sheet for	Appn
7	As. L'as Al				Signature)	ı

THE DETAILED DESIGN STUDY ON UPGRADING INTER-URBAN HIGHWAY SYSTEM ALONG THE PAN-PHILIPPINE HIGHWAY (Plaridel, Cabanatuan and San Jose Bypasses)
CABANATUAN BYPASS - CONTRACT PACKAGE IV

PROJECT AND LOCATION :

SHEET CONTENTS :
TALAVERA RIVER BRIDGE CROSSING
ROADWAY LIGHTING PLAN
AND LOAD SCHEDULE
INITIAL STAGE