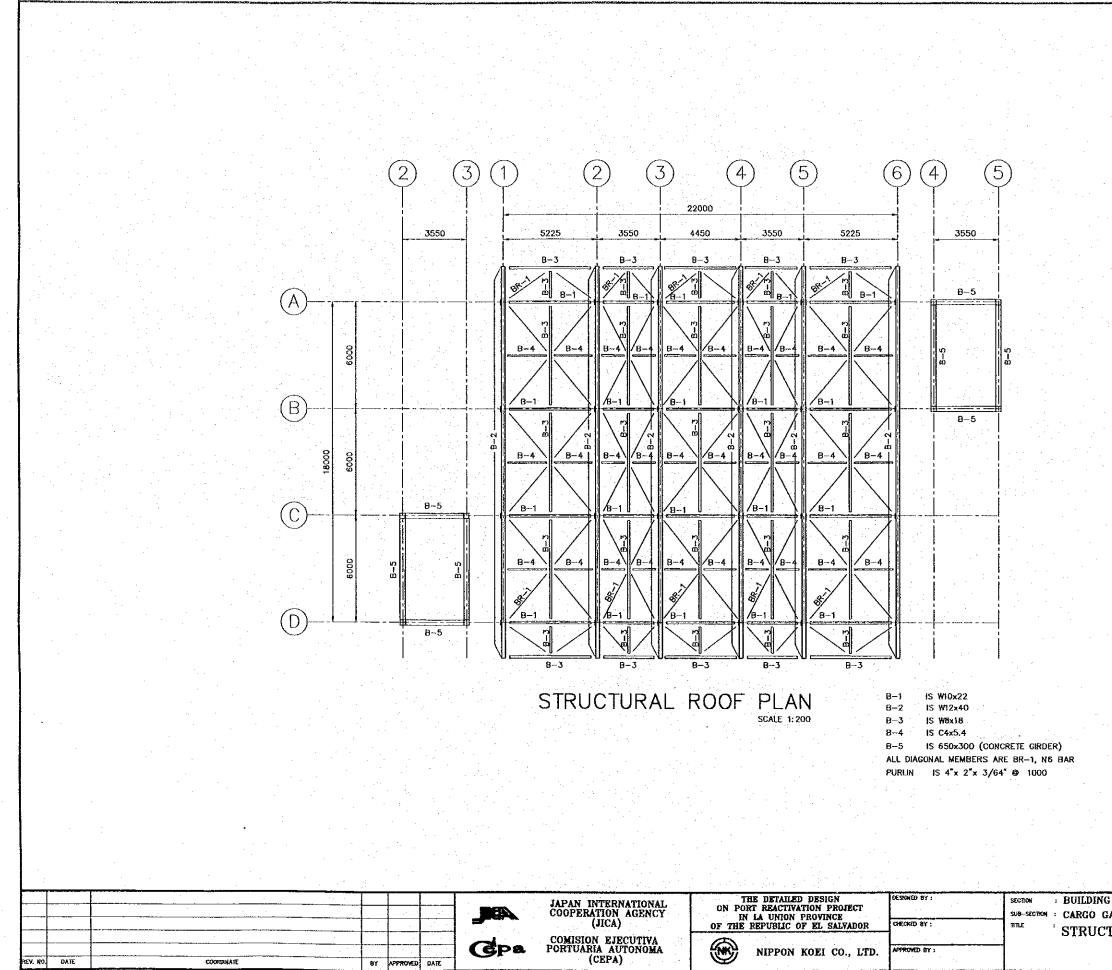
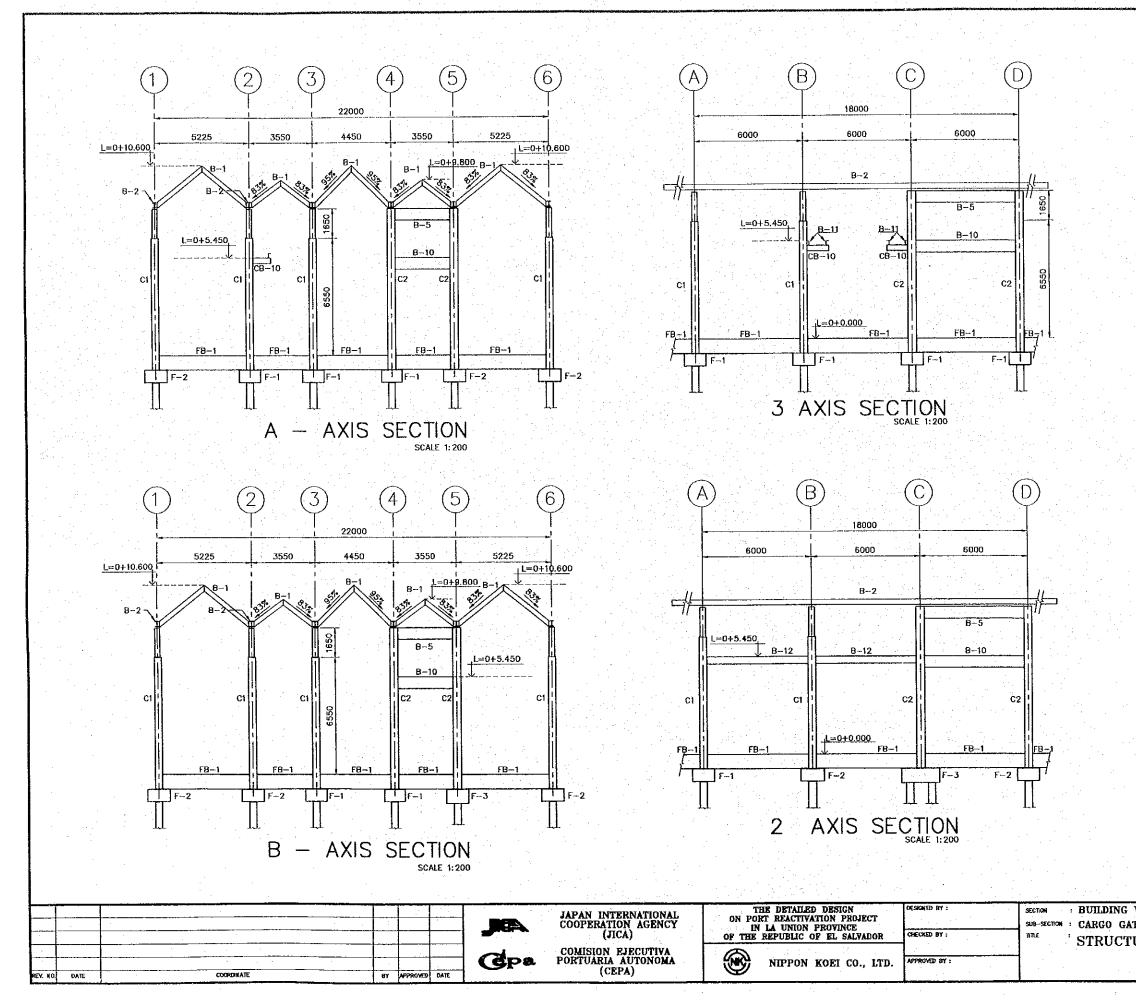


SEE DRAMMC: 10-00-007		
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JEE DRAMNG:	ig−α0−007	
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	and the second	

							<u> </u>
		2 3	4 5 22000 4450 3550	5225 SECAST PRESTRESS DECK. AB (WITH CAST IN PLACE DNCRETE TOPPING)			
			B−11 B−11 CB−10 CB−10 CB−11 CB−11 CB−10 CB−	B-11 CB-10 B- B- B- B- B- B- B- CB- CB-	10 IS 650 X 300 11 C-10 X 25 12 IS 400 X 300 13 W8 X 31		
	D PRECAST PREST SLAB (MTH CAS CONCRETE TOPP STF	RESS DECK IN PLACE NG) RUCTURAL SE(COND FLOOR P	LAN			
		2 3	(4) (5) ••	6			
	B (C)	C37 B=13 C3					
		 STAIR LANDI	NG LEVEL				
REV. NO. DATE COORDINATE	BY APPROVED DATE	JAPAN INTERNATIONAL COOPERATION AGENCY (JICA) COMISION EJECUTIVA PORTUARIA AUTONOMA (CEPA)	THE DETAILED DESIGN ON PORT REACTIVATION PRO IN LA UNION PROVINCE OF THE REPUBLIC OF EL SAL		SECTION : BUILDING WORK SUB-SECTION : CARGO GATE MRE STRUCTURAJ FLOOR PLAN LANDING PL	& STAIR	OCTOBER/2002



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WORK	DATE : OCTOBER/2002
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FURAL ROOF PLAN	SCALE : 1:200
	DRAWING NO:
	BD-05-015
	·····



F: FOOTING

F-1	IS 1210 x 1210 x 700
- <u>-</u>	(1 PRECAST PRESTRESS PILE)
F-2	IS 1260 x 1260 x 700
	(1 PRECAST PRESTRESS PILE)
F3	IS 2100 x 1260 x 800
1	(2 PRECAST PRESTRESS PILE)

C: COLUMN IS 400x400/300x300 C2 IS 450x450

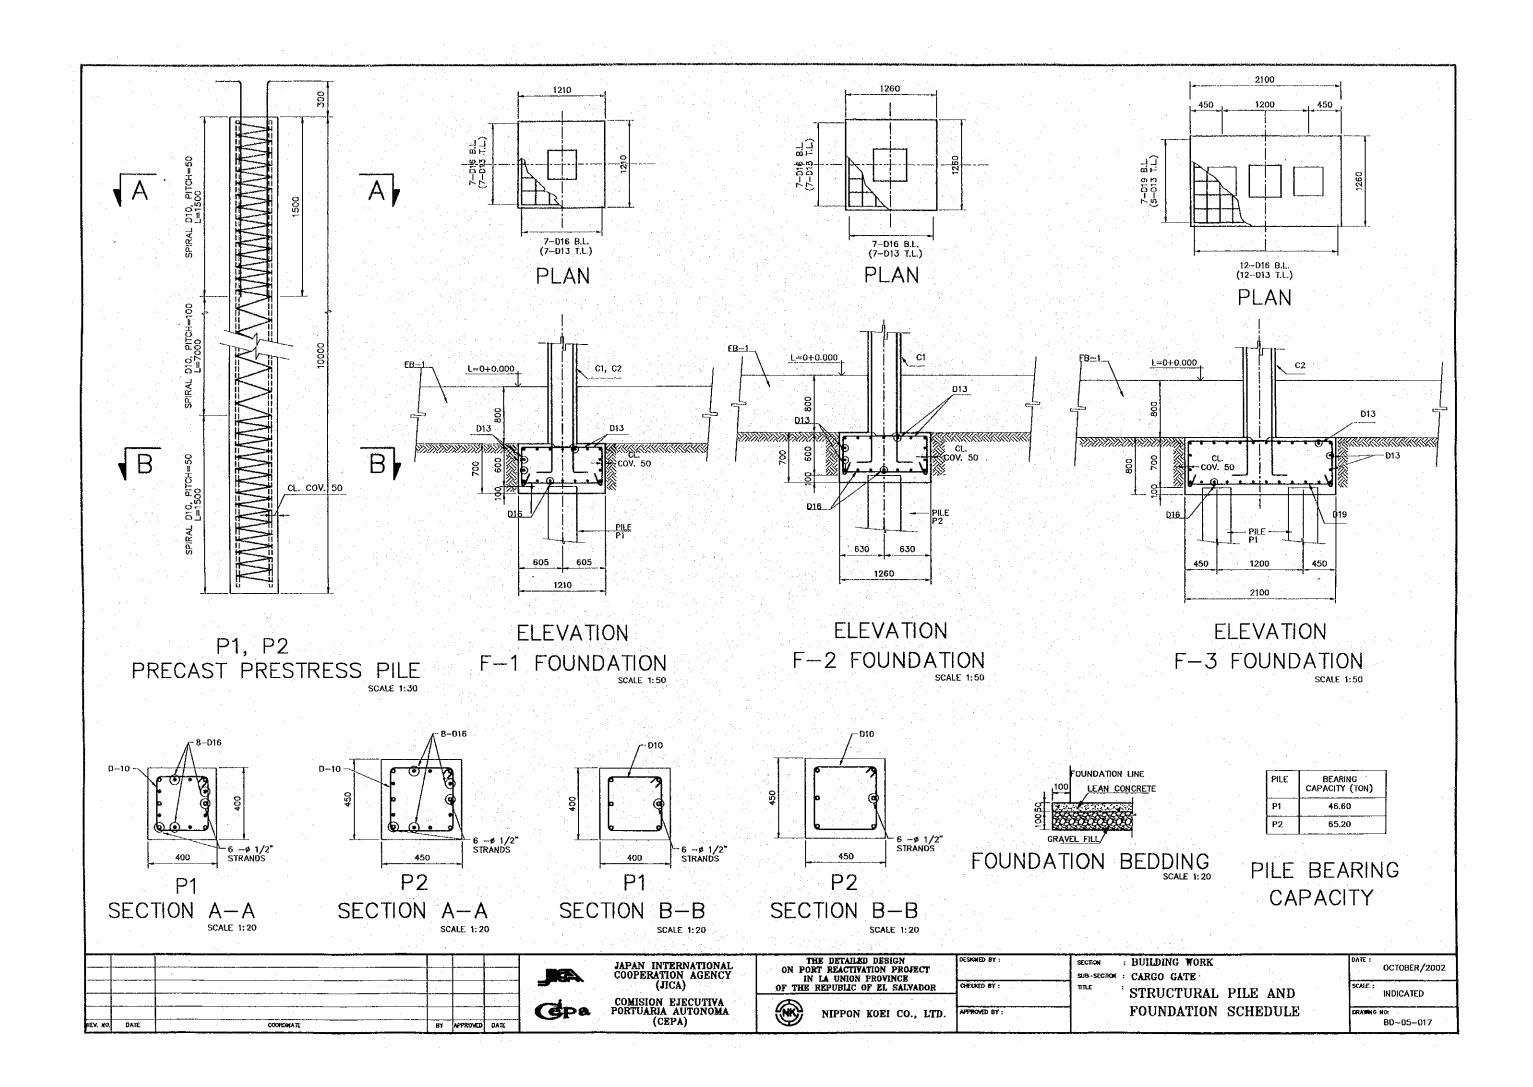
FD: FOUNDATION BEAM IS 800 x 400 F0--1

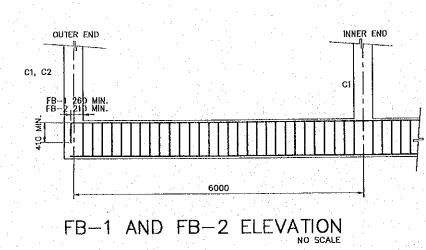
CB: CANTILEVER BEAM CB-10 IS 300 x 300

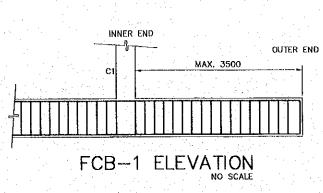
B: BEAM

	,
B~1 ·	IS W10x22
8-2	IS W12x40
85	IS 650 x 300
	(CONCRETE GIRDER)
8-10	IS 650 x 300
	(CONCRETE GIRDER)
8-11	IS C 10 x 25
8-12	IS 400x300

and the second	
	the second second
WORK TE	DATE : OCTOBER/2002
URAL SECTION	scale : 1:200
	DRAWING NO.
	80-05-016







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LEAN CONCRETE		
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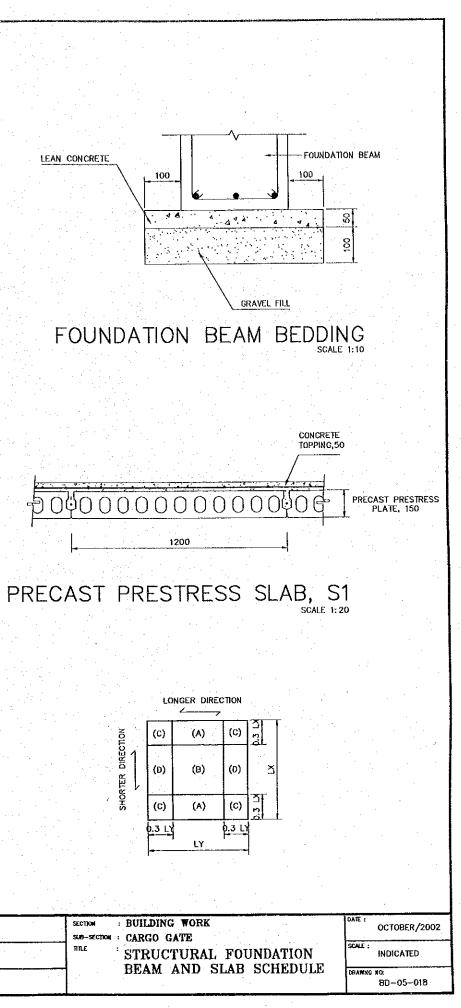
MARK	and the second	FB-1, FCB-1	
PORTION	OUTER END	CENTER	INNER END
SECTION			
BxD		400 X 800	
TOP BAR	3-025	4D25	4-025
BOTTOM BAR	3~D25	4D25	4-D25
STIRRUP	1	D13@200	
WEB BAR		2-D10	
TIE	· · · · ·	D10 @ 1000	· · · · · · · · · · · · · · · · · · ·

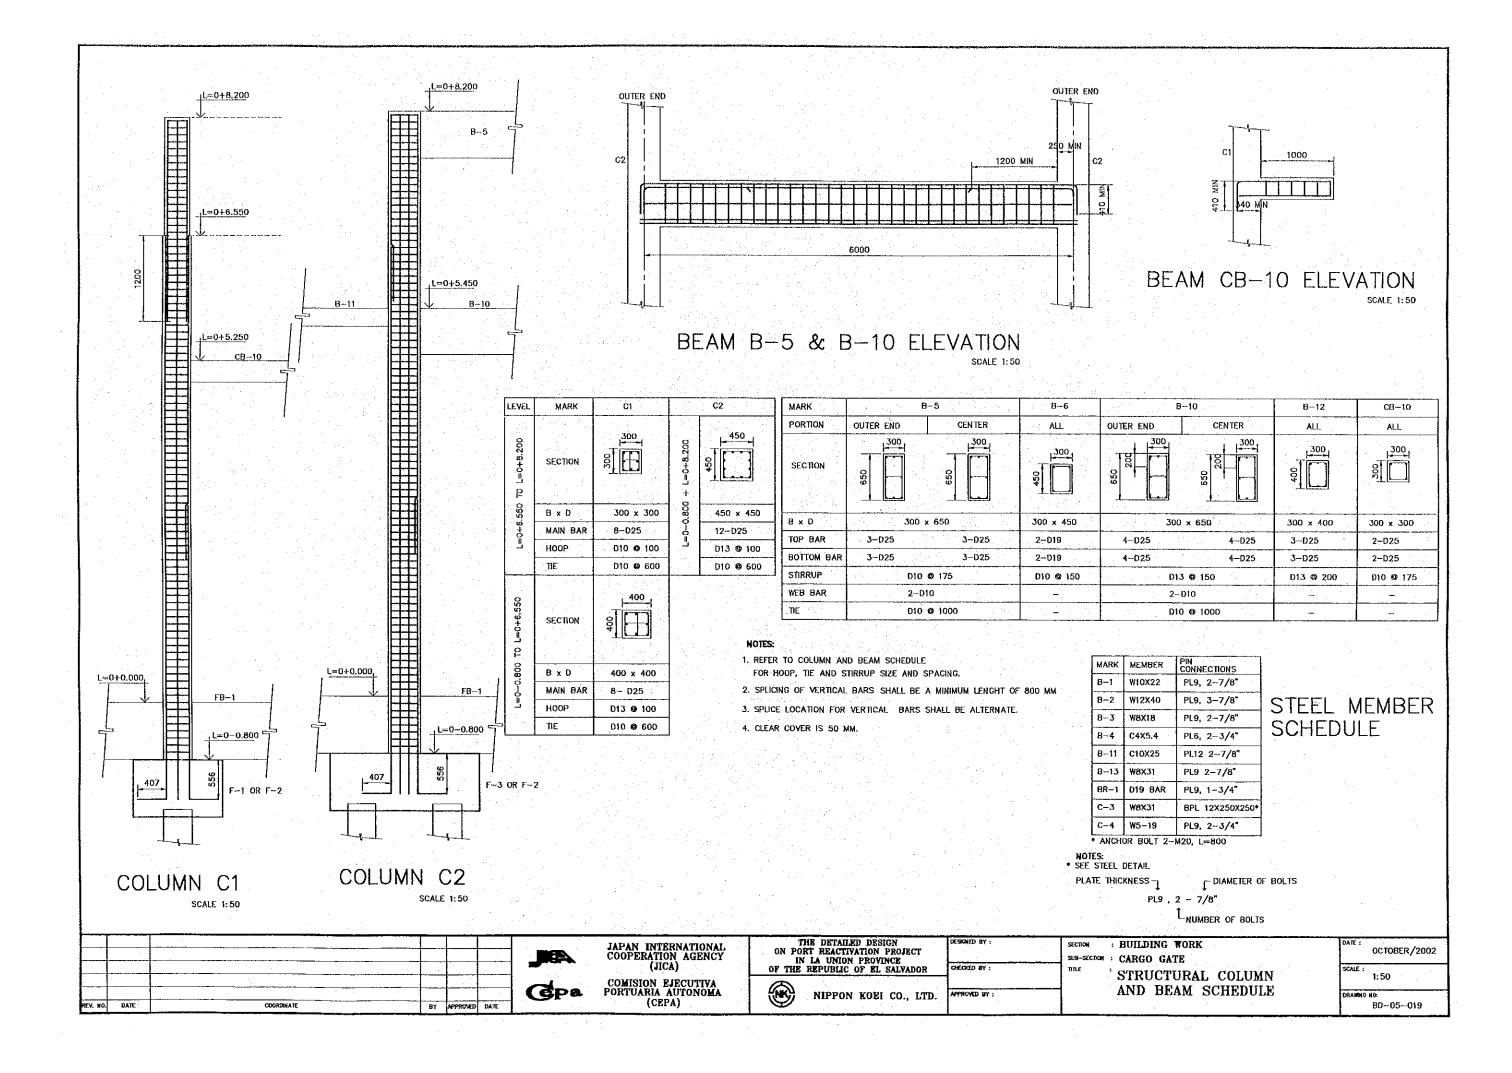
MARK	and the second second	FB-2	n i gana a
PORTION	OUTER END	CENTER	INNER END
SECTION			
BxD		300 X 650	
TOP BAR	3-025	3D25	3-D25
BOITOM BAR	3-D25	3D25	3-D25
STIRRUP		D10 @ 200	
WEB BAR		2D10	
TIE		D10 @ 1000	and the second second

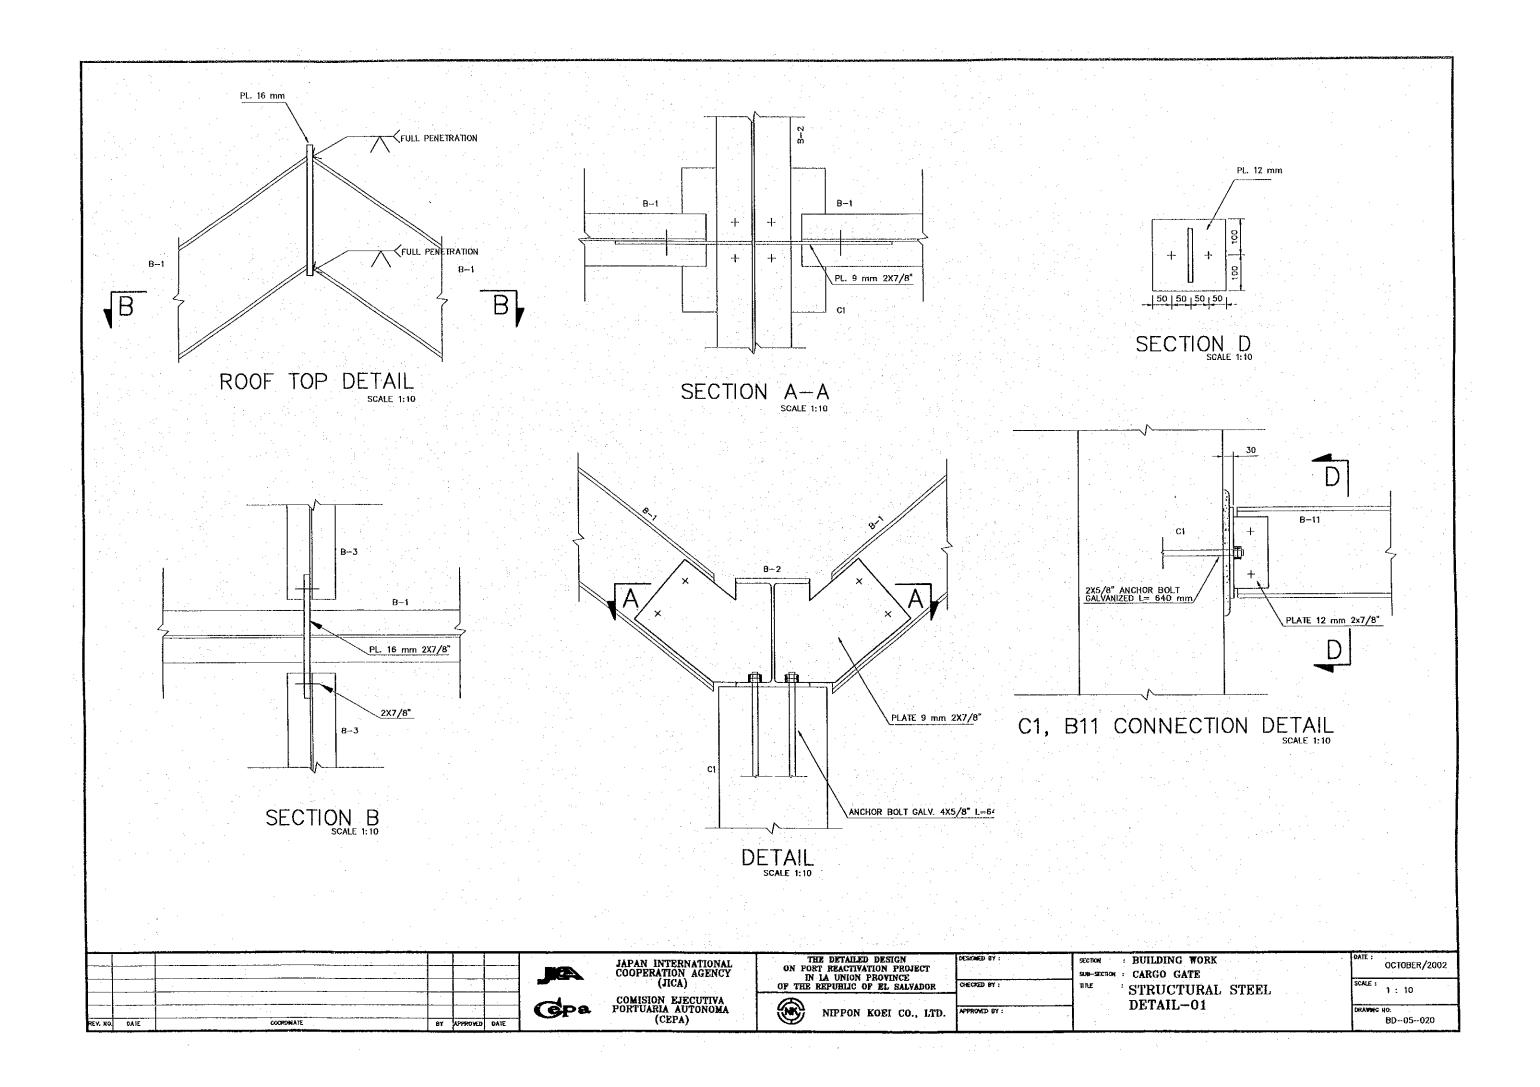
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CTION	1.	(C)
SHORTER DIREC	1	(D)
SHO	-	(C)
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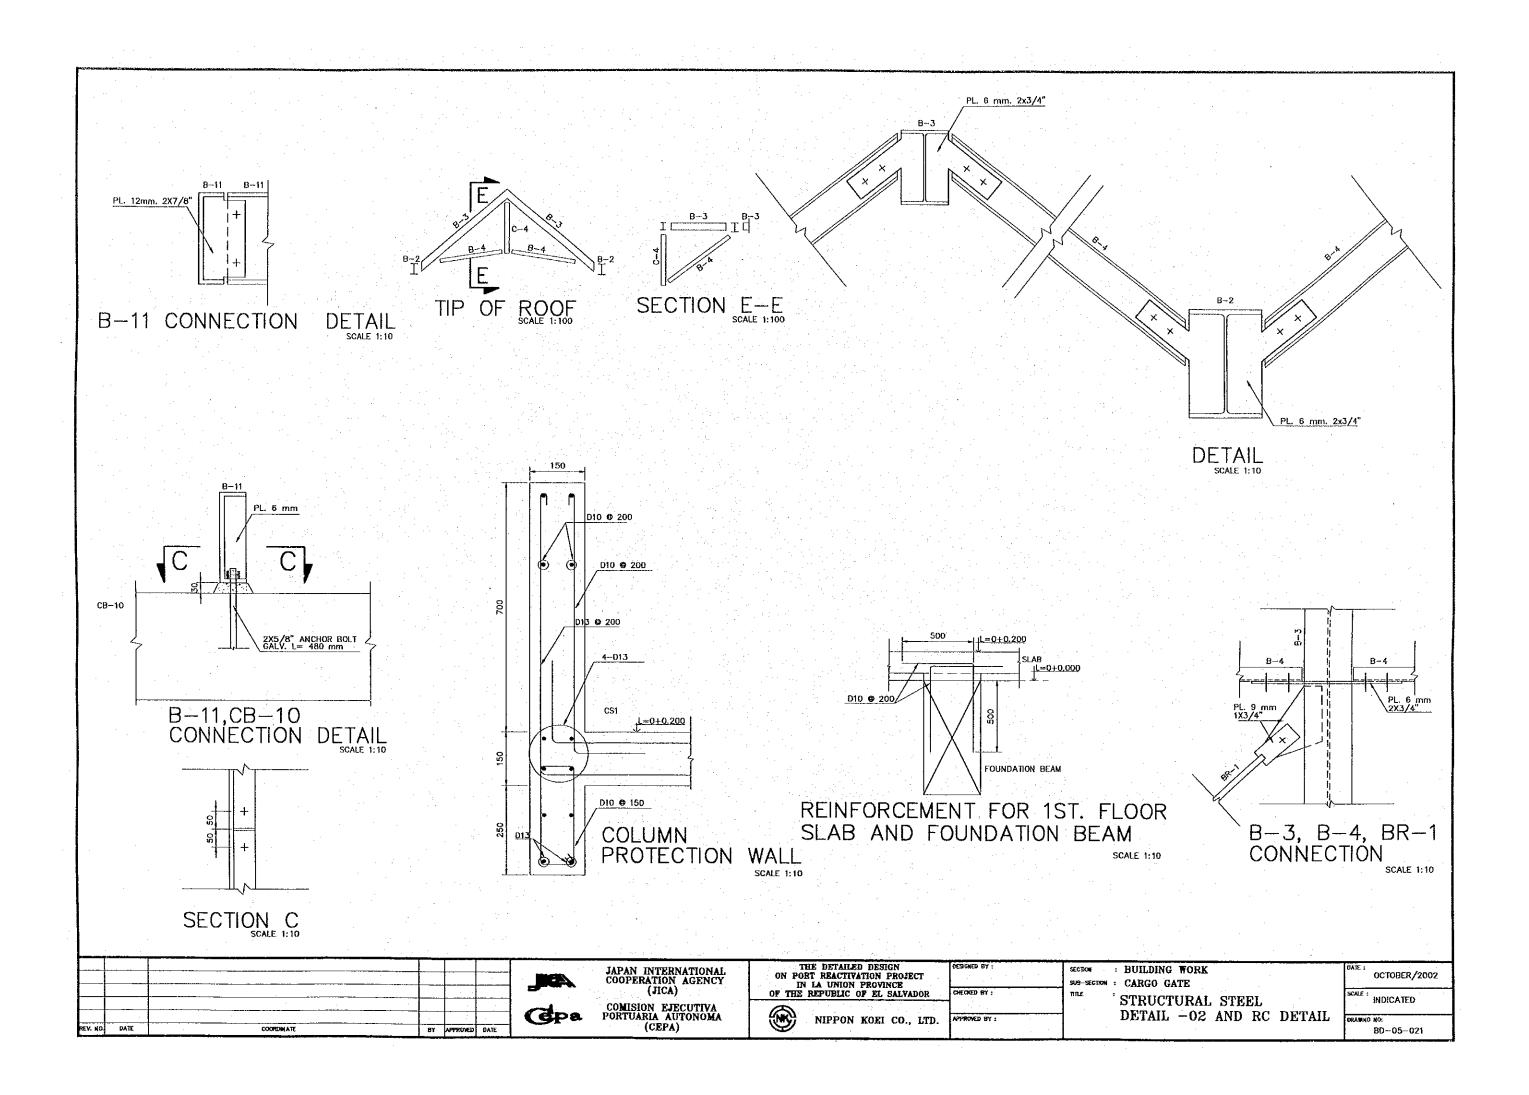
			e terpi	SHORTER SIDE	(DIRECTION)			LONGER SIDE	(DIRECTION)	
MARK	THICKNESS (MM)	LOCATION	EDCE	STRIP	MIDDL	e strip	EDGE	STRIP	MIDDL	e strip
			END (C)	CENTER (D)	END (A)	CENTER (B)	END (C)	CENTER (A)	END (D)	CENTER (E
~		TOP	D10 0 200	D10 0 200	D10 0 200	 - 	D10 0 250	D10 0 250	D10 0 250	
SI	120	BOTTOM	D10 9 200	D10 © 200	D10 0 200	D10 0 200	D10 0 250	D100250	D100250	D10 0 250
S2	COD	TOP	013 9 200	D13 9 200	D13 0 200	D13 0 200	D130200	D13@200	D13 9 200	D13 0 20
32	500	воттом	D13 9 200	D13 0 200	D13 9 200	D13 0 200	013 0 200	D13©200	D13 9 200	013 0 20
53	150	TOP	D10 6 200	D100200	D10 0 200		D100250	D109250	D10@250	
	150	BOTTOM	D10 0 200	D10 0 200	D10 0 200	D100200	D100250	D10 0 250	D100250	D10 9 250
CS1	150	TOP	D13 9 200	D13 9 200	D13 0 200	D13 9 200	D10 0 250	D10@250	D100250	
	150	BOTTOM	D10 9 200	D10 0 200	D10 0 200	D10 9 200	D10 9 250	0109250	D10 9 250	D10 9 250
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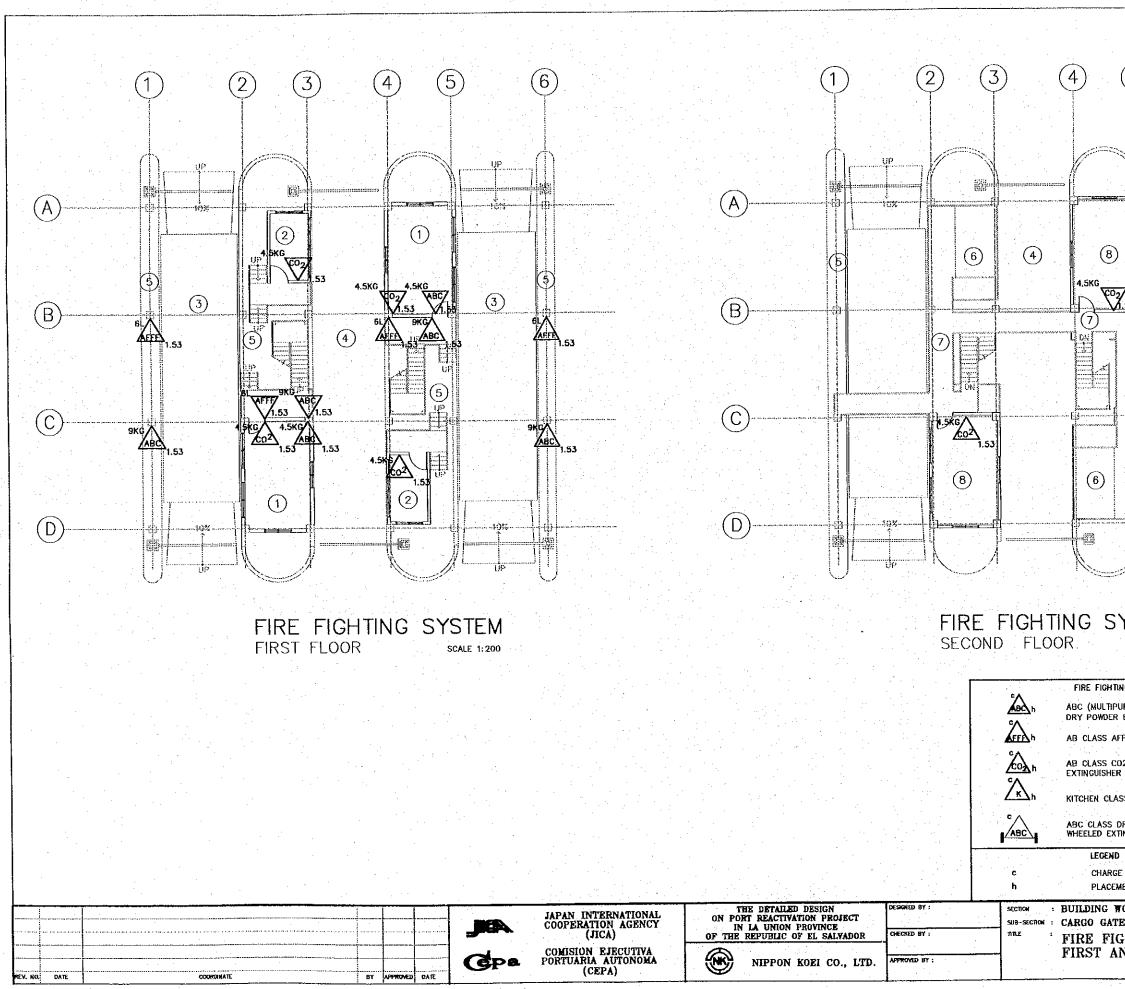




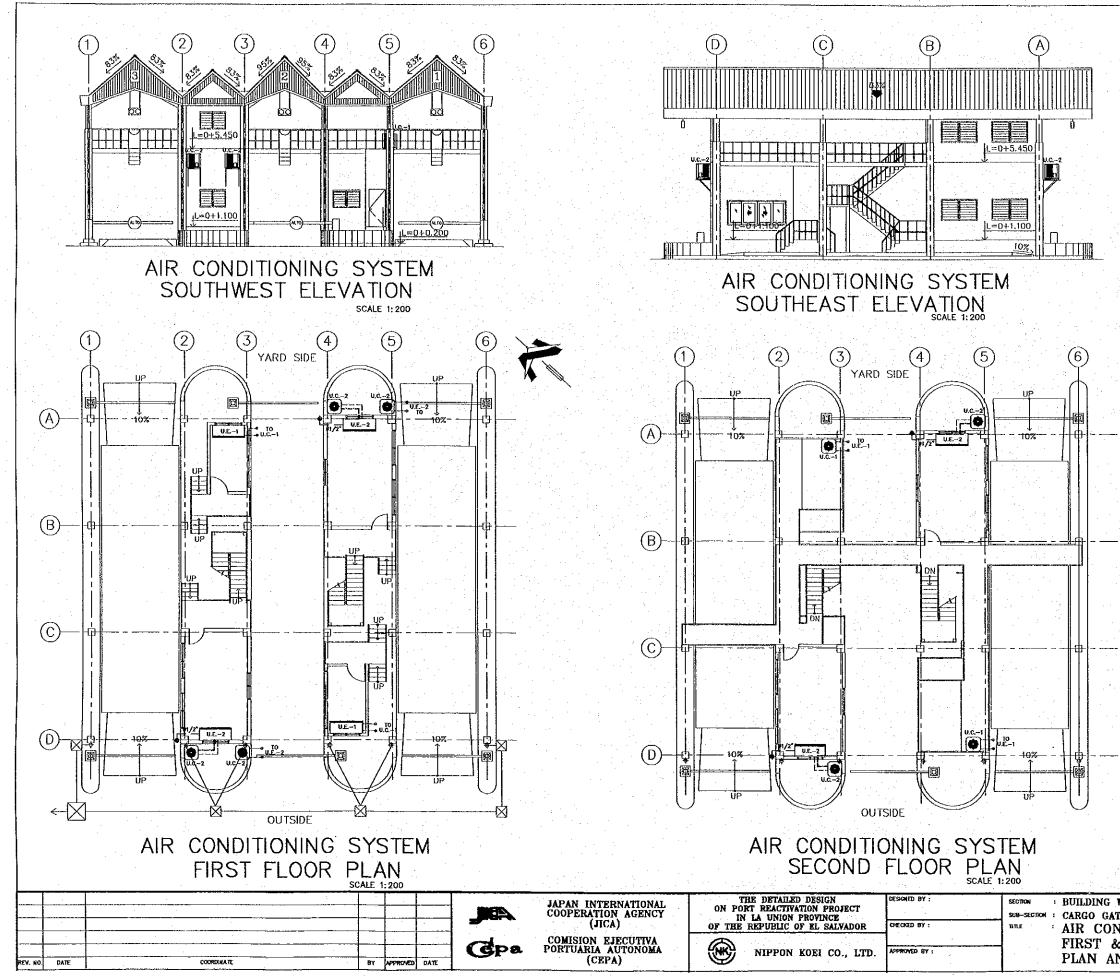








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		A.
SYSTEM	1.1	
SCALE 1:200		
ITING SYMBOLS		
PURPOSE)	(RO	OM LIST)
ER EXTINGUISHER	() WEIG	SH BRIDGE OFFICE
AFFF EXTINGUISHER	and the second second	en ang tao ang tao ang
CO2 IER	2 STO	RAGE
	3 WEIG	GH BRIDGE
LASS EXTINGUISHER	(4) GAT	e office
S DRY CHEMICAL XTINGUISER	_	REMENT
ND	(5) PAV	
ND RGE	6 SIDI	E WALK (island)
EMENT HEIGHT		
WORK		DATE : OCTOBER/2002
TE	• • • •	scale : 1 : 200
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		DRAIN PIPES	
	U.E1	EVAPORATOR	UNIT
· -	U.C1	CONDENSATO	R UNIT
		CONDENSATO	RUNIT
	C C C	CEILING EXTR	ACTOR FOR BATHROOMS
	E-4 📫	WALL MOUNTE	D EXTRACTOR
	!	GRILLE	
WORK			DATE :
TE			OCTOBER/2002
IDITI	ONING S COND FL		scale : 1 : 200
	LEVATIO		DRAWNS NO: BD-05-023

COLD WATER PIPES

---- SUCTION PIPES (PIPELINE)

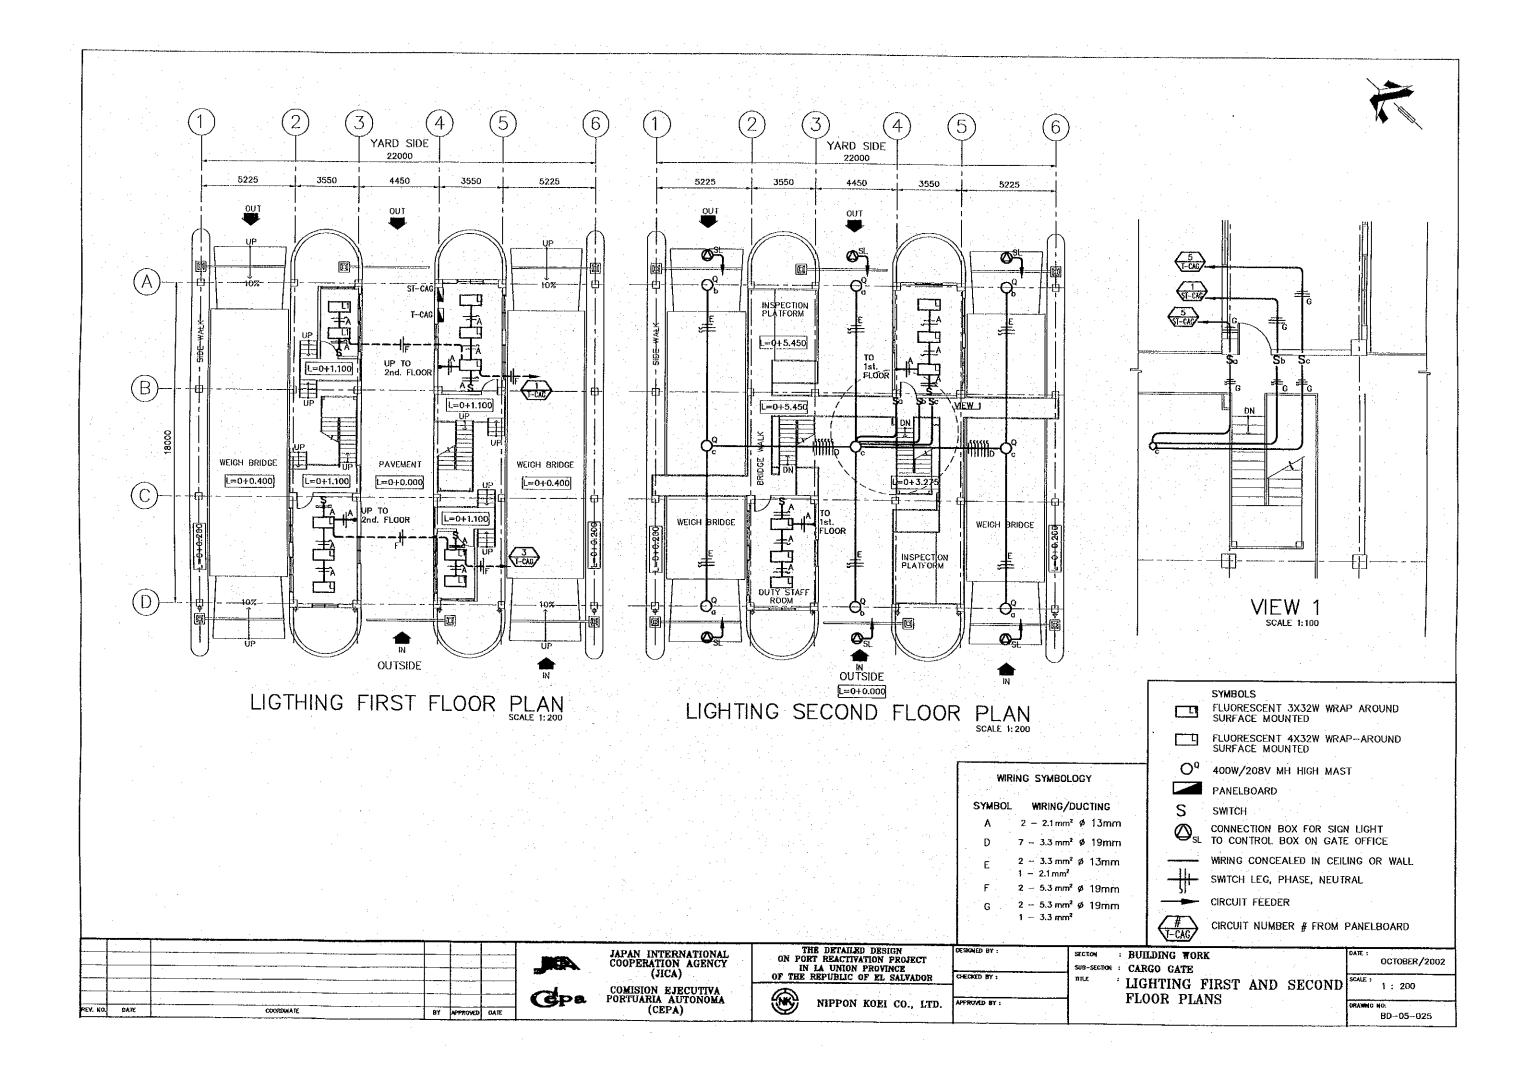
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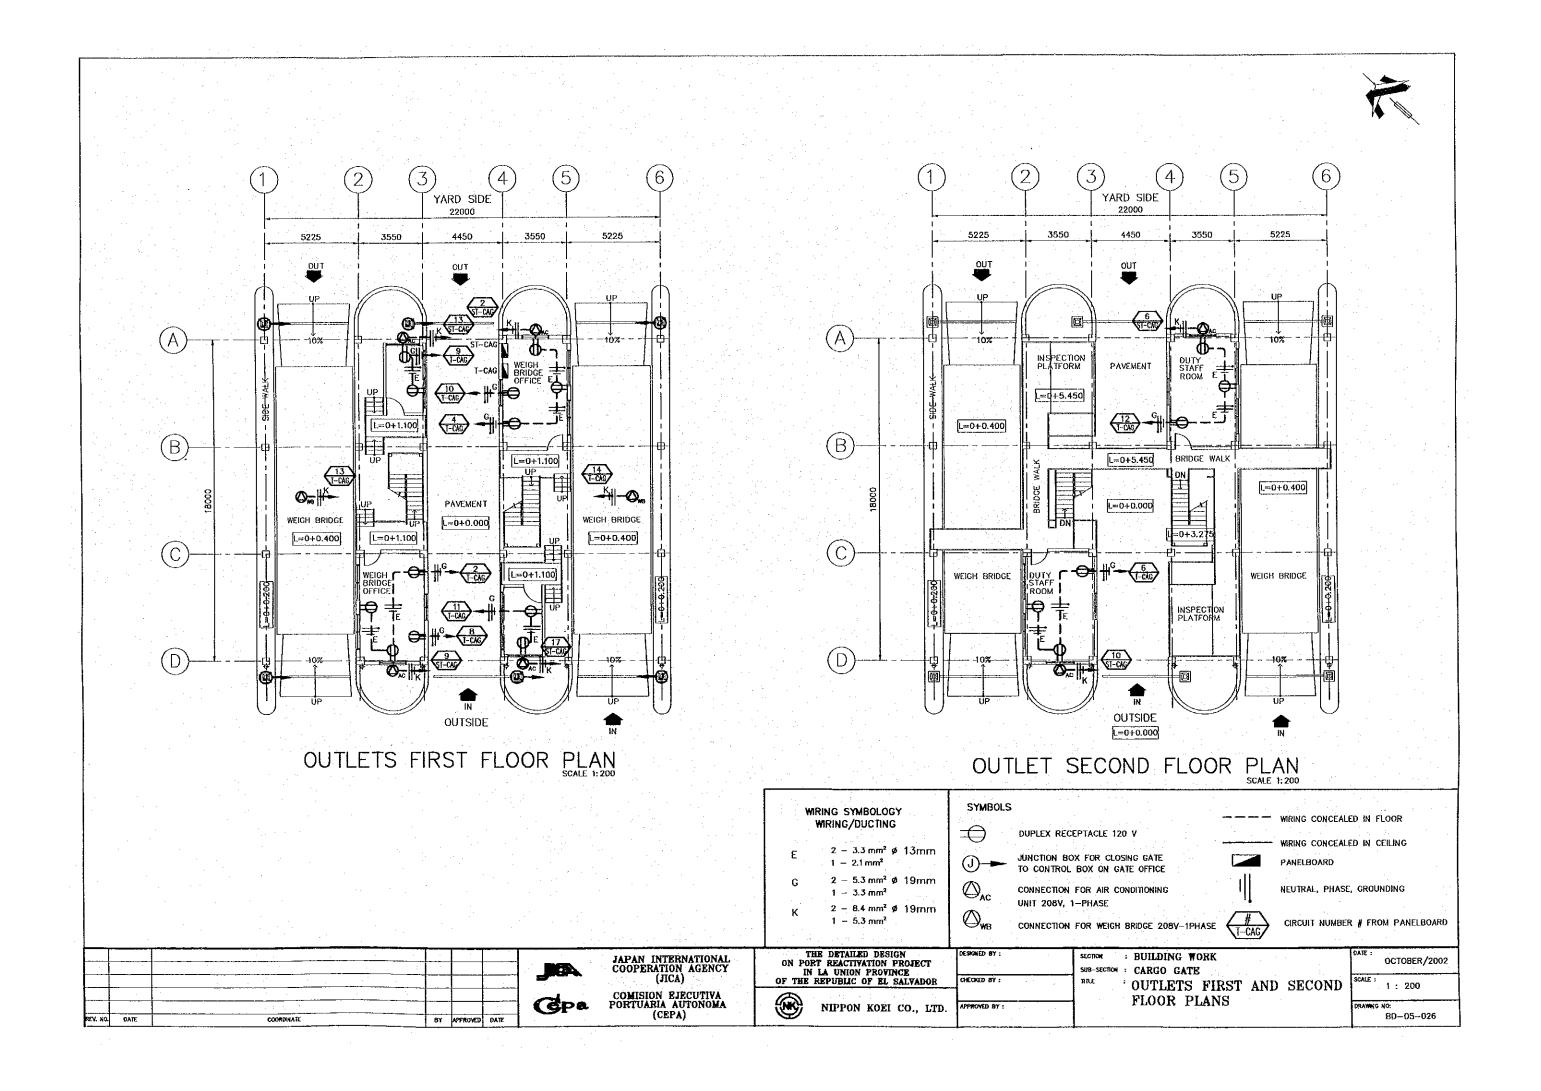
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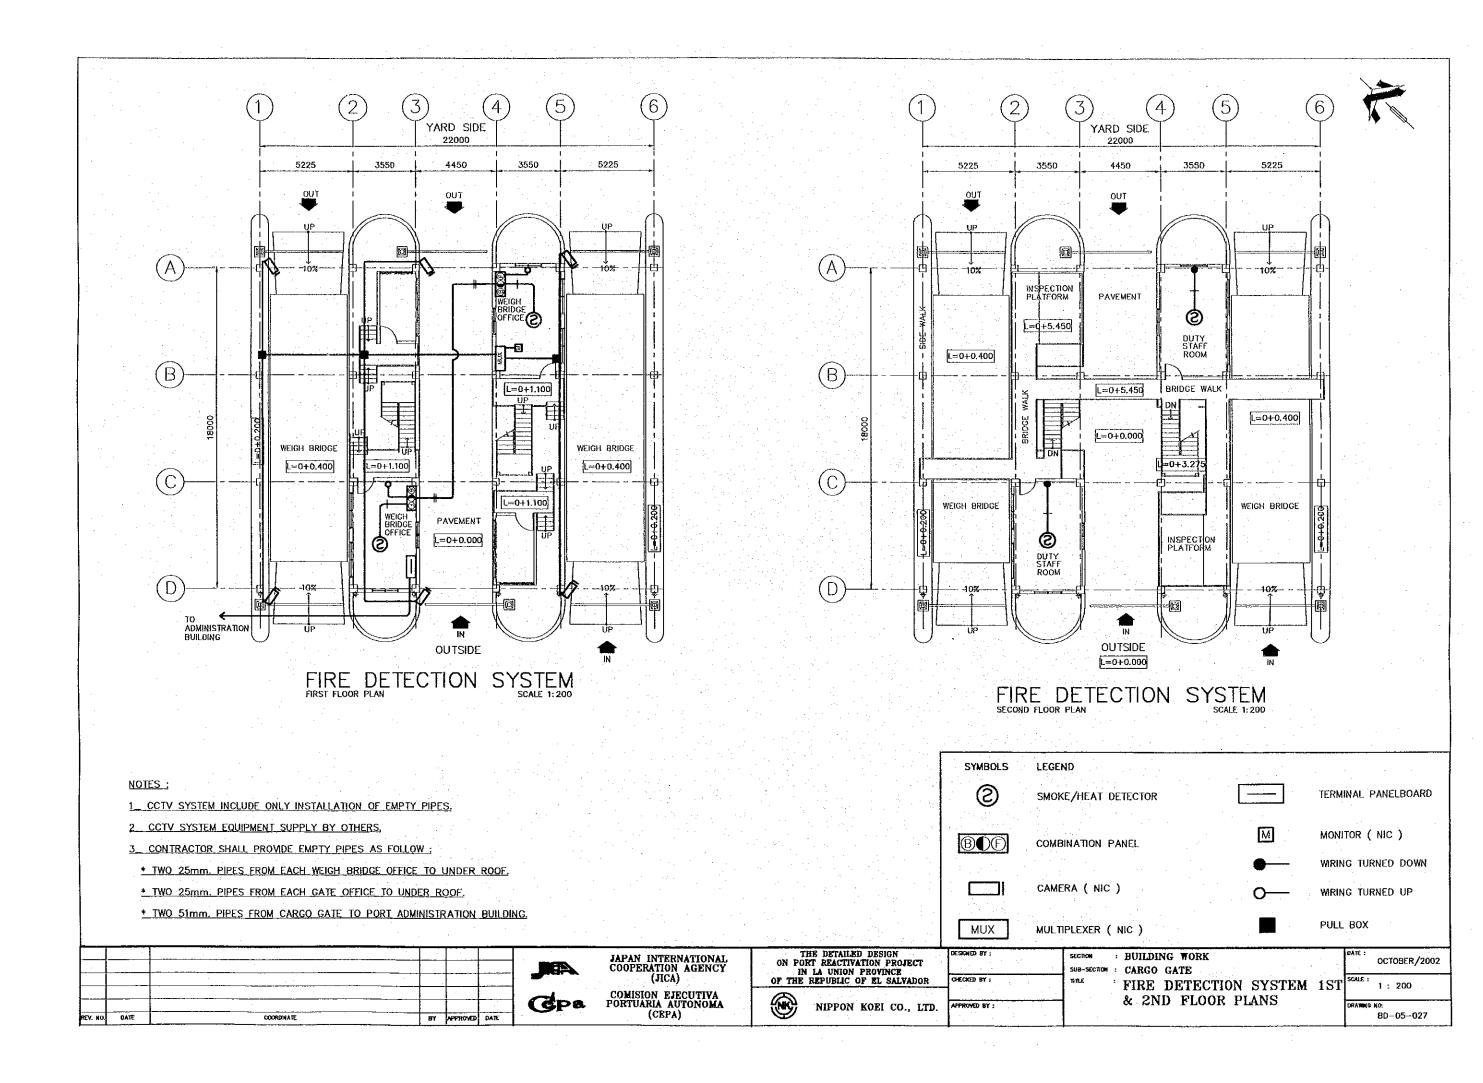
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T o.		· · · · ·	ERE BØC	DESCRIPTION		AIC 8	F	РНА В		Pole	AIC	DESCRIPTION	.	MPER B		WIRING	CT No
1	2x5.3mm ²	7.80	- 1.	Lighting offices	+	15			-			Outlets WB office	5.00			3x5.3mm²	2
	2x5.3mm ²			Lighting offices	2	15			-	+-		Outlets WB office		5.00		3x5.3mm²	4
5	3x5.3mm*)Flood lightings	2	15	-		-	2		Outlets DS room				3x5.3mm ²	6
7		6.60					+		-			Scale printer	2.00			3x5.3mm²	8
9	3x5.3mm ²	3.	3.0	Outlets gate offic		15		-	-	. 2	15	Scale printer		2.00	:	3x5.3mm²	10
11	3x5.3mm ²		3.30	Outlets gate offic	e 2	15						Outlets DS room			5.00	3x5.3mm ²	12
13	3x5.3mm²	0.50		Weight bridge	2	15	-+			2	15	Weight bridge	0.50		·	3x5.3mm ²	14
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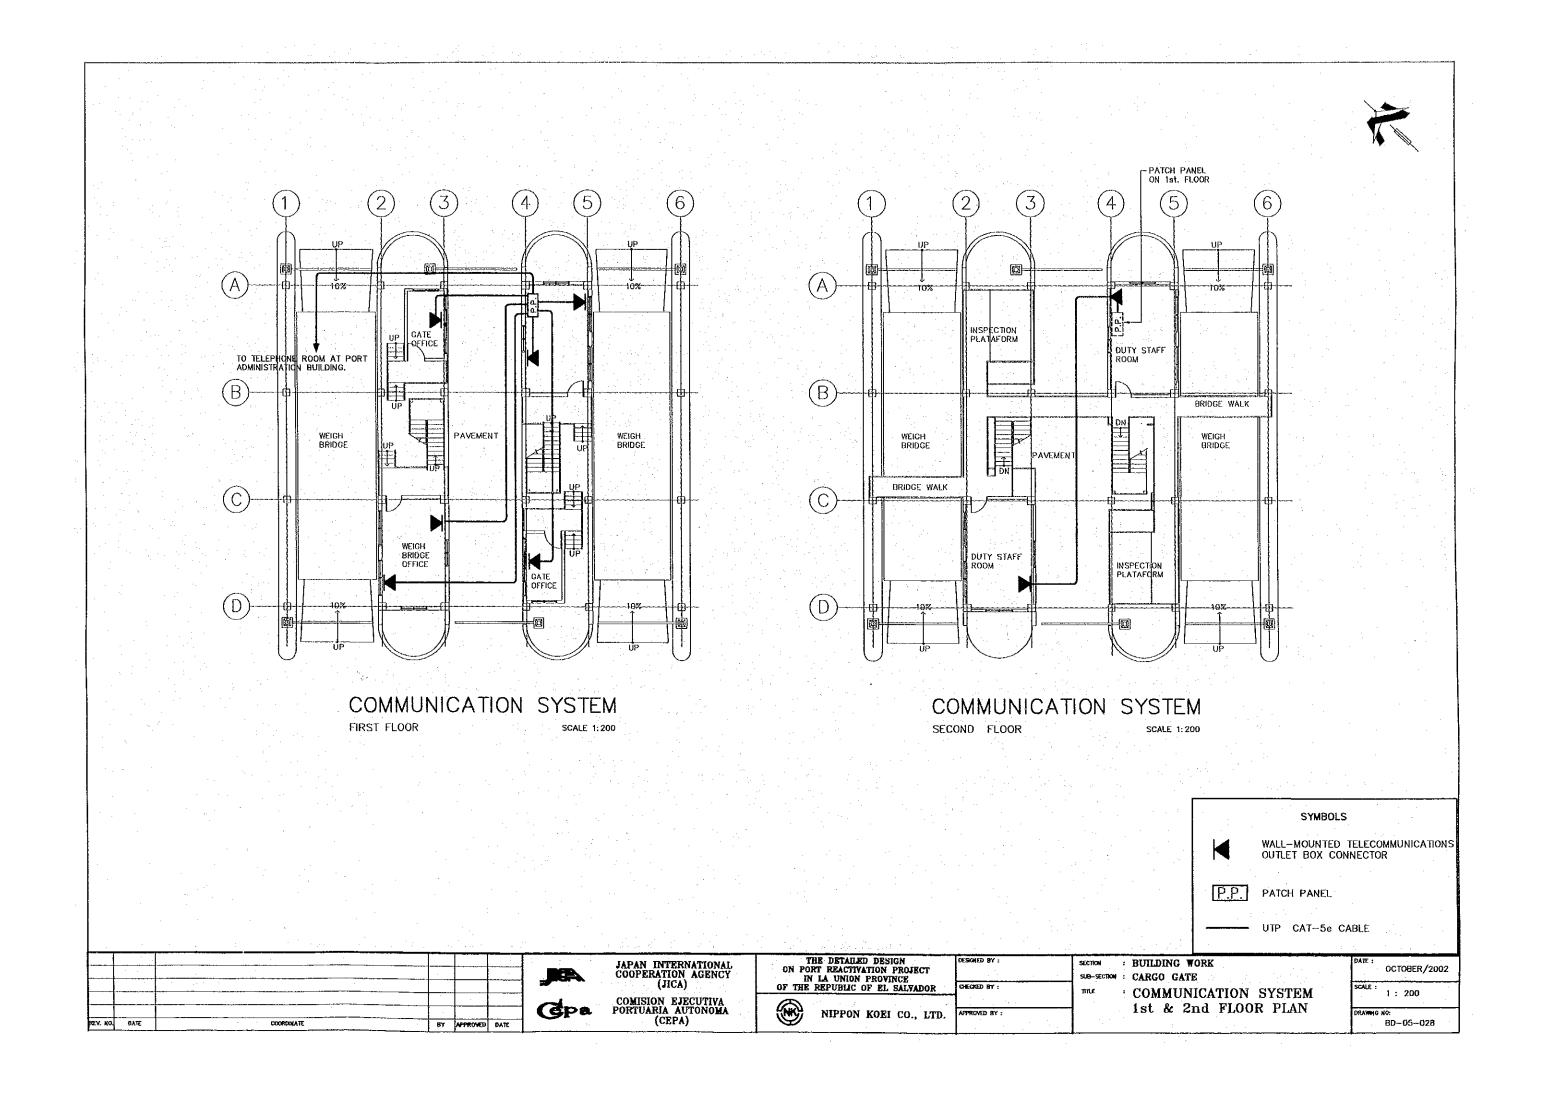
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TION	AMPERE	WIRING	CT No.	CT No.	WIRING	AMPERE	Df	ESCRIPTION	Pole AIC BO	PHASE	• [@]/)	DESCF	IPTION	AMPERE	WIRING	CT No.
office office	5.00	3x5.3mm ² 3x5.3mm ²	2 4	1 21 3	(5.3mm²	6.60 6.60	Flood	lights	2 15		- 2 15	A/C WB (office	16.8 16.8	3x8.4mm ²	2
	2.00	3x5.3mm ² 3x5.3mm ²	6		(5.3mm*		.60 Flood	lights	2 15		- 2 15	A/C DS r	oom		8 3x8.4mm²	<u>6</u> 8
oom	5.00	3x5.3mm ² 3x5.3mm ²	10 12		(8.4mm²	16.8	A/C \ 6.8	WB office	2 15 2 15		- 2 15	A/C DS r	oom	16.8	3x8.4mm ²	10
8	0.50	3x5.3mm²	14		(8.4mm²	12.8		gate office	2 15				······································			14
			18	15 17 3	(8.4mm²		2.6 A/C	gate office	2 15							18
			22	19 21		12.6										20
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Þa	COMISION PORTUARIA							APPROVED BY :			FAN	ELBOARD	SCHED	ULL	NC DRAWNE NO:	DT TO SC
		PA)	•	Ś	NIPPON	KOEI CO.	, LTD. (*		1. A.	· ·						-05-024

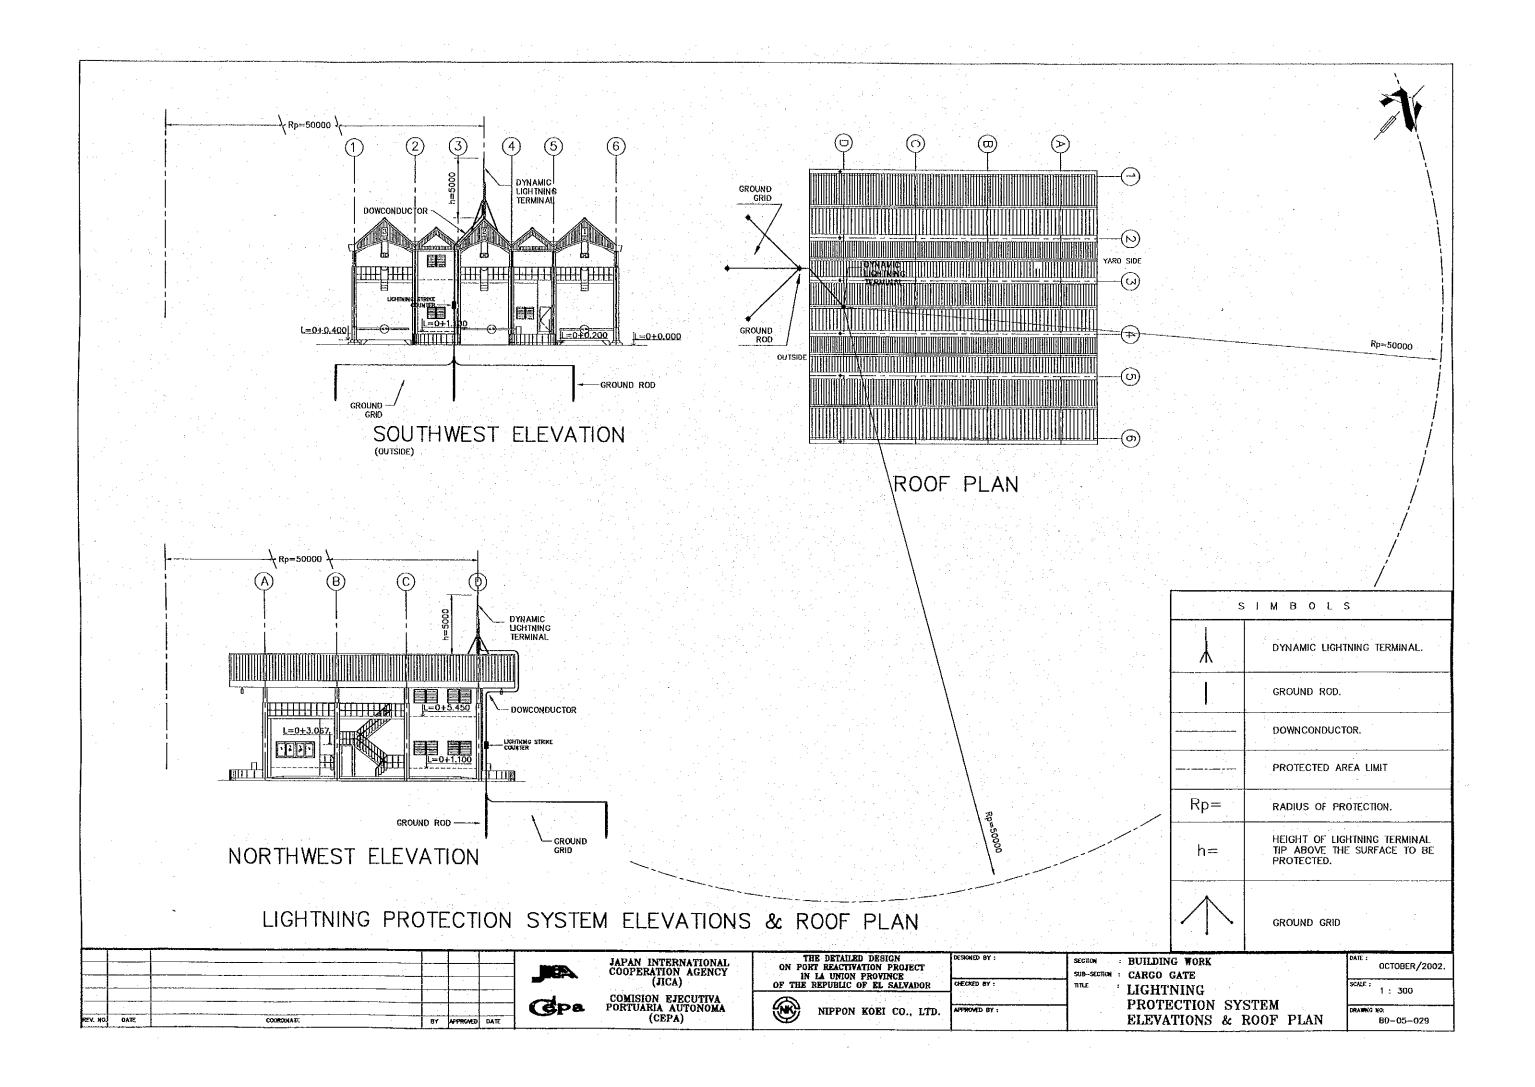
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Г											JAPAN INTERNATIONAL	THE DETAILED DESIGN	DESIGNED BY :	SECTION : BUILDIN
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			· · · · ·							3	(JICA)	OF THE REPUBLIC OF EL SALVADOR	CHECKED BY :	TRE : PANEL
			 · .				<u> </u>	· ·			COMISION EJECUTIVA			l star
· _			· · · · ·			· .	1			Gpa	PORTUARIA AUTONOMA (CEPA)	NIPPON KOEI CO., LTD.	APPROVED BY :	
2	ev. no.	DATE	 COORD	INATE			BY	APPROVED	DATE		(ODFA)		<u> </u>	

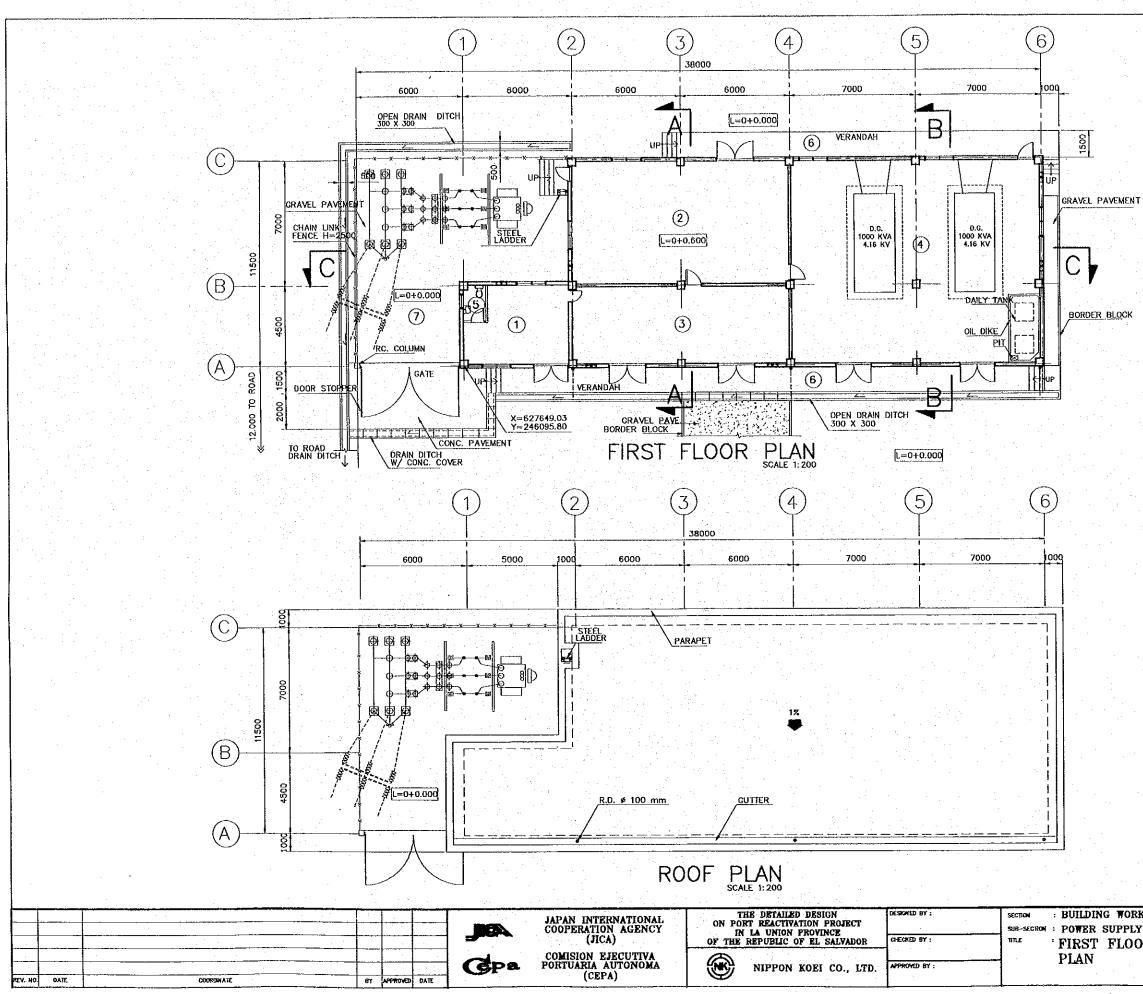








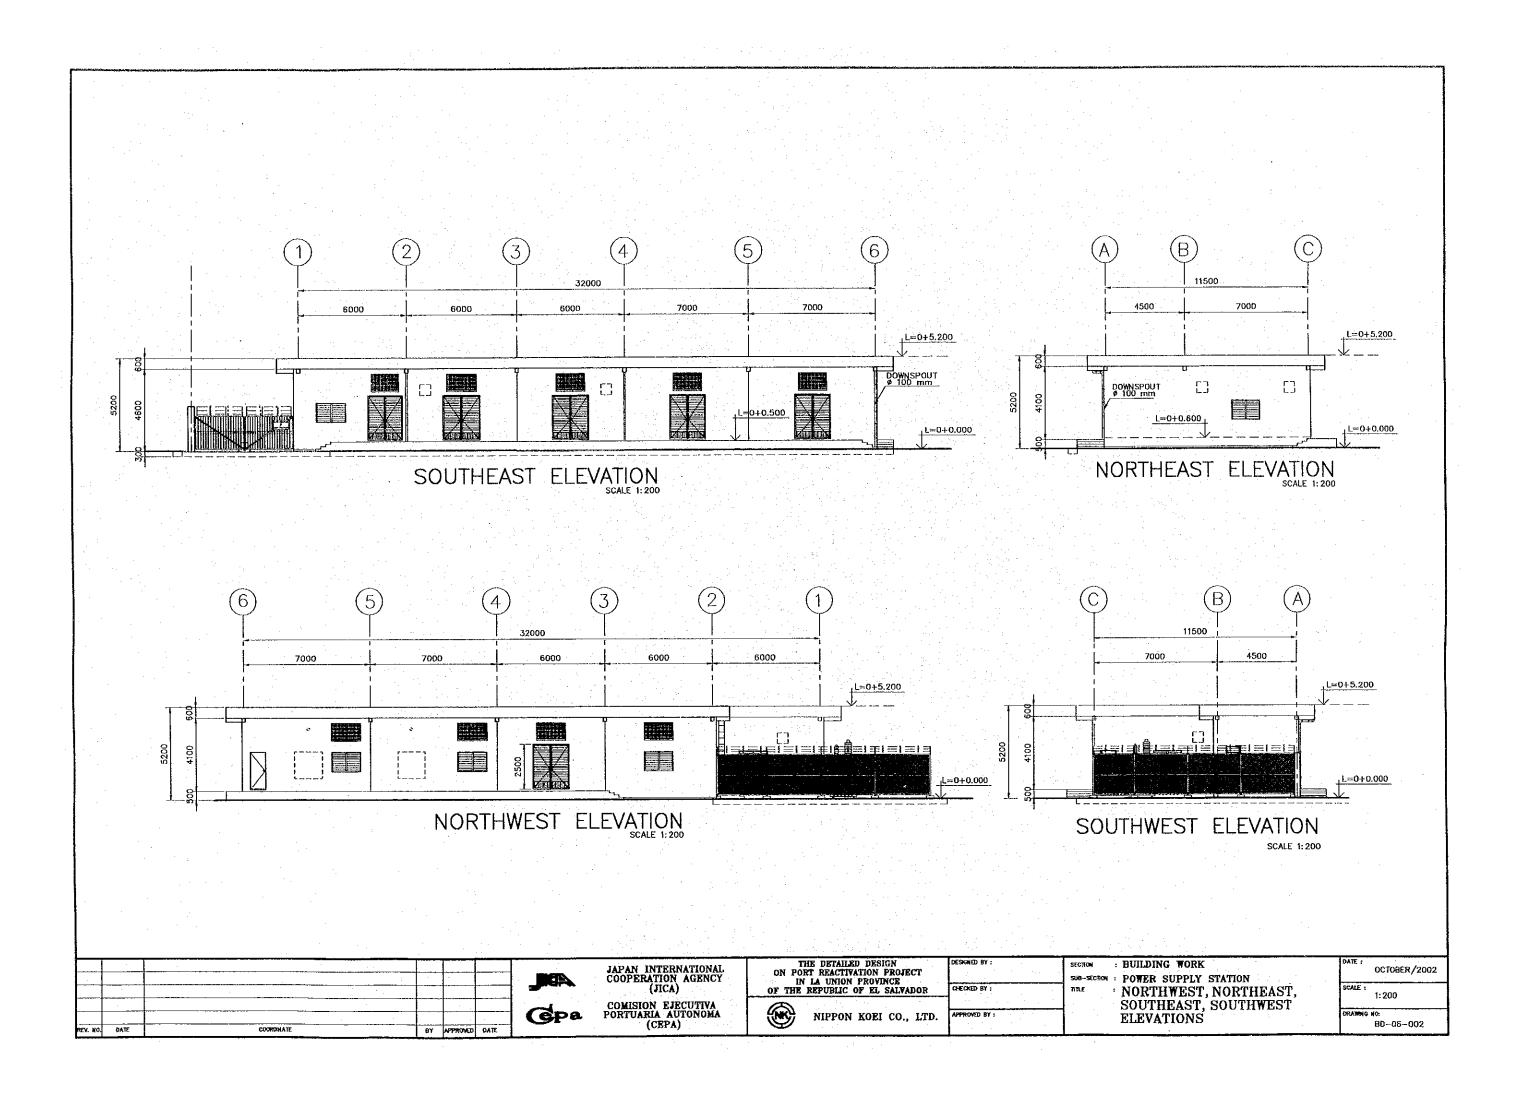


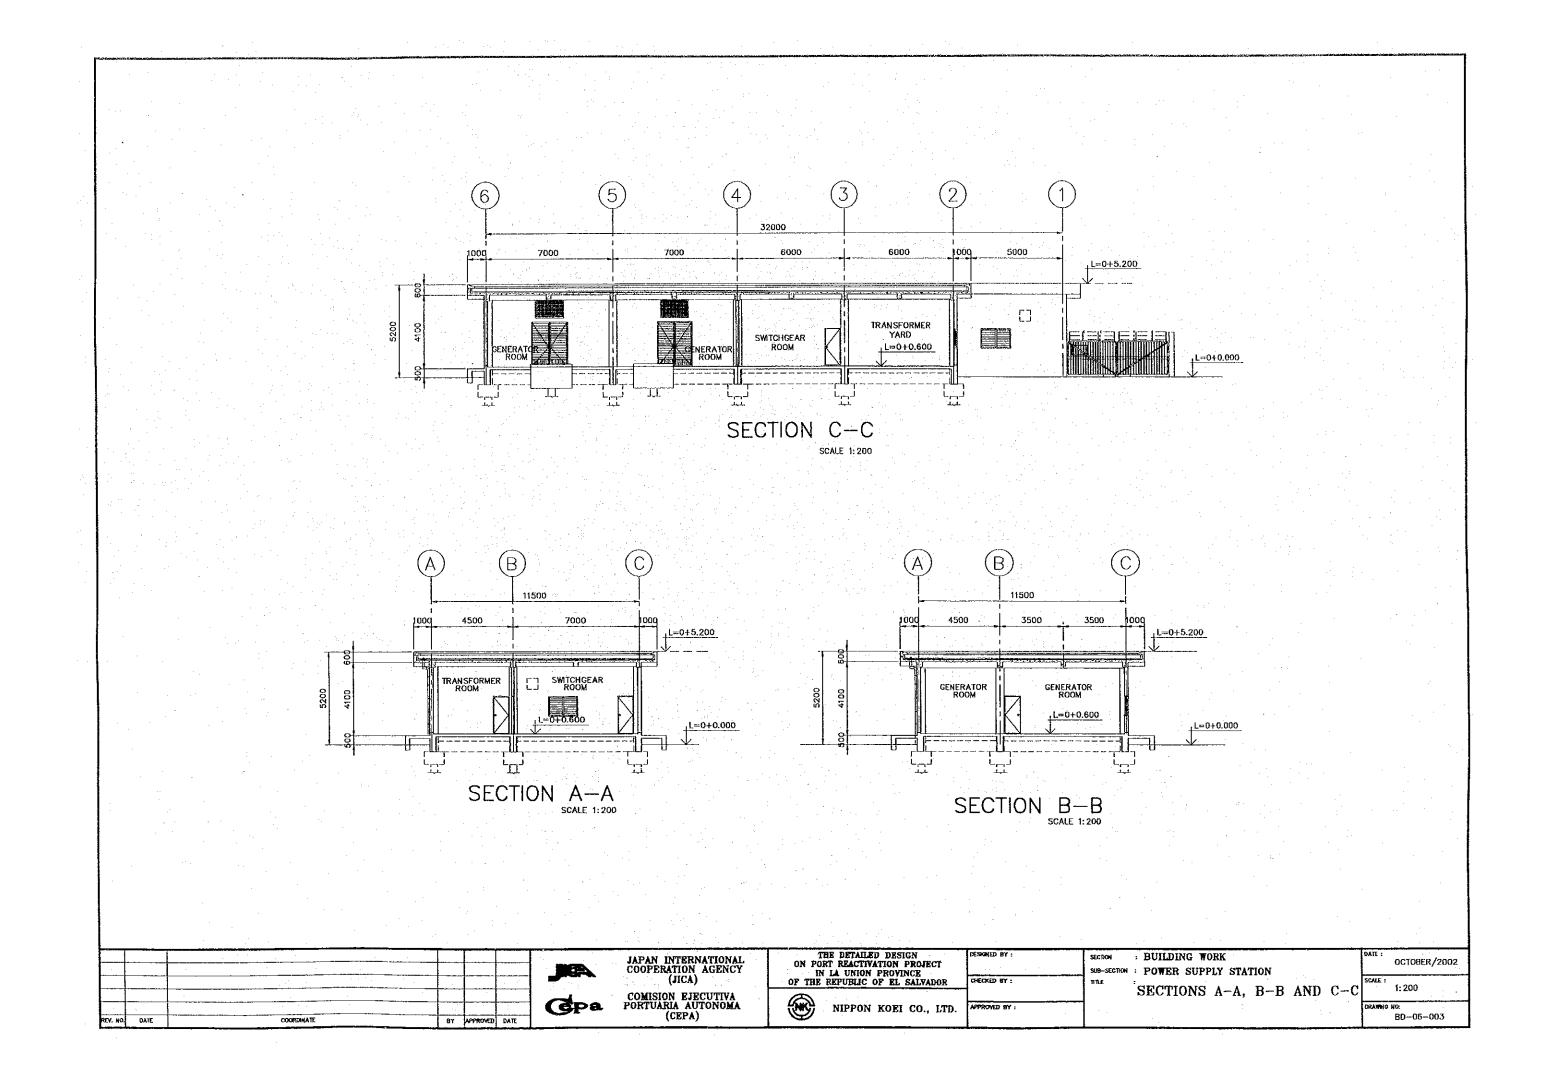


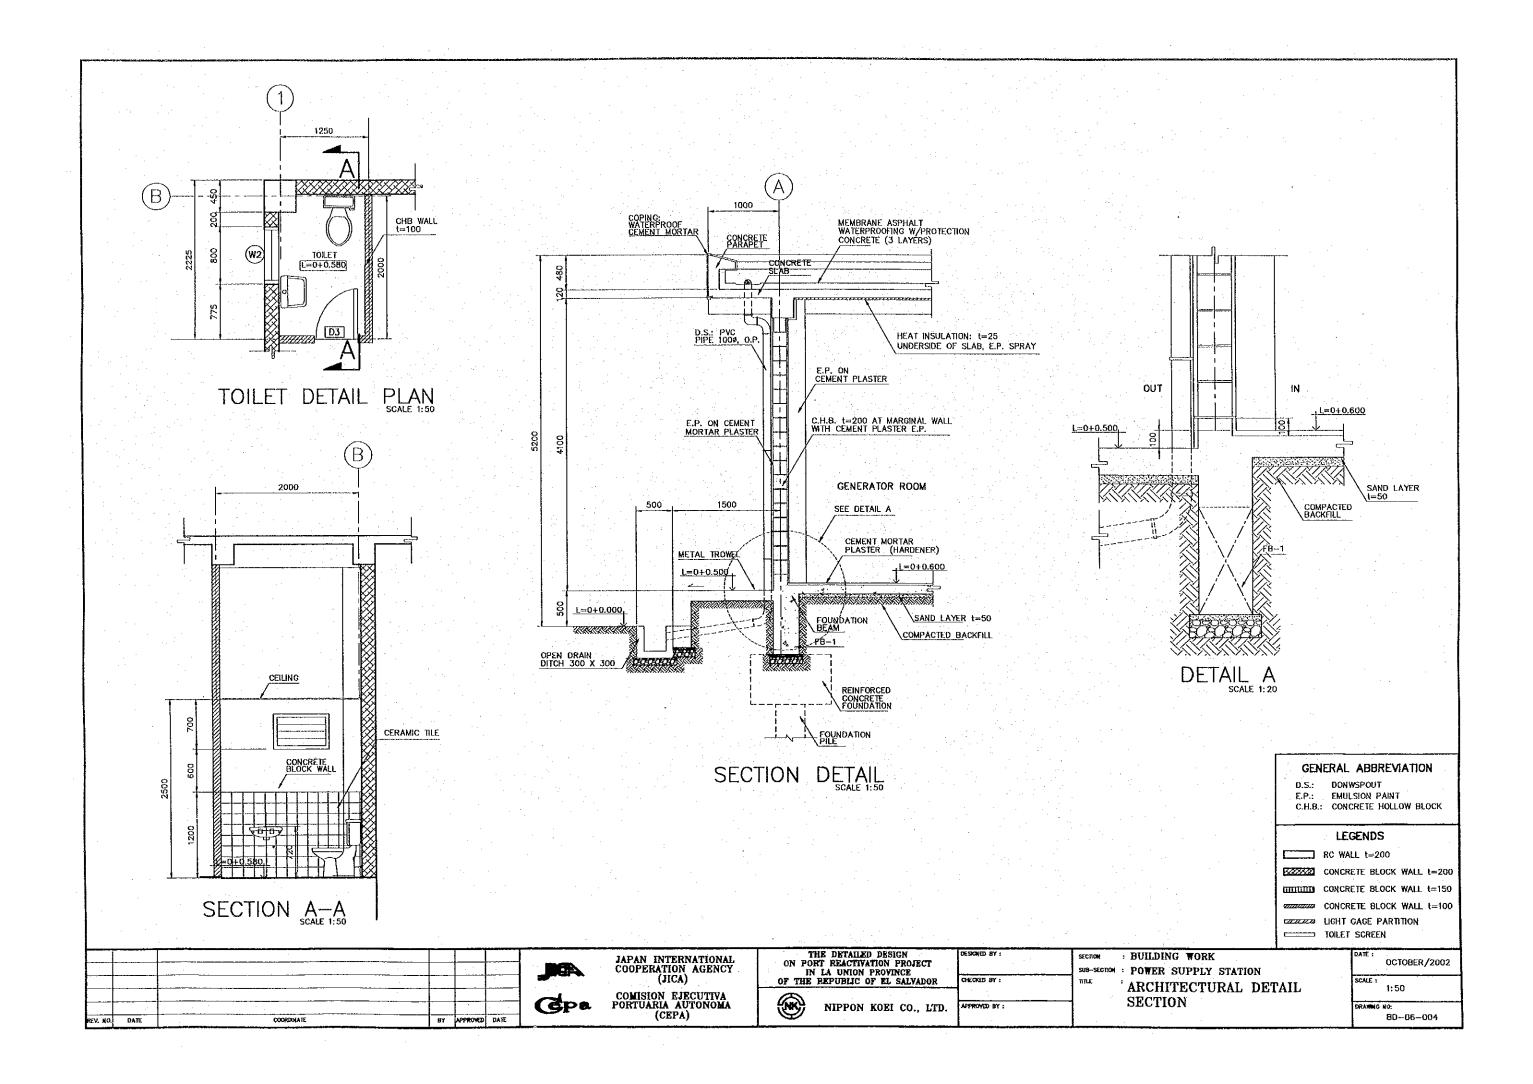
	(2) SWITCH	SEAR ROOM
	(3) TRANSF	ORMER ROOM
•	GENERA	TOR ROOM
	5 TOILET	
	6 SIDEWAI	K.
	(7) TRANSF	ORMER YARD
WORK		DATE : OCTOBER/2002
FLOOR AND	ROOF	scale : 1:200
		DRAWNG NO: BD~06001
		_1

LEGEND

(1) OFFICE ROOM







				DOOR AND WINDOW POWER SUPPLY	
SYMBOL &	: TYPE	回 STEEL FLUSH DOOR	···	DZ STEEL DOOR WITH STEEL LOUVER	D3 WOOD FLUSH DOOR
FIGURE DIMENSIO		38 73 00e		STEEL LOUVER STEEL GRILLES	
SIZE	тнк.	900 X 2100 1	00 (40)	2000 X 2100	700 X 2100 120 (40)
QUANTITY		5 SETS		6 SETS	1 SET
GLASS				NONE	NONE
HARDWARE		125 MM. BUTT HINGES, DOOR CLOSER, CYLINDI LOCK W/ KNOB, DOOR STOP	RICAL	150 MM BUTT HINGES, METAL LOUVER, LOCK LEVER HANDLE, DOOR BOLTS, STOPPER	125 MM BUTT HINGES, DOOR RIM CYLINDRICAL LOCK/KNOB, DOOR RELEASE, COAT HOOK
PAINTING		OIL PAINT		OIL PAINT	OIL PAINT
DESCRIPTIC	ON	STAINLESS SILL; 40 X 15 X 2.0, STEEL SILL (EXTERIOR)		STEEL SILL, INSECT SCREEN TO ALL	HARD WOOD FRAMES
SYMBOL &	۲YPE ،	(W) STEEL FRAMED LOUVER WINDO	S₩	(2) STEEL FRAMED LOUVER WINDOW	W3 CONCRETE LATTICE WINDOW
FIGURE DIMENSIO	·	1600 765 70 765 8 5 5 5 5 5 5 5 5 5 5 5 5 5 5 5 5 5 5			
					FL.
SIZE	тнк.	1600 X 1100	· · · ·	800 X 500 100	2500 X 1000
QUANTITY		7 SETS	:	1 SET	9 SETS
GLASS		6.8 MM FIGURED GLASS		6.8 MM FIGURED GLASS	NONE
HARDWARE	£	GLASS BLADE ADJUSTERS		GLASS BLADE ADJUSTERS	NONE
PAINTING		PAINT		PAINT	OIL PAINT
DESCRIPTIC	ON	STEEL GRILLES OUTSIDE, INSECT SCREEN	· · ·	STEEL GRILLES OUTSIDE, INSECT SCREEN	STORM PROOFED CONCRETE LATTICE WINDOW, INSECT SCREEN
			··· · .		
0. DATE		COORGINATE BY APPROVED	DATE	JAPAN INTERNATIONAL COOPERATION AGENCY (JICA) COMISION EJECUTIVA PORTUARIA AUTONOMA (CEPA)	IE DETAILED DESIGN DESCNID BY: SECHON : BUI T. REACTIVATION PROJECT LA UNION PROVINCE SUB-SECHON : POT LA UNION PROVINCE CHECKED BY: SUB-SECHON : POT REPUBLIC OF EL SALVADOR CHECKED BY: BRL : WIN NIPPON KOEI CO., LTD. APPROVED BY: SCI

DING TORK ER SUPPLY STATION DOWS AND DOORS	HEDULE	DRAWING NO:	-06-005
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ROOM FINISH SCHEDULE

POWER SUPPLY STATION

		DESCRIPTION					F	LOC	R	. 1. 1.	•				•	•		: • • .					WA	LL		1.1.1	• :.						• •	(CEIL	_IN(3		
			M/	ATER	IAL.		· · ·	. Fil	NISHE	ES	· · ·		SK	IRTI	NG				M	ATER	RIAL		•	di.			FIN	ISH	S	TYPE	Ξ		MA	TER	IAL	F	INISH	IES	н
		SYMBOL		.:		1	2	3	4 5	6	5	B) 2	3		\$	6	X	8	×i)	N	1 2			2 1	1	29	F7	B	B	C	PF	Ē			
	STORY	MATERIAL ROOM	REINFORCED CONCRETE, STEEL STROWEL	RD PA	NATURAL SOIL	CARPETING ON CEMENT MORTAR	GRANITE STONE THE	. The	CEMENT MORTAR PLASTERING	NATURAL GRASS	HARDENER	COLUCIT LUDERAD		WOOD, (PAINT), H=100 MM	CERAMIC TILE, H=100 MM CERAMIC TILE H=100 MM	RENFORCED CONCRETE CONCRETE BLOCK 2D0mm. THICK	TE BLOCK 150mm	CONCRETE BLOCK 100mm. THICK	CEMENT FIBERBOARD	GYPSUM BOARD W/ CALVANIZED STEEL FRAME	CORRUGATED STEEL SHEET ALUM FRAME, COMPRESSED WOOD	PANEL W/ MELAMINE COVERING	LENE AND	STEEL SHEE		AIC TILE	ON GYPSUM	PAINT ON CEMENT PLASTER	NONE	CONCRETE BLOCK WITH GROOVE	This list of	CEMENT FIBERBOARD W/ALUMINIUM FRAME	CYPSUM BOARD W/ ALUMINIUM FRAME		MINERAL FIBER ACOUSTIC TILE W/ALM. FRAME	INSTRAT'N DAMT SPRAY		PAINTING	
	1.	FIRST FLOOR								-					-																						1		
- [1.1	OFFICE ROOM	•	· ·				•		1		· .																				\bullet						۲	•
· [1.2	SWITCHGEAR ROOM	۲	1	<u> </u>	_		. 1	•														·					•									<i>i</i> [•	Ĺ.
·]	1.3	TRANSFORMER ROOM	•		·		<u> </u>	1	•	1												- 1 ²⁷		<u>1</u> T										•		•	ł 🖂		Ŀ
	1.4	GENERATOR ROOM	•			_						[e 7							T											1	۲		•	+		ſ
	1.5	TOILET	•	_						1								•	1	Т						•						•					· · .	•	ľ.
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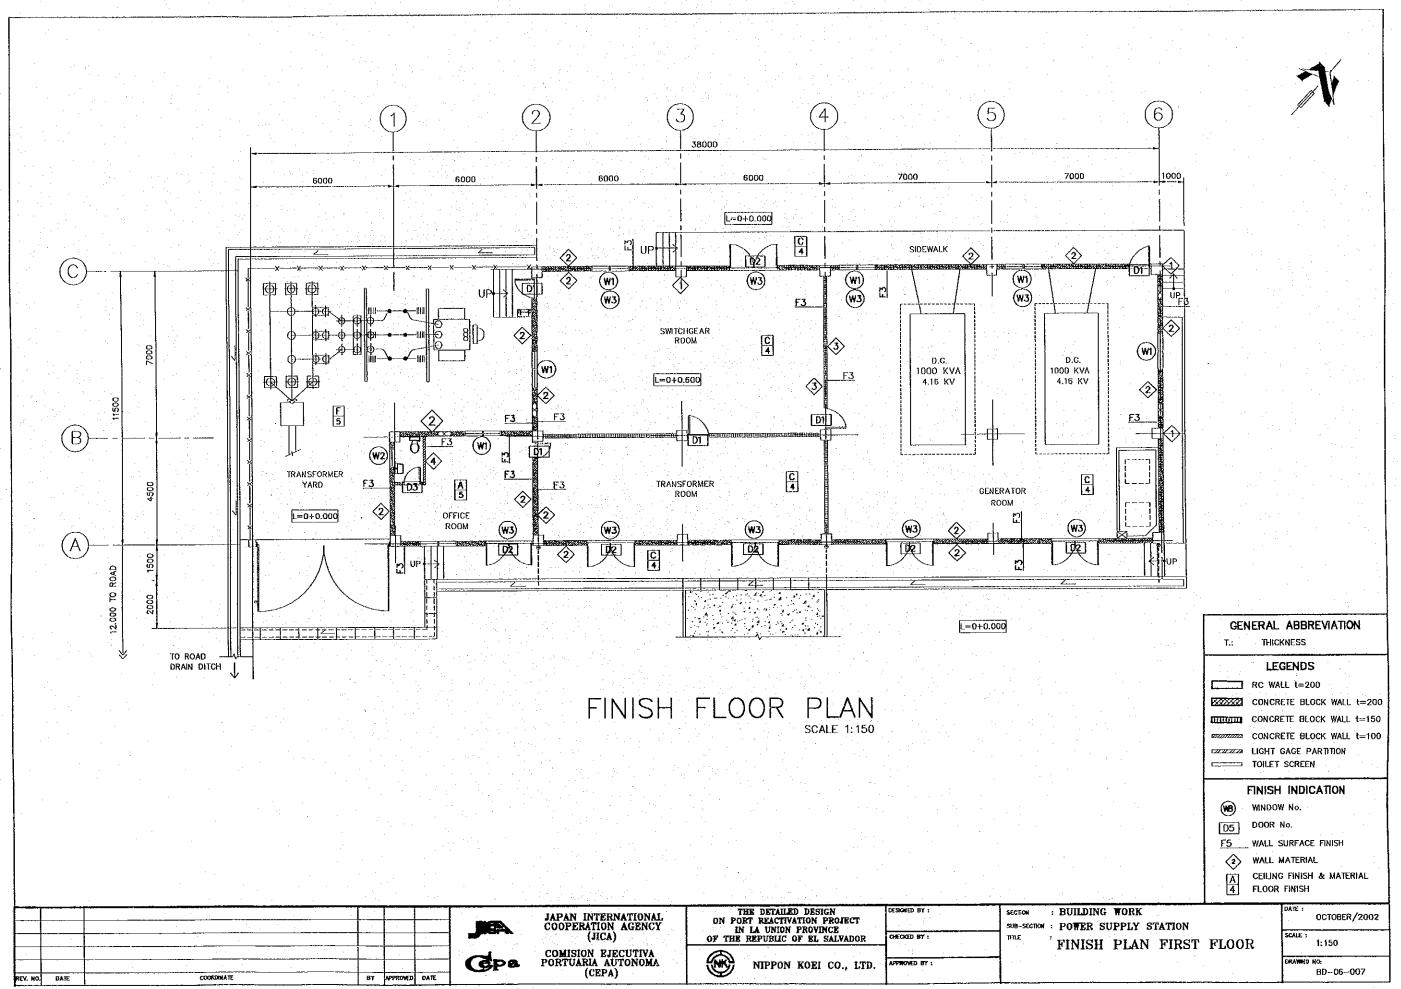
EXTERIOR FINISH SCHEDULE

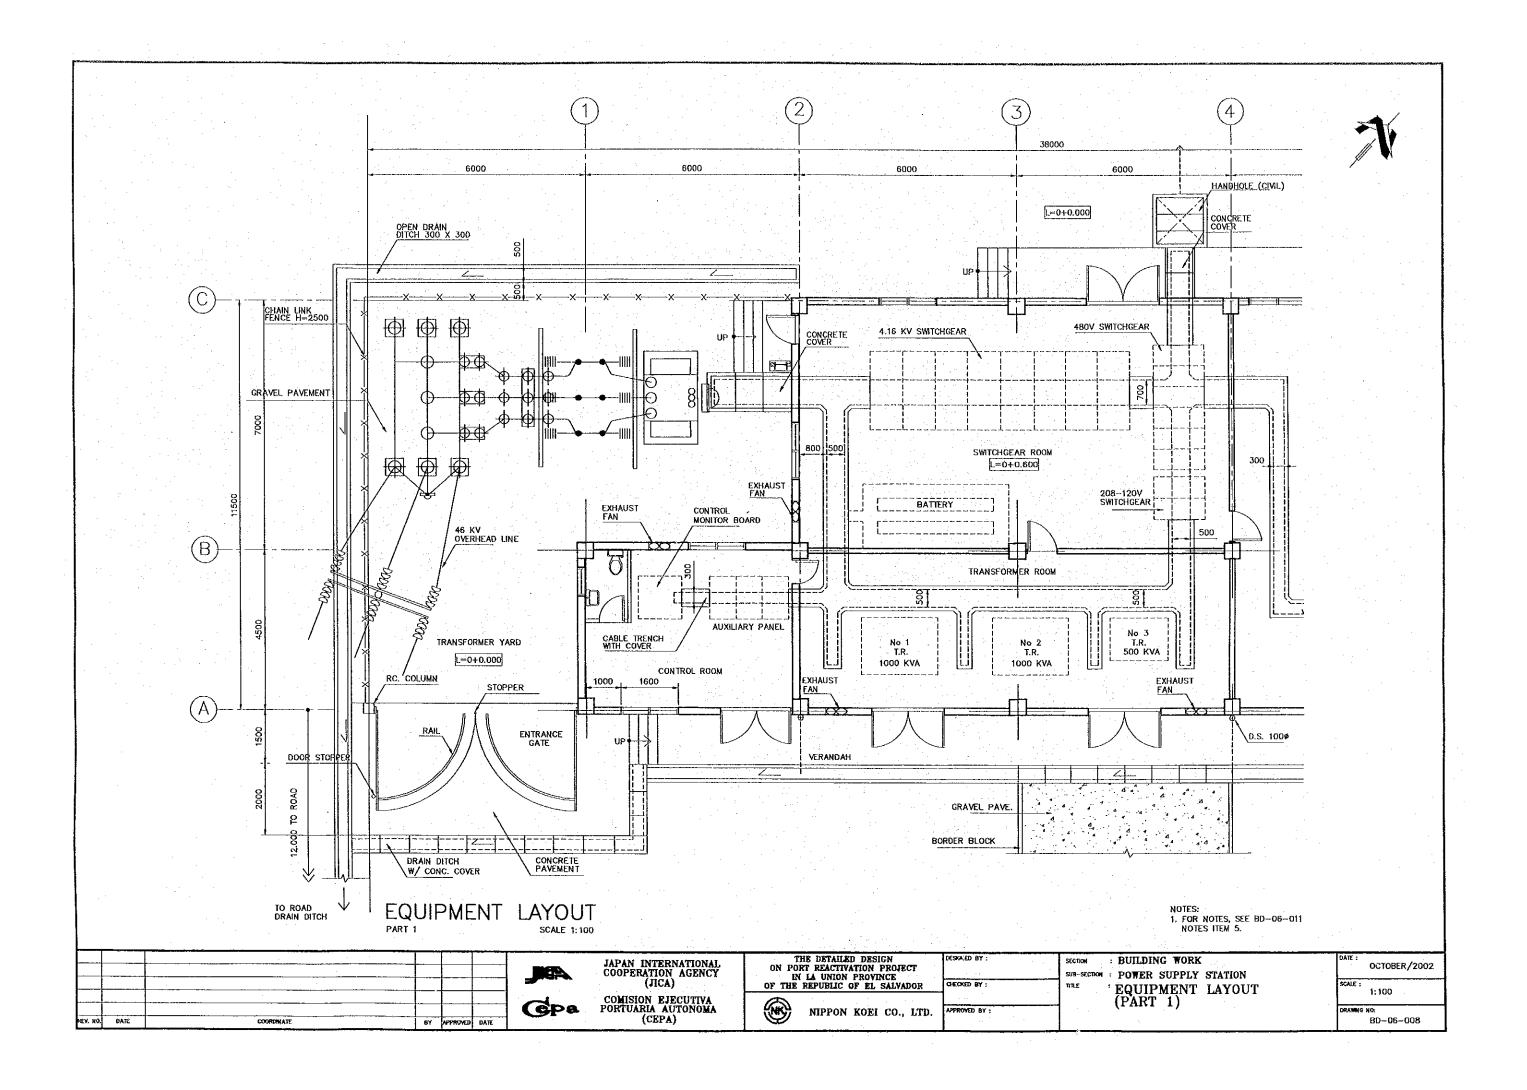
POWER SUPPLY STATION

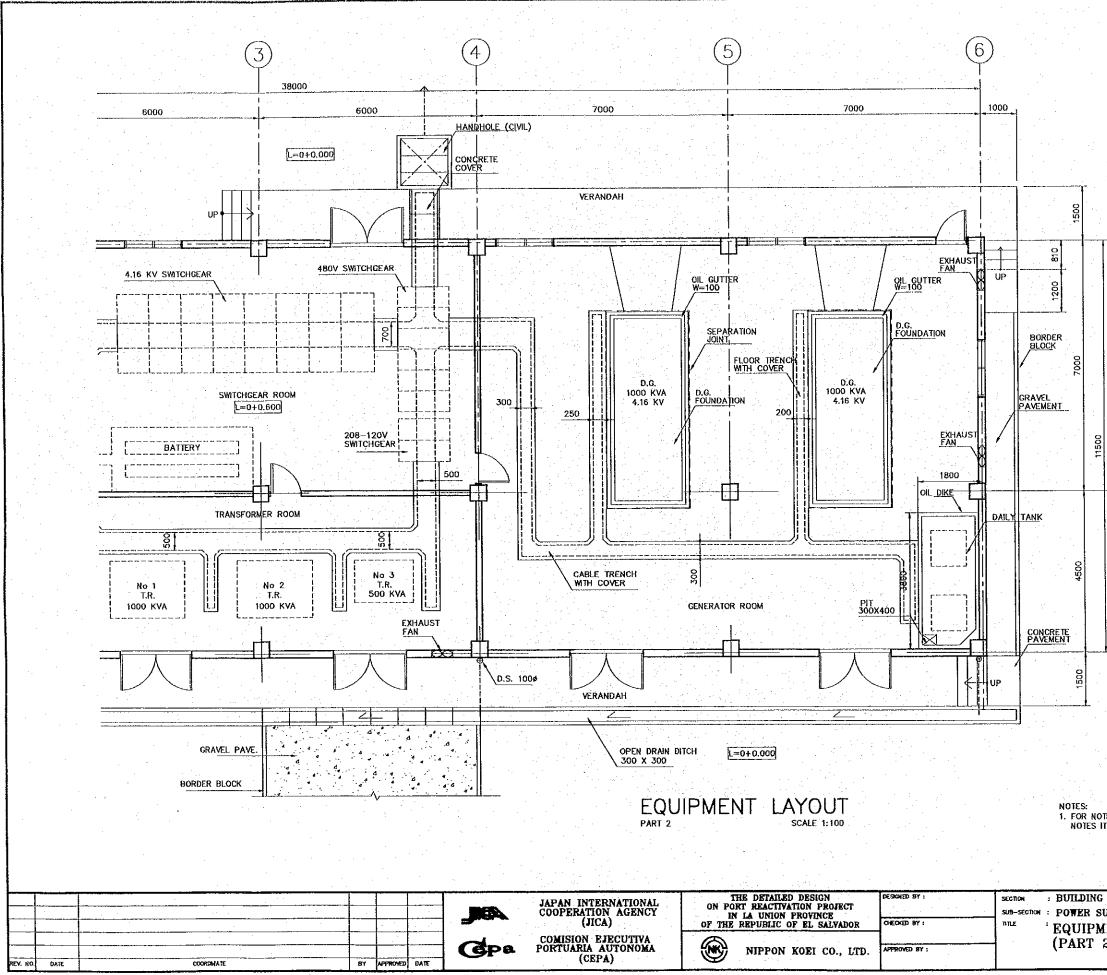
PORTION	FINISHES	PORTION	FINISHES
ROOF	WATERPROOF CEMENT MORTAR t=30, COVERING CONCRETE t=60 WITH ESPANSION JOINT @ 3.0 M. CURING MORTAR t=15, 3-LAYERS ASPHALT WATERPROOFING, LEVELING MORTAR t=15, INSULATION BOARD (FORM POLYSTYRENE) t=25 UNDERSIDE OF ROOF SLAB.	SIDEWALK	CONCRETE SLAB, METAL TROWEL FINISH AND GRAVEL
	POOF GUTTER: WATERPROOF CEMENT MORTAR WITH WIRE MESH AND JOINT.	FENCE & GATE	ENTRANCE GATE: GALVANIZED STEEL PIPES OIL PAINT
EXTERIOR WALL	ACRYLIC EMULSION PAINT (EXTERIOR QUALITY) ON CEMENT MORTAR PLASTER WITH 20 MM, CONTROL JOINT AT APPROX. EVERY 3.0 M.		FENCING: GALAVANIZED STEEL PIPE FRAMING WITH GALV
	SKIRTING: CEMENT MORTAR PLASTER H=700 MM, ABOVE GROUND.	OPEN DRAIN DITCH	CONCRETE MADE WITH CONCRETE COVER.
PARAPET	WATERPROOF CEMENT MORTAR t=30 MM. INCLUDING COPINC W/WIRE MESH.	EQUIPMENT FOUNDATION	CONCRETE MADE WITH ANCHOR HOLES.
ROOF DRAIN & DOWNSPOUT	ROOFDRAIN: CAST IRON MADE 1000 TAR BAKED. DOWNSPOUT: FVC PIPE (HEAVY DUTY), 1000 VINYL PAINT.	TRANSFORMER YARD	EQUIPMENT FOUNDATION: CONCRETE MADE WITH ANCHO
EAVES	COLORED CEMENT SPRAY ON TREATED EXPOSED CONCRETE SURFACES.	VERENDAH	CONCRETE SLAB, METAL TROWEL, WALL: AEP (EXT. QUA

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