


# **BUILDING WORKS**

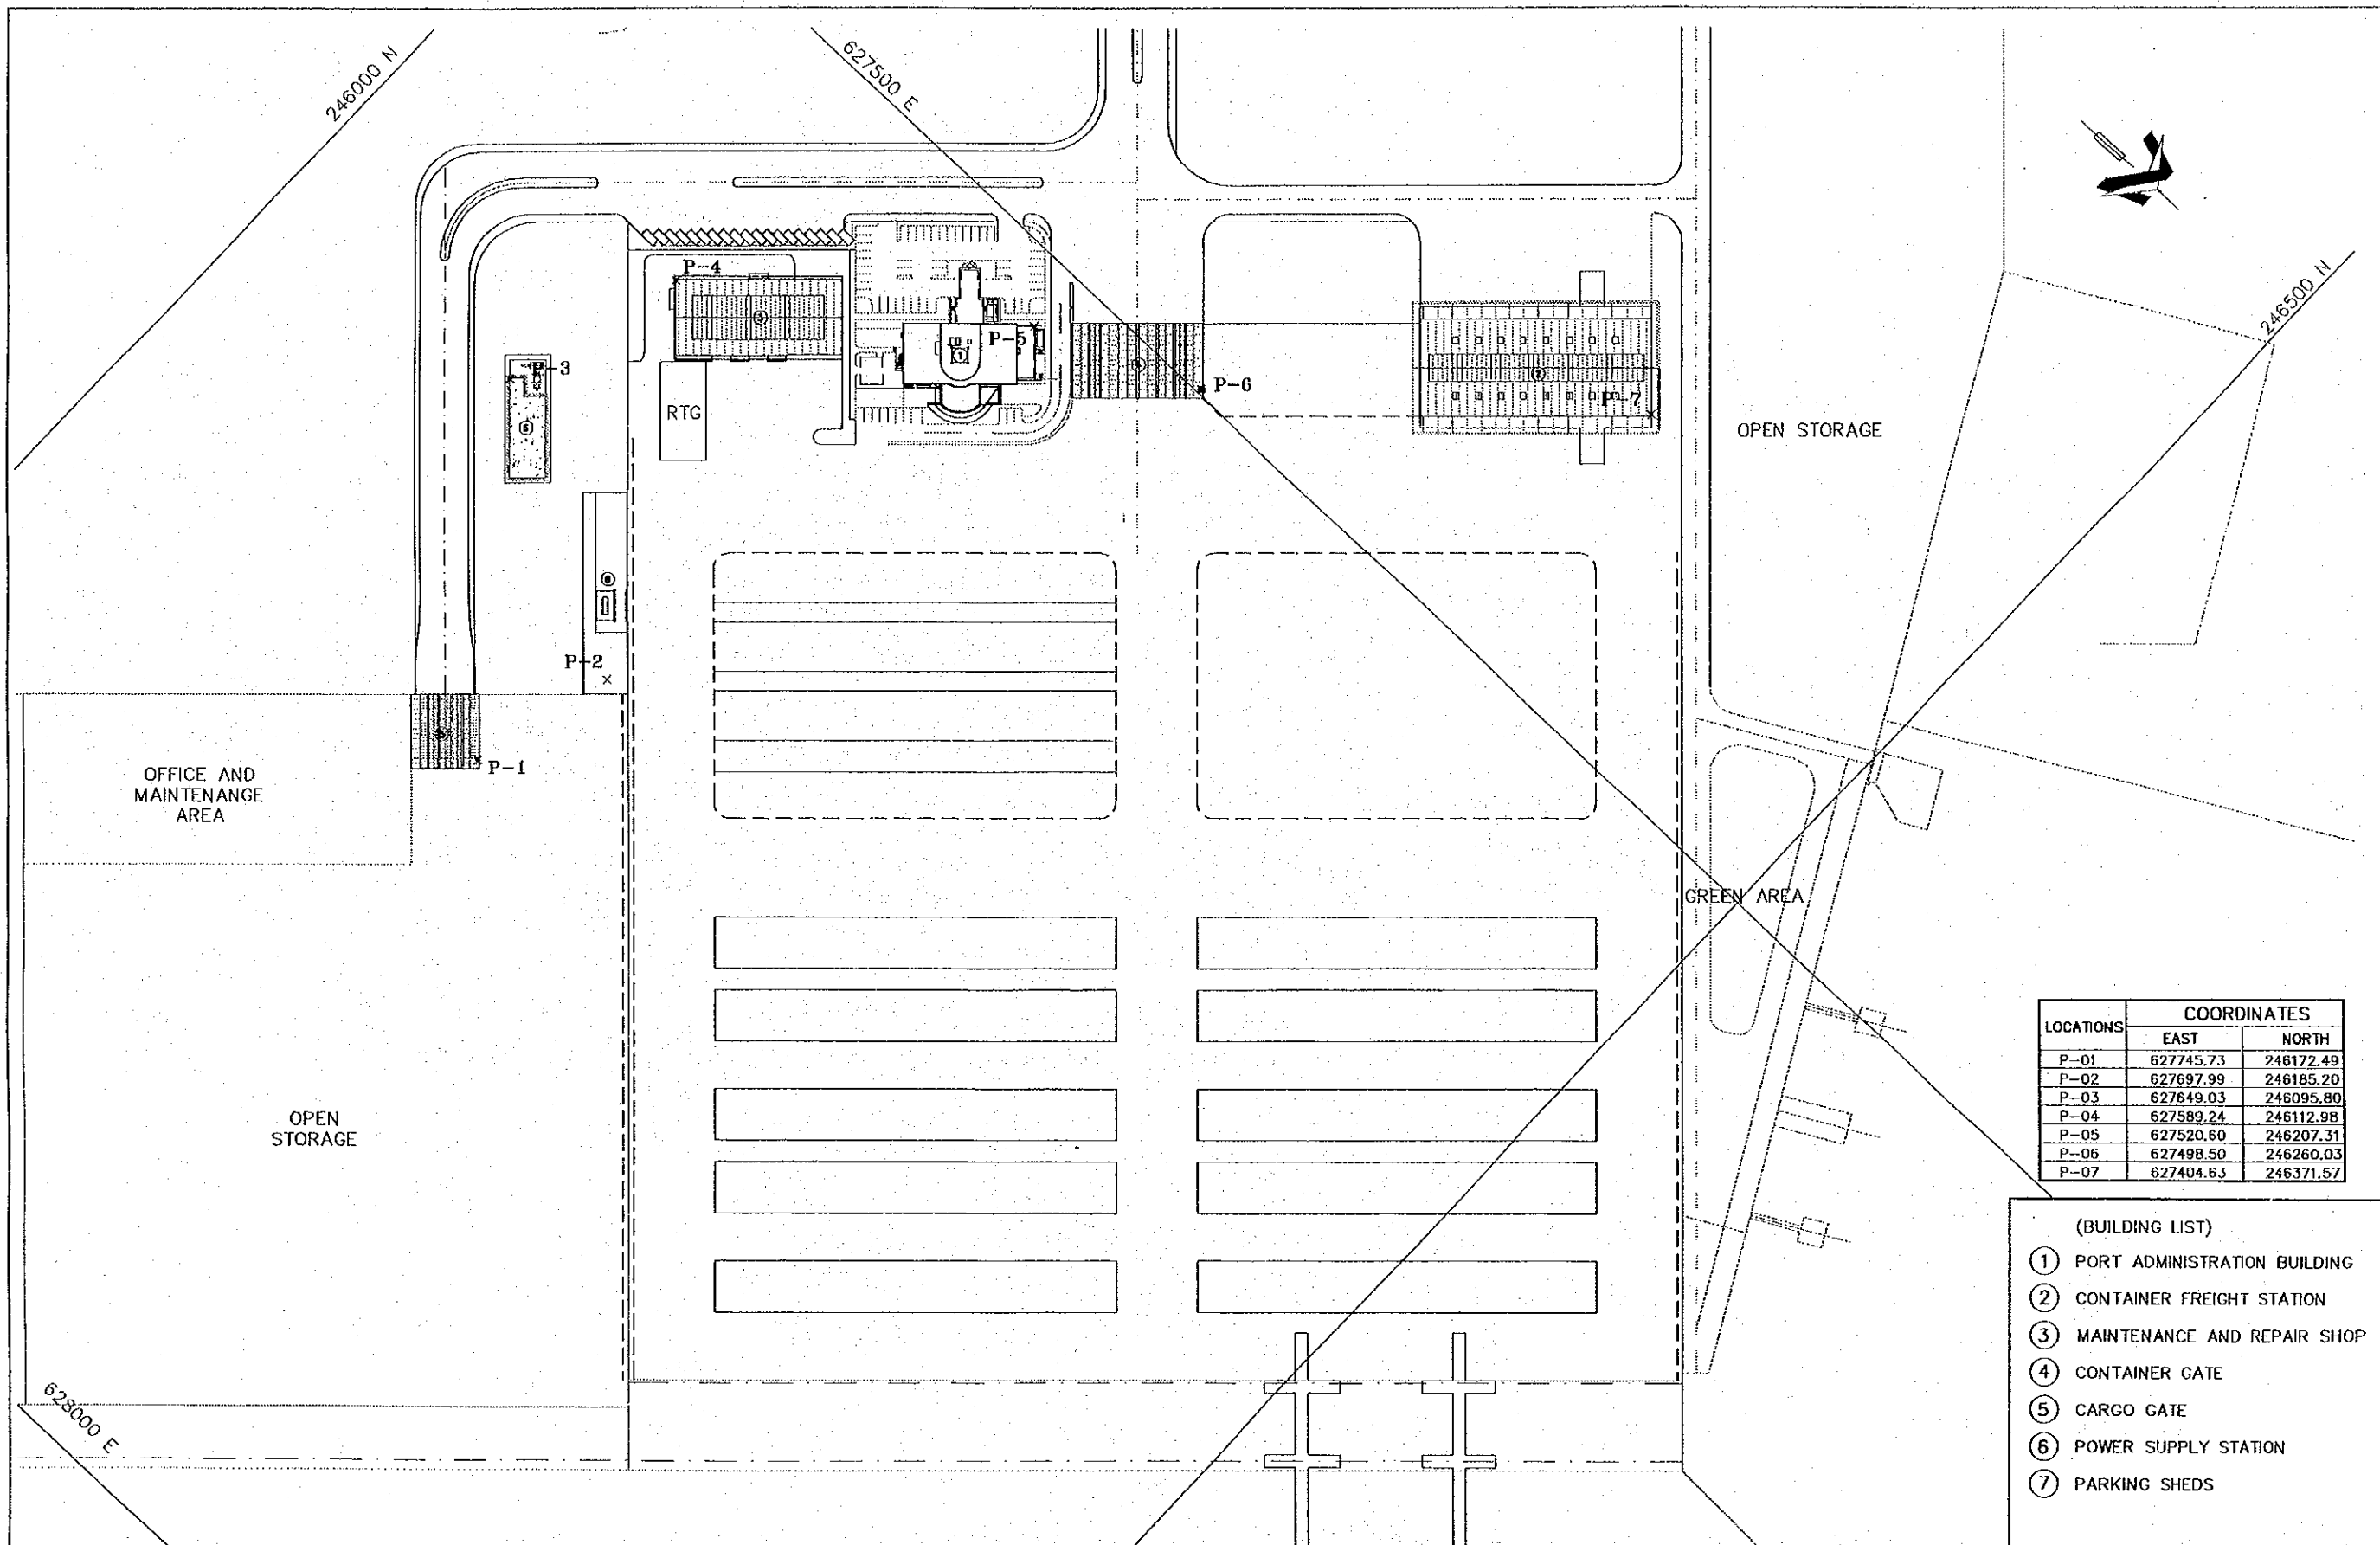

LOCATIONS	COORDINATES	
	EAST	NORTH
P-01	627745.73	246172.49
P-02	627697.99	246185.20
P-03	627649.03	246095.80
P-04	627589.24	246112.98
P-05	627520.60	246207.31
P-06	627498.50	246260.03
P-07	627404.63	246371.57


- (BUILDING LIST)
- ① PORT ADMINISTRATION BUILDING
  - ② CONTAINER FREIGHT STATION
  - ③ MAINTENANCE AND REPAIR SHOP
  - ④ CONTAINER GATE
  - ⑤ CARGO GATE
  - ⑥ POWER SUPPLY STATION
  - ⑦ PARKING SHEDS

REV. NO.	DATE	COORDINATE	BY	APPROVED	DATE	<b>JAPAN INTERNATIONAL COOPERATION AGENCY (JICA)</b> <b>COMISION EJECUTIVA PORTUARIA AUTONOMA (CEPA)</b>		<b>THE DETAILED DESIGN ON PORT REACTIVATION PROJECT IN LA UNION PROVINCE OF THE REPUBLIC OF EL SALVADOR</b> <b>NIPPON KOEI CO., LTD.</b>		DESIGNED BY : CHECKED BY : APPROVED BY :	SECTION : <b>BUILDING WORK</b> SUB-SECTION : <b>GENERAL</b> TITLE : <b>BUILDING LOCATION PLAN</b>	DATE : <b>OCTOBER/2002</b> SCALE : <b>1 : 2,000</b> DRAWING NO. : <b>BD-00-001</b>









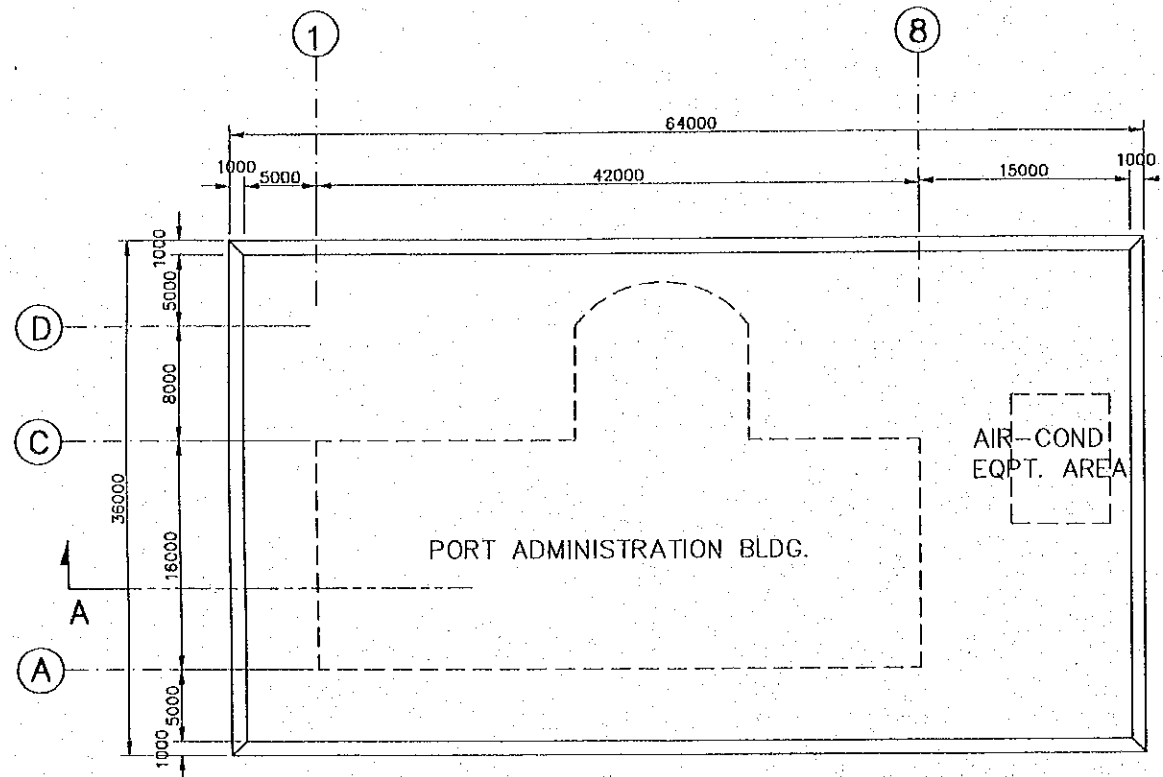


PLAN OF SUBSEQUENT RECLAMATION  
SCALE 1:500

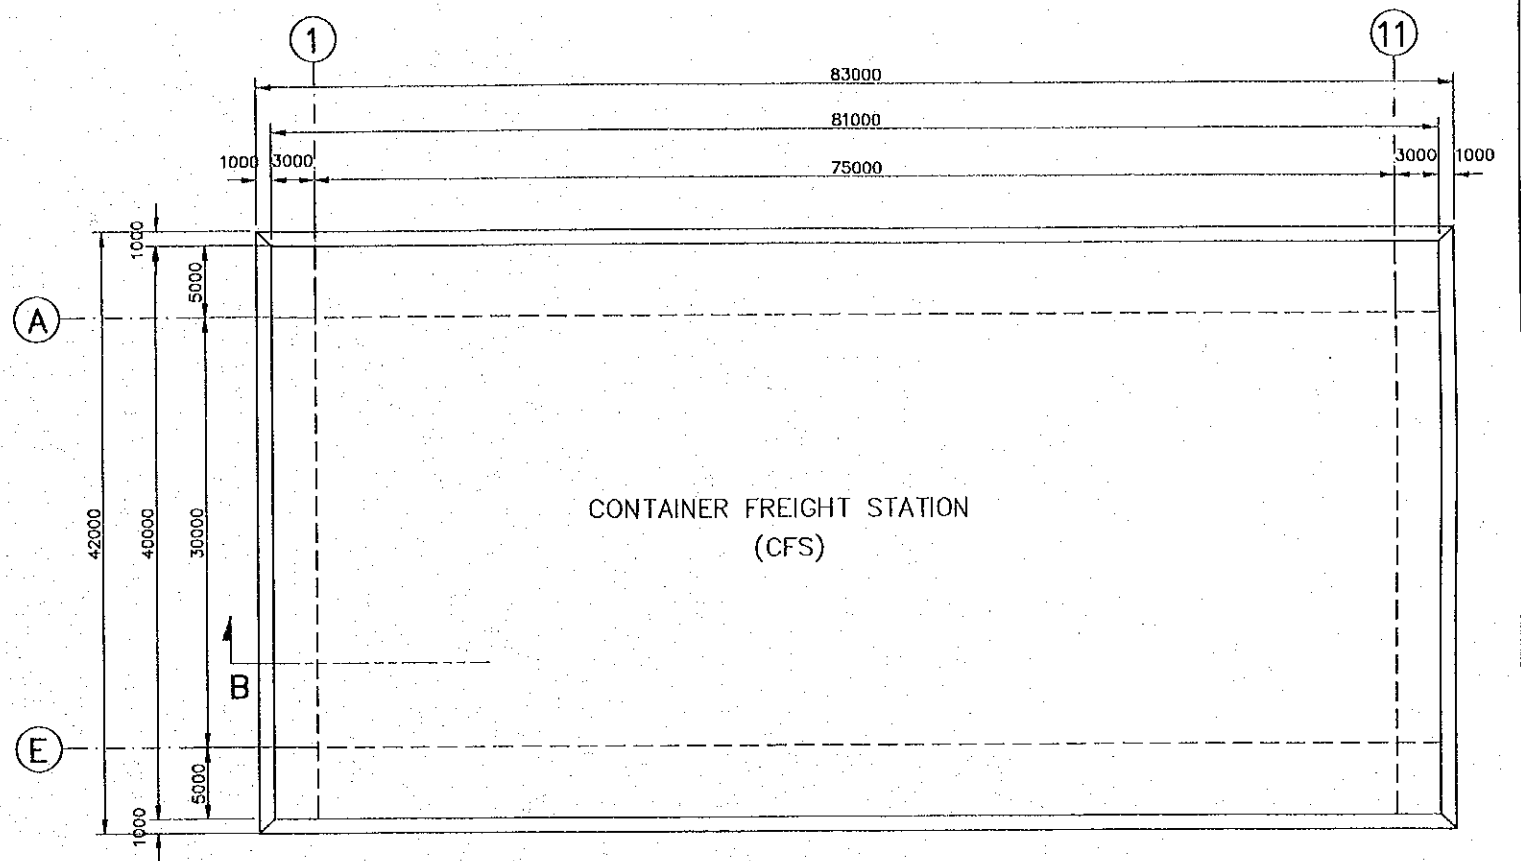

PLAN OF SUBSEQUENT RECLAMATION  
SCALE 1:500

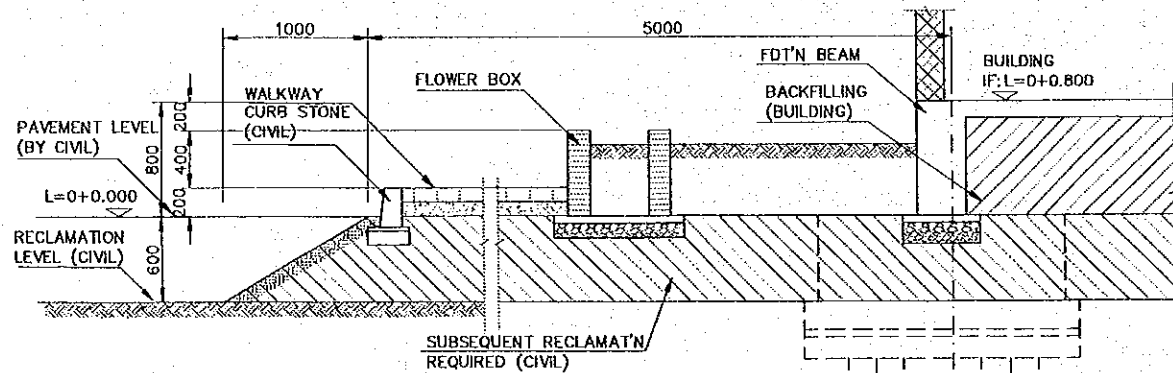

SECTION - A  
SCALE 1:50

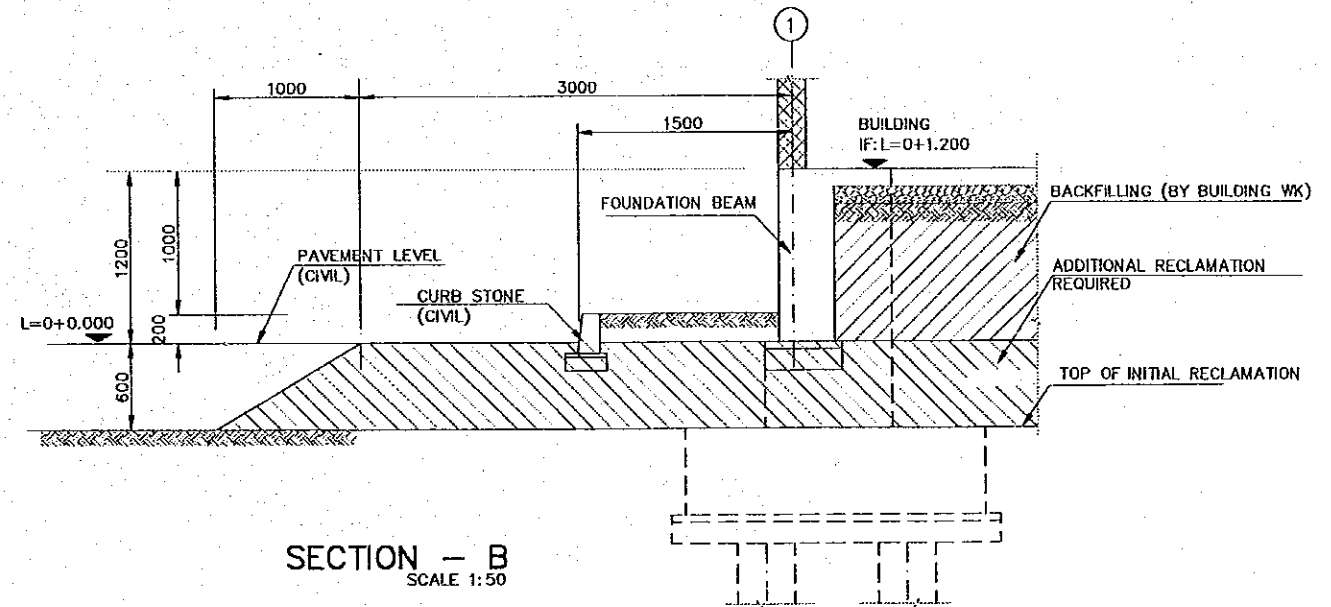

SECTION - B  
SCALE 1:50

NOTES:

1. THIS DRAWING SHOWS THE AREA, SECTION AND VOLUMES REQUIRED FOR SUBSEQUENT RECLAMATION TO THE TWO BUILDING CONSTRUCTION SITES.
2. THE BUILDING SITES AND REQUIRED VOLUME SHALL BE AS FOLLOWS:  
 1) PORT ADMINISTRATION BUILDING:  $(63 \times 35) \times 0.60 = 1,323 \text{ M}^3$   
 2) CONTAINER FREIGHT STATION (CFS):  $(82 \times 41) \times 0.6 = 2,017.2 \text{ M}^3$   
 TOTAL =  $3,340.2 \text{ M}^3$
3. THE SUBSEQUENT RECLAMATION SHALL BE PERFORMED BY THE CIVIL WORK UNDER THIS CONTRACT.
4. COMPACTION SHALL BE DONE SATISFACTORILY IN ACCORDANCE WITH THE SPECIFICATION PROVIDED UNDER CIVIL WORK IN ORDER TO ACHIEVE REQUIRED BEARING CAPACITY

REV. NO.	DATE	COORDINATE	BY	APPROVED	DATE

**JICA**  
JAPAN INTERNATIONAL COOPERATION AGENCY (JICA)

**Cepa**  
COMISION EJECUTIVA PORTUARIA AUTONOMA (CEPA)

THE DETAILED DESIGN  
ON PORT REACTIVATION PROJECT  
IN LA UNION PROVINCE  
OF THE REPUBLIC OF EL SALVADOR

**NK**  
NIPPON KOEI CO., LTD.

DESIGNED BY :  
CHECKED BY :  
APPROVED BY :

SECTION : BUILDING WORK  
SUB-SECTION : GENERAL  
TITLE : SUBSEQUENT RECLAMATION

DATE : OCTOBER/2002  
SCALE : INDICATED  
DRAWING NO. : BD-00-005




**6. PRECAST PRESTRESS SLAB**

**A) SUPERIMPOSED LOADS**


THE SUPERIMPOSED LOAD FOR THE SLAB IS ALL THE ADDITIONAL WEIGHT NOT CONSIDERING THE SELFWEIGHT AND THE 5 CM CONCRETE TOPPING. THE SELFWEIGHT OF THE PRECAST SLAB SHALL NOT EXCEED 225 Kg/m<sup>2</sup>

ROOM	LOAD (kg/m <sup>2</sup> )
OFFICE	400
AUDITORIUM & HALLWALK	450


**B) DETAILS FOR SUPPORT ON STEEL BEAMS**

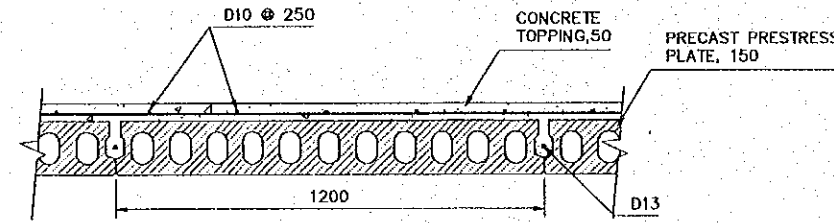

**PRECAST PRESTRESS SLAB**  
SCALE 1:20

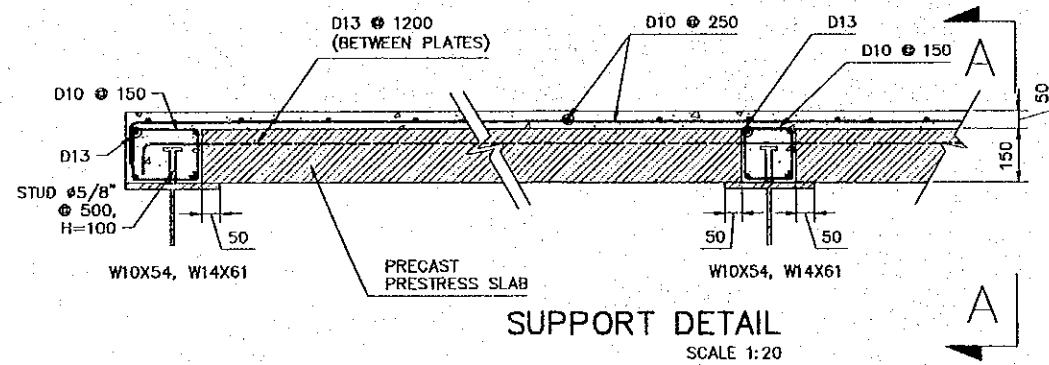


**SUPPORT DETAIL**  
SCALE 1:20

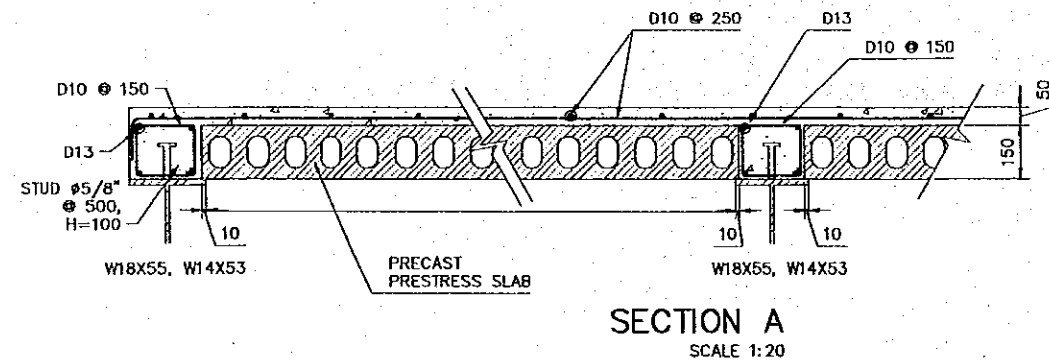

**SECTION A**  
SCALE 1:20


**9. CONCRETE BLOCK WALL**

**A) SECTION**

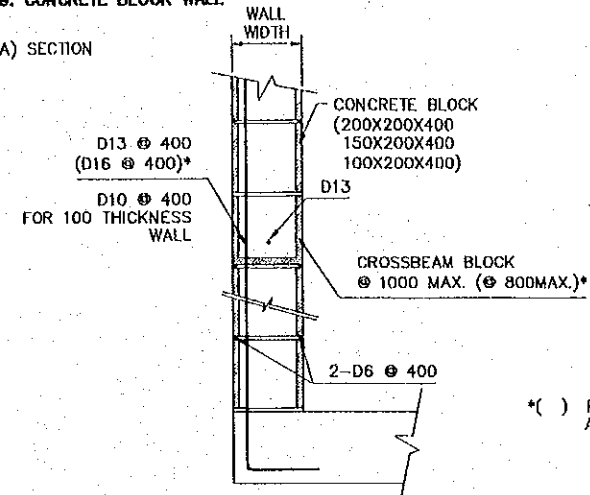


( ) FOR OUTSIDE WALL OF PORT ADMINISTRATION BUILDING


**B) WALL CONNECTIONS**

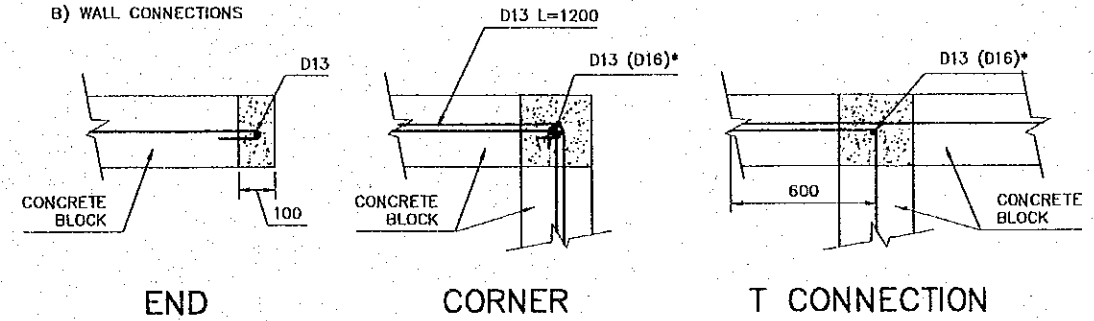

**C) TOP OF WALL**

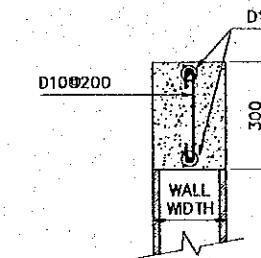


**D) LINTEL**

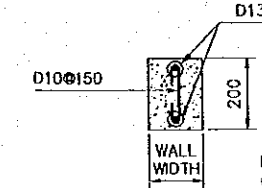

LINTEL SHALL BE PROVIDED FOR WALL OPENINGS (DOORS AND WINDOWS) AND SHALL BE THE SAME WIDTH AS THE CONCRETE BLOCK.

**E) EXPANSION JOINT**

EXPANSION JOINT SHALL BE PROVIDED TO AVOID ANY INTERACTION BETWEEN THE WALL AND THE CONCRETE FRAME. THE JOINT SHALL BE 25 MM. OF WIDTH AND SHALL CONSIST OF A FIRM, FLEXIBLE TEAR-RESISTANT RUBBER WITH A POLYURETHANE SEALANT OF AN ADEQUATE DEPTH. THE EXPANSION JOINT SHALL CONFORM TO ASTM C-920, D-2240, D-412 AND D-624.

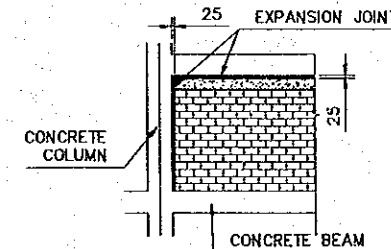

**10) ABBREVIATIONS**

B.L.	BOTTOM LAYER
CL.	CLEAR
COV.	COVER
D.	DIAMETER
GALV.	GALVANIZED
L.	LEVEL
MAX.	MAXIMUM
MIN.	MINIMUM
MM	MILLIMETERS
PL.	PLATE
RC	REINFORCED CONCRETE
T.	METRIC TONS
TH.	THICKNESS
T.L.	TOP LAYER

REV. NO.	DATE	COORDINATE	BY	APPROVED	DATE



JAPAN INTERNATIONAL COOPERATION AGENCY (JICA)  
COMISION EJECUTIVA PORTUARIA AUTONOMA (CEPA)

THE DETAILED DESIGN ON PORT REACTIVATION PROJECT IN LA UNION PROVINCE OF THE REPUBLIC OF EL SALVADOR  
NIPPON KOEI CO., LTD.
















DESIGNED BY :  
CHECKED BY :  
APPROVED BY :

SECTION : BUILDING WORK  
SUB-SECTION : GENERAL  
TITLE : STRUCTURALS STANDARD DETAILS - 02

DATE : OCTOBER/2002  
SCALE : INDICATED  
DRAWING NO. : BD-00-007



## DETAILS OF LIGHTING FIXTURE

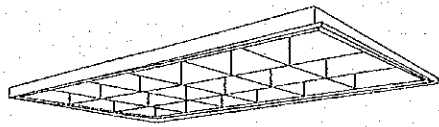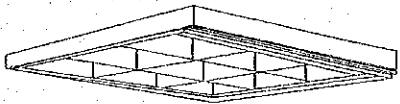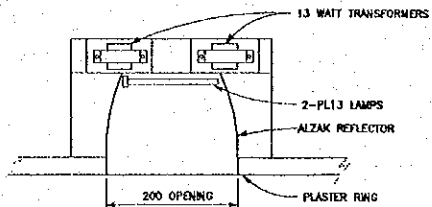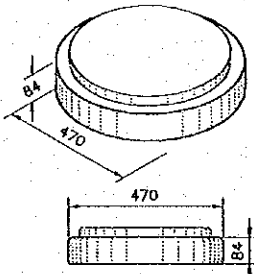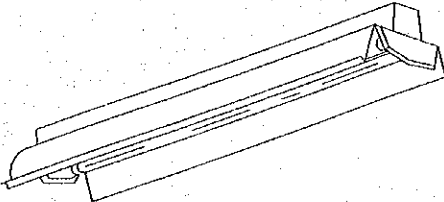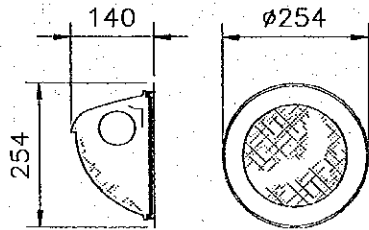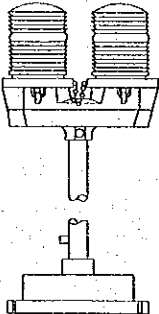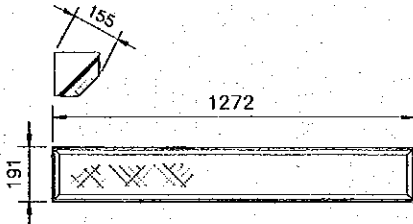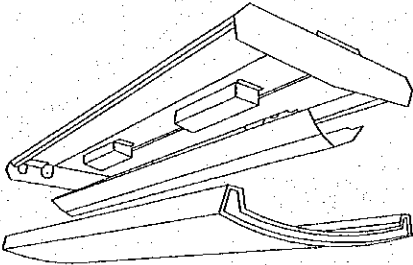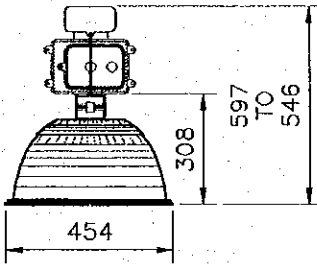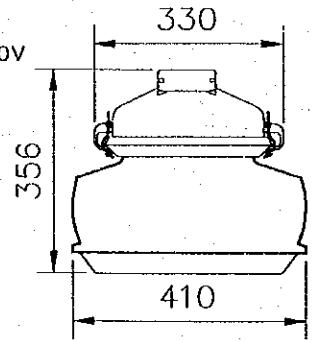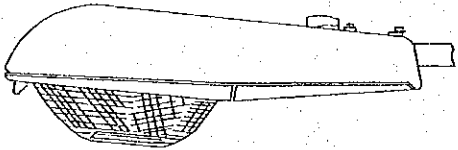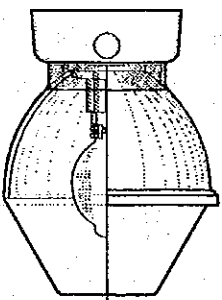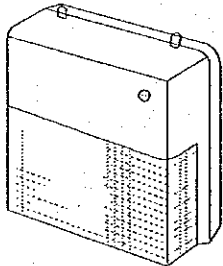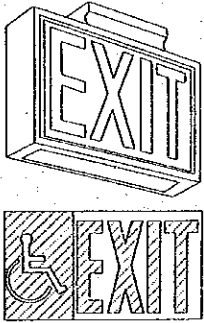A	FL 32Wx3	B	FL 31Wx2	C	FL 26Wx2	D	FL 32W+40W	F	FL 32Wx2
—	—	—	—	—	—	—	—	F1	FL 32Wx4
RECESSED MOUNTING TYPE WITH LOUVER		RECESSED MOUNTING TYPE WITH LOUVER U LAMPS		6" OPEN DOWNLIGHT		ROUND SURFACE MOUNTED		CEILING MOUNTING	
									
G	MH 100W FORWARD WIDE	H	IL 116Wx2	I	FL 32Wx2	L	FL 32Wx4	M	MH 400W 240V
G1	MH 100W HORIZONTAL NARROW	—	—	J	FL 3Wx2 HIGH ABUSE	L1	FL 32Wx3	—	—
RECESSED WALL LIGHT		RED OBSTRUCTION LIGHT		ROUGH SERVICE CORNER MOUNT		CEILING MOUNTING WRAP-AROUND		HIGH BAY PENDANT	
									
N	MH 175W	P	HPS 250W 480V	Q	HPS 400W 240V	R	HPS 150W 120V	X	LED
N1	HPS 150W	—	—	Q1	HPS 1000W 480V	—	—	—	—
BANTAM PENDANT 240V		COBRA HEAD TYPE		HIGH MAST		WALL PACK, WALL MOUNTED		EXIT LIGHT	
									




HPS: HIGH PRESSURE SODIUM


IL: INCANDESCENT

MH: METAL HALIDE

LED: LIGHT EMITTING DIODE

FL: FLUORESCENT

REV. NO.	DATE	COORDINATE	BY	APPROVED	DATE	 JAPAN INTERNATIONAL COOPERATION AGENCY (JICA)  COMISION EJECUTIVA PORTUARIA AUTONOMA (CEPA)		THE DETAILED DESIGN ON PORT REACTIVATION PROJECT IN LA UNION PROVINCE OF THE REPUBLIC OF EL SALVADOR  NIPPON KOEI CO., LTD.		DESIGNED BY : CHECKED BY : APPROVED BY :	SECTION : BUILDING WORK SUB-SECTION : GENERAL TITLE : ELECTRICAL STANDARD DETAILS	DATE : OCTOBER/2002 SCALE : NOT TO SCALE DRAWING NO. : BD-00-008

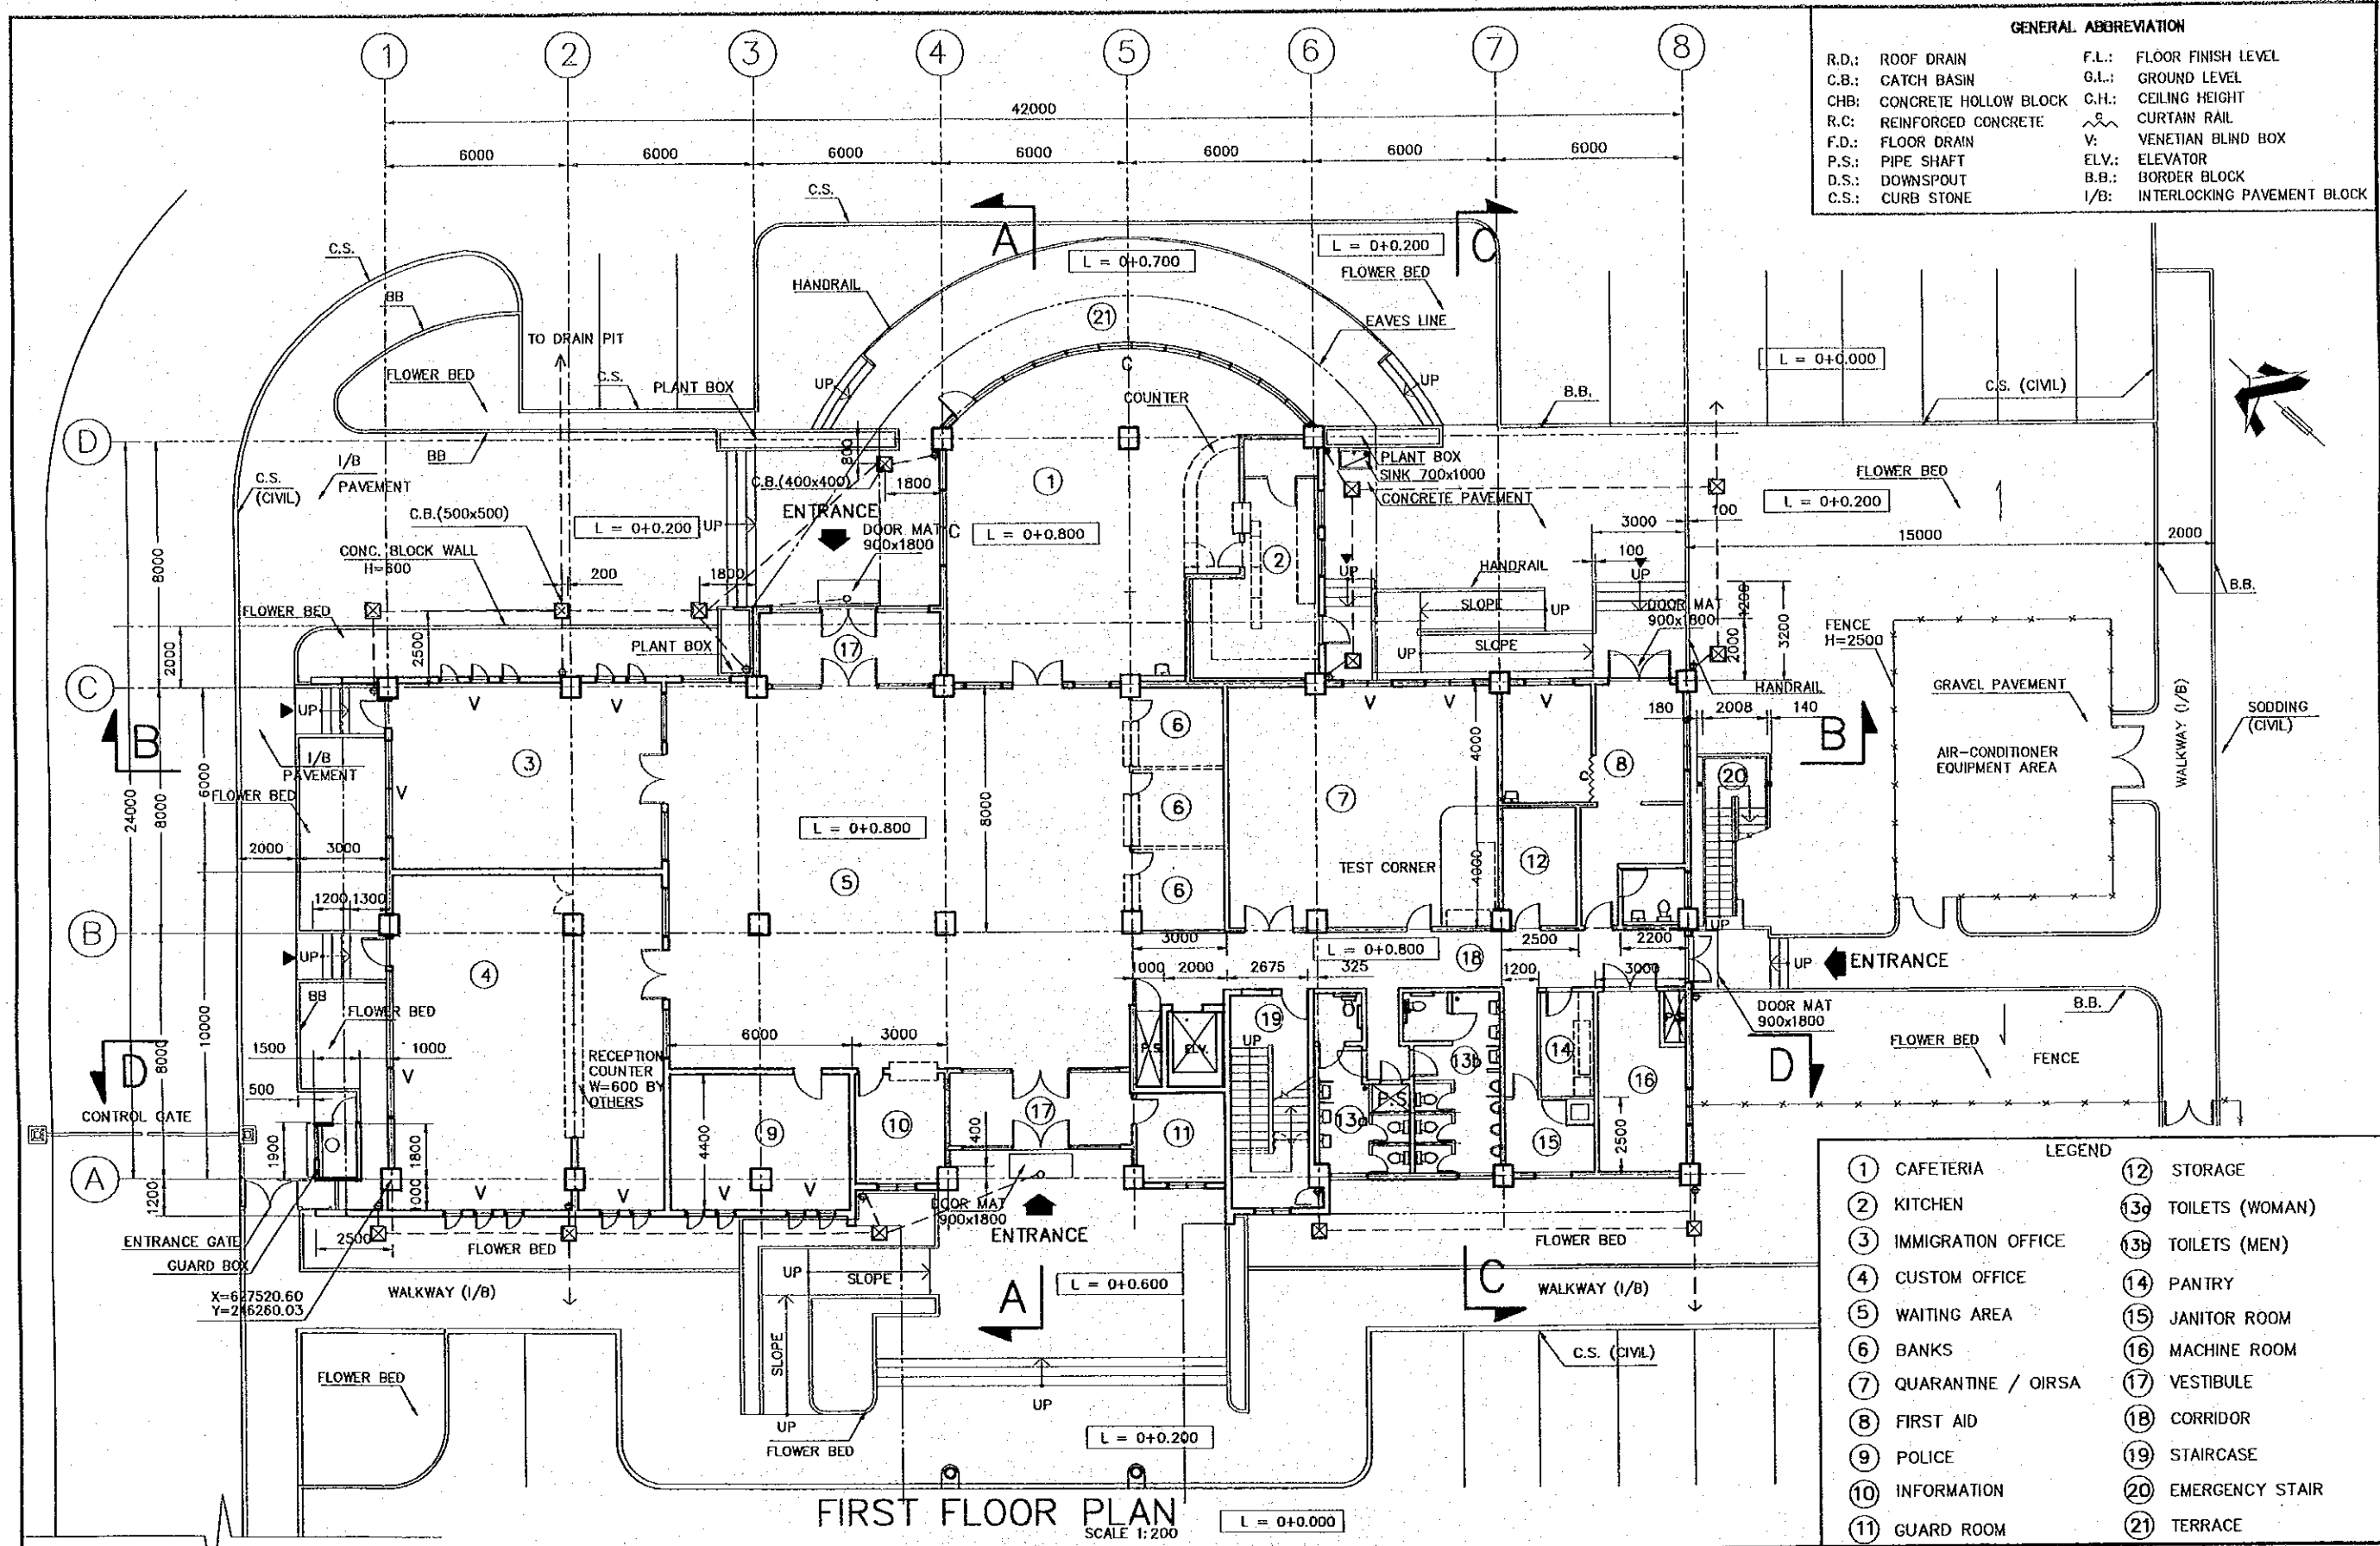

**GENERAL ABBREVIATION**


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C.B.:	CATCH BASIN	G.L.:	GROUND LEVEL
CHB:	CONCRETE HOLLOW BLOCK	C.H.:	CEILING HEIGHT
R.C.:	REINFORCED CONCRETE	CR:	CURTAIN RAIL
F.D.:	FLOOR DRAIN	V.:	VENETIAN BLIND BOX
P.S.:	PIPE SHAFT	ELV.:	ELEVATOR
D.S.:	DOWNSPOUT	B.B.:	BORDER BLOCK
C.S.:	CURB STONE	I/B.:	INTERLOCKING PAVEMENT BLOCK

**LEGEND**

①	CAFETERIA	⑫	STORAGE
②	KITCHEN	⑬	TOILETS (WOMAN)
③	IMMIGRATION OFFICE	⑭	TOILETS (MEN)
④	CUSTOM OFFICE	⑮	PANTRY
⑤	WAITING AREA	⑯	JANITOR ROOM
⑥	BANKS	⑰	MACHINE ROOM
⑦	QUARANTINE / OIRSA	⑱	VESTIBULE
⑧	FIRST AID	⑲	CORRIDOR
⑨	POLICE	⑳	STAIRCASE
⑩	INFORMATION	㉑	EMERGENCY STAIR
⑪	GUARD ROOM		

**FIRST FLOOR PLAN**  
SCALE 1:200

REV. NO.	DATE	COORDINATE	BY	APPROVED	DATE	JAPAN INTERNATIONAL COOPERATION AGENCY (JICA) COMISION EJECUTIVA PORTUARIA AUTONOMA (CEPA)	THE DETAILED DESIGN ON PORT REACTIVATION PROJECT IN LA UNION PROVINCE OF THE REPUBLIC OF EL SALVADOR NIPPON KOEI CO., LTD.	DESIGNED BY :	SECTION :	DATE :
								CHECKED BY :	SUB-SECTION :	OCTOBER/2002
								APPROVED BY :	TITLE :	SCALE :
									<b>BUILDING WORK</b>	1 : 200
									<b>PORT ADMINISTRATION BUILDING</b>	DRAWING NO. :
									<b>FIRST FLOOR PLAN</b>	BD-01-001

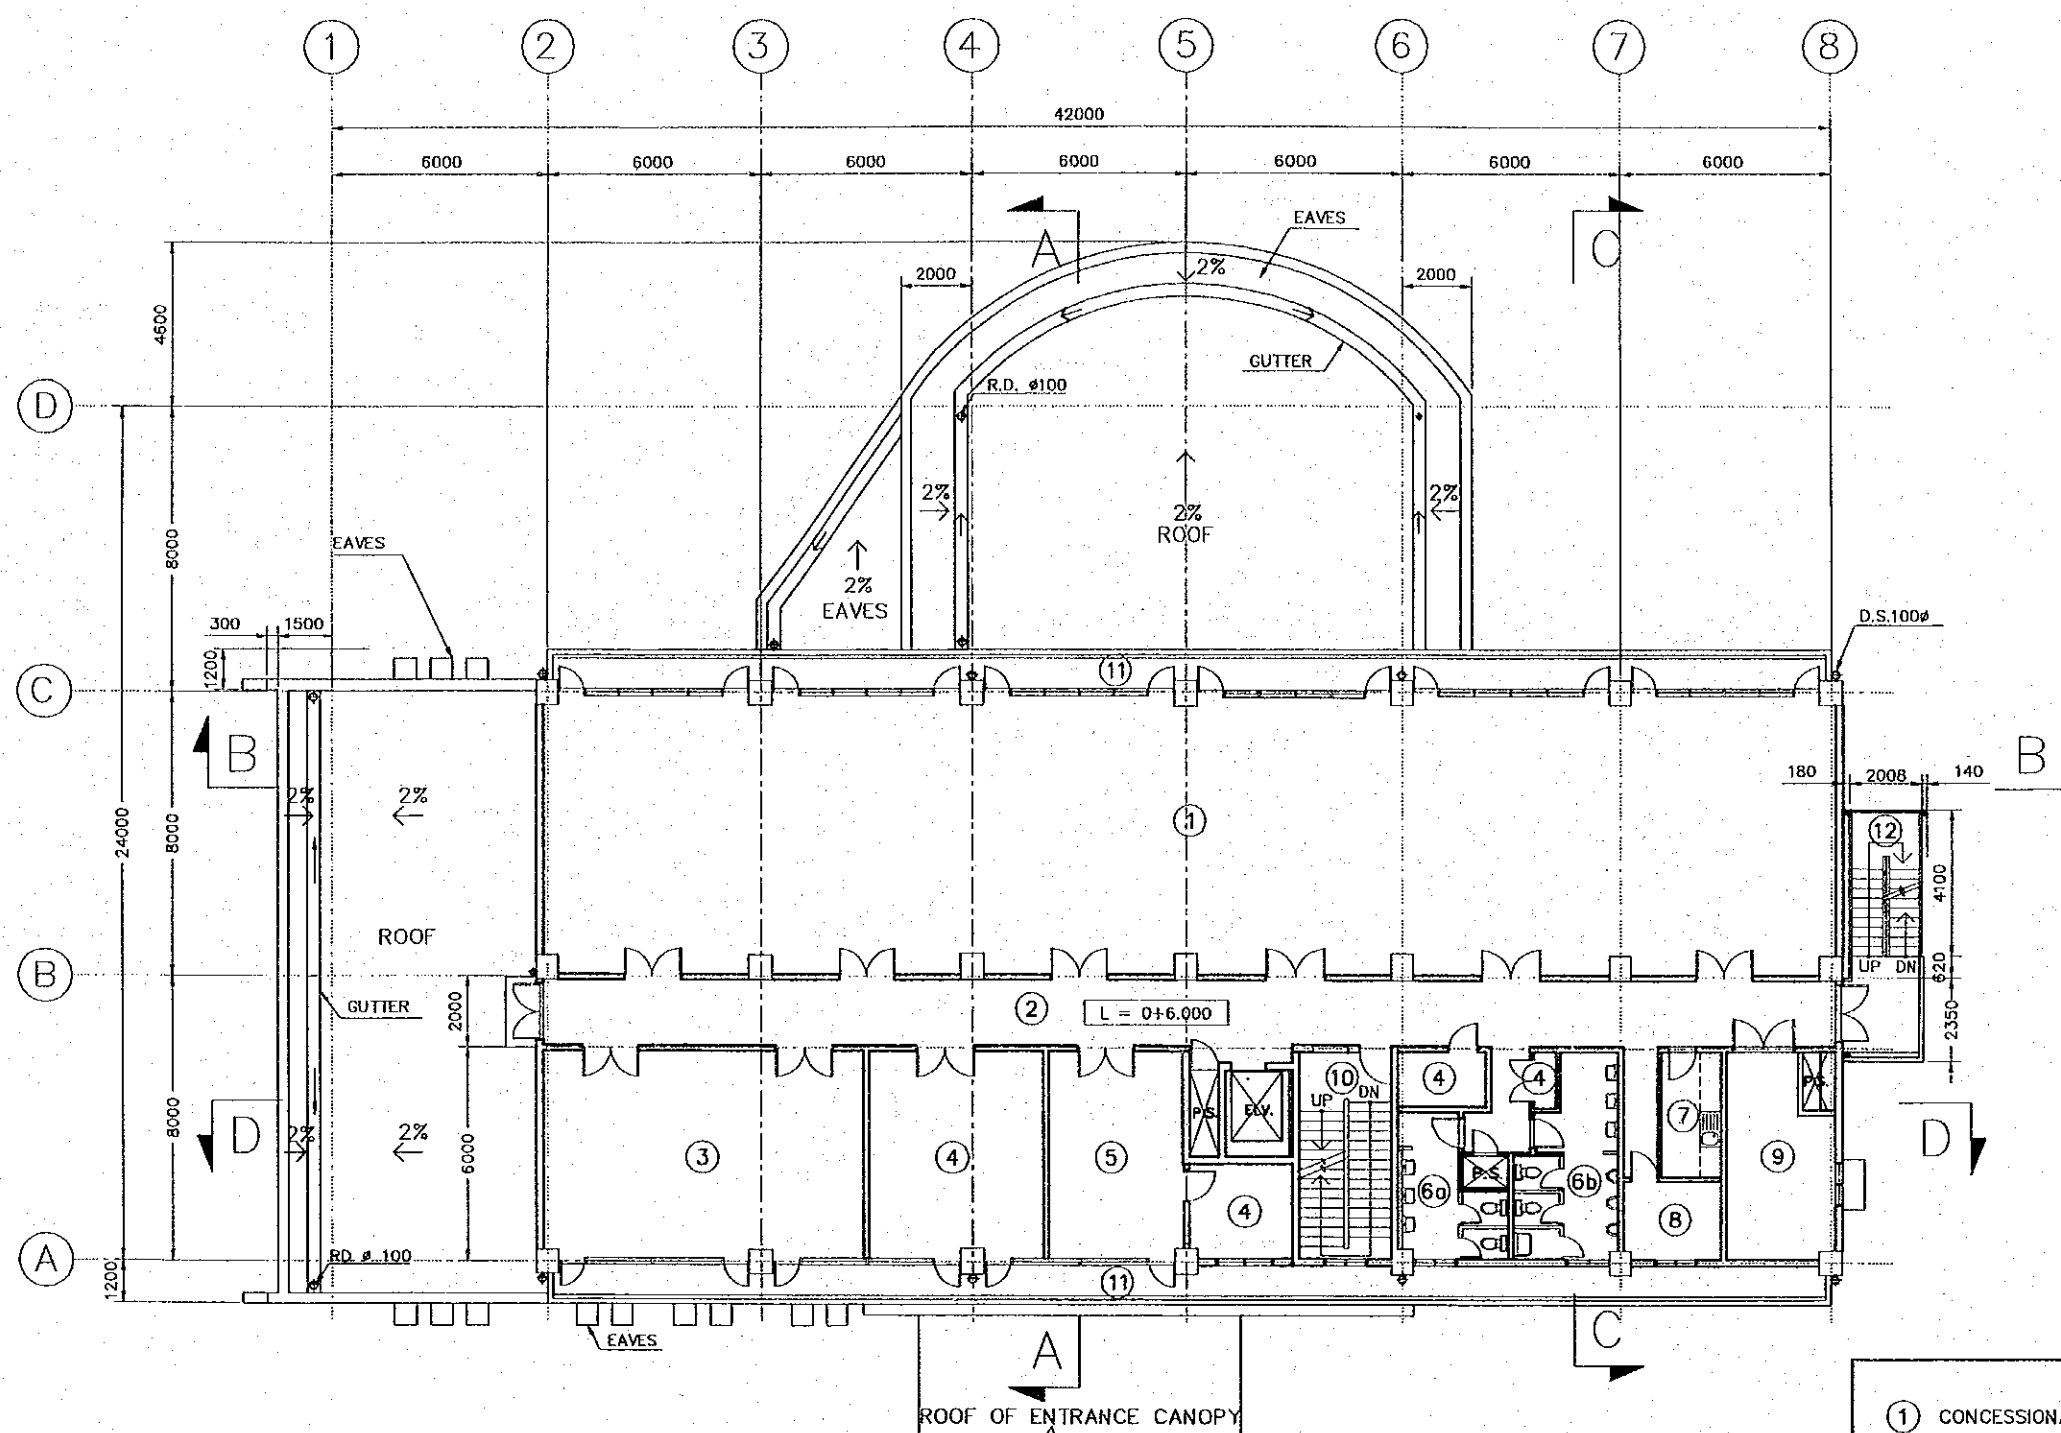


**SECOND FLOOR PLAN**  
SCALE 1:200

LEGEND	
① CONCESSIONAIRE OFFICES	⑦ PANTRY
② CORRIDOR	⑧ JANITOR ROOM
③ SECURITY DIVISION	⑨ MACHINE ROOM
④ STORAGE	⑩ STAIRCASE
⑤ METEOROLOGY	⑪ VERANDAH
⑥a TOILETS (WOMEN)	⑫ EMERGENCY STAIR
⑥b TOILETS (MEN)	

GENERAL ABBREVIATION	
R.D.: ROOF DRAIN	F.L.: FLOOR FINISH LEVEL
C.B.: CATCH BASIN	G.L.: GROUND LEVEL
CHB: CONCRETE HOLLOW BLOCK	C.H.: CEILING HEIGHT
R.C.: REINFORCED CONCRETE	~: CURTAIN RAIL
F.D.: FLOOR DRAIN	V: VENETIAN BLIND BOX
P.S.: PIPE SHAFTS	ELV.: ELEVATOR
D.S.: DOWNSPOUT	

<table border="1"> <thead> <tr> <th>REV. NO.</th> <th>DATE</th> <th>COORDINATE</th> <th>BY</th> <th>APPROVED</th> <th>DATE</th> </tr> </thead> <tbody> <tr><td> </td><td> </td><td> </td><td> </td><td> </td><td> </td></tr> <tr><td> </td><td> </td><td> </td><td> </td><td> </td><td> </td></tr> <tr><td> </td><td> </td><td> </td><td> </td><td> </td><td> </td></tr> </tbody> </table>	REV. NO.	DATE	COORDINATE	BY	APPROVED	DATE																				<p align="center">THE DETAILED DESIGN ON PORT REACTIVATION PROJECT IN LA UNION PROVINCE OF THE REPUBLIC OF EL SALVADOR</p> <p align="center">NIPPON KOEI CO., LTD.</p>	DESIGNED BY : CHECKED BY : APPROVED BY :	SECTION : BUILDING WORK SUB-SECTION : PORT ADMINISTRATION BUILDING TITLE : SECOND FLOOR PLAN	DATE : OCTOBER/2002 SCALE : 1 : 200 DRAWING NO. : 8D-01-002
	REV. NO.	DATE	COORDINATE	BY	APPROVED	DATE																							

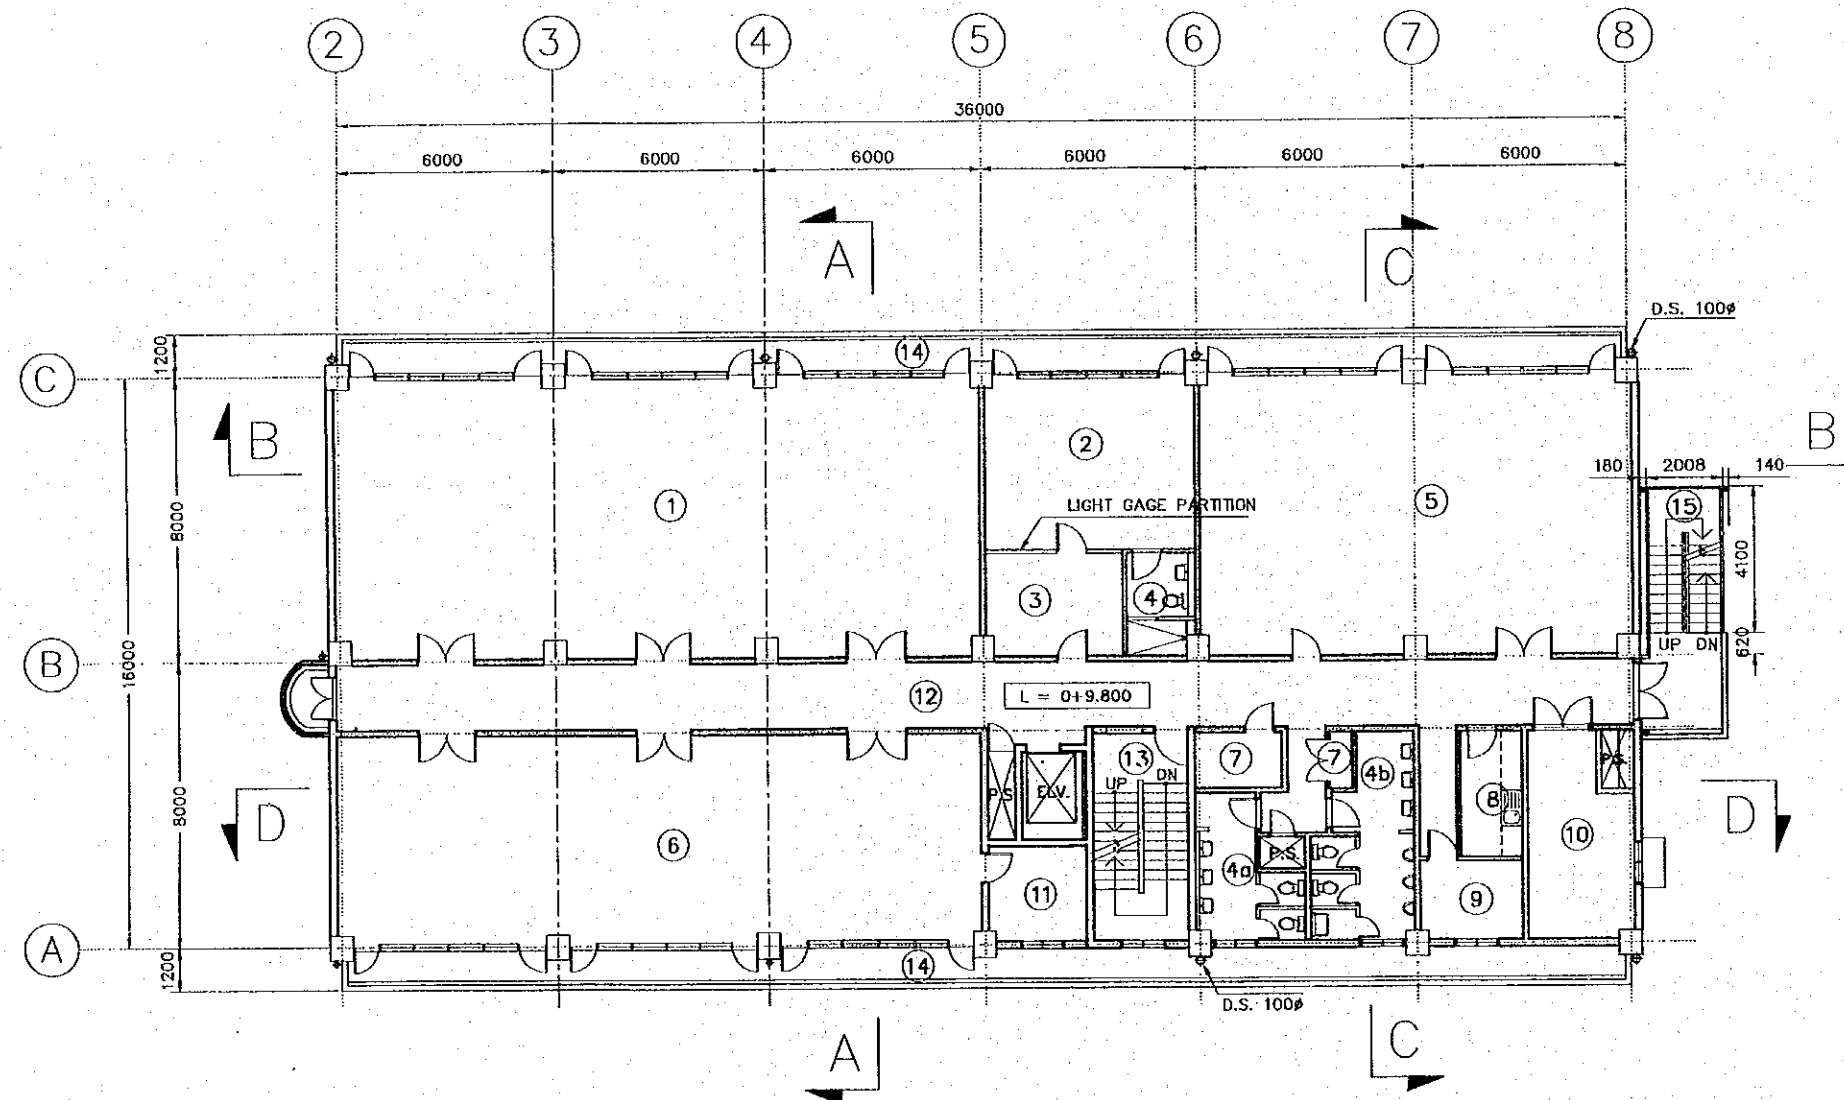

### THIRD FLOOR PLAN

SCALE 1:200

#### LEGEND

- |                          |                   |
|--------------------------|-------------------|
| ① AUDITORIUM             | ⑦ STORAGE         |
| ② MANAGER'S ROOM         | ⑧ PANTRY          |
| ③ SECRETARY              | ⑨ JANITOR         |
| ④ LAVATORY               | ⑩ MACHINE ROOM    |
| ④a TOILETS (WOMAN)       | ⑪ TELEPHONE ROOM  |
| ④b TOILETS (MEN)         | ⑫ CORRIDOR        |
| ⑤ ADMINISTRATION OFFICES | ⑬ STAIRCASE       |
| ⑥ MAINTENANCE DEPT.      | ⑭ VERANDAH        |
|                          | ⑮ EMERGENCY STAIR |

#### GENERAL ABBREVIATION

- R.D.: ROOF DRAIN
- C.B.: CATCH BASIN
- CHB: CONCRETE HOLLOW BLOCK
- R.C: REINFORCED CONCRETE
- F.D.: FLOOR DRAIN
- P.S.: PIPE SHAFT
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- ~: CURTAIN RAIL
- V: VENETIAN BLIND BOX
- ELV.: ELEVATOR

REV. NO.	DATE	COORDINATE	BY	APPROVED	DATE




JAPAN INTERNATIONAL COOPERATION AGENCY (JICA)  
COMISION EJECUTIVA PORTUARIA AUTONOMA (CEPA)

THE DETAILED DESIGN ON PORT REACTIVATION PROJECT IN LA UNION PROVINCE OF THE REPUBLIC OF EL SALVADOR  
NIPPON KOEI CO., LTD.

DESIGNED BY:  
CHECKED BY:  
APPROVED BY:

SECTION : BUILDING WORK  
SUB-SECTION : PORT ADMINISTRATION BUILDING  
TITLE : THIRD FLOOR PLAN

DATE : OCTOBER/2002  
SCALE : 1 : 200  
DRAWING NO: BD-01-003

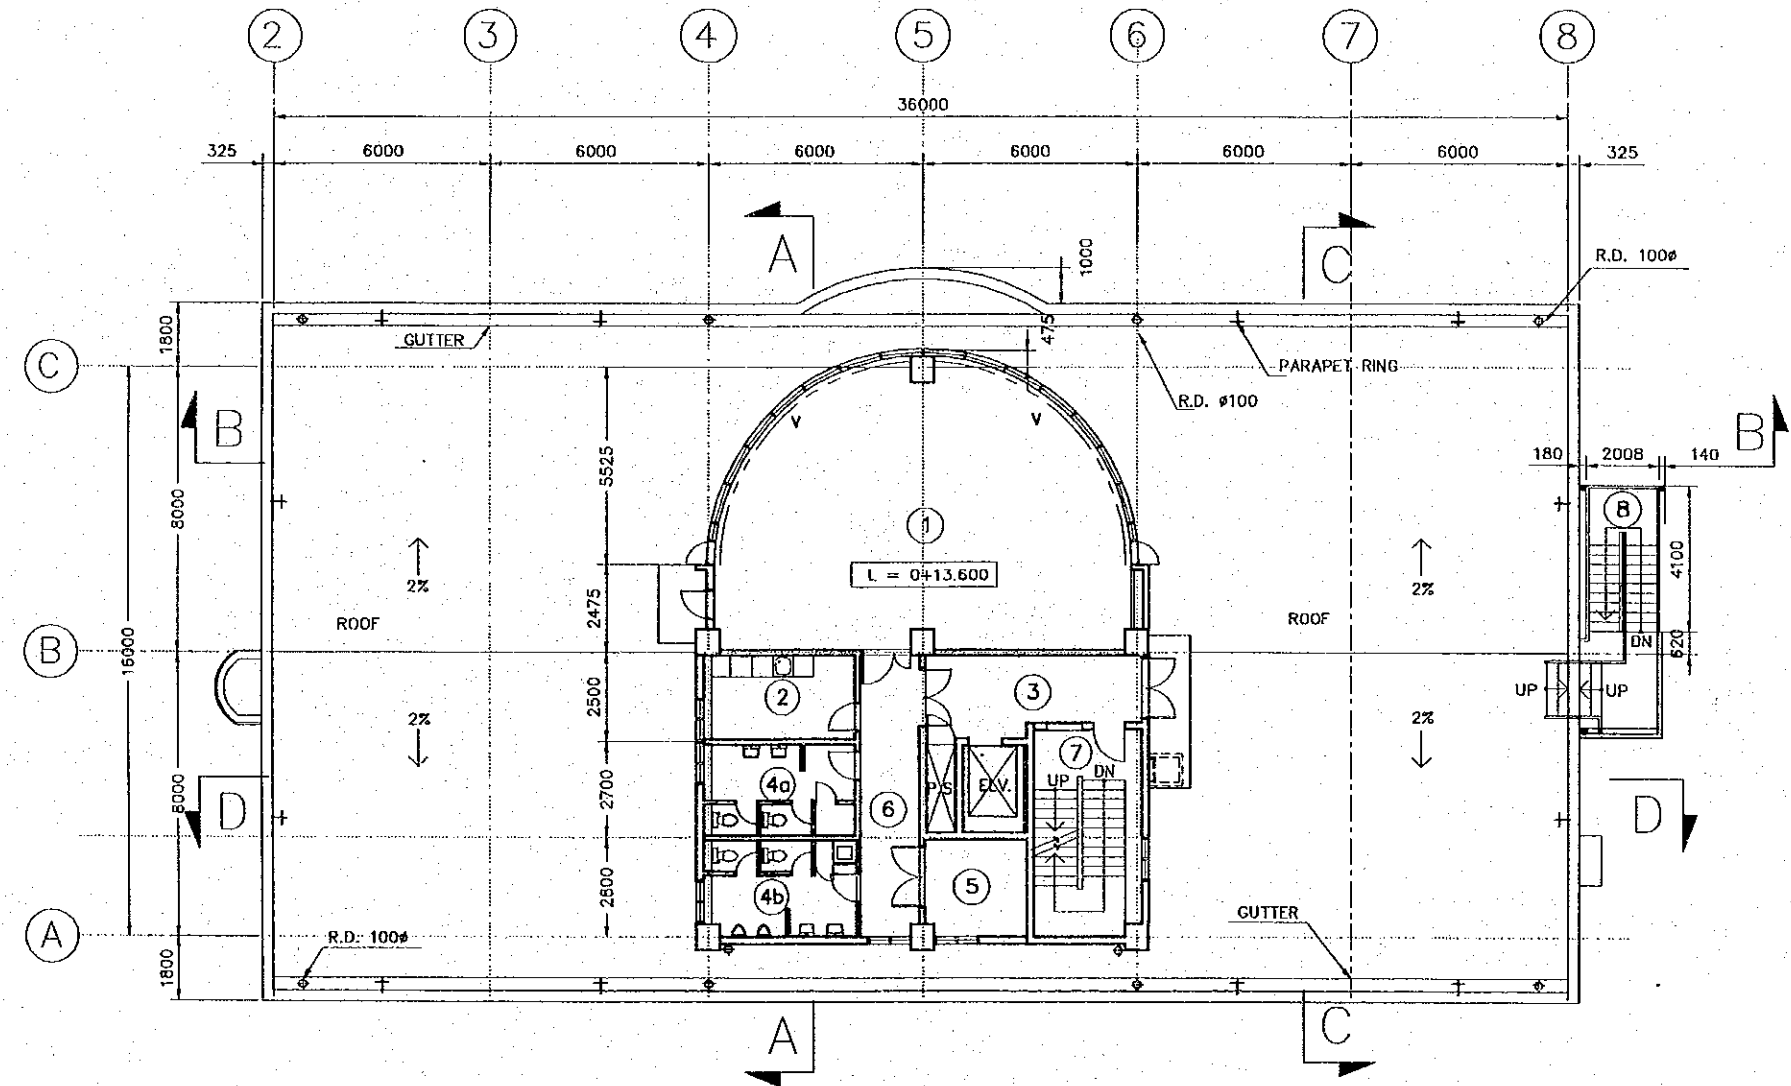

**4TH FLOOR PLAN**  
SCALE 1:200


**GENERAL ABBREVIATION**

R.D.:	ROOF DRAIN
C.B.:	CATCH BASIN
CHB:	CONCRETE HOLLOW BLOCK
R.C.:	REINFORCED CONCRETE
F.D.:	FLOOR DRAIN
P.S.:	PIPE SHAFT
D.S.:	DOWNSPOUT
F.L.:	FLOOR FINISH LEVEL
G.L.:	GROUND LEVEL
C.H.:	CEILING HEIGHT
~~~	CURTAIN RAIL
V:	VENETIAN BLIND BOX
ELV.:	ELEVATOR


**LEGEND**

①	MEETING ROOM
②	PANTRY
③	HALL
④a	TOILET (WOMEN)
④b	TOILET (MEN)
⑤	MACHINE ROOM
⑥	CORRIDOR
⑦	STAIRCASE
⑧	EMERGENCY STAIR


REV. NO.	DATE	COORDINATE	BY	APPROVED	DATE	JAPAN INTERNATIONAL COOPERATION AGENCY (JICA) COMISION EJECUTIVA PORTUARIA AUTONOMA (CEPA)	THE DETAILED DESIGN ON PORT REACTIVATION PROJECT IN LA UNION PROVINCE OF THE REPUBLIC OF EL SALVADOR NIPPON KOEI CO., LTD.	DESIGNED BY :	SECTION : BUILDING WORK SUB-SECTION : PORT ADMINISTRATION BUILDING TITLE : FOURTH FLOOR PLAN	DATE : OCTOBER/2002
								CHECKED BY :		SCALE : 1 : 200
								APPROVED BY :	DRAWING NO. : BD-01-004	

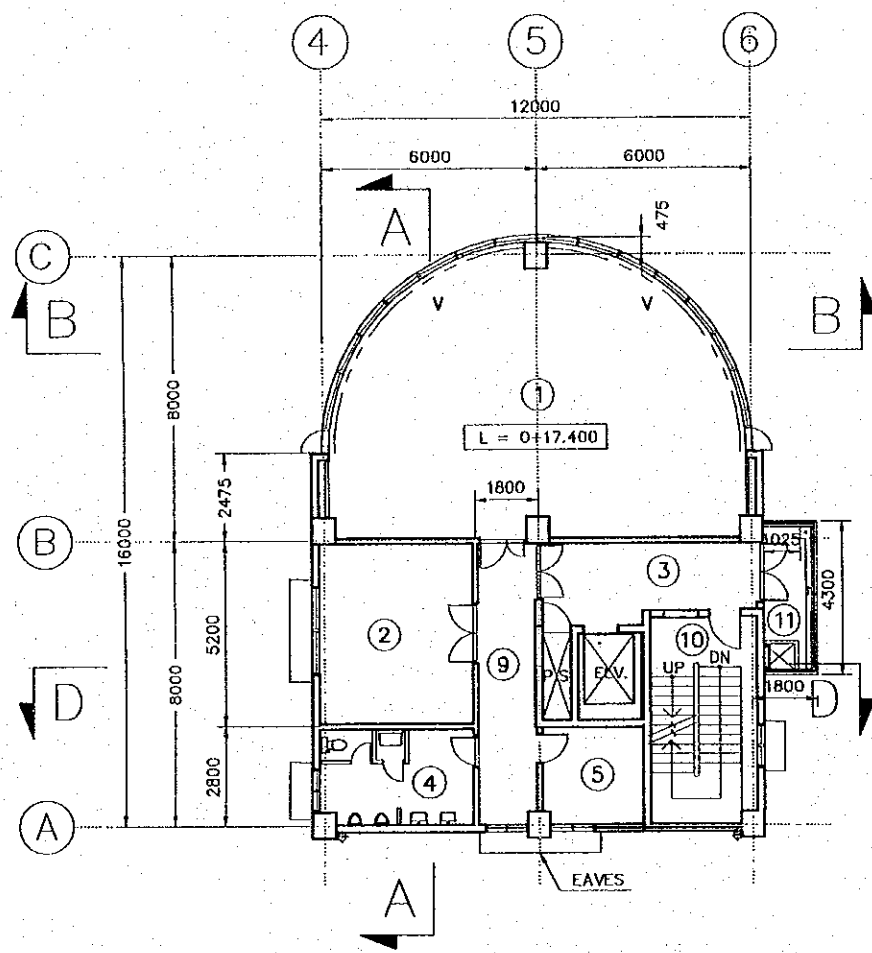

5TH FLOOR PLAN  
SCALE 1:200

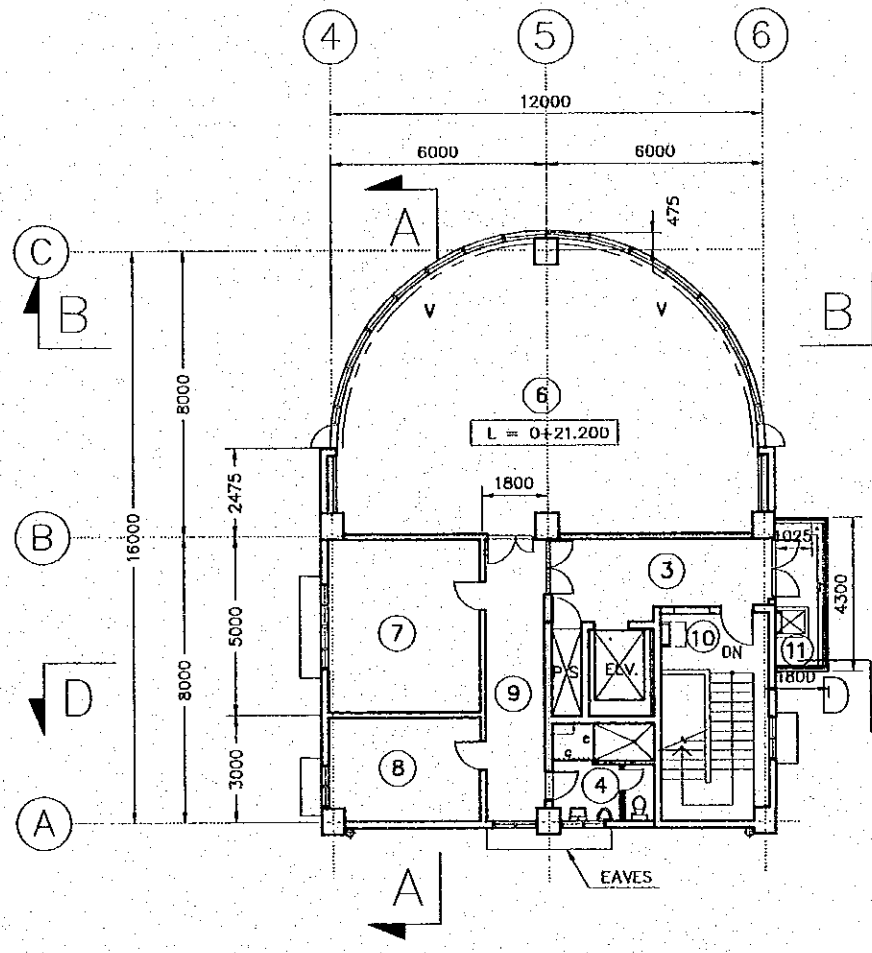

6TH FLOOR PLAN  
SCALE 1:200

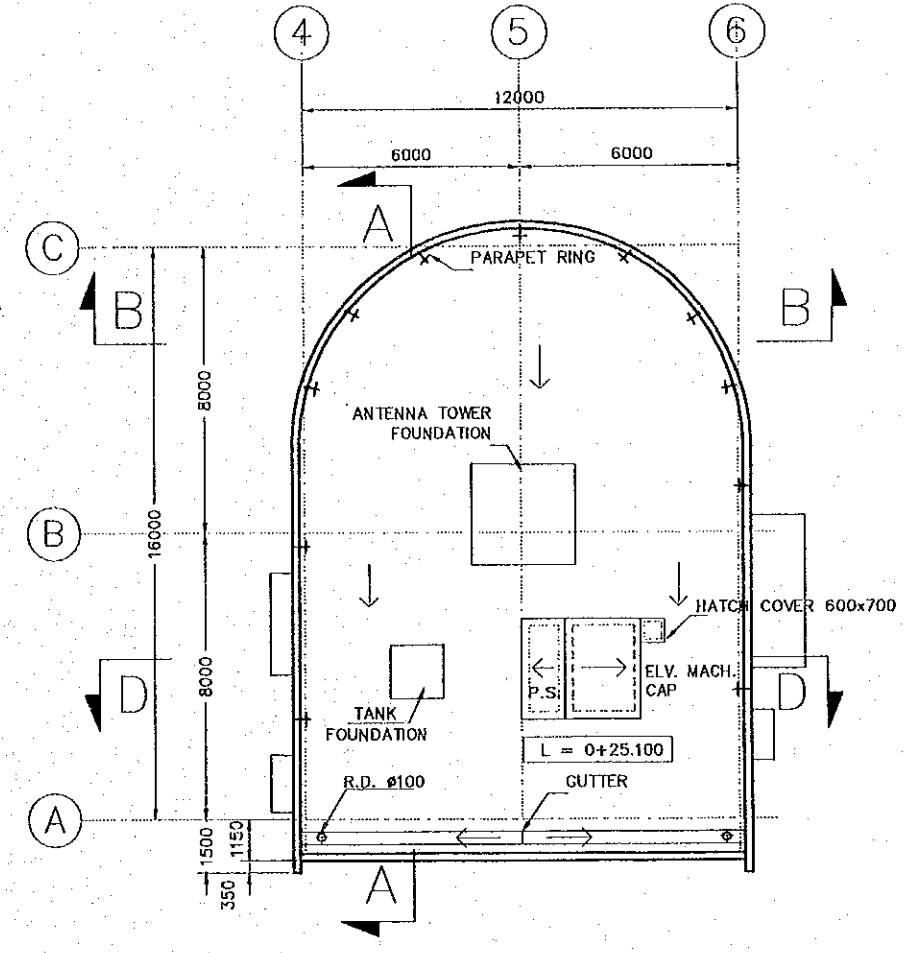

ROOF PLAN  
SCALE 1:200

**GENERAL ABBREVIATION**

R.D.:	ROOF DRAIN
C.B.:	CATCH BASIN
CHB:	CONCRETE HOLLOW BLOCK
R.C.:	REINFORCED CONCRETE
F.D.:	FLOOR DRAIN
P.S.:	PIPE SHAFT
D.S.:	DOWNSPOUT
F.L.:	FLOOR FINISH LEVEL
G.L.:	GROUND LEVEL
C.H.:	CEILING HEIGHT
~~	CURTAIN RAIL
V:	VENETIAN BLIND BOX
ELV.:	ELEVATOR

**LEGEND**

①	YARD CONTROLLER ROOM	⑦	HARBOR MASTER ROOM
②	STACK ROOM	⑧	BEDROOM
③	HALL	⑨	CORRIDOR
④	TOILET	⑩	STAIRCASE
⑤	MULTI PURPOSE ROOM	⑪	VERANDAH
⑥	NAVIGATION CONTROLLER ROOM		

REV. NO.	DATE	COORDINATE	BY	APPROVED	DATE

**JICA**  
JAPAN INTERNATIONAL COOPERATION AGENCY (JICA)

**CEPA**  
COMISION EJECUTIVA PORTUARIA AUTONOMA (CEPA)


THE DETAILED DESIGN ON PORT REACTIVATION PROJECT IN LA UNION PROVINCE OF THE REPUBLIC OF EL SALVADOR

**NK** NIPPON KOEI CO., LTD.

DESIGNED BY :	
CHECKED BY :	
APPROVED BY :	




SECTION :	BUILDING WORK
SUB-SECTION :	PORT ADMINISTRATION BUILDING
TITLE :	5th., 6th, AND ROOF FLOOR PLANS

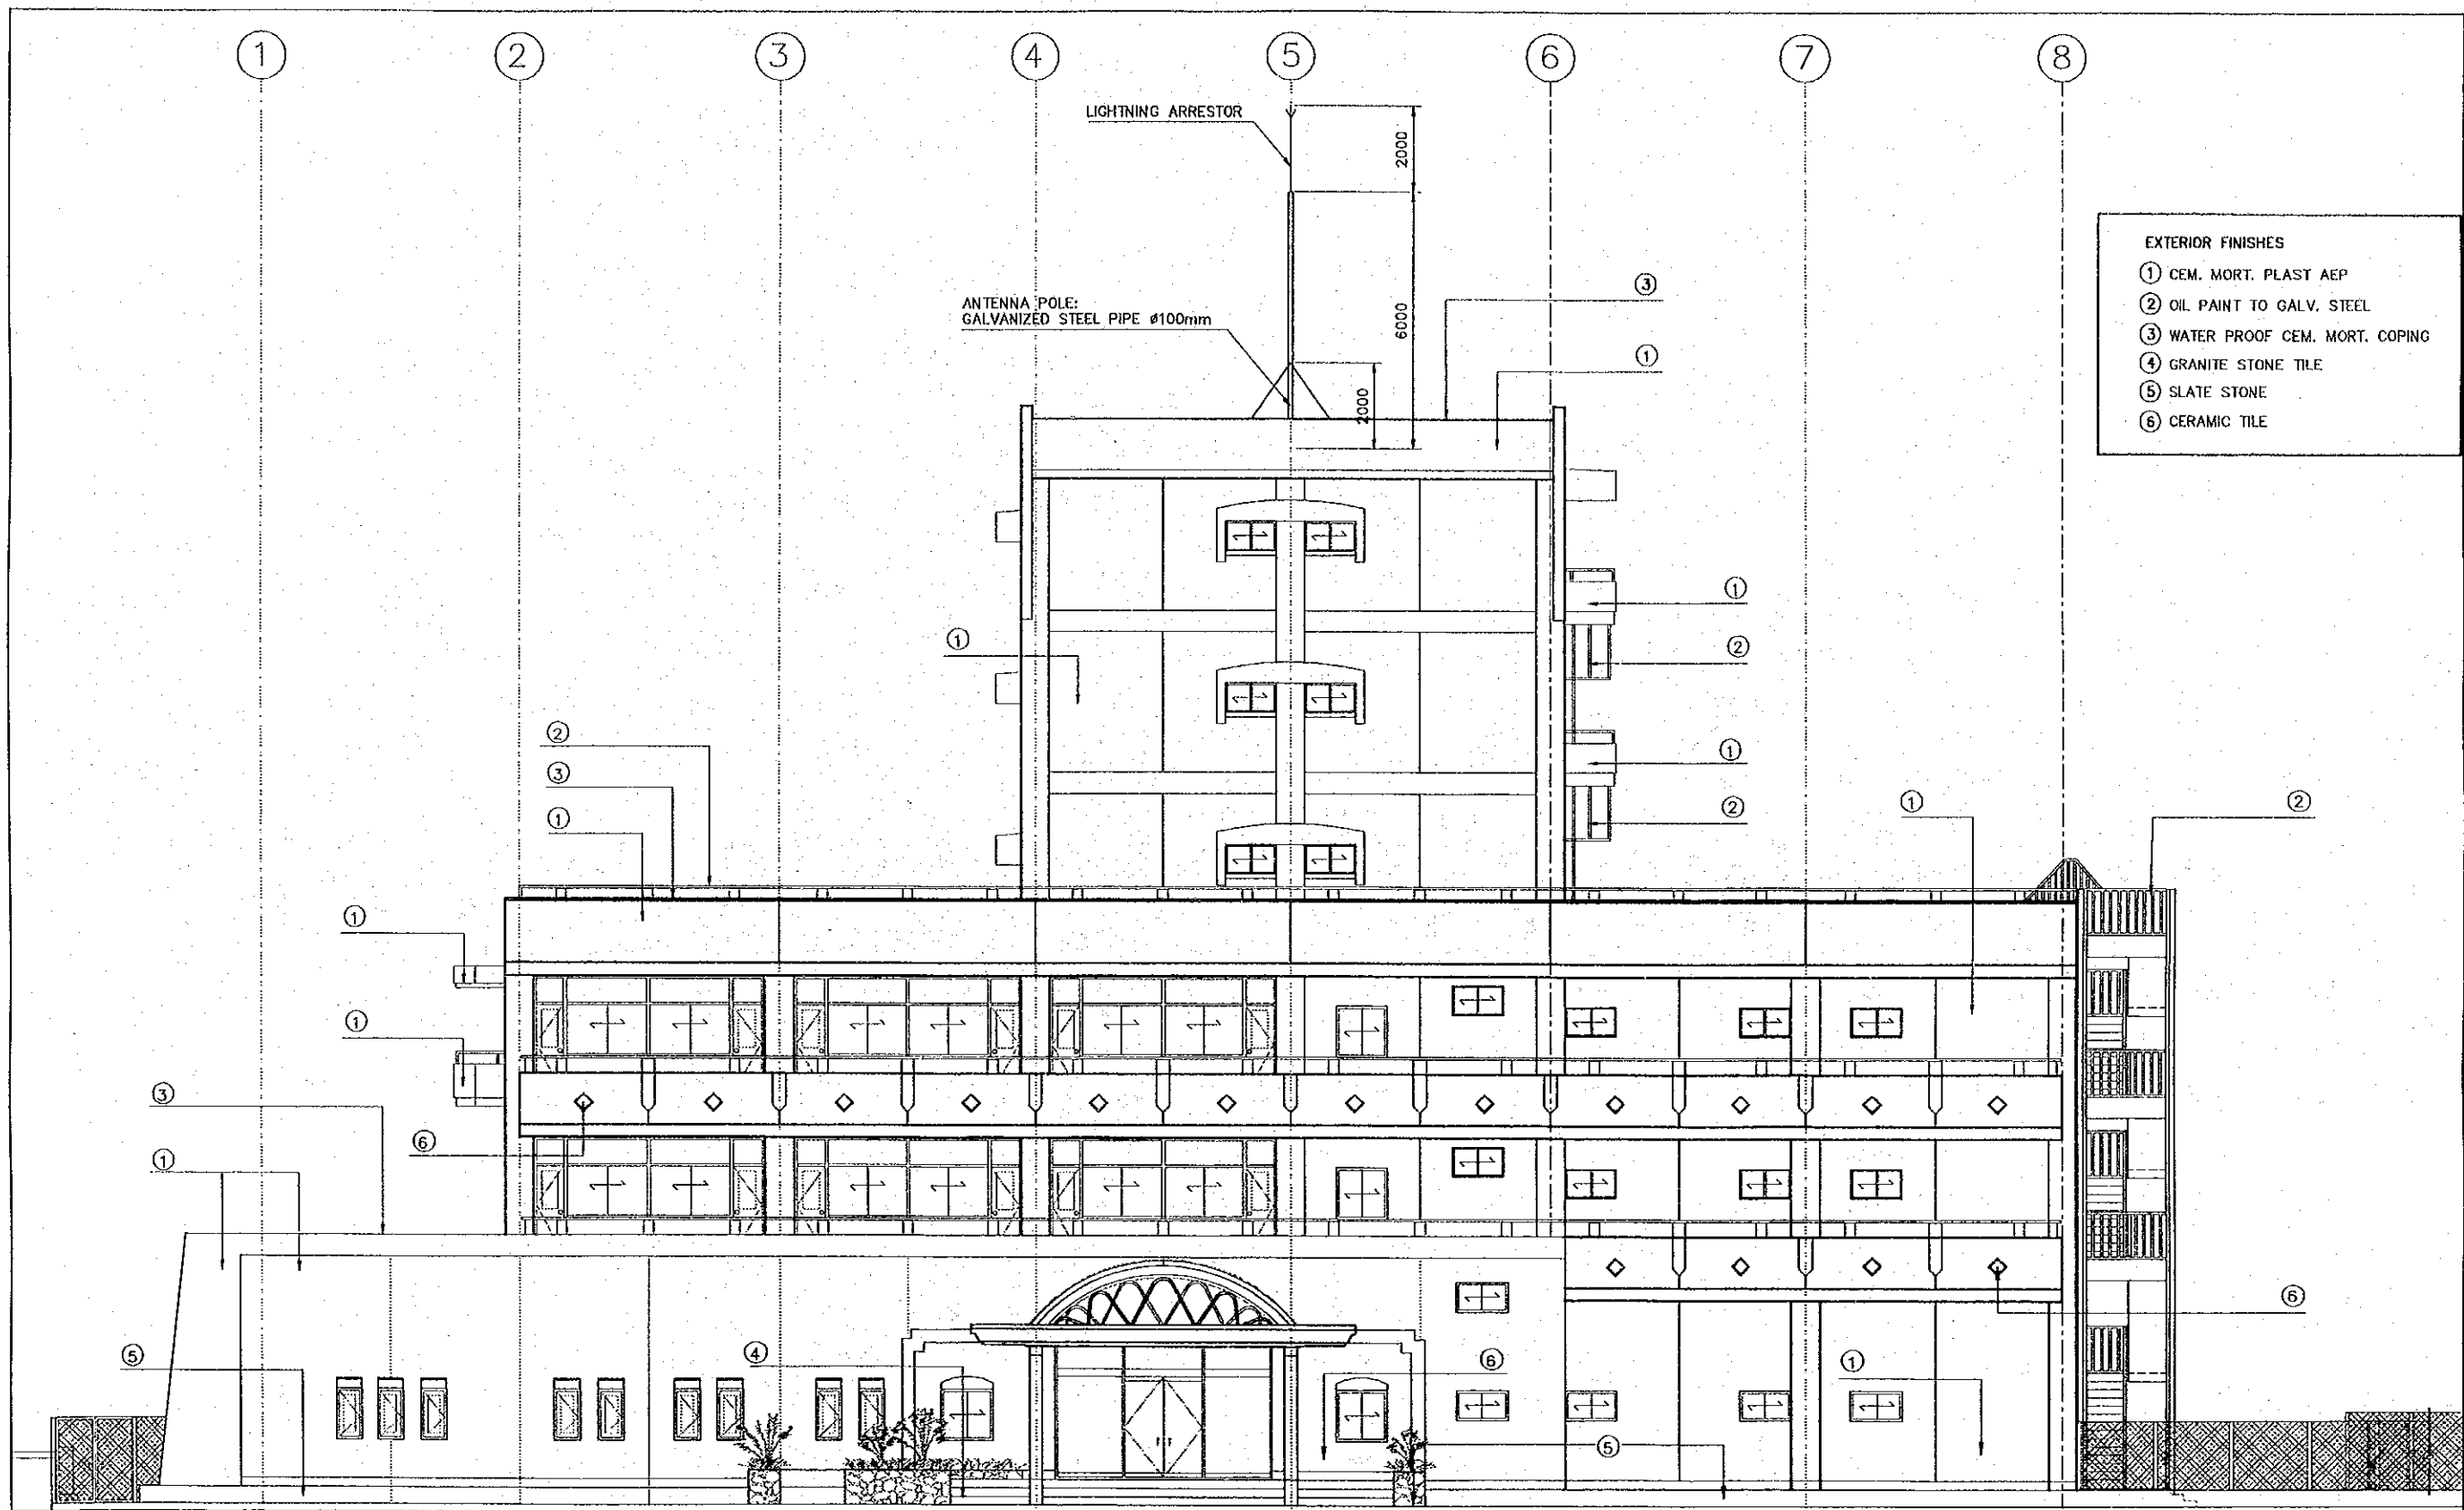
DATE :	OCTOBER/2002
SCALE :	1 : 200
DRAWING NO.:	BD-01-005



- EXTERIOR FINISHES
- ① CEM. MORT. PLAST AEP
  - ② OIL PAINT TO GALV. STEEL
  - ③ WATER PROOF CEM. MORT. COPING
  - ④ GRANITE STONE TILE
  - ⑤ SLATE STONE
  - ⑥ CERAMIC TILE

SOUTHWEST ELEVATION  
SCALE 1:150

REV. NO.	DATE	COORDINATE	BY	APPROVED	DATE	 <b>JAPAN INTERNATIONAL COOPERATION AGENCY (JICA)</b>	 <b>COMISION EJECUTIVA PORTUARIA AUTONOMA (CEPA)</b>	 <b>NIPPON KOEI CO., LTD.</b>	DESIGNED BY :	SECTION :	DATE :
									CHECKED BY :	SUB-SECTION :	OCTOBER/2002
									APPROVED BY :	TITLE :	SCALE :
										<b>BUILDING WORK</b>	1 : 150
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										<b>SOUTHWEST ELEVATION</b>	BD-01-006

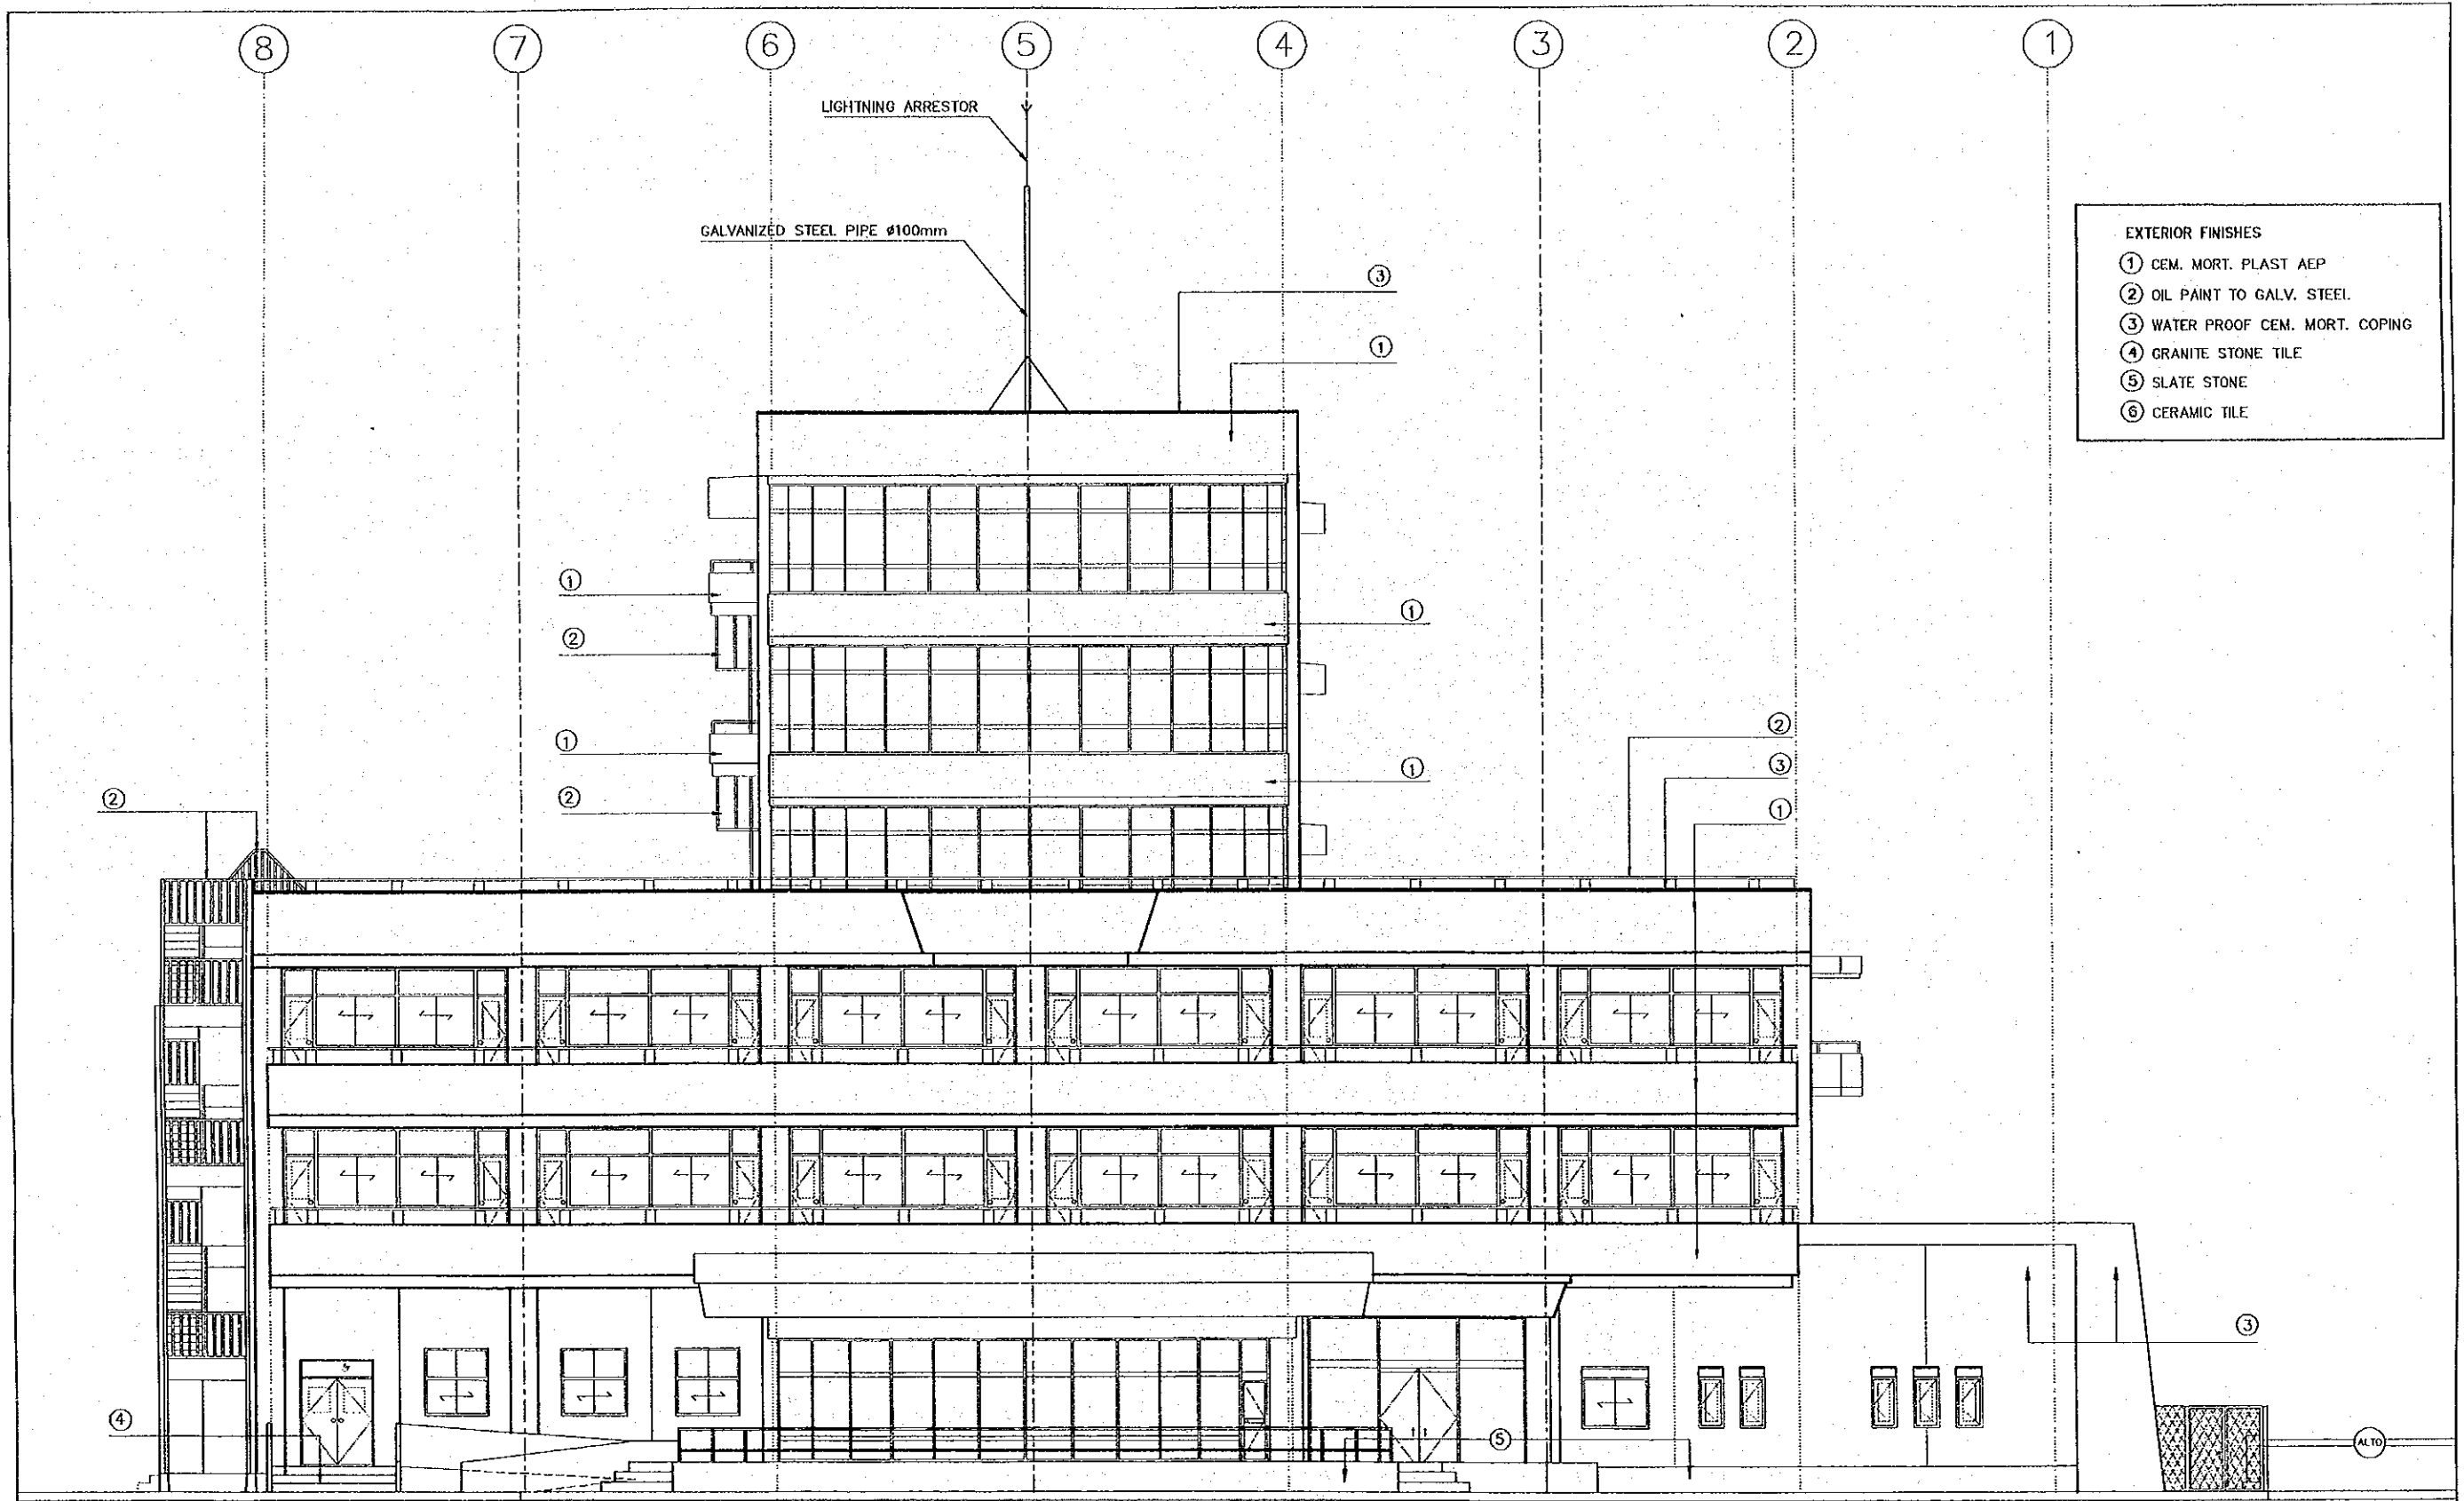


- EXTERIOR FINISHES**
- ① CEM. MORT. PLAST AEP
  - ② OIL PAINT TO GALV. STEEL.
  - ③ WATER PROOF CEM. MORT. COPING
  - ④ GRANITE STONE TILE
  - ⑤ SLATE STONE
  - ⑥ CERAMIC TILE

**NORTHEAST ELEVATION**  
SCALE 1:150

REV. NO. DATE	COORDINATE	BY	APPROVED	DATE	JICA JAPAN INTERNATIONAL COOPERATION AGENCY (JICA)	COMISION EJECUTIVA PORTUARIA AUTONOMA (CEPA)	THE DETAILED DESIGN ON PORT REACTIVATION PROJECT IN LA UNION PROVINCE OF THE REPUBLIC OF EL SALVADOR NIPPON KOEI CO., LTD.	DESIGNED BY :	SECTION : BUILDING WORK	DATE : OCTOBER/2002	
								CHECKED BY :			SUB-SECTION : PORT ADMINISTRATION BUILDING
								APPROVED BY :			TITLE : NORTHEAST ELEVATION
											DRAWING NO. : BD-01-007



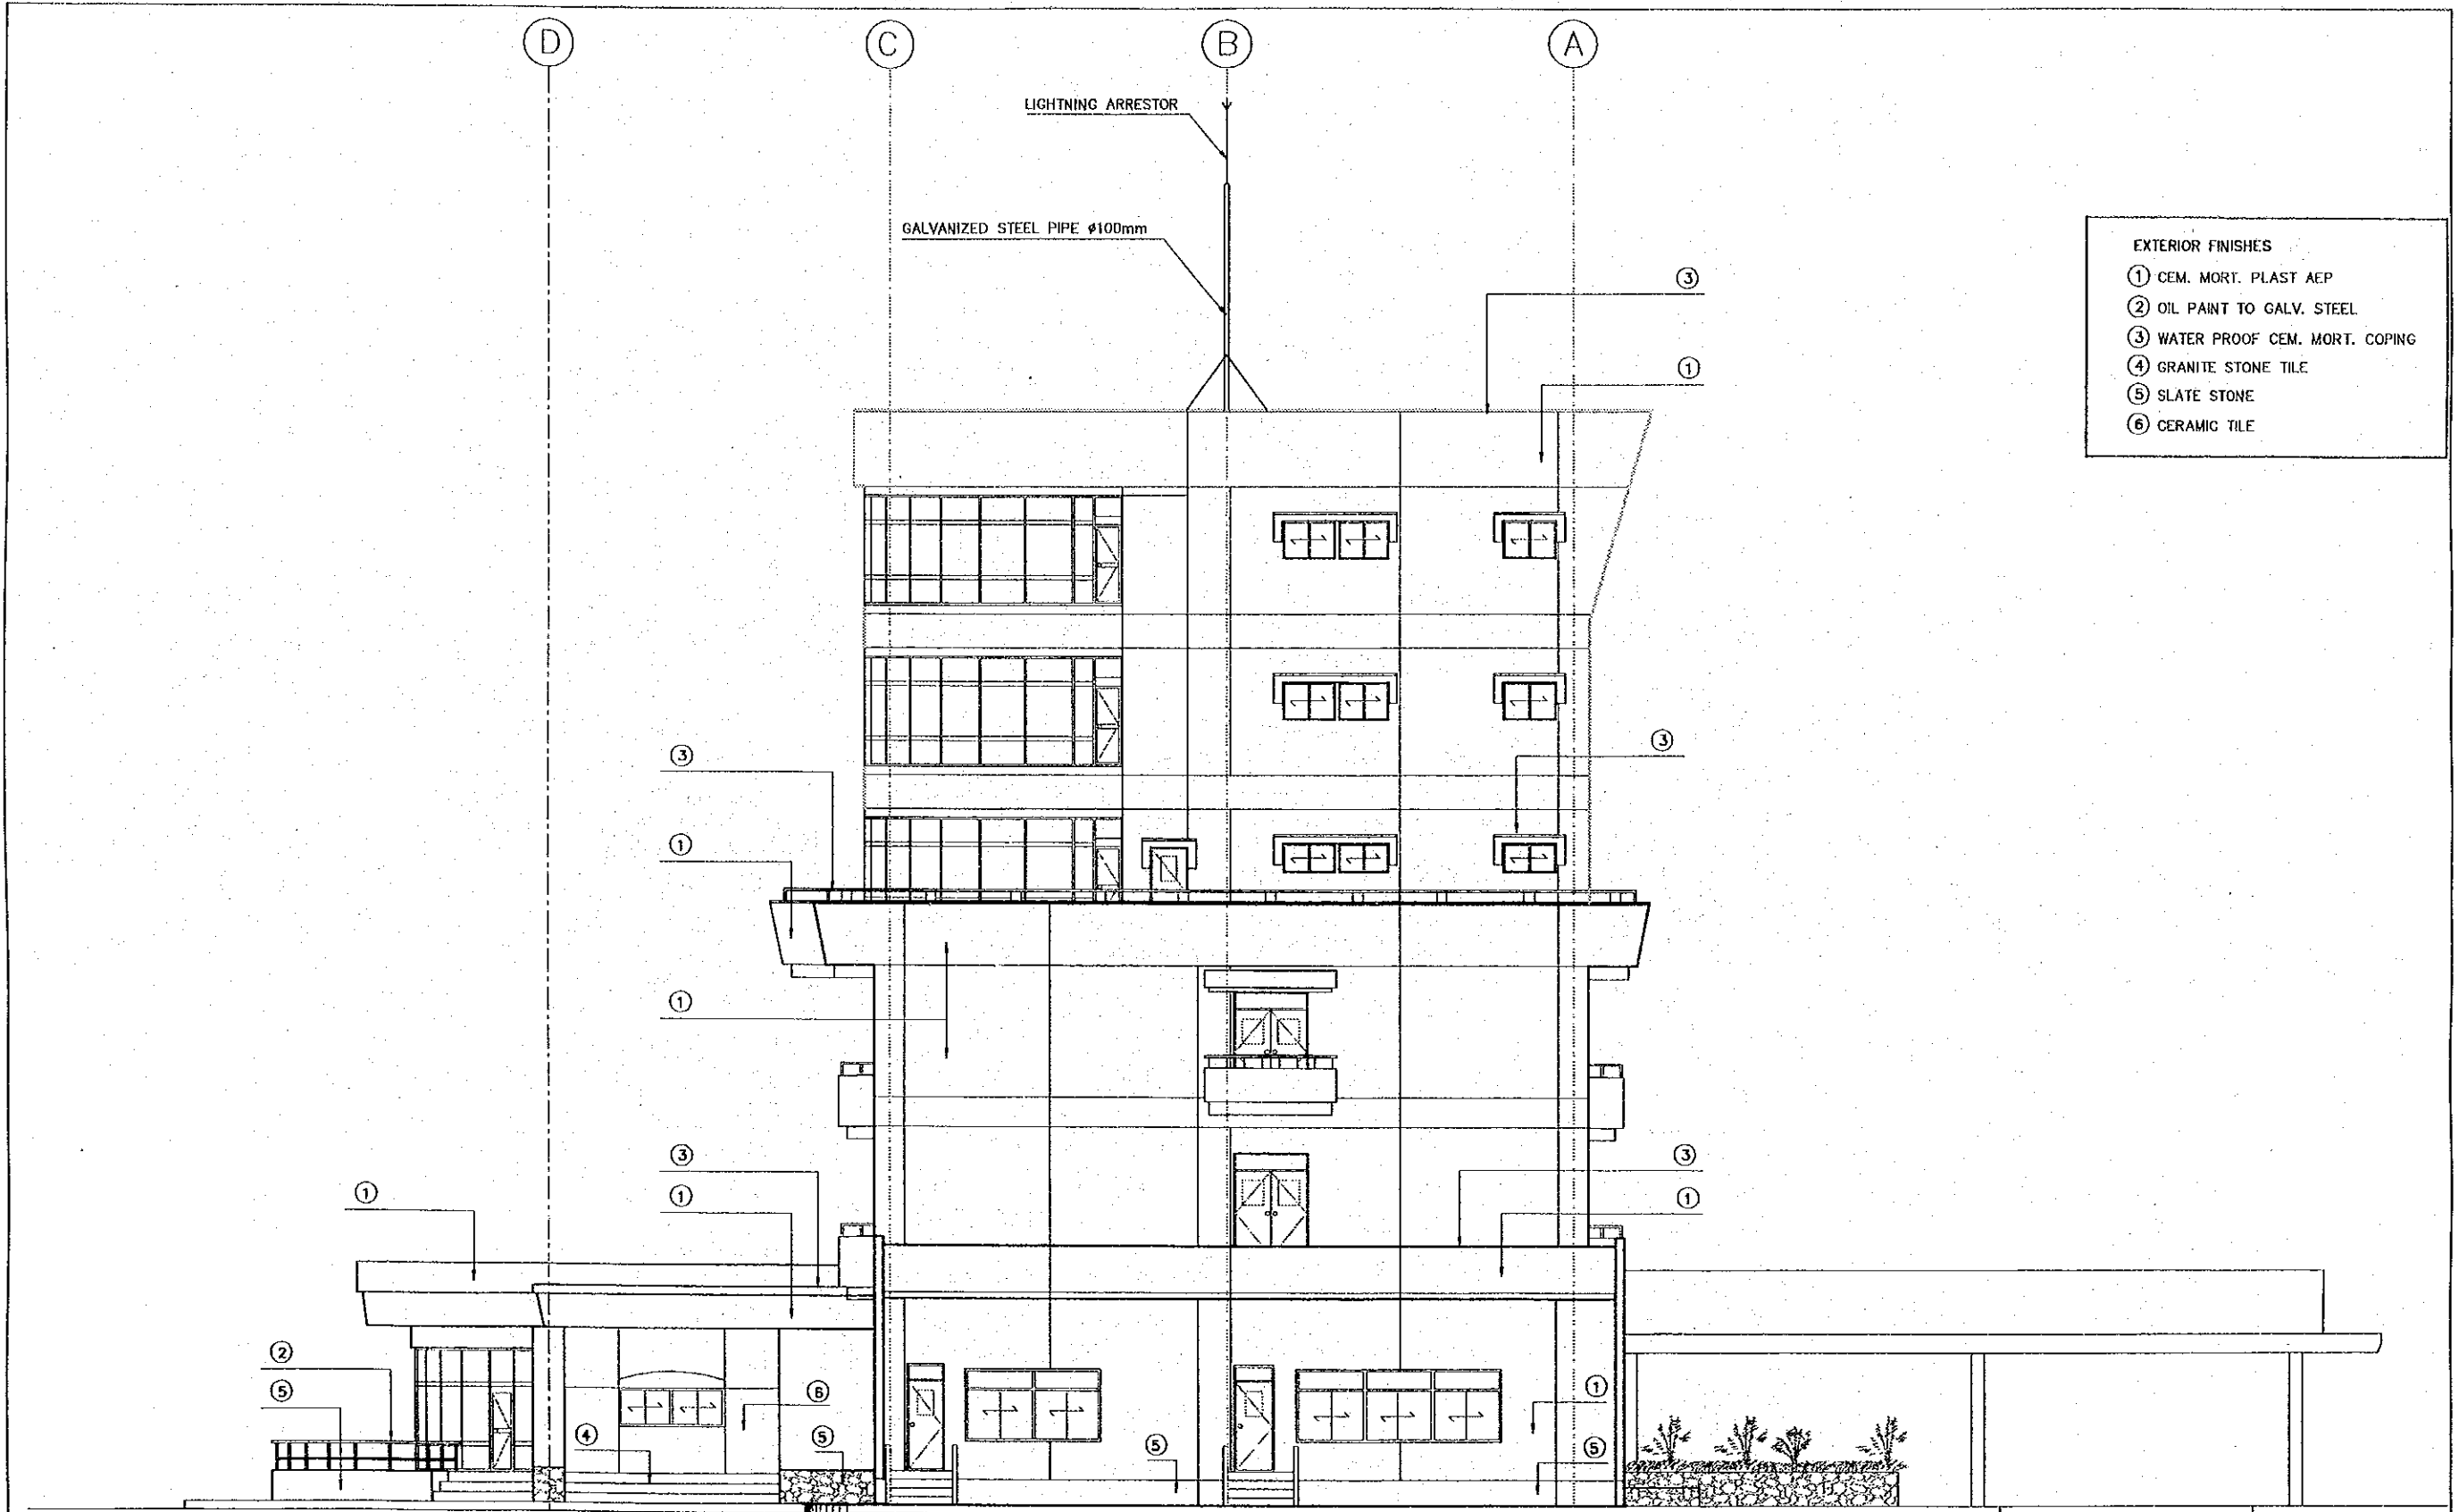


- EXTERIOR FINISHES
- ① CEM. MORT. PLAST AEP
  - ② OIL PAINT TO GALV. STEEL
  - ③ WATER PROOF CEM. MORT. COPING
  - ④ GRANITE STONE TILE
  - ⑤ SLATE STONE
  - ⑥ CERAMIC TILE




NORTHWEST ELEVATION


SCALE 1:150

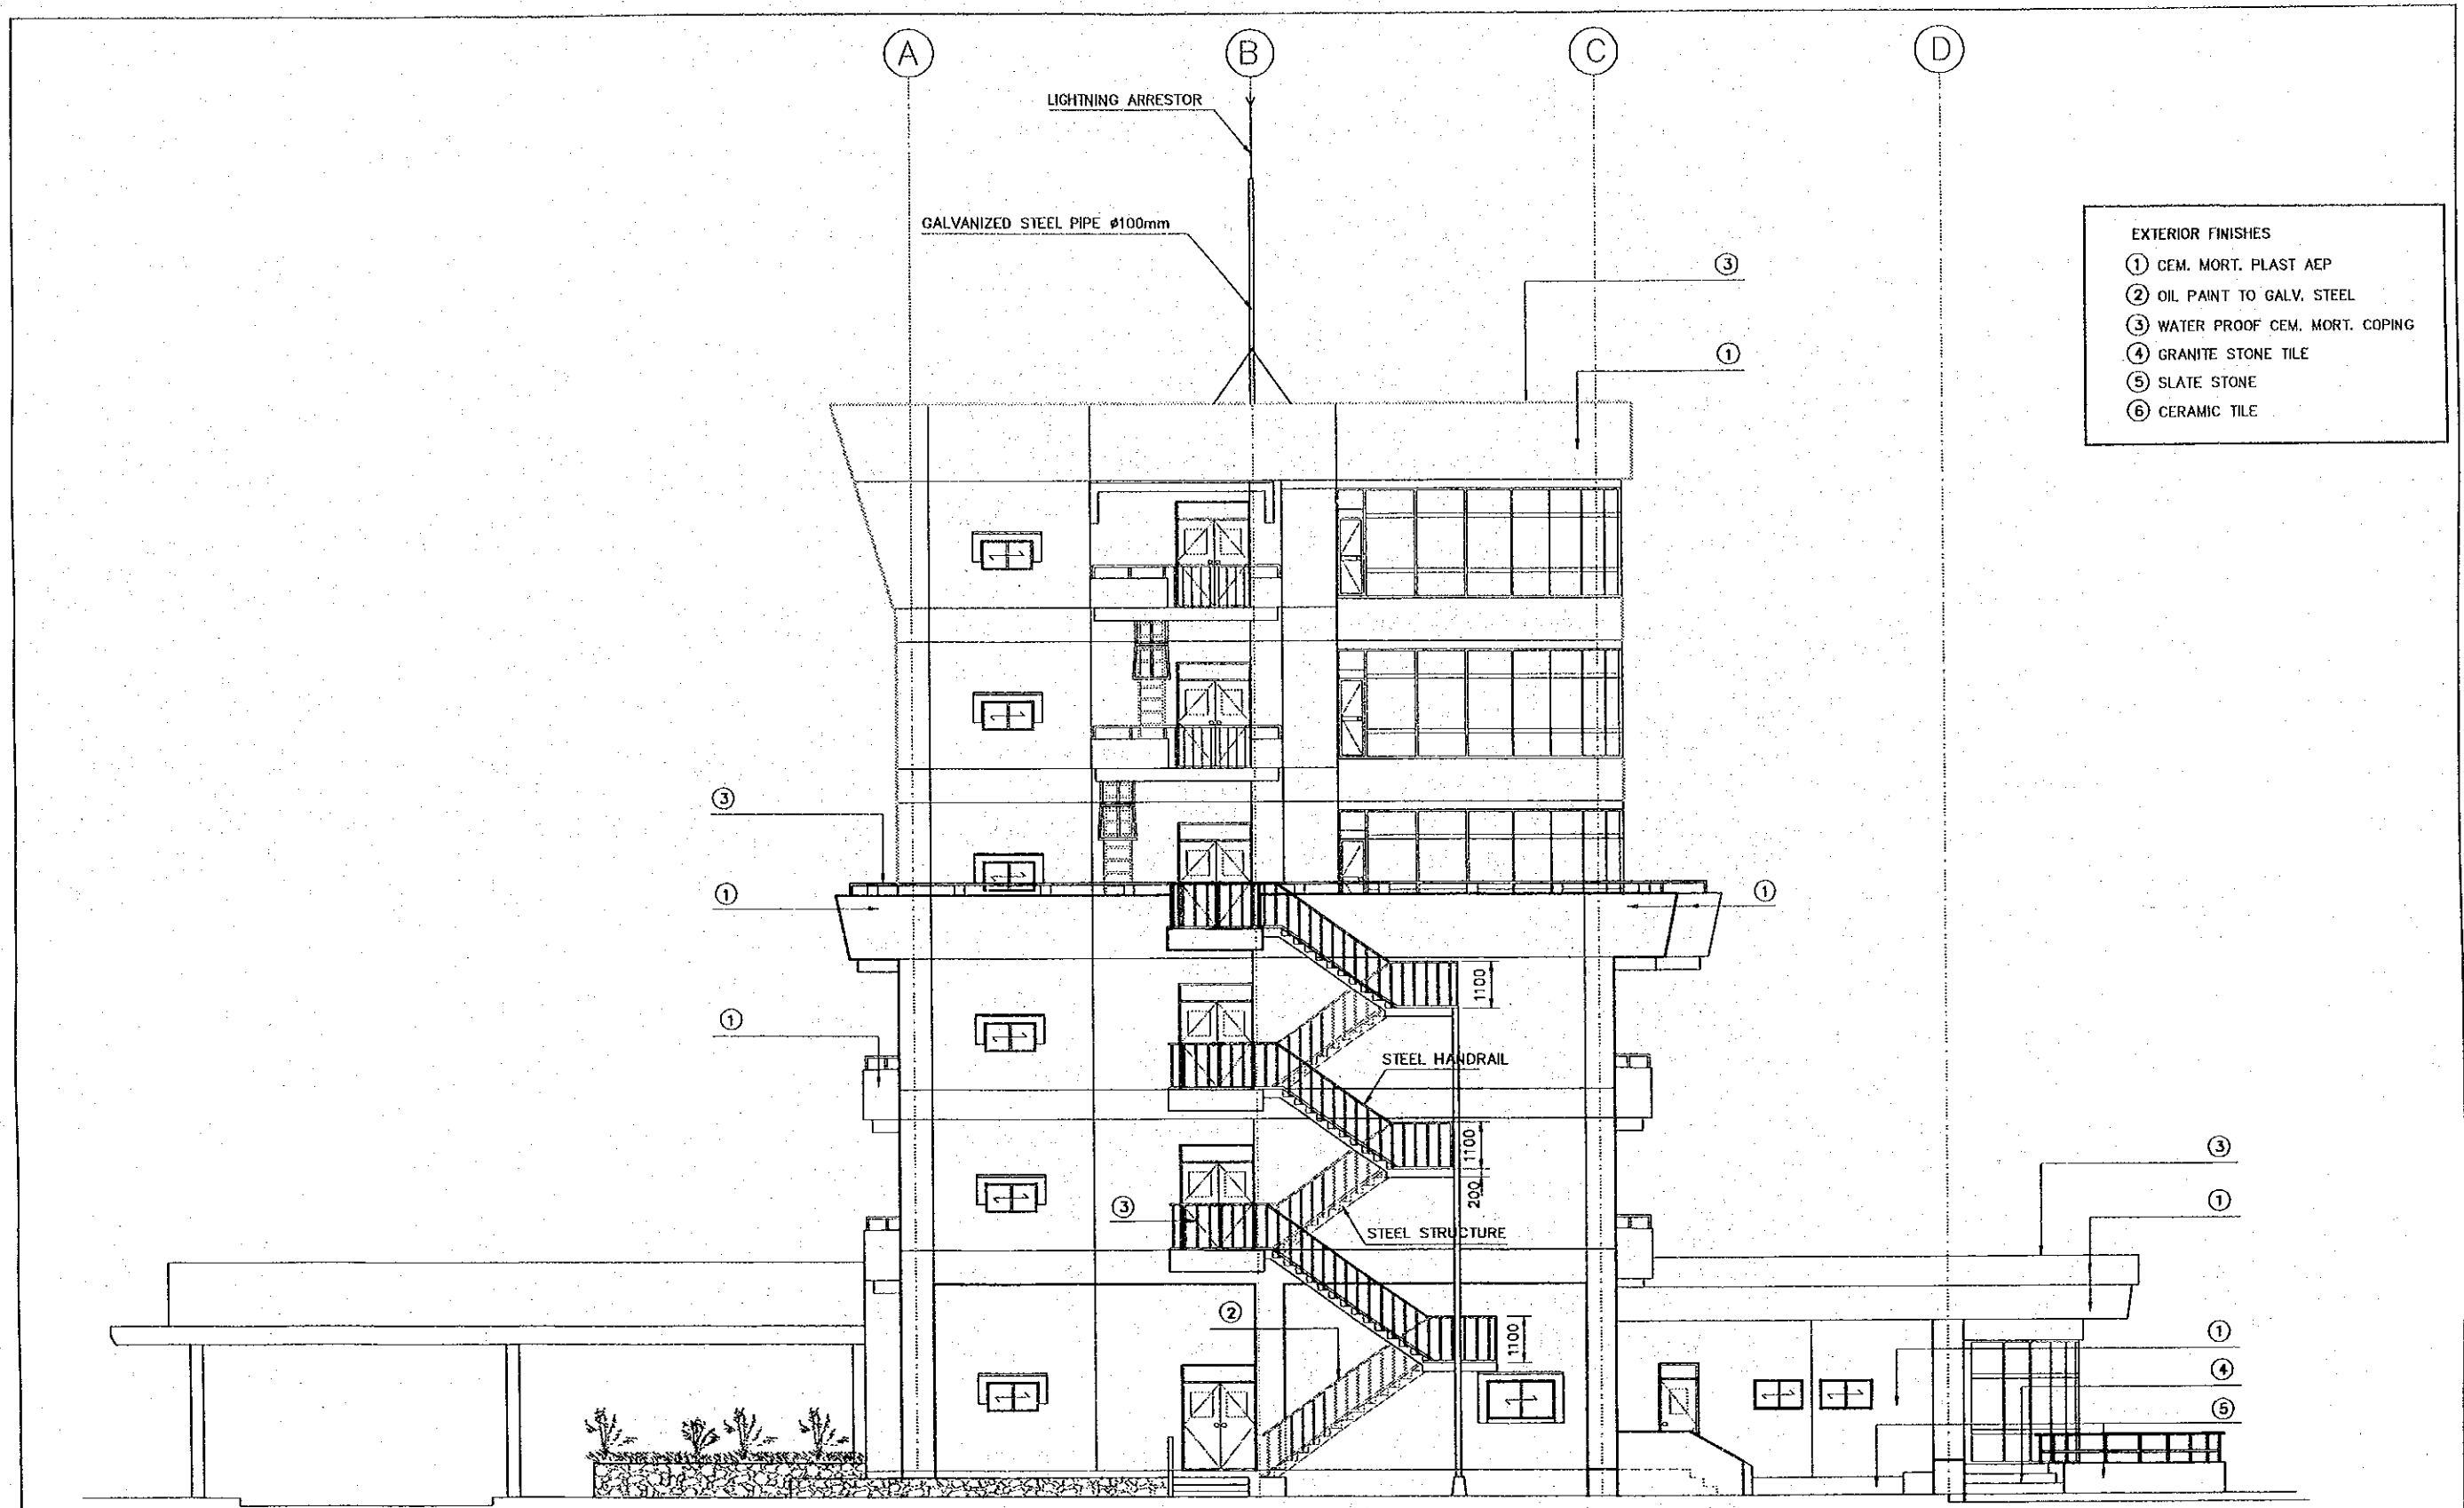DESIGNED BY: CHECKED BY: APPROVED BY:	SECTION : BUILDING WORK SUB-SECTION : PORT ADMINISTRATION BUILDING TITLE : NORTHWEST ELEVATION	DATE : OCTOBER/2002 SCALE : 1 : 150 DRAWING NO: BD-01-008
	JICA JAPAN INTERNATIONAL COOPERATION AGENCY (JICA) CEPA COMISION EJECUTIVA PORTUARIA AUTONOMA (CEPA)	THE DETAILED DESIGN ON PORT REACTIVATION PROJECT IN LA UNION PROVINCE OF THE REPUBLIC OF EL SALVADOR NIPPON KOEI CO., LTD.




SOUTHEAST ELEVATION  
SCALE 1:150

REV. NO.	DATE	COORDINATE	BY	APPROVED	DATE	 <b>JICA</b> JAPAN INTERNATIONAL COOPERATION AGENCY (JICA)	 <b>CEPA</b> COMISION EJECUTIVA PORTUARIA AUTONOMA (CEPA)	 <b>NIPPON KOEI CO., LTD.</b>	DESIGNED BY :	SECTION :	<b>BUILDING WORK</b> <b>PORT ADMINISTRATION BUILDING</b> <b>SOUTHEAST ELEVATION</b>	DATE :
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

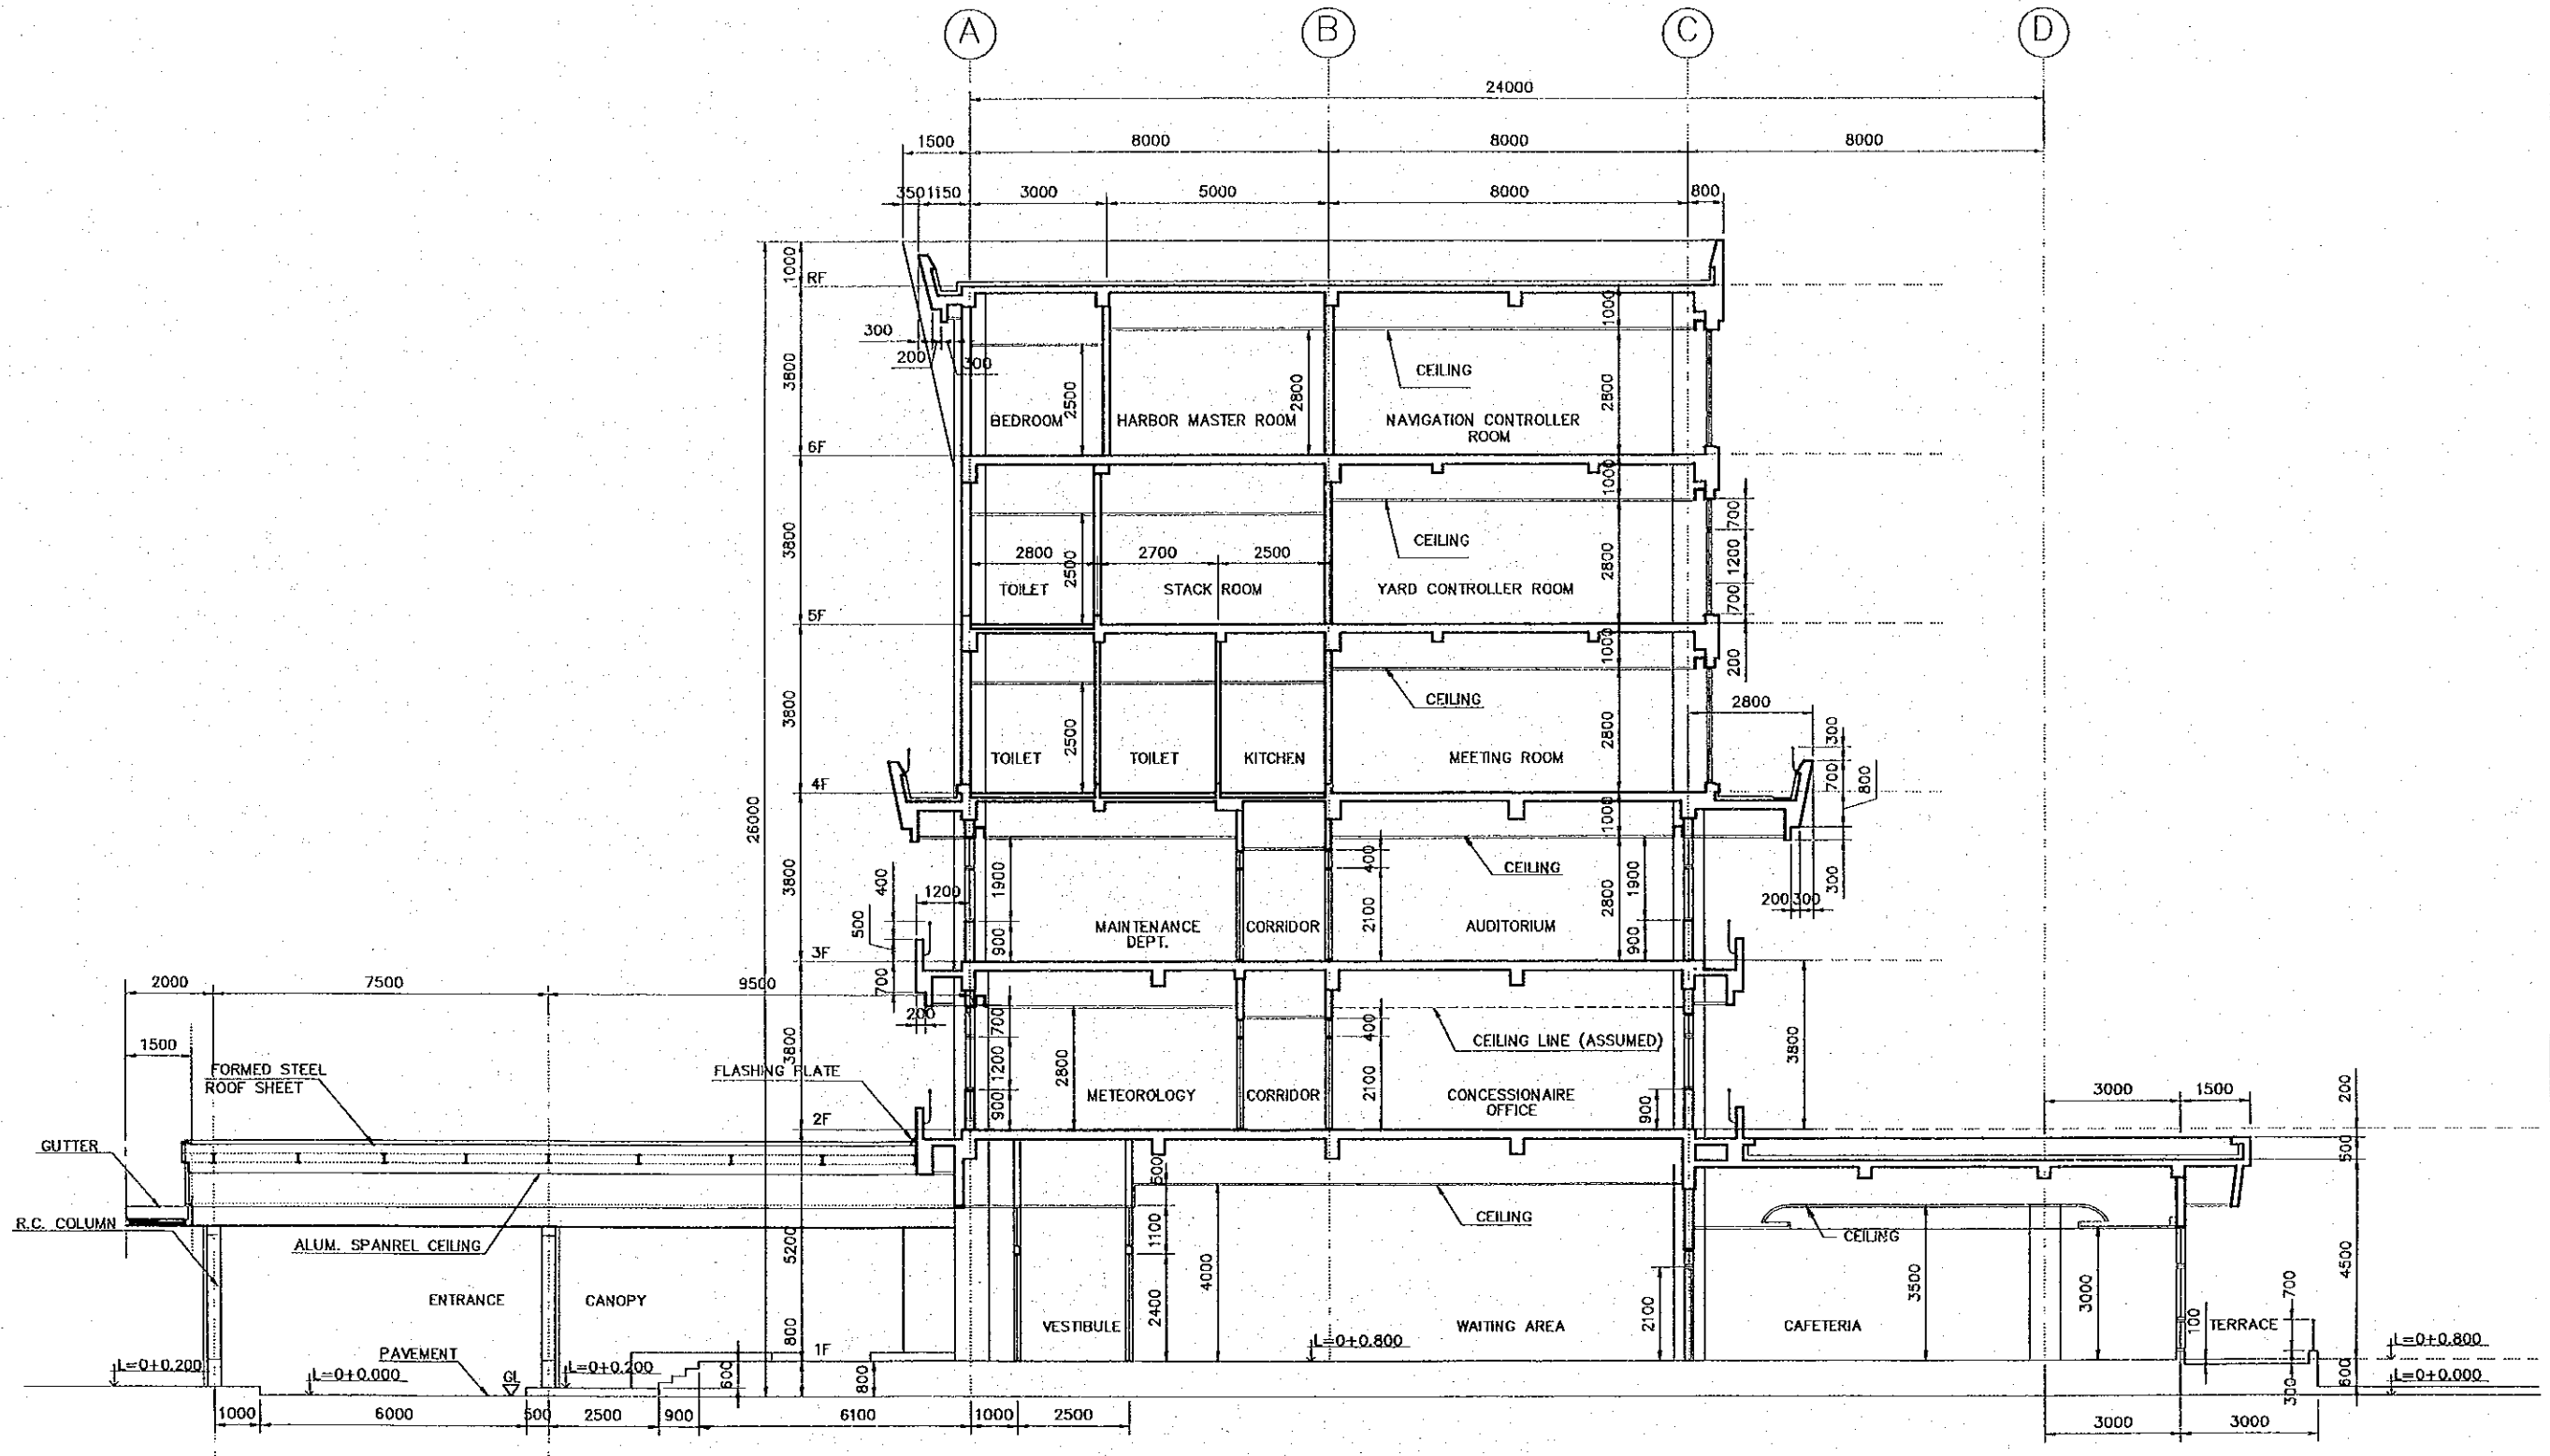


SECTION A-A  
SCALE 1:150

		<b>JAPAN INTERNATIONAL COOPERATION AGENCY (JICA)</b>		THE DETAILED DESIGN ON PORT REACTIVATION PROJECT IN LA UNION PROVINCE OF THE REPUBLIC OF EL SALVADOR		DESIGNED BY : CHECKED BY : APPROVED BY :		SECTION : BUILDING WORK SUB-SECTION : PORT ADMINISTRATION BUILDING TITLE : SECTION A-A		DATE : OCTOBER/2002 SCALE : 1 : 150 DRAWING NO : BD-01-010	
		<b>COMISION EJECUTIVA PORTUARIA AUTONOMA (CEPA)</b>				<b>NIPPON KOEI CO., LTD.</b>					
REV. NO.	DATE	COORDINATE	BY	APPROVED	DATE						

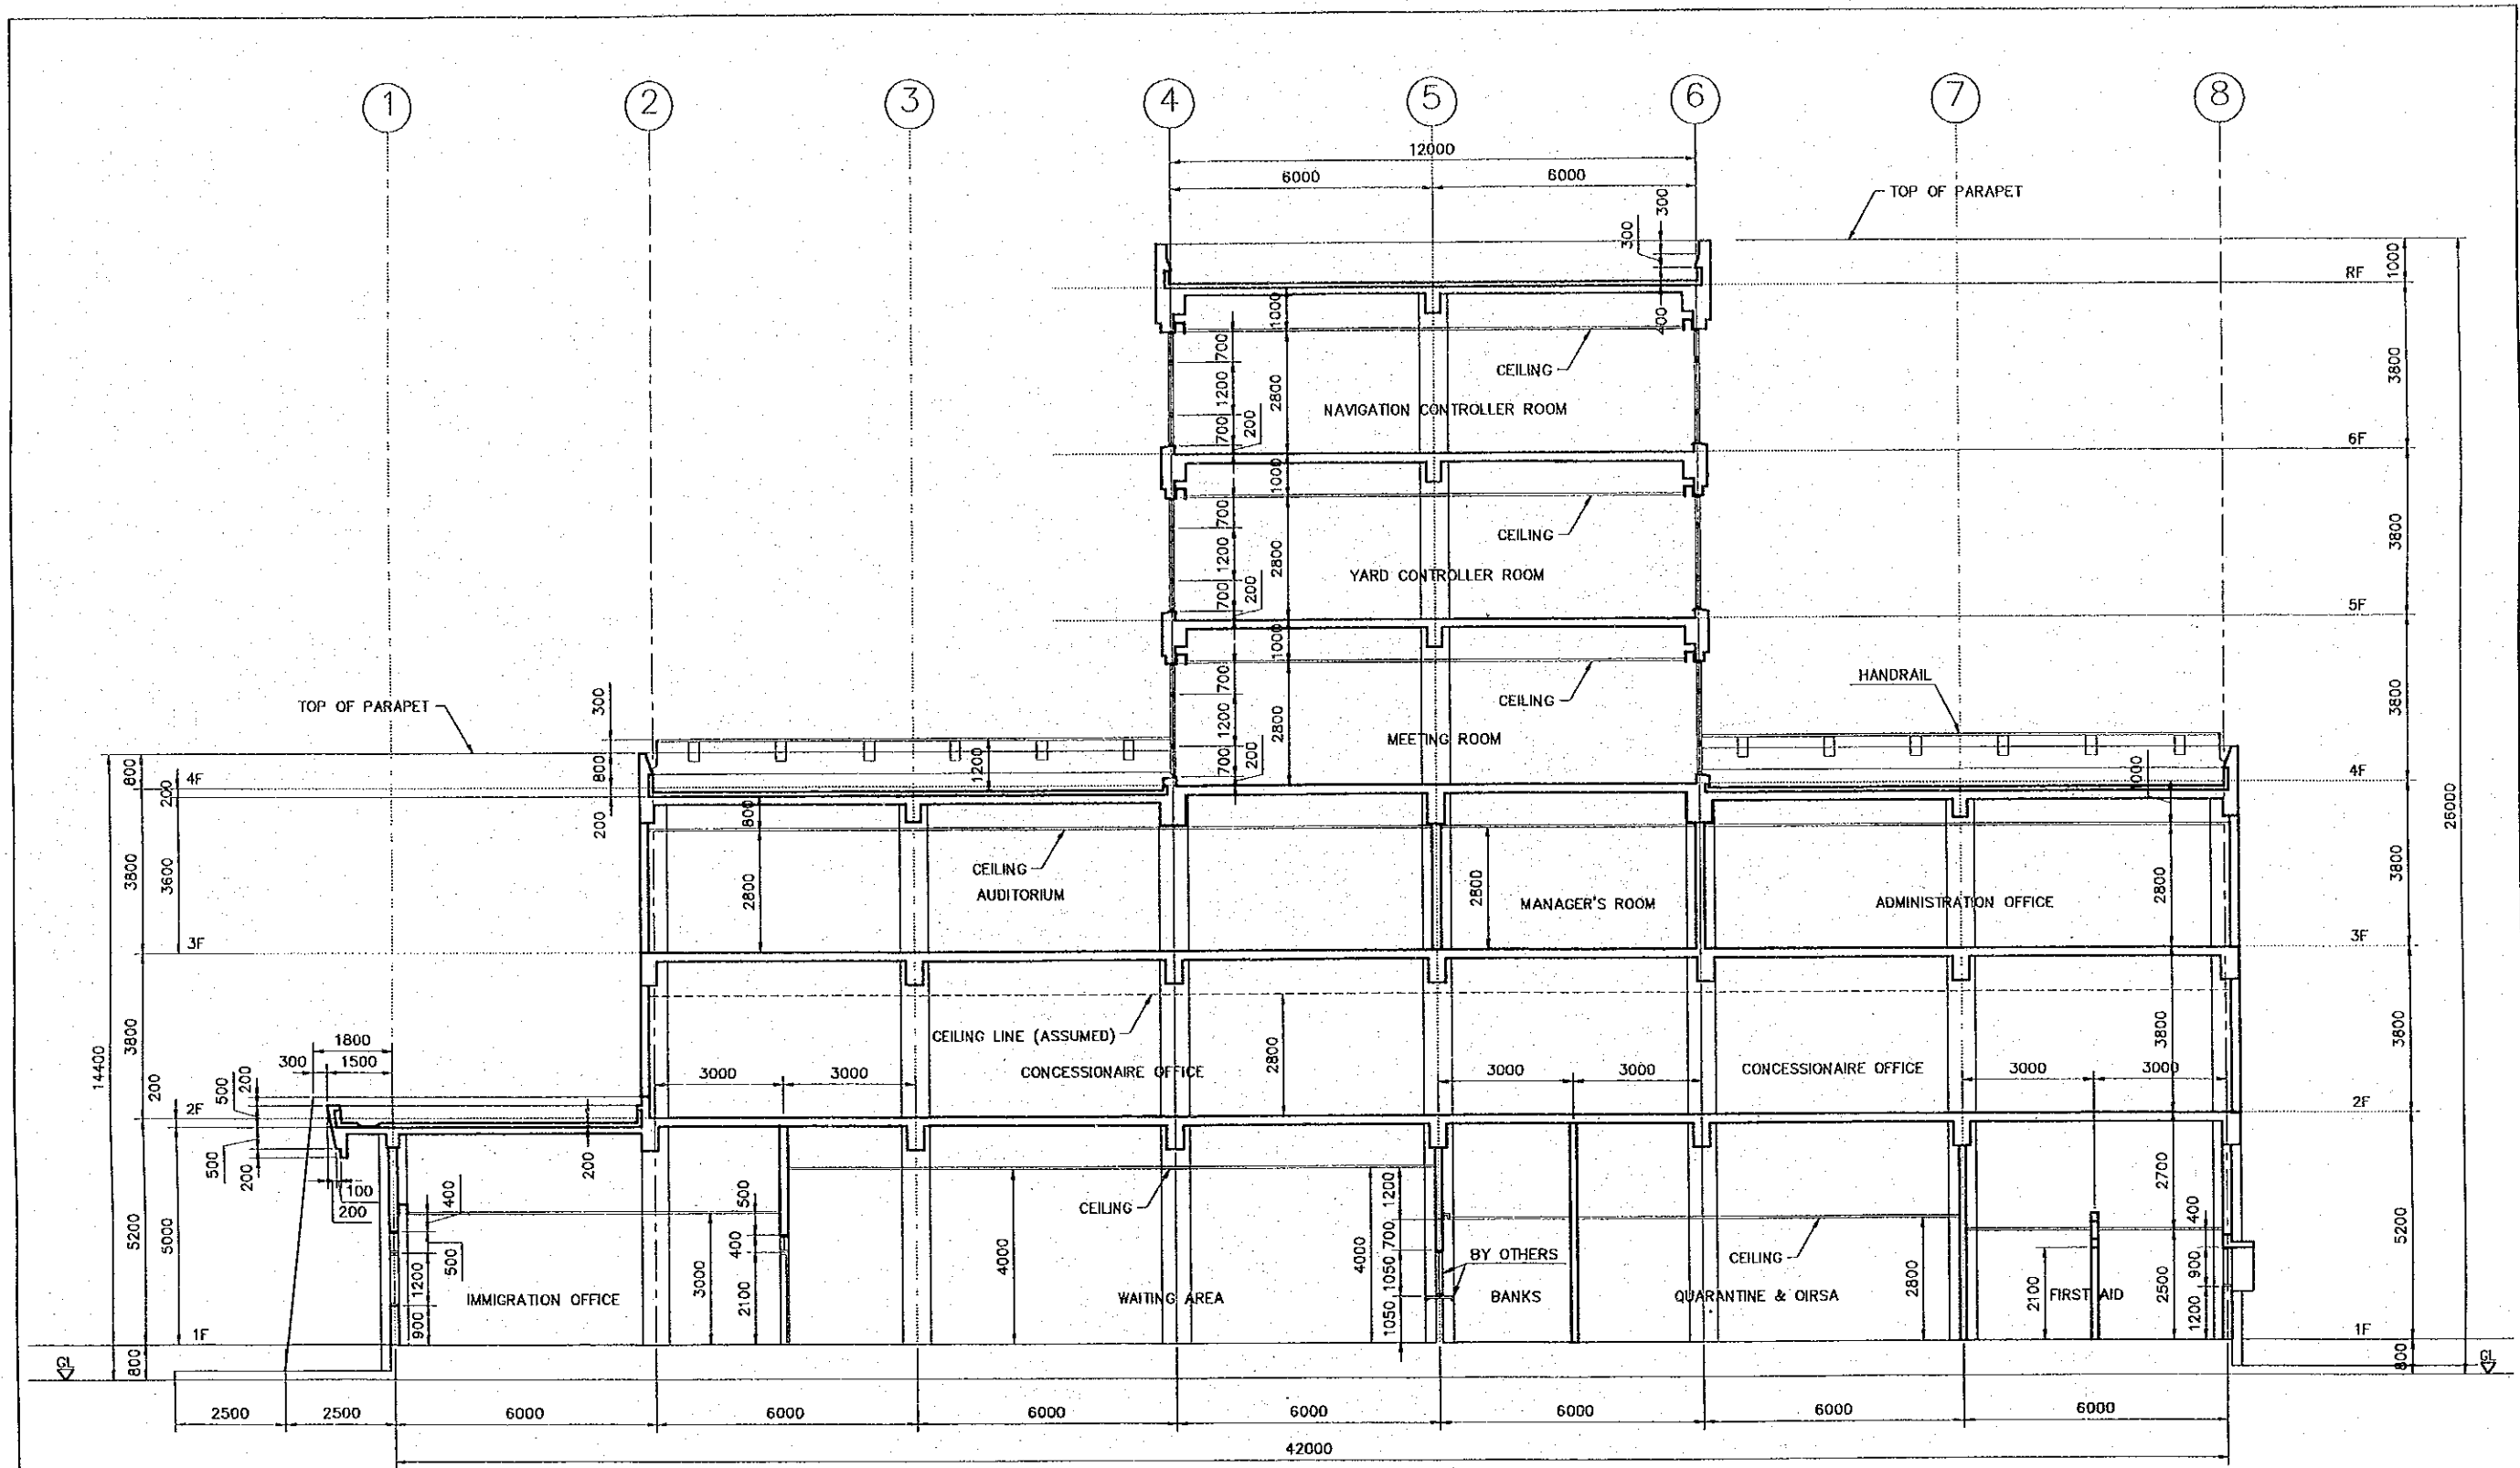




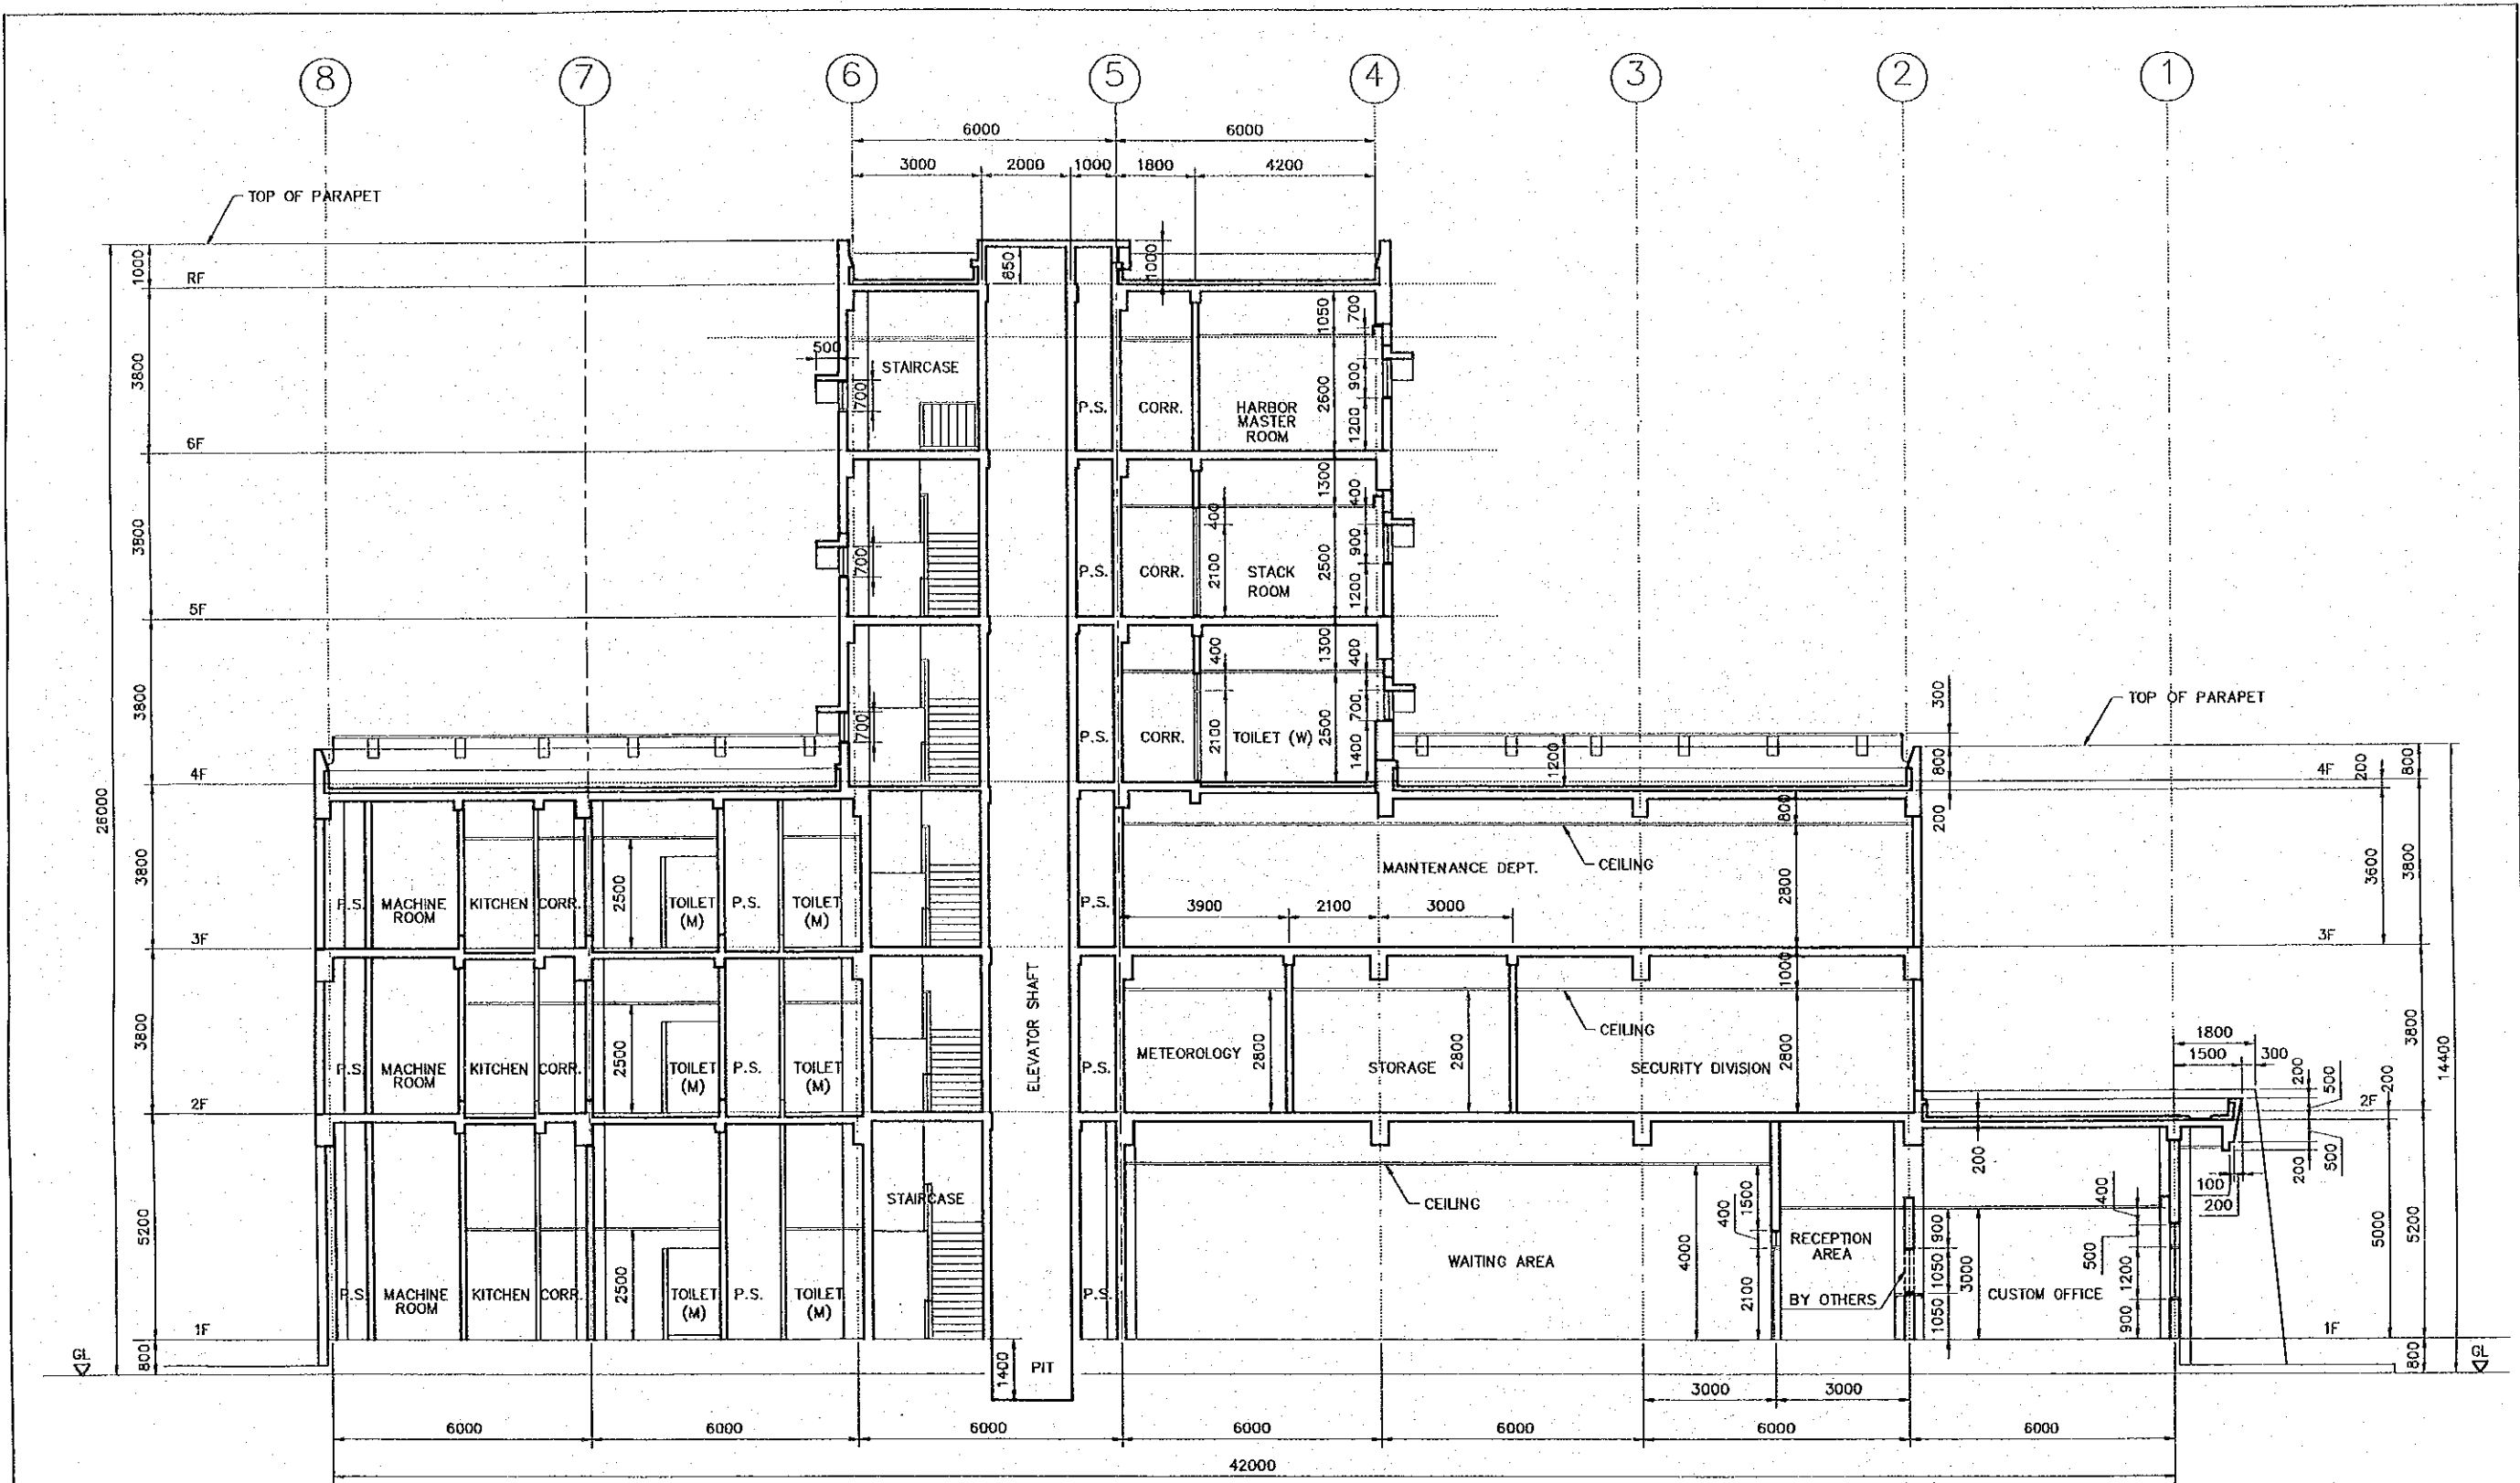
SECTION B-B  
SCALE 1:150

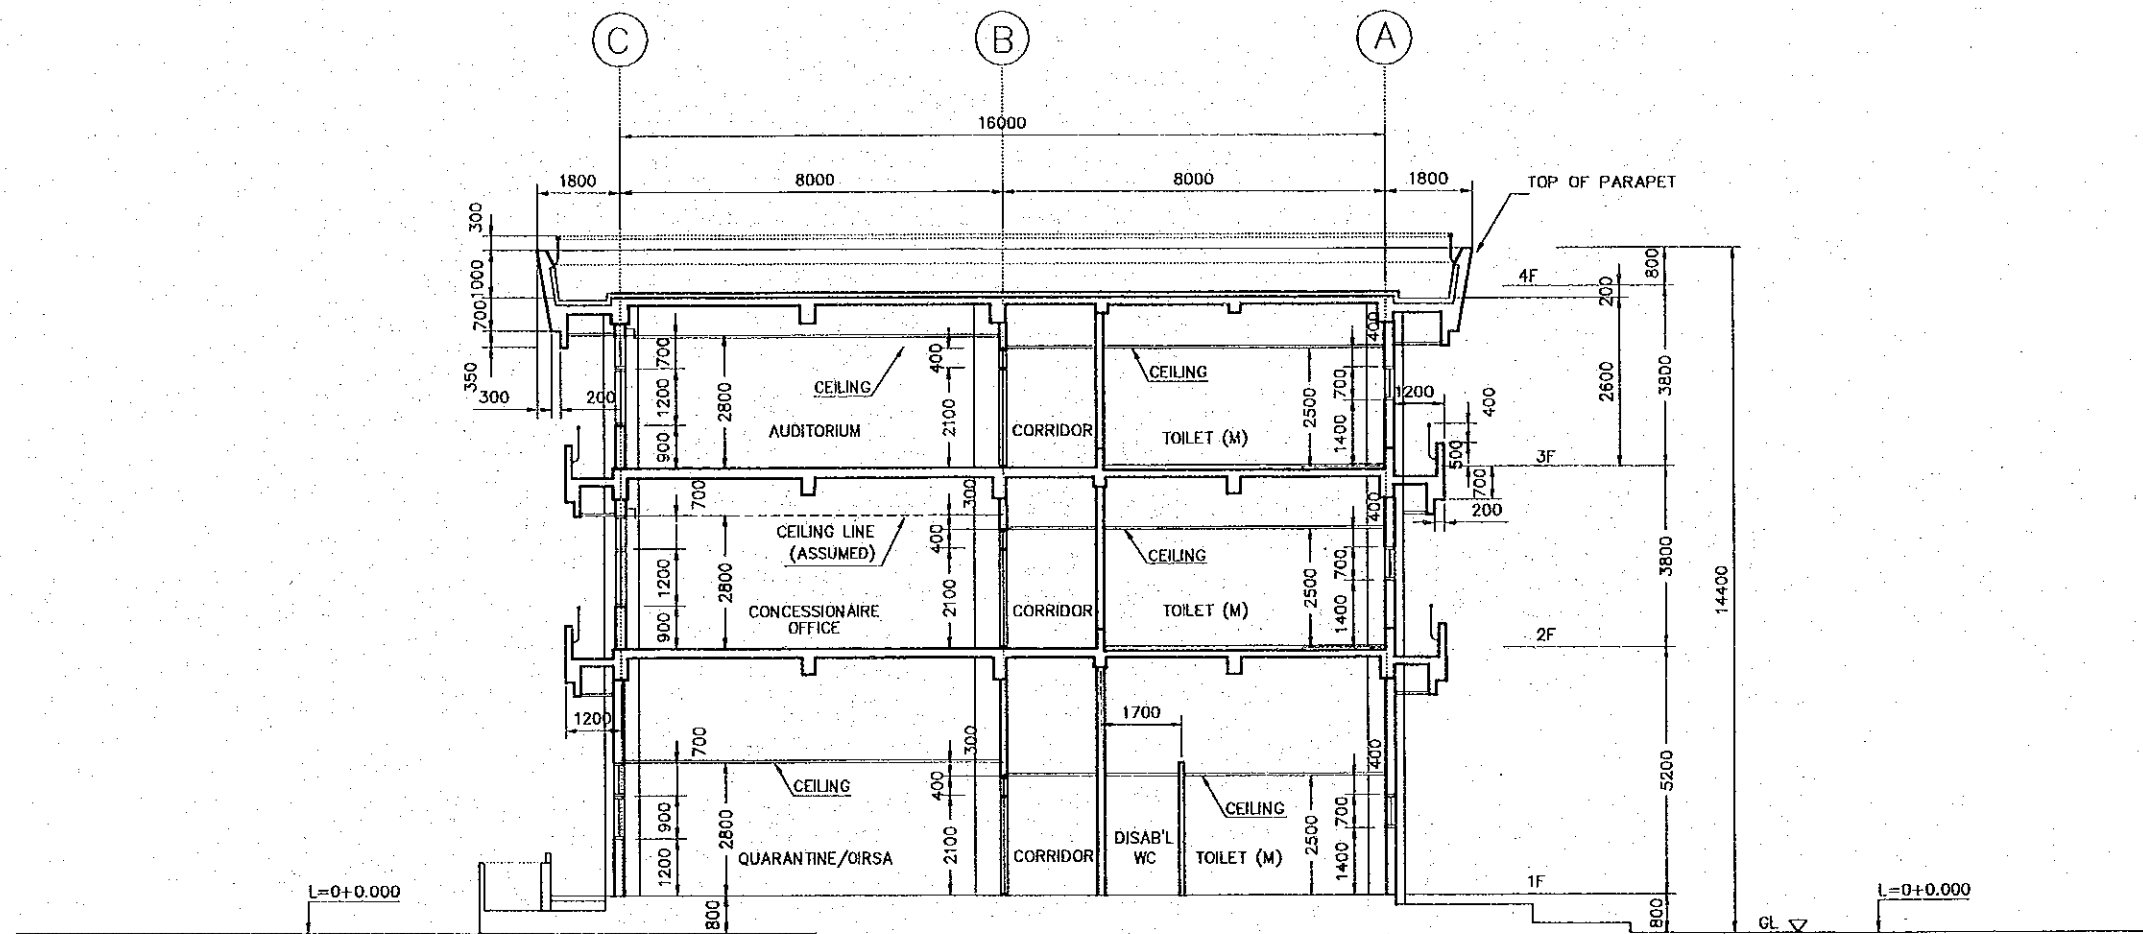REV. NO.	DATE	COORDINATE	BY	APPROVED	DATE	 <b>JICA</b> JAPAN INTERNATIONAL COOPERATION AGENCY (JICA) <b>CEPA</b> COMISION EJECUTIVA PORTUARIA AUTONOMA (CEPA)	 <b>NIPPON KOEI CO., LTD.</b>	DESIGNED BY :	SECTION : BUILDING WORK	DATE : OCTOBER/2002
								CHECKED BY :	SUB-SECTION : PORT ADMINISTRATION BUILDING	SCALE : 1 : 150
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




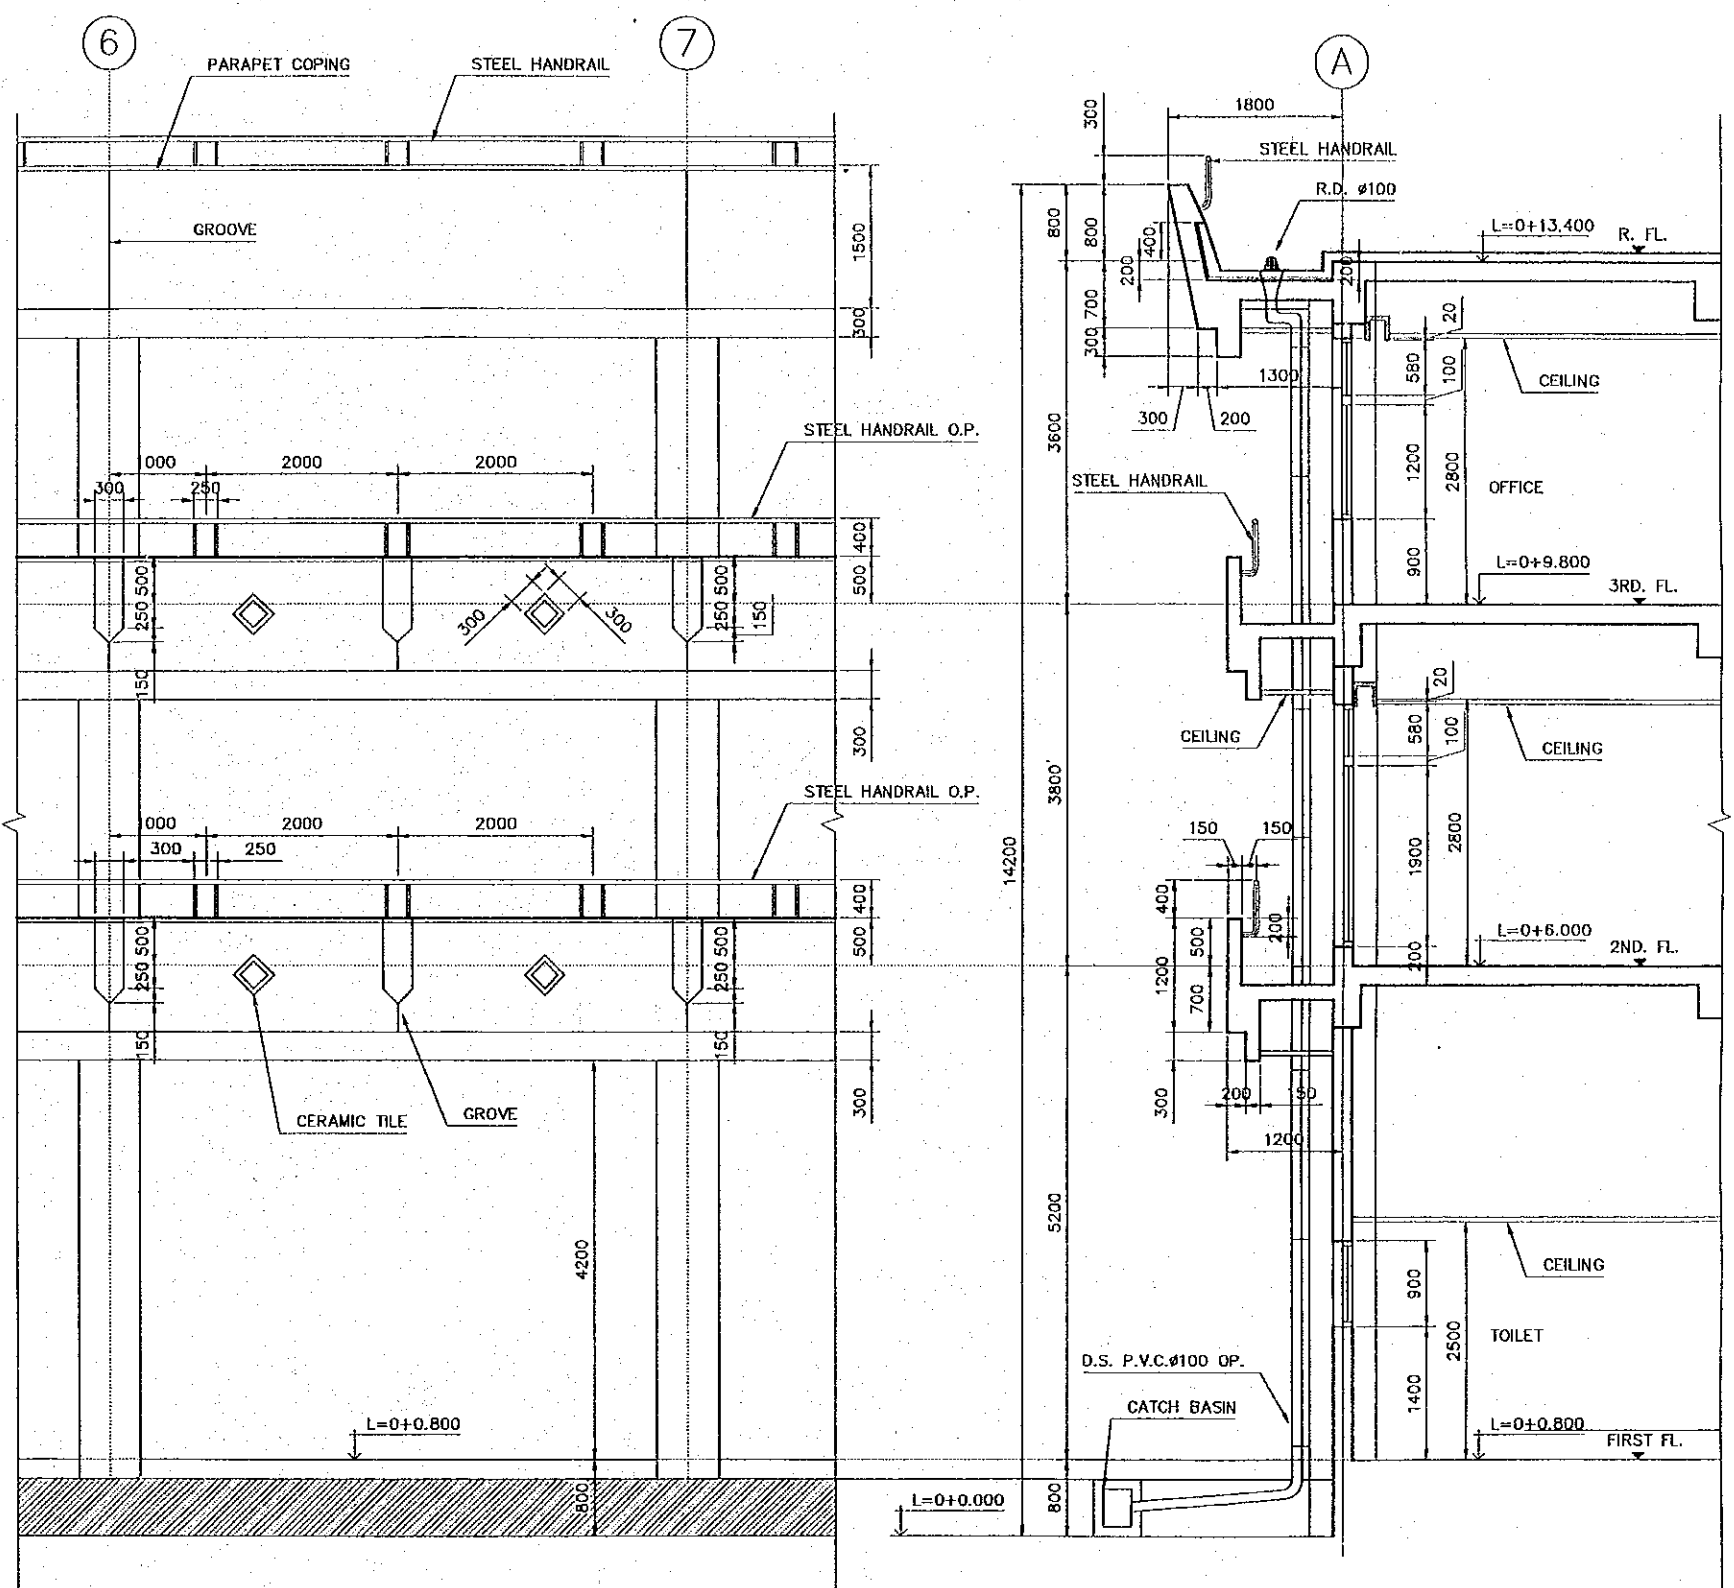
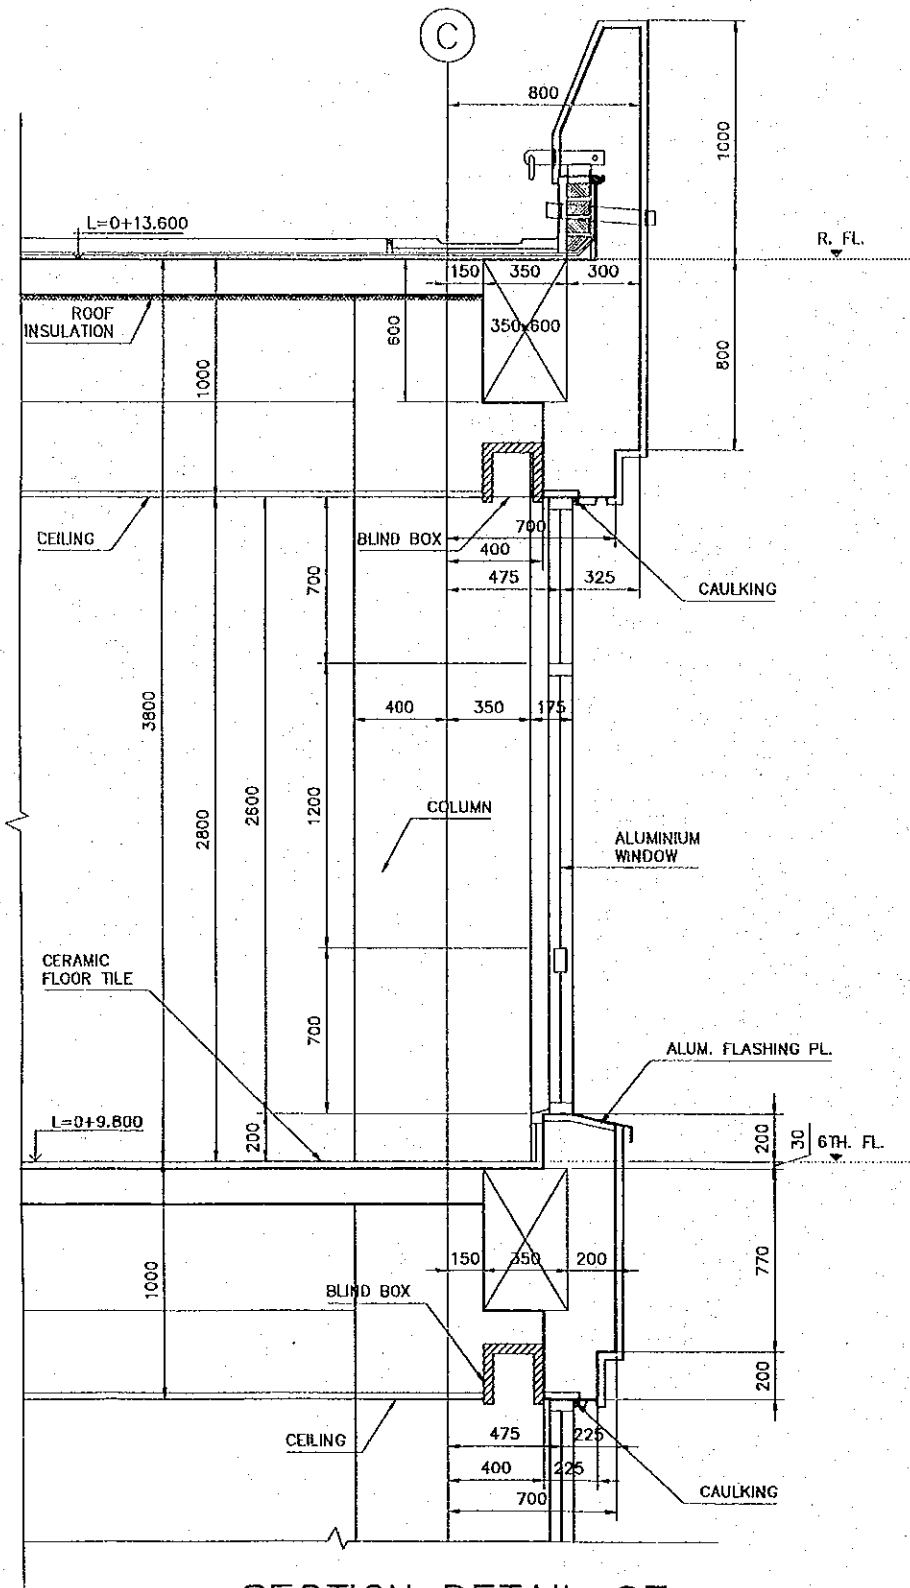
SECTION C-C  
SCALE 1:150

REV. NO.	DATE	COORDINATE	BY	APPROVED	DATE	 <b>JAPAN INTERNATIONAL COOPERATION AGENCY (JICA)</b>	 <b>COMISION EJECUTIVA PORTUARIA AUTONOMA (CEPA)</b>	 <b>NIPPON KOEI CO., LTD.</b>	DESIGNED BY :	SECTION : <b>BUILDING WORK</b>	DATE : <b>OCTOBER/2002</b>
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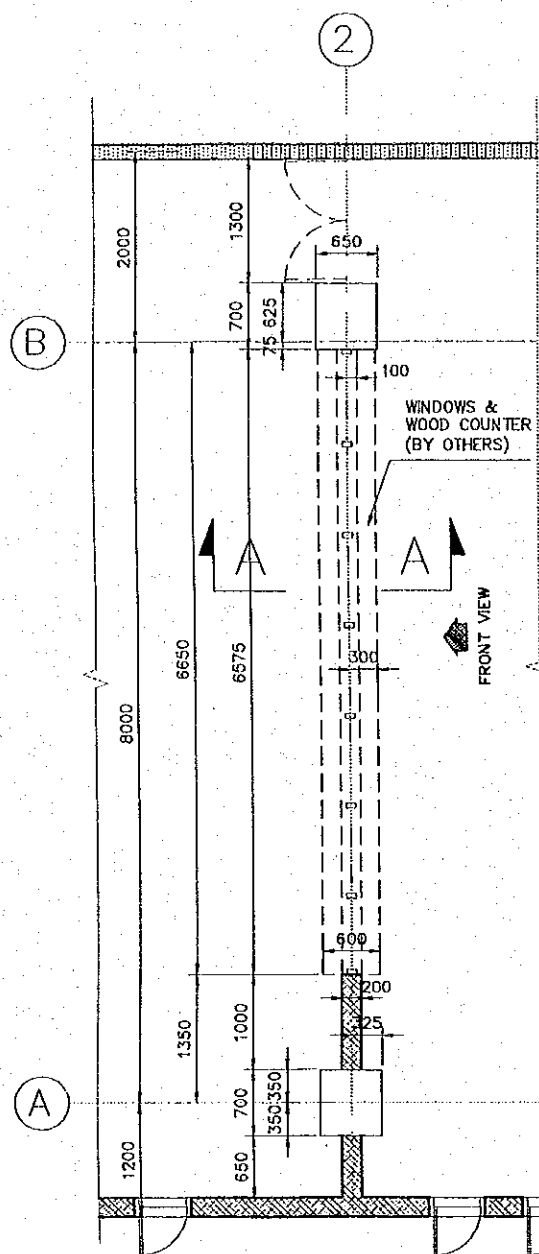


SECTION D-D  
SCALE 1:150


REV. NO.	DATE	COORDINATE	BY	APPROVED	DATE	 <b>JAPAN INTERNATIONAL COOPERATION AGENCY (JICA)</b>  <b>COMISION EJECUTIVA PORTUARIA AUTONOMA (CEPA)</b>	<b>THE DETAILED DESIGN ON PORT REACTIVATION PROJECT IN LA UNION PROVINCE OF THE REPUBLIC OF EL SALVADOR</b>  <b>NIPPON KOEI CO., LTD.</b>	DESIGNED BY :	SECTION : BUILDING WORK	DATE : OCTOBER/2002
								CHECKED BY :	SUB-SECTION : PORT ADMINISTRATION BUILDING	SCALE : 1 : 150
							APPROVED BY :	TITLE : SECTION D-D	DRAWING NO. : BD-01-013	




REV. NO.	DATE	COORDINATE	BY	APPROVED	DATE	JAPAN INTERNATIONAL COOPERATION AGENCY (JICA) COMISION EJECUTIVA PORTUARIA AUTONOMA (CEPA)	THE DETAILED DESIGN ON PORT REACTIVATION PROJECT IN LA UNION PROVINCE OF THE REPUBLIC OF EL SALVADOR NIPPON KORI CO., LTD	DESIGNED BY :	SECTION :	DATE :
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									BUILDING WORK	OCTOBER/2002
									PORT ADMINISTRATION BUILDING	INDICATED
									SECTION DETAILS	BD-01-014




CUSTOM RECEPTION COUNTER PLAN  
SCALE 1:75

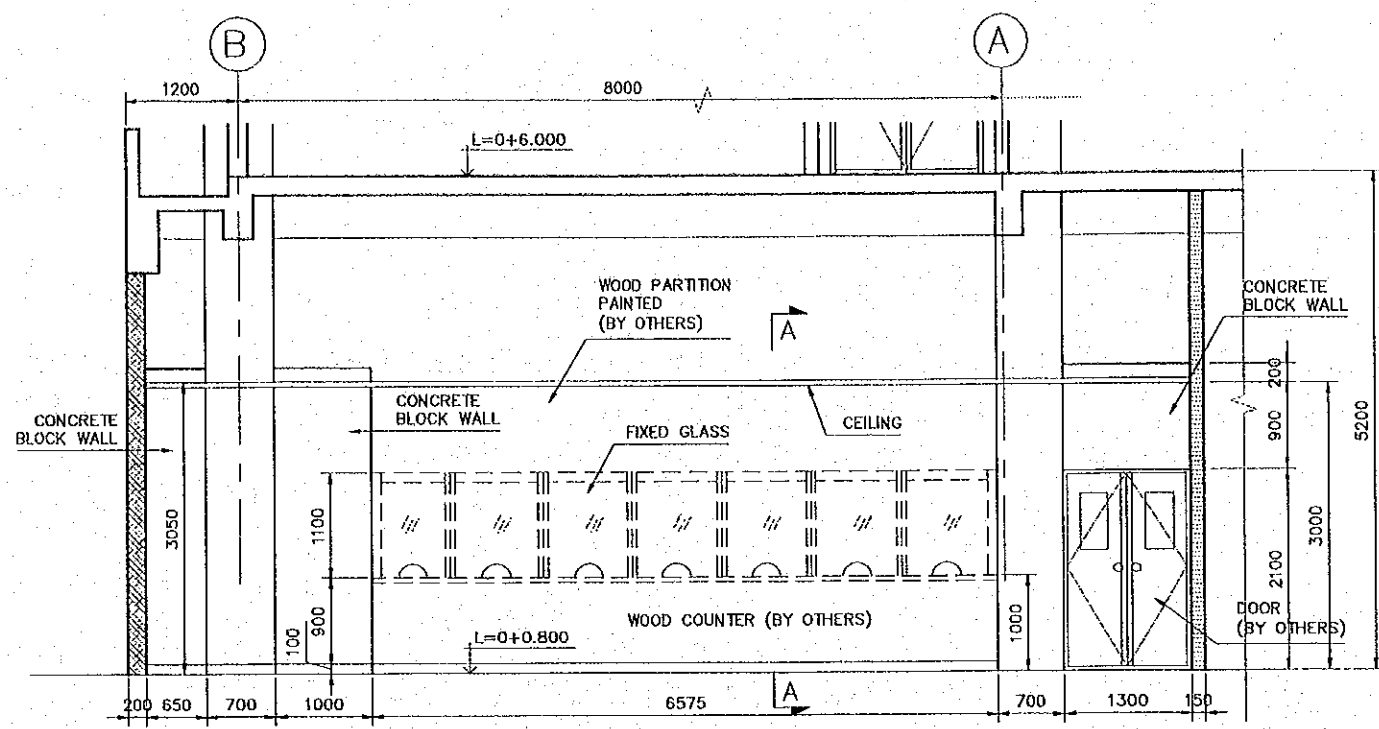


FRONT VIEW CUSTOM RECEPTION COUNTER (BY OTHERS)  
SCALE 1:75

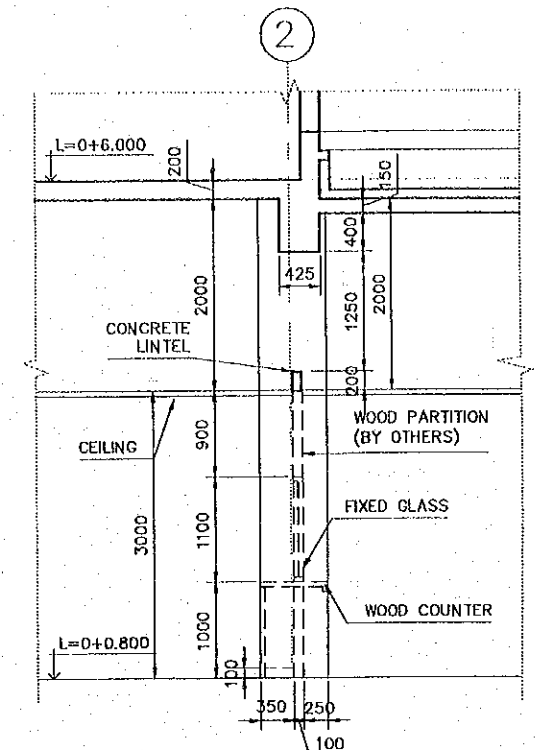


SECTION A-A  
SCALE 1:75

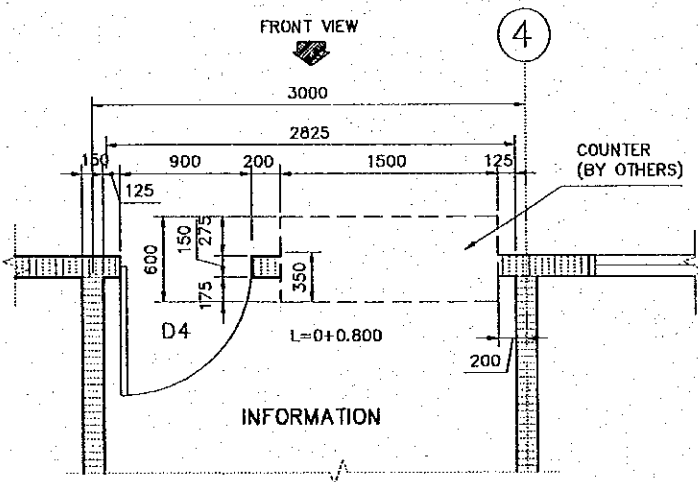

INFORMATION COUNTER PLAN  
SCALE 1:50

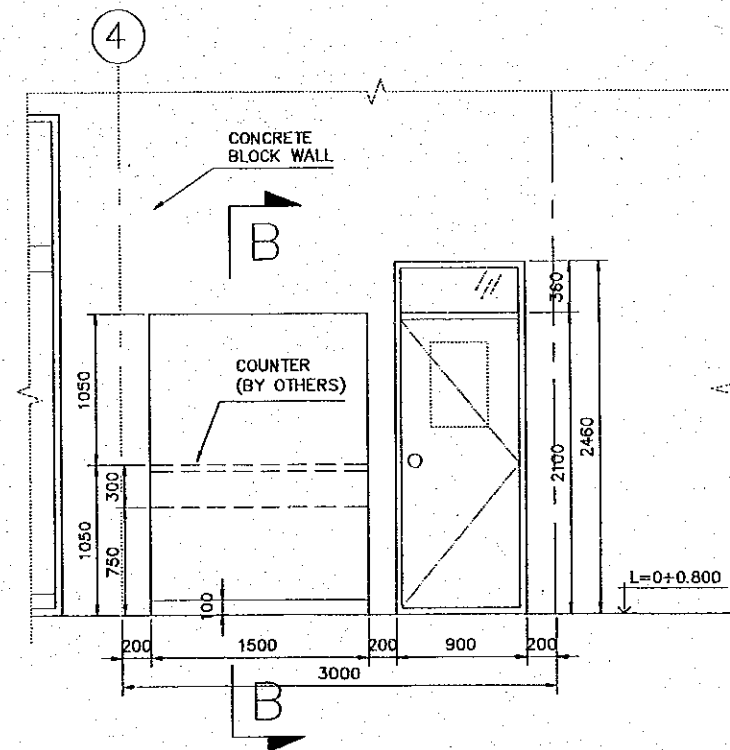

FRONT VIEW  
SCALE 1:50

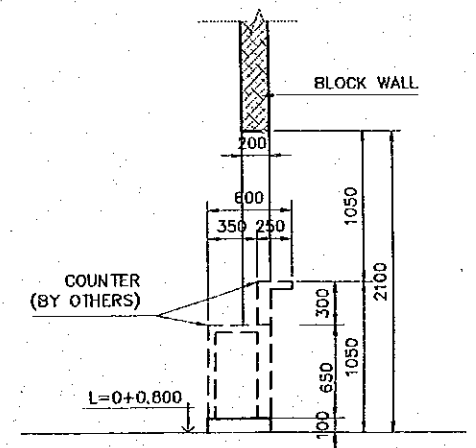

SECTION B-B  
SCALE 1:50

REV. NO.	DATE	COORDINATE	BY	APPROVED	DATE	JICA JAPAN INTERNATIONAL COOPERATION AGENCY (JICA) COMISION EJECUTIVA PORTUARIA AUTONOMA (CEPA)	THE DETAILED DESIGN ON PORT REACTIVATION PROJECT IN LA UNION PROVINCE OF THE REPUBLIC OF EL SALVADOR NIPPON KOEI CO., LTD.	DESIGNED BY :	SECTION :	DATE :
								CHECKED BY :	SUB-SECTION :	OCTOBER/2002
								APPROVED BY :	TITLE :	SCALE :
									BUILDING WORK	
									PORT ADMINISTRATION BUILDING	INDICATED
									ARCHITECTURAL COUNTER	
									DETAILS	DRAWING NO.:
										BD-01-015











