


PLAN S = 1/500

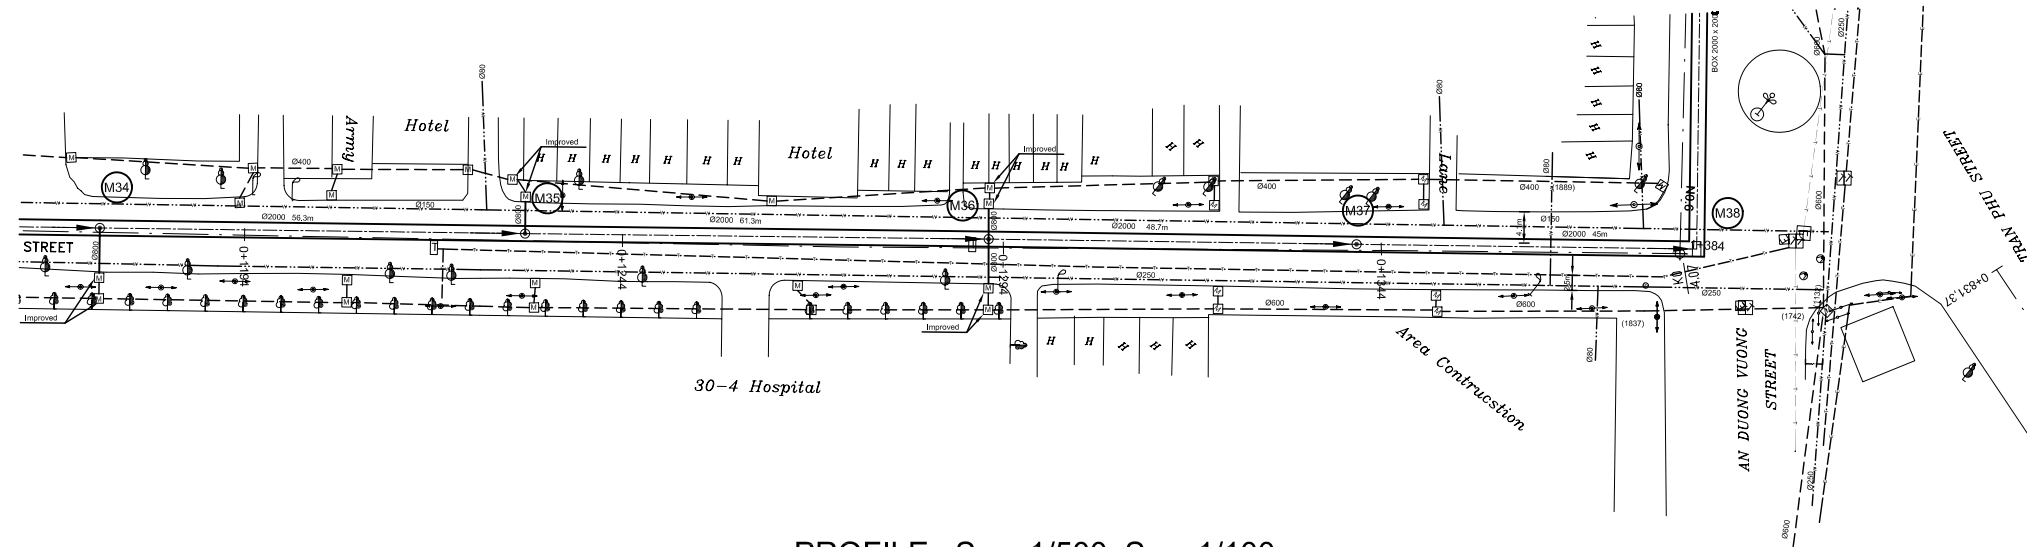


PROFILE $S_H = 1/500, S_V = 1/100$



Manhole Number	M34		M35		M36		M37		M38
Diameter (mm)		Ø2000		Ø2000		Ø2000		Ø2000	Box 2000 x 2000
Gradient (%)		0.80		0.80		0.80		0.80	0.80
Length (m)		56.3		55		55		45	54.9
Existing Ground Elevation (m)	4.12	4.10	4.13	4.14	4.16	4.16	4.04	4.04	4.07
Earth Covering (m)	2.23		2.28		2.36		2.28		2.34
Invert Elevation (m)	-0.26	-0.27	-0.30	-0.31	-0.35	-0.35	-0.39	-0.39	-0.43
Total Accumulation Length (m)	1160.9	1179.0	1217.2	1229.0	1272.2	1272.7	1327.2	1329.0	1369.0

KEYMAP

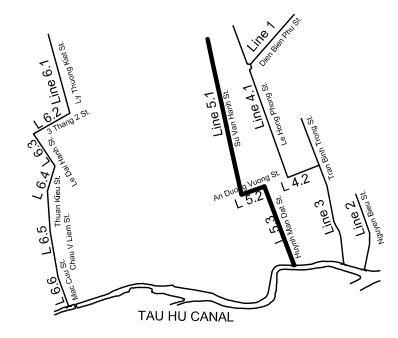

LEGEND

- Sewer Line
- Planned Sewer
- Existing Sewer
- Telephone Cable
- Electric Cable
- Water Pipe
- Outlet Without Flap Gate
- Outlet With Flap Gate
- Manhole
- Special Manhole
- Diversion Chamber
- Diversion Chamber with Manhole
- Existing Manhole
- Existing Inlet
- Telephone Cable Inspection Chamber
- Electric Cable Inspection Chamber
- Fire Hydrant
- S4 - Area to be Required for Shaft
- Sewer Connected from The Right Side
- Sewer Connected from The Left Side

NO.	DATE	DESCRIPTIONS	BY	APRO.
REVISIONS				
PROJECT MANAGEMENT UNIT FOR HO CHI MINH CITY WATER ENVIRONMENT IMPROVEMENT				
THE DETAILED DESIGN ON HO CHI MINH CITY WATER ENVIRONMENT IMPROVEMENT PROJECT IN THE SOCIALIST REPUBLIC OF VIET NAM				
PACKAGE D EXISTING COMBINED SEWER IMPROVEMENT				
PLAN AND PROFILE ECSI - LINE 5.1 - 5.2 (5)				
SCALE : As Shown				
JAPAN INTERNATIONAL COOPERATION AGENCY (JICA)				
PACIFIC CONSULTANTS INTERNATIONAL				
DESIGNED KATSUKI TAKAOKI		CHECKED KONDO MASAMI		
DATE : JUNE 2001		DWG. No. PD - ECSI - 222		

