


(JICA)


MY THUAN PROJECT MANAGEMENT UNIT

VO HY HAI TRAN-Q-CU H. FUJIKAWA HAC buang LAJI DATE 4.4.2000 4.4.2000 65/14/2000

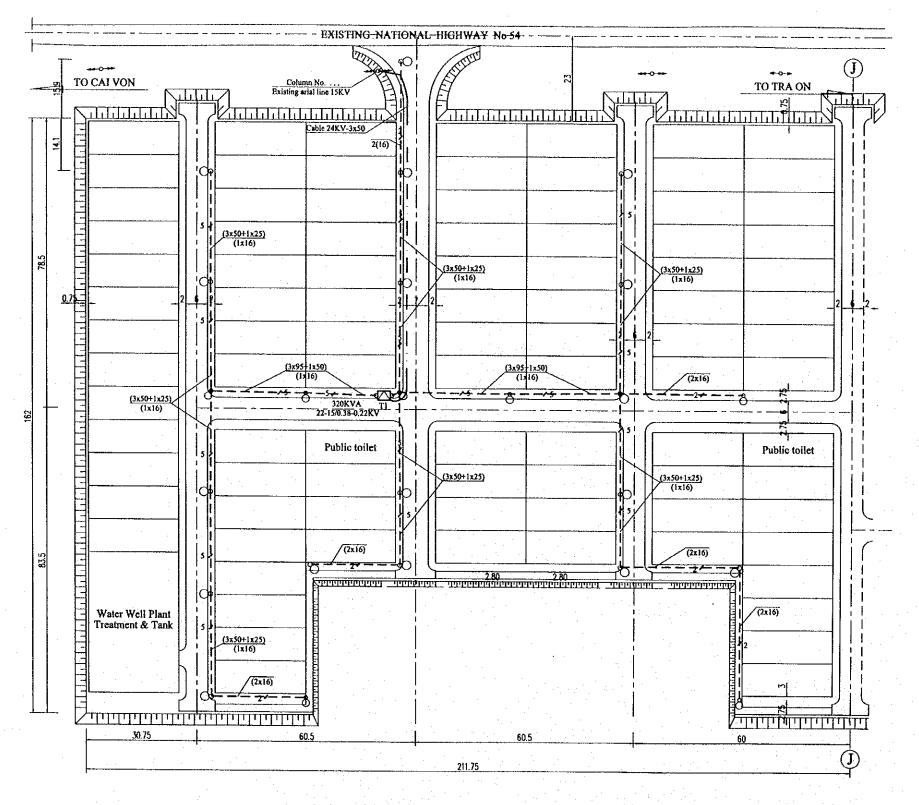

ELECTRICAL DISTRIBUTION PLAN SCALE 1:1

PROJECT NAME	IMPLEMENTATION AGENCY	EXECUTING AGENCY	ЛСА STUDY TEAM	PREPARED BY CHECKED BY APPROVED BY DRAWING TITLE	DWG NO.
DETAILED DESIGN OF THE CAN THO BRIDGE CONSTRUCTION PROJECT =	JAPAN INTERNATIONAL COOPERATION AGENCY (JICA)	SOCIALIST REPUBLIC OF VIET NAM MINISTRY OF TRANSPORT (MOT) MY THUAN PROJECT MANAGEMENT UNIT	NIPPON KOEI CO.,LTD.	NAME BYKY THUY BUILKY THUY HIFTITHE WA	12/25

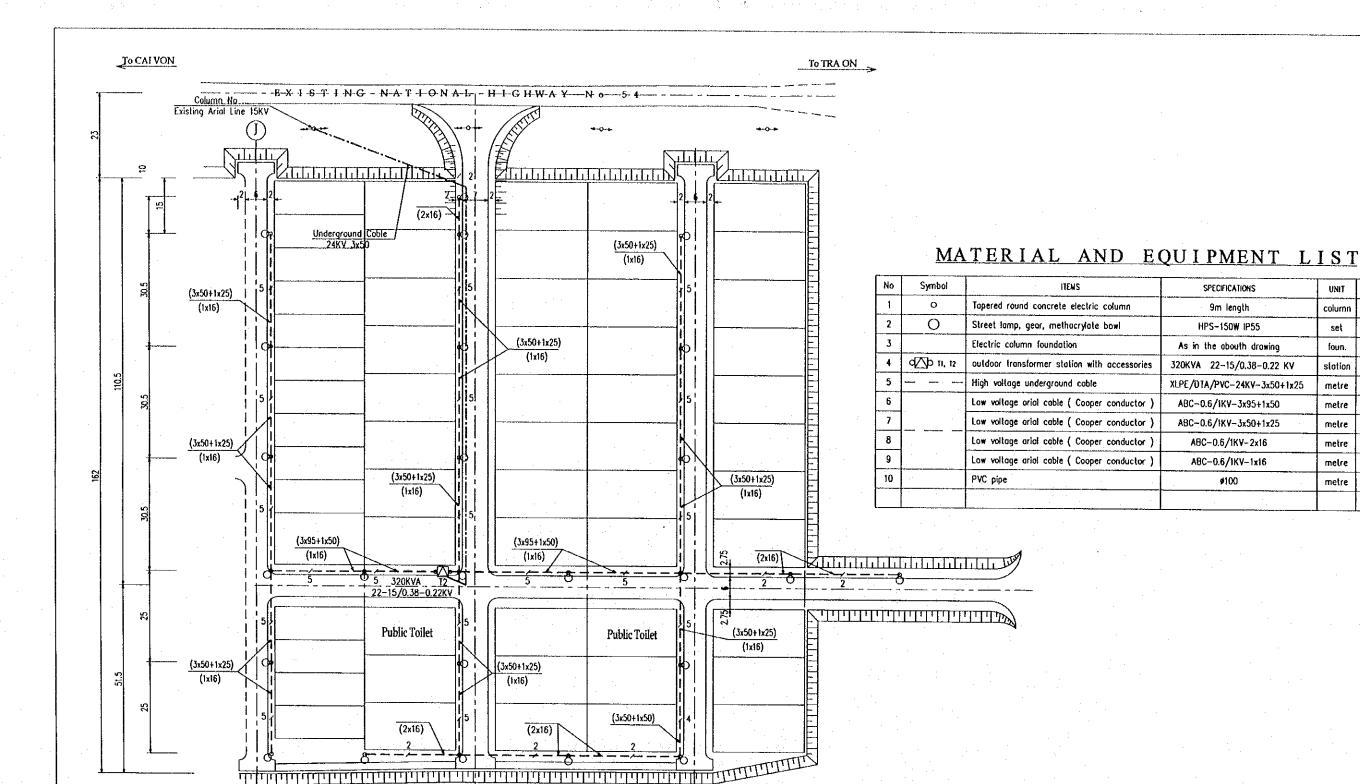

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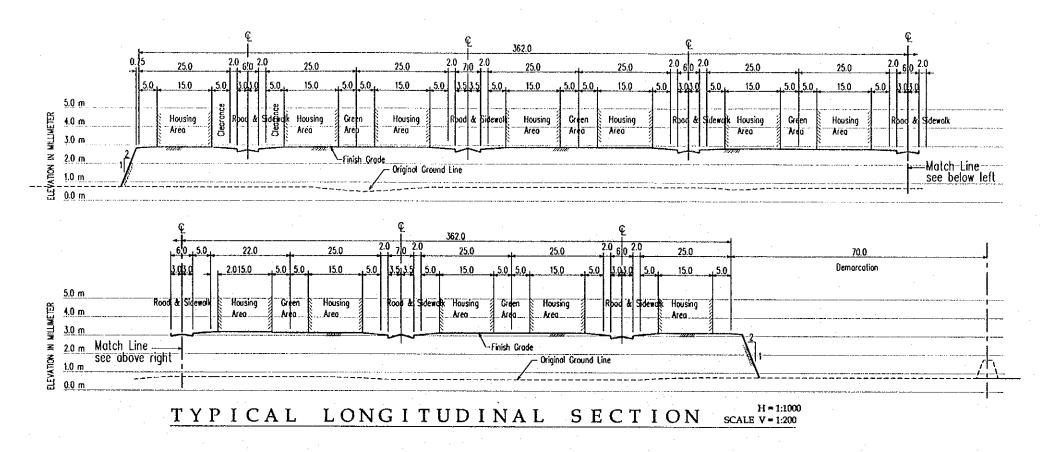
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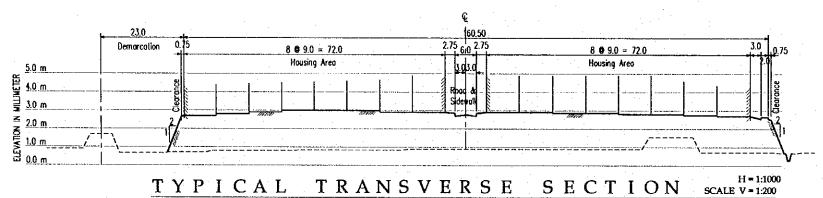
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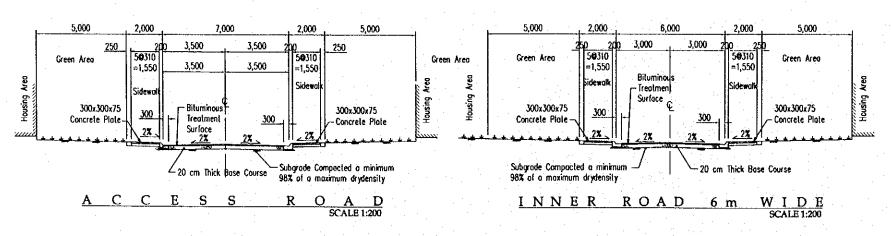
 ECTR	I CAL	DISTRIB	UTION	PLAN


	EMENTATION AGENCY	EXECUTING AGENCY	JICA STUDY TEAM		PREPARED BY	CHECKED BY	APPROVED BY	DRAWING TITLE	DWG NO.
DETAILED DESIGN OF THE CAN THO BRIDGE		SOCIALIST REPUBLIC OF VIET NAM		NAME	ВЦІ ҚҮТНИҮ	BUILTHUY	MIRUTIKAWA		
THE CAN THO BRIDGE CONSTRUCTION PROJECT		MINISTRY OF TRANSPORT (MOT) THUAN PROJECT MANAGEMENT UNIT	(NK) NIPPON KOEI CO.,LTD.	SIGNATURE	Uning	Cruy	NA	ELECTRICAL DISTRIBUTION PLAN (2)	13/25
	(JICA) WI	THOANTROJECT MANAGEMENT UNIT	<u> </u>	DATE	04/04/2000	04/04/2000	05/04/2000		

SCALE 1:1000







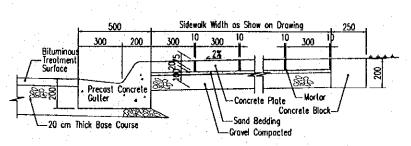


DETAILS OF SIDEWALK & GUTTER
NOTTOSCALE

TYPICAL SECTIONS, ROAD CROSS SECTIONS & DETAILS

Γ

IMPI	EMENTATION AGENCY
IIII.	JAPAN INTERNATIONAL
	COOPERATION AGENCY
	(JICA)

EXECUTING AGENCY
SOCIALIST REPUBLIC OF VIET NAM
MINISTRY OF TRANSPORT (MOT)
MY THUAN PROJECT MANAGEMENT UNIT

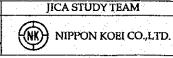


		PREPARED BY	CHECKED BY	APPROVED BY	Γ
Ī	NAME	VOHYHAI	M. FUJIKAWA	M. FY JIKA WA	Γ
	SIGNATURE	Mai	Kit.	Mite	l
	DATE	4,4,2,000	05/04/2010	25/24/2000	l


TYPICAL SECTION, ROAD CROSS SECTION & DETAILS


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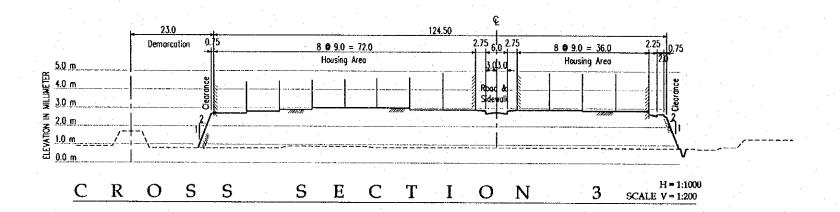
14/25


DWG NO.



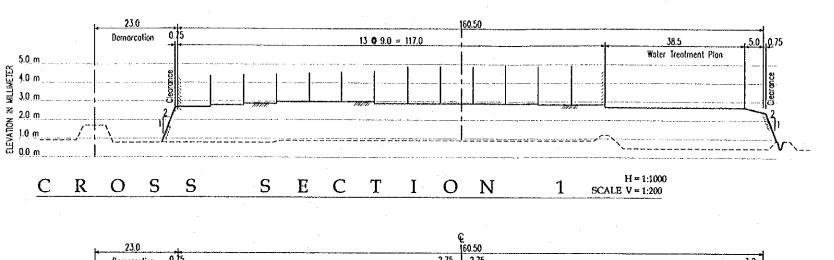

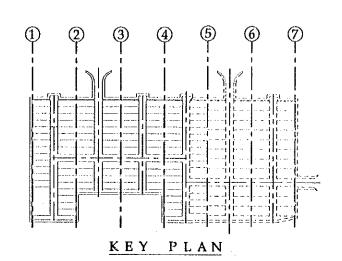

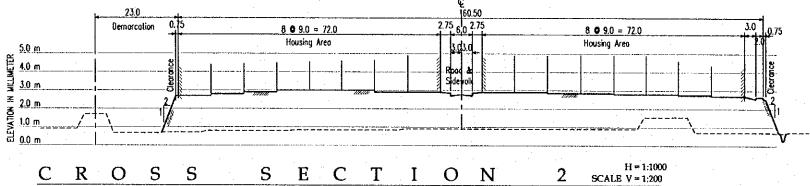

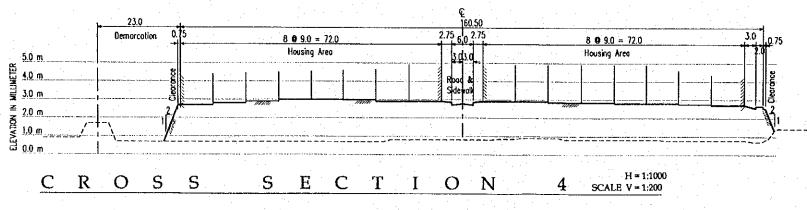


CROSS SECTIONS

PROJECT NAME
DETAILED DESIGN OF
THE CAN THO BRIDGE
CONSTRUCTION PROJECT

JICA STUDY TEAM

	LKELYKED RA	CHECKED BY	APPROVED BY	L
NAME	LAH YHOV	VOHY HAT	H.FIJKJW1	Γ
SIGNATURE	liai	ital.	A.R	1
DATE	4.4.200	4.4.2000	05/04/2000	1

DRAWING TITLE	DWG NO.
CROSS SECTIONS	15/25

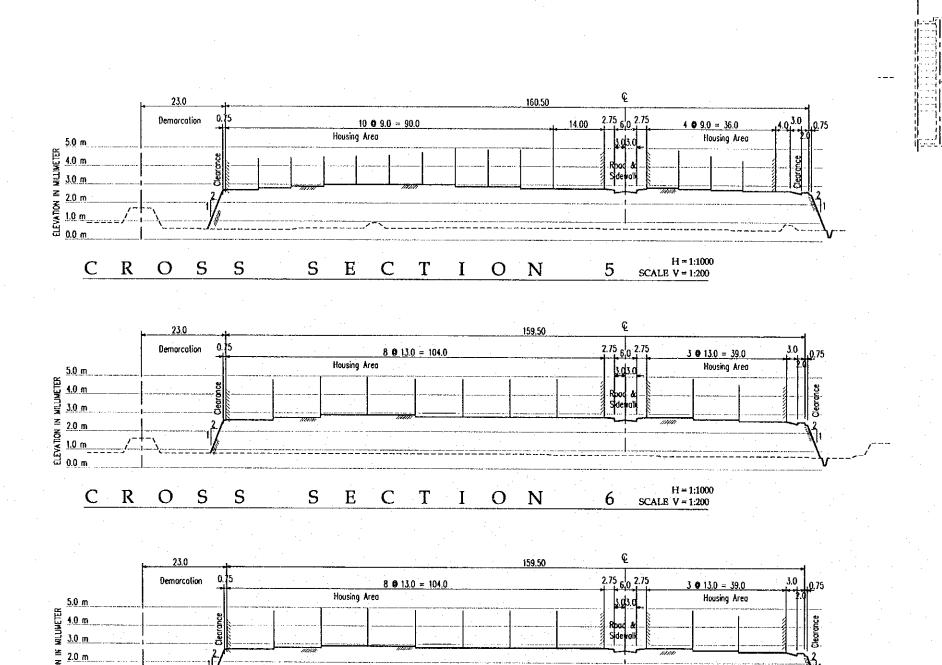

CROSS SECTIONS

H = 1:1000 SCALE V = 1:200

PROJECT NAME

DETAILED DESIGN OF
THE CAN THO BRIDGE
CONSTRUCTION PROJECT

IMPLEMENTATION AGENCY

JAPAN INTERNATIONAL

COOPERATION AGENCY

(JICA)

O

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EXECUTING AGENCY
SOCIALIST REPUBLIC OF VIET NAM
MINISTRY OF TRANSPORT (MOT)
MY THUAN PROJECT MANAGEMENT UNIT

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JICA STUDY TEAM

NIPPON KOEI CO.,LTD.

I O N

PREPARED BY CHECKED BY APPROVED BY

NAME VO HY HAI VO HY HAI M.FWJUAWA

SIGNATURE (HAL HAL ALA)


DATE 4.4.2.000 4.4.2.000 csfc4/2000


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CROSS SECTIONS


DWG NO.

16/25

KEY PLAN

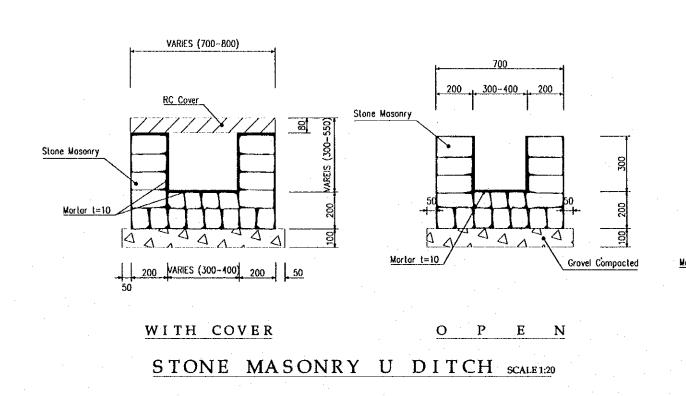


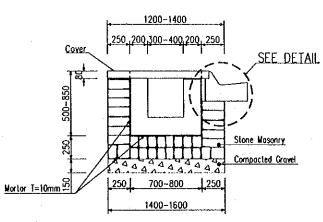


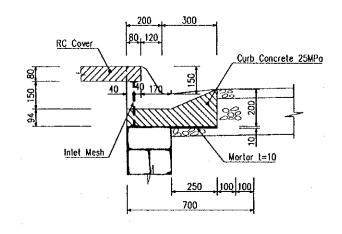


SECTION

DETAIL OF INLET
SCALE 1:20

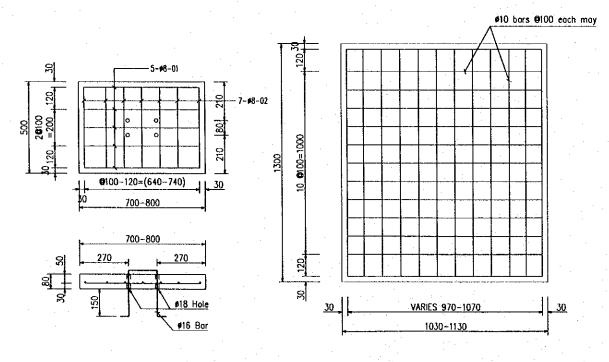

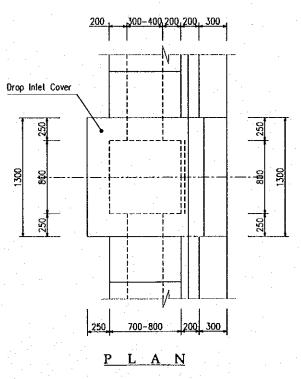

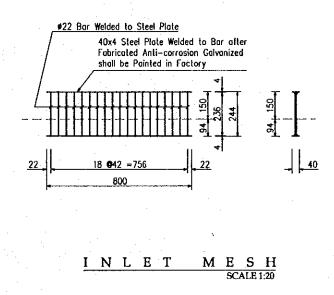

U DITCH COVER SCALE 1:20


COVER INLET SCALE 1:20

CURB INLET SCALE 1:40

PROJECT NAME
DETAILED DESIGN OF
THE CAN THO BRIDGE
CONSTRUCTION PROJECT

IMPLEMENTATION AGENCY
JAPAN INTERNATIONAL
COOPERATION AGENCY
(JICA)

EXECUTING AGENCY
SOCIALIST REPUBLIC OF VIET NAM
MINISTRY OF TRANSPORT (MOT)
MY THUAN PROJECT MANAGEMENT UNIT

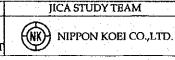

PREPARED BY CHECKED BY APPROVED BY


NAME VOHYHAI MG. VAN FRUNG M. T. WIRA WA


SIGNATURE (N.C. TW) A. J. Z.


DATE 4.4.2000 4.4.2000 CS/LY/ZCLU

DRAWING TITLE
DETAILED OF DRAINAGE
STRUCTURE - U TYPE DITCH

DWG NO. 17/25

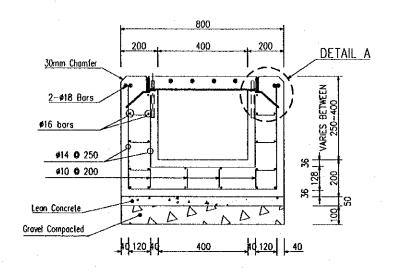

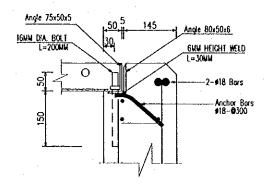


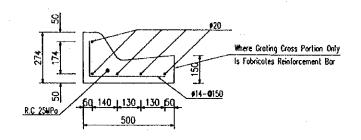


CONCRETE U DITCH SCALE 1:20

DETAIL A SCALE 1:10

CONCRETE CURB DETAIL SCALE 1:20

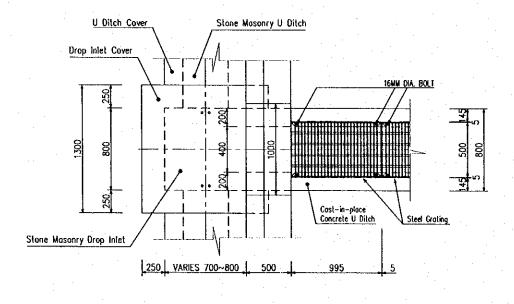

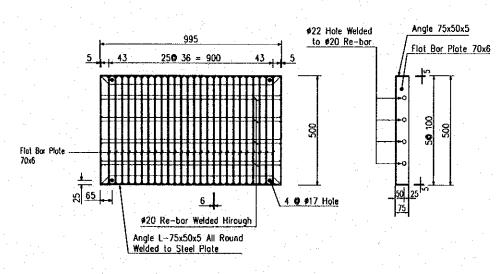



P L A N SCALE 1:40

GRATING SCALE 1:20

STEEL GRATING COVER U DITCH

PROJECT NAME	IMPLEMENTATION AGENCY	EXECUTING AGENCY	JICA STUDY TEAM		PREPARED BY	CHECKED BY APPROVED BY	DRAWING TITLE	DWG NO.
DETAILED DESIGN OF THE CAN THO BRIDGE CONSTRUCTION PROJECT	JAPAN INTERNATIONAL COOPERATION AGENCY (JICA)	SOCIALIST REPUBLIC OF VIET NAM MINISTRY OF TRANSPORT (MOT) MY THUAN PROJECT MANAGEMENT UNIT	NIPPON KOEI CO.,LTD.	NAME SIGNATURE DATE	VO HYHAI HAC 4.4.2000	HE WASTRING H. FUTIFAMAT THE STORY 2000 04/04/2000 05/04/2000	DETAILED OF DRAINAGE STRUCTURE U-TYPE GRATING COVER	18/25

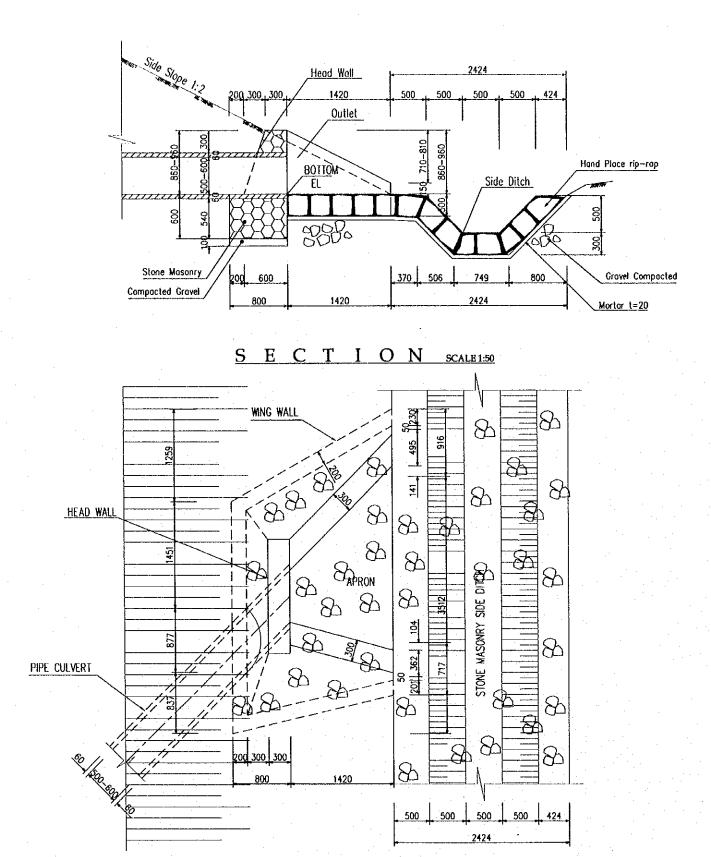

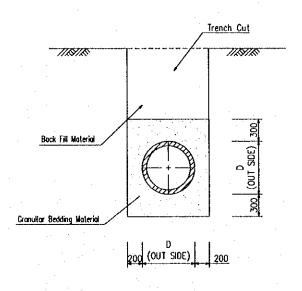



PIPE BEDDING SCALE 1:50

PLAN OF PIPE CULVERT AND OUTLET SCALE 1-50

PIPE CULVERT OUTLET AND SIDE DITCH


PROJECT NAME	IMPLEMENTATION AGENCY	EXECUTING AGENCY	JICA STUDY TEAM		PREPARED BY CHECKED BY AI	PPROVED BY	DRAWING TITLE	DWG NO.
DETAILED DESIGN OF THE CAN THO BRIDGE CONSTRUCTION PROJECT	JAPAN INTERNATIONAL COOPERATION AGENCY (JICA)	SOCIALIST REPUBLIC OF VIET NAM MINISTRY OF TRANSPORT (MOT) MY THUAN PROJECT MANAGEMENT UNIT	NIPPON KOEI CO.,LTD.	NAME SIGNATURE DATE	VOHYHAI WS YM TRUM HO 140 TWS 9.4.2000 04/11/2000 05	FUTIKIWA NATEGOD	DETAILED OF DRAINAGE STRUCTURE PLAN OF PIPE CULVERT AND OUTLET	19/25

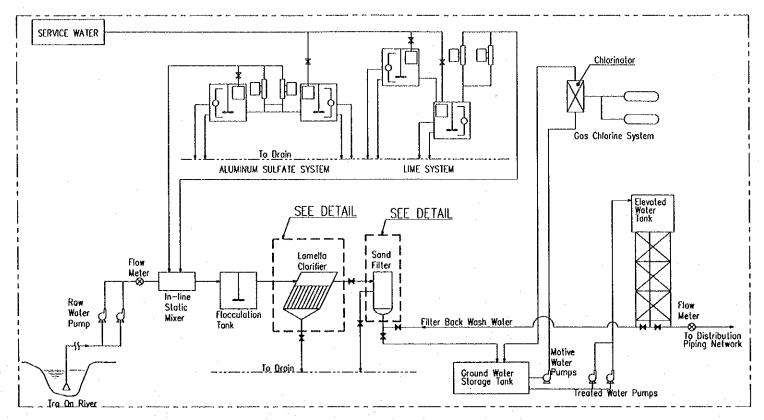

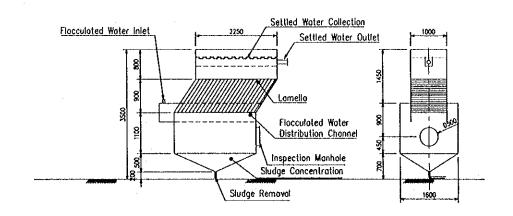

LAMELLA CLARIFIER SCA

WATER TREATMENT PLANT DIAGRAM NOT TO SCALE

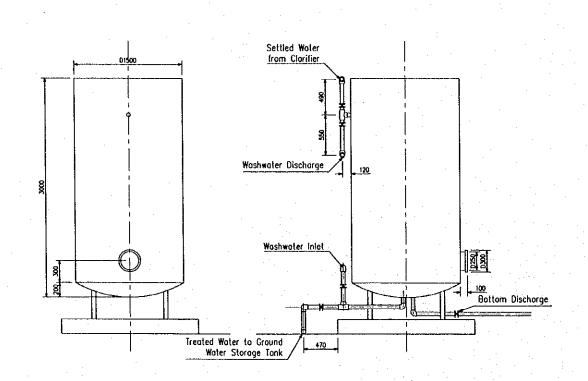

ON PHYSICAL - CHEMICAL ASPECTS

	mporary criteria issued	·		
No	Parameter	Unit	Urban Area	Country Side
1_	Cleamess Sneller	cm	> 30	> 25
2	Color	degree	< 10	< 10
3	Odour, taste	point	0	0
4	Suspended solid	mg/l	5	20
5	Total dry solid	mg/l	500	1000
6	pH		6.5 - 8.5	6.5 - 8.5
7	Hardness	mg/l	500	500
8	Chlorides			
	- Coastal area	mg/l	400	500
	- Inland	mg/l	250	250
9.	Oxidation (Organic)	mg/l	0.5 - 0.2	2.0 - 4.0
10	Ammonium			
	- Surface water	mg/l	0	. 0
	- Ground water	rng/i	3	3
11	Nitrites (NO2)	mg/l	0	0
12	Nitrates (NO3)	mg/l	10	10
- 13	Aluminum (Al)	mg/l	0.2	0.2
14	Copper (Cu)	mg/l	1	1
15	Iron (Fe)	mg/l	0.3	0.5
16	Manganese (Mn)	mg/l	0.1	0.1
17	Sodium (Na)	mg/l	200	200
-18	Sulfates (SO4)	mg/l.	400	400
. 19	Zinc (Zn)	mg/i	5	5
20	Hydrogen Suffide (S)		0	0


ON MICROBIOLOGICAL AND CREATURAL ASPECTS


М	Parameters	Unit	Value	Remark
1	MICROBIOLOGICAL CRITERIA			1
	A. Water supply by piping system			
	Treated water in network		ŀ	Turbidity 1 NTU
	- Faecal coliforms/100ml		0	Desinffection with
				Chlorine, pH=8.0
	- Coliforms Organisms/100ml		0	Contacting time 30 mln. ar
			ŀ	residual chlorine 0.2-0.5 m
	2. No treatment performed in network		ŀ	
	- Faecal coliforms/100ml		0	With 98% admissible
		ľ		samples a year
	- Coliforms Organisms/100mi		< 3	Occasionally
	3. Water in network			
	- Faecal coliforms/100ml		0	With 98% admissible
				samples a year
	- Coliforms Organisms/100ml		< 3	Occasionally
. '				
	B. Water supplied without piping system		l	
	- Faecal coliforms/100ml		0	Not often. And if it is often
	- Coliforms Organisms/100ml		10	a senitary check & water
				source protection measure
				ment should be taken
	C. Bottled water	l		
	- Faecal coliforms/100mi		0	
	- Coliforms Organisms/100ml		0	
				
	D. Emergency water supply system		_	
	Faecal coliforms/100ml		0	in case of emergency wat
	- Coliforms Organisms/100ml		0	should be boiled
II	CREATURAL CRITERIA			
	- Protozoa	}	. 0	
	- Helminths	1	0	
	- Zoo plankton & algae	L	0	L


SAND FILTER TANK SCALE 1:5


WATER TREATMENT REQUIREMENT FOR DRINKING WATER


PROJECT NAME	IMPLEMENTATION AGENCY	EXECUTING AGENCY	JICA STUDY TEAM	PREPARED BY	CHECKED BY APPROVED BY	DRAWING TITLE	DWG NO.
DETAILED DESIGN OF	JAPAN INTERNATIONAL	SOCIALIST REPUBLIC OF VIET NAM	8	NAME VOHYHAI	TRAN-Q-CU M. FUTIFAWA	DETAILED OF	00.405
THE CAN THO BRIDGE	LINE COOPERATION AGENCY	MINISTRY OF TRANSPORT (MOT)	(NK)) NIPPON KOEI CO.,LTD.	SIGNATURE AFAC	ought white		20/25
CONSTRUCTION PROJECT	(JICA)	MY THUAN PROJECT MANAGEMENT UNIT	Θ	DATE 4.4.2.000	4.4.2000 15/14/2010	WATER TREATMENT DIAGRAM	

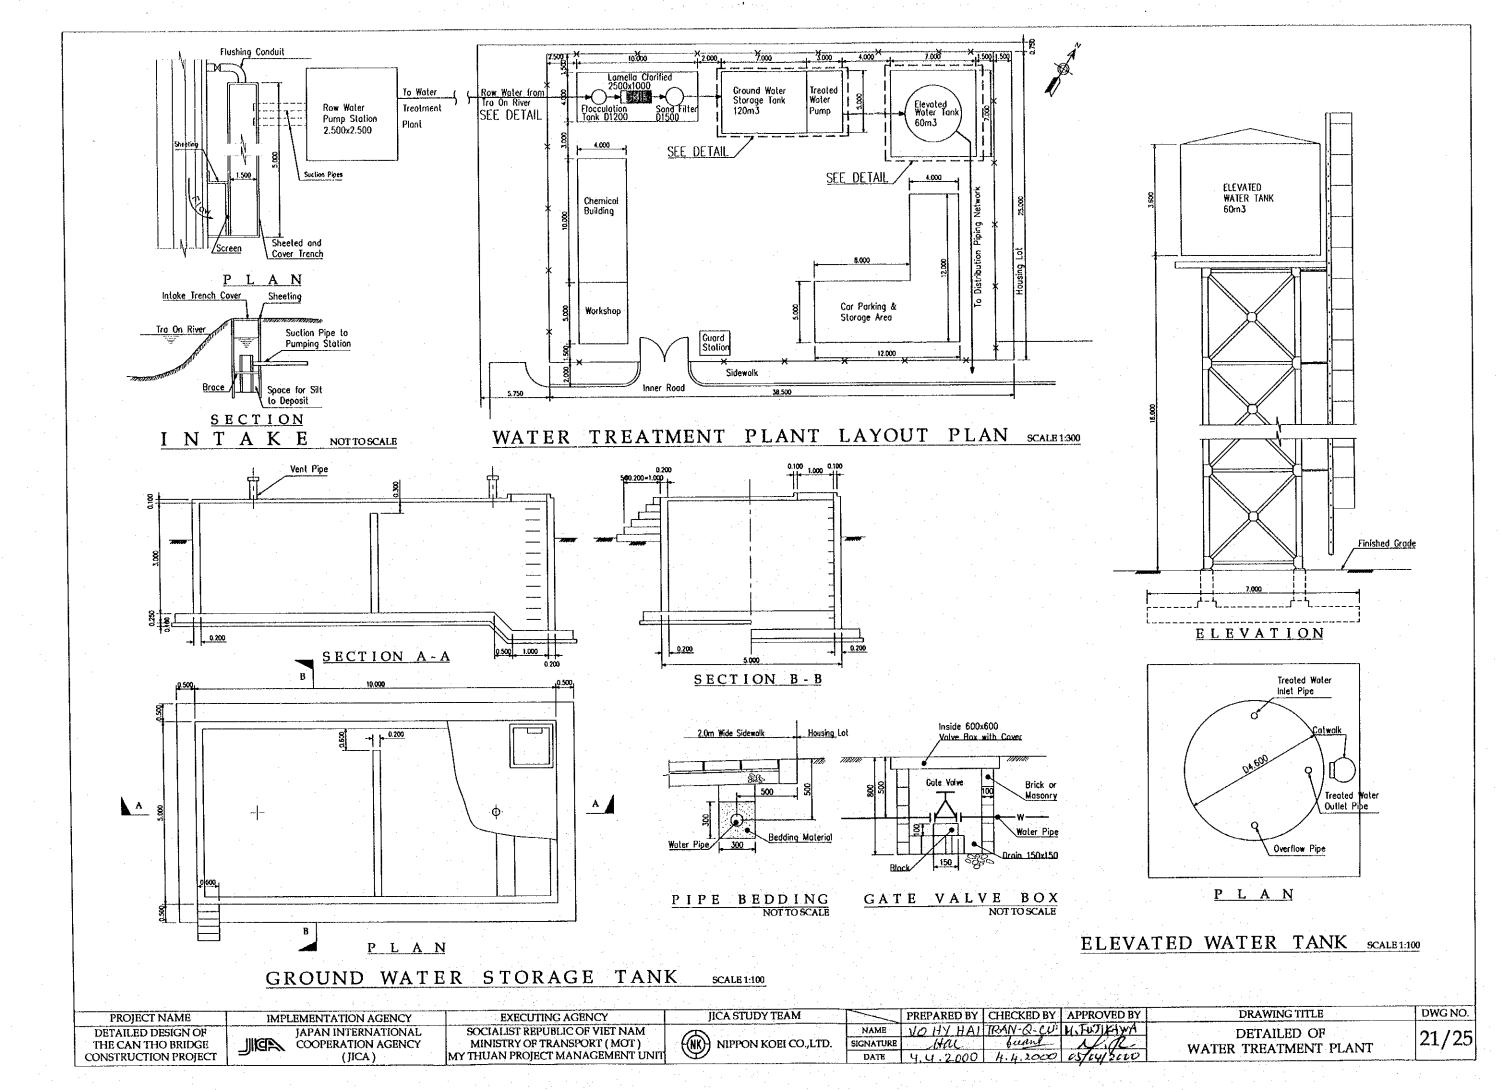


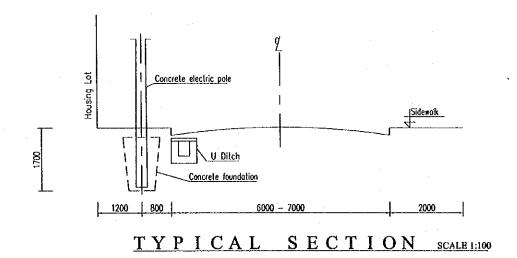

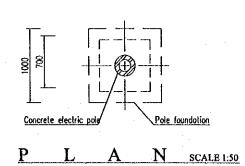

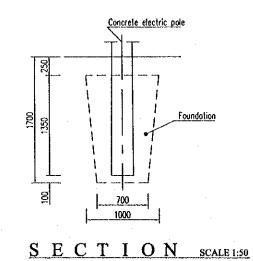

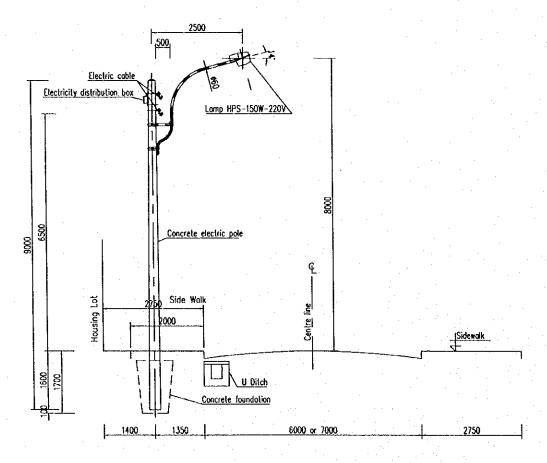


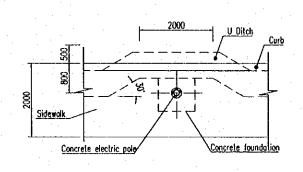


INSTALL DITCH AT FOUNDATION SCALE 1:100

TYPI	CAL	SECTI	ON	SCALE 1:100
	The state of the s			

PROJECT NAME IMPLEMENTATION AGENCY	EXECUTING AGENCY	JICA STUDY TEAM		PREPARED BY CHECK	ED BY APPROVED BY	DRAWING TITLE	DWG NO.
DETAILED DESIGN OF THE CAN THO BRIDGE CONSTRUCTION PROJECT JIMPA TAPAN INTERNATIONAL COOPERATION AGENCY (IICA)	SOCIALIST REPUBLIC OF VIET NAM MINISTRY OF TRANSPORT (MOT) MY THUAN PROJECT MANAGEMENT UNIT	NIPPON KOBI CO.,LTD.	NAME SIGNATURE DATE	Byrky THUY BUILTY Gray 94/04/	77.7	ELECTRICAL DETAILS	22/25

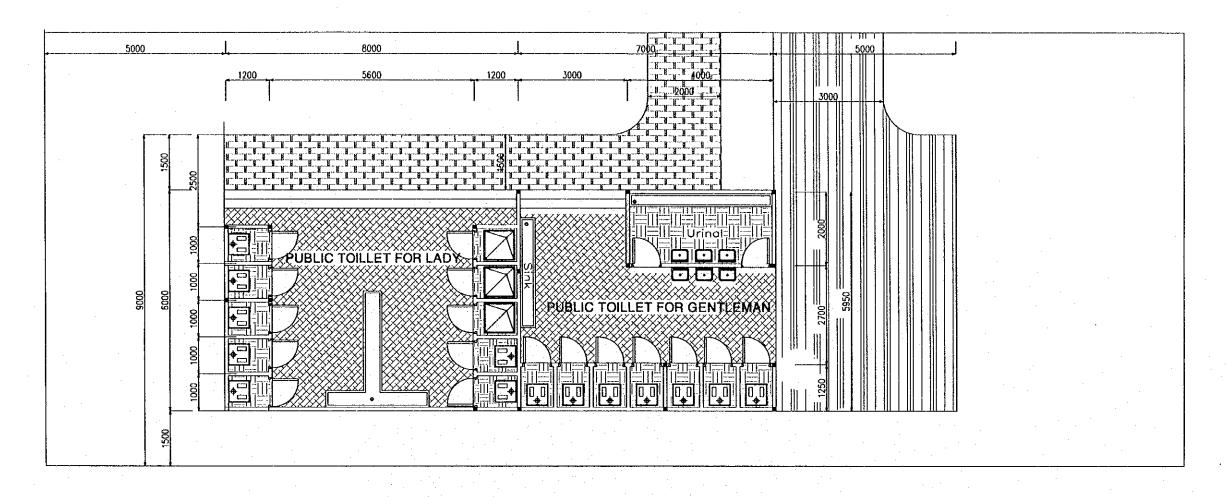





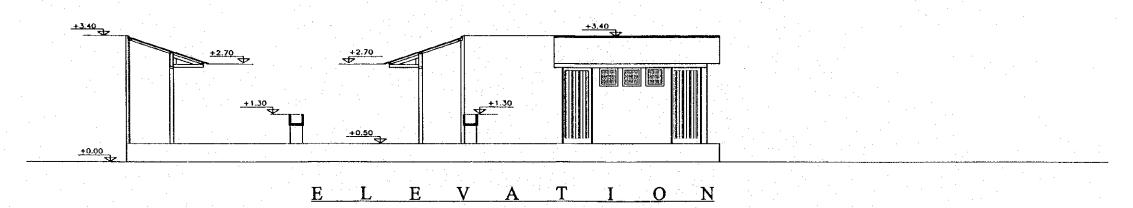

ARCHITECT - PUBLIC TOILET LAYOUT PLAN SCALE 1:100

۱ ا	PROJECT NAME	IMPLEMENTATION AGENCY	EXECUTING AGENCY	JICA STUDY TEAM		PREPARED BY	CHECKED BY APPROVED BY	DRAWING TITLE	DWG NO.
l	DETAILED DESIGN OF	JAPAN INTERNATIONAL	SOCIALIST REPUBLIC OF VIET NAM		NAME	LE THI VAN PHI	LE THE VAN PHE H. FUTIFAY4	ARCHITECT - PUBLIC TOILET FLOOR	
- 1	THE CAN THO BRIDGE	COOPERATION AGENCY	MINISTRY OF TRANSPORT (MOT)	(NK)) NIPPON KOEI CO.,LTD.	SIGNATURE	NZVI-	STALL WITE	ARCHITECT - TODERC TOTEST FLOOR	123/25
l	CONSTRUCTION PROJECT	(JICA)	MY THUAN PROJECT MANAGEMENT UNIT	9	DATE	1-4-2000	A-2-2000 65/64/2000	PLAN AND ELEVATION	/

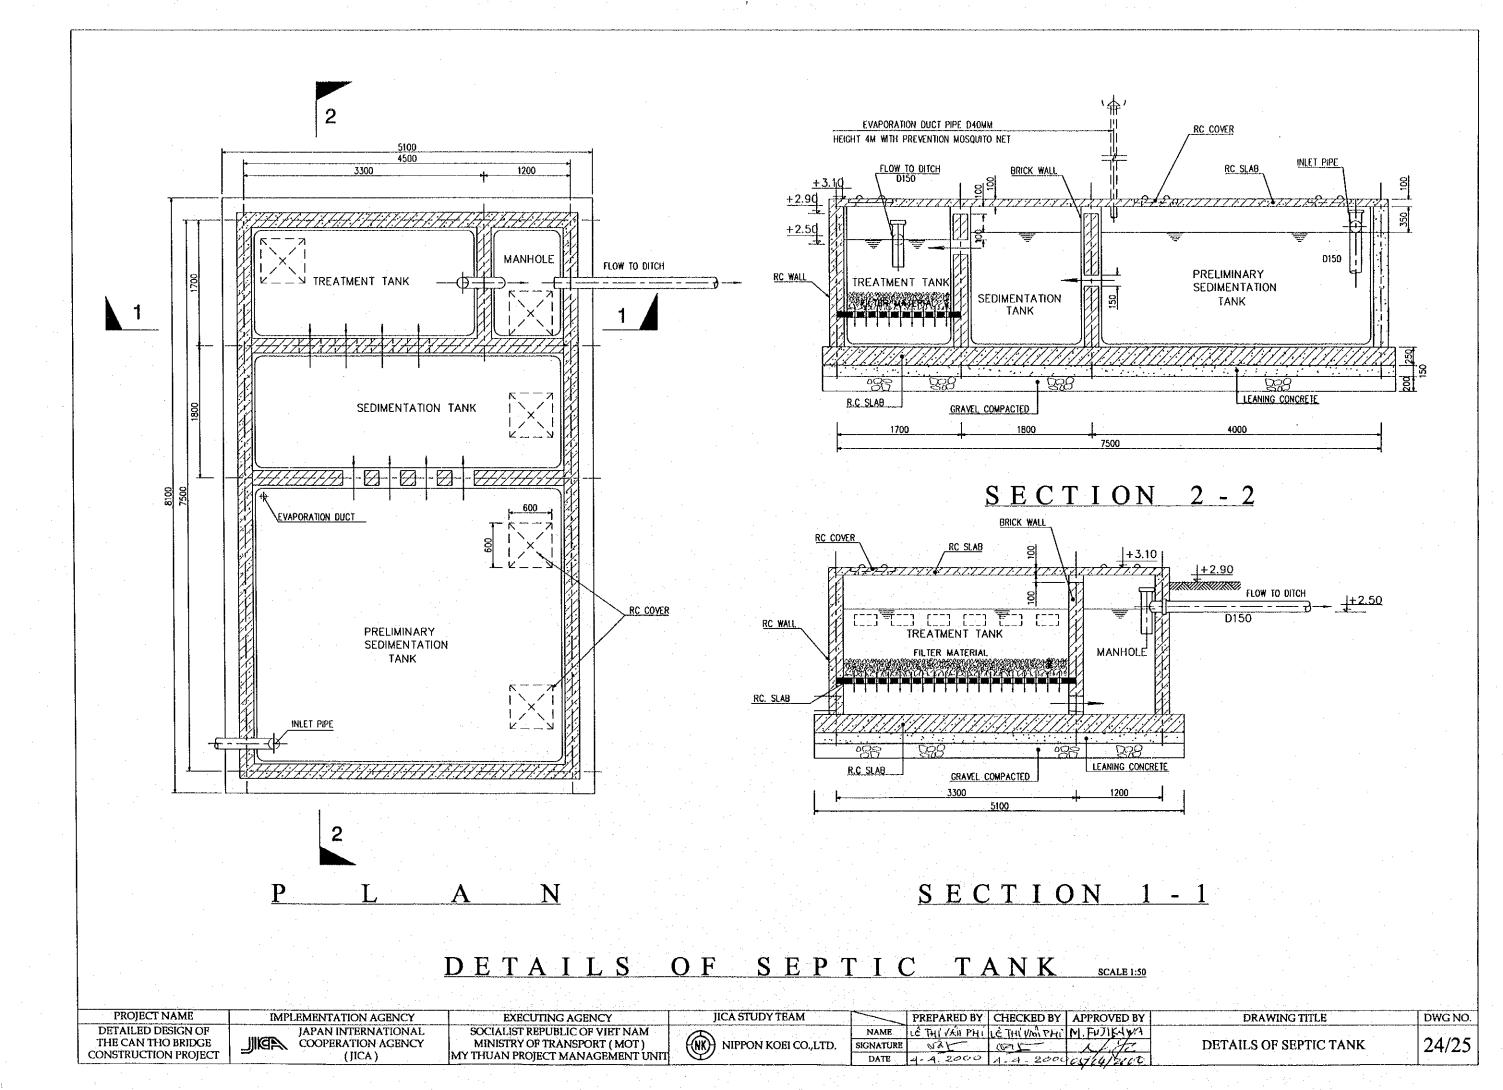

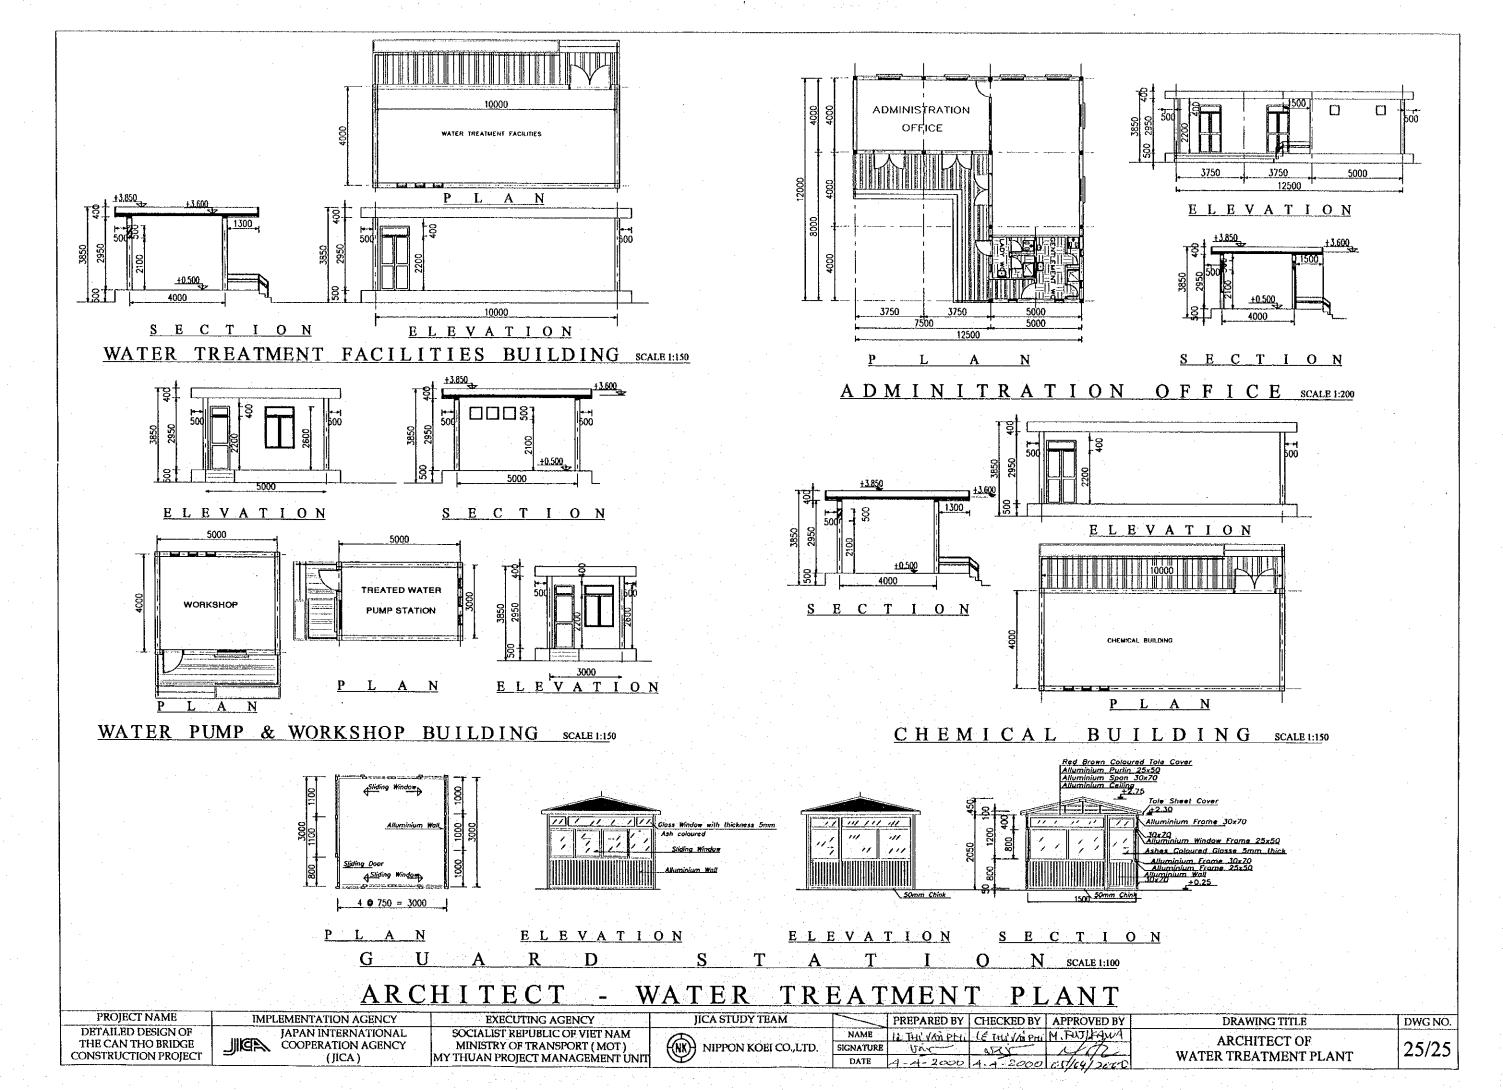

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