

# P3/LS LIGHTING SYSTEM

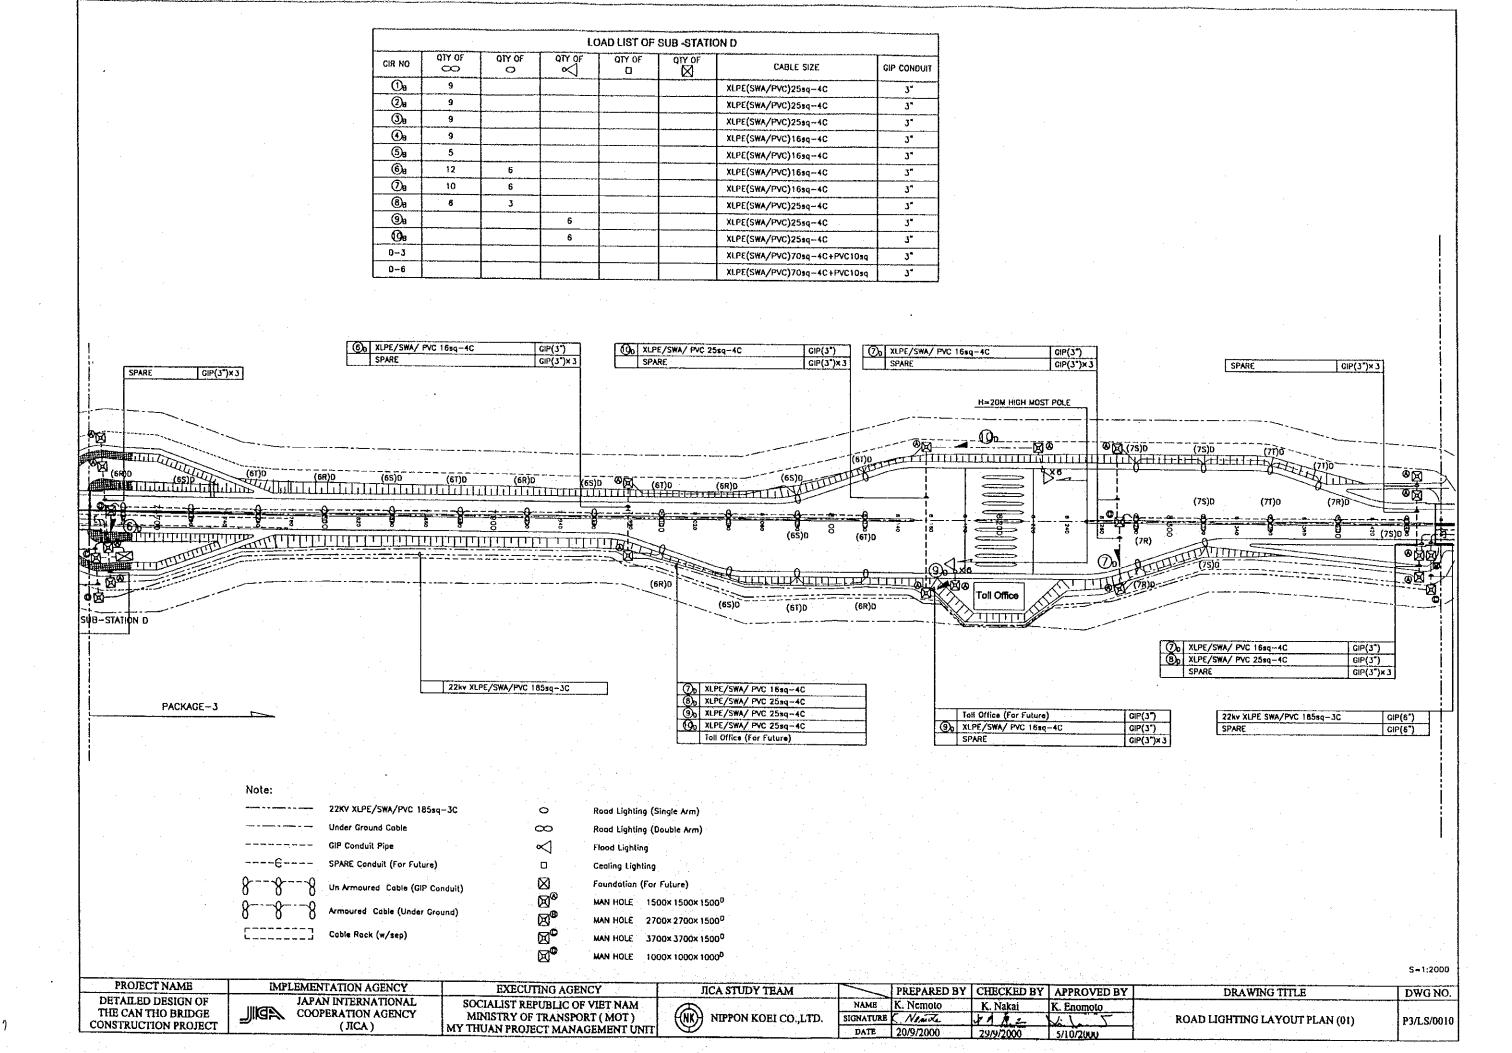

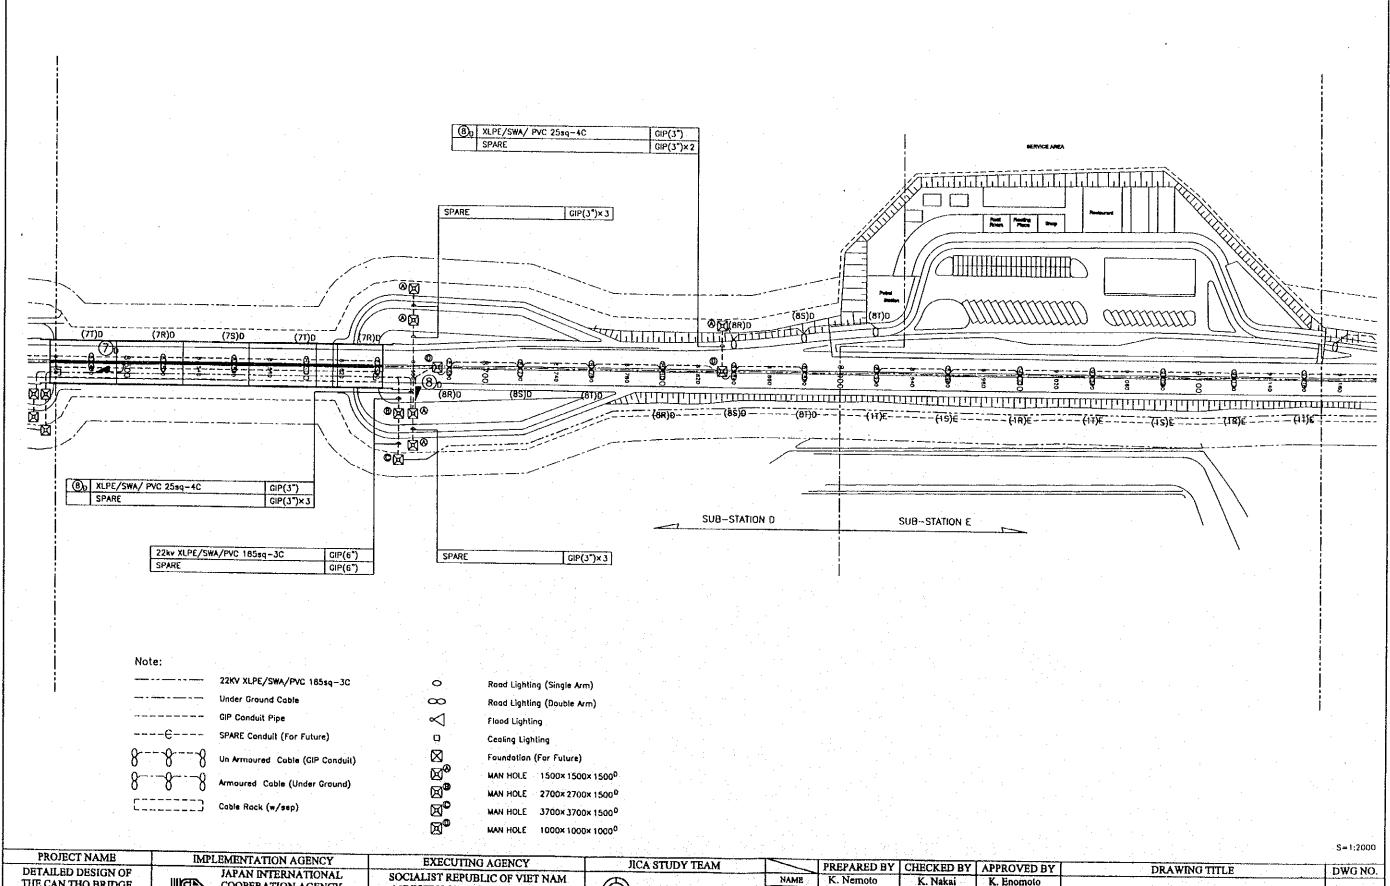

THE CAN THO BRIDGE CONSTRUCTION PROJECT

COOPERATION AGENCY (JICA)


MINISTRY OF TRANSPORT (MOT) MY THUAN PROJECT MANAGEMENT UNIT


NIPPON KOEI CO.,LTD.

K. Nakai K. Enomoto SIGNATURE L. Namula DATE 20/9/2000 29/9/2000


ROAD LIGHTING LAYOUT PLAN (02)


P3/LS/0020

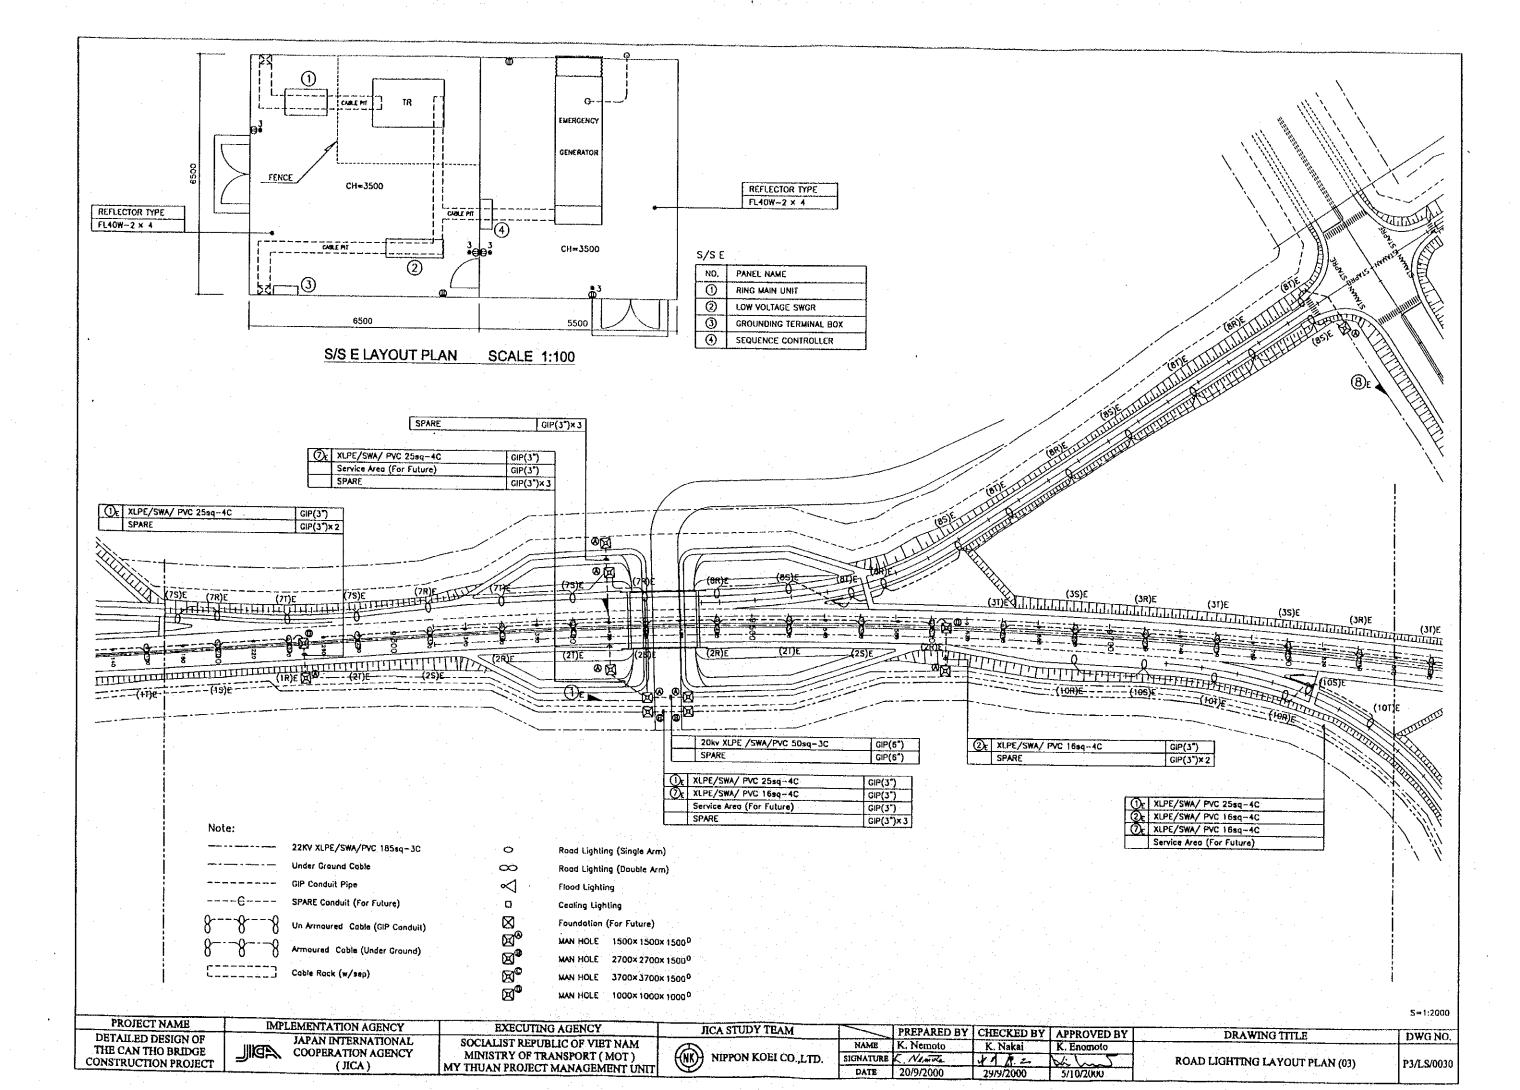


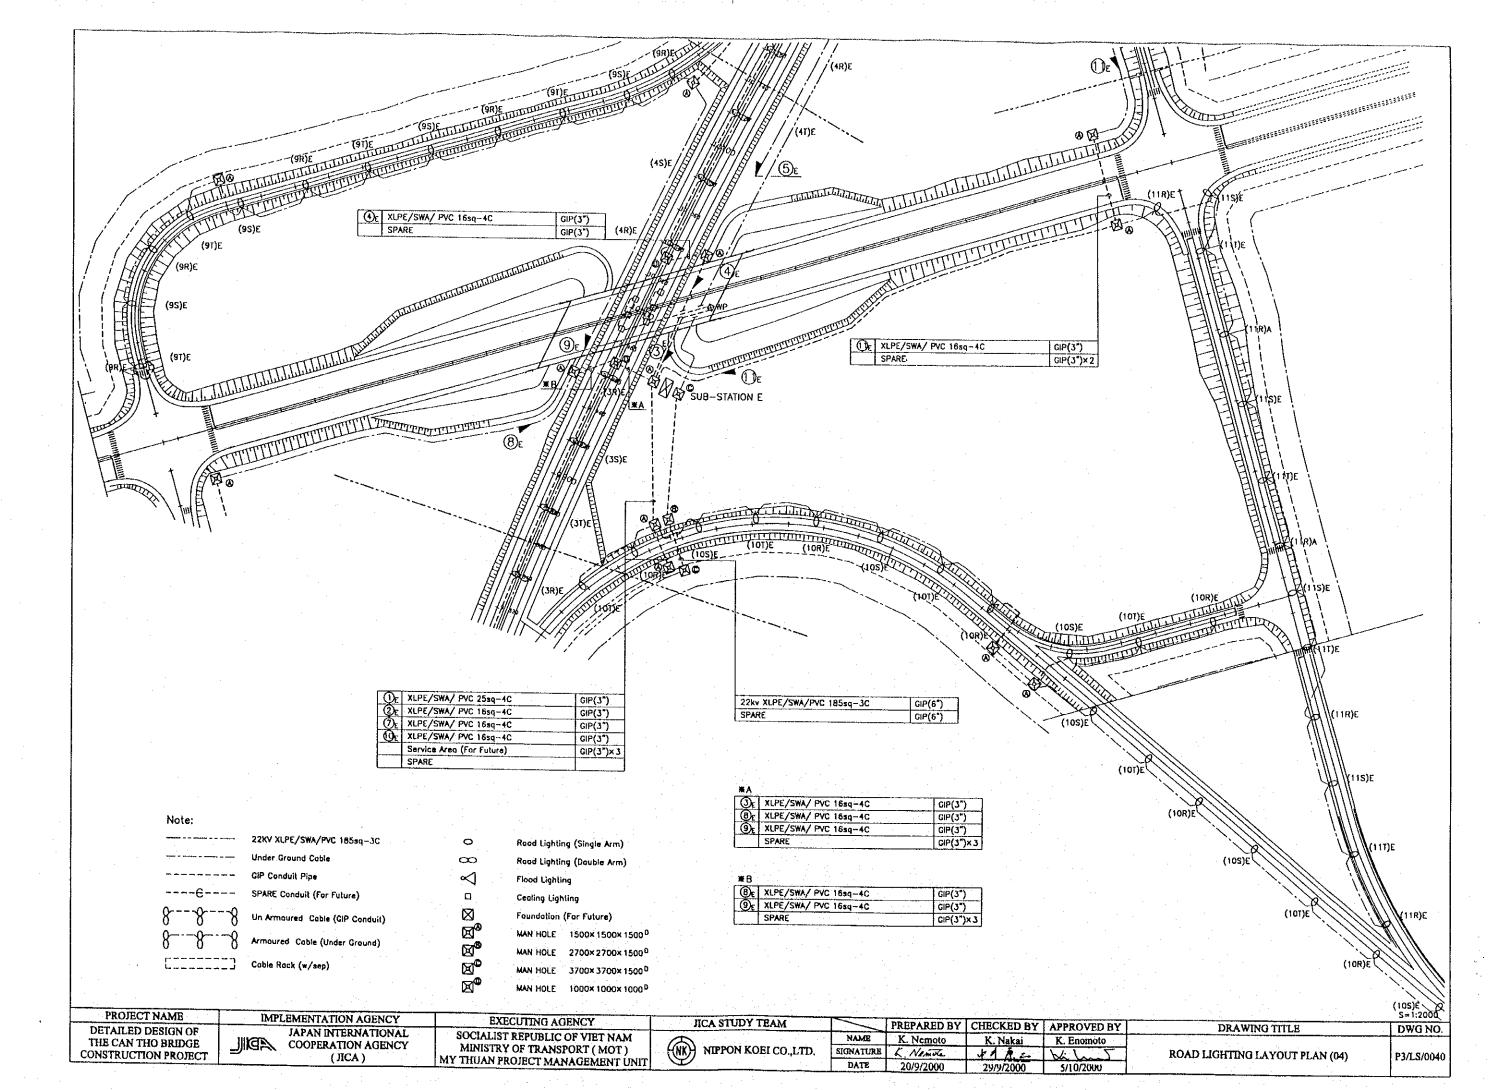



2.5

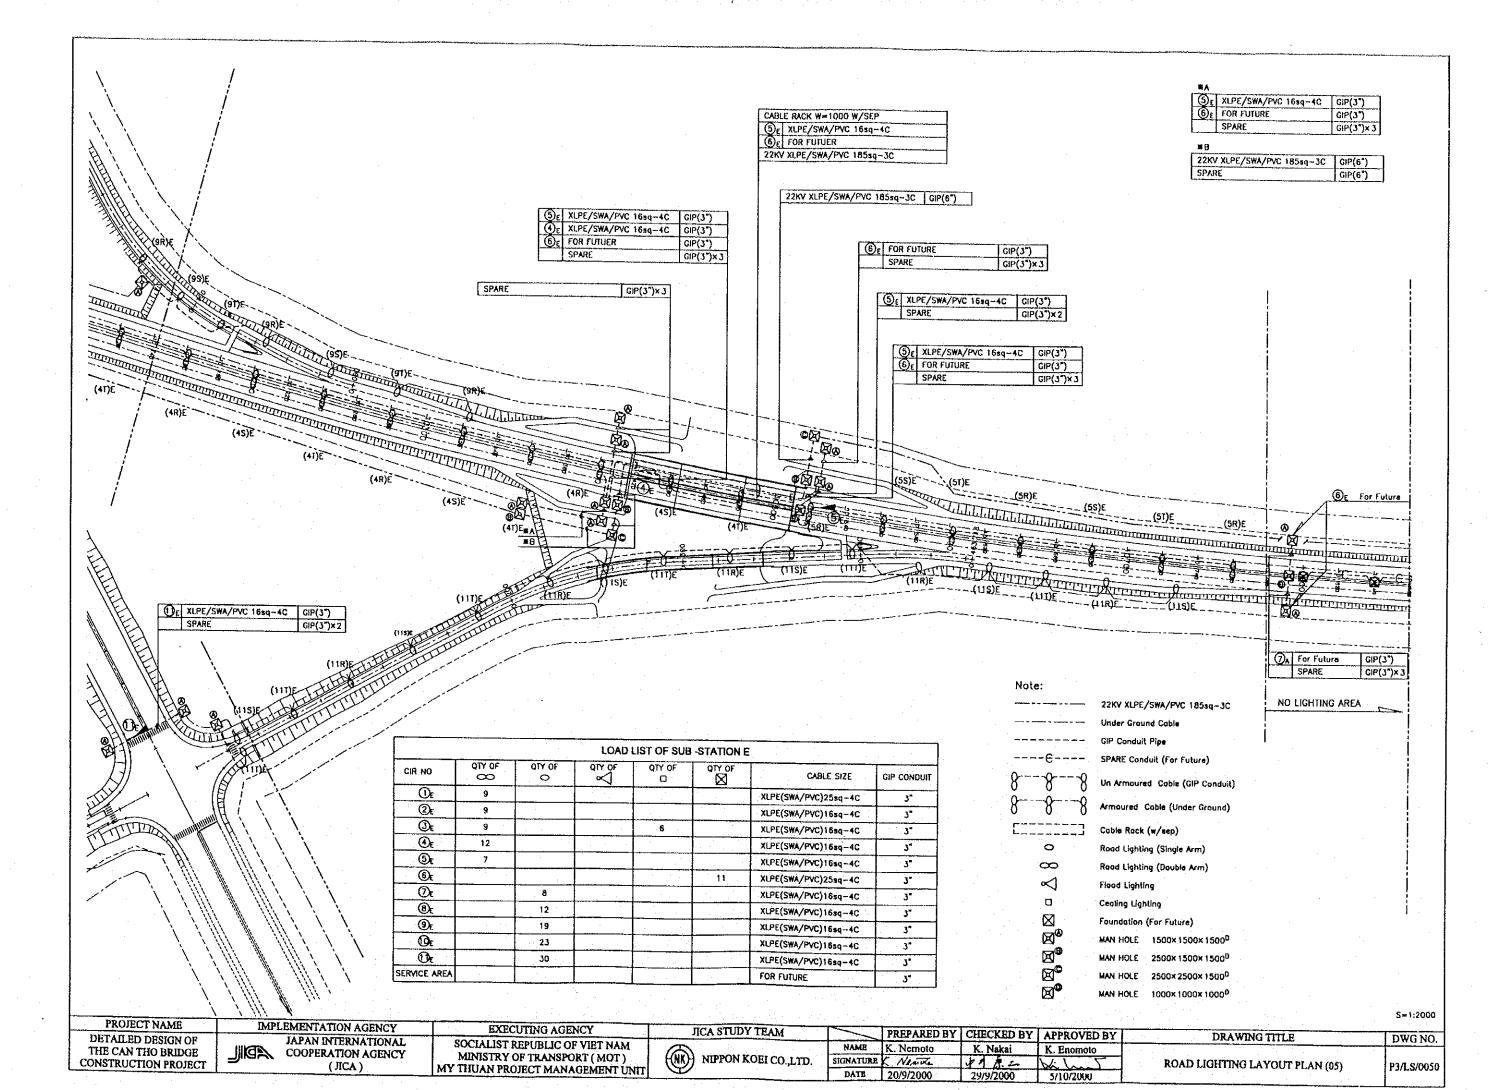


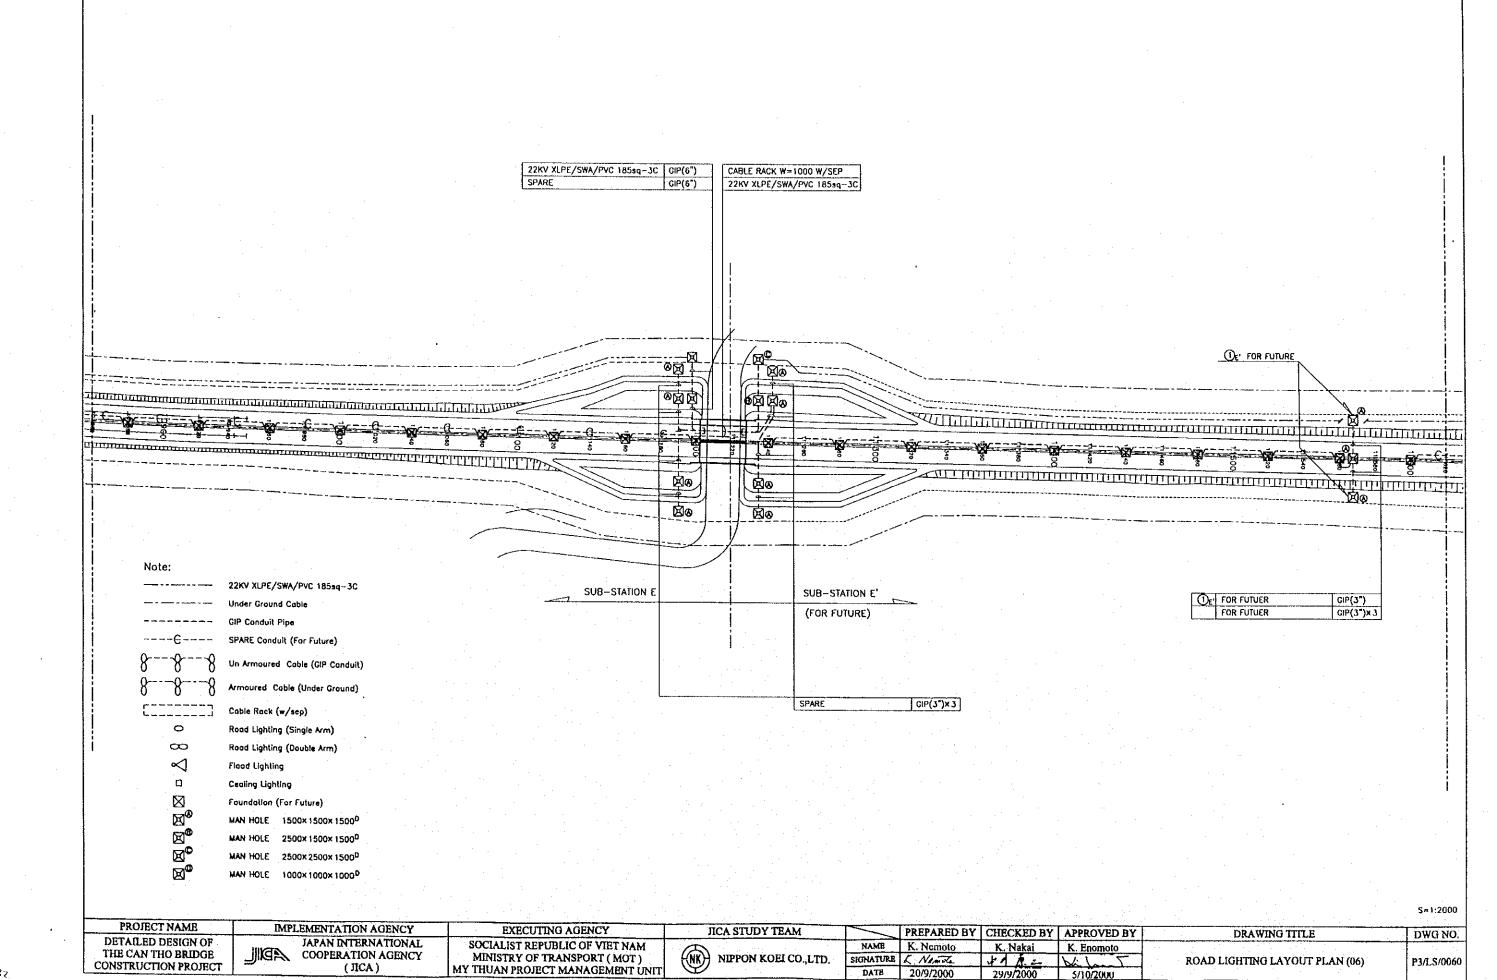


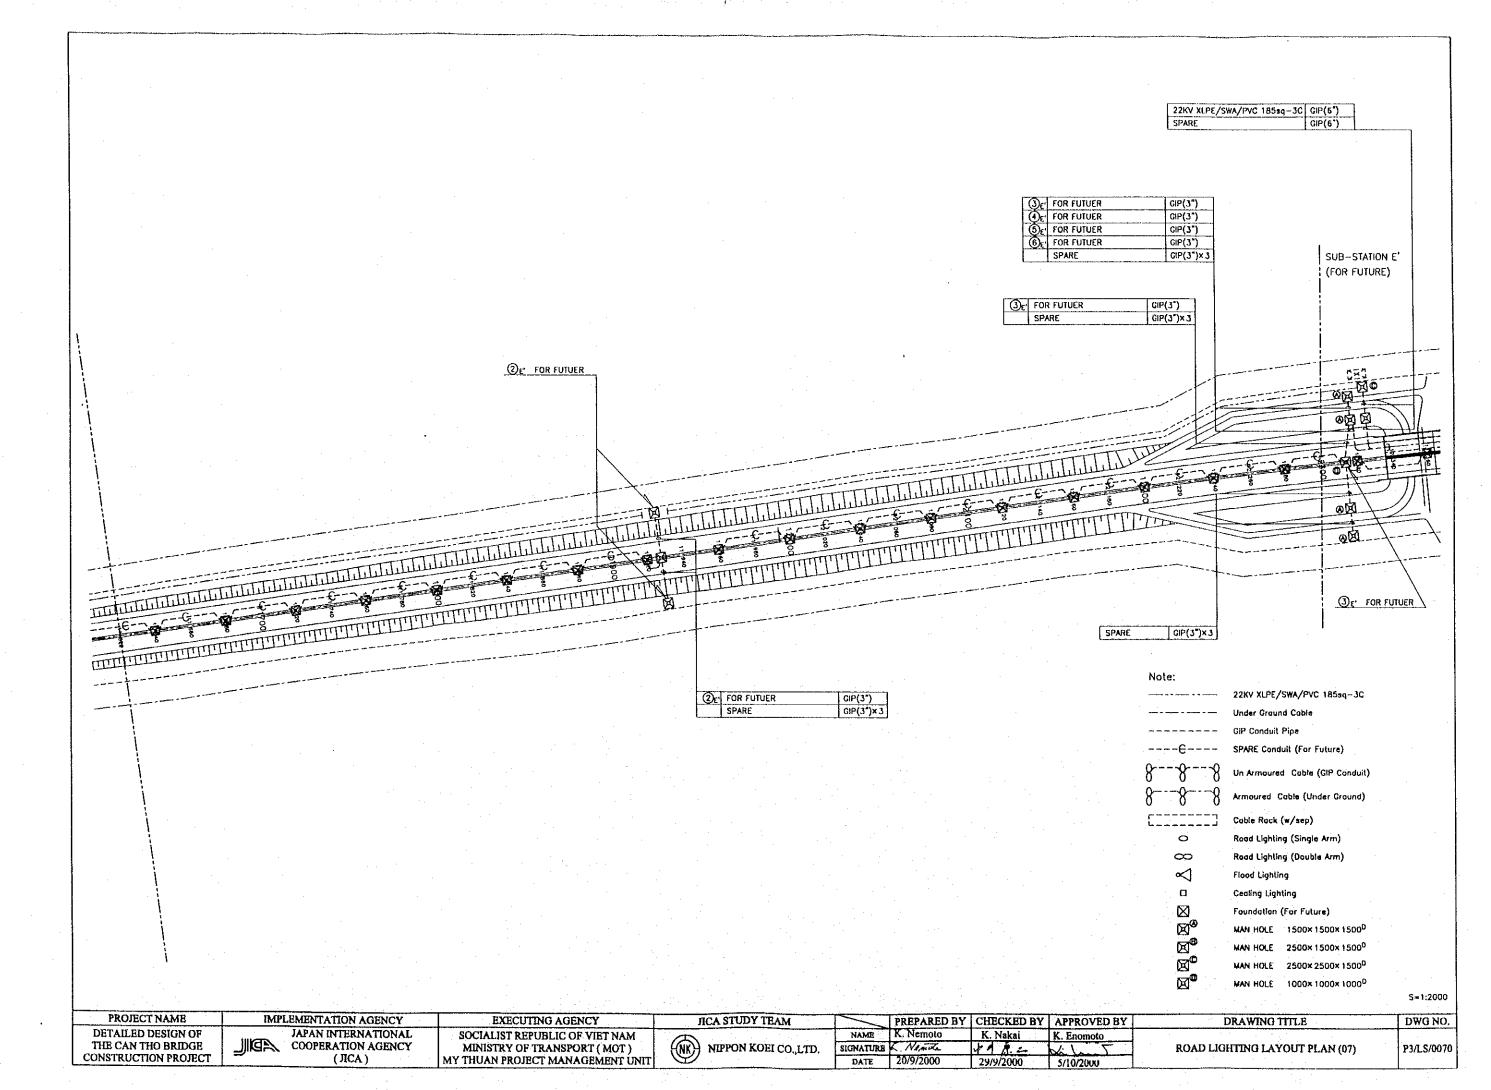

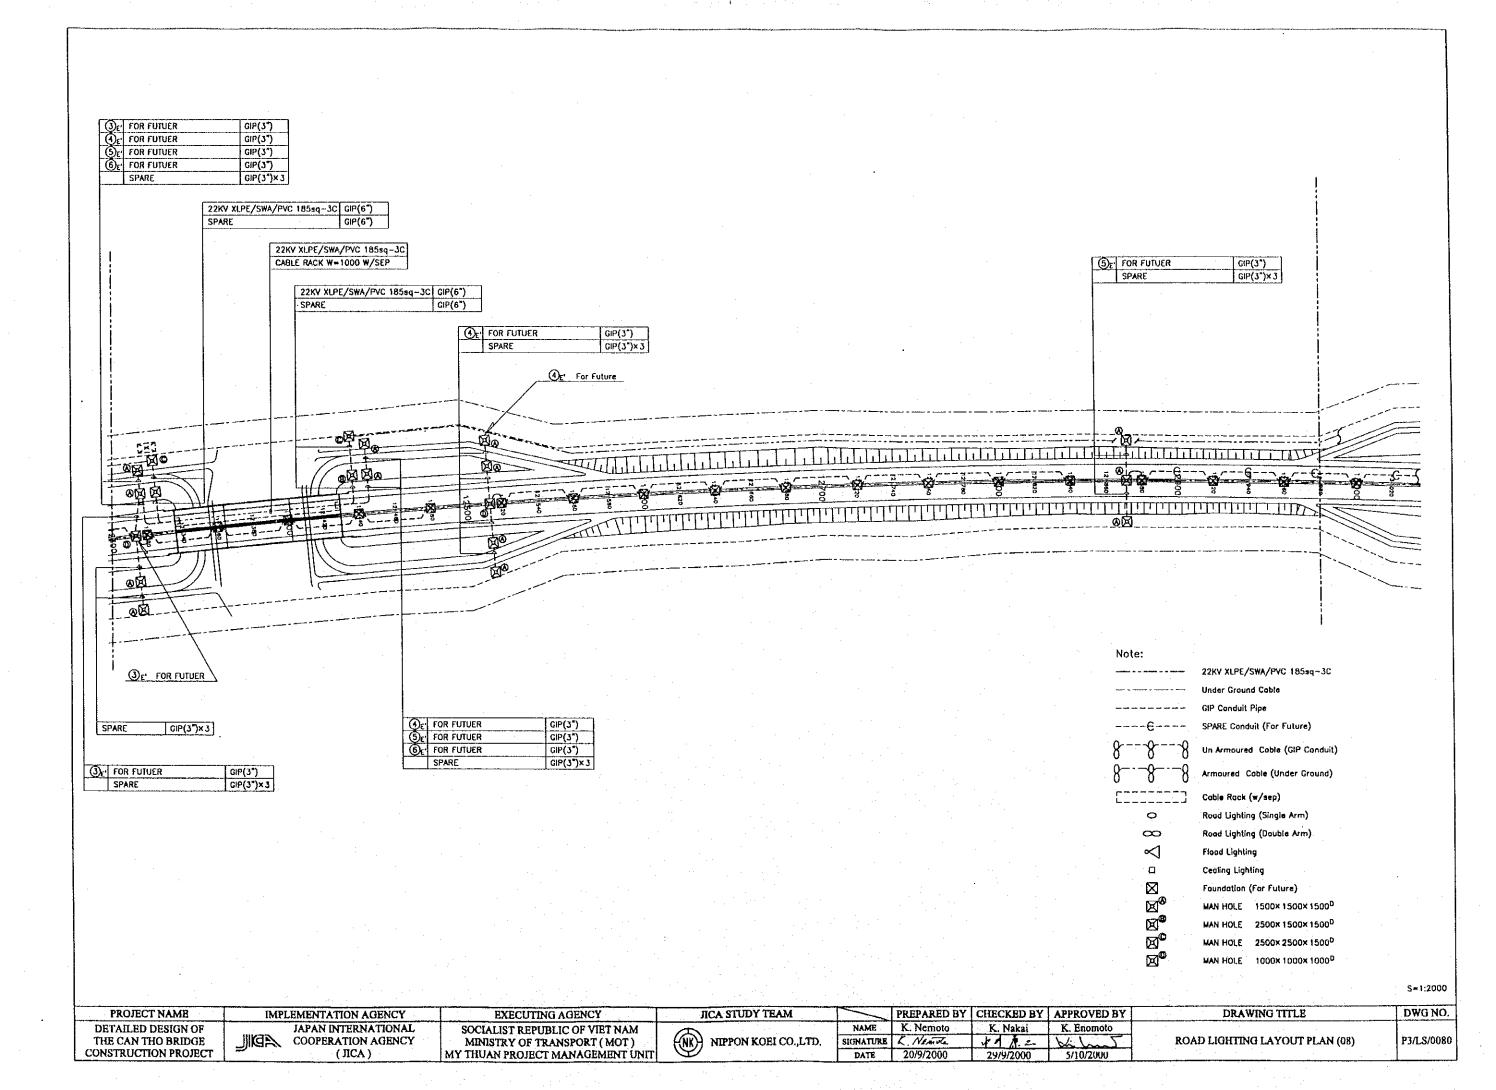

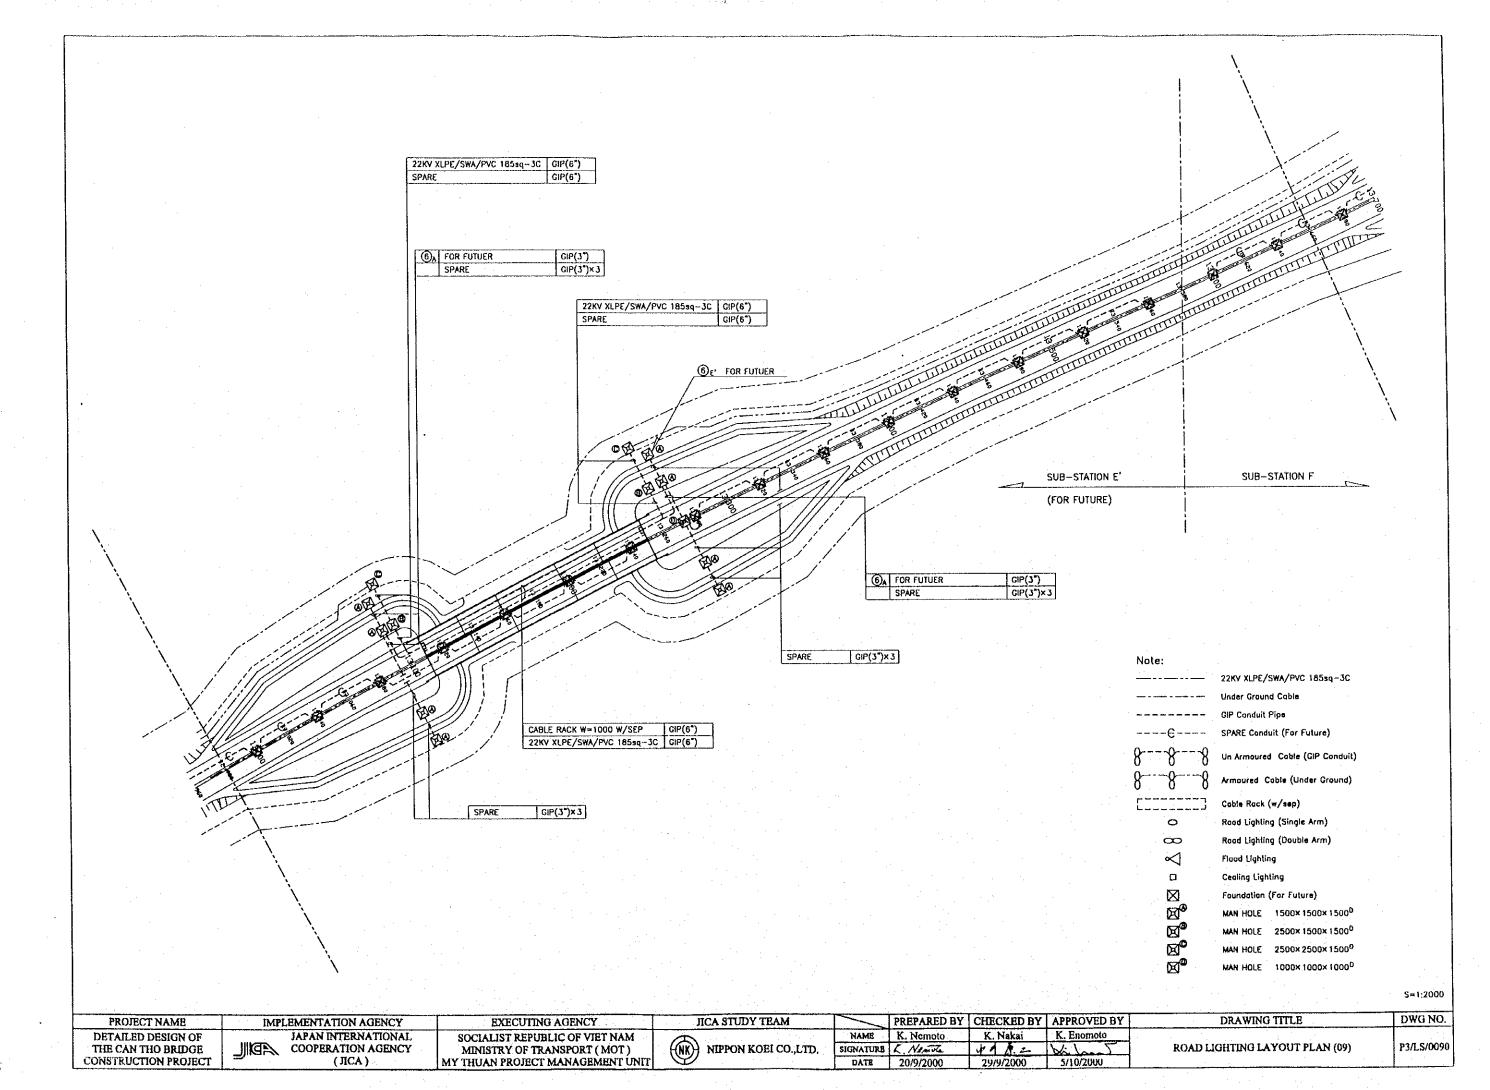


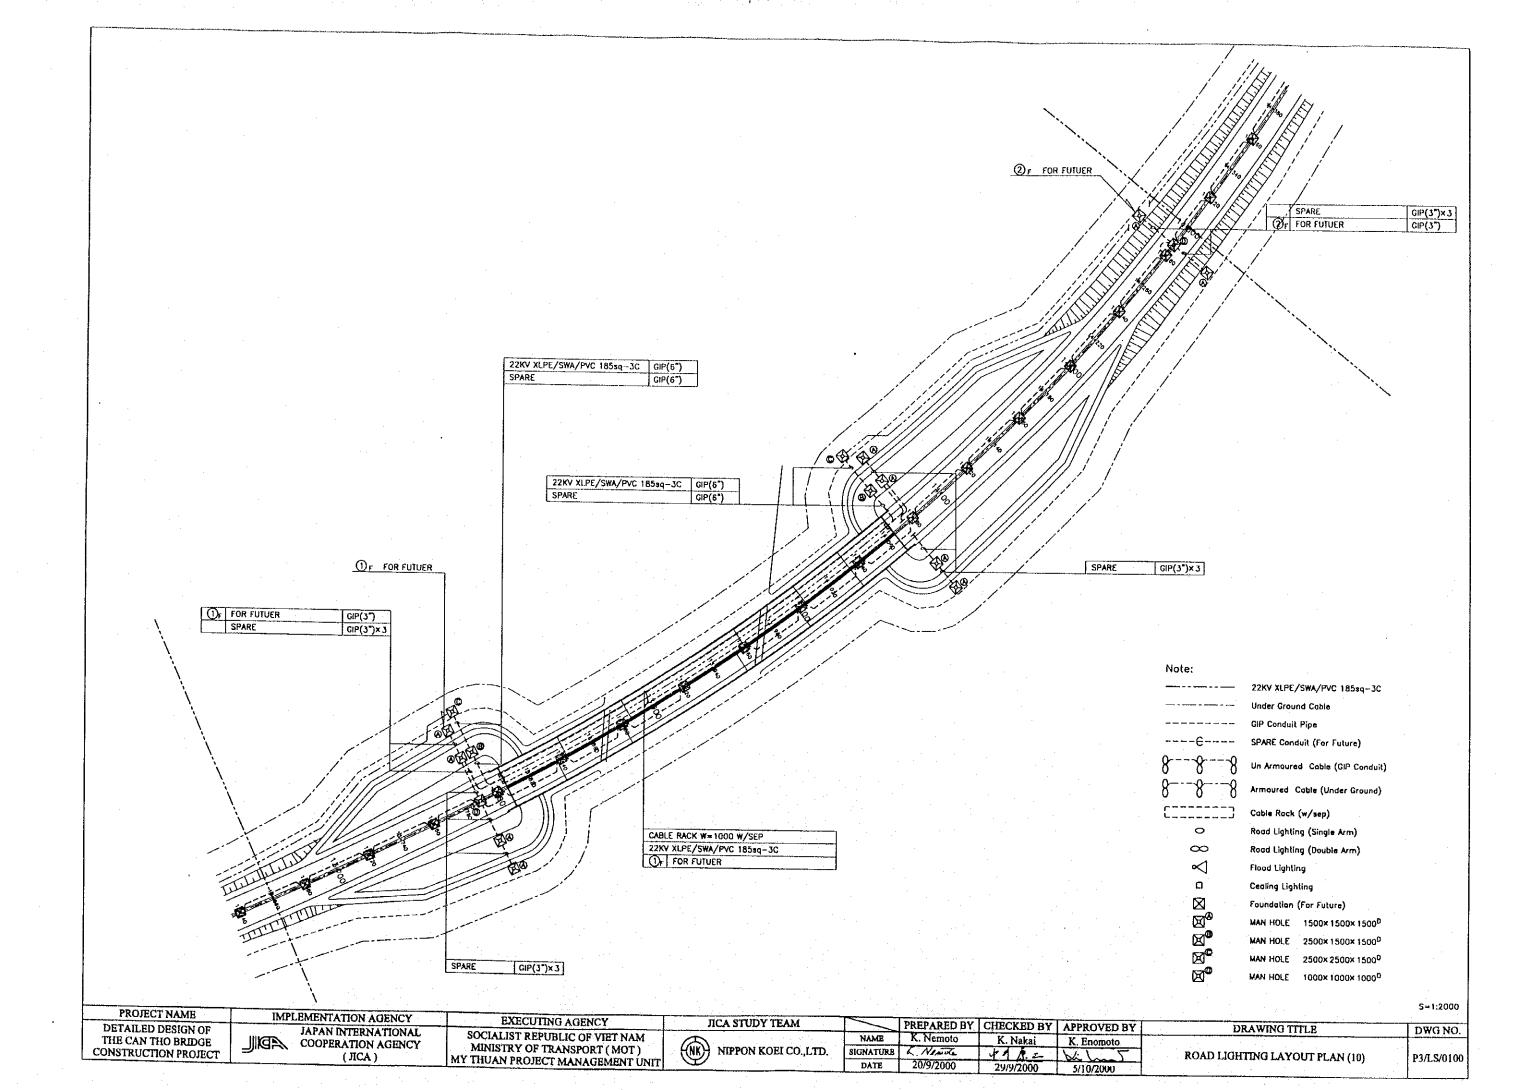


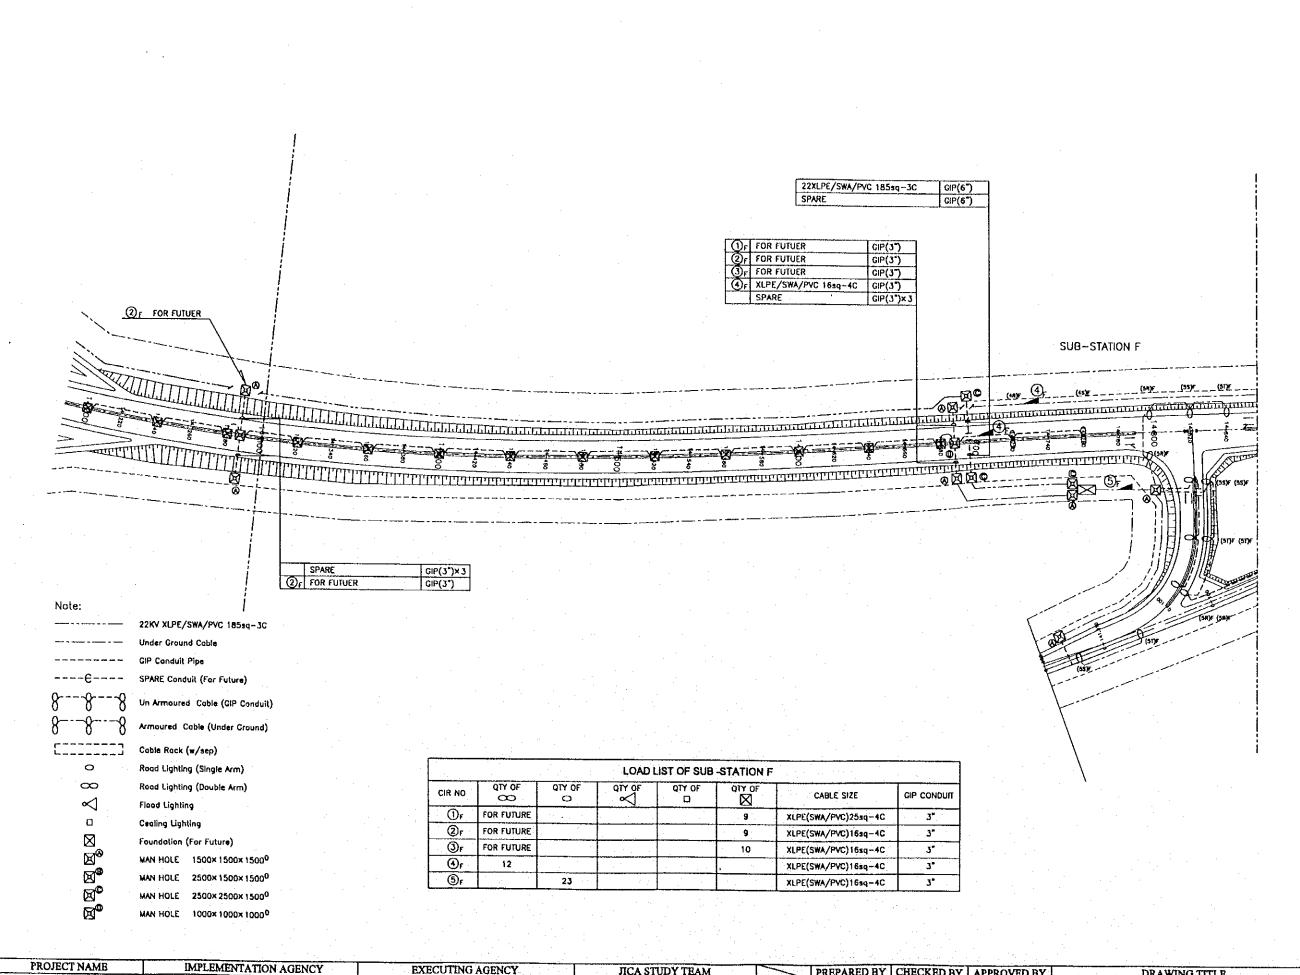



S=1:2000

EXECUTING AGENCY ЛСА STUDY TEAM PREPARED BY | CHECKED BY | APPROVED BY DRAWING TITLE DWG NO. **DETAILED DESIGN OF** JAPAN INTERNATIONAL SOCIALIST REPUBLIC OF VIET NAM K. Nemoto K. Enomoto THE CAN THO BRIDGE COOPERATION AGENCY MINISTRY OF TRANSPORT ( MOT ) NIPPON KOEI CO.,LTD. SIGNATURE & NAME **ROAD LIGHTING LAYOUT PLAN (11)** P3/LS/0110 CONSTRUCTION PROJECT (JICA) MY THUAN PROJECT MANAGEMENT UNIT DATE 20/9/2000

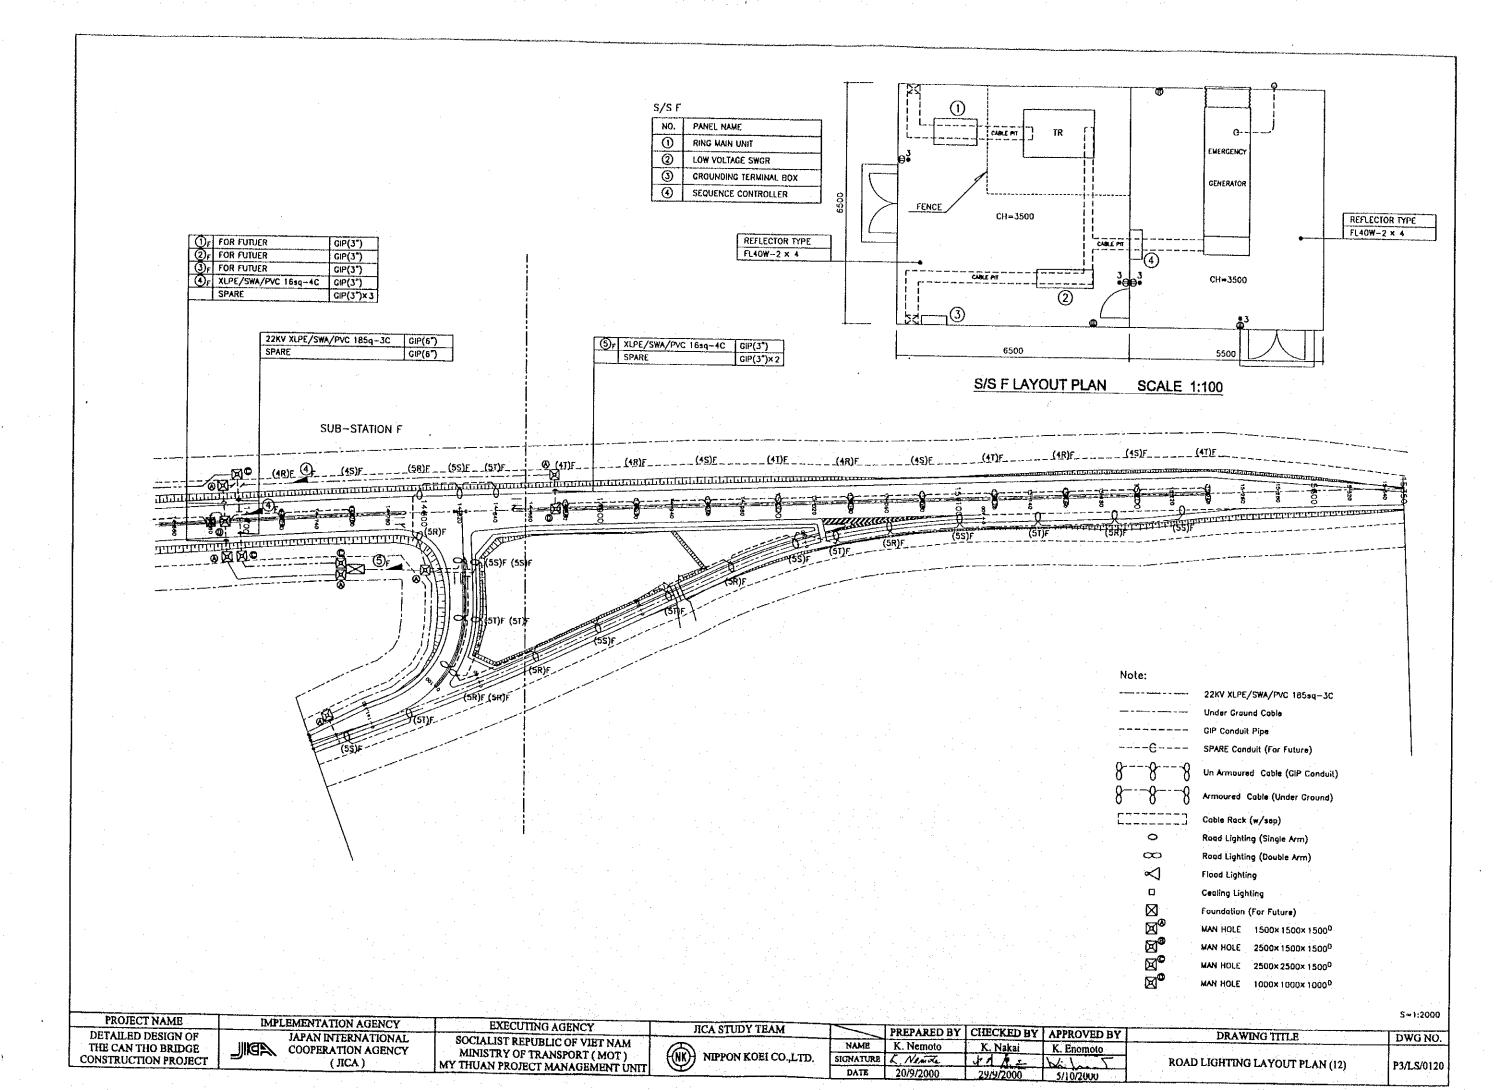

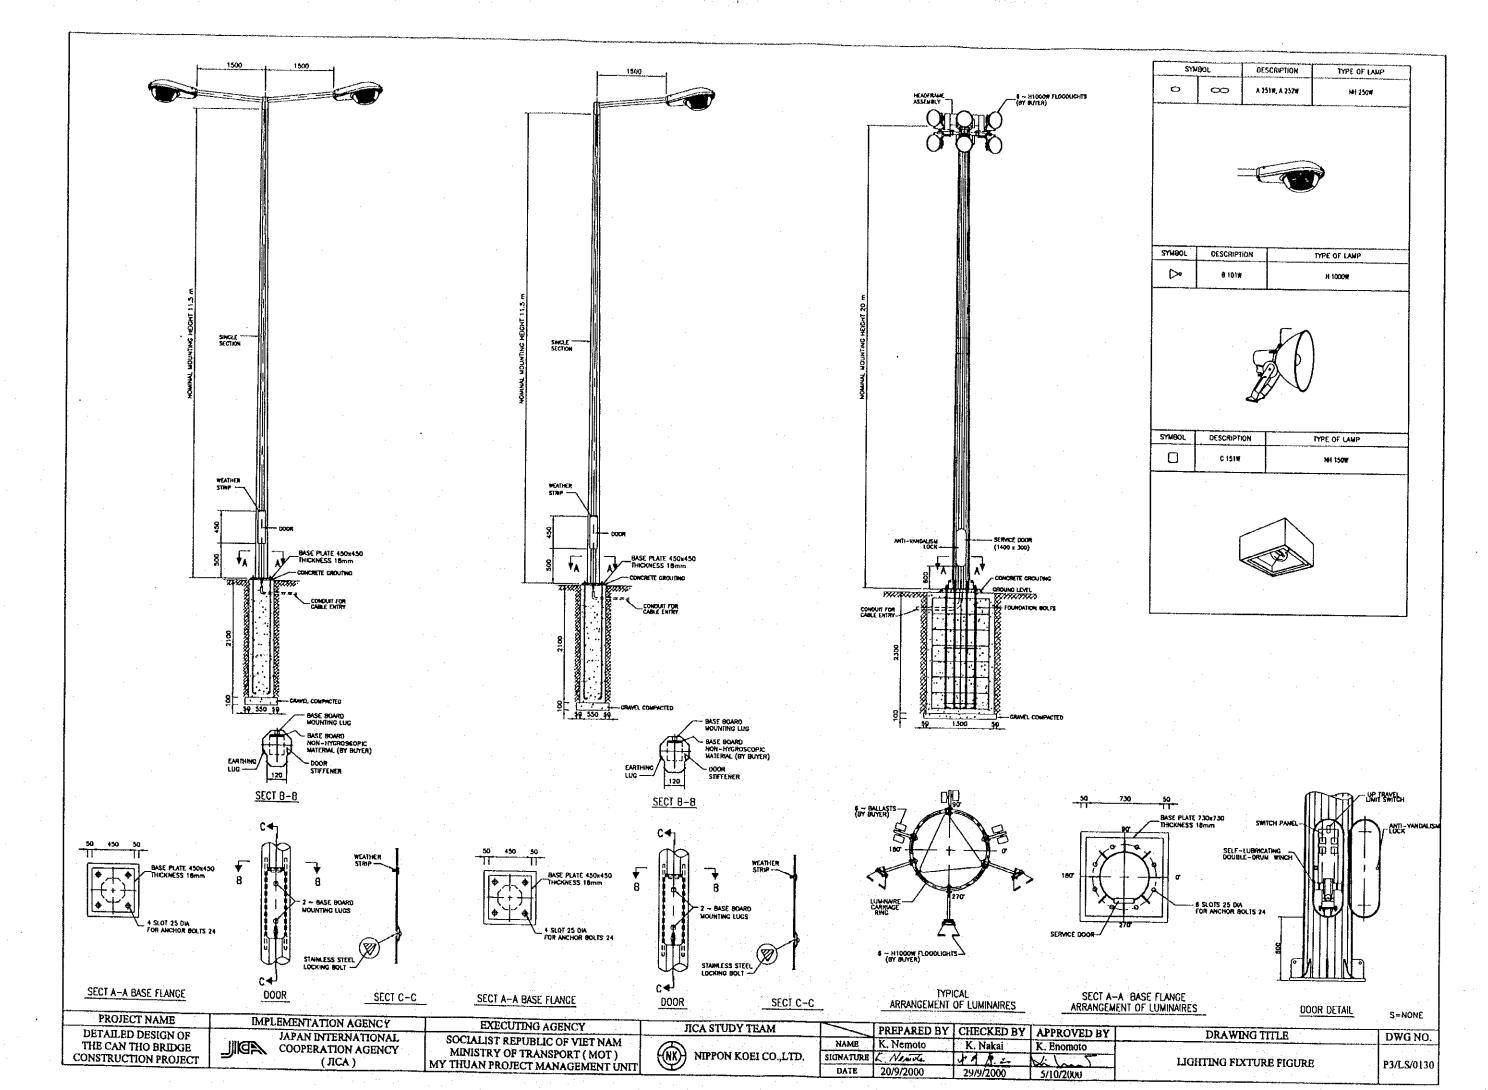


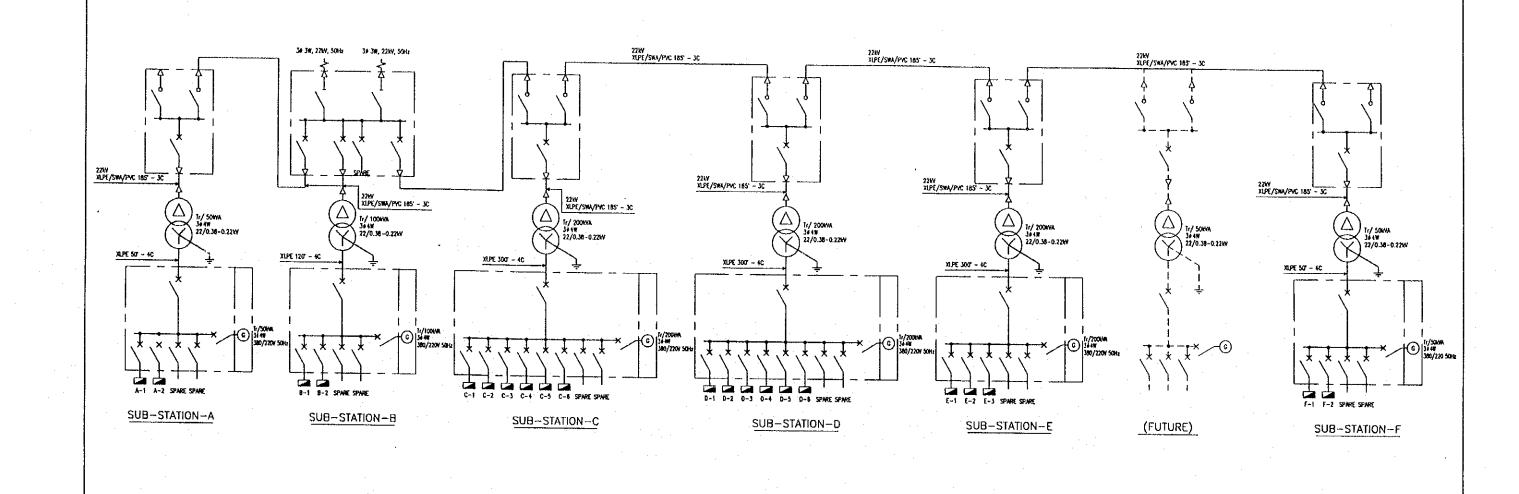

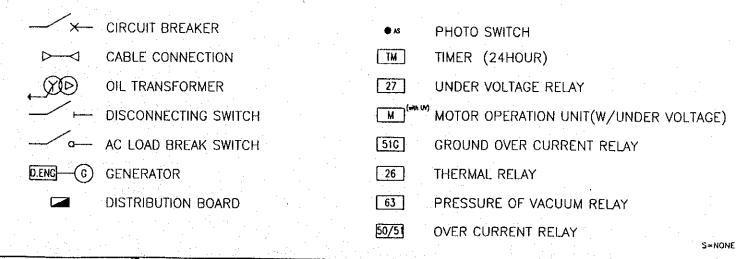



PROJECT NAME IMPLEMENTATION AGENCY **EXECUTING AGENCY** JICA STUDY TEAM PREPARED BY | CHECKED BY | APPROVED BY DETAILED DESIGN OF DRAWING TITLE DWG NO. JAPAN INTERNATIONAL COOPERATION AGENCY SOCIALIST REPUBLIC OF VIET NAM K. Nakai K. Enomoto THE CAN THO BRIDGE CONSTRUCTION PROJECT MINISTRY OF TRANSPORT (MOT) POWER RECEIVING SYSTEM SINGLE LINE DIAGRAM NIPPON KOEI CO.,LTD. SIGNATURE K. Nemoza (JICA) P3/LS/0140 MY THUAN PROJECT MANAGEMENT UNIT DATE 20/9/2000 29/9/2000

LEGEND :

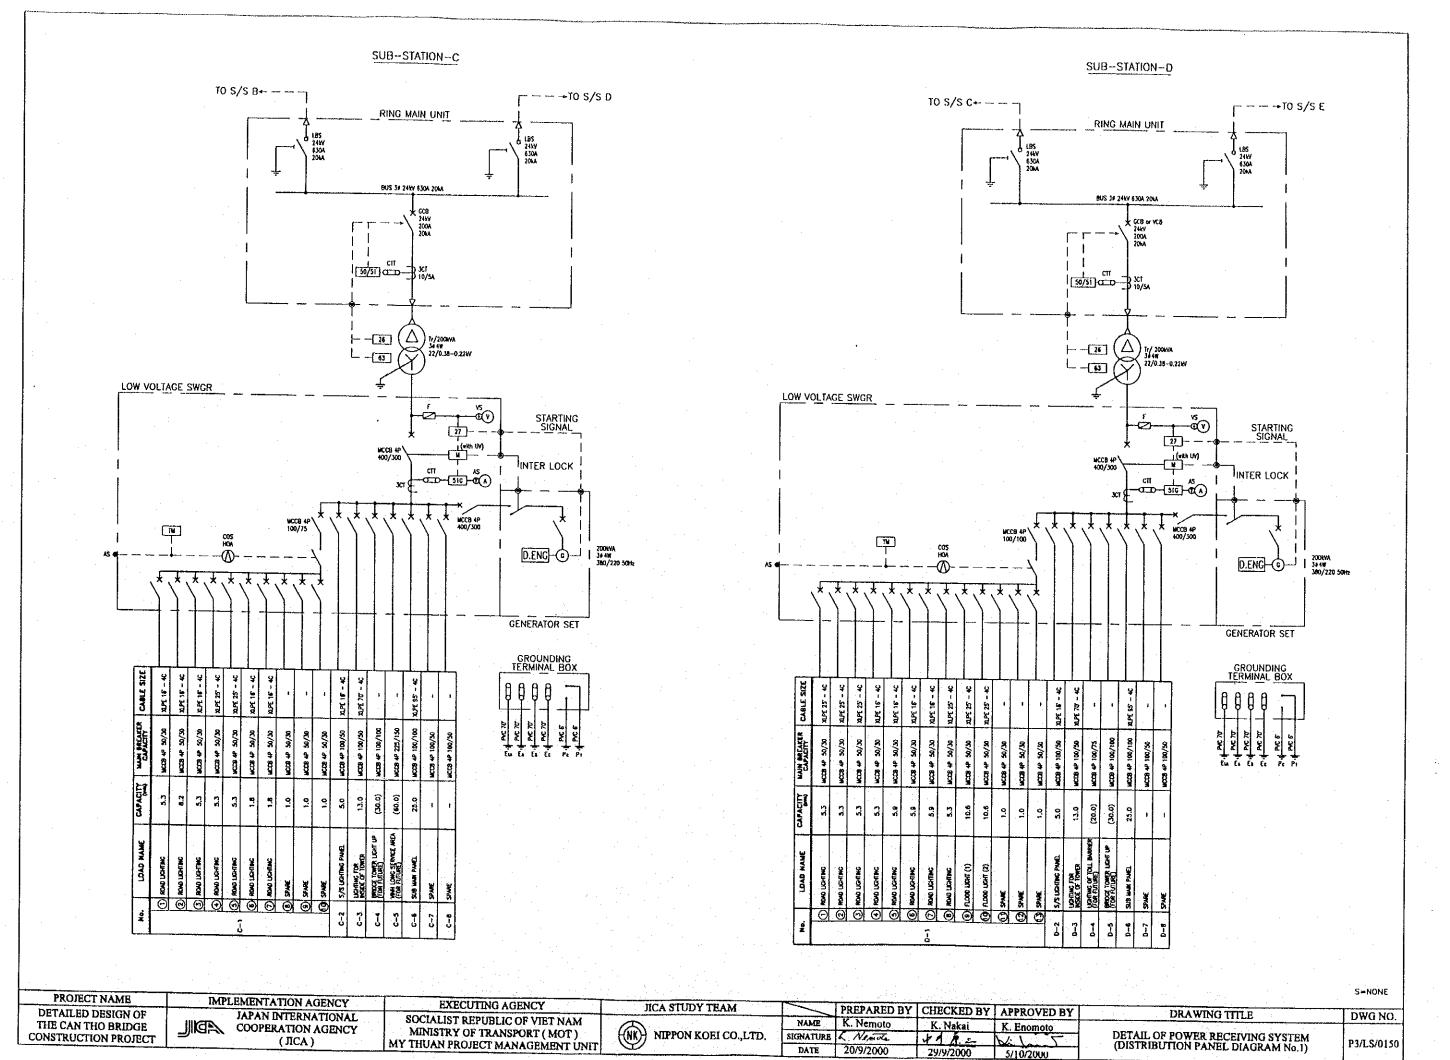

1.1

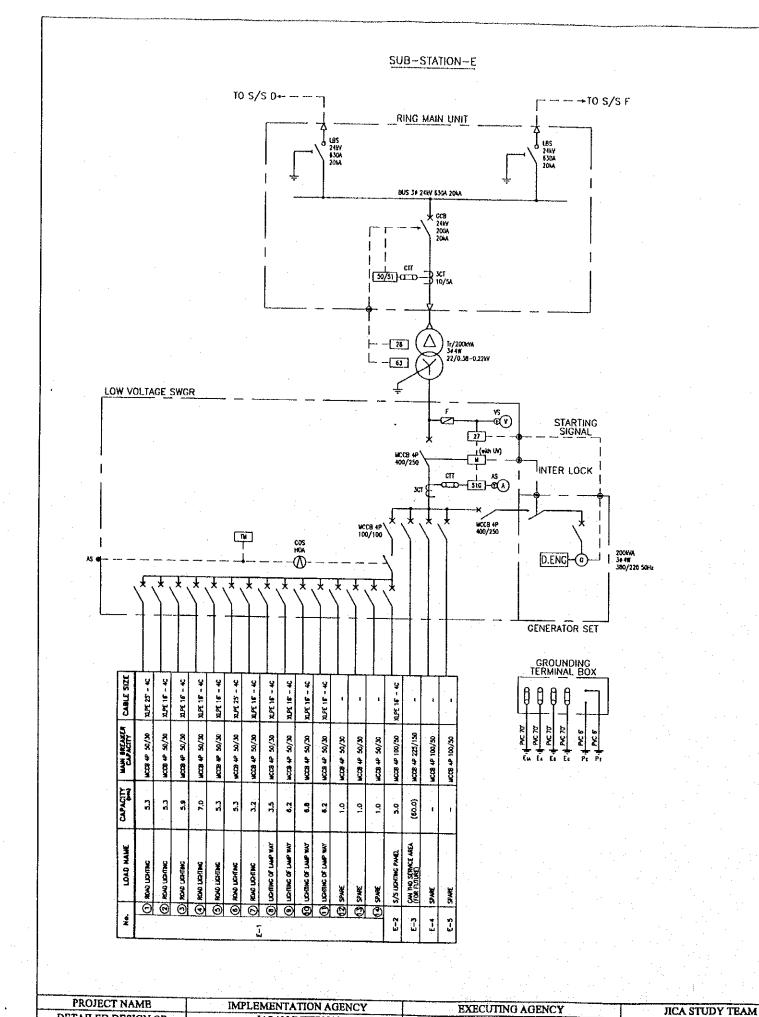

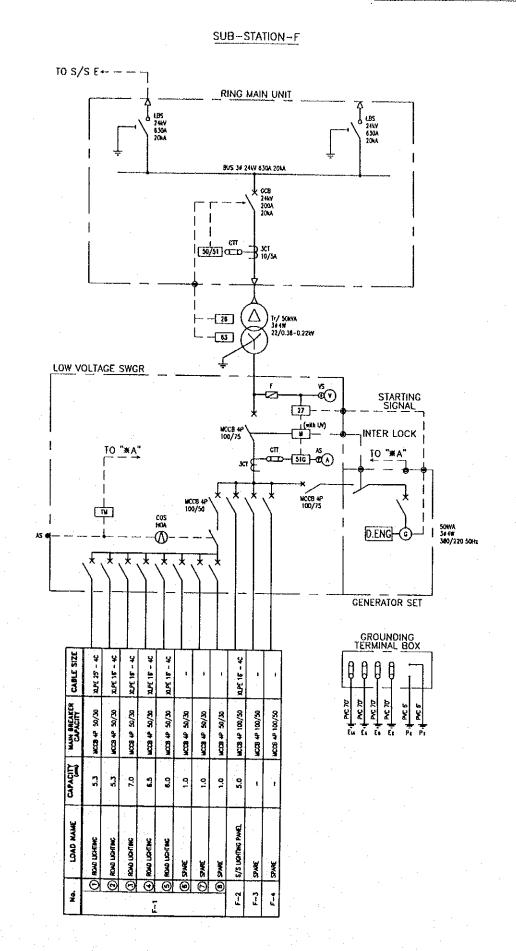

S=NONE

DWG NO.

DETAILED DESIGN OF THE CAN THO BRIDGE CONSTRUCTION PROJECT

JAPAN INTERNATIONAL COOPERATION AGENCY (JICA)

SOCIALIST REPUBLIC OF VIET NAM MINISTRY OF TRANSPORT ( MOT ) MY THUAN PROJECT MANAGEMENT UNIT


AM T) TUNIT


NIPPON KOEI CO.,LTD.

DETAIL OF POWER RECEIVING SYSTEM (DISTRIBUTION PANEL DIAGRAM No.2)

DRAWING TITLE


YSTEM M No.2) P3/LS/0160

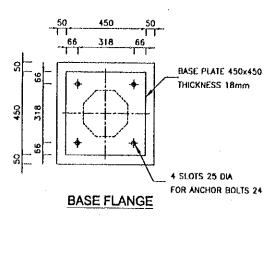

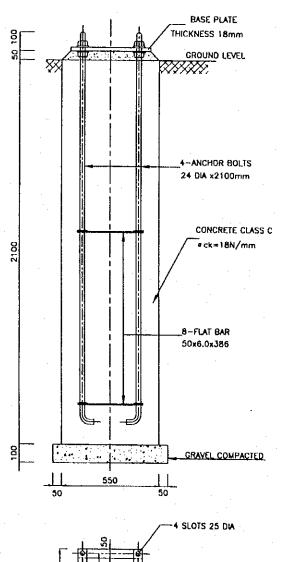






8-FLAT BAR 50x6.0x368

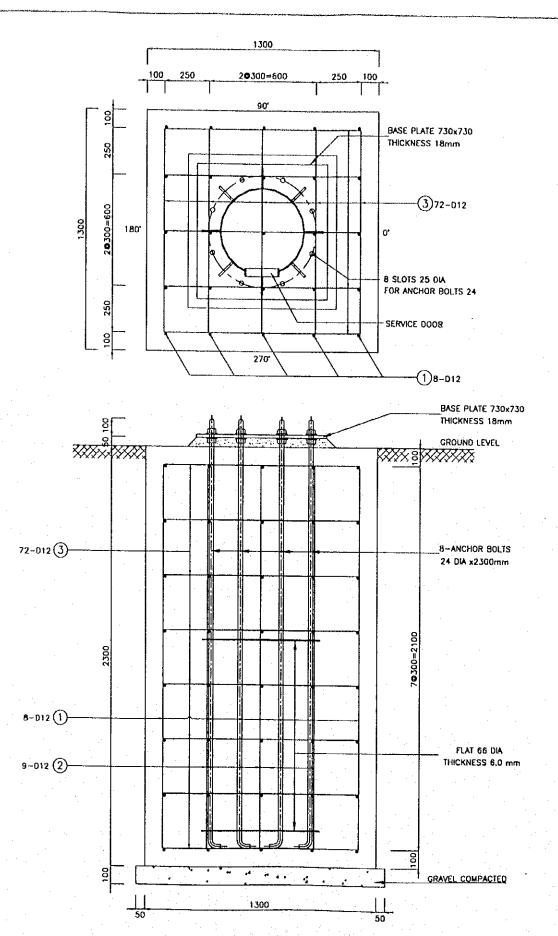

BASE CONCRETE FOR 20.0m POLE

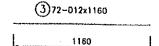

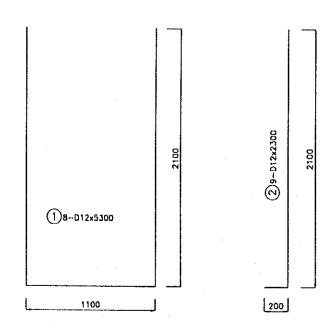

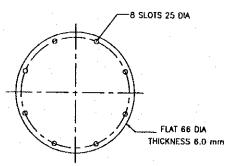


#### LIST OF REINFORCEMENT


TYPE	DIA.	LENGTH	NUMBER	WEIGHT/m	WEIGHT/no.	WEIGHT	REMARKS
1	D12	5,300	l a	0.888	4.71	38	
2	D12	2,300	9	0.868	2.04	19	L L
3	012	1,160	72	0,888	1.03	75	
	<u> </u>				012	132	kgi
					TOTAL	132	kol


S=1:20


PROJECT NAME IMPLEMENTATION AGENCY **EXECUTING AGENCY** JICA STUDY TEAM PREPARED BY | CHECKED BY | APPROVED BY DRAWING TITLE DWG NO. DETAILED DESIGN OF JAPAN INTERNATIONAL SOCIALIST REPUBLIC OF VIET NAM K. Nemoto NAME K. Nakai K. Enomoto THE CAN THO BRIDGE COOPERATION AGENCY MINISTRY OF TRANSPORT ( MOT )
MY THUAN PROJECT MANAGEMENT UNIT NIPPON KOEI CO.,LTD. SIGNATURE K. NAMUG 411= CONSTRUCTION PROJECT (ЛСА) DETAIL OF LIGHTING POLE HOLE P3/LS/0170 DATE 20/9/2000 29/9/2000 5/10/2000


# P3/MS MSCELLANEOUS

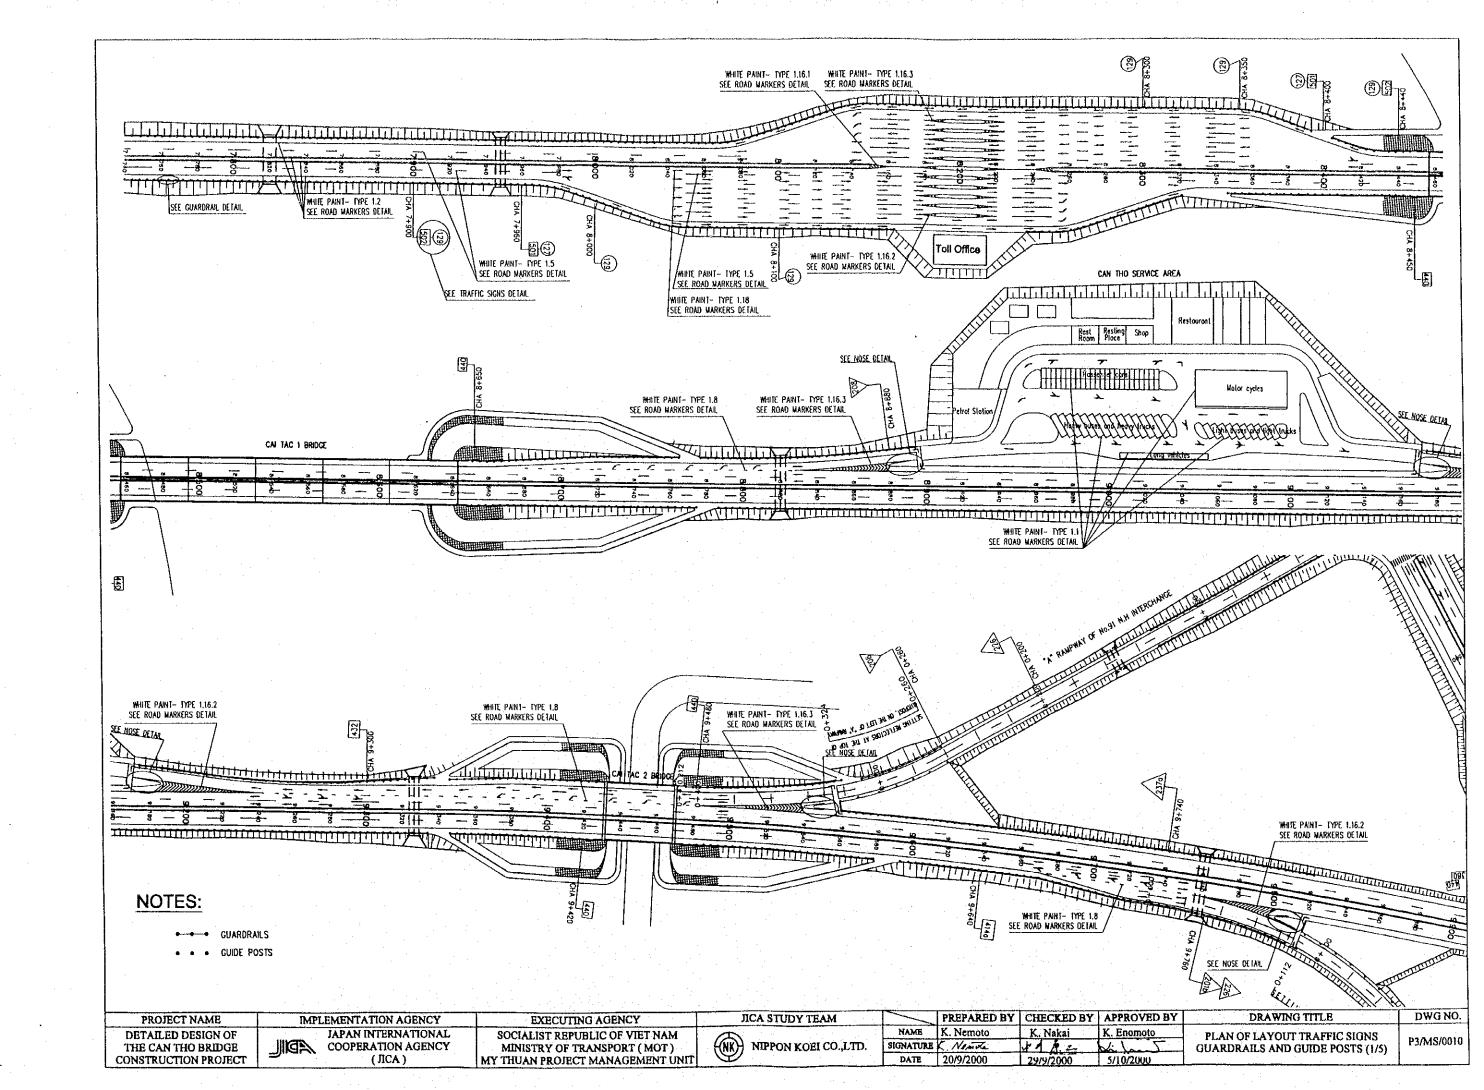


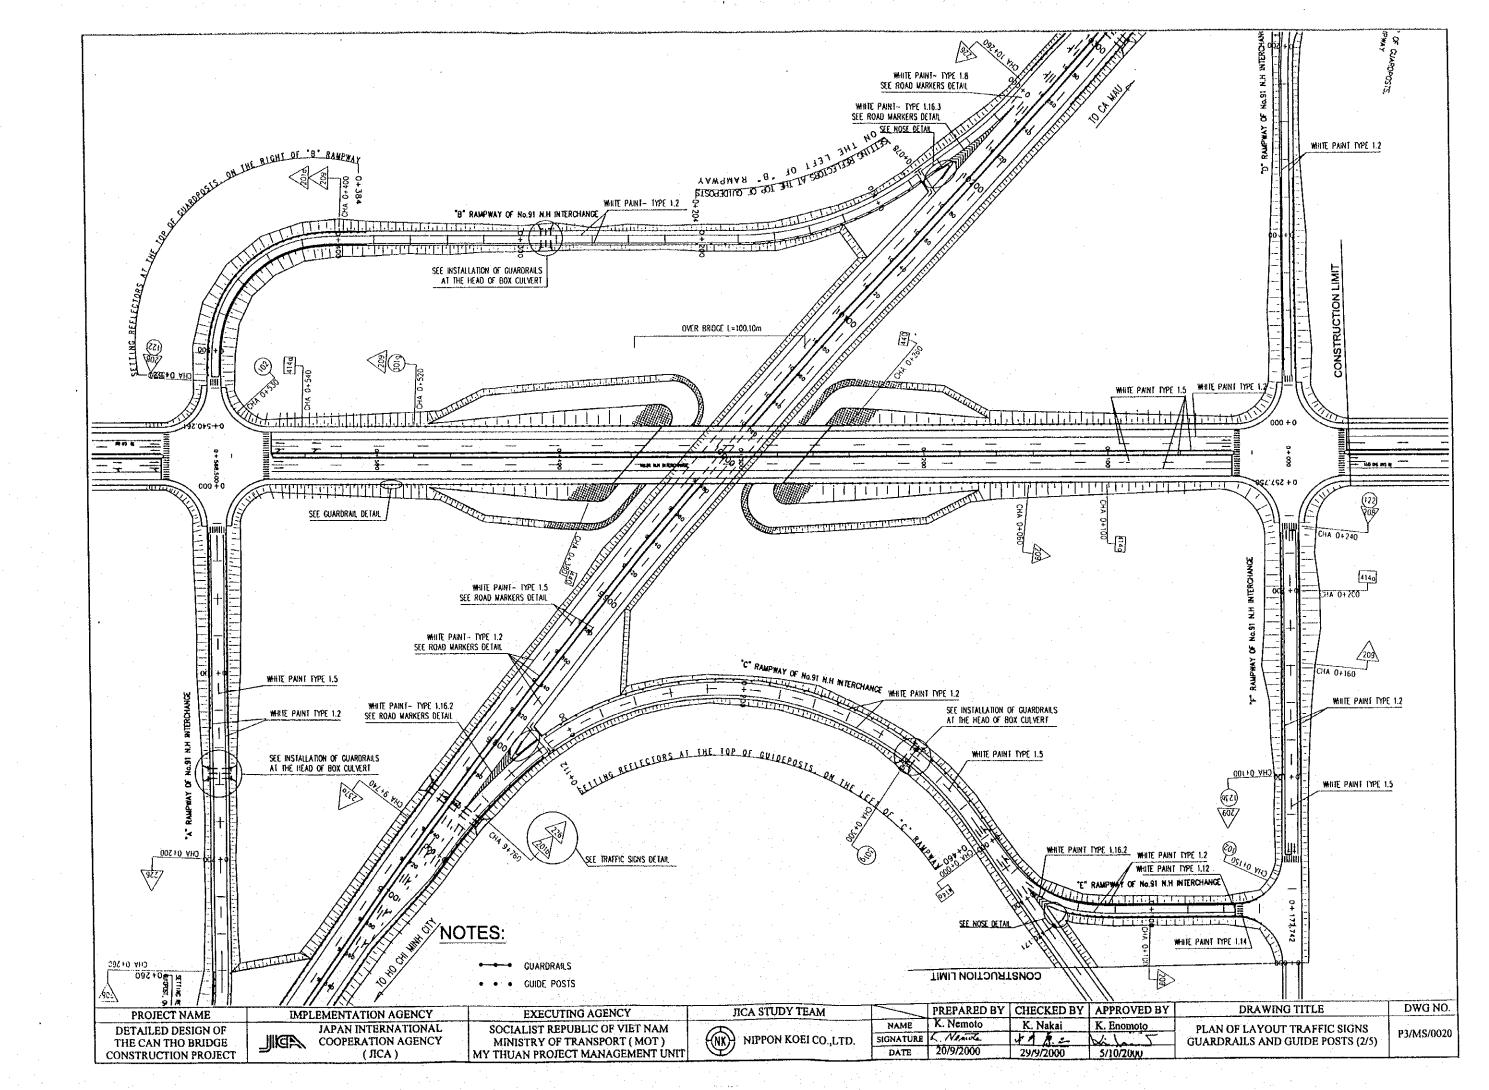


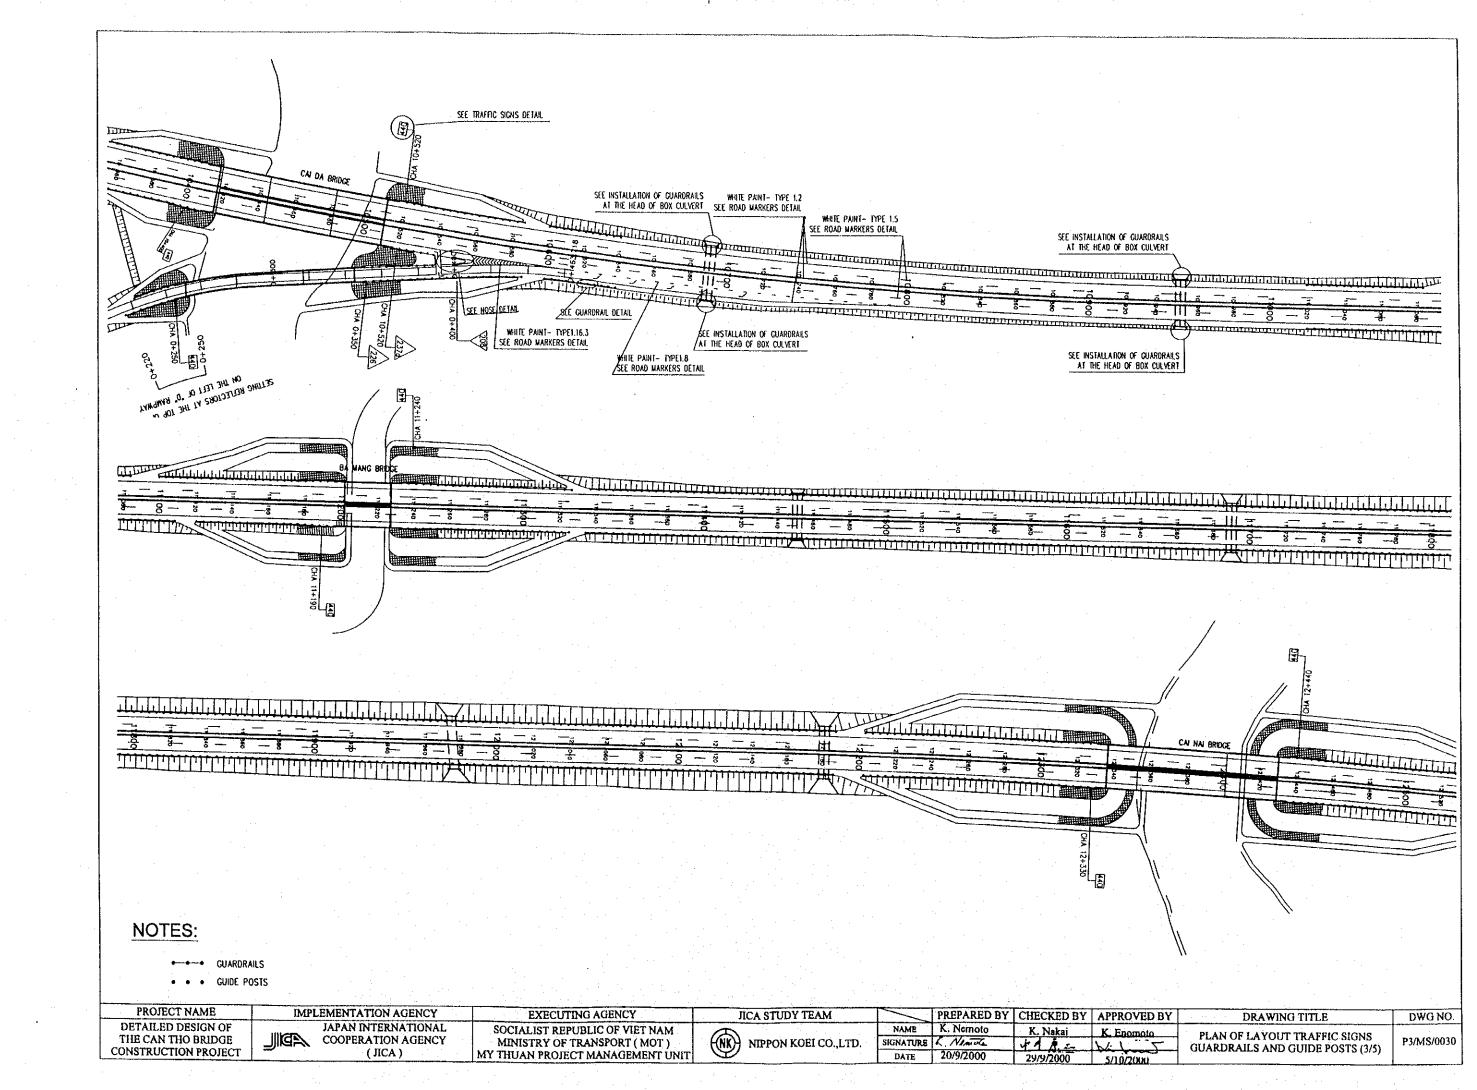


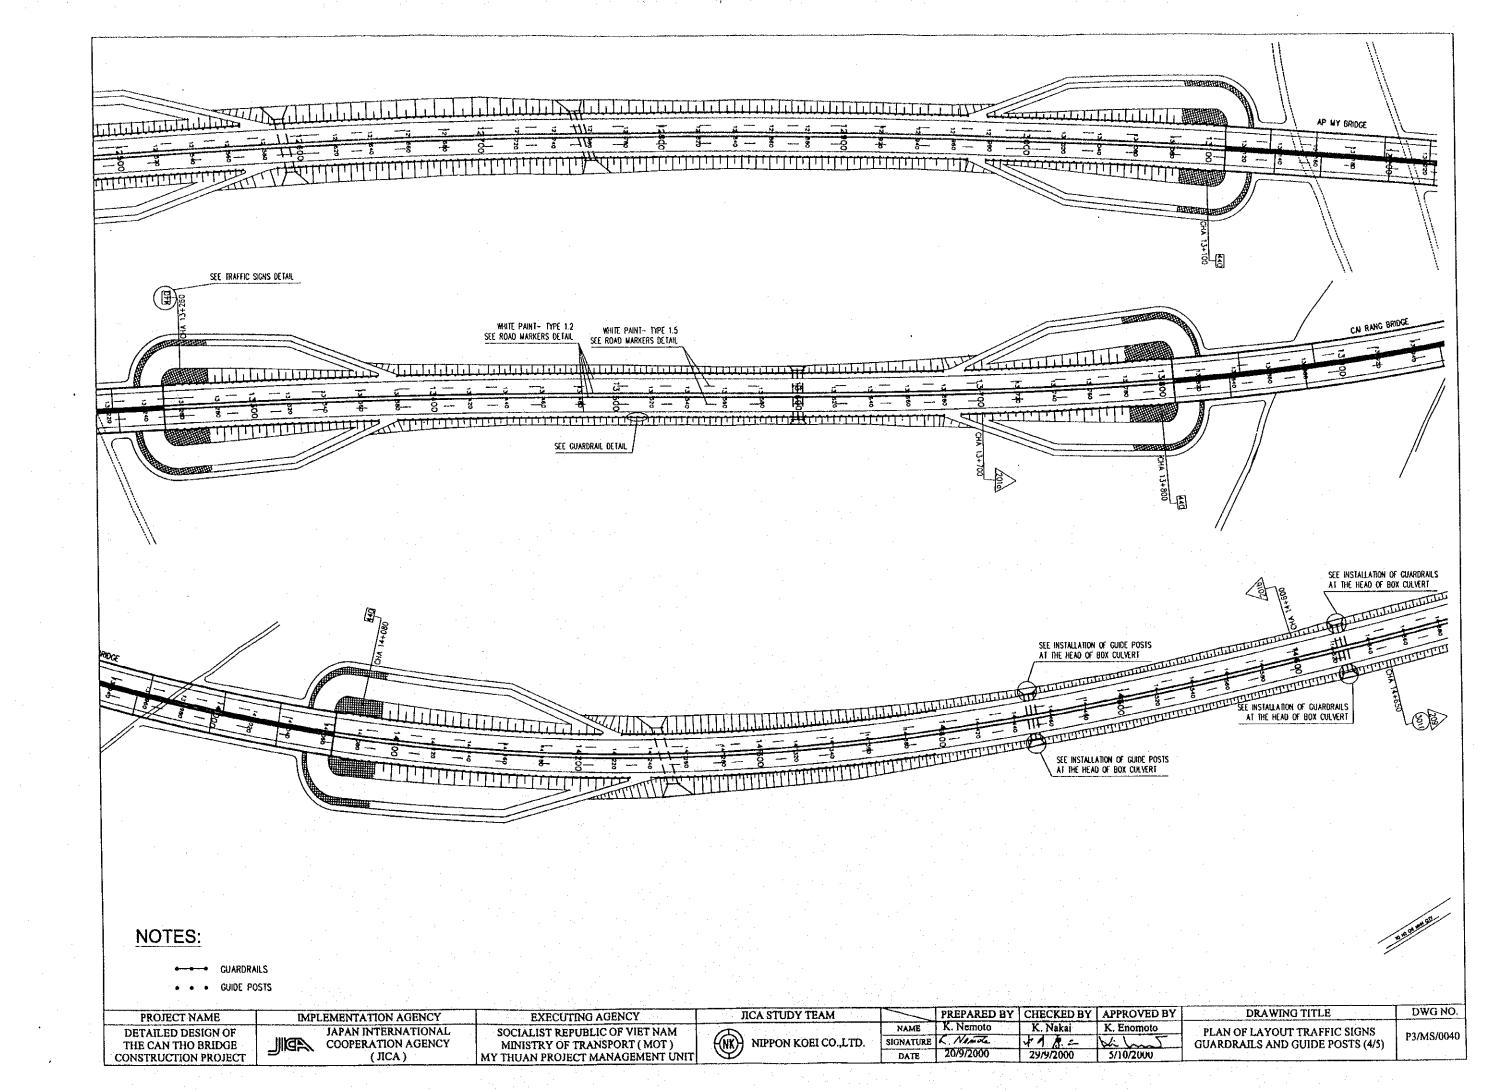


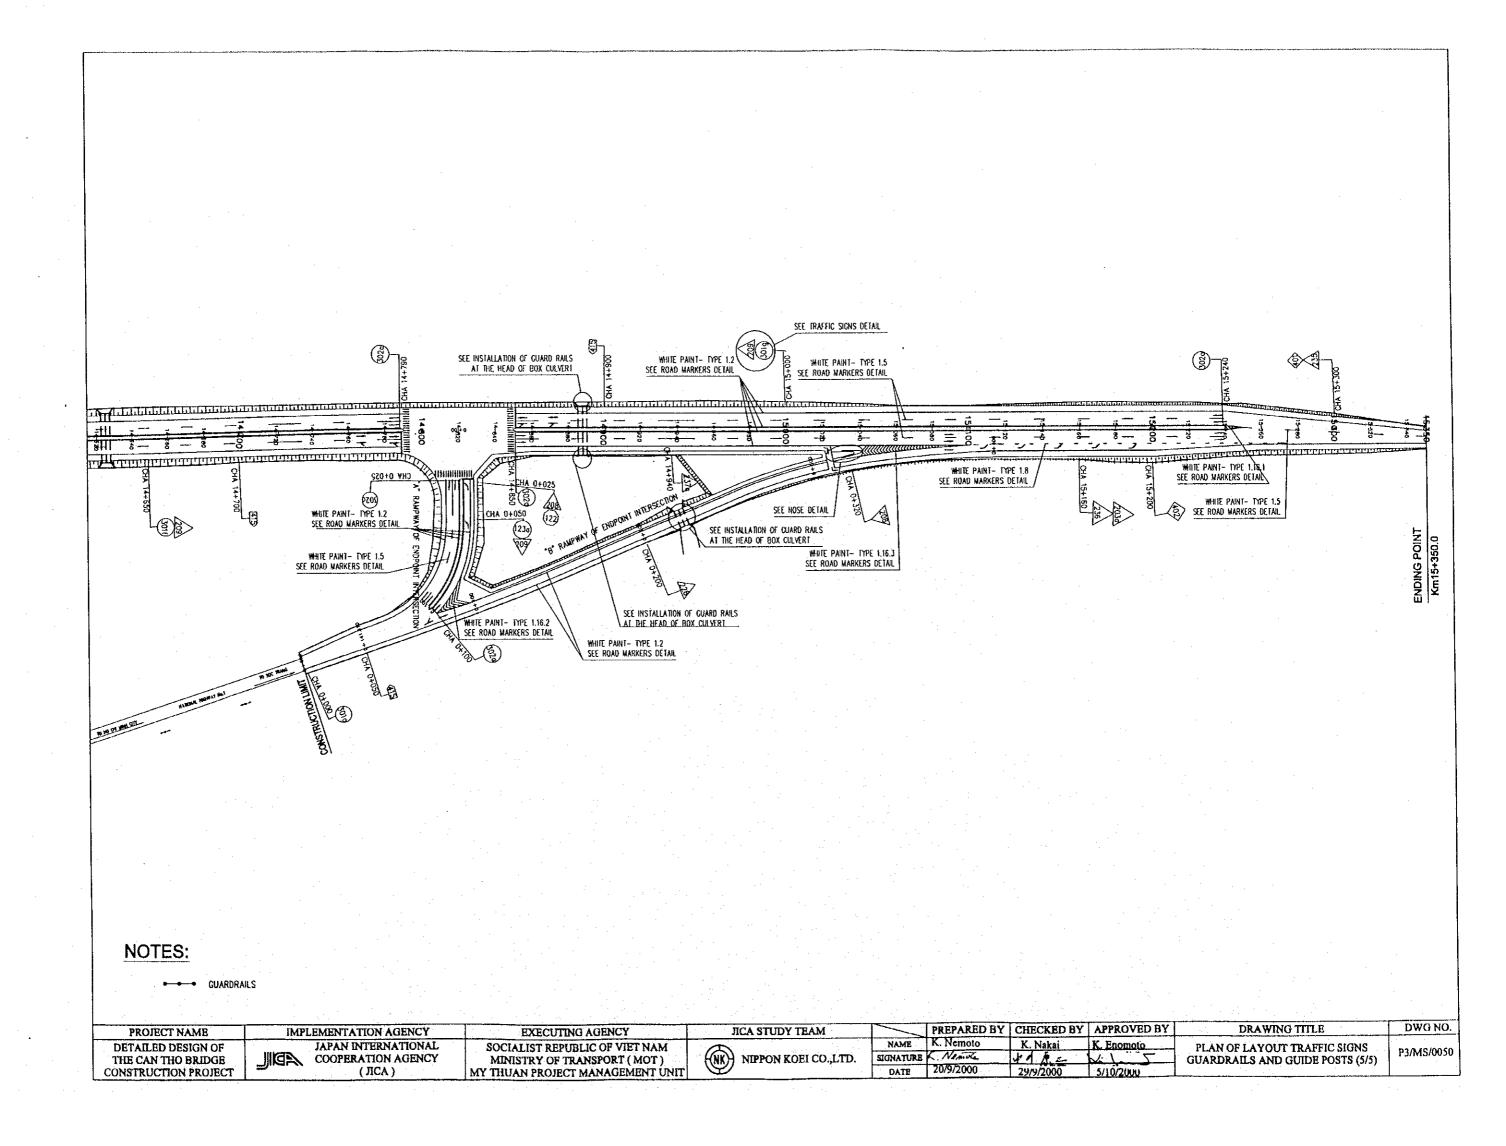


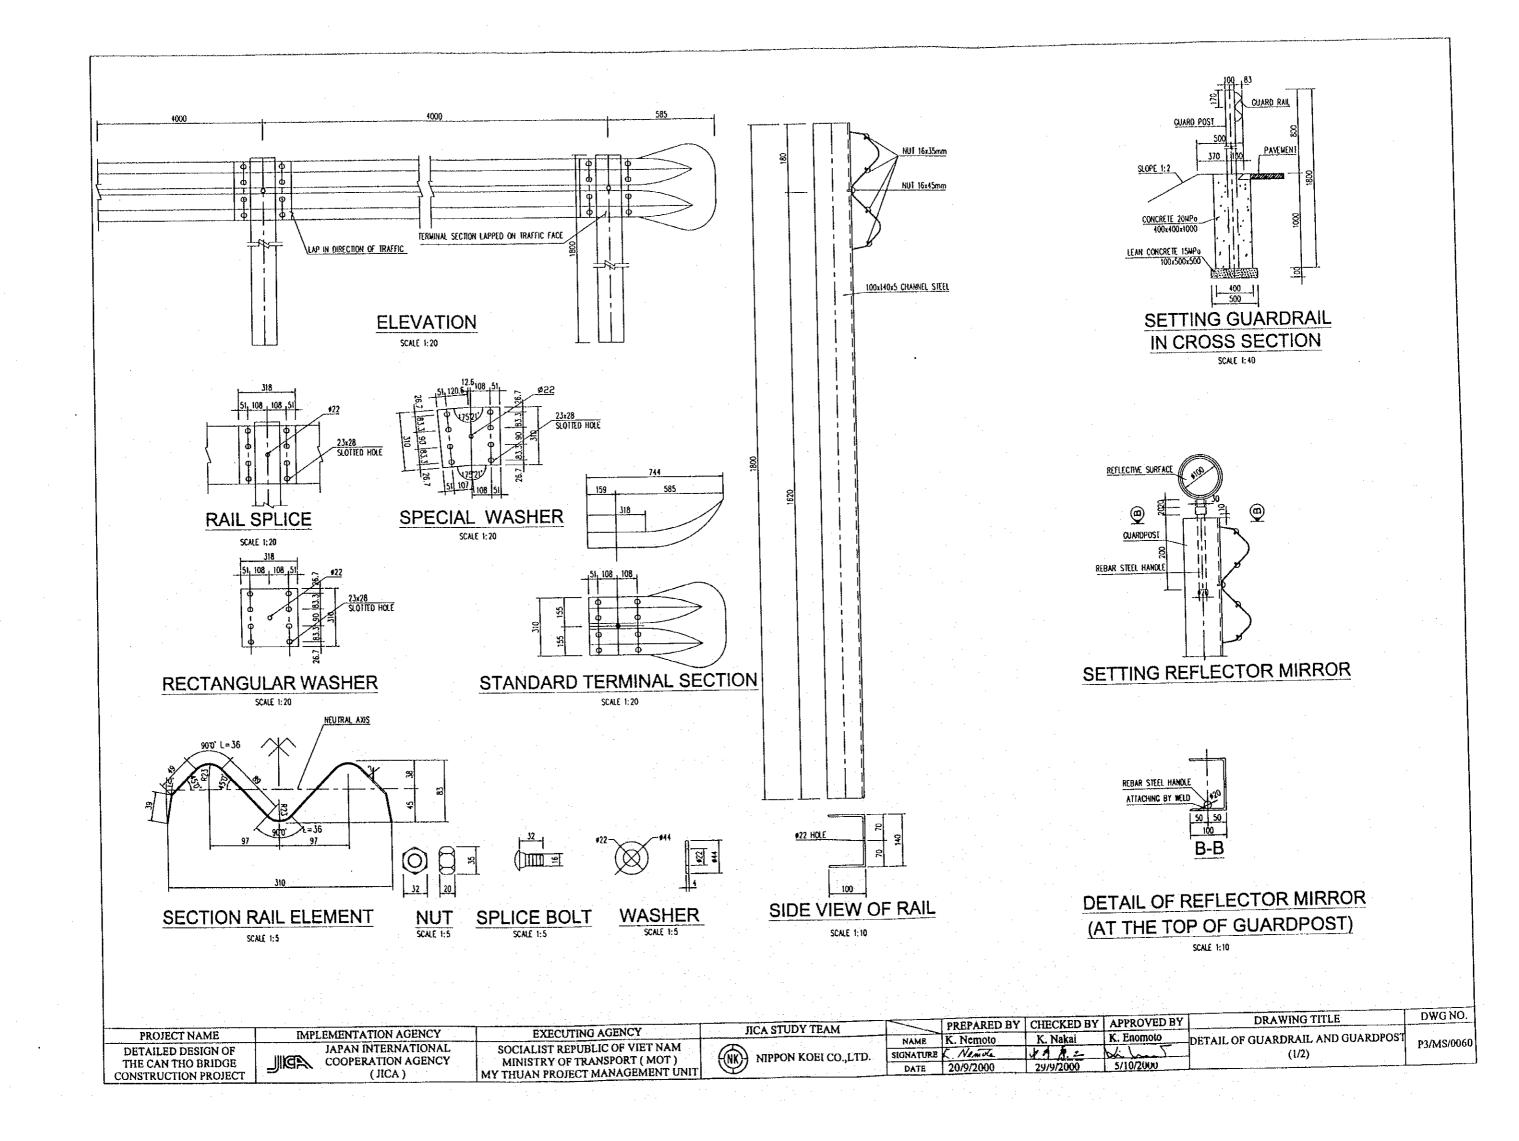


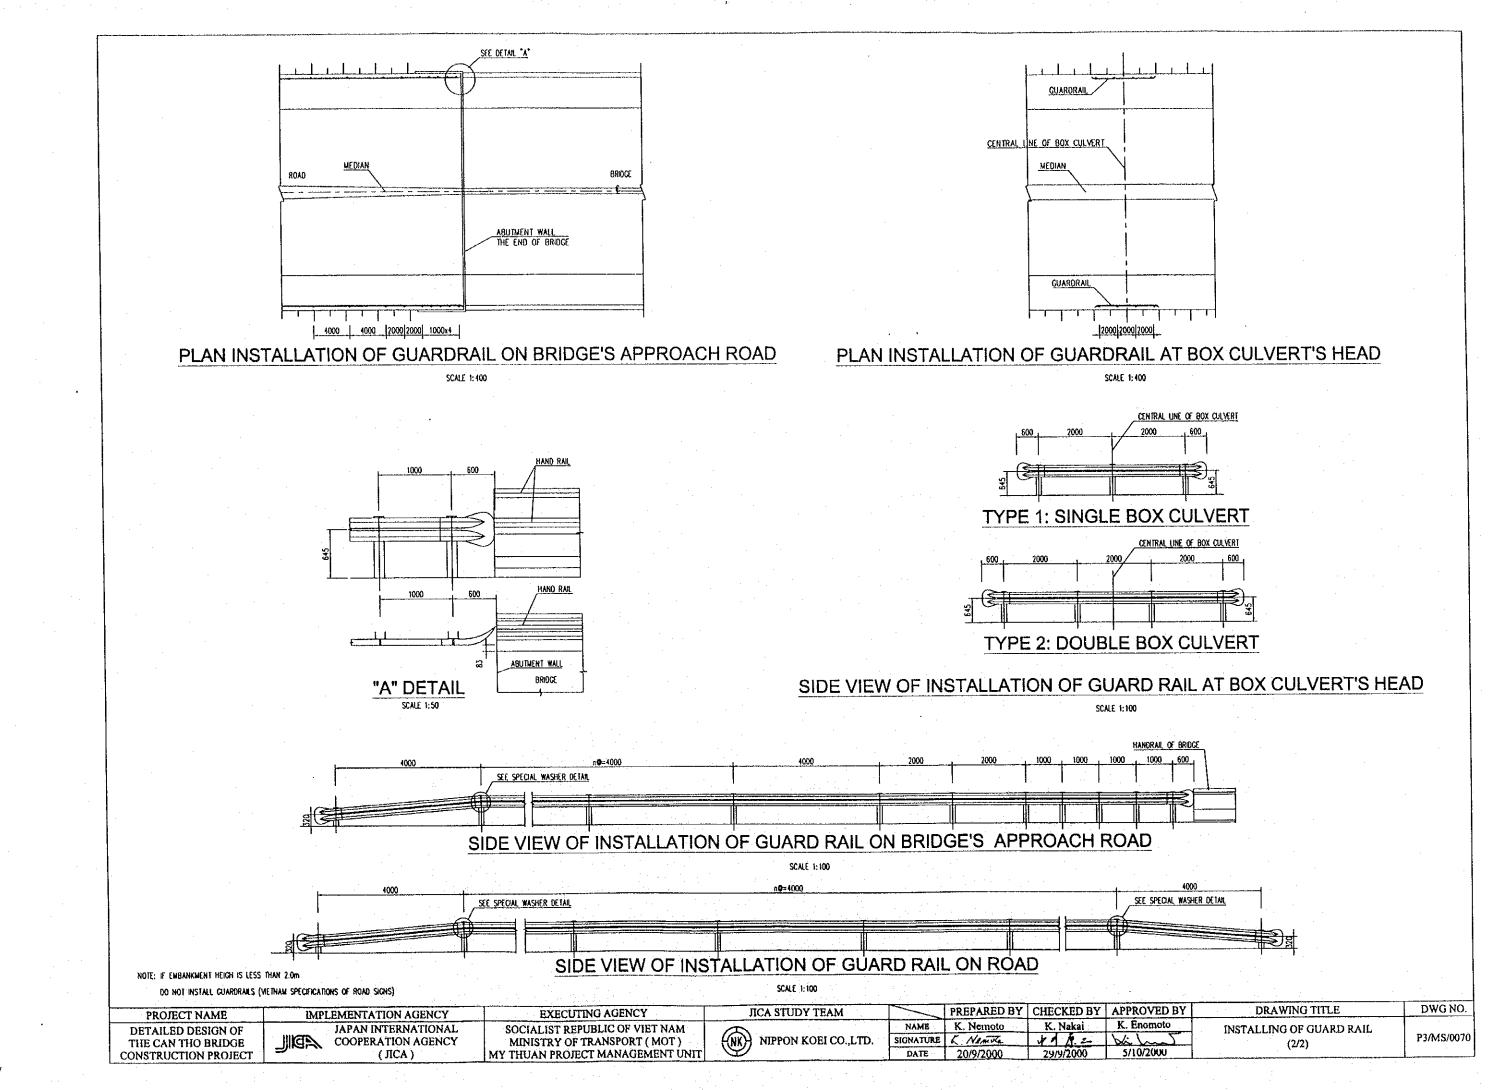

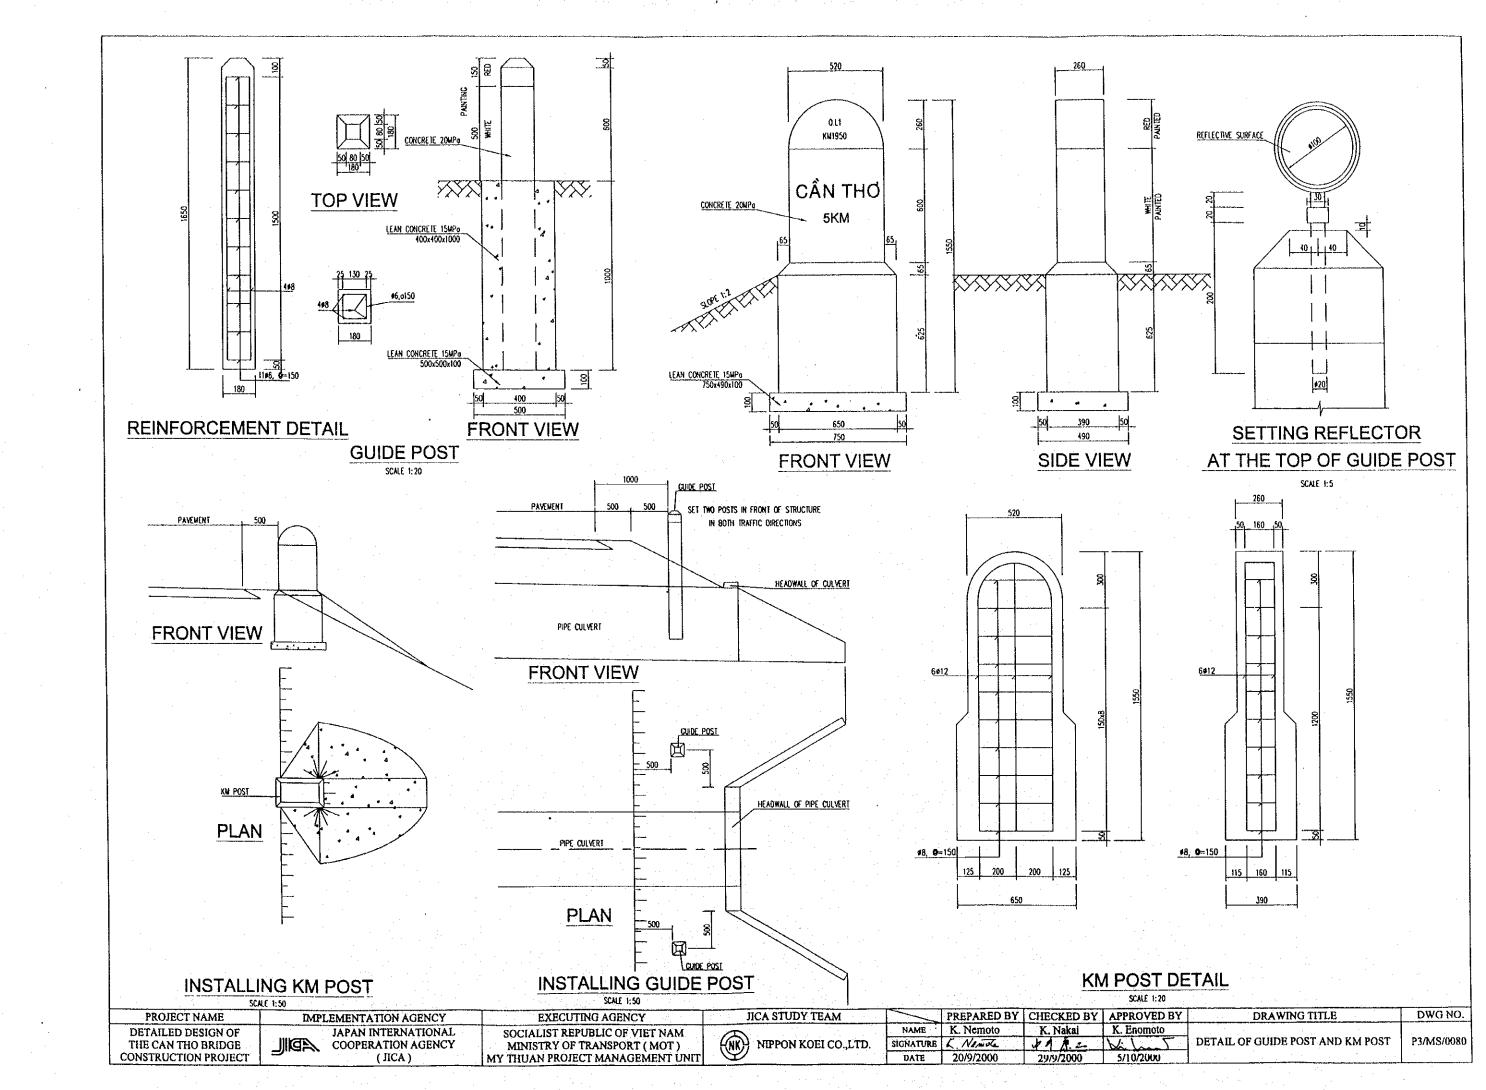

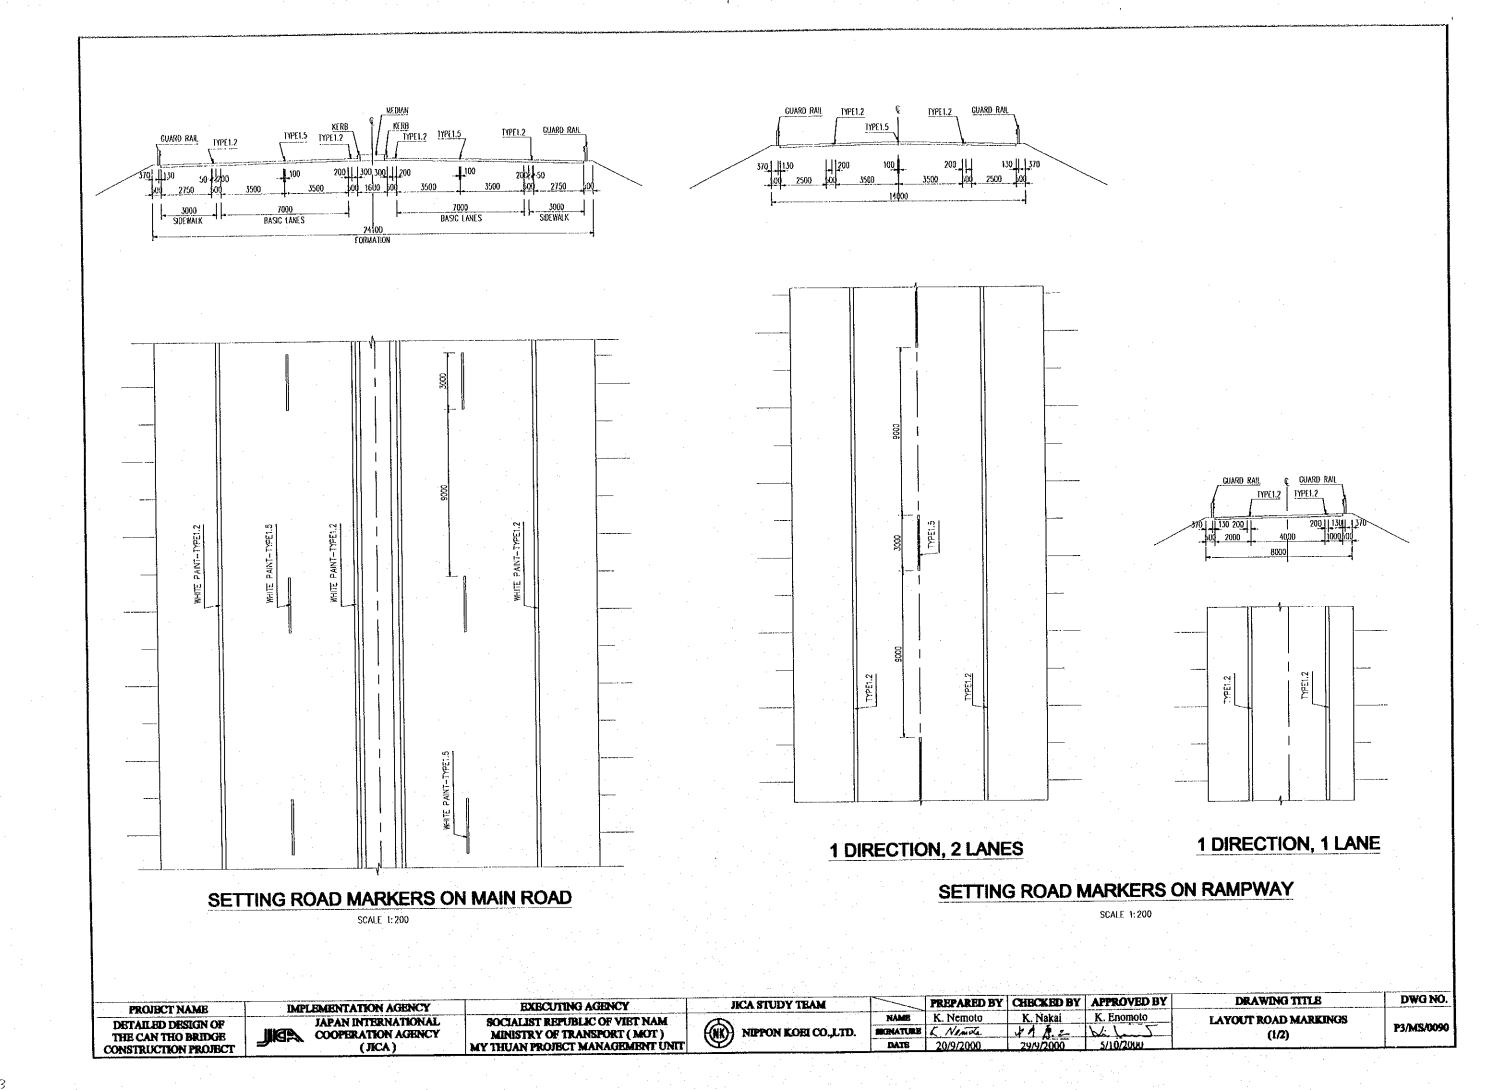

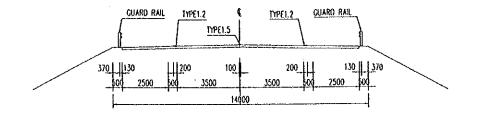

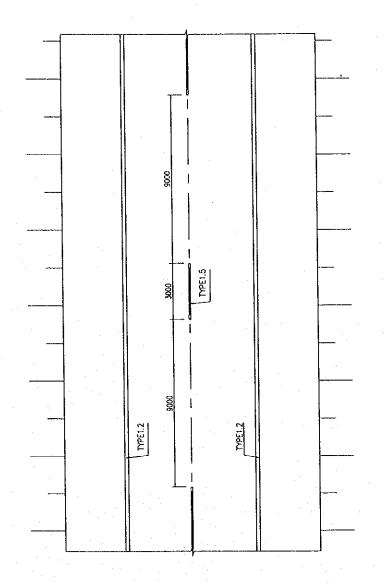

# SETTING ROAD MARKERS ON No.54 N.H INTERCHANGE

SCALE 1: 200


· '	4							A STATE OF THE STA		
PROJECT NAME	IMPLI	MENTATION AGENCY	EXECUTING AGENCY	ЛСА STUDY TEAM		PREPARED BY	CHECKED BY	APPROVED BY	DRAWING TITLE	DWG NO.
DETAILED DESIGN OF		JAPAN INTERNATIONAL	SOCIALIST REPUBLIC OF VIET NAM	<b>(</b>	NAME	K. Nemoto	K. Nakai	K. Enomoto	LAYOUT ROAD MARKINGS	7000000
THE CAN THO BRIDGE		COOPERATION AGENCY	MINISTRY OF TRANSPORT ( MOT )	(NK) NIPPON KOEI CO.,LTD.	SIGNATURE	K Namola	41 1.2	Milmo	(2/2)	P3/MS/0100
CONSTRUCTION PROJECT	٠٠٠	(ЛСА)	MY THUAN PROJECT MANAGEMENT UNIT		DATE	20/9/2000	29/9/2000	5/10/2000	(/	

# TYPE 1.1 - SINGLE SOLID LINE (WHITE PAINT) SCALE 1: 200 TYPE 1.2 - SINGLE SOLID LINE (WHITE PAINT) SCALE 1: 200 TYPE 1.5 - SINGLE BROKEN LINE (WHITE PAINT) SCALE 1: 200 TYPE 1.8 - SINGLE BROKEN LINE (WHITE PAINT) SCALE 1: 200 TYPE 1.12 - SINGLE SOLID LINE (WHITE PAINT) SCALE 1: 200 TYPE 1.12 - SINGLE SOLID LINE (WHITE PAINT) SCALE 1: 200


TYPE 1.14 - PEDESTRIAN CROSSING (WHITE PAINT)

SCALE 1:200

TYPE 1.15 - BICYCLE
CROSSING (WHITE PAINT)

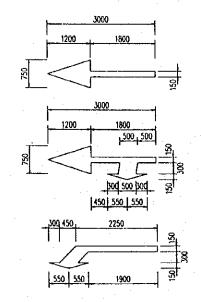


TYPE 1.18 - SPECIAL ROAD MARKING (WHITE PAINT)

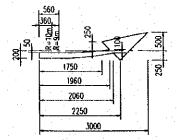


TYPE 1.19 - FOR LANE SHIFT (WHITE PAINT)

SCALE 1:100

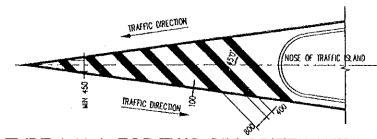

TYPE 1.16.1- FOR TWO OPPOSITE LANES

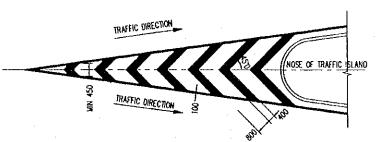


TYPE 1.16.2- FOR TWO DIVERGING LANES



TYPE 1.16.3- FOR TWO MERGING LANES

TYPE 1.16 - CHEVRON HATCHING MARKING (WHITE PAINT)

SCALE 1:200

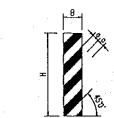

TYPE 2.1- FOR PIERS OF FLYOVER BRIDGE


SCALE 1:25





TYPE 2.7- FOR KERBS OF NOSES

SCALE 1:25


	<u></u>	有一个人,我们们还有一个人的人,我们就是一个人的人,			and the second second second	and the second of the second			
PROJECT NAME	IMPLEMENTATION AGENCY	EXECUTING AGENCY	JICA STUDY TEAM		PREPARED BY	CHECKED BY	APPROVED BY	DRAWING TITLE	DWG NO.
DETAILED DESIGN OF	JAPAN INTERNATIONAL	SOCIALIST REPUBLIC OF VIET NAM	<b>A</b>	NAME	K. Nemoto	K. Nakai	K. Enomoto		
THE CAN THO BRIDGE	COOPERATION AGENCY	MINISTRY OF TRANSPORT ( MOT )	((NK)) NIPPON KOEI CO.,LTD.	SIGNATURE	L. Nemote	41 1.2	De hand	DETAIL OF ROAD MARKINGS	P3/MS/0110
CONSTRUCTION PROJECT	(JICA)	MY THUAN PROJECT MANAGEMENT UNIT		DATE	20/9/2000	70/0/2000	5/10/2(XH)		1

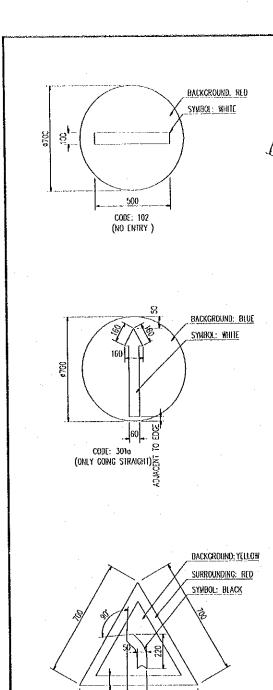

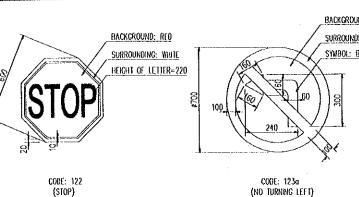

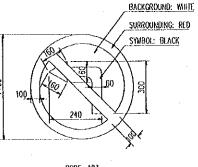


BACKCROUND: WHITE SURROUNDING: RED HEIGHT OF FIGURE = 300

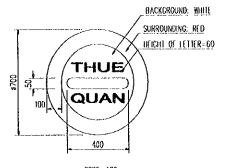



CODE: 123b (NO TURNING RIGHT ) DIMENSIONS, COLORS, SYMBOL SIMILAR TO 1230

CODE: 127 (MAXIMUM LIMITED SPEED)


CODE: 129 (TOLL STATION)

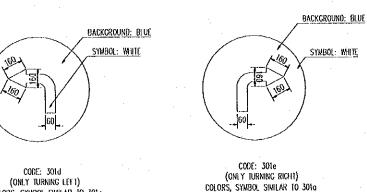

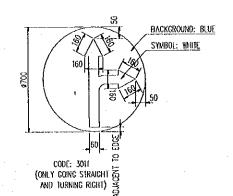

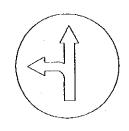



CODE: 301g (ONLY GOING STRAIGHT AND TURNING LEFT) DIMENSIONS, COLORS, SYMBOL SIMILAR TO 3011

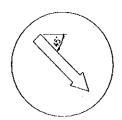

CODE: 302a (Avoiding obstruction) DIMENSIONS, COLORS SIMILAR TO 3011, EXCEPT ADDITIONS


## **REGULATORY SIGNS (TYPE 1)**

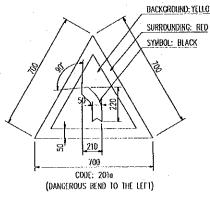

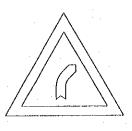


COLORS, SYMBOL SIMILAR TO 3010


CODE: 2016 (DANGEROUS BEND TO THE RIGHT) DIMENSIONS, COLORS, SYMBOL SIMILAR TO 2010

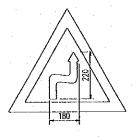

CODE: 202b (MANY DANCEROUS CONSTANT BENDS, THE FIRST BENDS TO THE RIGHT) DIMENSIONS, COLORS SIMILAR TO 2010, EXCEPT ADDITIONS

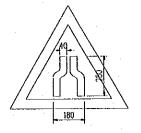


CODE: 203a (NARROWER ROAD BOTH SIDES) DIMENSIONS, COLORS SIMILAR TO 2010, EXCEPT ADDITIONS

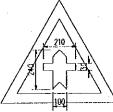


CODE: 207a

CODE: 2076

CROSSING WITH MINOR ROADS (TRAFFIC ON THE MINOR ROAD MUST GIVE WAY)

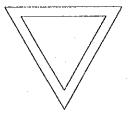


CODF: 208 (INTERSECTION WITH PRIORITY ROAD)

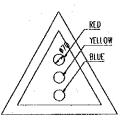


CODE: 209 (CROSSSING WITH TRAFFIC LIGHT)




DIMENSIONS, COLORS SIMILAR TO 2010 DIMENSIONS, COLORS SIMILAR TO 2010, EXCEPT ADDITIONS DIMENSIONS, COLORS SIMILAR TO 2010, EXCEPT ADDITIONS

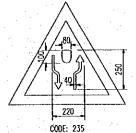


(BEGINNING ROAD WITH MEDIAN) DIMENSIONS, COLORS SIMILAR TO 2010, EXCEPT ADDITIONS

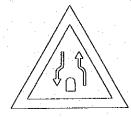

CODE: 236 (ENDING ROAD WITH MEDIAN) DIMENSIONS, COLORS, SYMBOL SIMILAR TO 235

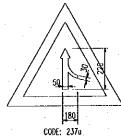

(MERGING STREAM ON RIGHT) DIMENSIONS, COLORS SIMILAR TO 2014, EXCEPT ADDITIONS

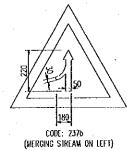

DIMENSIONS, COLORS SIMILAR TO 2370

DWG NO.

P3/MS/0120

#### **WARNING SIGNS (TYPE 2)** SCALE 1:25


PROJECT NAME DETAILED DESIGN OF THE CAN THO BRIDGE CONSTRUCTION PROJECT IMPLEMENTATION AGENCY JAPAN INTERNATIONAL COOPERATION AGENCY (JICA)


EXECUTING AGENCY SOCIALIST REPUBLIC OF VIET NAM MINISTRY OF TRANSPORT (MOT) MY THUAN PROJECT MANAGEMENT UNIT


J	ica st	UDY	TEA	M.	
(18)	NIPPO	)N K	OEI (	<b>1.00</b>	TD.

PREPARED BY CHECKED BY APPROVED BY NAME K. Nemoto K. Nakai K. Enomoto MONATURE C. NIMUL 41 1. = DATE 20/9/2000 5/10/2000 29/9/2000


DRAWING TITLE DETAIL OF SIGNBOARD (1/2)

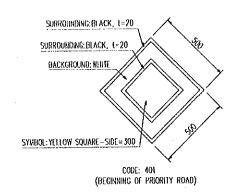


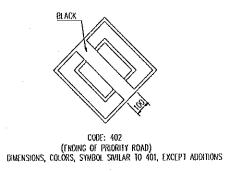


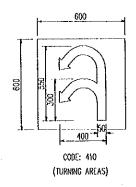





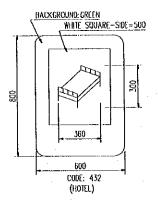

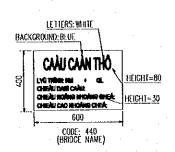

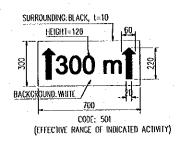

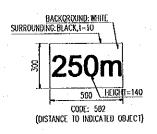


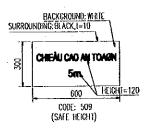

### **GUIDANCE SIGNS (TYPE 3)**

SCALE 1:25




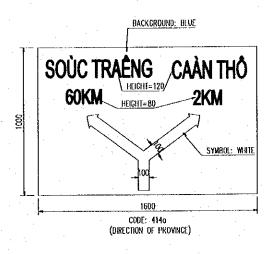



# **GUIDANCE SIGNS (TYPE 4)**


SCALE 1:25

- 1						<u></u>	<u></u>	T	
1	PROJECT NAME	IMPLEMENTATION AGENCY	EXECUTING AGENCY	JICA STUDY TEAM	PREPARED BY	CHBCKED BY	APPROVED BY	DRAWING TITLE	DWG NO.
	DETAILED DESIGN OF	JAPAN INTERNATIONAL	SOCIALIST REPUBLIC OF VIET NAM		NAMES K. Nemoto	K. Nakai	K. Enomoto	DETAIL OF SIGNBOARD	
	THE CAN THO BRIDGE	COOPERATION AGENCY	MINISTRY OF TRANSPORT (MOT)	(NK) NIPPON KOELCO.,LTD.	SECNATURE & NAME	41 1	W. L. J	(ID)	P3/MS/0130
	CONSTRUCTION PROJECT		MY THUAN PROJECT MANAGEMENT UNIT	<b>9</b>	DATE 20/9/2000	29/9/2000	5/10/2000	(42)	<u> </u>

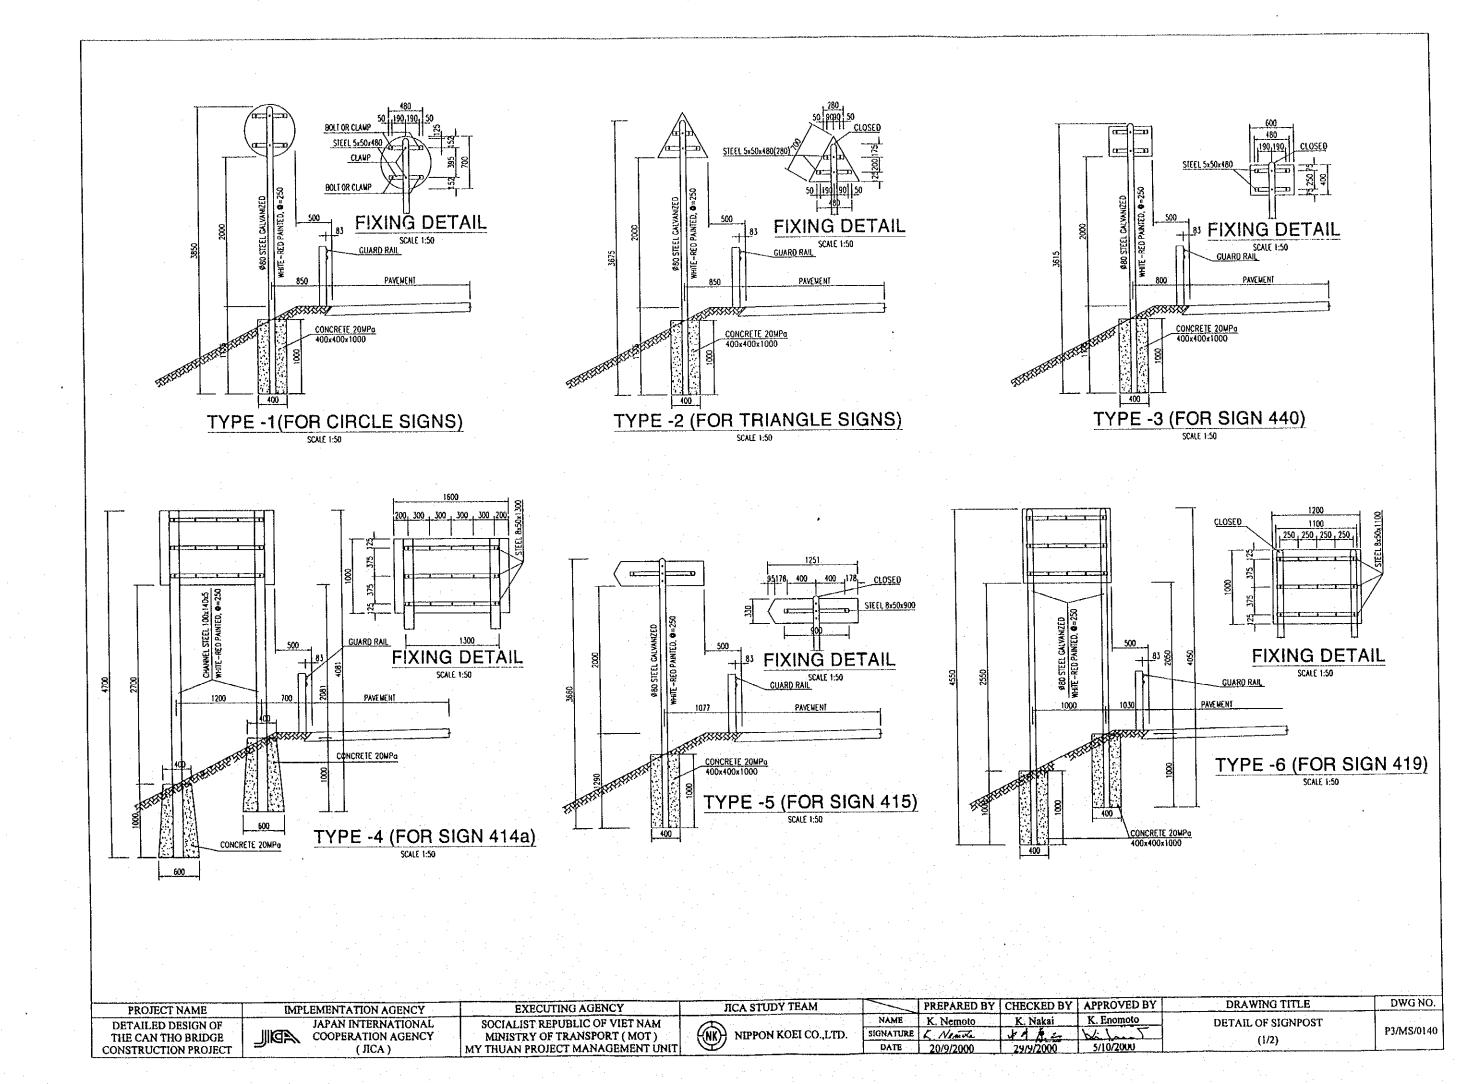

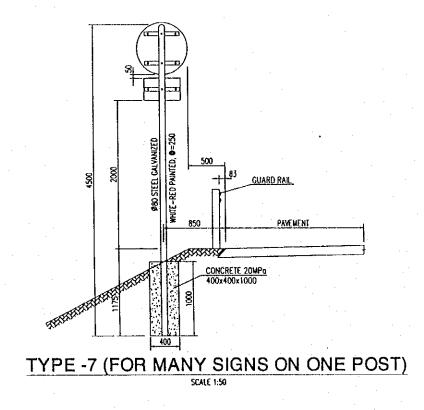

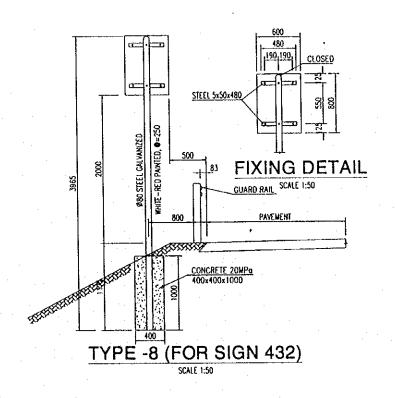

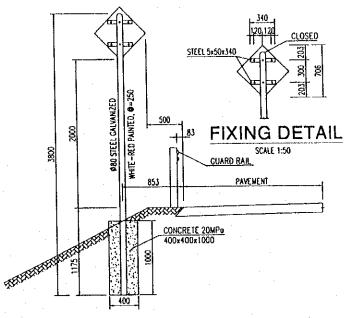



TYPE -9 (FOR SIGN 401)


#### NOTES:


ALL SIGN BOARDS ARE PAINTED WITH REFLECTOR AND MADE OF ALUMINUM.


- 1									
	PROJECT NAME	IMPLEMENTATION AGENCY	EXECUTING AGENCY	JICA STUDY TEAM		PREPARED BY   CHECKED BY	APPROVED BY	DRAWING TITLE	DWG NO.
	DETAILED DESIGN OF	JAPAN INTERNATIONAL	SOCIALIST REPUBLIC OF VIET NAM	T)	NAME	K. Nemoto K. Nakai	K. Enomoto	DETAIL OF SIGNPOST	20000000
	THE CAN THO BRIDGE	COOPERATION AGENCY	MINISTRY OF TRANSPORT ( MOT )	(NK) NIPPON KOEI CO.,LTD.	SIGNATURE	K. Nemote & A R. Z	Tank	(2/2)	P3/MS/0150
	CONSTRUCTION PROJECT		MY THUAN PROJECT MANAGEMENT UNIT		DATE	20/9/2000 29/9/2000	5/10/2000		

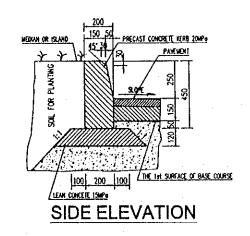

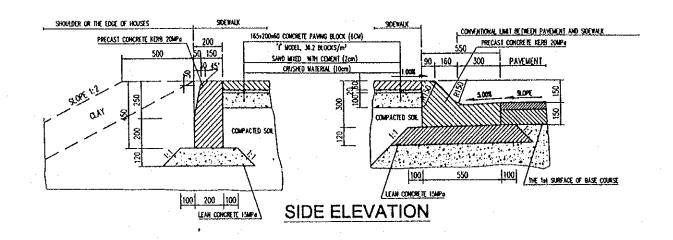


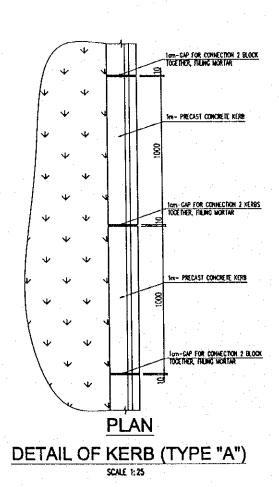

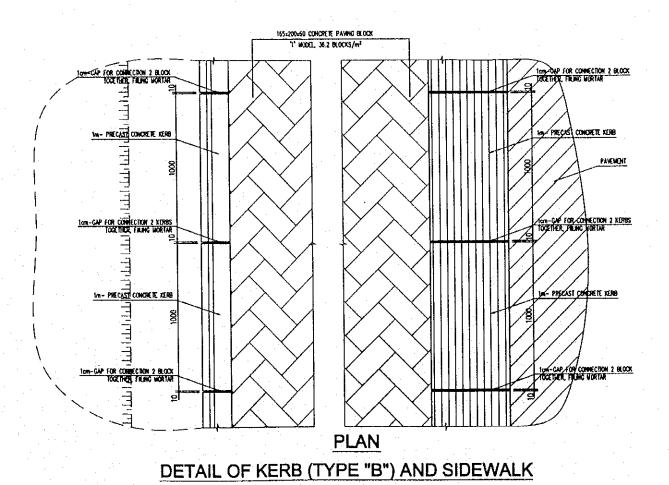


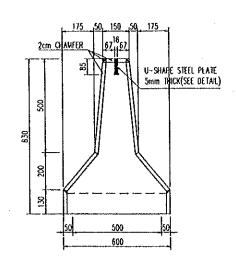


**FRONT ELEVATION** SCALE 1:20

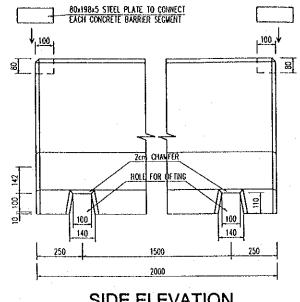


SIDE ELEVATION SCALE 1:20

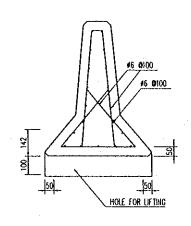

REINFORCEMENT DETAIL SCALE 1:20

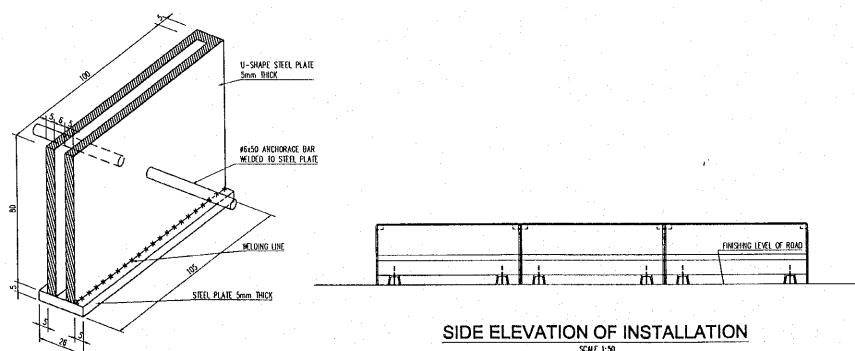

SCALE 1:50

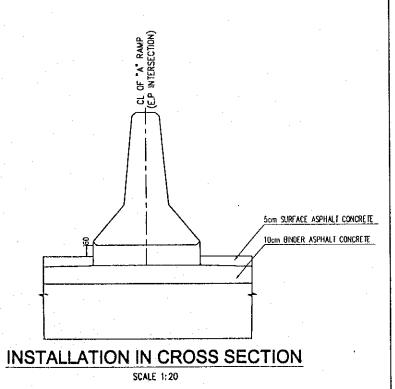


LKOIECT NAME	
DETAILED DESIGN OF	
THE CAN THO BRIDGE	
CONSTRUCTION PROJECT	

IMPI	EMENTATION.
	JAPAN INTERI
	COOPERATIO
	( JICA

DETAIL OF U-SHAPE STEEL PLATE

AGENCY NATIONAL ON AGENCY

EXECUTING AGENCY SOCIALIST REPUBLIC OF VIET NAM MINISTRY OF TRANSPORT ( MOT ) MY THUAN PROJECT MANAGEMENT UNIT

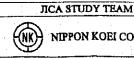



NIPPON KOEI CO.,LTD.

PREPARED BY | CHECKED BY | APPROVED BY NAME K. Nemoto K. Nakai K. Enomoto SIGNATURE & NAMEZA 41 A.E 5/10/2000 DATE 20/9/2000 29/9/2000

DRAWING TITLE DETAIL OF MEDIAN BARRIER WALL ON "A" RAMP OF E.P INTERSECTION

DWG NO. P3/MS/0170

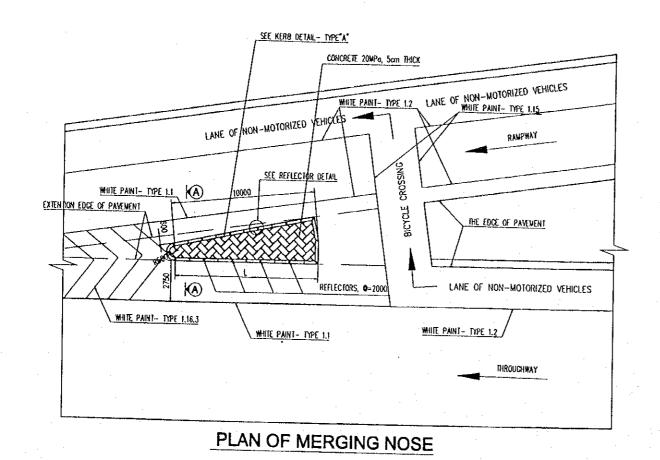

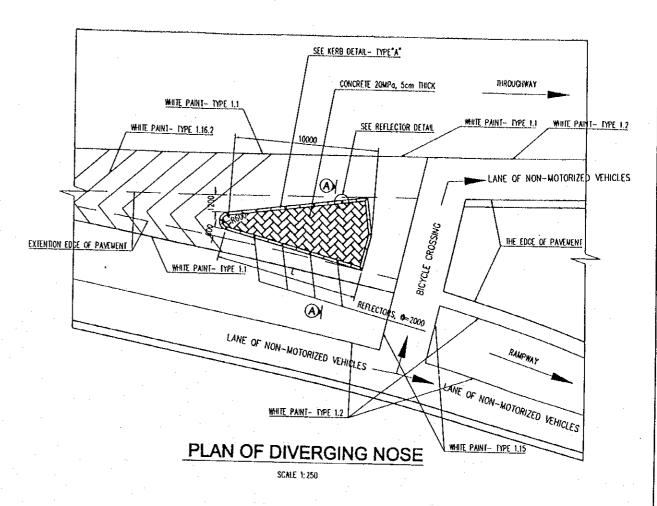

PRECAST CONCRETE XERB(20MPa) 50 150 SAND, Jcm THICK
PAVEMENT OF THROUGHWAY

CRUSHED MATERIAL, 10cm THICK

CRUSHED MATERIAL, 10cm THICK

SAND, Jcm THICK

CRUSHED MATERIAL, 10cm THICK

SAND, Jcm THICK

PAVEMENT OF THROUGHWAY

PAVEMENT OF RAMPWAY

THE 1st SURFACE OF BASE COURSE

100 200 100

LEAN CONCRETE 15MPa

CONCRETE 20MPa, 5cm THICK

200

PRECAST CONCRETE KERB(20MPa)

PAVEMENT OF RAMPWAY

DIPLOMATERIAL TO THE SOUTH OF THE SURFACE OF BASE COURSE

LEAN CONCRETE 15MPa

LEAN CONCRETE 15MPa

A-A (KERB - TYPE "A")

REFLECTIVE SURFACE

SIDE ELEVATION OF

INSTALLING REFLECTORS
REFLECTOR DETAIL


# NOTES:

PAINTING WHITE PAINT TYPE 2.7 ALONG THE KERB OF NOSE

SET REFLECTOR INTO THE GAP BETWEEN TWO KERBS, THEN FILLING MORTAR


PROJECT NAME IMPLEMENTATION AGENCY **EXECUTING AGENCY** JICA STUDY TEAM DETAILED DESIGN OF PREPARED BY CHECKED BY APPROVED BY JAPAN INTERNATIONAL SOCIALIST REPUBLIC OF VIET NAM DRAWING TITLE THE CAN THO BRIDGE DWG NO. COOPERATION AGENCY NAME K. Nemoto K. Nakai K. Enomoto MINISTRY OF TRANSPORT (MOT) CONSTRUCTION PROJECT NIPPON KOEI CO.,LTD. (JICA) SIGNATURE L Nemote DETAIL OF NOSE MY THUAN PROJECT MANAGEMENT UNIT P3/MS/0180 DATE 20/9/2000 AT RAMPWAY TERMINALS

# TYPE 1: CROSS-SECTION INSIDE 25m-DISTANT FROM ABUTMENT

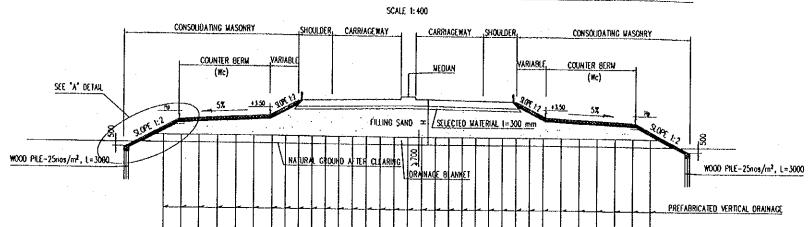


Н	5m <b>¢H¢6</b> m	H>6m
Wc	10m	12m
Нр	+3.00	+2.90

# TYPE 2: CROSS-SECTION OUTSIDE 25m-DISTANT FROM ABUTMENT

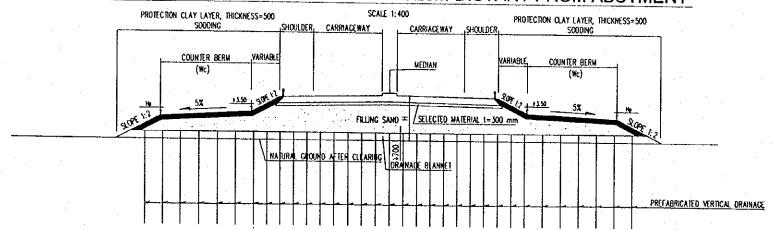


## "A" DETAIL

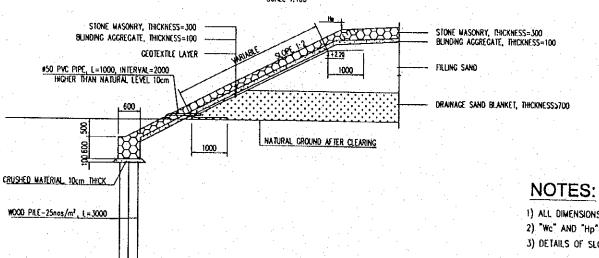


- 1) ALL DIMENSIONS ARE IN MILIMETER, UNLESS OTHERWISE INDICATED.
- 2) "Wc" AND "Hp" ARE THE WIDTH AND THE ELEVATION OF COUNTER BERM
- 3) DETAILS OF SLOPE PROTECTION SEE BRIDGE DRAWNGS.

PROJECT NAME	IMPLEMENTATION AGENCY	EXECUTING AGENCY	JICA STUDY TEAM					
DETAILED DESIGN OF	JAPAN INTERNATIONAL	SOCIALIST REPUBLIC OF VIET NAM	JICA STODY TEAM		RED BY   CHECKED BY	APPROVED BY	DRAWING TITLE	DWG NO.
THE CAN THO BRIDGE	COOPERATION AGENCY	MINISTRY OF TRANSPORT ( MOT )		NAME K. Nen	16, 14MM1	K. Enomoto		
CONSTRUCTION PROJECT	= / ***	MY THUAN PROJECT MANAGEMENT UNIT	(NK) NIPPON KOEI CO.,LTD.	SIGNATURE & NAME	<u> </u>	Wilson T	SLOPE PROTECTION (1/2)	P3/MS/0190
	(1111)	MIT THOANTROJECT MANAGEMENT UNIT	<u>v</u>	DATE 20/9/20	2000 29/9/2000	5/10/2000		


# TYPE 3: CROSS-SECTION INSIDE 25m-DISTANT FROM ABUTMENT

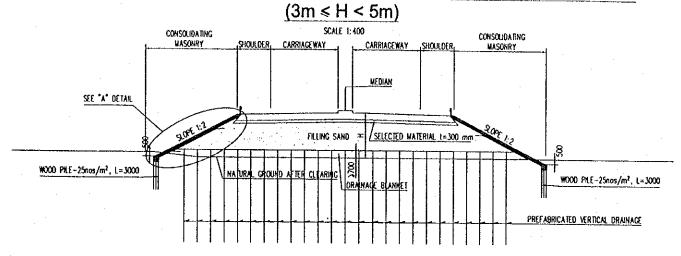

# TYPE 4: CROSS-SECTION OUTSIDE 25m-DISTANT FROM ABUTMENT

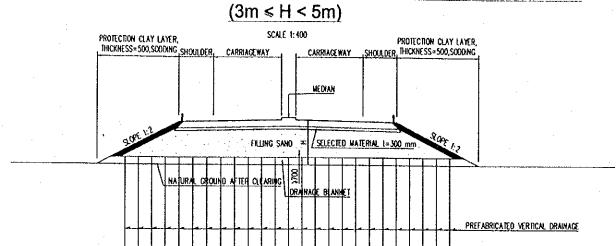


# TYPE 5: CROSS-SECTION OUTSIDE 25m-DISTANT FROM ABUTMENT

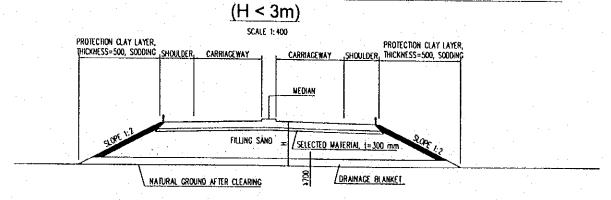



### NOTES:

1) ALL DIMENSIONS ARE IN MILIMETER, UNLESS OTHERWISE INDICATED.

PROJECT NAME	IMPLEMENTATION AGENCY	EXECUTING AGENCY	JICA STUDY TEAM	PREPARED BY	CHECKED BY	APPROVED BY	DRAWING TITLE	DWG NO.
DETAILED DESIGN OF THE CAN THO BRIDGE CONSTRUCTION PROJECT	JAPAN INTERNATIONAL COOPERATION AGENCY ( JICA )	SOCIALIST REPUBLIC OF VIET NAM MINISTRY OF TRANSPORT ( MOT ) MY THUAN PROJECT MANAGEMENT UNIT	NIPPON KOEI CO.,LTD.	NAME K. Nemoto SIGNATURE A Name DATE 20/9/2000		K. Enomoto 5/10/2000	SLOPE PROTECTION (2/2)	P3/MS/0200

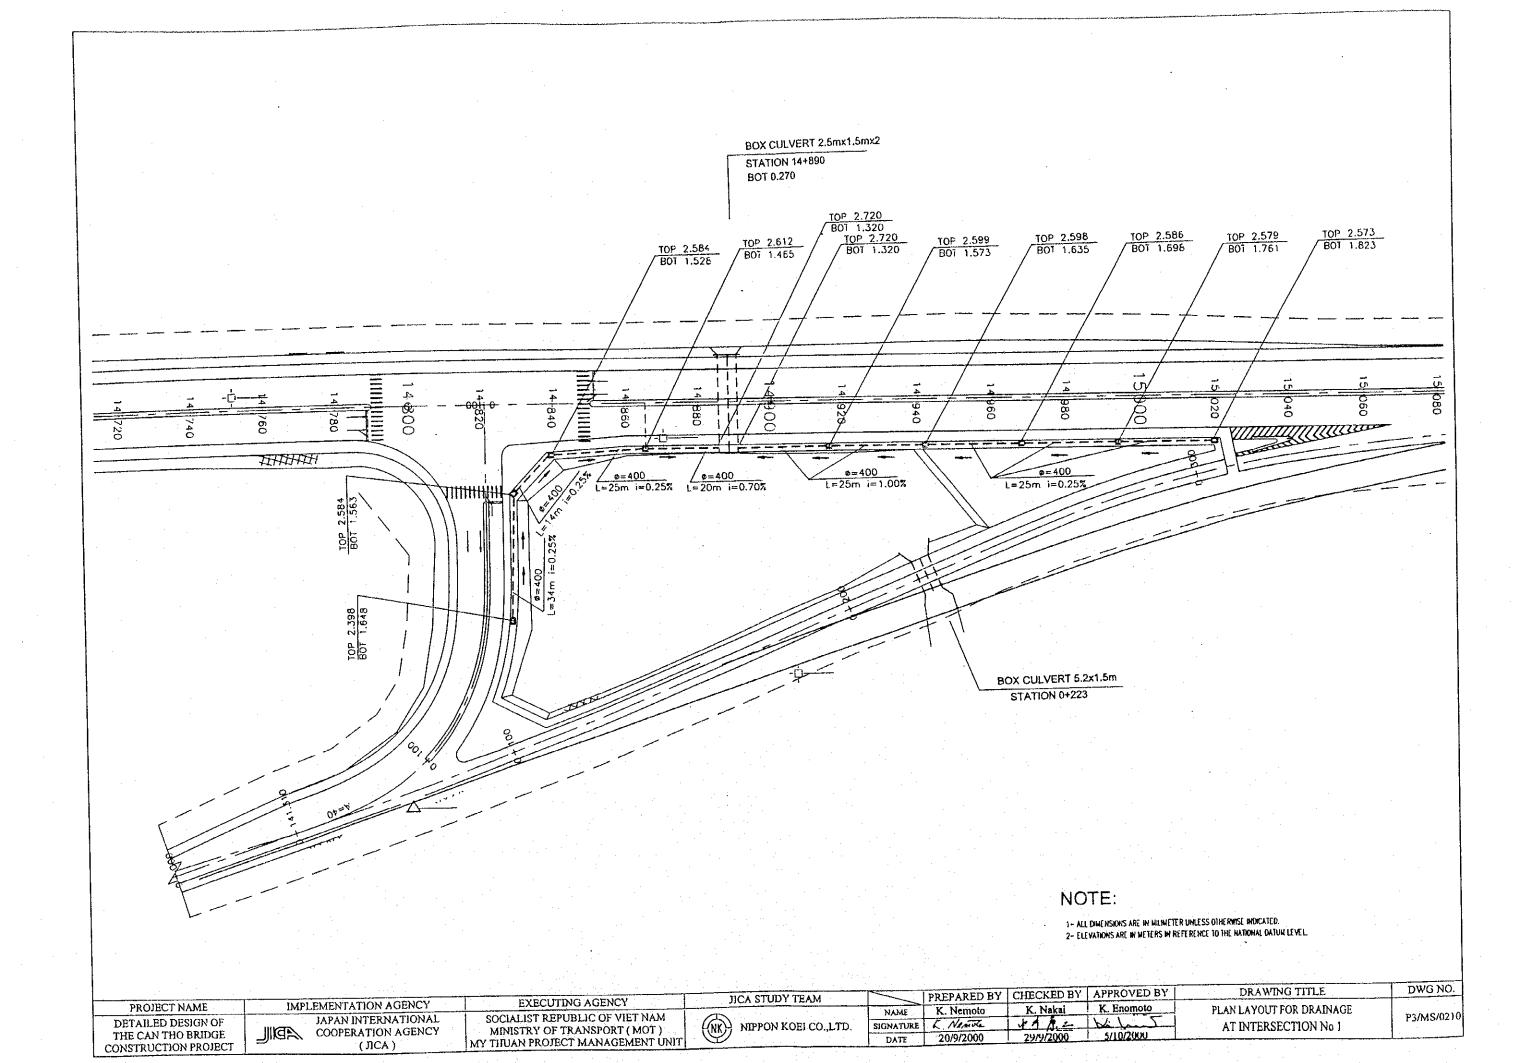


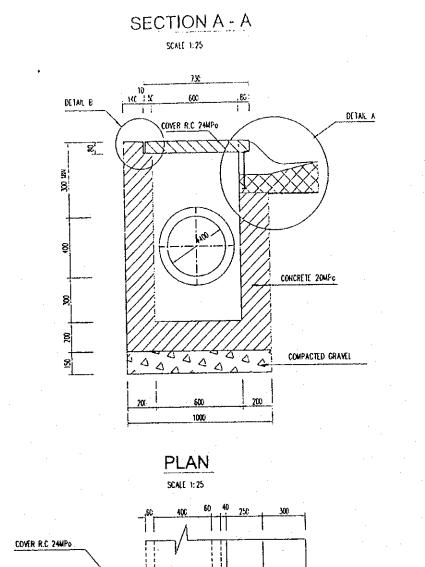

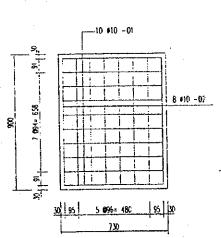

COVER

SCALE 1:25

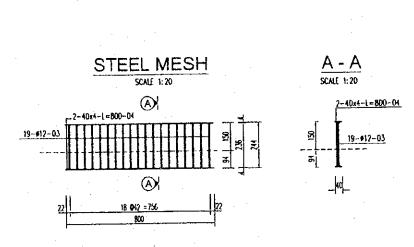

DETAIL A

KERB CONCRETE 24MPb


PLASTERING CEMENT

SCALE 1: 20

COVER R.C 24MPo

SILLI MIZA

CONCRETE 20MPc

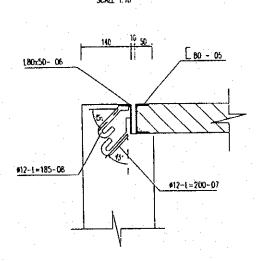

**DETAIL** B

#### MISCELANEOUS WORK OF INTERSECTION No1

-	Culverts 400mm diometer			Calch pil				Pil cover			Steel	Kerbs	
	Pipes (m)	Joints No	Composted grove:	Concrete 20 MPo groce (m 3)	Compacted arove!	Reinforcement 12 mm diameter (Kg)	l 80x50 steo! (Kg)		Reinforcement 10 mm diameter (Kg)	BO steal (Kg)	Pieces steol 40x4x800 mm (Kg)	Reinforcement 12 mm diameter (Kg)	Concrete 24 MPc grade (m <sup>.3</sup> )
	218	216	39.74	9.51	1.62	21.54	107.78	0.47	94.11	206.85	18.09	35.84	0.58


CATCH PIT & DROP INLET

<u>(3</u>

<sup>8</sup> €

- ALL DIMENSIONS ARE IN MILIMETER UNLESS OTHERWISE INDICATED.


		TYPOUTDIC AGENCY	IICA STUDY TEAM   PREPARED BY CHECKED BY APPROVED BY DRAWING TITLE DWG NO.	
PROJECT NAME	IMPLEMENTATION AGENCY	EXECUTING AGENCY	NAME K. Nemoto K. Nakai K. Enomoto DETAIL OF CATCH PIT, DROP INLET AND COVER	í
DETAILED DESIGN OF	JAPAN INTERNATIONAL	SOCIALIST REPUBLIC OF VIET NAM	NEPPON KOEI CO., LTD. SIGNATURE & New 1 1 1 INTERSECTION No 1	i
THE CAN THO BRIDGE	JINCE COOPERATION AGENCY	MINISTRY OF TRANSPORT (MOT)		į
CONSTRUCTION PROJECT	(JICA)	MY THUAN PROJECT MANAGEMENT UNIT	DAIL TOTAL STATES	

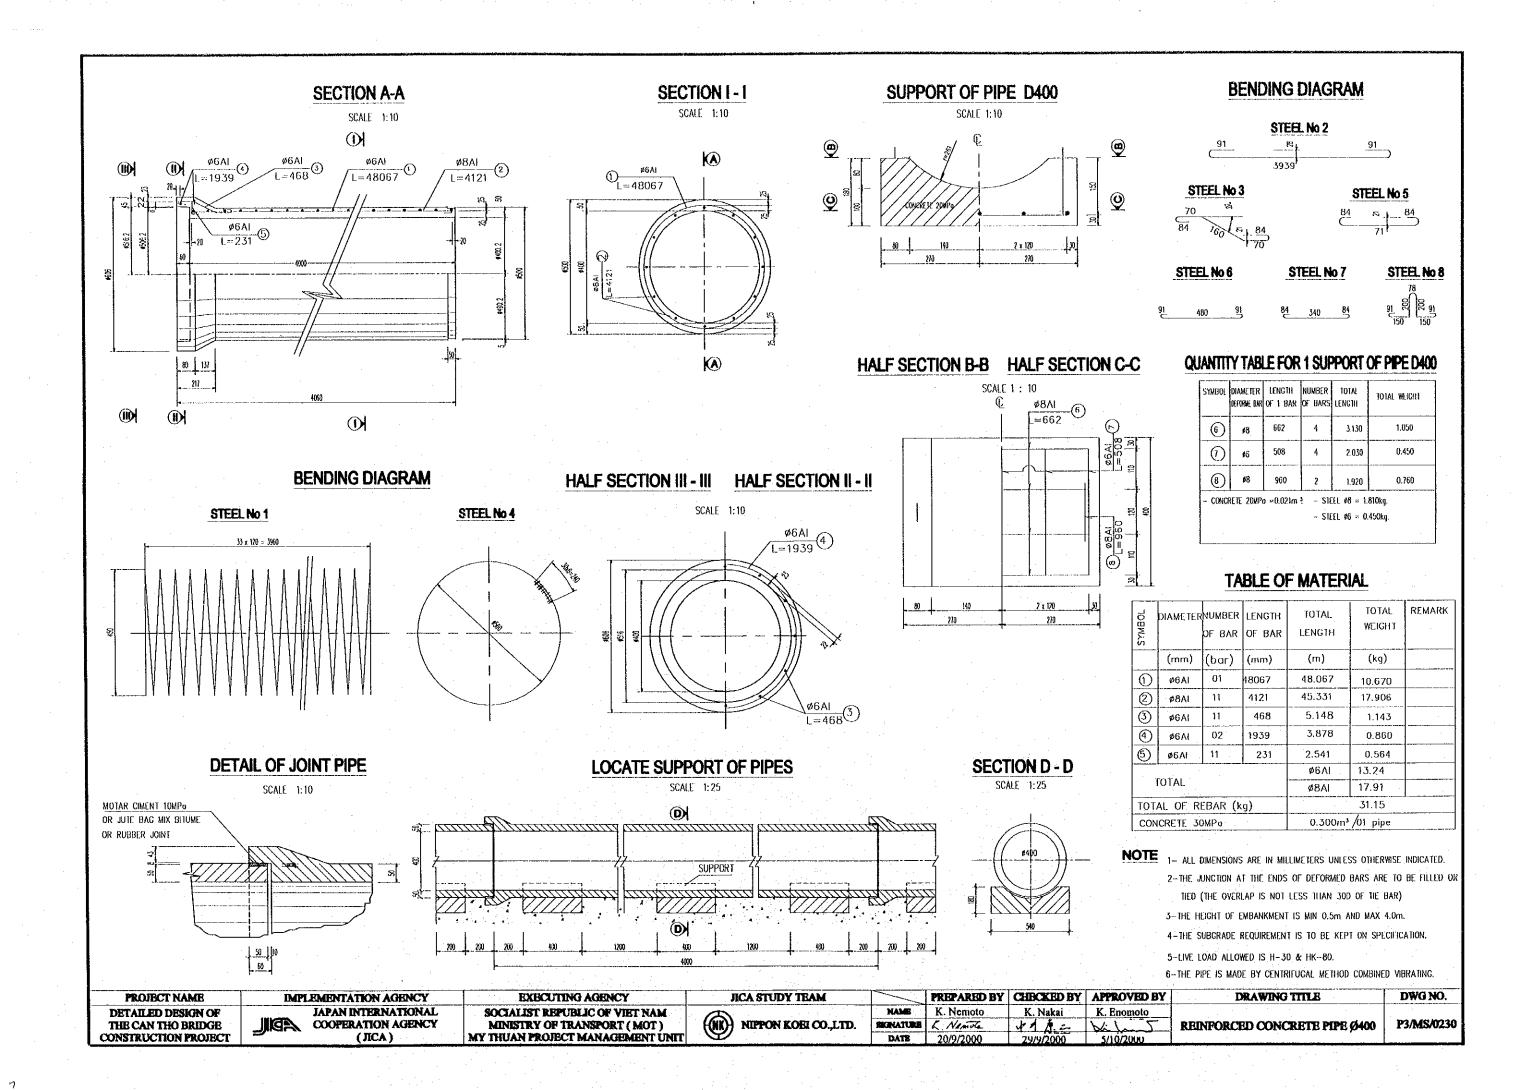

# SCHEDULE OF SERVICE ROAD

No CHAINAGE		LOCATION	LENGTH	WIDTH	GROUND	DESIGN FLEVATION (m)		
ľ	FROM	10	LOCASION	(m)	(m)	ELEVATION (m)	FROM	10
1	7+640.00	7+700.00	LEF THRIGHT	162.00	2.50 / 3.00	0,10	1.74	1.74
2	71700.00	7+769.00	LEFTERICHT	139.00	2.50 / 3.00	0.10	1.74	4.65
3	8+321.00	8 † 478.00	LEFT I RICHT	221.00	2.50 / 3.00	0.41	1.74	5.60
4	8+614.00	8+724.50	LEFT+RIGHT	230.00	2.50 / 3.00	0.31	1.74	1.74
5	8+724.50	8+785.00	LEFTERIGHT	123.00	2.50 / 3.00	0.41	1.74	4.61
6	9+337.00	9+380.00	LEFT + RIGHT	90.00	2.50 / 3.00	1.10	4.98	. 1.74
7	9+380.00	9+440.00	LEFT+RIGHT	138.00	2.50 / 3.00	0.50	1.74	1.74
8	9+461.00	9+521.50	LEFT+RIGHT	147.00	2.50 / 3.00	0.50	1.74	1.74
9	91 521.50	9+592.00	LEĘTERICHT	157.00	2.50 / 3.00	1.50	1.74	5.02
10	10+341.00	101-445.00	LEFT+RIGHT	339.00	2.50 / 3.00	1.20	1.74	1.74
11	10+473.00	10+560.00	LEFT I RICHT	148.00	2.50 / 3.00	0.65	1.74	1.74
12	10+560.00	10 ± 602.00	LEFT+RICHT	80.00	2.50 / 3.00	1.45	1.74	4.09
13	11+084.00	11+160.00	LEFT+RIGHT	124.00	2.50 / 3.00	1.00	4.47	1.74
14	11+160.00	11+205.00	LEFT+RIGHT	160.00	2.50 / 3.00	1.00	1.74	1.74
15	11+227.00	11+280.00	LEFT+RIGHT	175.00	2.50 / 3.00	. 1.00	1.74	1.74
16	11 + 280.00	11+337.00	LEFT+RIGHT	109.00	2.50 / 3.00	1.00	1,74	4.68
17	12+188.00	12+254.00	LEFTERIGHT	135.00	2.50 / 3.00	0.90	6.15	1.74
18	12+254.00	12+361.00	LEF1+RICHT	287.00	2.50 / 3.00	0.90	1,74	1,74
19	12+451.00	12+507.00	LEFT+RIGHT	258.00	2.50 / 3.00	1.00	1.74	1.74
20	12+507.00	12+586.00	LEFTERICHT	149.00	2.50 / 3.00	1.00	1.74	5.60
21	12+967.00	13+023.00	LEFT#RIGHT	108.00	2.50 / 3.00	1,00	3.79	1.74
22	13+023.00	13+159.00	LEFT+RIGHT	287.00	2.50 / 3.00	1.00	1.74	1.74
23	13+206.00	13 ± 320.00	LEFT+RICHT	263.00	2.50 / 3.00	1.10	1.74	1.74
24	13+320.00	13+380.00	LEFT+RIGHT	101.00	2.50 / 3.00	11.00	1.74	4.01
25	131674.00	13+754.00	LEFT+RIGHT	120.00	2.50 / 3.00	1.20	2.63	1.74
26	13+754,00	13+877.00	LEFT+RIGHT	327.00	2.50 / 3.00	1.20	1.74	1.74
21	13+959.00	141160.00	LEF 1+RIGHT	381.00	2.50 / 3.00	1.00	1.74	1.74
28	14 ( 160.00	14+245.00	LEFTERICHT	152.00	2.50 / 3.00	. 1.10	1.74	5.58
<u> </u>		TOTAL	*.	5110.00			· · · · · · · · · · · · · · · · · · ·	

# TYPICAL CROSS SECTION

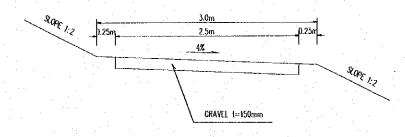

- 1	PROJECT NAME	IMPLEMENTATION AGENCY	EXECUTING AGENCY	JICA STUDY TEAM		PREPARED BY	CHECKED BY	APPROVED BY	DRAWING TITLE	DWG NO.
ı	DETAILED DESIGN OF	JAPAN INTERNATIONAL	SOCIALIST REPUBLIC OF VIET NAM		NAME	K. Nemoto	K. Nakai	K. Enomoto	APPROACH ROAD OF CAN THO BRIDGE	
	THE CAN THO BRIDGE	COOPERATION AGENCY	MINISTRY OF TRANSPORT (MOT)	(NK) NIPPON KOEI CO.,LTD.	SIGNATURE	K. Nemole	41 A.	Wilmy	SCHEDULE OF SEVICE ROAD	P3/MS/0240
4	CONSTRUCTION PROJECT	(JICA)	MY THUAN PROJECT MANAGEMENT UNIT		DATE	20/9/2000	29/9/2000	5/10/2000	SOUTH OF HE KAN BOTH	<u> </u>

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