




10 15mSCALE 1:300 THE ARAB REPUBLIC OF EGYPT MINISTRY OF WATER RESOURCES AND IRRIGATION NORTH SINAI DEVELOPMENT ORGANIZATION THE NORTH SINAI INTEGRATED RURAL DEVELOPMENT PROJECT (PHASE III) CONVEYANCE SYSTEM OF EL SHEIKH GABER EL SABBAH CANAL MAIN POWER SUBSTATION (FOR EL SALAAM No. 7 P.S.) MAIN SUBSTATION FRAMING ELEVATION JAPAN INTERNATIONAL COOPERATION AGENCY (JICA) Sanyu Consultants Inc, Pacific Consultants International DESIGNED TRACED CHECKED APPROVED DRAWING NO. SBW-416

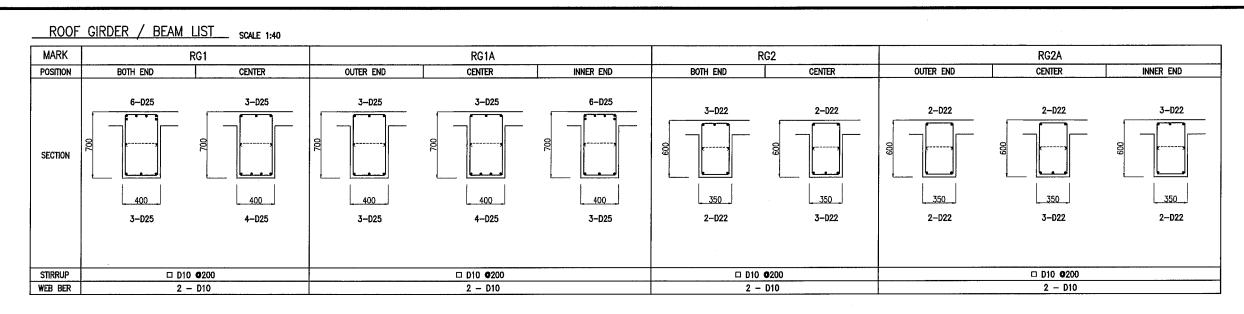


GRADE BEAM LIST SCALE 1:40

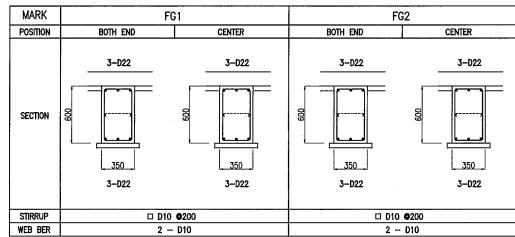


# COLUMN LIST SCALE 1:40

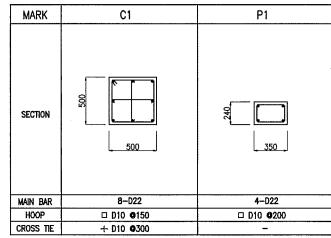


BEAM LIST SCALE 1:40

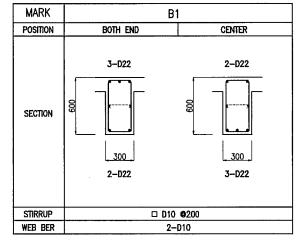




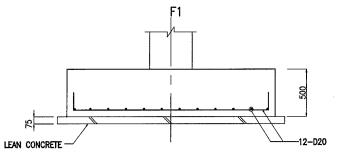


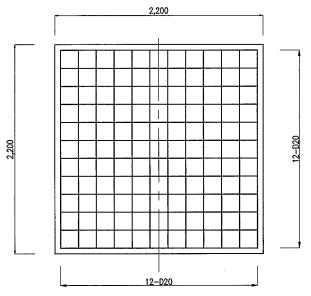


PARAPET

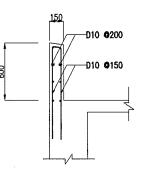



SLAB LIST SCALE 1:40 MARK RS1 GS1 SHORT SPAN SHORT SPAN -D12 **0**200 -D10 **O**200 -D12 **O**200 -D10 **O**200 SECTION 150 <del>/ . . . .</del> . 20 ∽D10 **©**200 <sup>1</sup> D12 0200 -D10 **O**200 --D12 **0**200 F2

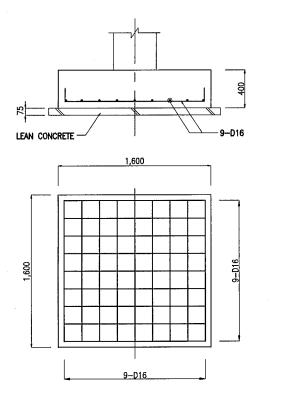


THE ARAB REPUBLIC OF EGYPT WINISTRY OF WATER RESOURCES AND IRRIGATION NORTH SINAI DEVELOPMENT ORGANIZATION THE NORTH SINAI INTEGRATED RURAL DEVELOPMENT PROJECT (PHASE III)							
	SYSTEM OF EL SHEIKH GABER EL SABBAH CANAL R SUBSTATION (FOR EL SALAAM No. 7 P.S.) MAIN SUBSTATION WENBER SCHEDULE						
	JAPAN INTERNATIONAL COOPERATION AGENCY (JICA) Sanyu consultants inc, pacific consultants international						
DESIGNED							
TRACED							
CHECKED							
APPROVED							
DRAWING NO.	SBW-417						

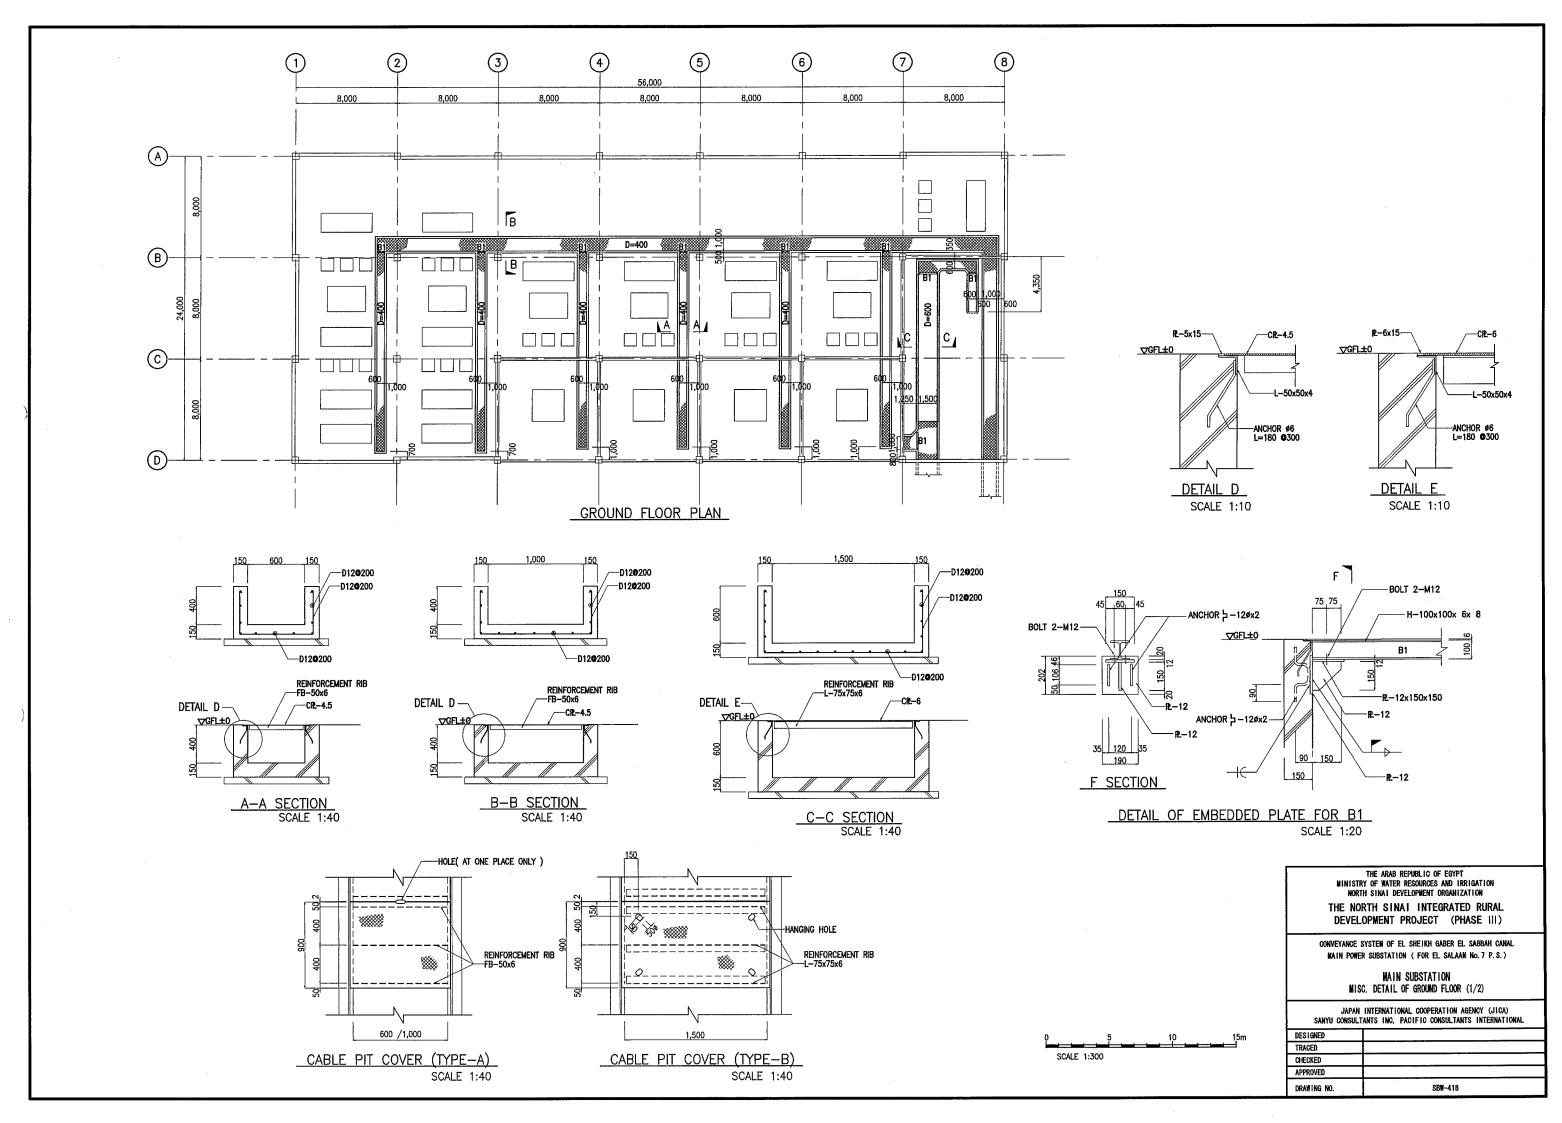


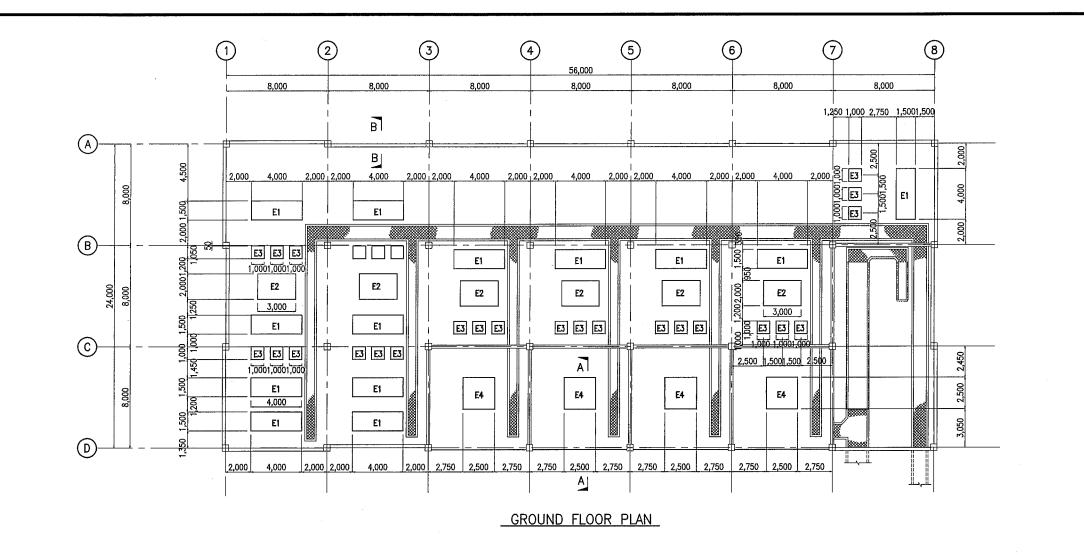

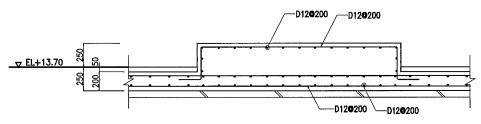

REINFORCEMENT FOR EQUIPMENT FOUNDATION E1,E2,E3 SCALE 1:40

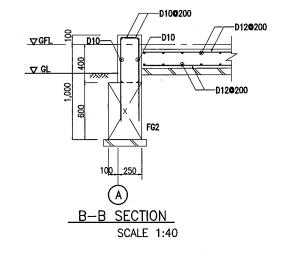


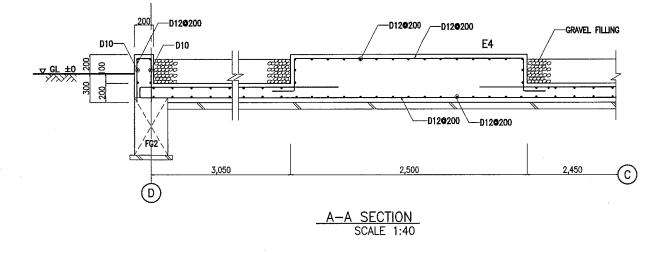

SCALE 1:300

THE ARAB REPUBLIC OF EGYPT WINISTRY OF WATER RESOURCES AND IRRIGATION NORTH SINAI DEVELOPMENT ORGANIZATION									
THE NORTH SINAI INTEGRATED RURAL DEVELOPMENT PROJECT (PHASE 111)									
CONVEYANCE SYSTEM OF EL SHEIKH GABER EL SABBAH GANAL MAIN POWER SUBSTATION ( FOR EL SALAAM No.7 P.S.)									
MIS	MAIN SUBSTATION C. DETAIL OF GROUND FLOOR (2/2)								
JAPAN INTERNATIONAL COOPERATION AGENCY (JICA) Sanyu consultants inc, pacific consultants international									
DESIGNED									
TRACED									
CHECKED									
APPROVED									
DRAWING NO.	SB#-419								

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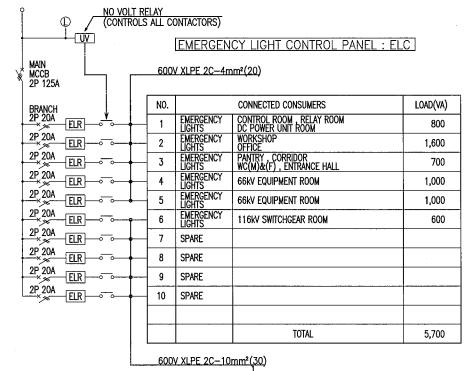

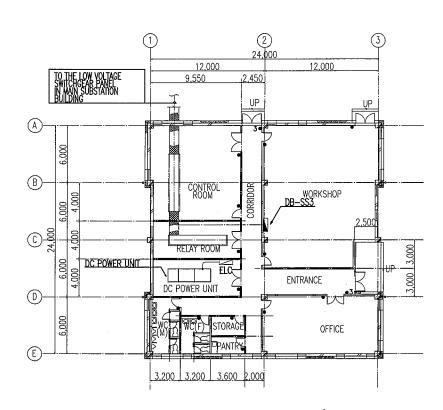
## GROUND FLOOR PLAN S=1/400

LEGEND

LEGEND	
SYMBOL	DESCRIPTION
	DISTRIBUTION BOARD (WALL SURFACE MOUNT)
٥	REMOTE CONTROL SWITCH (LIGHTING)
•	1-WAY LIGHTING SWITCH
•3	3-WAY LIGHTING SWITCH
WP	WATER PROOFING
- <u>.</u>	LIGHTING MAIN LINE (EXPOSED WIRING)
	LIGHTING MAIN LINE (UNDER FLOOR WIRING)





CONDUIT SIZE(TYPICAL)

DISTRIBUTION	DOVDD	DD CCZ
	DUARU	00-333

3 PHASE 380/220V A,B,C+N

A-NB-NC-N ₽₽₽₽

X	Main MCCB 3P+N 100A					
	MCCB	ſ	NO.		CONNECTED CONSUMERS	LOAD(VA)
ļ	ÎP 20A ELR	AN	1	LIGHTS	CONTROL ROOM	600
ļ	1P 20A ELR	<u> </u>	2	LIGHTS	WORKSHOP	1,000
ļ	1P 20A ELR	C-N	3	LIGHTS	WORKSHOP	900
ļ		A_N	4	LIGHTS	RELAY ROOM DC POWER UNIT ROOM	800
ļ		BN ~	5	LIGHTS	WC(M)&(F) PANTRY, STORAGE	600
ļ		C_N	6	LIGHTS	CORRIDOR , ENTRANCE HALL MAIN ENTRANCE EVES	950
ļ	1P 20A 	A-N	7	LIGHTS	EXTERIOR OF PUMP STATION	2,000
		<u> </u>	8	LIGHTS	EXTERIOR	2,000
-		C_N	9	LIGHTS	EXTERIOR	2,000
ł		<u>A_N</u>	10	LIGHTS	EXTERIOR	2,000
	1P 20A ELR	<u>B-N</u>	11	LIGHTS	EXTERIOR	2,000
	1P 20A ELR	CN	12	SPARE		
+	1P 20A ELR	A-N	13	SOCKET	CONTROL ROOM	1,000
+	1P 20A 	B-N	14	SOCKET OUTLETS	WORKSHOP	1,000
+	1P 20A 	C-N	15	SOCKET OUTLETS	OFFICE	1,000
ł		A_N	16	SOCKET OUTLETS	RELAY ROOM DC POWER UNIT ROOM	1,000
+		BN	17	SOCKET OUTLETS	PANTRY	1,000
+		C-N	18	SOCKET OUTLETS	PANTRY	1,000
ł	1P 20A ELR	A-N	19	SOCKET	WC(M)&(F) CORRIDOR, ENTRANCE HALL	1,000
ł	1P 20A 	B_N	20	SPARE	· · · · · · · · · · · · · · · · · · ·	
+		C_N	21	SPARE		
+	1P 30A 	A_N	31	SOCKET	CONTROL ROOM	4,000
+	1P 30A ELR	B-N	32	SOCKET	WORKSHOP	4,000
+	1P 30A ELR	<u> </u>	33	SOCKET OUTLETS	WORKSHOP	4,000
ł	1P 30A ELR	A-N	34	SOCKET OUTLETS	WORKSHOP	4,000
+	1P 30A ELR	B-N	35	SPARE		
ł	1P 30A ELR	C-N	36	SPARE		
ł	3P 20A ★≫ ELR	A,B,C	51	SOCKET OUTLETS	CONTROL ROOM	5,000
┝	3P 20A ≫ ELR	A,B,C	52	SOCKET OUTLETS	WORKSHOP	5,000
					TOTAL	47,850

## LIGHTING FIXTURE SCHEDULE

### DESCRIPTION CEILING SURFACE MOUNTED TYPE WITH METALLIC LOW BRIGHTNESS LOUVER(IP51) CEILING SURFACE MOUNTED OPEN TYPE (IP51)

PIPE PENDANT TYPE WITH HIGH CEILING MOUNTEL WITH METALLIC REFLEC FLOOD LIGHT FIXTURE(

Pole top mounted ty Fixture(IP65) WALL MOUNTED TYPE WITH

CEILING/WALL MOUNTED

NOTE:

IL : INCANDESCENT LAMP FL :FLUORESCENT LAMP

HPS : HIGH-PRESSURE SODIUM LAMP

SON :SODIUM LAMP

### INSTALLATION SCHEDULE

P0014 (1971		LIGHT	ING	SOCKET OUTLET			
ROOM/AREA	GENERAL TYPE-NUMBERS		Emergency Type-Numbers		1P+E 15A 220V	2P+E 30A 220V	3P+E 20A 380V
CONTROL ROOM	A-FL322	12	H–IL100	6	6	1	1
WORKSHOP	B-FL322	19	H-1L100	8	8	3	1
OFFICE	AFL322	8	H-IL100	4	8		
RELAY ROOM	B-FL322	4	H-IL100	1	1		
DC POWER UNIT ROOM	B-FL322	4	H-IL100	1	1		
STORAGE	B-FL321	1					
PANTRY	B-FL322	<u></u> 1	H—IL100	1	3		
WC(M)	B-FL322	3	H—IL100	1	1		
WC(F)	B-FL322	2	H-IL100	1	1		
CORRIDOR	B-FL321	9	H-1L100	3	3		
ENTRANCE HALL	B-FL322	3	H-IL100	1	1		
MAIN ENTRANCE EAVES	G-FL321	2					
ENTRANCE EAVES(1)	GFL321	1					
ENTRANCE EAVES(2)	G-FL321	1					
exterior	F-SON125	50					

LIGHTING	AND SOCKET OUTLET INSTILLATION SCHEDULE
	PAN INTERNATIONAL COOPERATION AGENCY (JICA) Sultants Inc, Pacific consultants international
DESIGNED	
TRACED	
CHECKED	
APPROVED	
DRAWING NO.	SB₩-420

DEVELOPMENT PROJECT (PHASE III) CONVEYANCE SYSTEM OF EL SHEIKH GABER EL SABBAH CANAL MAIN POWER SUBSTATION (FOR EL SALAAM No. 7 P.S.)


ADMINISTRATION BUILDING

THE ARAB REPUBLIC OF EGYPT WINISTRY OF WATER RESOURCES AND IRRIGATION NORTH SINAI DEVELOPMENT ORGANIZATION THE NORTH SINAI INTEGRATED RURAL


ED TYPE WITH METALLIC LOW	A-FL322 A-FL323	FL32W×2 FL32W×3
ed open type (IP51)	B-FL321 B-FL322	FL32WX1 FL32WX2
I METALLIC REFLECTOR(IP51)	C-FL321 C-FL322	FL32WX1 FL32WX2
D TYPE CTOR(IP51)	D-HPS400	HPS400W×1
(IP65)	E-HPS400	HPS400W×1
YPE AREA LIGHTING	F-SON125	SON125W×1
H PLASTIC COVER(IP65)	G-FL321	FL32W×1
TYPE(IP51)	H-1L100	IL100W×11

TYPE

LAMPS

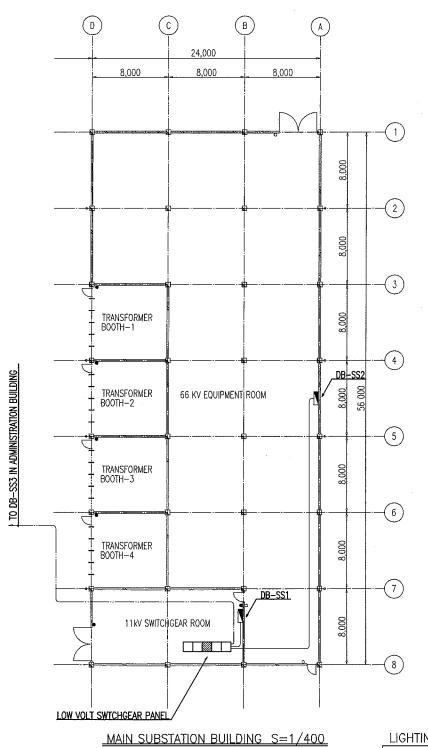

3 PHASE 380/220V A.B.C+N				
A-NB-NC-N MAIN MCCB 3P+N 60A		DISTRIBU	TION BOARD DB-SS1	
MCCB	NO.		CONNECTED CONSUMERS	LOAD(VA)
MCCB 1P 20A ELR A-N	1	LIGHTS	11kV SWITCHGEAR ROOM ENTRANS EAVES(1)	650
1P 20A ELR B-N	2	LIGHTS	11kV SWITCHGEAR ROOM	1,200
1P 20A C-N	3	LIGHTS	TRANSFORMER BOOTH(1)(2)(3)(4)	800
1P 20A ELR A-N	4	SOCKET OUTLETS	11kV SWITCHGEAR ROOM	1,000
1P 20A ELR B-N	5	SOCKET	11kv Switchgear Room	1,000
1P 20A C-N	6	SOCKET	TRANSFORMER BOOTH(1)(2)(3)(4)	1,000
1P 20A ELR A-N	7	SPARE		
1P 20A ELR B-N	8	SPARE		
1P 20A ELR C-N	9	SPARE		
1P 30A ELR A-N	31	SOCKET	11kV SWITCHGEAR ROOM	4,000
1P 30A ELR B-N	32	SPARE		
3P 20A ELR A,B,C	51	SOCKET OUTLETS	11kV SWITCHGEAR ROOM	5,000
			TOTAL	60,600

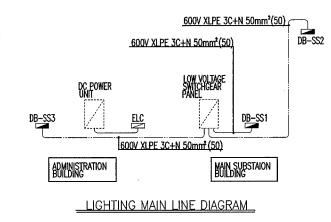

TULO		COLIFPIN	
HNG	FIXTURE	SCHEDUL	_E

DESCRIPTION	TYPE	LAMPS
CEILING SURFACE MOUNTED TYPE WITH METALLIC LOW BRIGHTNESS LOUVER(IP51)	A-FL322 A-FL323	FL32WX2 FL32WX3
CEILING SURFACE MOUNTED OPEN TYPE (IP51)	B-FL321 B-FL322	FL32W×1 FL32W×2
PIPE PENDANT TYPE WITH METALLIC REFLECTOR(IP51)	C-FL321 C-FL322	FL32W×1 FL32W×2
HIGH CEILING MOUNTED TYPE WITH METALLIC REFLECTOR(IP51)	D-HPS400	HPS400W×1
FLOOD LIGHT FIXTURE(IP65)	E-HPS400	HPS400W×1
Pole Top Mounted type area lighting Fixture(IP65)	F-SON125	SON125W×1
WALL MOUNTED TYPE WITH PLASTIC COVER(IP65)	GFL321	FL32W×1
CEILING/WALL MOUNTED TYPE(IP51)	H-1L100	IL100W×11

### NOTE:

IL :INCANDESCENT LAMP

FL :FLUORESCENT LAMP

HPS :HIGH-PRESSURE SODIUM LAMP

SON :SODIUM LAMP

INSTALLATION S	SCHEDULE												
	LIGHTING				SOCKET OUTLET			LIGHTING SOCKET OUTLET					
ROOM/AREA	GENERAL TYPE-NUMBERS	GENERAL EMERGENCY TYPE-NUMBERS TYPE-NUMBERS		1P+E 15A 2P+E 30A 3P+E 20A 220V 220V 380V									
66kV EQUPMENT ROOM	D-HPS400 B-FL321	15 20	H-IL100	20	18	6	4						
11kV SWITCHGEAR ROOM	B-FL322	18	H-IL100	6	6	1	1						
TRANSFORMER BOOTH(1)	B-FL321	4			1					THE ARAB REPUBLIC OF EGYPT Y OF WATER RESOURCES AND IRRIGATION			
TRANSFORMER BOOTH(2)	BFL321	4			1					H SINAI DEVELOPMENT ORGANIZATION			
TRANSFORMER BOOTH(3)	B-FL321	4			1					RTH SINAI INTEGRATED RURAL OPMENT PROJECT (PHASE III)			
TRANSFORMER BOOTH(4)	B-FL321	4			1								
ENTRANS EAVES(1)	G-FL321	1						C		SYSTEM OF EL SHEIKH GABER EL SABBAH CANAL R SUBSTATION(FOR EL SALAAM No. 7 P. S.)			
ENTRANS EAVES(2)	G-FL321	1								MAIN SUBSTATION BUILDING			
ENTRANS EAVES(3)	G-FL321	1			ļ			LIG	HTING AND	SOCKET OUTLET INSTALLATION SCHEDUL			
			1					SAN		INTERNATIONAL COOPERATION AGENCY (JICA) ANTS INC, PACIFIC CONSULTANTS INTERNATIONAL			
								DESIGNED	DESIGNED				
								TRACED					
								CHECKED					
								DRAWING		SB#-421			

I	I		DISTRIBU	TION BOARD DB-SS2	
MAIN MCCB 3P+N 200A					
MCCB 1P.20A	ſ	NO.		CONNECTED CONSUMERS	LOAD(VA)
	~_ <u>A–N</u>	1	LIGHTS	66KV EQUPMENT ROOM	1,500
	<u> </u>	2	LIGHTS	66kV EQUPMENT ROOM	2,000
1P 20A ELR	<u> </u>	3	LIGHTS	66KV EQUPMENT ROOM	2,000
	<u> </u>	4	LIGHTS	66kV EQUPMENT ROOM	2,000
1P 20A ELR	<u> </u>	5	LIGHTS	ENTRANS EAVES(2)	550
IP 20A <u>ELR</u>	<u> </u>	6	LIGHTS	ENTRANS EAVES(3)	550
IP 20A ELR	AN	7	SPARE		
IP 20A ELR	<u> </u>	8	SPARE		
<u>1P 20A</u> <u>ELR</u>	<u> </u>	9	SPARE		
<u>1P 20A</u> ELR	AN	10	SOCKET OUTLETS	66kV EQUPMENT ROOM	1,000
1P 20A ELR	B_N	11	SOCKET	66kV EQUPMENT ROOM	1,000
<u>1P 20A</u> ELR	<u> </u>	12	SOCKET OUTLETS	66KV EQUPMENT ROOM	1,000
1P 20A <u>ELR</u>	A_N	13	SPARE		
IP 20A ELR	<u> </u>	14	SPARE		
<u>1P 20A</u> <u>× ELR</u>	<u> </u>	15	SPARE		
IP 30A ELR	<u> </u>	31	SOCKET OUTLETS	66KV EQUPMENT ROOM	4,000
IP 30A ELR	<u> </u>	32	SOCKET OUTLETS	66kV EQUPMENT ROOM	4,000
1P 30A ELR	<u> </u>	33	SOCKET	66kV EQUPMENT ROOM	4,000
1P 30A ELR	AN	34	SOCKET	66kV EQUPMENT ROOM	4,000
1P 30A ELR	B-N	35	SOCKET	66kV EQUPMENT ROOM	4,000
1P 30A ELR	<u> </u>	36	SOCKET	66kV EQUPMENT ROOM	4,000
3P 20A ELR	A,B,C	51	SOCKET	66kV EQUPMENT ROOM	5,000
3₽´20A ×≫ ELR	A,B,C	52	SOCKET	66kV EQUPMENT ROOM	5,000
3P 20AELR	A,B,C	53	SOCKET	66kv Equpment Room	5,000
3P 20A ELR	A,B,C	54	SOCKET	66kV EQUPMENT ROOM	5,000
3P 20A ELR	A,B,C	55	SOCKET	66kV EQUPMENT ROOM	5,000
	ļ				
			l	TOTAL	60,600

LEGEND

DESCRIPTION
DISTRIBUTION BOARD (WALL SURFACE MOUNT)
REMOTE CONTROL SWITCH (LIGHTING)
1-WAY LIGHTING SWITCH
3-WAY LIGHTING SWITCH
WATER PROOFING
LIGHTING MAIN LINE (EXPOSED WIRING)
LIGHTING MAIN LINE (IN CABLE PIT)

3 PHASE 380/220V A,B,C+N

# GENERAL NOTES FOR VENTILATION AIR CONDITIONING AND PLUMBING SYSTEM

### 1. DESIGN CRITERIA

DEGIGIT GIUTEIU		
OUTDOOR DESIGN CONDITIONS	:	37°CDB,23°CWB
INDOOR DESIGN CONDITIONS	:	25±1°CDB,50±10%RH
VENTILATION REQUIREMENT		
ROOM		VENTILATION RATE
WORK SHOP IN PUMP HOUSE	:	20 AC/H
WORK SHOP IN ADMINISTRATION BLDG TOILET	:	15 AC/H
SUB-STATION	:	15 AC/H
DC POWER UNIT ROOM	:	30 AC/H

### 2. LEGEND


SYMBOL	DESCRIPTION
	POTABLE WATER PIPE
	SEWAGE PIPE
$-\bowtie$	GATE VALVE
-N	CHECK VALVE
-57-	STRAINER "Y" TYPE
	AIR CONDITIONER,
0	OUTDOOR CONDENSING UNIT
←8	EXHAUST FAN
_8_	AXIAL FLOW FAN
$\boxtimes$	MANHOLE
(L)	LEVEL SWITCH

### 3. ABBREVIATIONS SUPPLY AIR REGISTER SAR СММ CUBIC METER PER MINUTES RA RETURN AIR SUPPLY AIR SA TYP. TYPICAL VAC VENTILATION AND AIR CONDITIONING AC/H AIR CHANGE PER HOUR DB DRY BULB RH RELATIVE HUMIDITY A/C AIR CONDITIONER


### 4. GENERAL NOTES


- 4.1 DRAWING OF VENTILATION, AIR CONDITIONING AND PLUMBING SYSTEM SHALL BE READ' IN CONJUNCTION WITH RELEVANT ARCHITECTURAL AND OTHER SERVICES DRAWINGS.
- 4.2 ALL DIMENSIONS ARE MILLEMETER UNLESS OTHERWISE INDICATED.
- 4.3 THE WORK SHALL BE EXE CUTED IN CLOSE COORDINATION WITH ALL TRADES.
- 4.4 ALL FLOOR MOUNTED EQUIPMENT SHALL BE PROVIDE WITH VIBRATION ISOLATORS TO PREVENT VIBRATION AND NOISE TRANSMISSION.
- 4.5 PRIMARY POWER TO THE MOTOR CONTROL PANEL (MCP) SHALL BE SUPPLIED BY THE ELECTRICAL WORK. MCP AND WIRING BETWEEN MCP AND EQUIPMENT SHALL ALSO BE THE SCOPE OF THE ELECTRICAL WORK.
- 4.6 PROVIDE AUTOMATIC AIR VENT VALVE AT HIGH POINT AND DRAIN VALVE AT LOW POINT IN THE WATER PIPING SYSTEM.
- 4.7 PROVIDE PIPE SLEEVES FOR ALL PIPING PASSING THROUGH BUILDING STRUCTURE.
- 4.8 PROVIDE ACCESS DOOR AT THE PIPE SHAFT AND ACCESS PANEL AT THE CEILING WHERE REQUIRED FOR PROPER OPERATION AND MAINTENANCE.
- 4.9 THE CONDENSATE DRAINPIPE SHALL BE DISCHARGED TO THE GROUND.
- 4.10 LOCATION OF OUTDOOR AIR INTAKE LOUVERS SHOWN ON THE DRAWINGS SHALL BE INDICATIVE ONLY AND SHALL BE REFERRED TO THE ARCHITECTURAL DRAWINGS.
- 4.11 ROOF OVER THE AIR CONDITIONED SPACE SHALL BE INSULATED.
- 4.12 THE PROPELLER TYPE EXHAUST FAN SHALL BE PROVIDED WITH GRAVITY LOUVER AND INSECT SCREEN.

	THE ARAB REPUBLIC OF EGYPT Y OF WATER RESOURCES AND IRRIGATION H SINAI DEVELOPMENT ORGANIZATION
THE NO	RTH SINAI INTEGRATED RURAL
DEVEL	OPMENT PROJECT (PHASE III)
CONVEYANCE S	SYSTEM OF EL SHEIKH GABER EL SABBAH CANAL
NAIN POWE	R SUBSTATION ( FOR EL SALAAM No.7 P.S.)
	STATION & ADMINISTRATION BUILDING NOTES FOR VAC AND PLUMBING SYSTEM
	INTERNATIONAL COOPERATION AGENCY (JICA) ANTS INC, PACIFIC CONSULTANTS INTERNATIONAL
DESIGNED	
TRACED	
CHECKED	
APPROVED	
DRAWING NO.	SBW-422

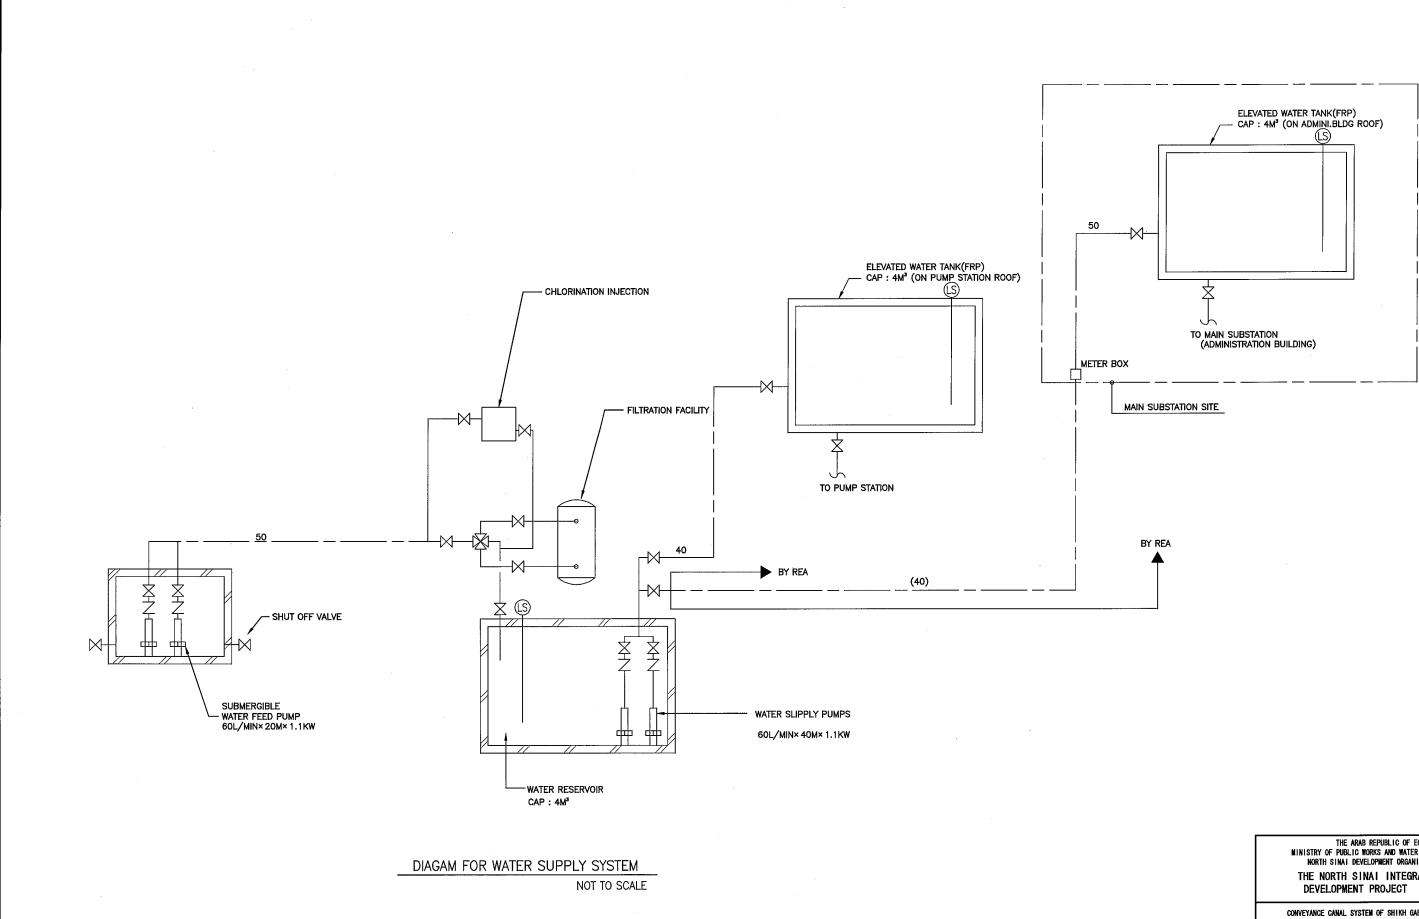

NORTH S	THE ARAB REPUBLIC OF EGYPT PUBLIC WORKS AND WATER RESOURCES SINAI DEVELOPMENT ORGANIZATION RTH SINAI INTEGRATED RURAL OPMENT PROJECT (PHASE III)
	ANAL SYSTEM OF SHIKH GABER EL SABAH CANAL Power supply STATION & ADMINISTRATION BUILDING
	AGRAM FOR WATER SUPPLY SYSTEM
	INTERNATIONAL COOPERATION AGENCY (JICA) ANTS INC, PACIFIC CONSULTANTS INTERNATIONAL
DESIGNED	
TRACED	
CHECKED	
APPROVED	
DRAWING NO.	SBW-423

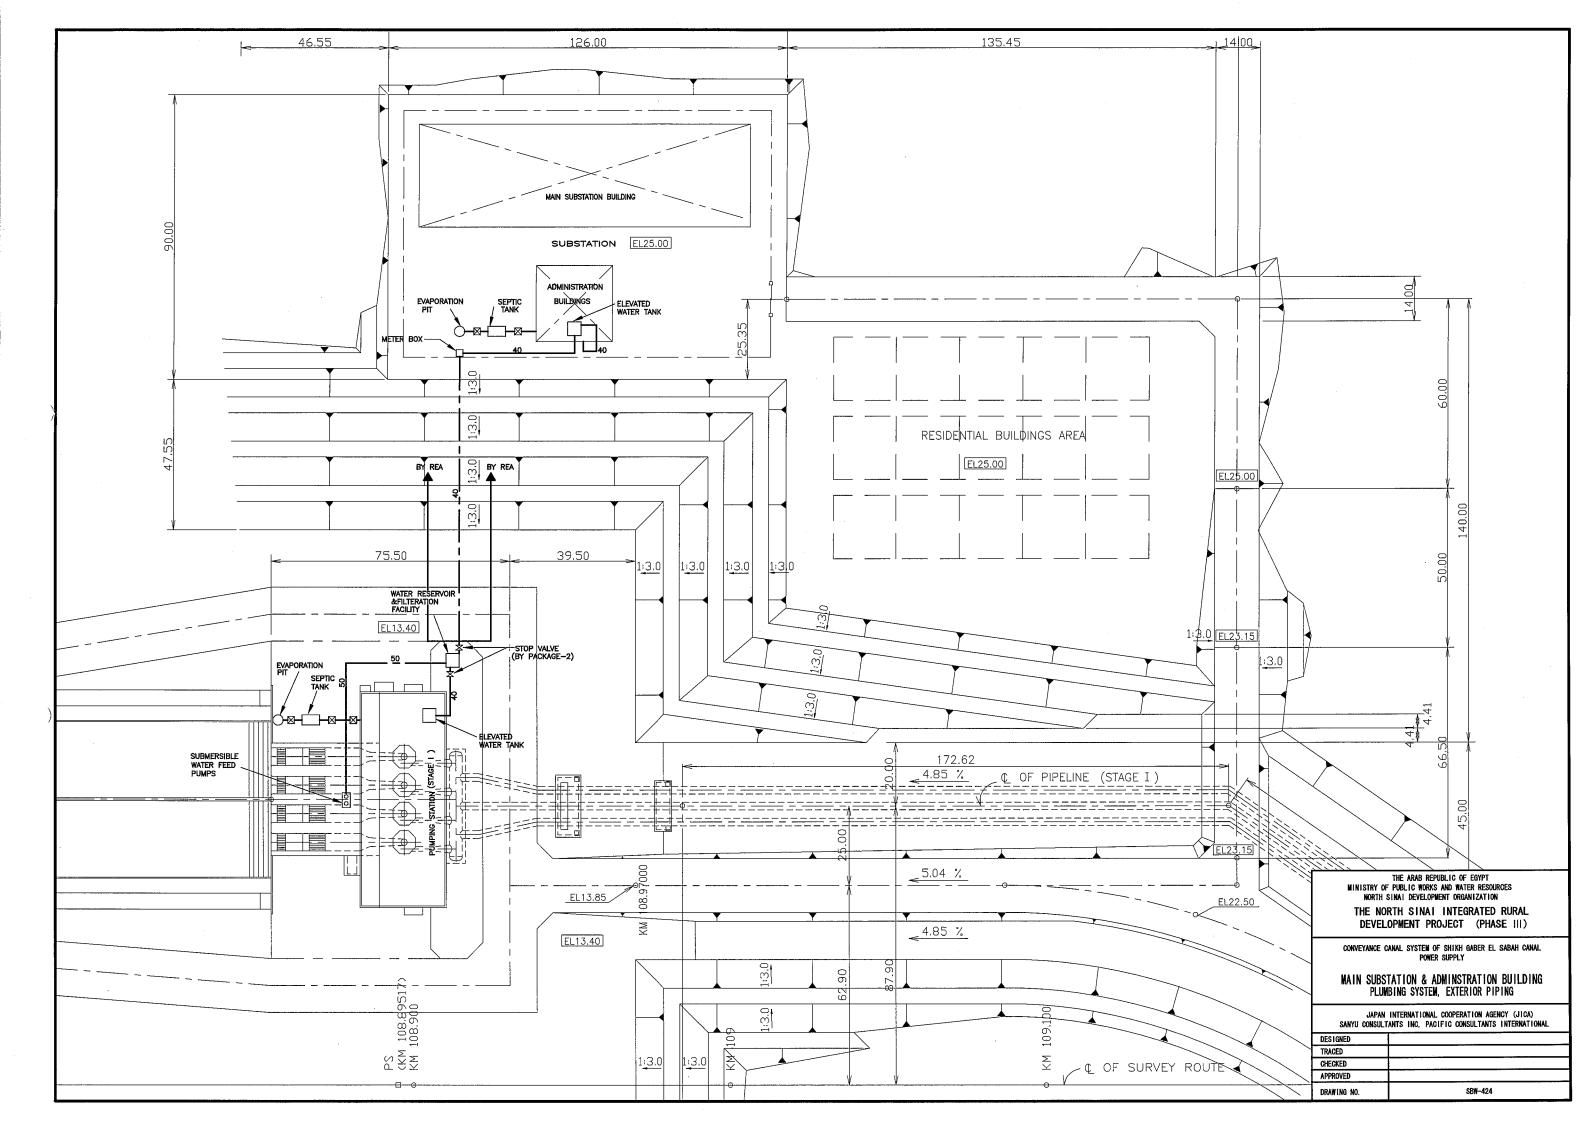

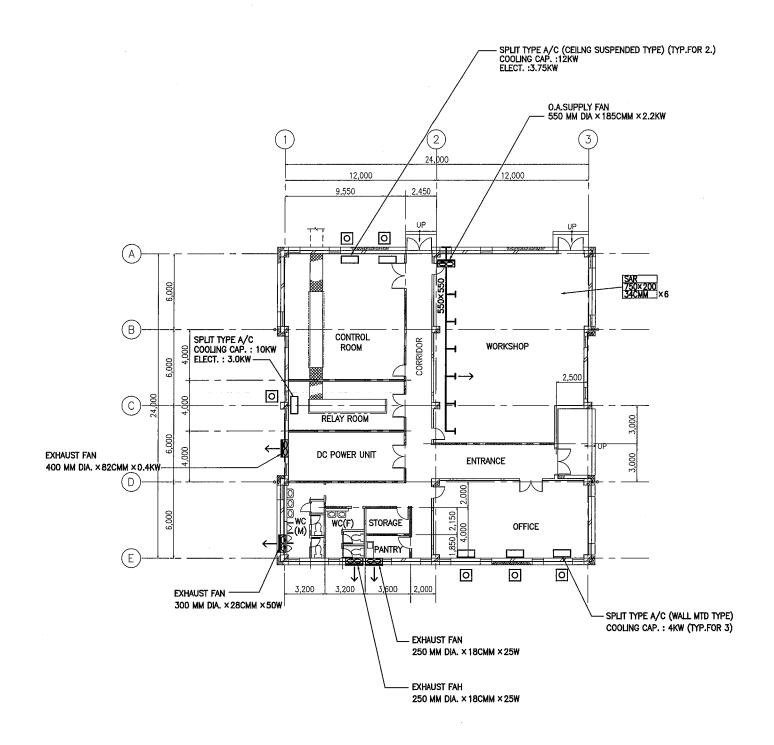


### VETTILATION AND AIR CONDITIONING SYSTEM, GROUND FLOOR

VENTILATION A	ADMINSTRATION BUILDING ND AIR CONDITIONING SYSTEM, GROUND FICOR
	INTERNATIONAL COOPERATION AGENCY (JICA) ANTS INC, PACIFIC CONSULTANTS INTERNATIONAL
DESIGNED	
TRACED	
CHECKED	
APPROVED	
DRAWING NO.	SBW-425

THE NORTH SINAI INTEGRATED RURAL DEVELOPMENT PROJECT (PHASE III) CONVEYANCE SYSTEM OF EL SHEIKH GABER EL SABBAH CANAL

MAIN POWER SUBSTATION (FOR EL SALAAM No. 7 P.S.)

THE ARAB REPUBLIC OF EGYPT MINISTRY OF WATER RESOURCES AND IRRIGATION NORTH SINAI DEVELOPMENT ORGANIZATION

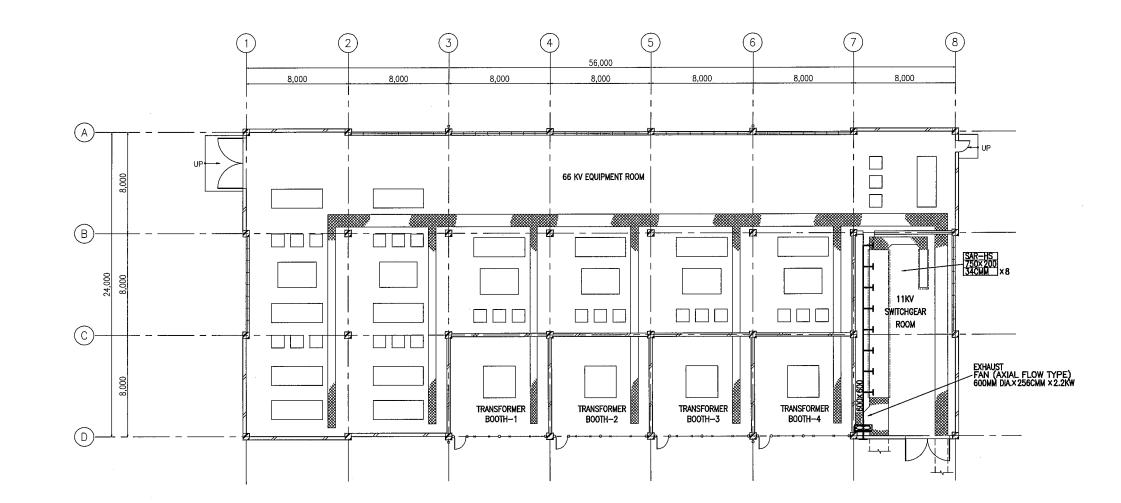

VETTILATION AND AIR CONDITIONINGSYSTEM, GROUND FLOOR

	SYSTEM OF EL SHEIKH GABER EL SABBAH CANAL
MAIN POW	ER SUBSTATION (FOR EL SALAAM No. 7 P.S.)
	MAIN SUBSTATION
GROUND FLOOF	VENTILATION AND AIR CONDITIONING SYSTEM
SANYU CONSUL	INTERNATIONAL COOPERATION AGENCY (JICA) TANTS INC, PACIFIC CONSULTANTS INTERNATIONAL
DESIGNED	
TRACED	
TRACED CHECKED	

THE ARAB REPUBLIC OF EGYPT WINISTRY OF WATER RESOURCES AND IRRIGATION NORTH SINAI DEVELOPMENT ORGANIZATION

THE NORTH SINAI INTEGRATED RURAL DEVELOPMENT PROJECT (PHASE 111)