



NOTES:
1. The location of curvatures on the canal route are as follows:



Principal peg	Distance (M)
SP-33	128,018.74
EC-33	128,114.73
BC-34	128,514.80
SP-34	128,544.54
EC-34	128,774.28
BC-35	128,944.12
SP-35	129,051.02
EC-35	129,157.92
BC-36	129,246.70
SP-36	129,338.33
EC-36	129,429.96
BC-37	129,512.22
SP-37	129,725.49
EC-37	129,838.76
BC-38	129,996.00
SP-38	130,089.96
EC-38	130,183.96
BC-39	130,489.12

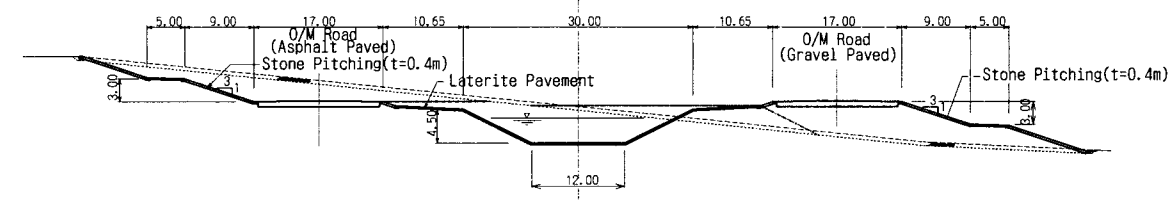


TYPICAL CROSS SECTION OF No. 3 OPEN CANAL
SCALE 1:1,000

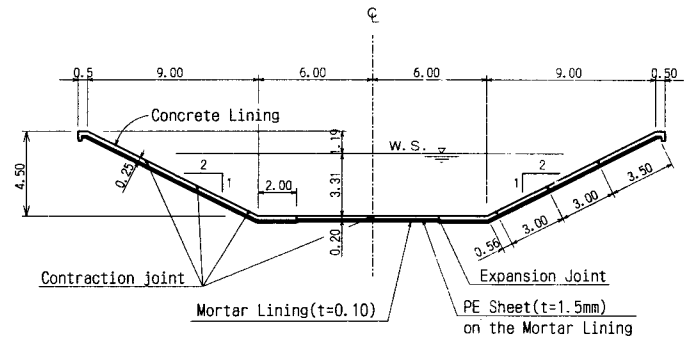

CONCRETE LINED SECTION
SCALE 1:400

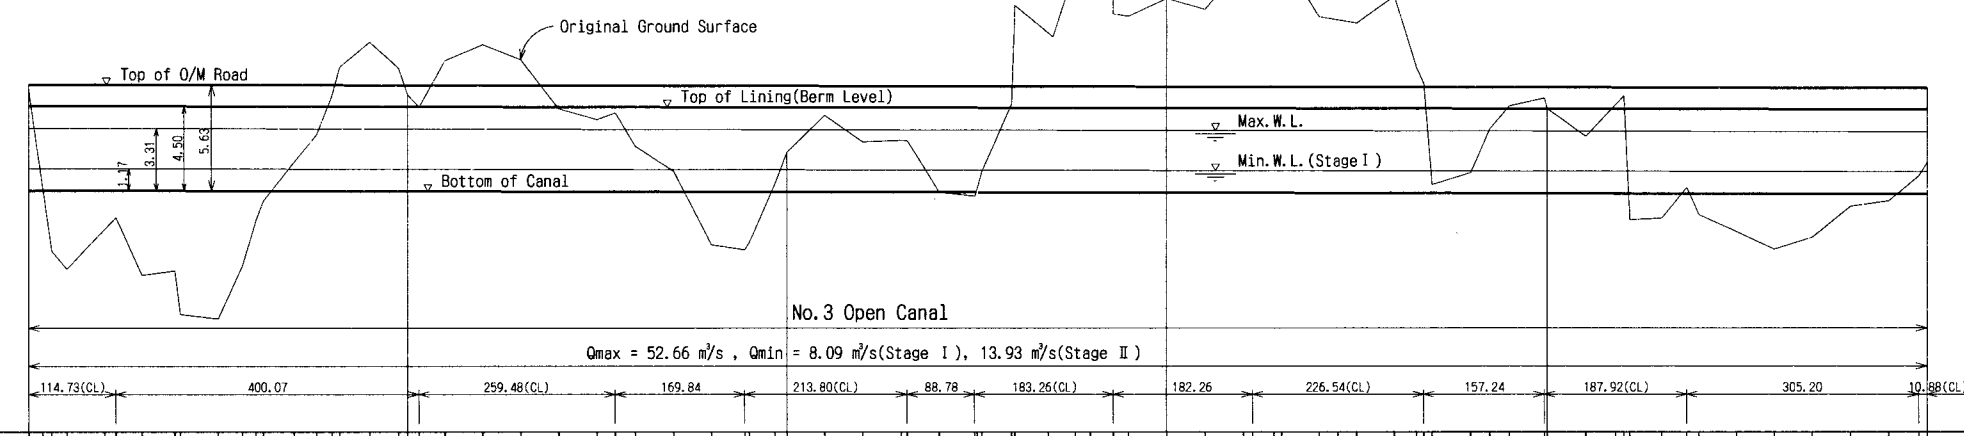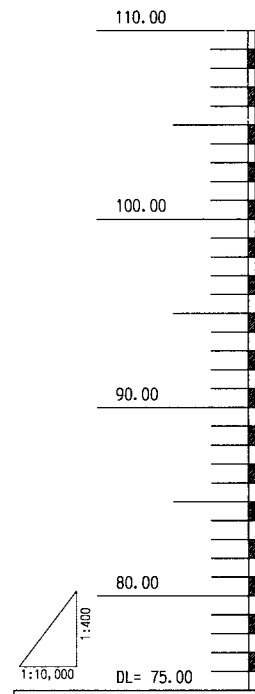

DISTANCE (KM)	ORIGINAL GROUND LEVEL	BERM LEVEL	TOP OF O/M ROAD	Max. WATER LEVEL	Min. WATER LEVEL AT STAGE I	BOTTOM WIDTH	BOTTOM GRADE	BOTTOM ELEVATION	CURVE ARRANGEMENT
128.000	93.18	92.31	93.44	91.12	88.98	12.00 m	8 cm/km = 1/12,500	87.81	IP33, IA=22° 00' 00", R=500.00, TL=97.19, CL=191.98, SL=9.36
128.050	86.60	92.31	93.44	91.12	88.98			87.81	
128.100	83.64	92.31	93.43	91.11	88.97			87.80	IP34, IA=29° 44' 00", R=500.00, TL=132.73, CL=259.48, SL=17.32
128.150	85.74	92.30	93.42	91.10	88.96			87.79	
128.200	81.00	92.29	93.41	91.09	88.95			87.78	IP35, IA=24° 30' 00", R=500.00, TL=108.56, CL=213.80, SL=11.65
128.250	83.56	92.28	93.40	91.08	88.94			87.77	
128.300	81.23	92.27	93.39	91.07	88.93			87.76	IP36, IA=21° 00' 00", R=500.00, TL=92.67, CL=183.26, SL=8.52
128.350	89.31	92.26	93.38	91.06	88.92			87.75	
128.400	89.31	92.25	93.37	91.05	88.91			87.74	IP37, IA=25° 57' 36", R=500.00, TL=115.25, CL=226.54, SL=13.11
128.450	90.79	92.24	93.36	91.04	88.90			87.73	
128.500	92.83	92.23	93.35	91.03	88.89			87.72	IP38, IA=21° 31' 59", R=500.00, TL=95.08, CL=187.92, SL=8.96
128.550	94.38	92.22	93.34	91.02	88.88			87.71	
128.600	95.70	92.21	93.33	91.01	88.87			87.70	IP39, IA=41° 20' 40", R=500.00, TL=188.66, CL=360.80, SL=34.41
128.650	94.71	92.20	93.32	91.00	88.86			87.69	
128.700	95.56	92.19	93.31	90.99	88.85			87.68	
128.750	94.77	92.18	93.30	90.98	88.84			87.67	
128.800	92.16	92.17	93.29	90.97	88.83			87.66	
128.850	91.59	92.16	93.28	90.96	88.82			87.65	
128.900	91.83	92.15	93.27	90.95	88.81			87.64	
128.950	90.16	92.14	93.26	90.94	88.80			87.63	
129.000	88.82	92.13	93.25	90.93	88.79			87.62	
129.050	84.92	92.12	93.24	90.92	88.78			87.61	
129.100	84.66	92.11	93.23	90.91	88.77			87.60	
129.150	85.04	92.10	93.22	90.90	88.76			87.59	
129.200	88.15	92.09	93.21	90.89	88.75			87.58	
129.250	89.85	92.08	93.20	90.88	88.74			87.57	
129.300	91.80	92.07	93.19	90.87	88.73			87.56	
129.350	90.40	92.06	93.18	90.86	88.72			87.55	
129.400	90.48	92.05	93.17	90.85	88.71			87.54	
129.450	90.47	92.04	93.16	90.84	88.70			87.53	
129.500	90.47	92.03	93.15	90.83	88.69			87.52	
129.550	90.47	92.02	93.14	90.82	88.68			87.51	
129.600	90.47	92.01	93.13	90.81	88.67			87.50	
129.650	90.47	92.00	93.12	90.80	88.66			87.49	
129.700	90.47	91.99	93.11	90.79	88.65			87.48	
129.750	90.47	91.98	93.10	90.78	88.64			87.47	
129.800	90.47	91.97	93.09	90.77	88.63			87.46	
129.850	90.47	91.96	93.08	90.76	88.62			87.45	
129.900	90.47	91.95	93.07	90.75	88.61			87.44	
129.950	90.47	91.94	93.06	90.74	88.60			87.43	
130.000	90.47	91.93	93.05	90.73	88.59			87.42	
130.050	90.47	91.92	93.04	90.72	88.58			87.41	
130.100	90.47	91.91	93.03	90.71	88.57			87.40	
130.150	90.47	91.90	93.02	90.70	88.56			87.39	
130.200	90.47	91.89	93.01	90.69	88.55			87.38	
130.250	90.47	91.88	93.00	90.68	88.54			87.37	
130.300	90.47	91.87	92.99	90.67	88.53			87.36	
130.350	90.47	91.86	92.98	90.66	88.52			87.35	
130.400	90.47	91.85	92.97	90.65	88.51			87.34	
130.450	90.47	91.84	92.96	90.64	88.50			87.33	
130.500	90.47	91.83	92.95	90.63	88.49			87.32	

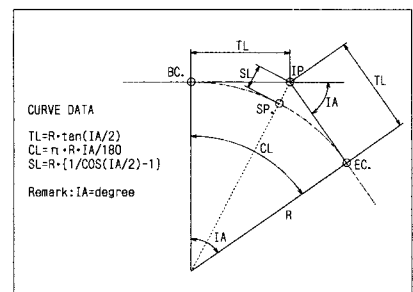

THE ARAB REPUBLIC OF EGYPT
MINISTRY OF WATER RESOURCES AND IRRIGATION
NORTH SINAI DEVELOPMENT ORGANIZATION


THE NORTH SINAI INTEGRATED RURAL DEVELOPMENT PROJECT (PHASE III)

CONVEYANCE SYSTEM OF EL SHEIKH GABER EL SABBAAH CANAL BETWEEN KM 118.560 AND KM 132.500

PLAN AND PROFILE BETWEEN KM 128.000 AND KM 130.500



JAPAN INTERNATIONAL COOPERATION AGENCY (JICA)
SANYU CONSULTANTS INC, PACIFIC CONSULTANTS INTERNATIONAL

DESIGNED	
TRACED	
CHECKED	
APPROVED	
DRAWING NO.	CCL-305

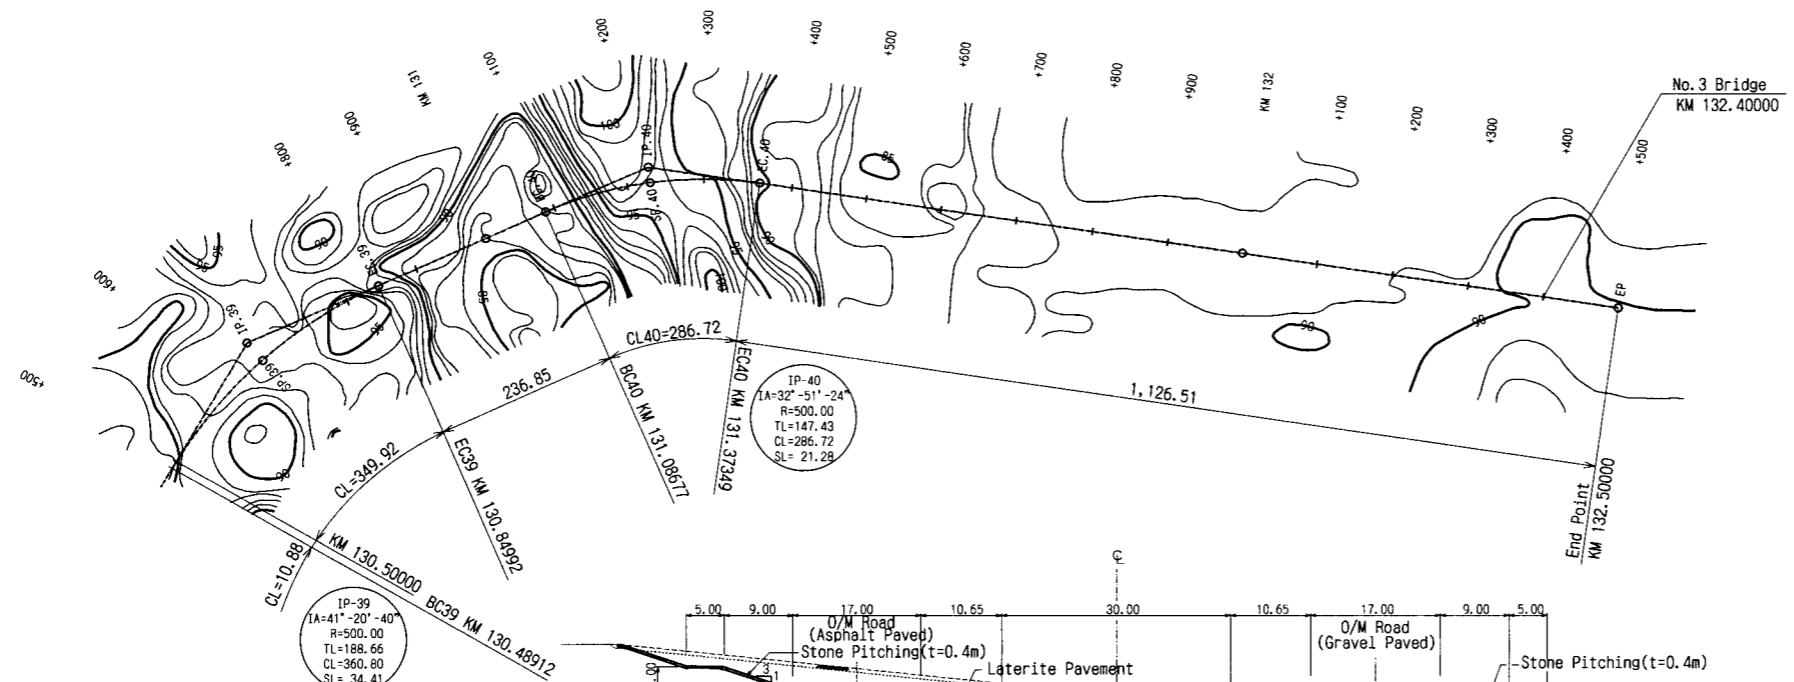


NOTES:
1. The location of curvatures on the canal route are as follows:


Principal peg	Distance (M)
SP-39	130,669.52
EC-39	130,849.92
BC-40	131,086.77
SP-40	131,230.13
EC-40	131,373.49
EP	132,500.00

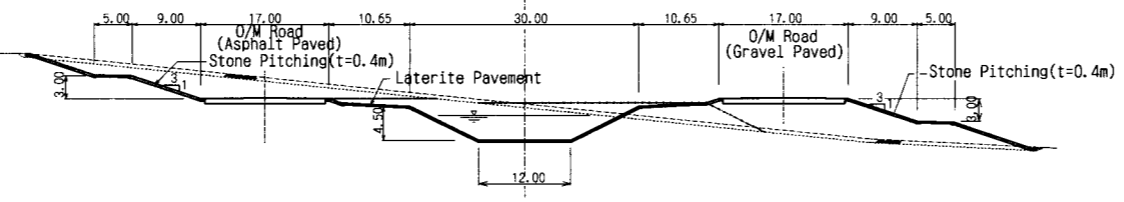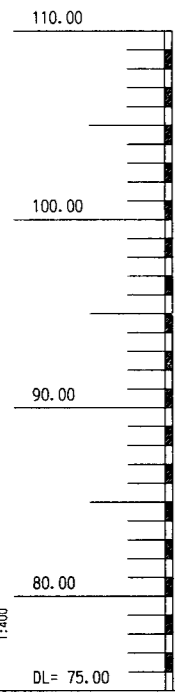


TYPICAL CROSS SECTION OF No.3 OPEN CANAL
SCALE 1:1,000

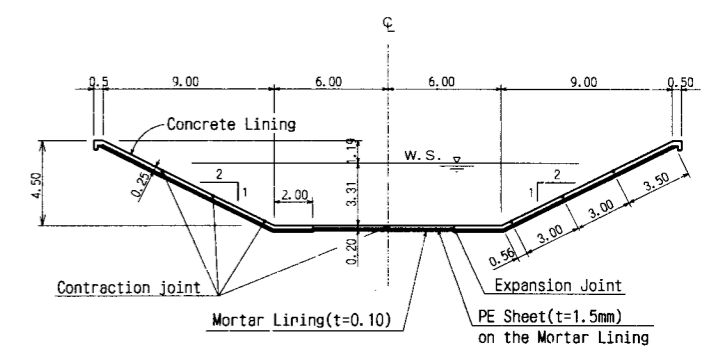

CONCRETE LINED SECTION
SCALE 1:400

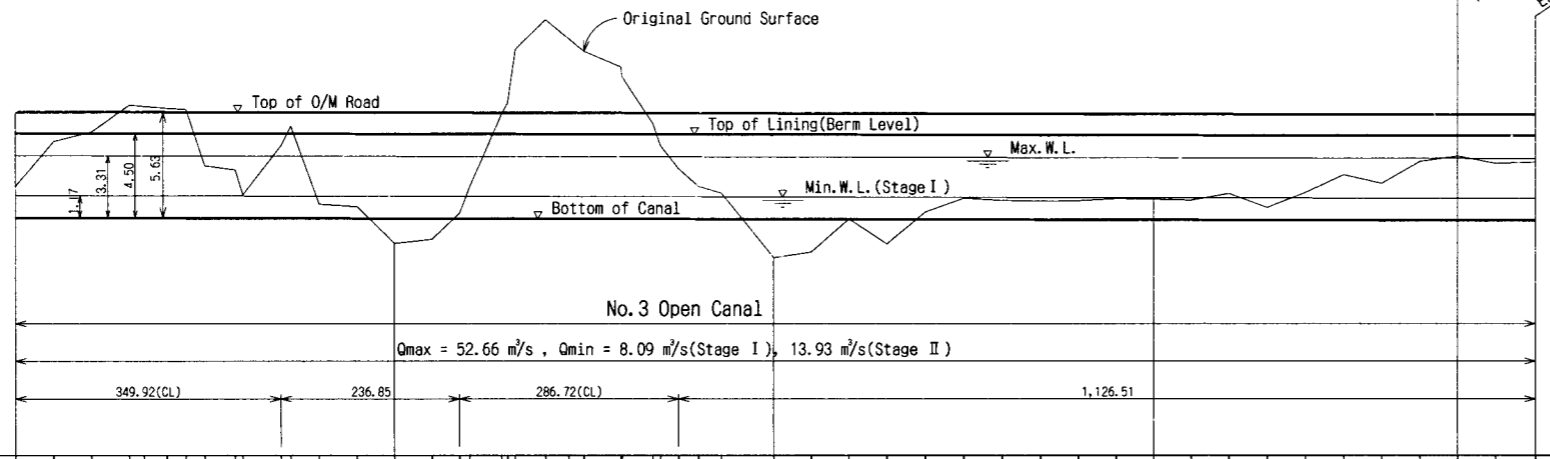

DISTANCE (KM)	ORIGINAL GROUND LEVEL	BERM LEVEL	TOP OF O/M ROAD	Max. WATER LEVEL	Min. WATER LEVEL AT STAGE I	BOTTOM WIDTH	BOTTOM GRADE	BOTTOM ELEVATION	CURVE ARRANGEMENT
130.500	89.30	92.11	93.24	90.92	88.78			87.61	IP-39, IA=41° 20' 40", R=500.00, TL=188.66m, CL=360.80m, SL=34.41m
130.550	91.67	92.11	93.24	90.92	88.78		87.61		
130.600	92.18	92.10	93.23	90.91	88.77		87.60		
130.650	93.60	92.09	93.22	90.90	88.76		87.59		
130.700	93.52	92.09	93.22	90.90	88.76		87.59		
130.750	93.38	92.08	93.21	90.89	88.75		87.58		
130.800	90.16	92.07	93.20	90.88	88.74		87.57		
130.850	88.83	92.07	93.20	90.88	88.74		87.57		
130.900	91.47	92.06	93.19	90.87	88.73		87.56		
130.950	88.33	92.05	93.18	90.86	88.72		87.55		
131.000	88.19	92.04	93.17	90.85	88.71	12.00 m	8 cm/km = 1/12,500	87.54	IP-40, IA=32° 51' 24", R=500.00, TL=147.43m, CL=286.72m, SL=21.28m
131.050	86.25	92.03	93.16	90.84	88.70		87.53		
131.100	86.47	92.03	93.16	90.84	88.70		87.53		
131.150	87.86	92.02	93.15	90.83	88.69		87.52		
131.200	86.26	92.01	93.14	90.82	88.68		87.51		
131.250	87.17	92.00	93.13	90.81	88.67		87.50		
131.300	83.11	91.99	93.12	90.80	88.66		87.49		
131.350	86.54	91.99	93.12	90.80	88.66		87.49		
131.400	88.90	91.98	93.11	90.79	88.65		87.48		
131.450	85.49	91.97	93.10	90.78	88.64		87.47		
131.500	85.79	91.96	93.09	90.77	88.63		87.46		
131.550	87.54	91.95	93.08	90.76	88.62		87.45		
131.600	86.21								
131.650	87.90								
131.700	88.64								
131.750	88.51								
131.800	88.49								
131.850	88.50								
131.900	88.61								
131.950	88.59								
132.000	88.53								
132.050	88.89								
132.100	88.14								
132.150	88.94								
132.200	89.89								
132.250	89.43								
132.300	90.60								
132.350	90.89								
132.400	90.49								
132.450	90.57								
EP									

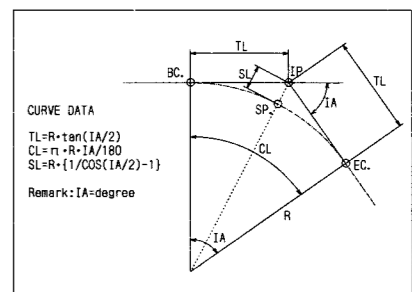

THE ARAB REPUBLIC OF EGYPT
MINISTRY OF WATER RESOURCES AND IRRIGATION
NORTH SINAI DEVELOPMENT ORGANIZATION

THE NORTH SINAI INTEGRATED RURAL DEVELOPMENT PROJECT (PHASE III)

CONVEYANCE SYSTEM OF EL SHEIKH GABER EL SABBAAH CANAL BETWEEN KM 118.560 AND KM 132.500

PLAN AND PROFILE BETWEEN KM 130.500 AND KM 132.500

JAPAN INTERNATIONAL COOPERATION AGENCY(JICA)
SANYU CONSULTANTS INC, PACIFIC CONSULTANTS INTERNATIONAL

DESIGNED	
TRACED	
CHECKED	
APPROVED	
DRAWING NO.	CCL-306