

NOTES:

1. This drawing scale is 1:40

0 1000m 2000m SCALE 1:40

SPECIFICATION

Hoisting capacity 13 tons
Lifting speed 2 m/min.
Travel speed 20 m/min.
Power source Ф3 AC380V 50Hz


THE ARAB REPUBLIC OF EGYPT
MINISTRY OF WATER RESOURCES AND IRRIGATION
NORTH SINAI DEVELOPMENT ORGANIZATION

THE NORTH SINAI INTEGRATED RURAL DEVELOPMENT PROJECT(PHASE II)

CONVEYANCE SYSTEM OF EL SHEIKH GABER EL SABBAH CANAL BETWEEN KM 108, 466 AND KM 118, 560 EL SALAAM NO. 7 (BIR EL ABD) PUMPING STATION MECHANICAL EQUIPMENT

MECHANICAL EQUIPMENT
GENERAL ARRANGEMENT
OF GANTRY CRANE

DESIGNED	
TRACED	
CHECKED	
APPROVED	
DRAWING NO.	PSM-211

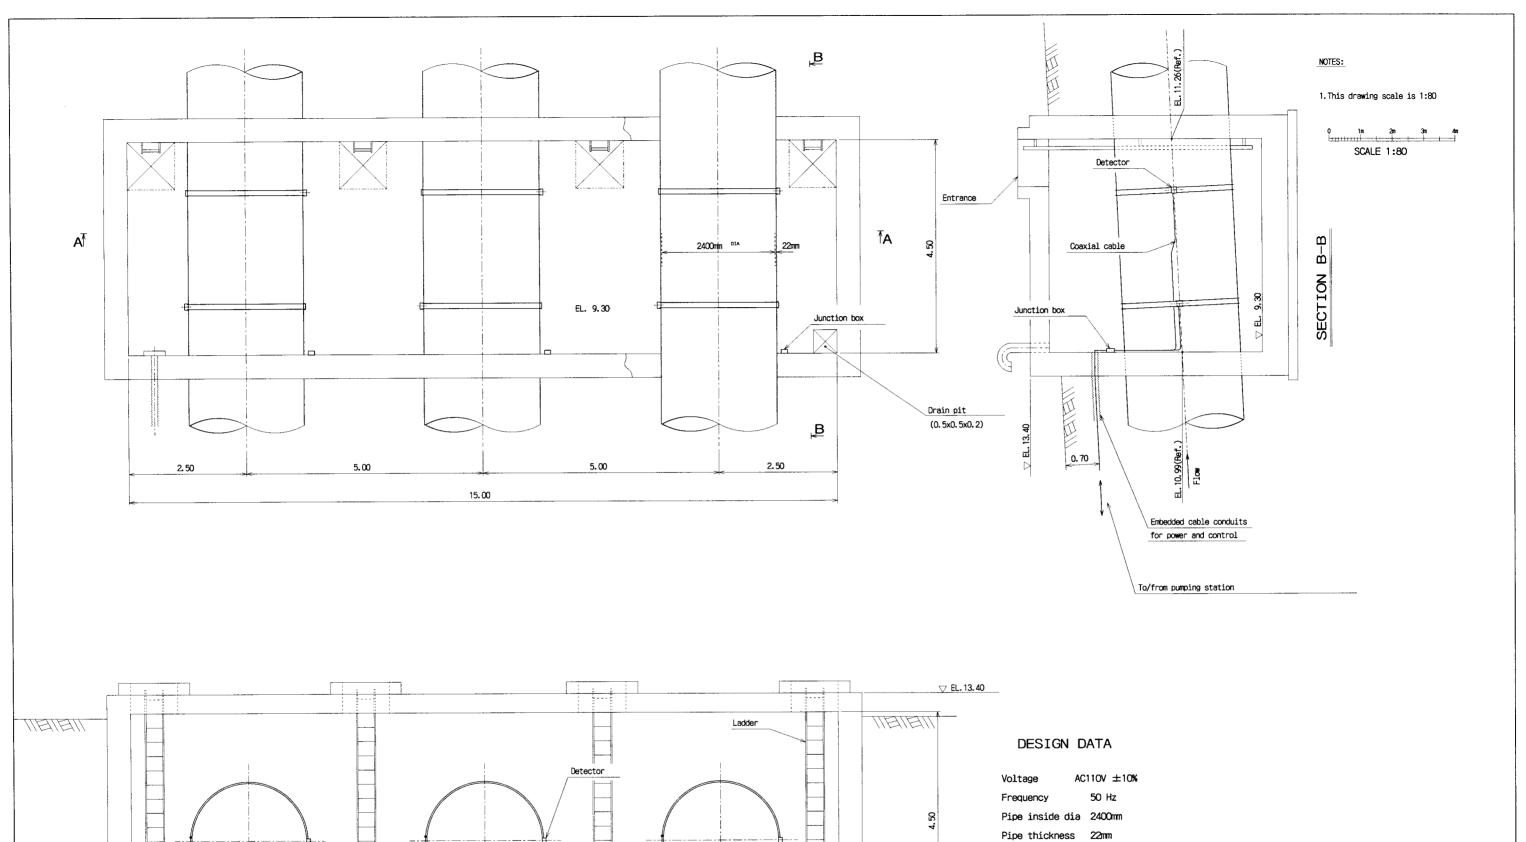

Wire Tightning device ▽ EL. 9.30 T. Frequi

SECTION A-A

Lining thickness -Pipe material Carbon steel Lining material Tar-epoxy Measurable capacity Max. 13.50m 3 /sec. Rated 10.827m 3 /sec. Flow meter

> Accuuraey ±1.0% FS Working temp. -10 +60°C

THE ARAB REPUBLIC OF EGYPT
MINISTRY OF WATER RESOURCES AND IRRIGATION
NORTH SINAI DEVELOPMENT ORGANIZATION

THE NORTH SINAI INTEGRATED RURAL DEVELOPMENT PROJECT(PHASE III)

CONVEYANCE SYSTEM OF EL SHEIKH GABER EL SABBAH CANAL BETWEEN KM 108, 466 AND KM 118, 560 EL SALAAM NO. 7 (BIR EL ABO) PUMPING STATION MECHANICAL EQUIPMENT

GENERAL ARRANGEMENT OF FLOW METER

JAPAN INTERNATIONAL COOPERATION AGENCY(JICA)

SANYU CONSULTANTS INC, PACIFIC CONSULTANTS INTERNATIONAL				
DESIGNED				
TRACED				
CHECKED				
APPROVED				
DRAWING NO.	PSM-212			

1. DESIGN STANDARD

THE FOLLOWING SPECIFIC STANDARDS SHALL BE USED FOR THE DESIGN,
MANUFACTURE AND TESTING OF ALL ELECTRICAL EQUIPMENT.

(a) MAIN PUMP MOTOR

IEC-34	ROTATING ELECTRICAL MACHINE.
IEC-72/72A	DIMENSIONS AND OUTPUT RATINGS.
IEC-85	RECOMMENDATIONS FOR THE CLASSIFICATION OF INSULATING
	MATERIALS IN RELATION TO THEIR THERMAL STABILITY IN SERVICE.

(b) POWER SUPPLY EQUIPMENT

IEC-76	SPECIFICATIONS FOR TRANSFORMERS AND REACTORS.
IEC-298	A.C. METAL-ENCLOSED SWITCHGEAR AND CONTROLGEAR
	FOR RATED VOLTAGES ABOVE 1KV.
IEC-439	LOW-VOLTAGE SWITCHGEAR AND CONTROLGEAR ASSEMBLIES.
IEC-470	HIGH-VOLTAGE ALTERNATING CURRENT CONTACTORS.
IEC-632	HIGH-VOLTAGE MOTOR STARTERS.
IEC-694	SPECIFICATION FOR A.C. SWITCHGEAR FOR VOLTAGE ABOVE 1KV.
IEC-947	LOW-VOLTAGE SWITCHGEAR AND CONTROLGEAR.

2. SYMBOLS AND ABBREVIATIONS

‡	:	VACUUM CIRCUIT BREAKER (VCB) DRAWOUT TYPE	↓		CURRENT TRANSFORMER (CT) CURRENT TRANSFORMER (CT)
***	:	AIR CIRCUIT BREAKER (ACB) DRAWOUT TYPE	\$ (1)1- 50/51	:	ZERO-PHASE CURRENT TRANSFORMER (ZCT) POTENTIAL TRANSFORMER OVER CURRENT RELAY WITH INSTANTANEOUS TRIP ELEMENTS
*	:	MOLDED CASE CIRCUIT BREAKER (MCCB)	46/47		OPEN PHASE/REVERSE PHASE POWER FACTOR RELAY
1	:	MAGNETIC CONTACTOR (MC)	56 87		OUT OF STEP DETECTING RELAY DIFFERENTIAL RELAY
~~~	:	CHANGE OVER SWITCH (C.O.S)	40 49/51G		UNDER FIELD CURRENT RELAY  OVER CURRENT GROUND RELAY

## 3. MAJOR EQUIPMENT / QUANTITY

EQUIPMENT	SPECIFICATION	PER PUMP UNIT	TOTAL
(a) MAIN PUMP MOTOR	13MW, 11KV, 375RPM, 50Hz	1	4
( b ) MAIN MOTOR STARTING PANEL	VACUUM CIRCUIT BREAKER (VCB)	3	12
	• VCB-1, 11KV, 1200A	(1)	(4)
	• VCB-2, 11KV, 1200A	(1)	(4)
	• VCB-3, 11KV, 1200A	(1)	(4)
(c) EXCITER TRANSFORMER PANEL	20KVA, 11KV/380V, SINGLE PHASE.	1	4
(d) EXCITER PANEL	AC EXCITER	1	4
( a ) MAIN PUMP UNIT CONTROL PANEL		2	8
	PROGRAMABLE CONTROLLER PANEL	(1)	(4)
	· RELAY PANEL	(1)	(4)
(f) AUTO-TRANSFORMER	11KV, 3MIN. RATING	1	4
(g) D.C POWER SOURCE		_	1
	BATTERY AND CHARGER		
	NICKEL-CADMIUM ALKALINE BATTERIES		
(h) LOAD CENTRE	380/220V, 3PHASE, 4WIRE	-	1
( i ) MOTOR CONTROL CENTRE (MCC)	FOR MAIN PUMP	1	4
(j) MCC	FOR COMMON A	-	1
(k) MCC	FOR COMMON B	_	1
(i) OPERATOR CONSOLE	DESK TYPE	-	1
(m) PRINTER DESK		-	1
(n) UNINTERRUPTIBLE POWER SUPPLY UNIT (UPS)	5KVA, 220V, SINGLE PHASE	_	1
( • ) EMERGENCY DIESEL GENERATOR SET	100KVA, 380/220V, 1500RPM, 50Hz	-	1

#### 4. GENERAL NOTES

- (a) THE WORK SHALL BE EXECUTED IN CLOSE COORDINATION WITH ALL TRADES.
- (b) DIMENSIONS AND NOS. OF SOME POWER SUPPLY EQUIPMENT MAY


  BE ADJUSTED SUBJECT TO EQUIPMENT SUPPLIER.
- (c) ALL ELECTRICAL EQUIPMENT AND ASSOCIATED METALLIC PARTS

  SHALL BE CONNECTED TO STATION EARTHING SYSTEM AS REQUIRED.

THE ARAB REPUBLIC OF EGYPT
MINISTRY OF MATER RESOURCES AND IRRIGATION
MORTH SIMAI DEVELOPMENT ORGANIZATION
THE NORTH SINAI INTEGRATED RURAL
DEVELOPMENT PROJECT (PHASE III)

CONVEYANCE SYSTEM OF EL SHEIKH GABER EL SABBAH CANAL BETWEEN KM 108.466 AND KM 118.560 EL SALAAM No.7 ( BIR EL ABD ) PUMPING STATION PUMP HOUSE GENERAL NOTES

SAMIU COMSOLIANIS INC. PACIFIC COMSOLIANIS INTERNATIONAL						
DESTONED						
TRACED						
CHECKED						
APPROVED						
DRAWING NO.	PSE-201					

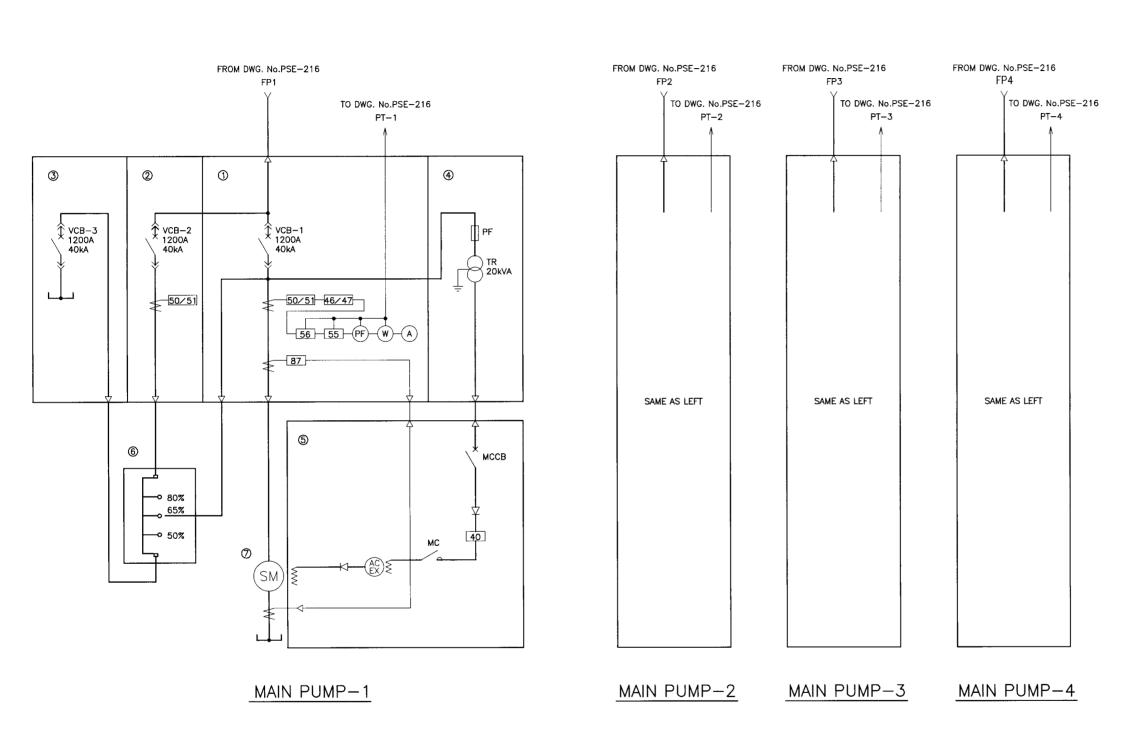

No.	PANEL NAME
1	MAIN PUMP STARTING PANEL (VCB-1)
2	MAIN PUMP STARTING PANEL (VCB-2)
3	MAIN PUMP STARTING PANEL (VCB-3)
4	EXCITER TRANSFORMER PANEL
⑤	EXCITER PANEL
6	AUTO TRANSFORMER
7	13,000kW SYNCHRONOUS MOTOR


	LEGENDS
50/51	: OVER CURRENT RELAY WITH INSTANTA— NEOUS TRIP ELEMENTS
46/47	: OPEN PHASE/REVERSE PHASE
55	: POWER FACTOR RELAY
56	: OUT OF STEP DETECTING RELAY
87	: DIFFERENTIAL RELAY
40	: UNDER FIELD CURRENT RELAY
VCB1~3	: VACUUM CIRCUIT BREAKER
PF	: POWER FUSE
PF	: POWER FACTOR METER
w	: WATTMETER
A	: AC AMMETER
(AC) EX	: AC EXCITER
мссв	: MOLDED CASE CIRCUIT BREAKER
мс	: MAGNETIC CONTACTOR


THE ARAB REPUBLIC OF EGYPT
MINISTRY OF MATER RESOURCES AND IRRIGATION
MORTH SINAI DEVELOPMENT ORGANIZATION
THE NORTH SINAI INTEGRATED RURAL
DEVELOPMENT PROJECT (PHASE III)

CONVEYANCE SYSTEM OF EL SHEIKH GABER EL SABBAH CANAL BETWEEN KM 108.466 AND KM 118.560 EL SALAAM No.7 ( BIR EL ABD ) PUMPING STATION


PUMP HOUSE PUMP UNIT POWER SUPPLY SINGLE LINE DIAGRAM

DESTONED	
TRACED	
CHECKED	
APPROVED	
DRAWING NO.	PSE-202

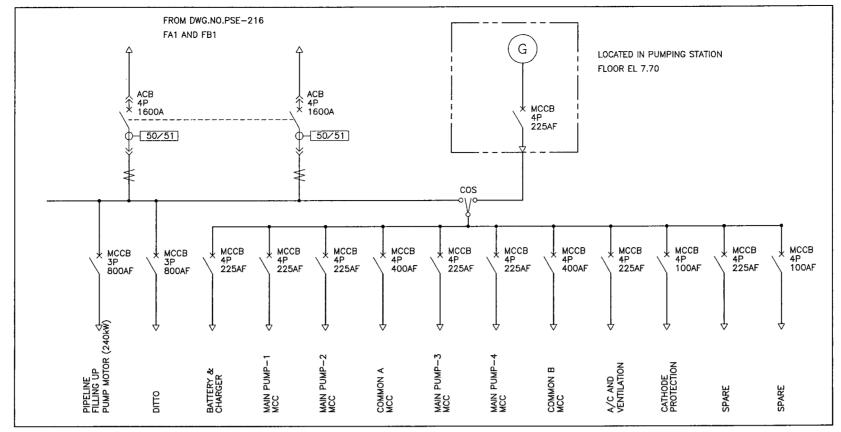

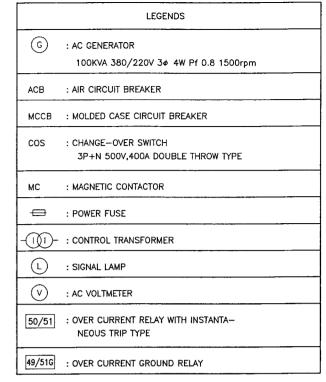

## 380V LOAD CENTRE

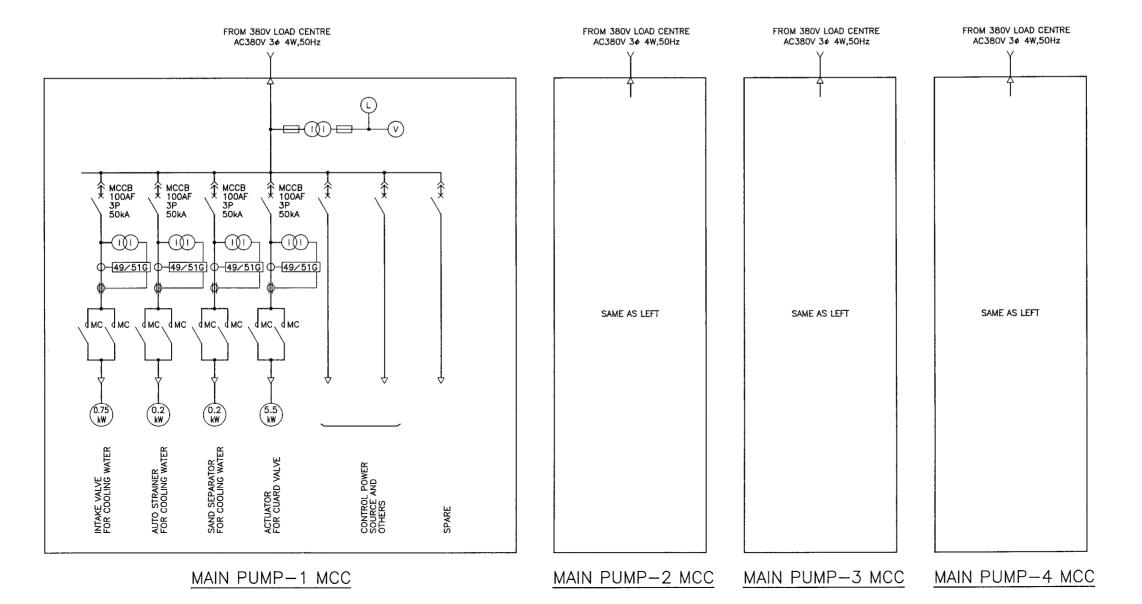


THE ARAB REPUBLIC OF EGYPT
MINISTRY OF WATER RESOURCES AND IRRIGATION
NORTH SIMAI DEVELOPMENT ORGANIZATION
THE NORTH SIMAI INTEGRATED RURAL


DEVELOPMENT PROJECT (PHASE III)

CONVEYANCE SYSTEM OF EL SHEIKH GABER EL SABBAH CANAL BETWEEN KM 108. 466 AND KM 118. 560 EL SALAAM NO. 7 ( BIR EL ABD ) PUMPING STATION PUMP HOUSE

380V LOAD CENTRE AND MAIN PUMP AUX. MOTOR CONTROL CENTRE (MCC) SINGLE LINE DIAGRAM

DRAWING NO.	PSE-203
APPROVED	
CHECKED	
TRACED	
DESIGNED	

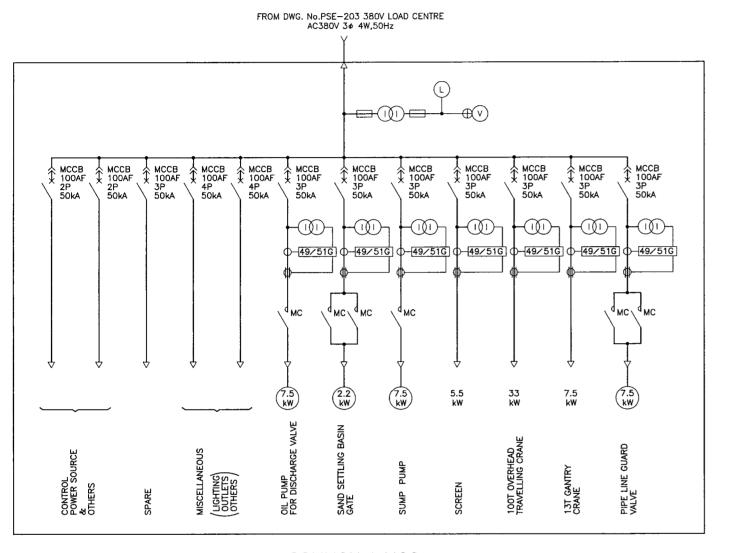

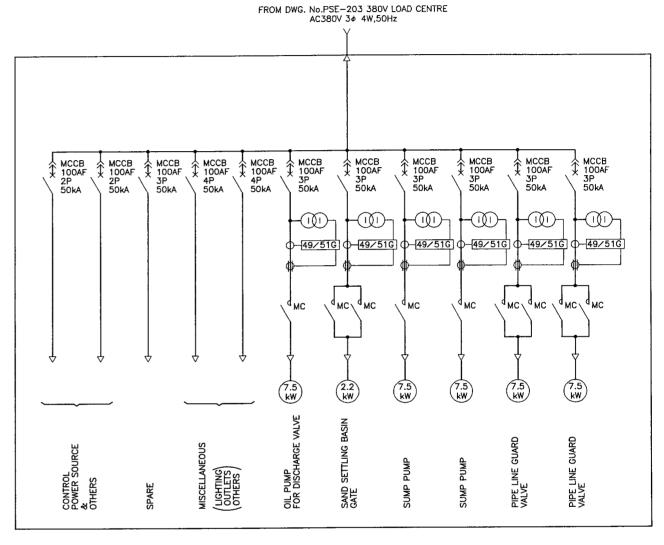

COMMON A MCC

COMMON B MCC


	1	THE A	rab re	Public (	of Egyi	PΤ		
MII	NISTRY	OF W	ATER R	ESOURCE	S AND	IRRIG	ATION	
	NORTH	SINA	I DEVE	LOPMENT	ORGAN	IZATI	ON	
ΙE	NOR	TH :	SINAI	INTE	EGRA1	ED	RUR/	٩


DEVELOPMENT PROJECT (PHASE III)

CONVEYANCE SYSTEM OF EL SHEIKH GABER EL SABBAH CANAL

CONVEYANCE SYSTEM OF EL SHEINH GABER EL SABOAT CAN
BETWEEN KM 108. 466 AND KM 118. 560
EL SALAAM No. 7 ( BIR EL ABD ) PUMPING STATION
PUMP HOUSE
MAIN PUMP COMMON AUX. MOTOR CONTROL CENTRE
SINGLE LINE DIAGRAM

DRAWING NO.	PSE-204
APPROVED	
CHECKED	
TRACED	
DESIGNED	

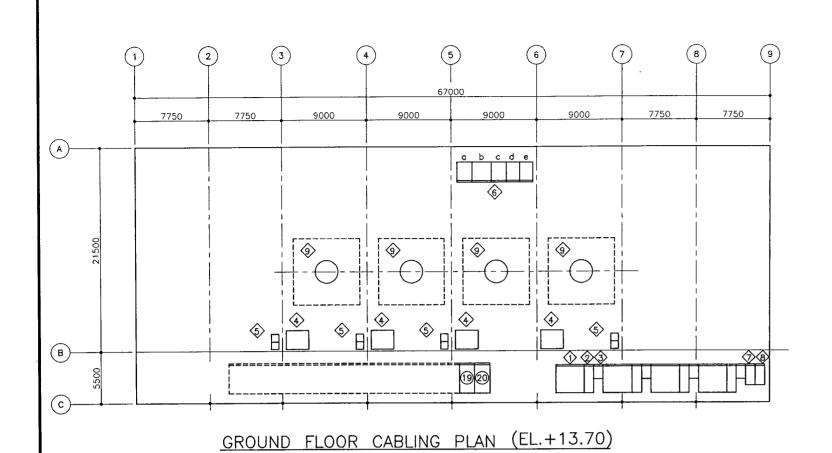

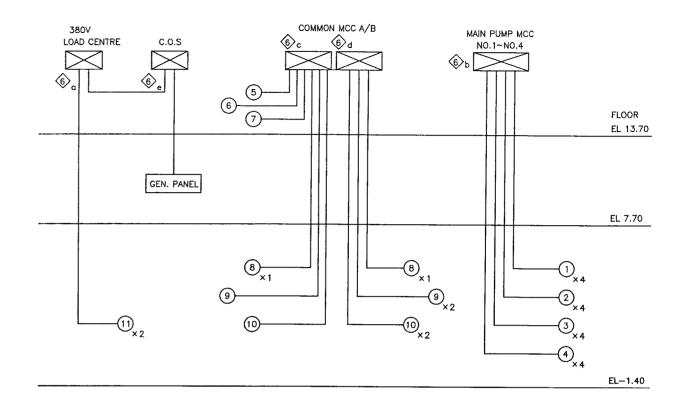

# ELEVATION POWER CABLING PLAN

NO.	EQUIPMENT NAME
1>	MAIN MOTOR STARTING PANEL
2	EXCITER TRANSFORMER PANEL
3>	EXCITER PANEL
4>	AUTO-TRANSFORMER
\$	MAIN PUMP UNIT CONTROL PANEL
6	g. 380V LOAD CENTRE
	b. MAIN PUMP MOTOR CONTROL CENTRE
	c. COMMON A MOTOR CONTROL CENTRE
	d. COMMON B MOTOR CONTROL CENTRE
	e. CHANGE-OVER SWITCH PANEL(C.O.S)
$\Diamond$	D.C POWER SOURE PANEL
8	GENERATOR CONTROL PANEL
9>	MAIN MOTOR
19	STATION TRANSFORWER PANEL A
(20)	STATION TRANSFORWER PANEL B

MAIN POWER CABLE
1 - 9
11kV XLPE (1C-400mm ² × 6) × 4
$\langle 1 \rangle - \langle 4 \rangle$
11kV XLPE (1C-400mm ² × 6) × 4
(19) (6) a
600V XLPE 1C-800mm ² × 4
(20) (6) a
600V XLPE 1C-800mm ² × 4
(6) a− (6) e
600V XLPE 1C-150mm ² × 4


NO.	EQUIPMENT NAME		MAIN POWER CABLE	
1	INTAKE VALVE FOR COOLING WATER	0.75kW× 4	€ b - 1 600V XLPE	(1C-2.5mm ² ×3) ×4
2	STRAINER FOR COOLING WATER	5.5kW×4	⑥ b − ② 600V XLPE	(1C-6.0mm ² ×3) ×4
3	SAND SEPARATOR FOR COOLING WATER	5.5kW×4	€ b - 3 600V XLPE	(1C-6.0mm ² ×3) ×4
4	ACTUATOR FOR GUARD VALVE	5.5kW×4	€ b - 4 600V XLPE	(1C-6.0mm ² ×3) ×4
5	100 ton OVERVEAD TRAVELLING CRANE	33kW	6 c - 5 600V XLPE	1C-50mm ² ×3
6	13 ton GANTRY CRANE	7.5kW	€ c − € 600V XLPE	1C-10mm 2 ×3
7	SCREEN	5.5kW	⑥ c − ⑦ 600V XLPE	1C-6.0mm ² ×3
8	OIL PUMP FOR DISCHARGE VALVE	7.5kW×2	6 c/d-8 600V XLPE	(1C-10mm ² ×3) ×2
9	SUMP PUMP	5.5kW×3	6 c/d-9 600V XLPE	(1C-6.0mm ² ×3) ×3
10	PIPE LINE GUARD VALVE	7.5kW×3	6 c/d-10 600V XLPE	(1C-10mm ² ×3) ×3
11)	PIPELINE FILLING UP PUMP	240kW×2	€ a - 10 600V XLPE	(1C-240mm² ×3) ×2
			6 e – GEN. PANEL 600V XLPE	1C-70mm ² ×4

THE ARAB REPUBLIC OF EGYPT
MINISTRY OF WATER RESOURCES AND IRRIGATION
NORTH SINAI DEVELOPMENT ORGANIZATION
THE NORTH SINAI INTEGRATED RURAL
DEVELOPMENT PROJECT (PHASE III)

CONVEYANCE SYSTEM OF EL SHEIKH GABER EL SABBAH CANAL BETWEEN KM. 108. 466 AND KM. 118. 560 EL SALAAM No. 7 ( BIR EL ABD ) PUMPING STATION


PUMP HOUSE EQUIPMENT LAYOUT AND POWER CABLING PLAN

SANTU GUNSULIANIS INC, PACIFIC CONSULIANIS INIERNATIONAL	
DESIGNED	
TRACED	
CHECKED	
APPROVED	
DRAWING NO.	PSE-205

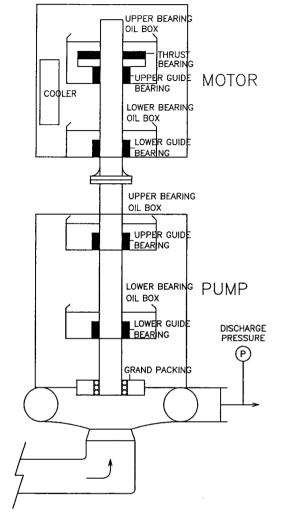

[ <del></del>	-				
	MOTOR				
MONITORING POINTS		C.B TRIP	ALARM		
SHAFT VIBRATION	-	-	н		
FRAME VIBRATION		-	н		
TEMP. OF STATOR CO	DIL	_	ł	Н	
UPPER BEARING	OIL LEVEL	0	LL	L	
OIL BOX	C.W. FLOW RATE	_	L	н	
	C.W. INLET TEMP.	-	Н		
	C.W. OUTLET TEMP.	_	Н		
THRUST BEARING	TEMP.	0	Н		
UPPER GUIDE BEARING	TEMP.	0	Н		
LOWER BEARING OIL BOX	OIL LEVEL	0	LL	L	
OIL DOX	C.W. FLOW RATE	-	L	н	
	C.W. INLET TEMP.	-	Н		
	C.W. OUTLET TEMP.	_	Н		
LOWER GUIDE BEARING	TEMP.	0	Н		
HEAT EXCHANGER (COOLER)	C.W. FLOW RATE	-	L	н	
(	C.W. INLET TEMP.	_	Н		
	C.W. OUTLET TEMP.	-	Н		

PUMP				
MONITORING POINTS	STOP	ALARM		
SHAFT VIBRATION		-	н	
FRAME VIBRATION		_	н	
UPPER BEARING	OIL LEVEL	0	LL	L
OIL BOX	C.W. FLOW RATE	-	L	н
	C.W. INLET TEMP.	-	ł	1
	C.W. OUTLET TEMP.	_	н	
GUIDE BEARING	TEMP.	0	Н	
LOWER BEARING	OIL LEVEL	0	LL	L
OIL BOX	C.W. FLOW RATE	-	L	Н
	C.W. INLET TEMP.	-	ł	1
	C.W. OUTLET TEMP.	-	Н	
GUIDE BEARING	темр.	0	н	
GRAND PACKING	C.W. FLOW RATE	-	L	Н
_	C.W. PRESSURE	-	L	н
DISCHARGE PRESSU	-	l	-	

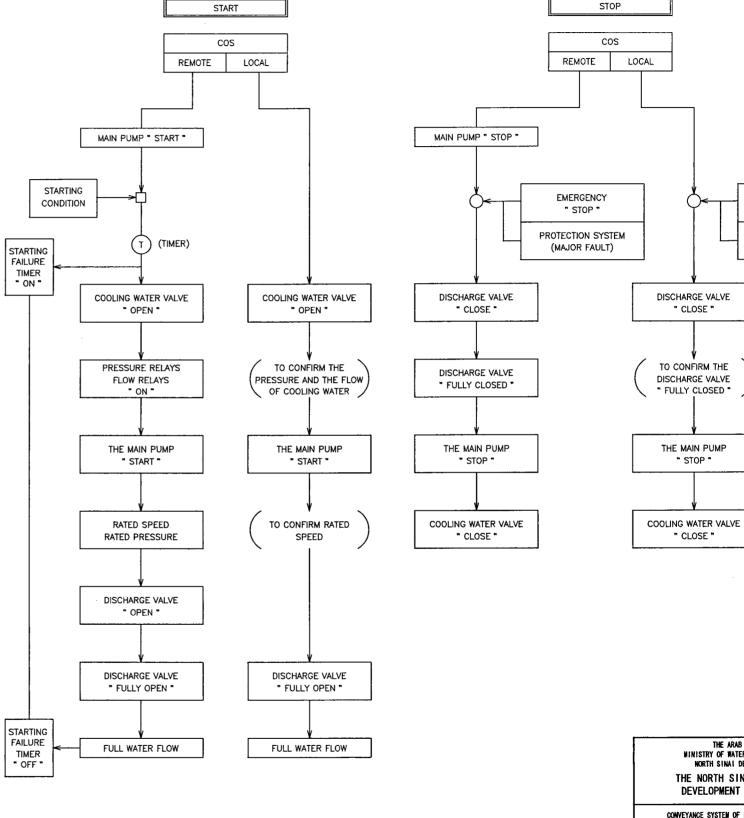

THE ARAB REPUBLIC OF EGYPT
MINISTRY OF WATER RESOURCES AND IRRIGATION
NORTH SINAI DEVELOPMENT ORGANIZATION
THE NORTH SINAI INTEGRATED RURAL
DEVELOPMENT PROJECT (PHASE III)

**EMERGENCY** 

" STOP "


PROTECTION SYSTEM

(MAJOR FAULT)

CONVEYANCE SYSTEM OF EL SHEIKH GABER EL SABBAH CANAL BETWEEN KM 108. 466 AMD KM 118. 560 EL SALAAM NO.7 ( BIR EL ABD ) PUMPING STATION PUMP HOUSE

MAIN PUMP UNIT PROTECTION SYSTEM AND OPERATION BLOCK DIAGRAM

DESIGNED		
TRACED		
CHECKED		
APPROVED		
DRAWING NO.	PSE-206	

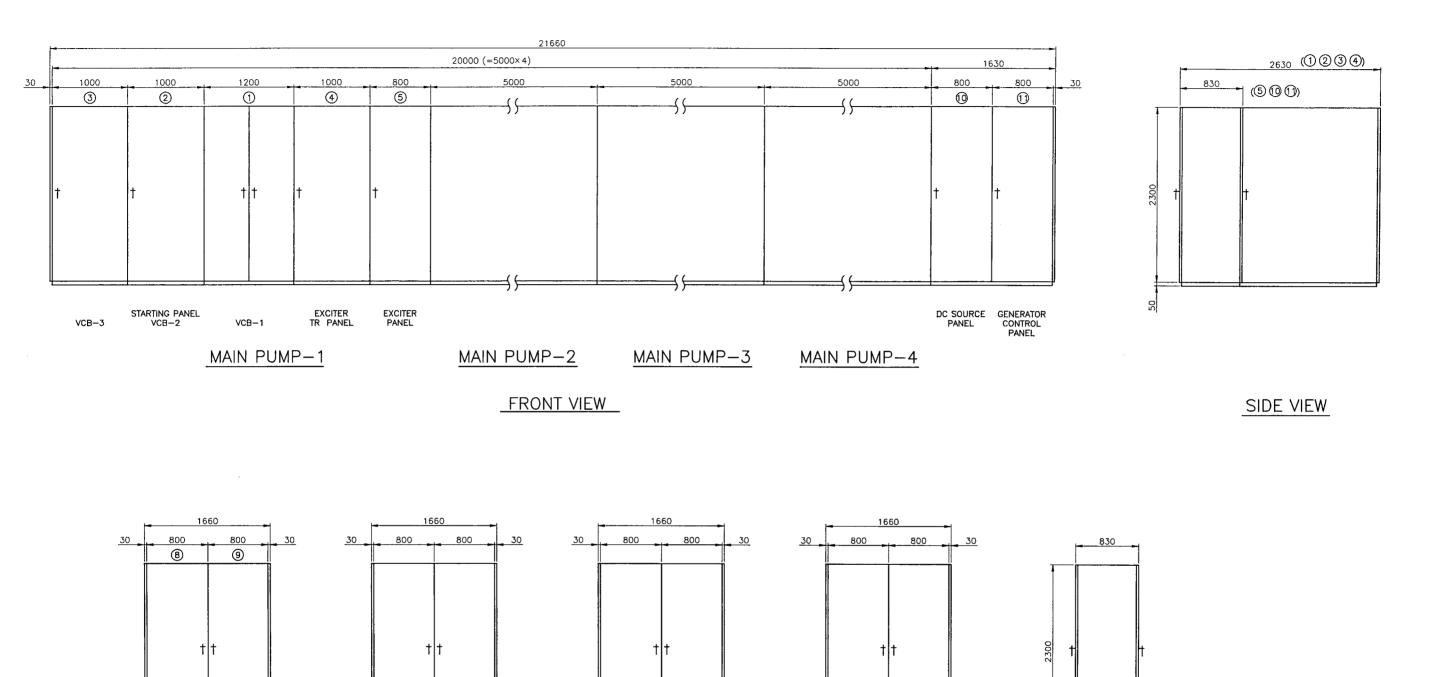

© ONTROL RELAY
PANEL

MAIN PUMP—1

MAIN PUMP—2

MAIN PUMP—3

MAIN PUMP—4


FRONT VIEW


SIDE VIEW


THE ARAB REPUBLIC OF EGYPT
MINISTRY OF WATER RESOURCES AND IRRIGATION
MORTH SINAI DEVELOPMENT ORGANIZATION
THE NORTH SINAI INTEGRATED RURAL
DEVELOPMENT PROJECT (PHASE !!!)


CONVEYANCE SYSTEM OF EL SHEIKH GABER EL SABBAH CANAL BETWEEN KM 108.466 AND KM 118.560 EL SALAAM NO.7 ( BIR EL ABD ) PUMPING STATION PUMP HOUSE MAIN MOTOR , MAIN MOTOR CONTROL, DC SOURCE, GENERATOR CONTROL PANEL OUTLINE


DRAWING NO.	PSE-207
APPROVED	
CHECKED	
TRACED	
DESIGNED	

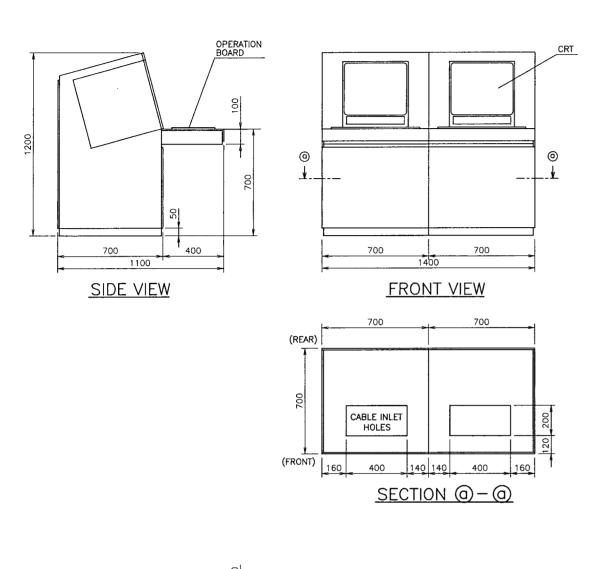

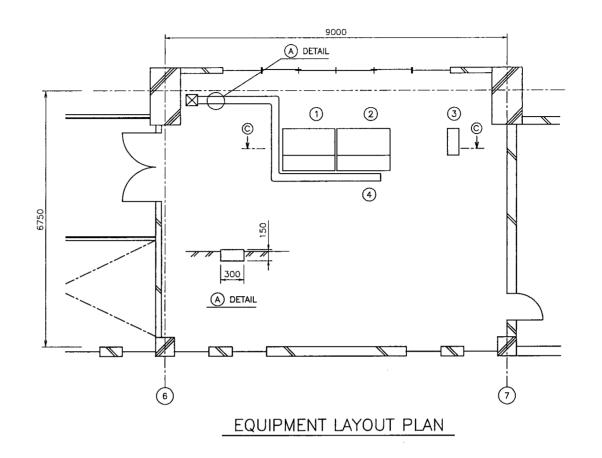

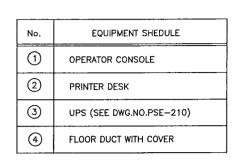

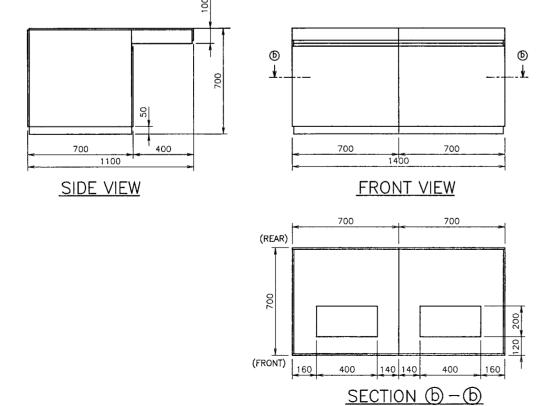

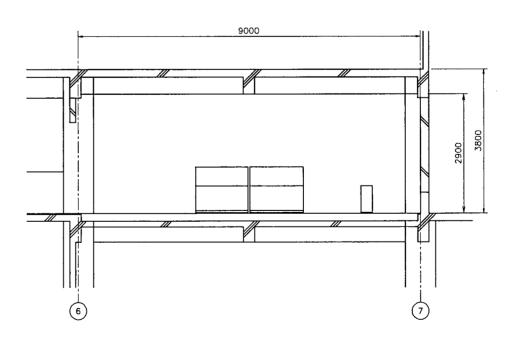

SECTION ©-©

THE ARAB REPUBLIC OF EGYPT
MINISTRY OF WATER RESOURCES AND IRRIGATION
NORTH SINAI DEVELOPMENT ORGANIZATION
THE MORTH CLANAL INTECRATED PURAI


THE NORTH SINAI INTEGRATED RURAL DEVELOPMENT PROJECT (PHASE III)


CONVEYANCE SYSTEM OF EL SHEIKH GABER EL SABBAH CANAL BETWEEN KM 108,466 AND KM 118.560 EL SALAAM No.7 ( BIR EL ABD ) PUMPING STATION

PUMP HOUSE


CENTRAL CONTROL ROOM EQUIPMENT LAYOUT PLAN

Drafte Concoctivatio	110, 1701110 001002772110 11112110111
DESIGNED	
TRACED	
CHECKED	
APPROVED	
DRAWING NO.	PSE-208

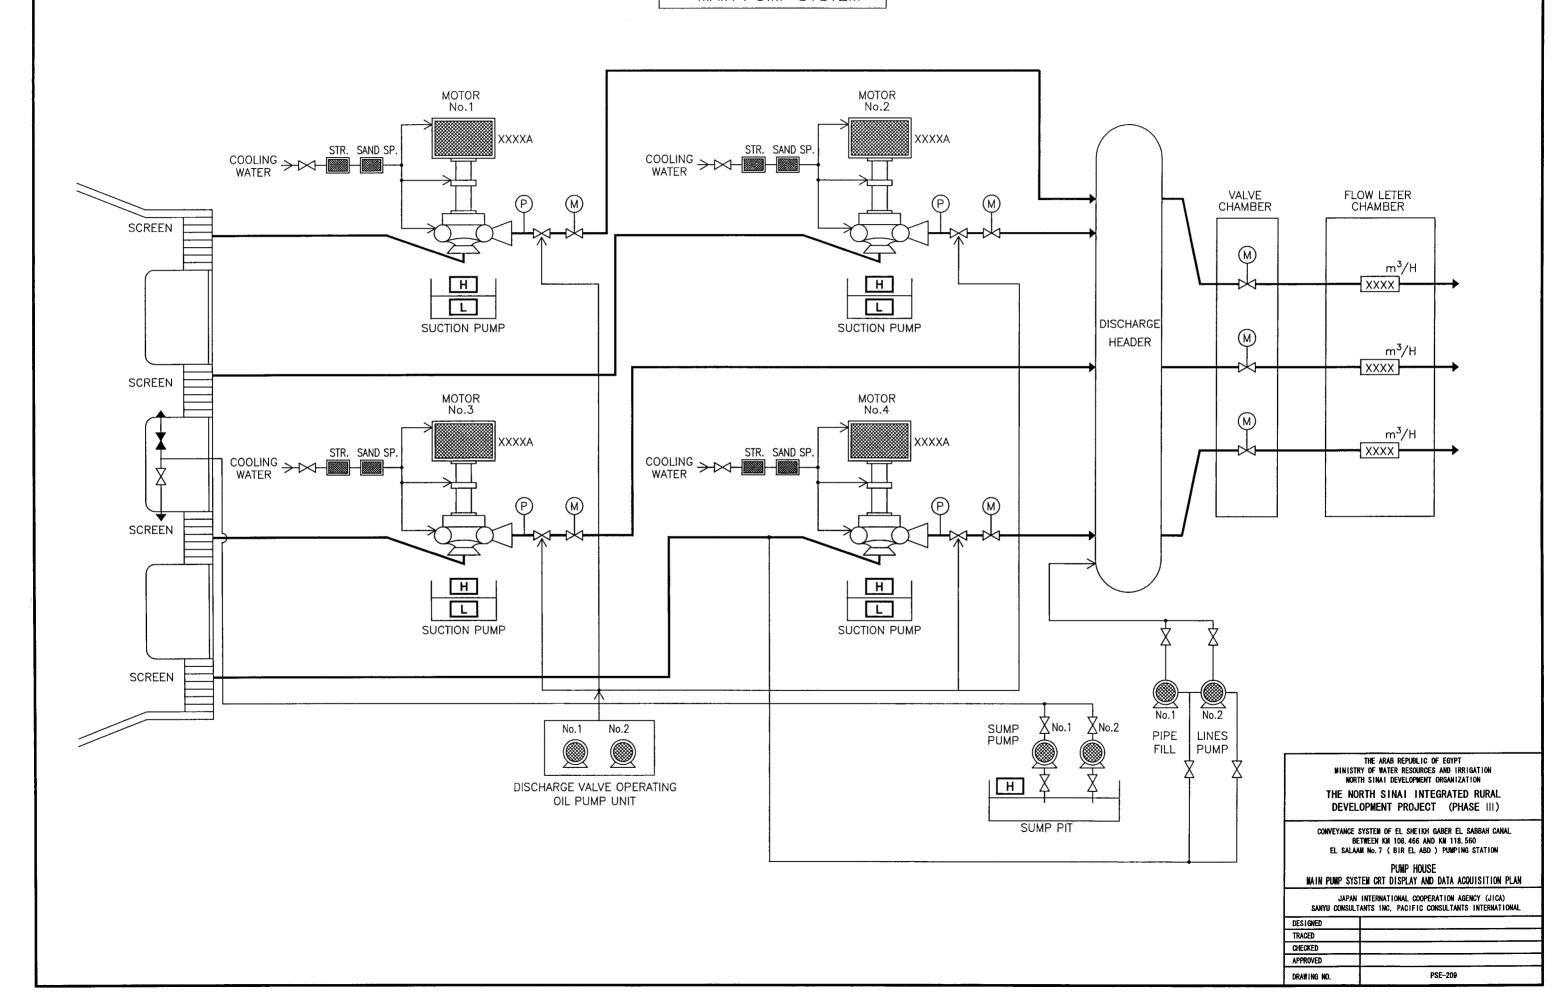


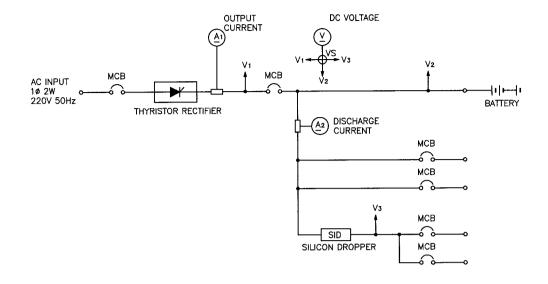


# DC POWER SOURCE MAIN CIRCUIT

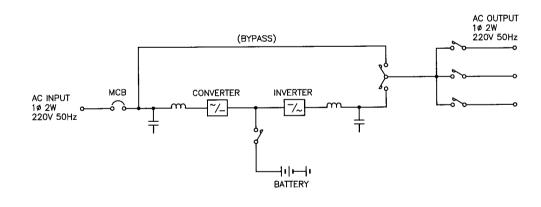

UPS MAIN CIRCUIT

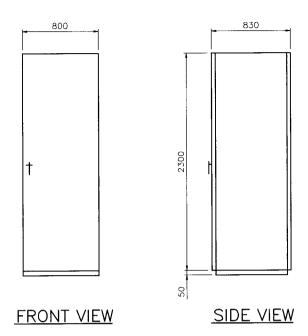

## PANEL OUTLINE

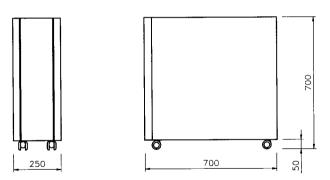

FRONT VIEW

SIDE VIEW

UPS OUTLINE

## MAIN TECHNICAL DATA

(1) D.C POWER SOURCE

1) BATTERY

1 TYPE : Ni-Cd ALKALINE/SINTERED PLATE

2 RATED CAPACITY (Ah) : 200Ah AT RATED DISCHARGE RATE 1 Hr.

3 VOLTAGE (V/CELL)

• NORMAL : 1.20 • FLOATING : 1.35 • EQUALIZING : 1.47

2) BATTERY CHARGER

1 A.C INPUT VOLTAGE : 1-PHASE, 220V, 50Hz

2 CHARGER INPUT CAPACITY : 20kVA
3 LOAD VOLTAGE COMPENSATOR : 100A
4 D.C OUTPUT VOLTAGE : 110V

(2) UPS

1) A.C INPUT

1 ELECTRIC SYSTEM : 1-PHASE, 2-WIRE 2 RATED VOLTAGE : 220V

3 RATED FREQUENCY : 50Hz 4 PERMISSIBLE VOLTAGE : RATED

DEVIATION RANGE

: RATED VOLTAGE ±10%

5 PERMISSIBLE FREQUENCY : RATED VOLTAGE ± 5%

DEVIATION RANGE

2) A.C OUTPUT

1 RATED OUTPUT : 5kVA

2 ELECTRIC SYSTEM : 1-PH

: 1-PHASE, 2-WIRE

3 RATED VOLTAGE : 220V

4 VOLTAGE REGURLATION RANGE : RATED VOLTAGE ± 5%

5 RATED FREQUENCY

: 50Hz : 0.85 LAG

6 RATED POWER FACTOR
7 VOLTAGE ACCURACY

-NORMAL DEVIATION

: RATED VOLTAGE ± 2% : RATED VOLTAGE ±10%

-TRANSIENT DEVIATION : RATED VC -SETTING TIME : 0.1 SEC

8 FREQUENCY ACCURACY : RATED FREQUENCY ±0.5%

9 WAVE FROM PISTORTION FACTOR : 5% OR LESS

THE ARAB REPUBLIC OF EGYPT
MINISTRY OF WATER RESOURCES AND IRRIGATION
NORTH SINAI DEVELOPMENT ORGANIZATION
THE NORTH SINAI INTEGRATED RURAL
DEVELOPMENT PROJECT (PHASE III)

CONVEYANCE SYSTEM OF EL SHEIKH GABER EL SABBAH CANAL BETWEEN KM 108. 466 AND KM 118.560 EL SALAAM No. 7 ( BIR EL ABD ) PUMPING STATION PUMP HOUSE

JAPAN INTERNATIONAL COOPERATION AGENCY (JICA)

DC POWER SOURCE AND UPS SINGLE LINE DIAGRAM

SANYU CONSULTANTS INC, PACIFIC CONSULTANTS INTERNATIONAL		
DESTGNED		
TRACED		
CHECKED		
APPROVED		
DRAWING NO.	PSE-210	