





	STATE/REGION		TOTAL SHEET	
rojeci	STATE/ REGION		ZALYKAMIZARANYA WALAKA	
GHAZIABAD-MEERUT EXPRESSWAY	NCR	5/26	039	
PLAN AND PROFILE SCALE: H = 1:5000, V =		/ = 1:500		
		SANTA CONTRACTOR AND	***************************************	

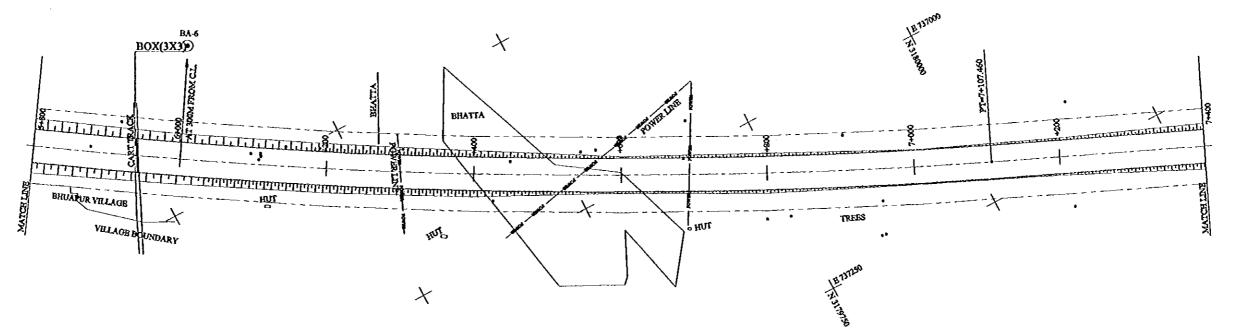

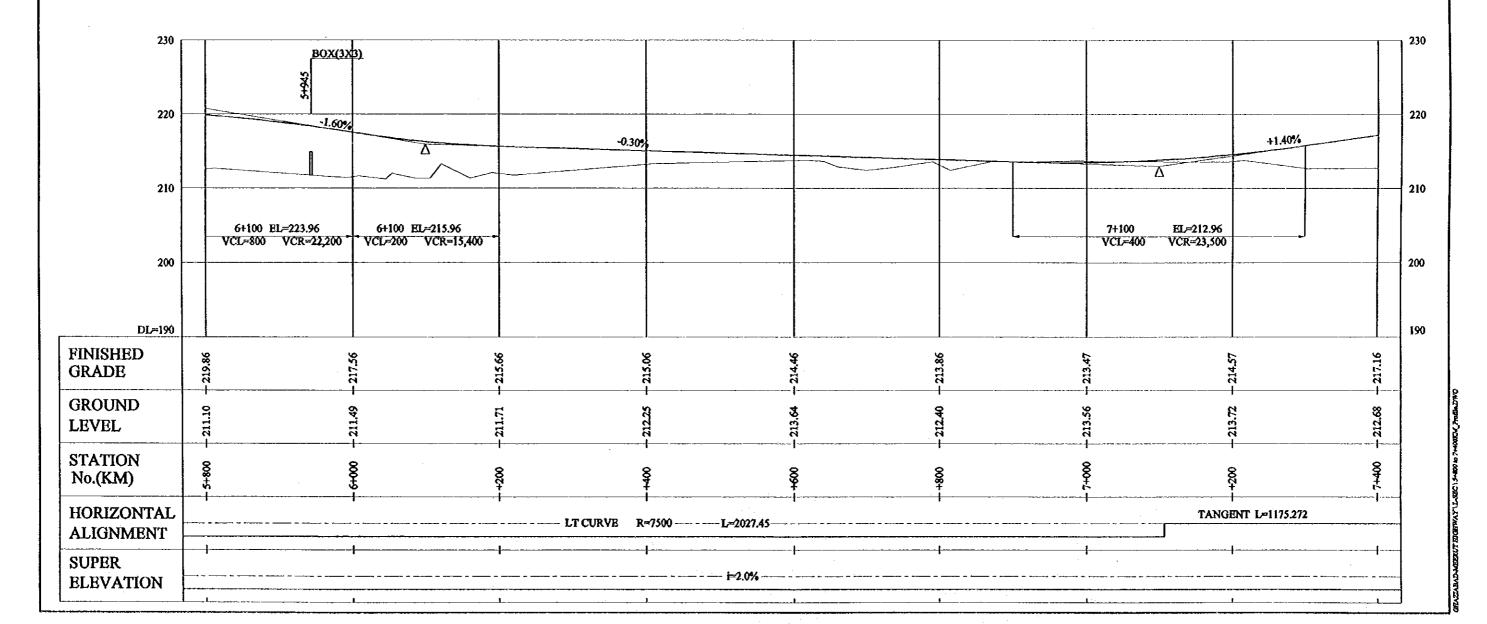

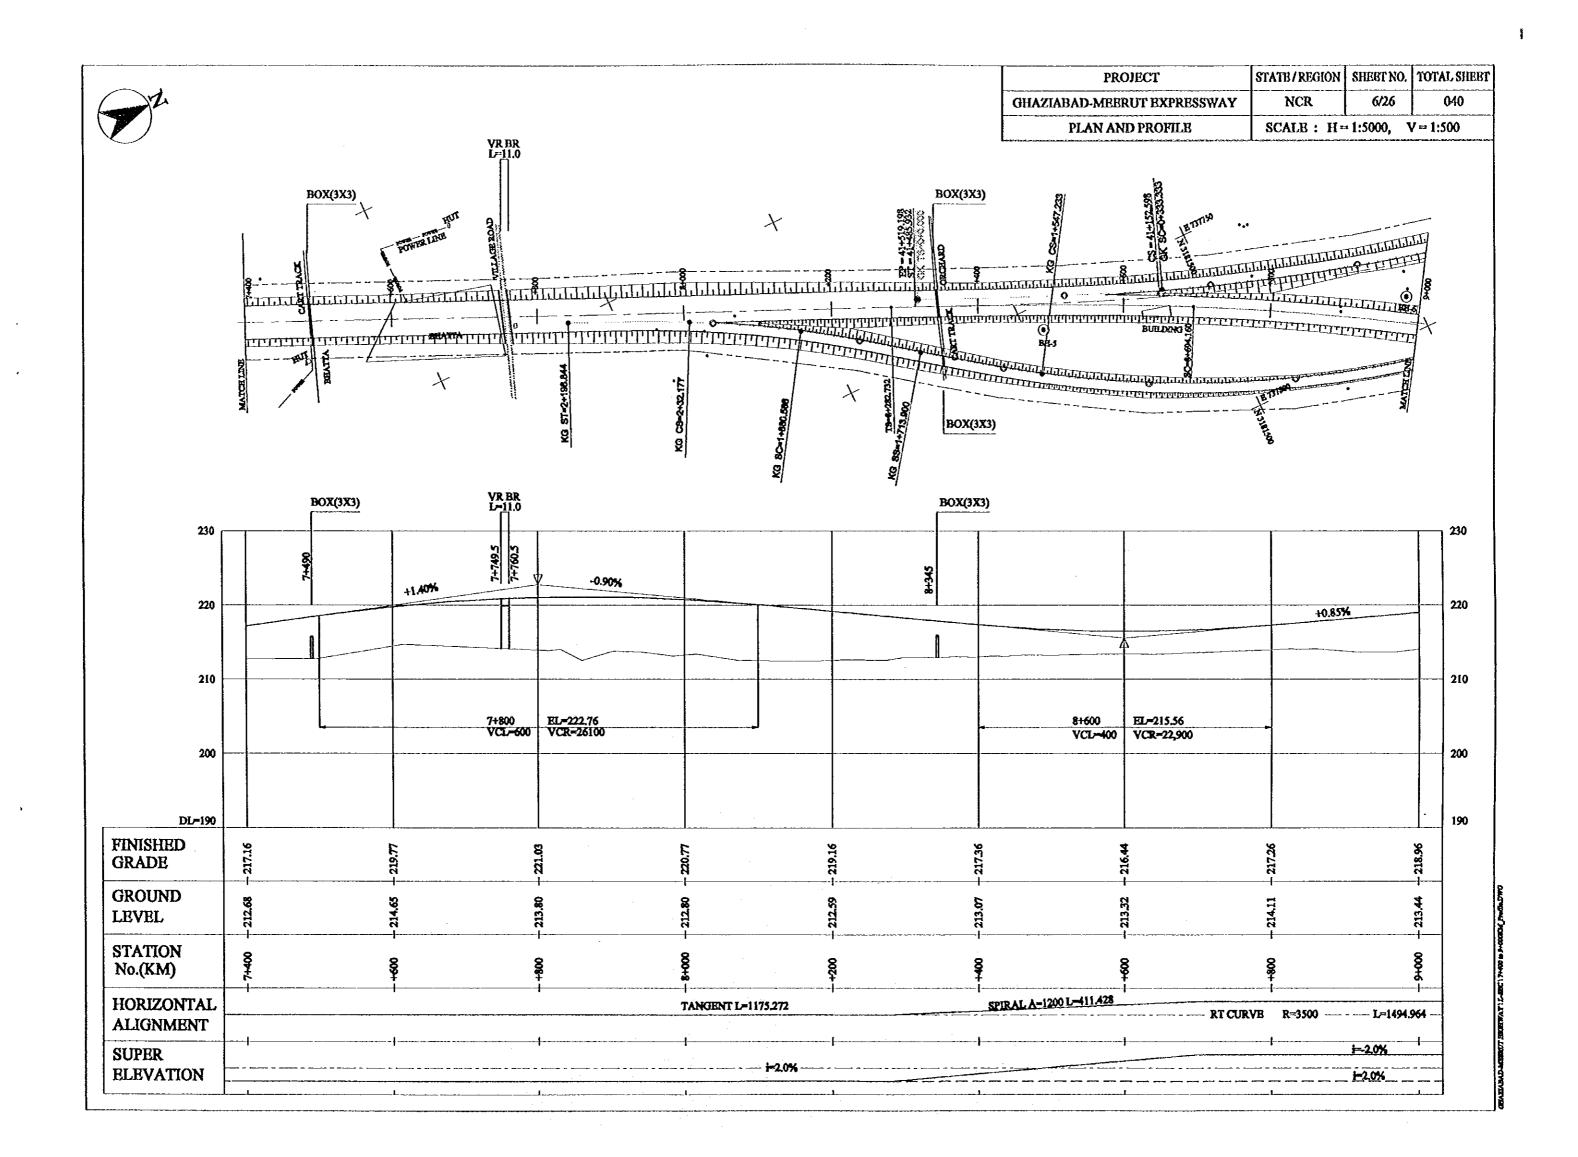


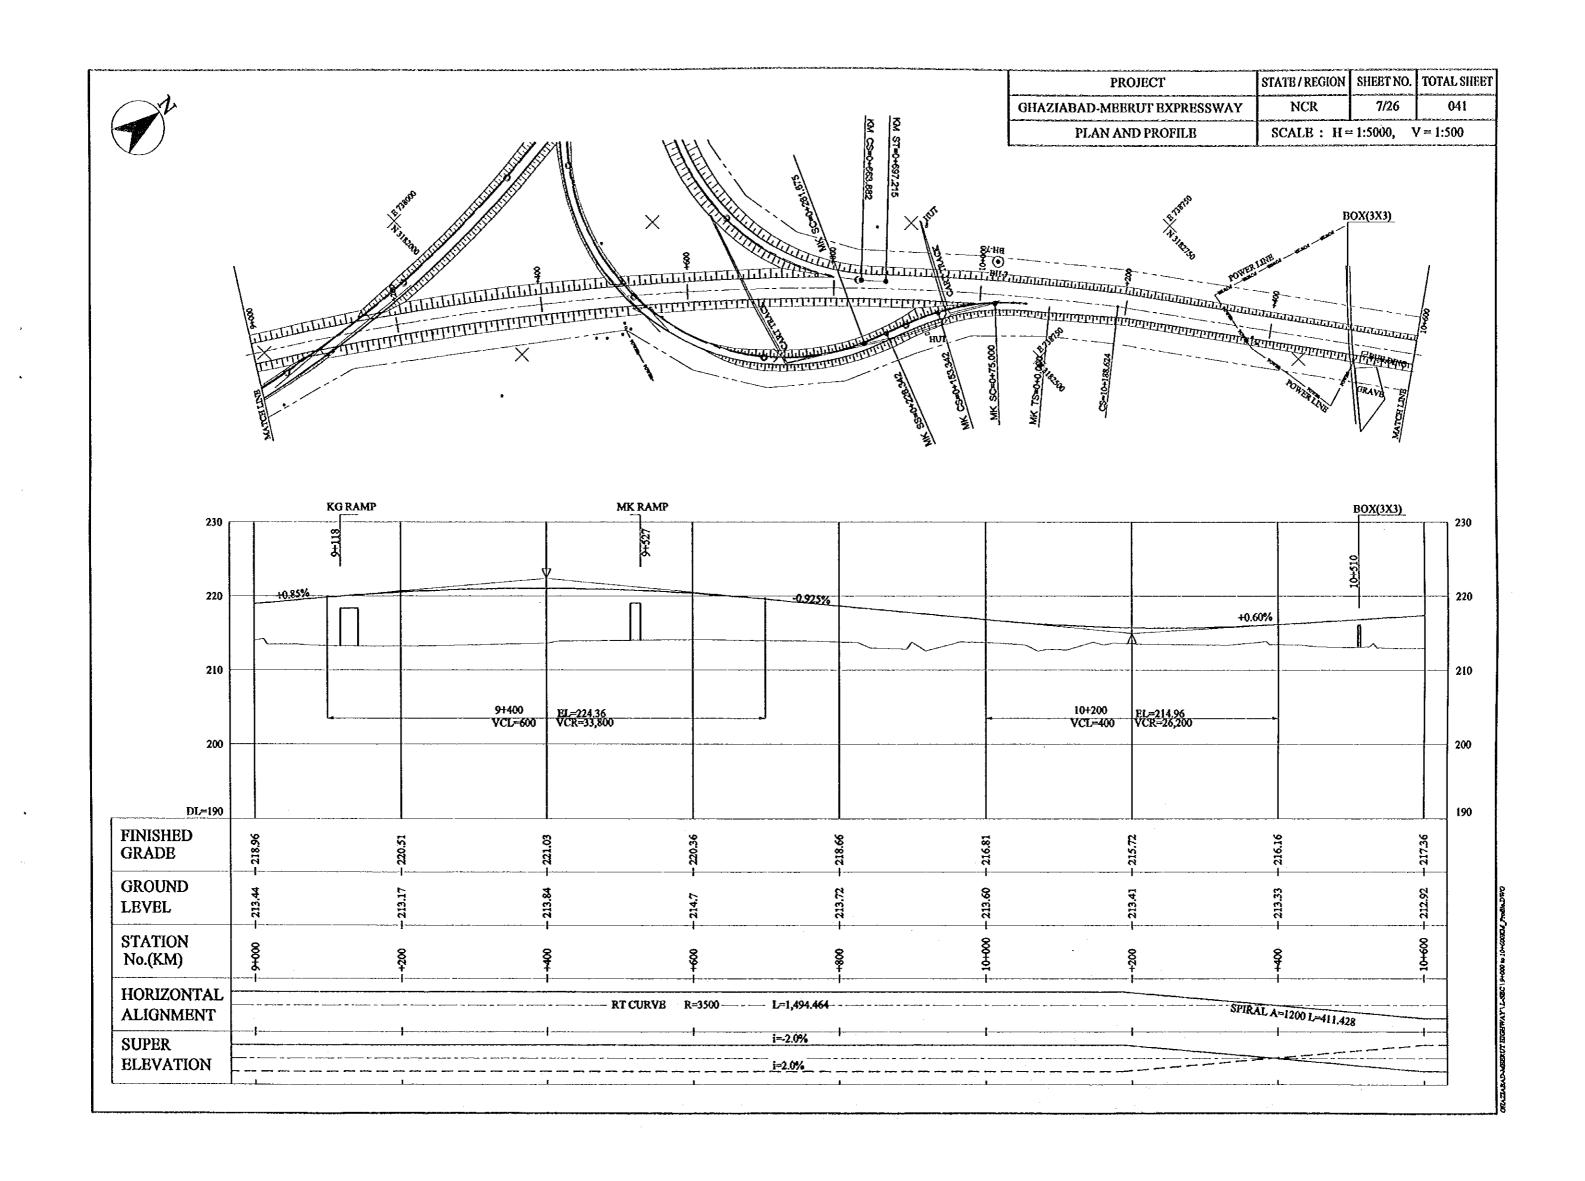






PROJECT STATE/REGION SHEET NO. TOTAL SHEET
GHAZIABAD-MEERUT BXPRESSWAY NCR 8/26 042

PLAN AND PROFILE SCALE: H=1:5000, V=1:500

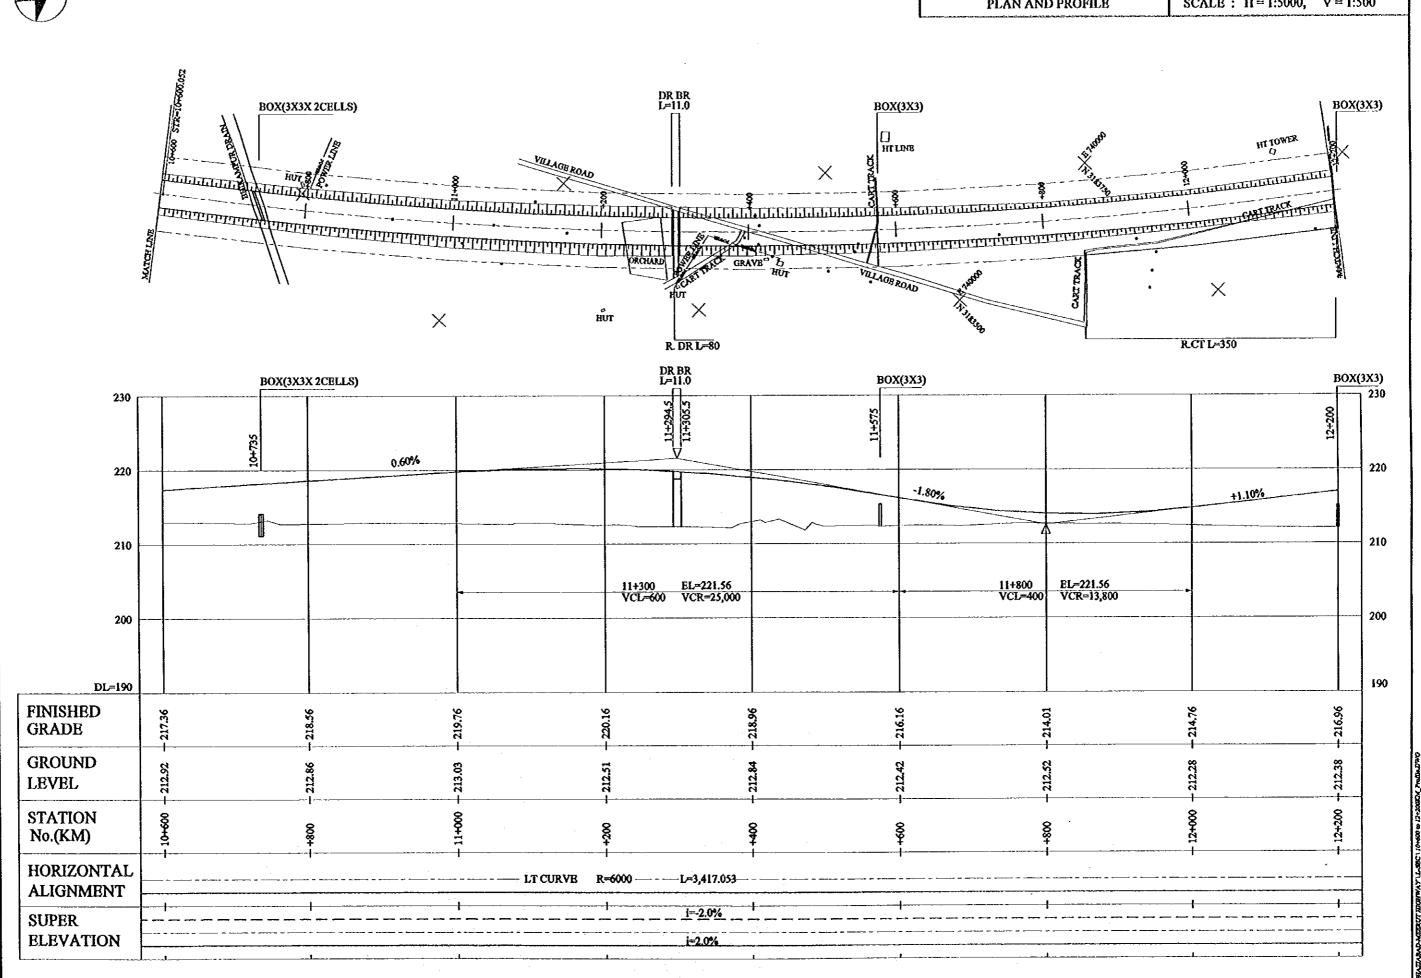

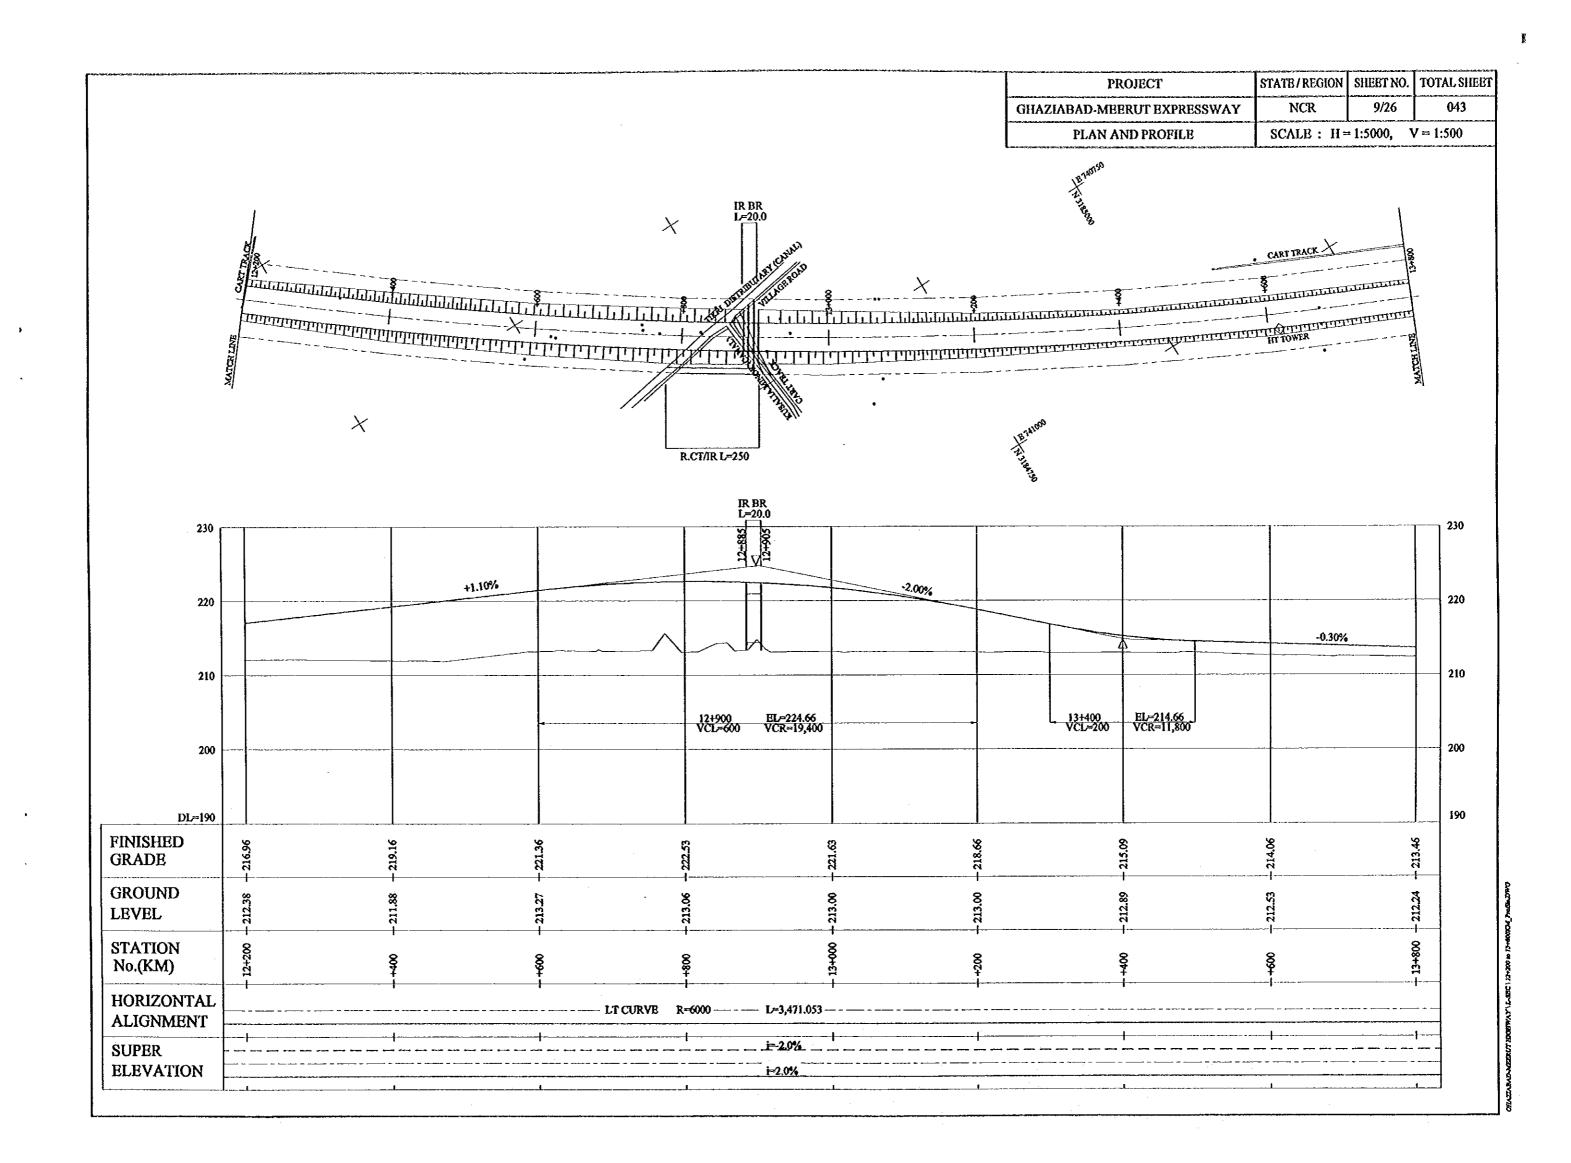


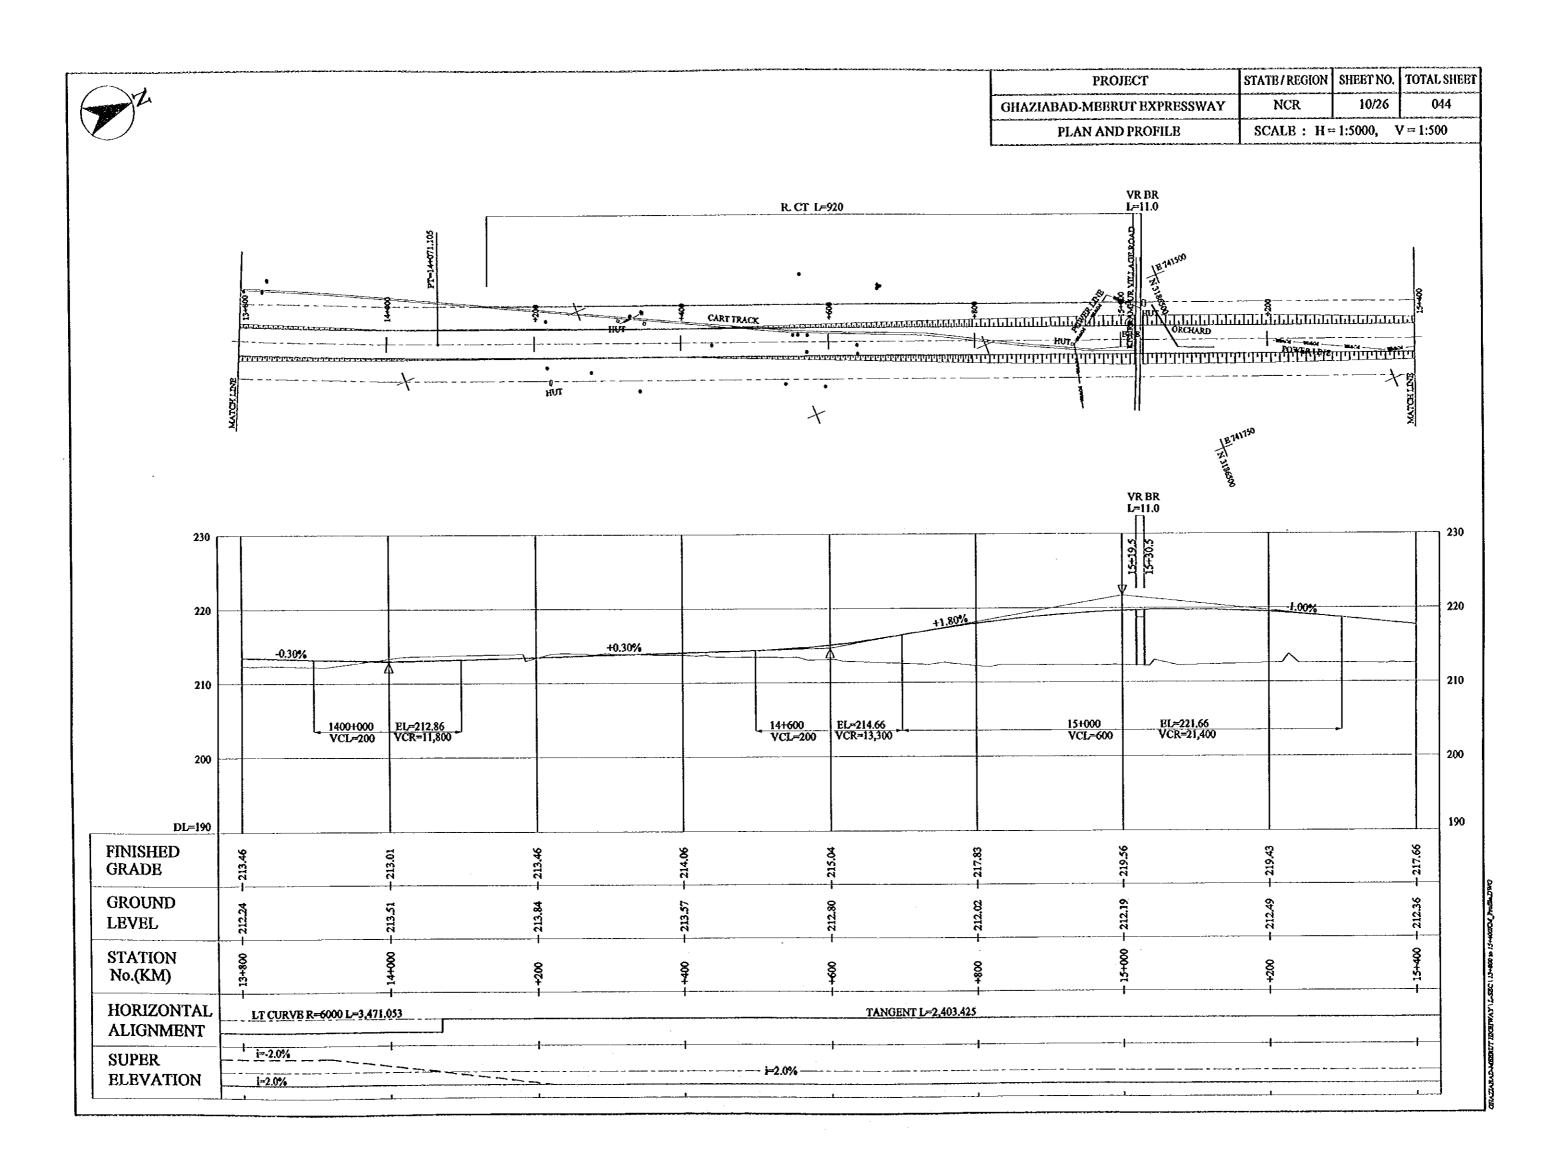


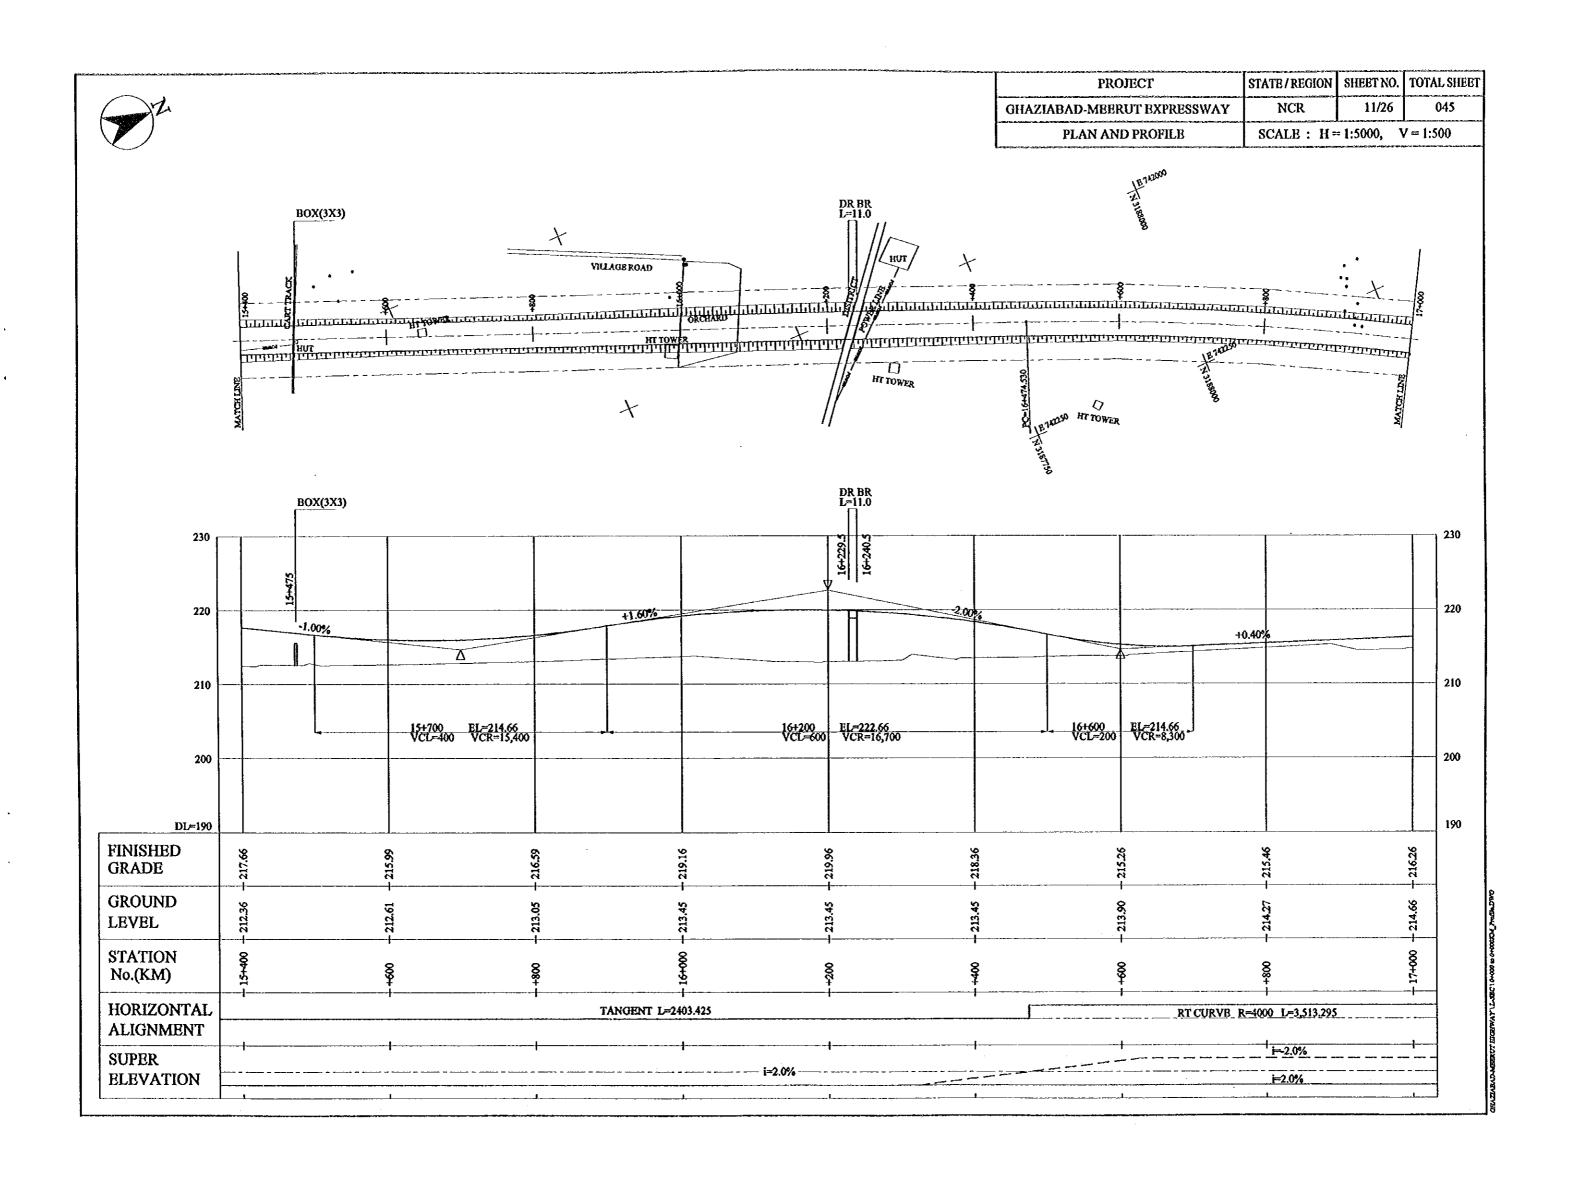




-	PROJECT	STATE/REGION	SHEET NO.	TOTAL SHEET	
	GHAZIABAD-MEERUT EXPRESSWAY	NCR	12/26	046	
	PLAN AND PROFILE	SCALE: H=	SCALE: H=1:5000, V=1:500		

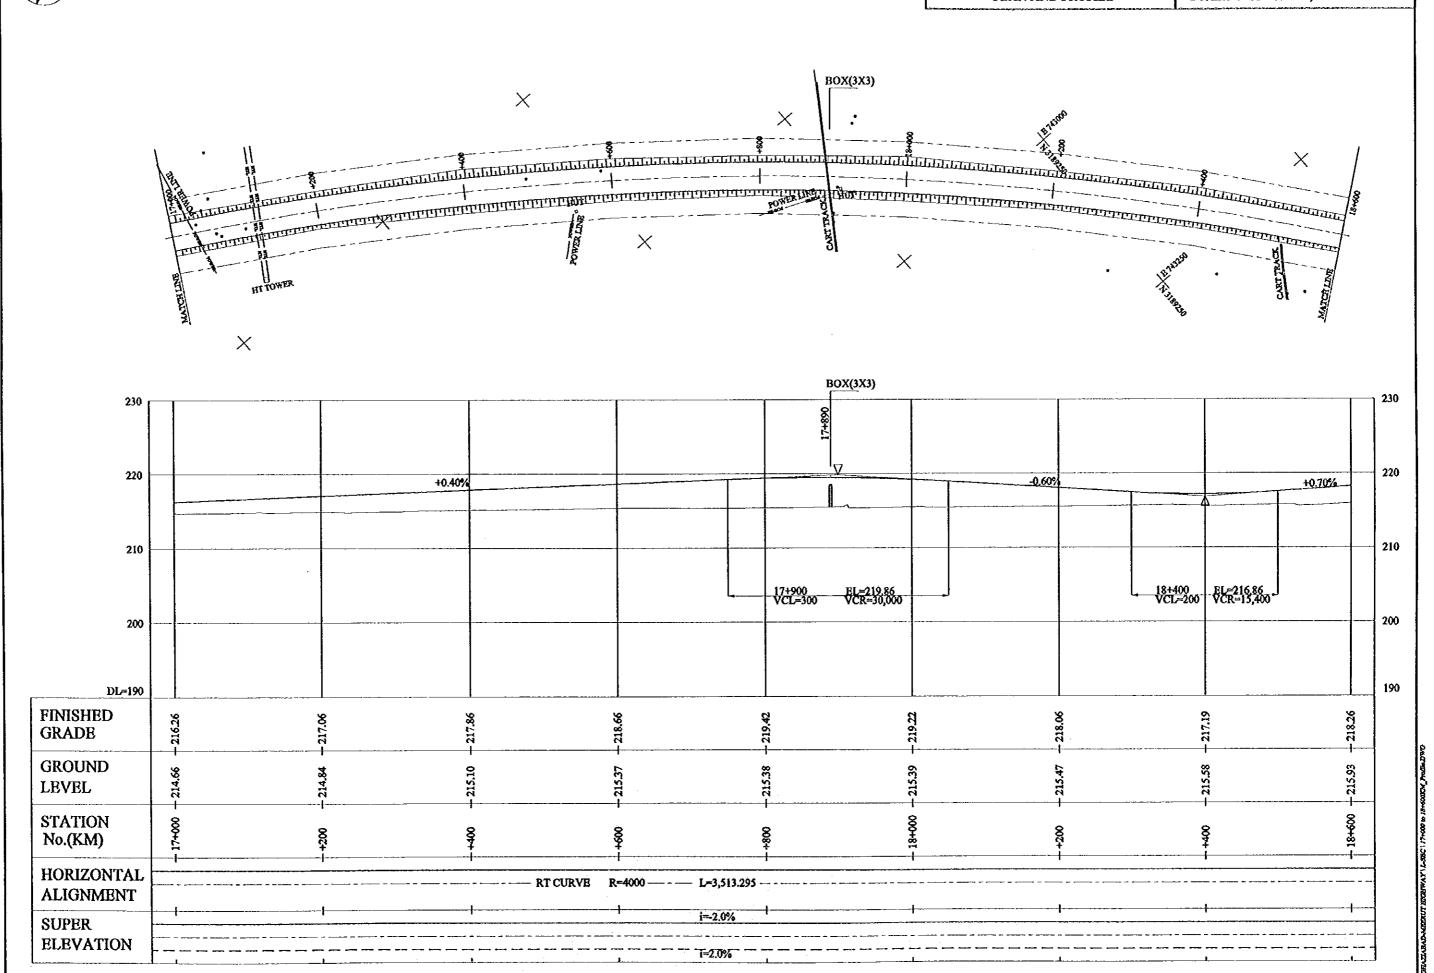


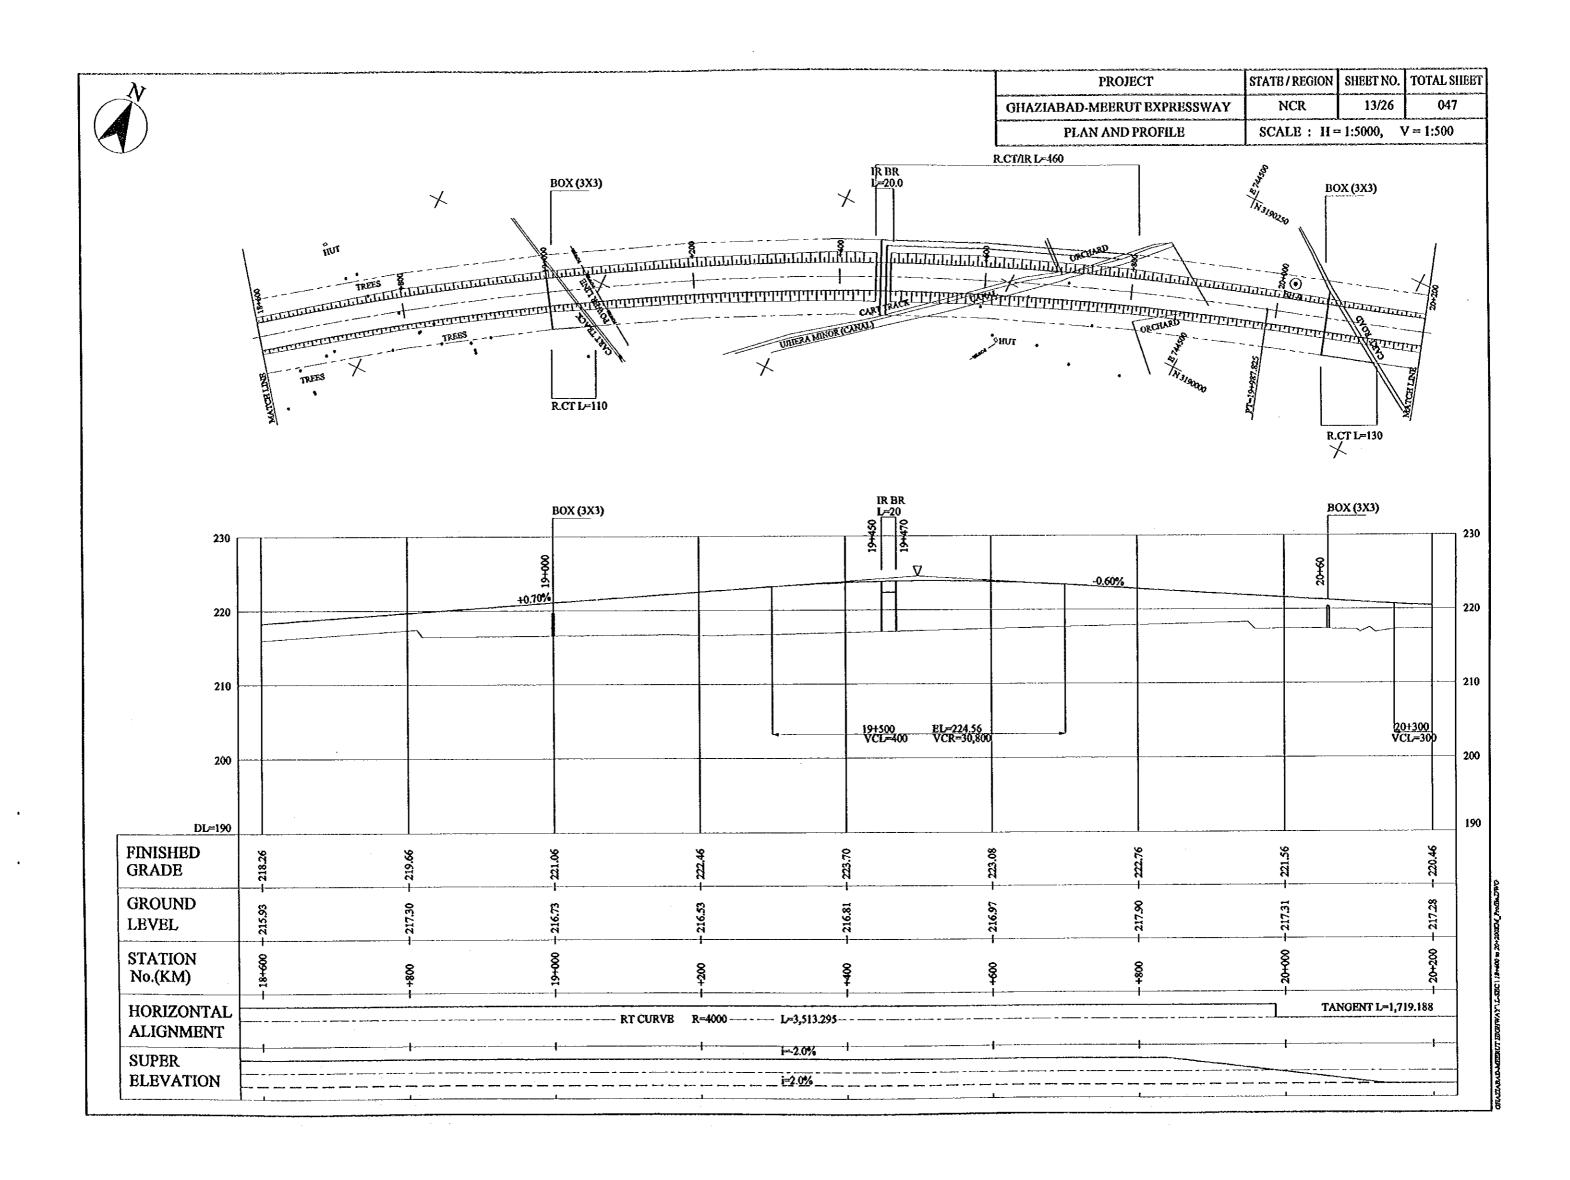


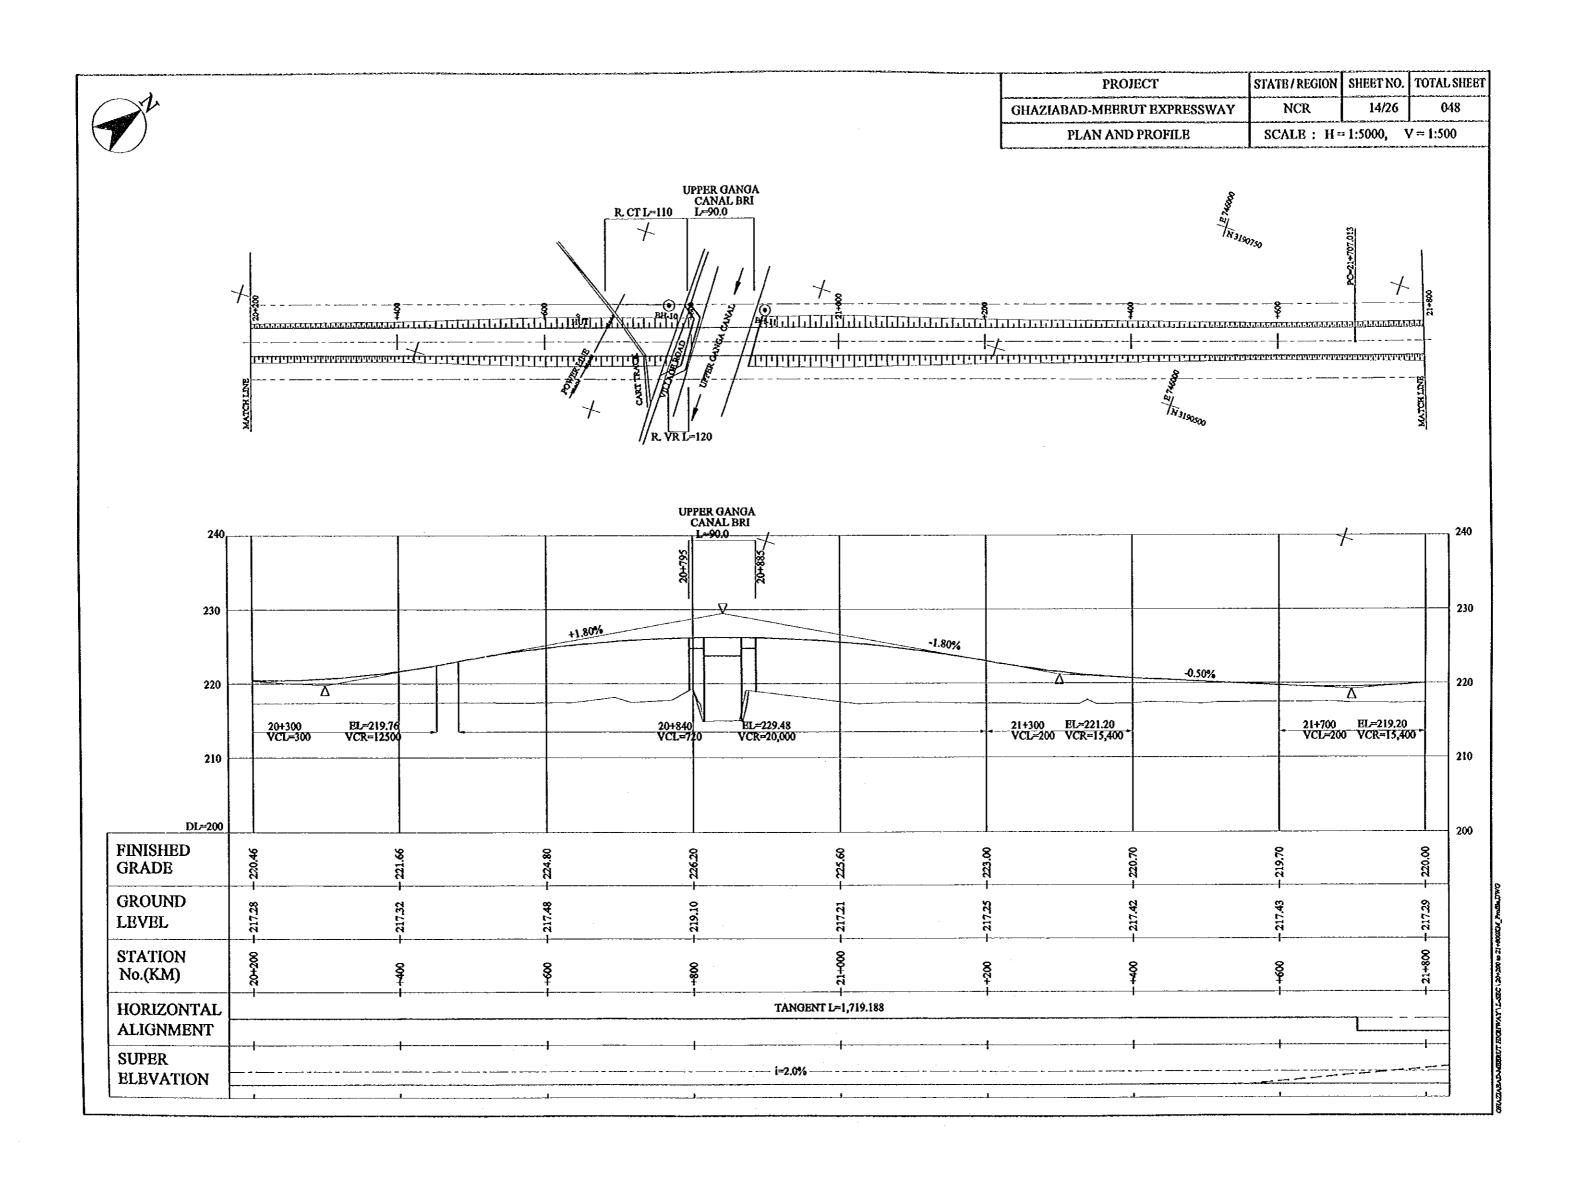





٠										
	PROJECT	STATE/REGION	SHEET NO.	TOTAL SHEET						
	GHAZIABAD-MEERUT EXPRESSWAY	NCR	15/26	049						
	PLAN AND PROFILB	SCALE: H=1:5000, V=1:500								

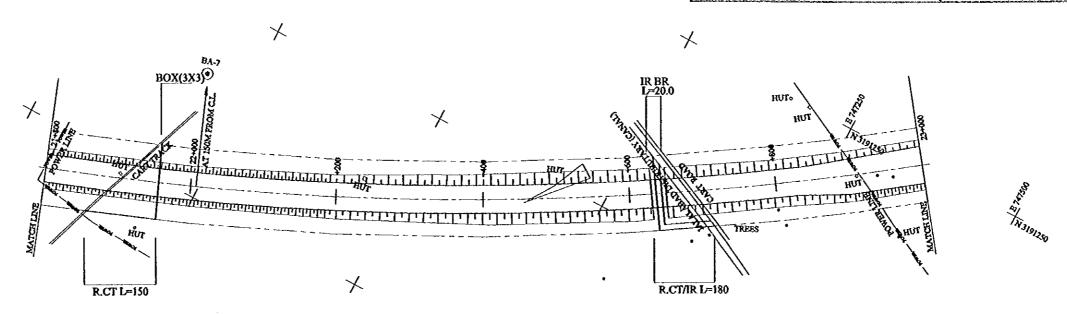

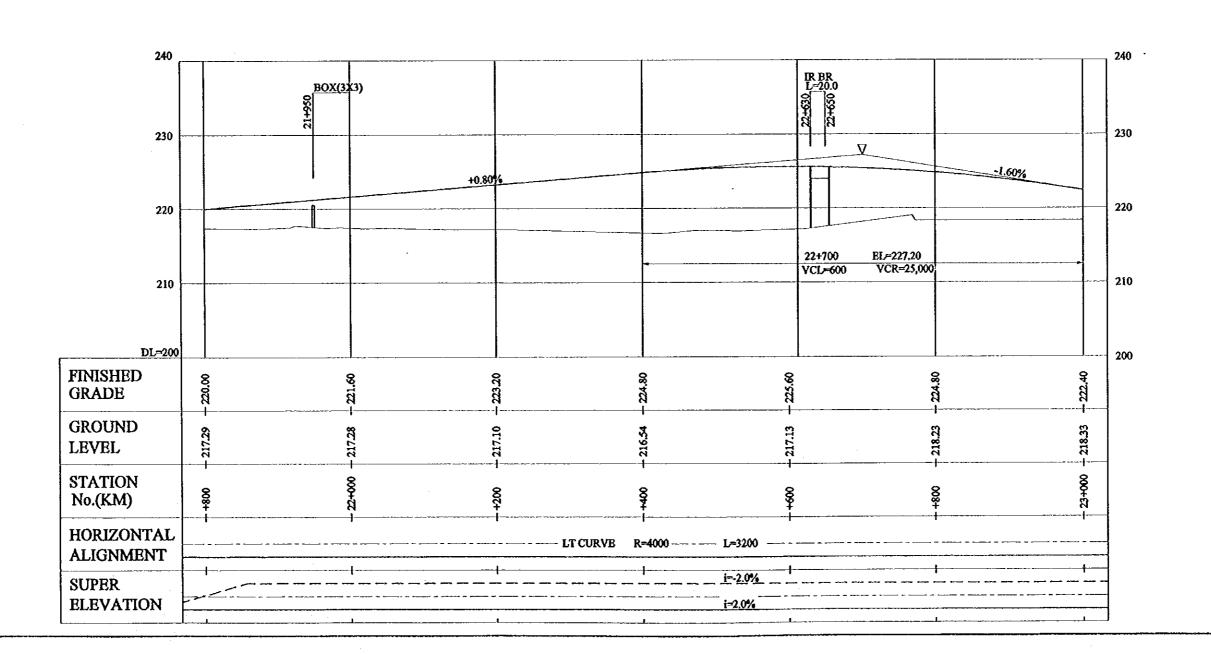

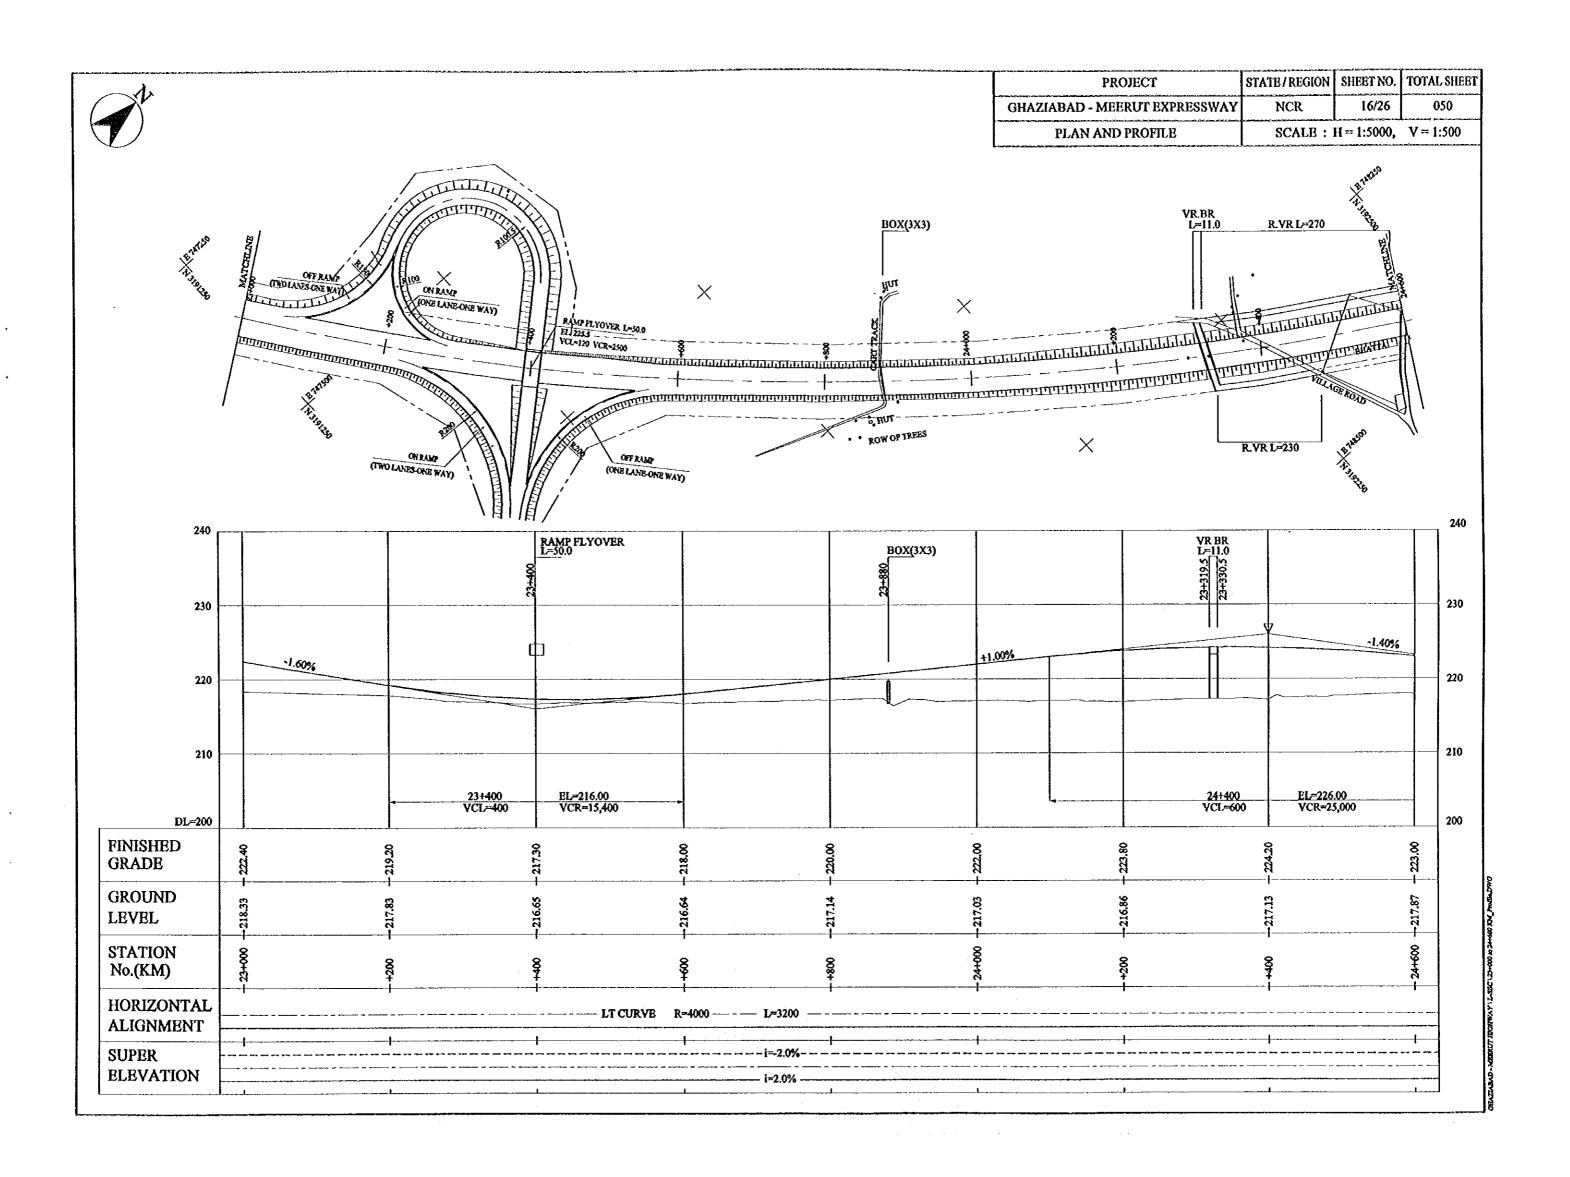

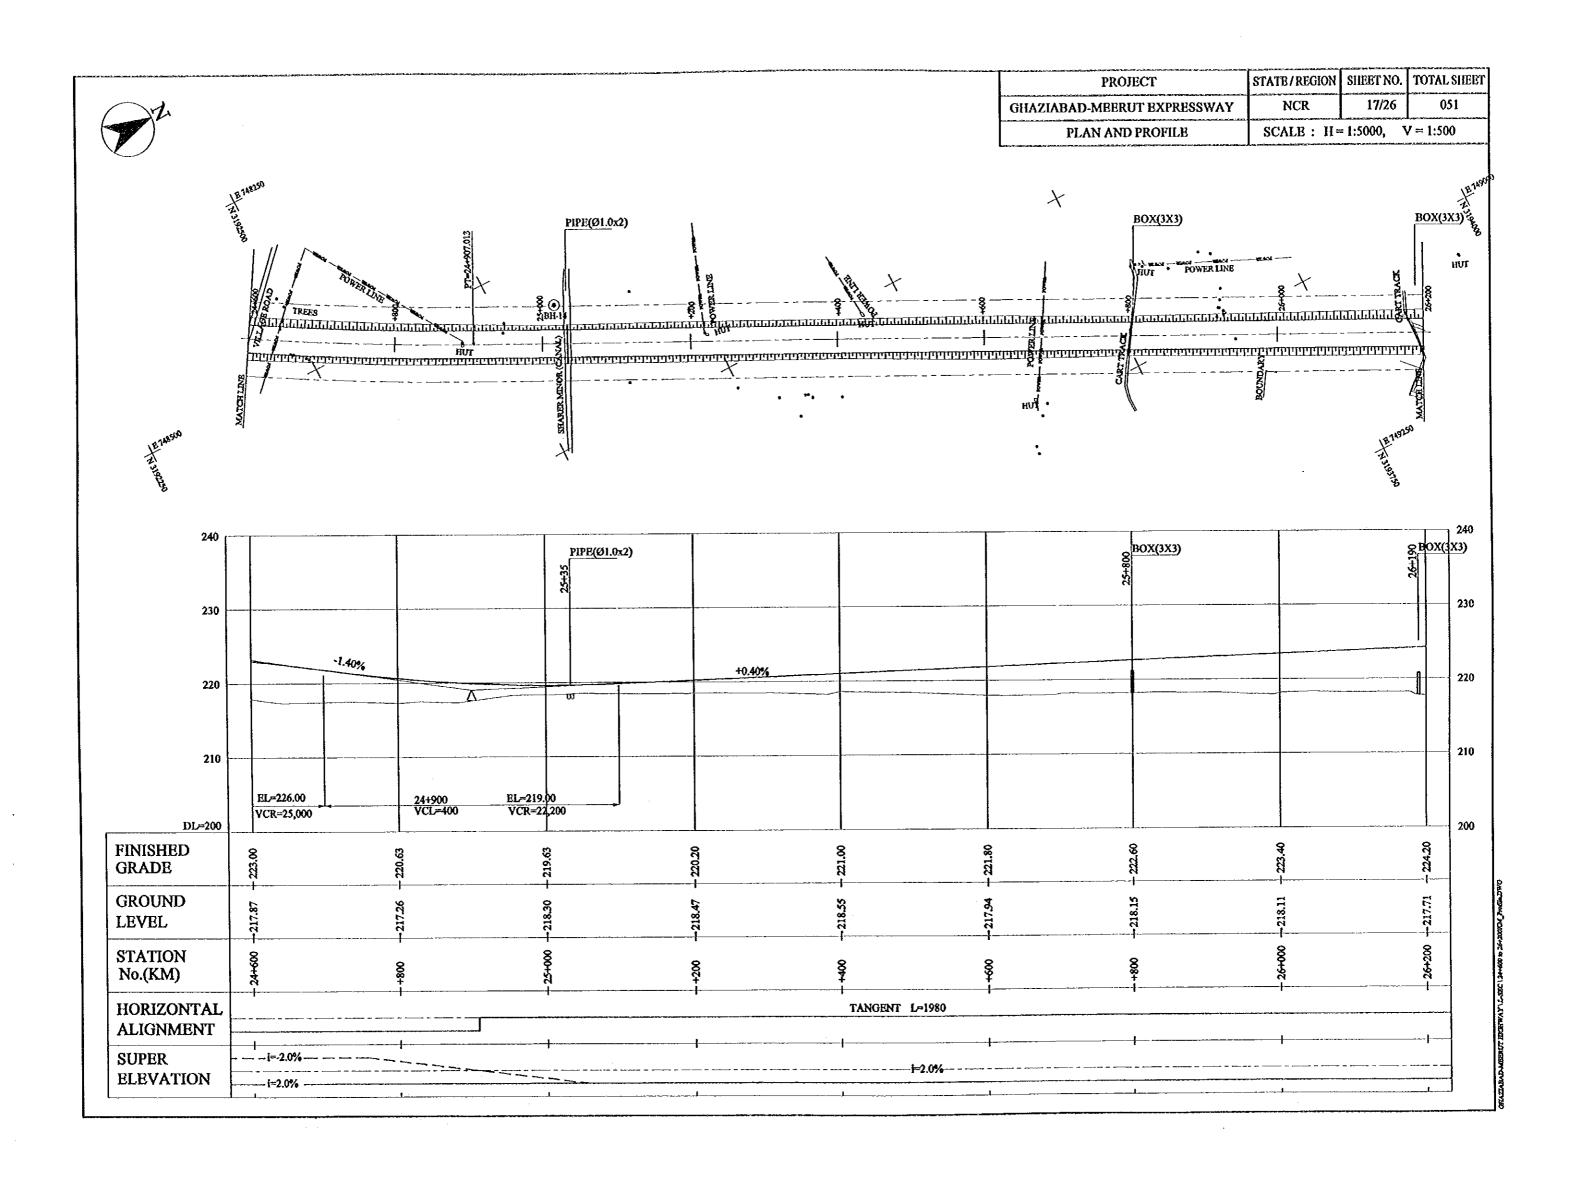






PROJECT STATE / REGION SHEET NO. TOTAL SHEET


GHAZIABAD - MEERUT EXPRESSWAY NCR 18/26 052


PLAN AND PROFILE SCALB: H = 1:5000, V = 1:500

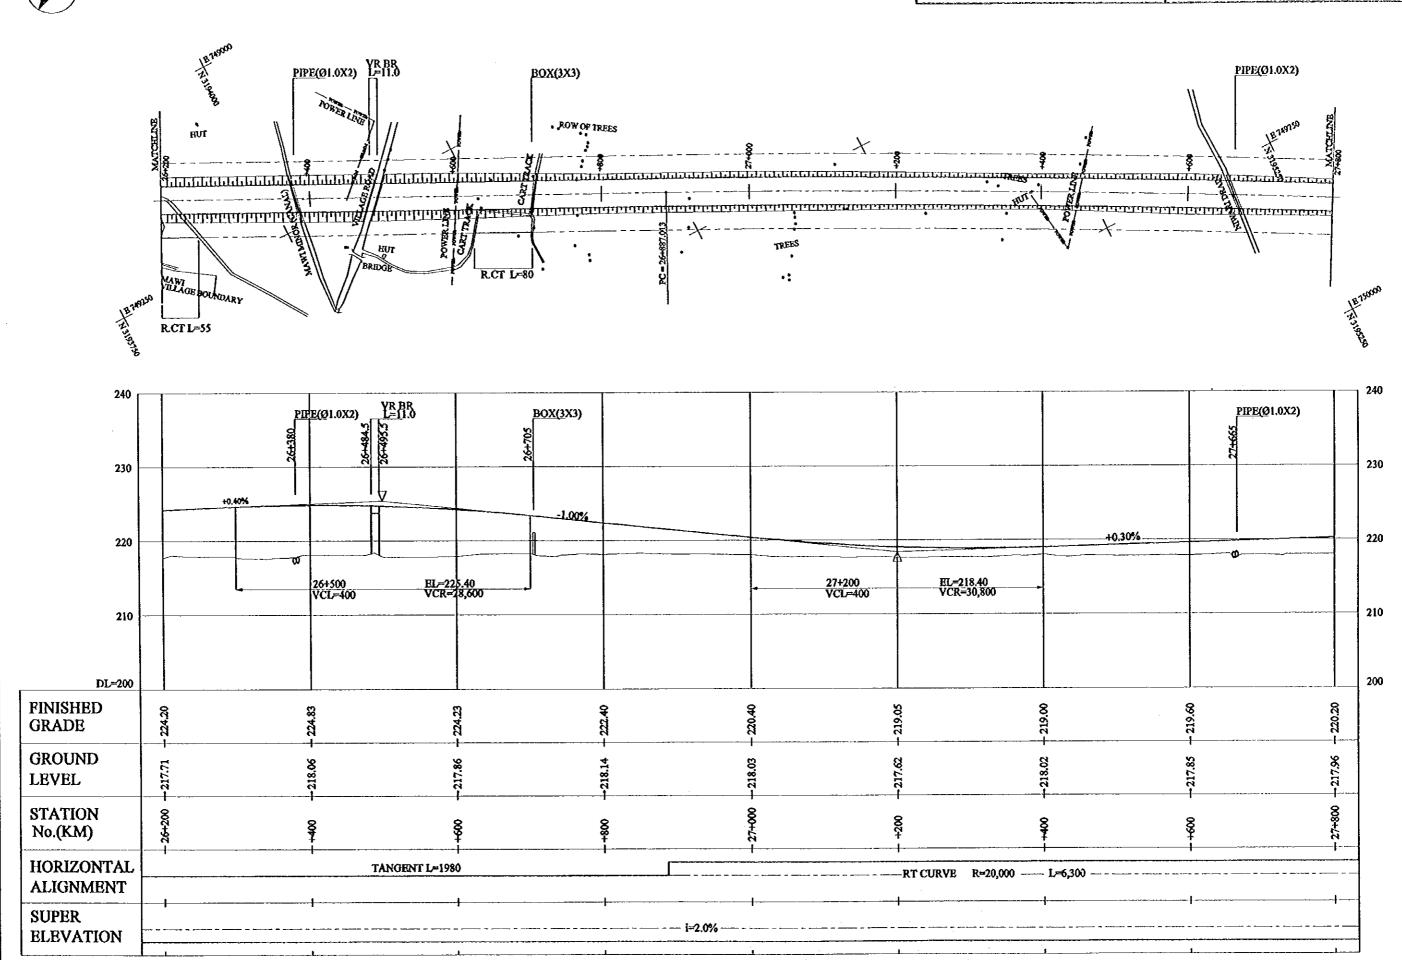

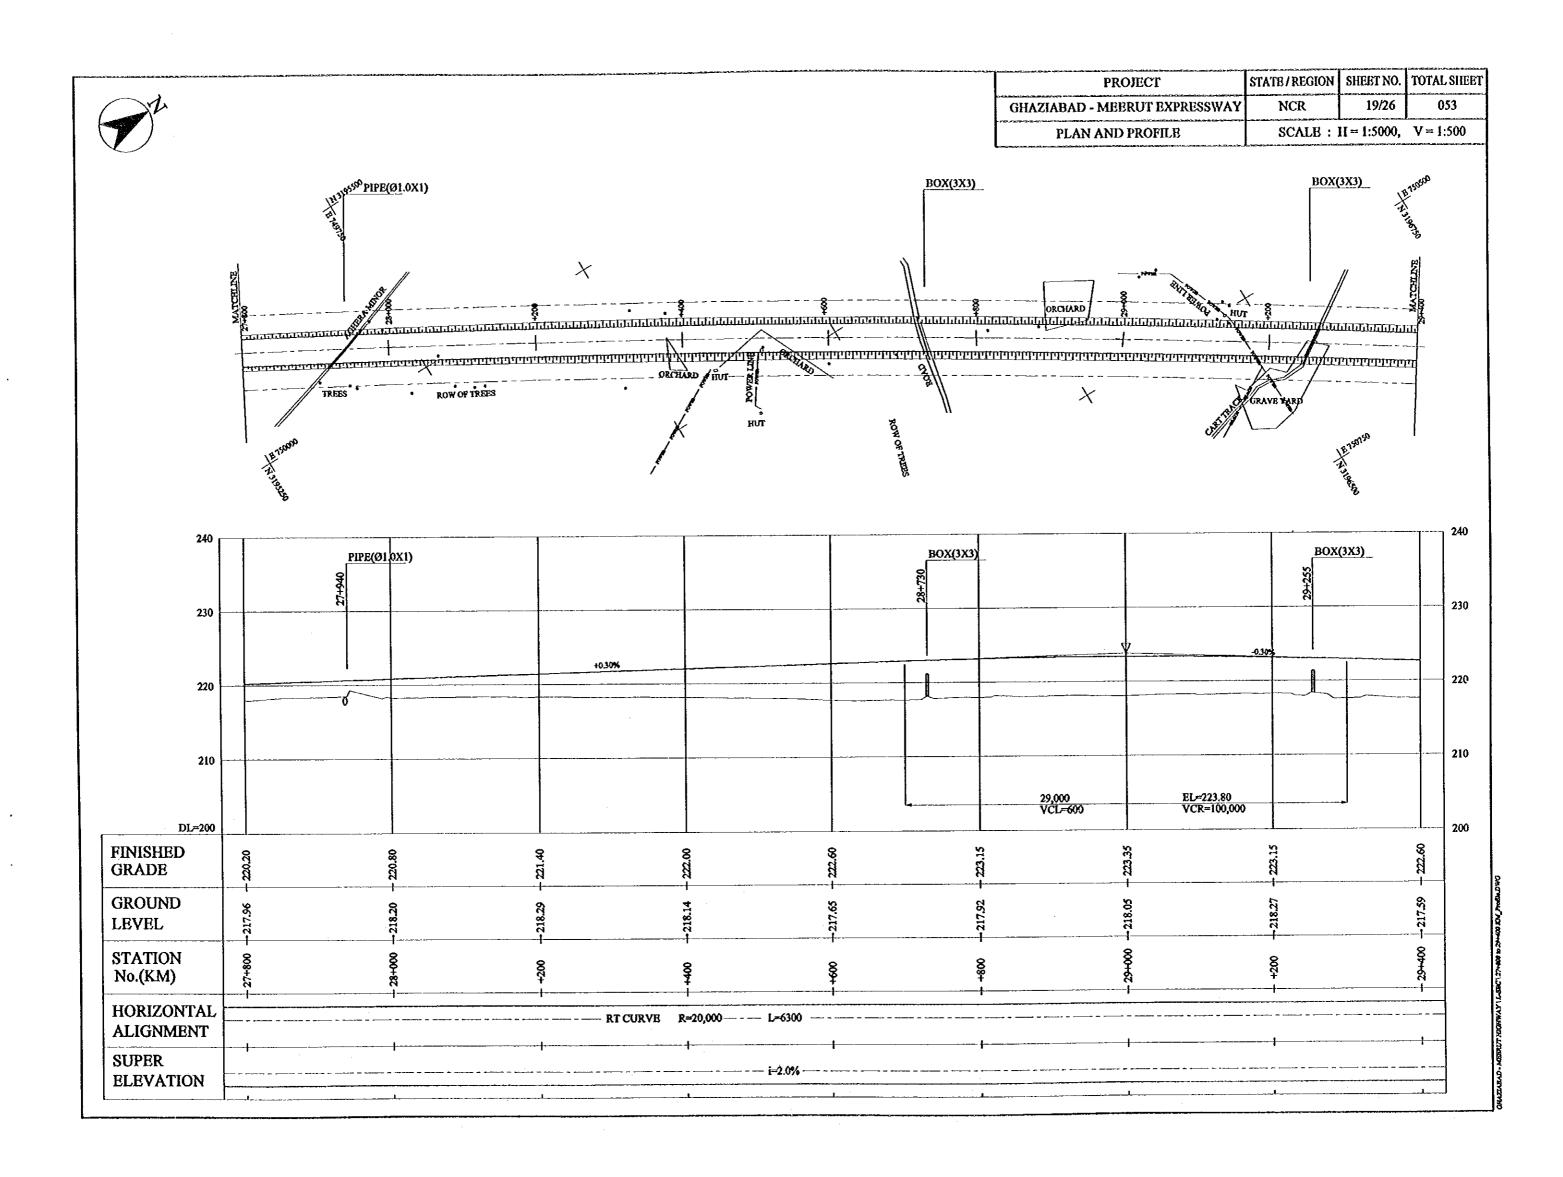

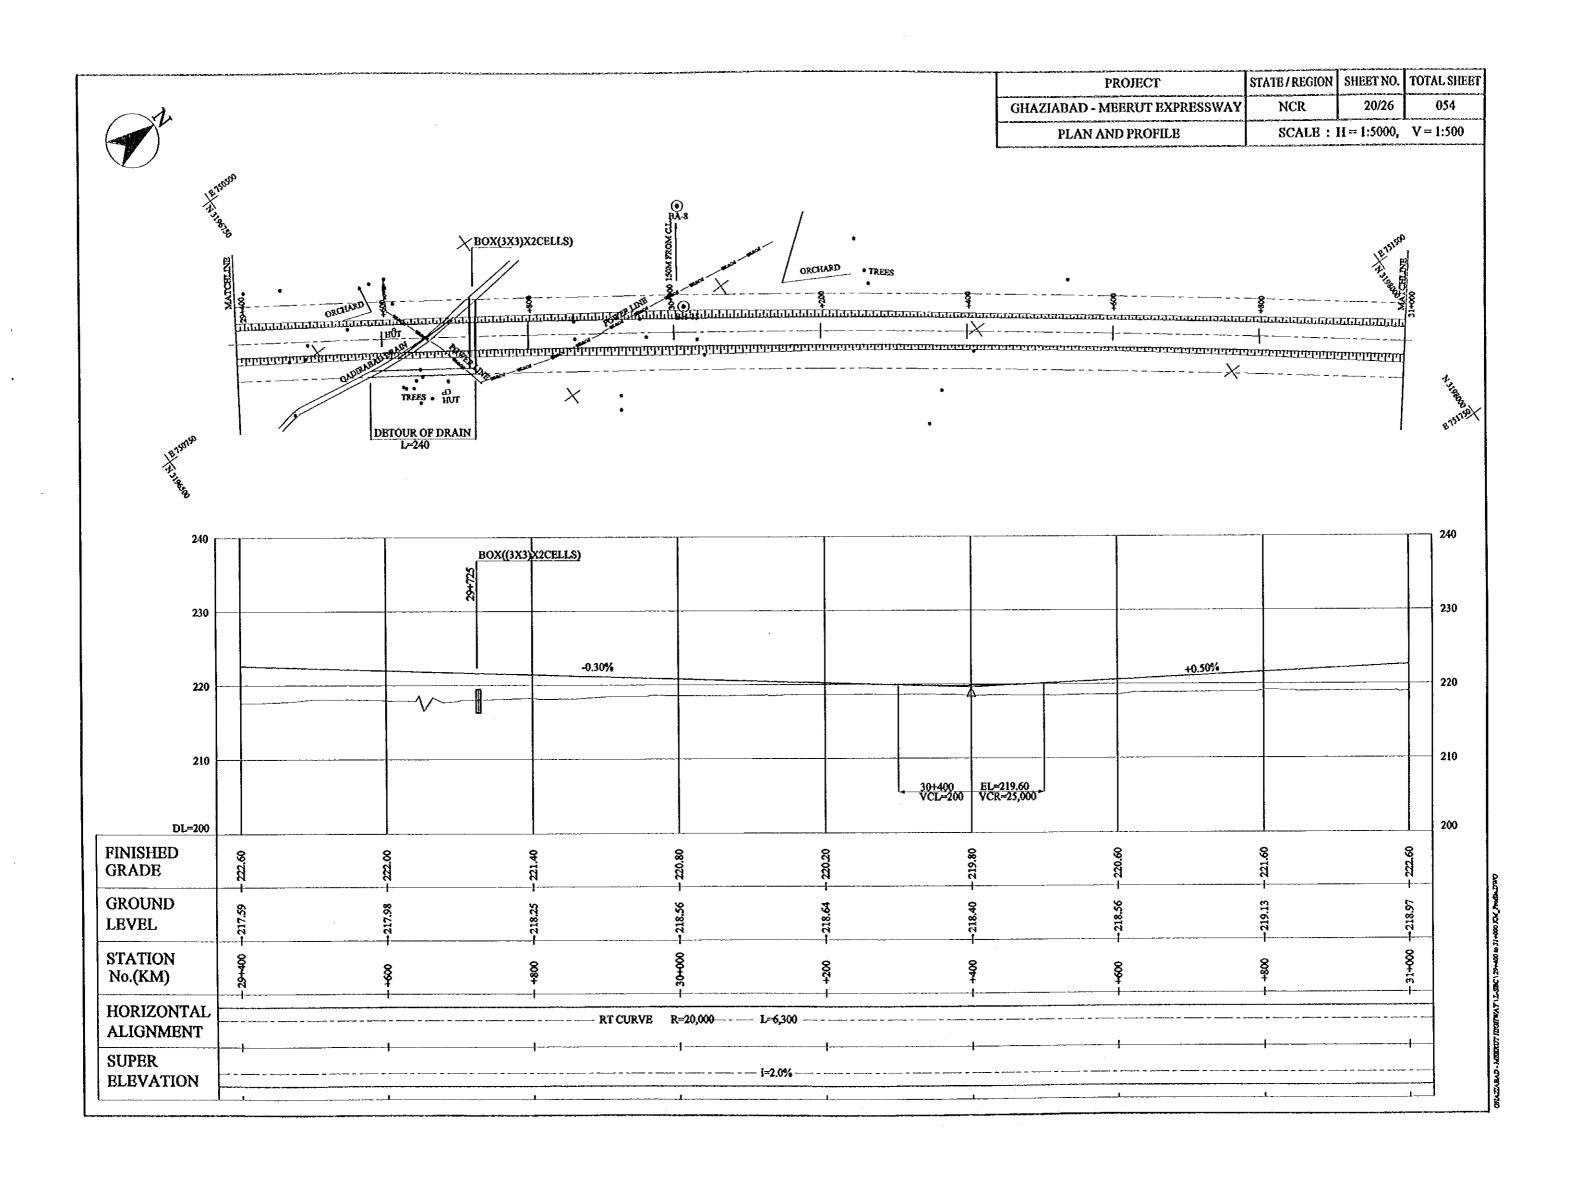

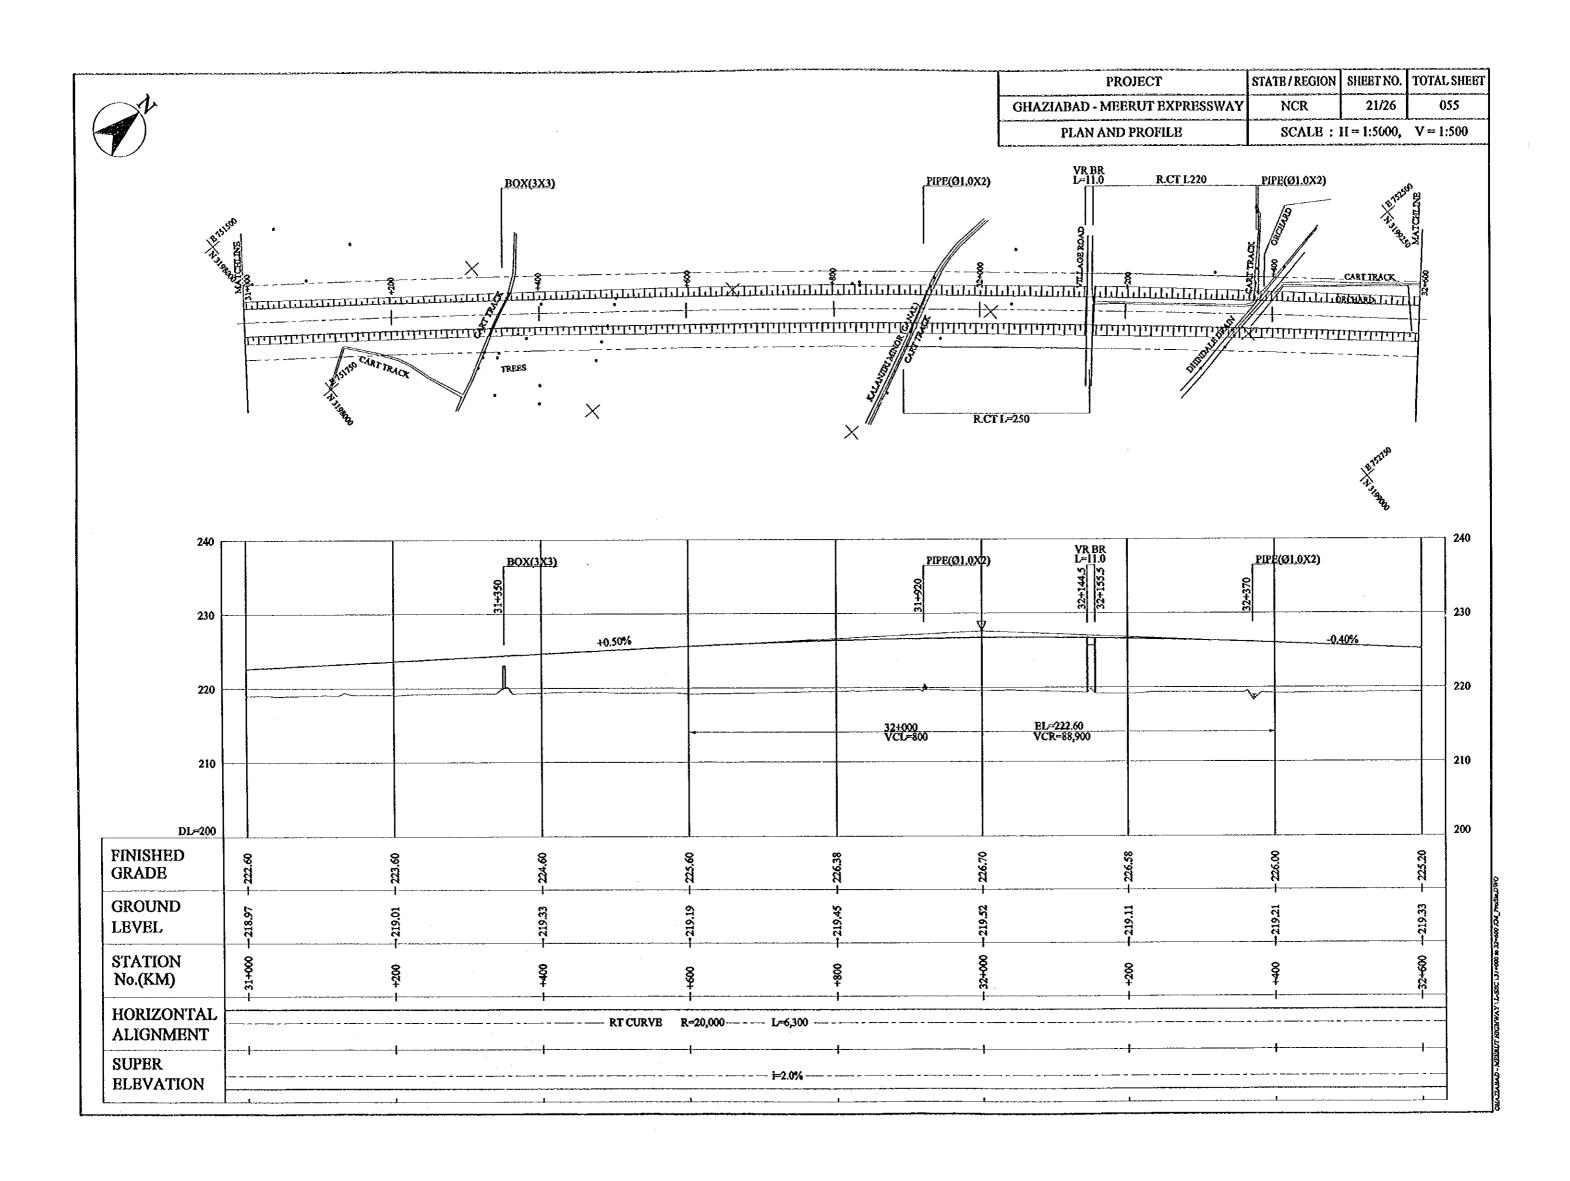

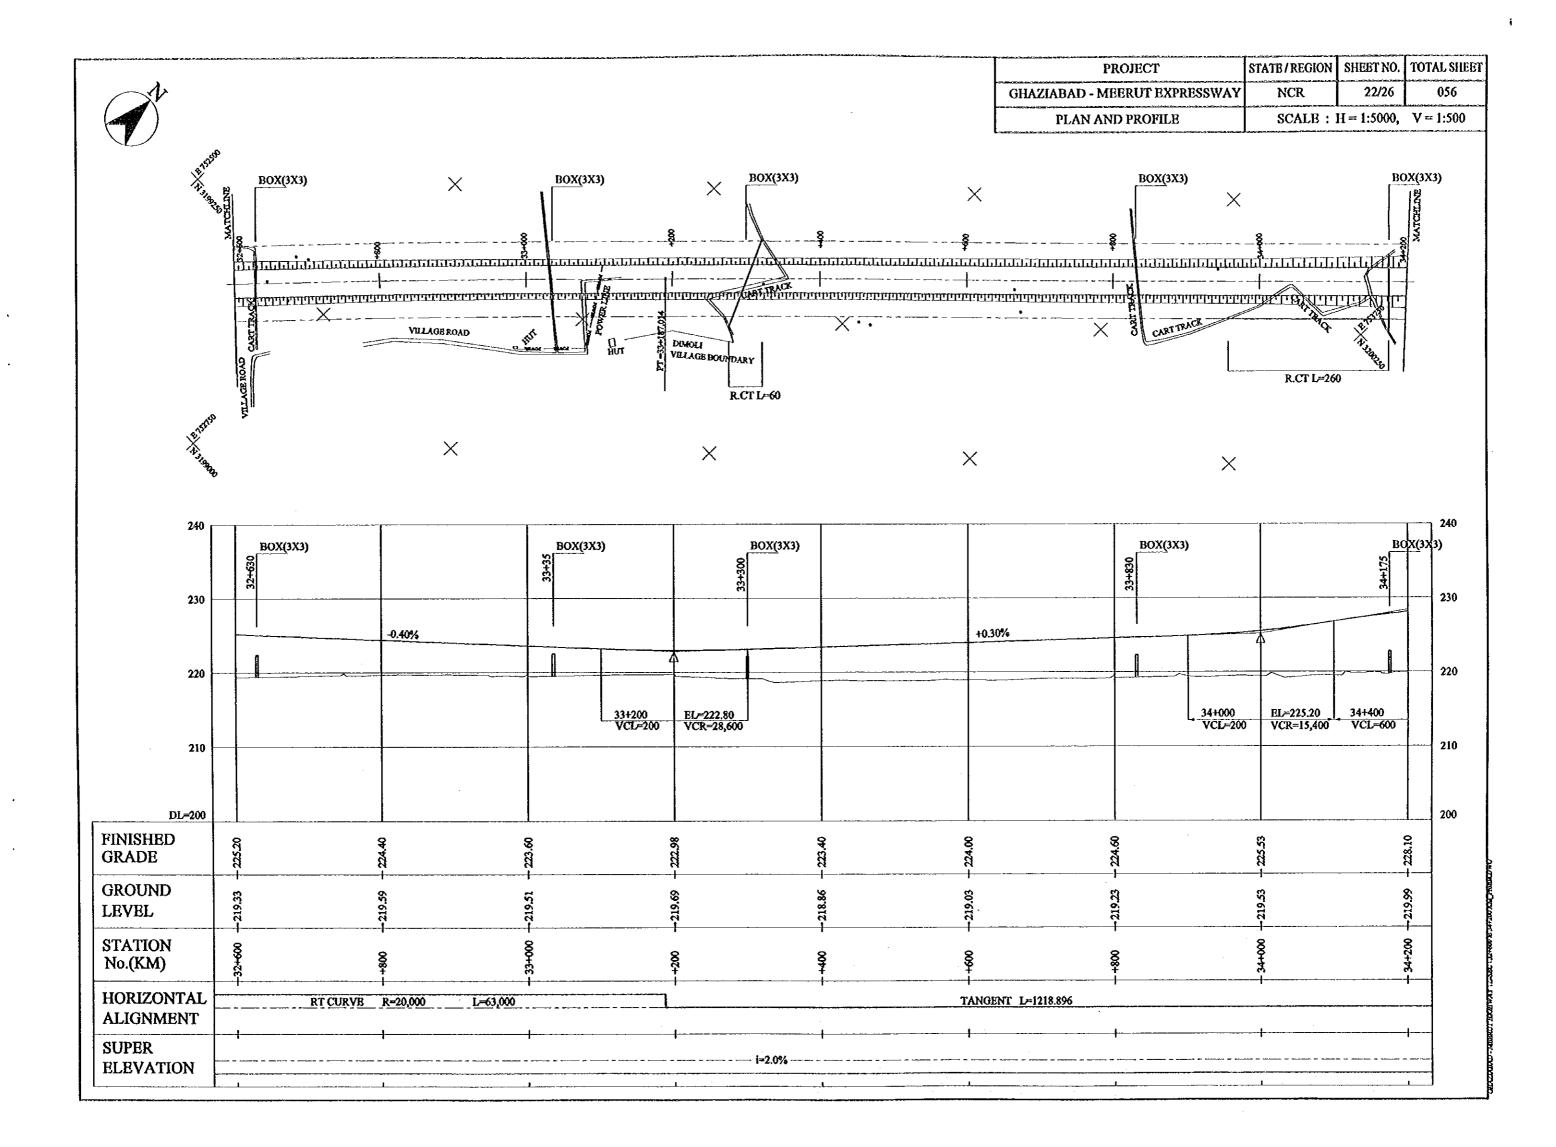

240

230

220

210

DL=200

228.10

**FINISHED** 

GROUND LEVEL


STATION No.(KM)


SUPER


HORIZONTAL ALIGNMENT


**ELEVATION** 


GRADE

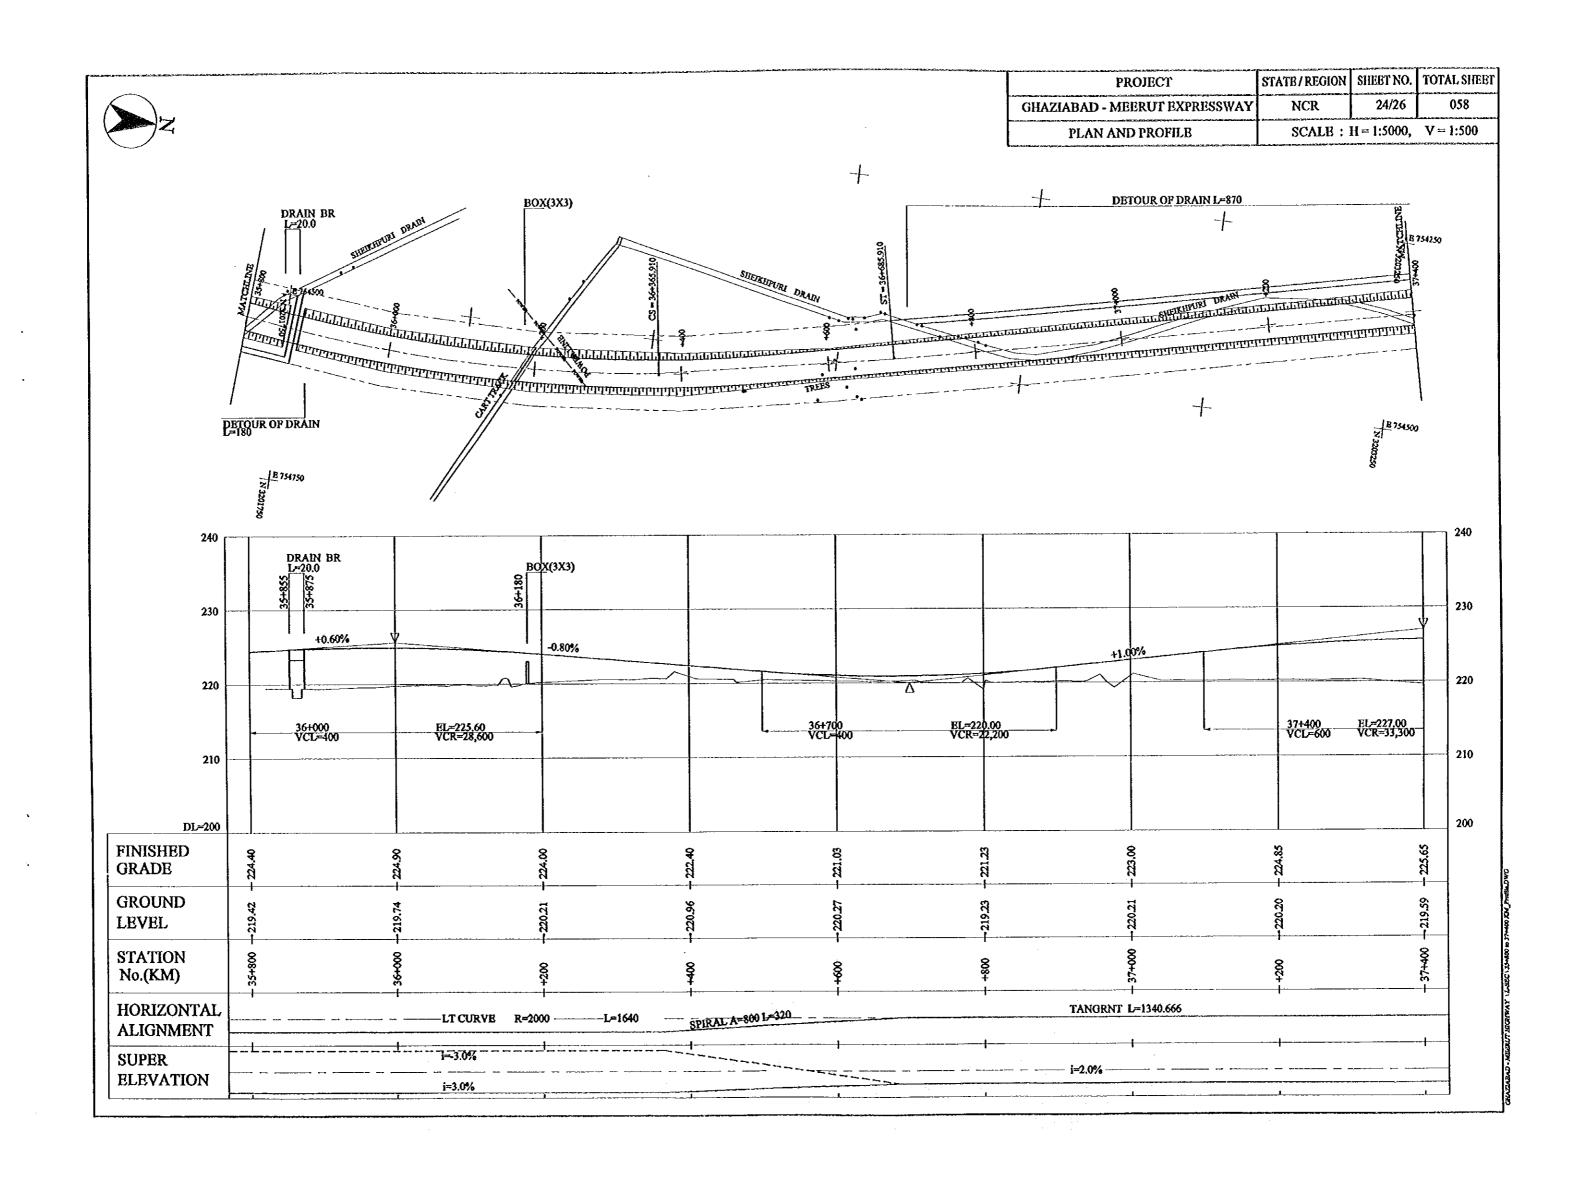


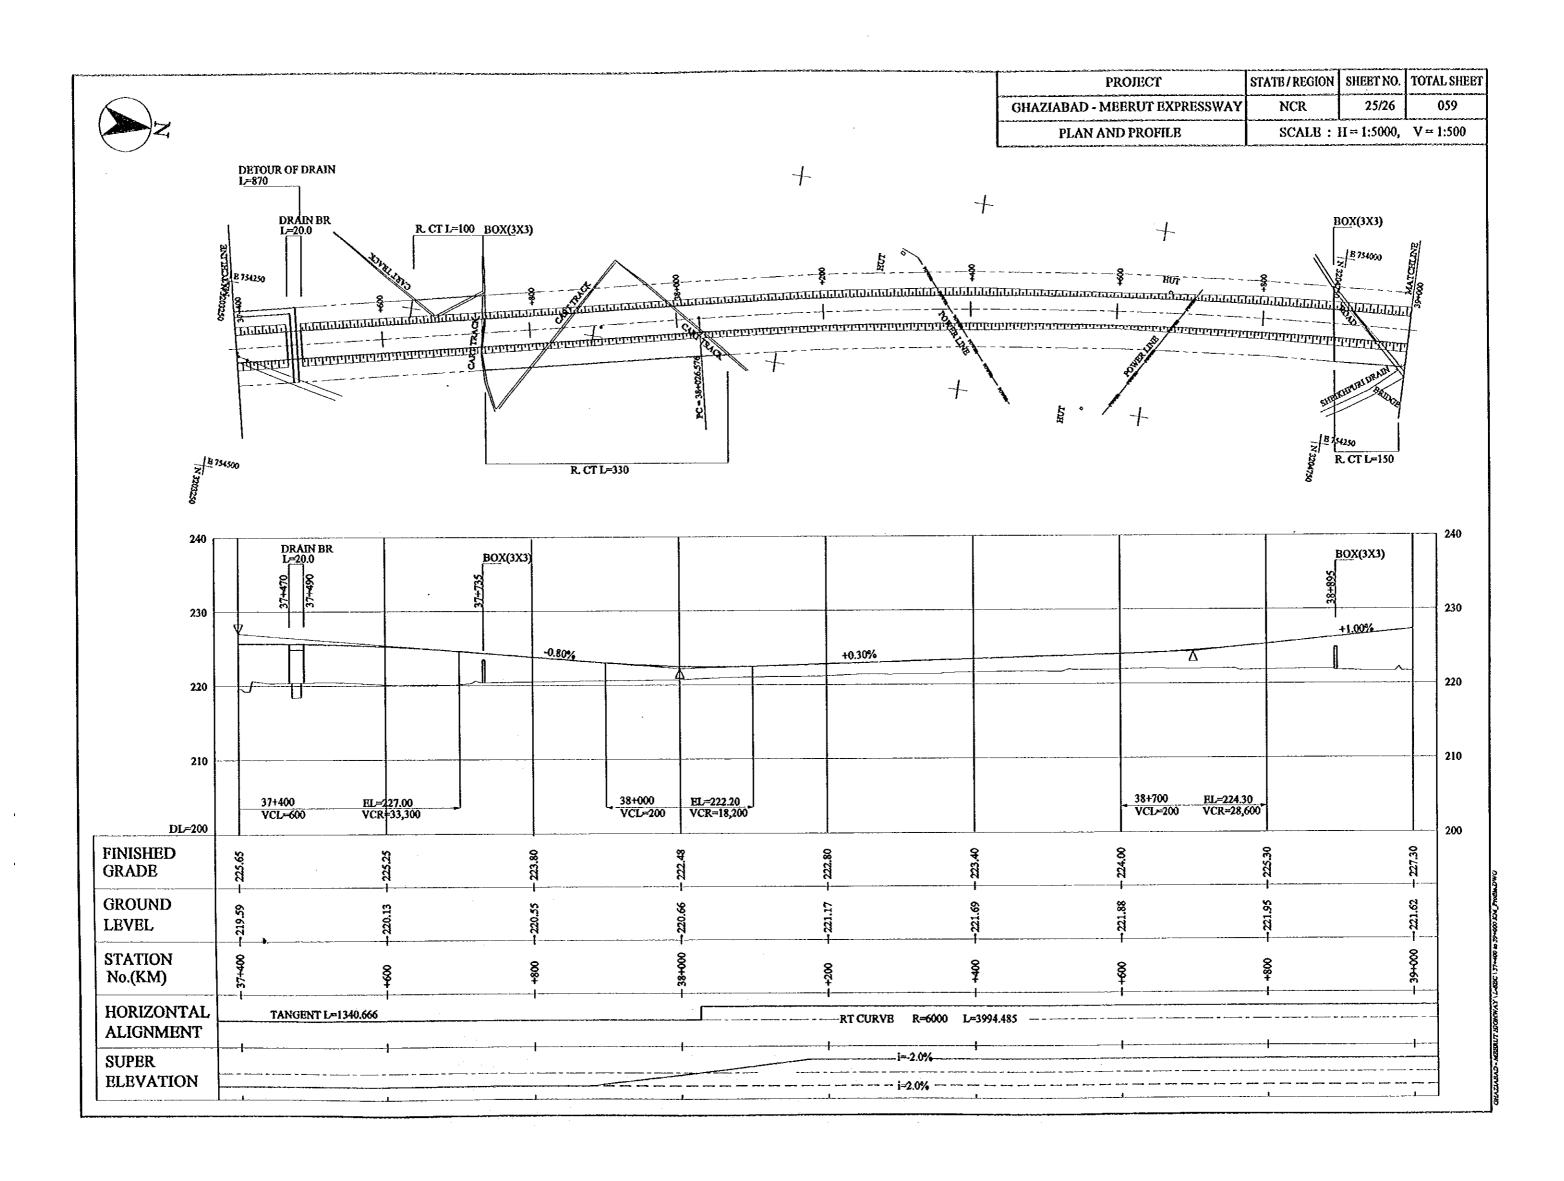


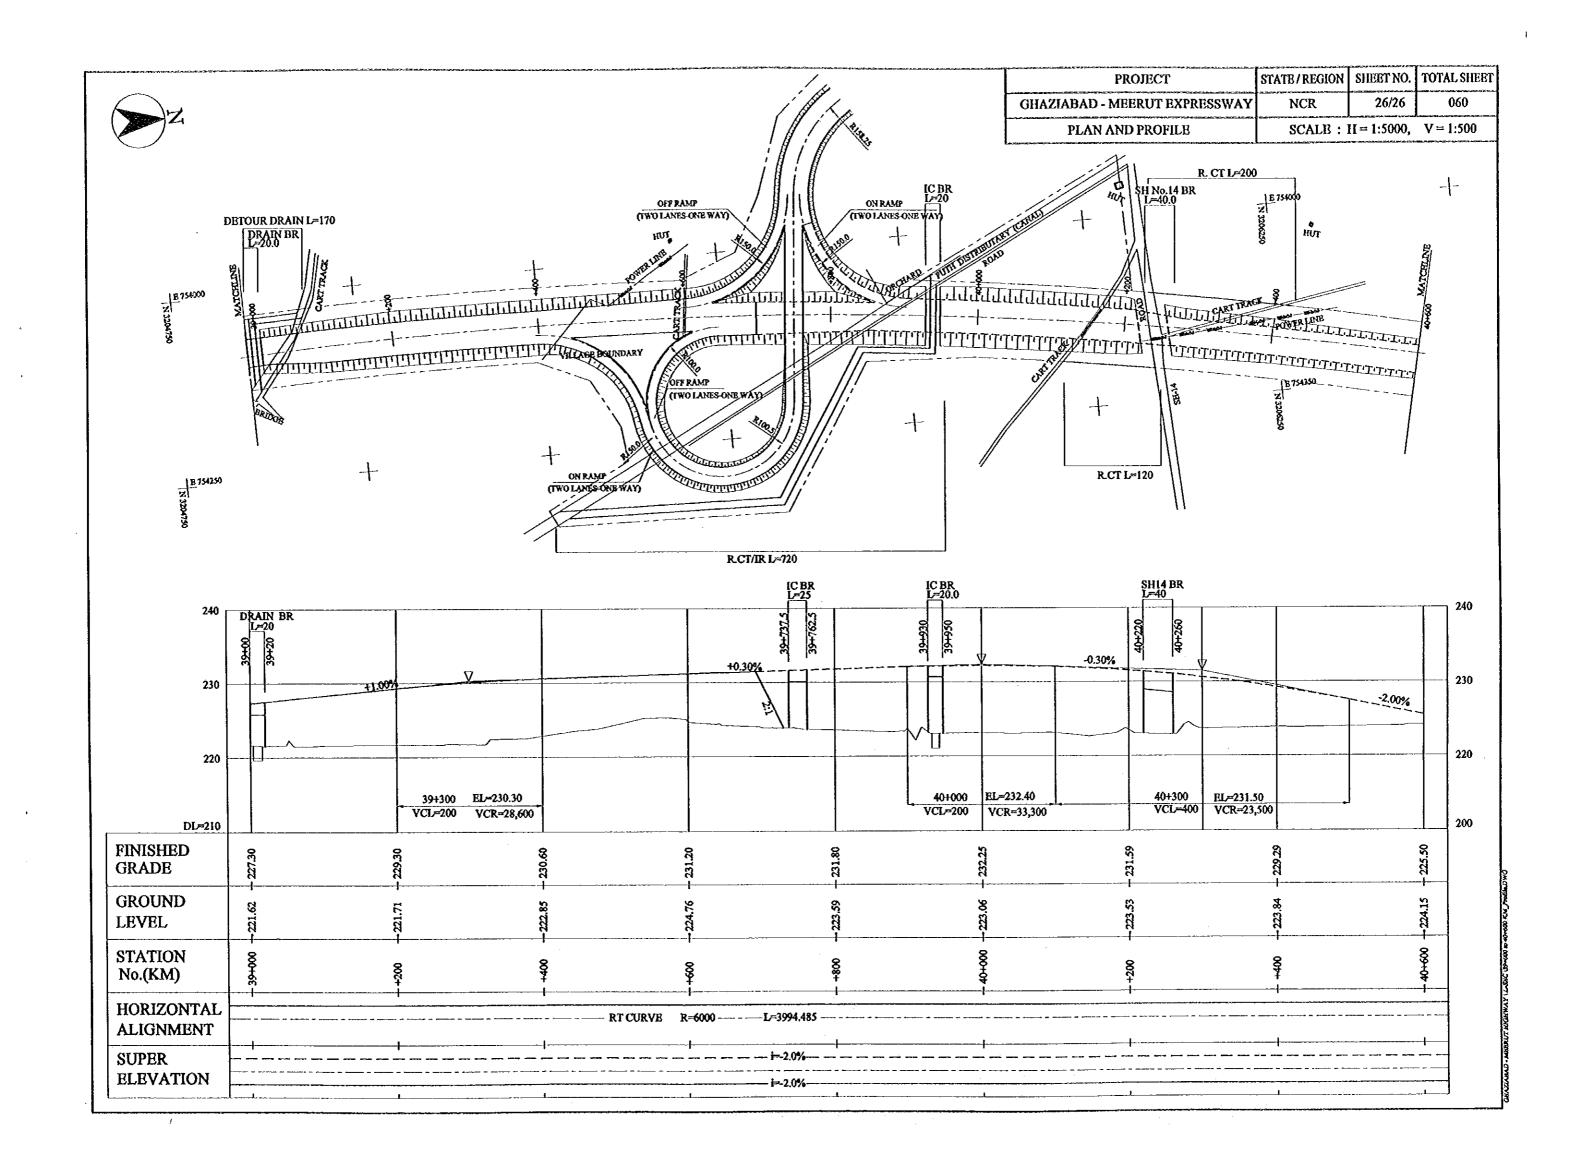


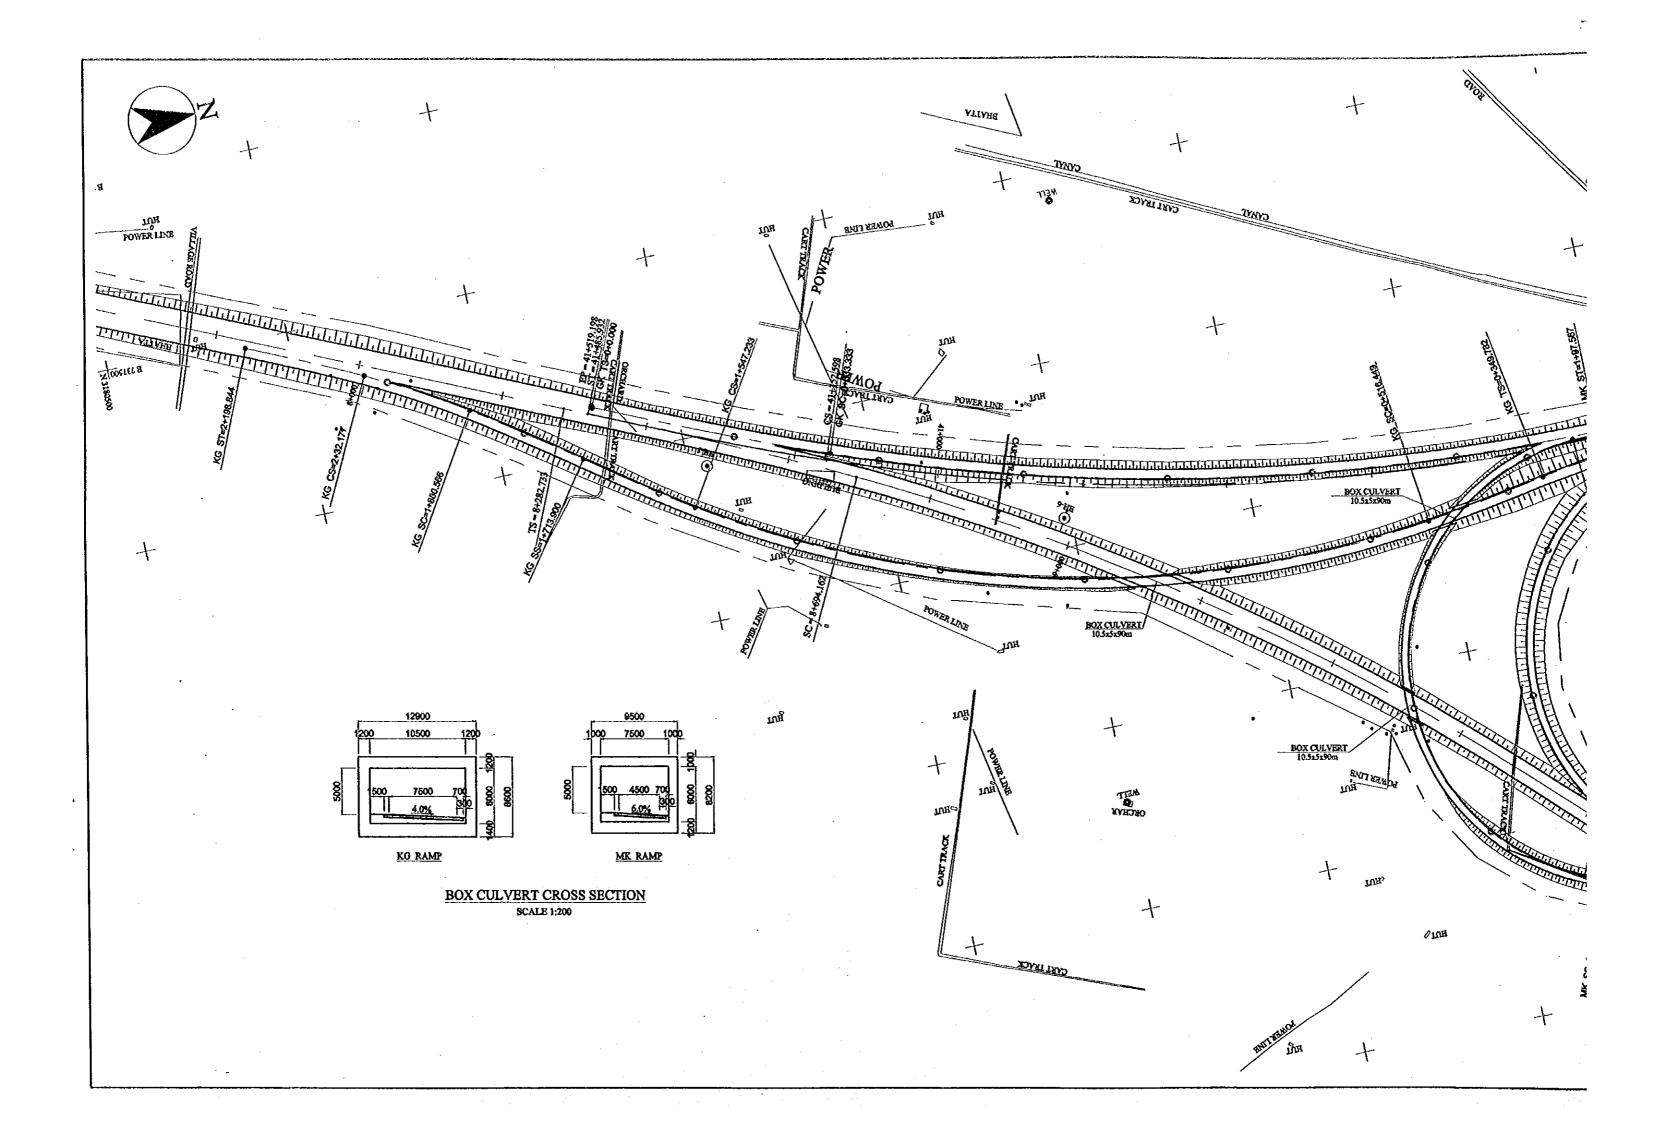


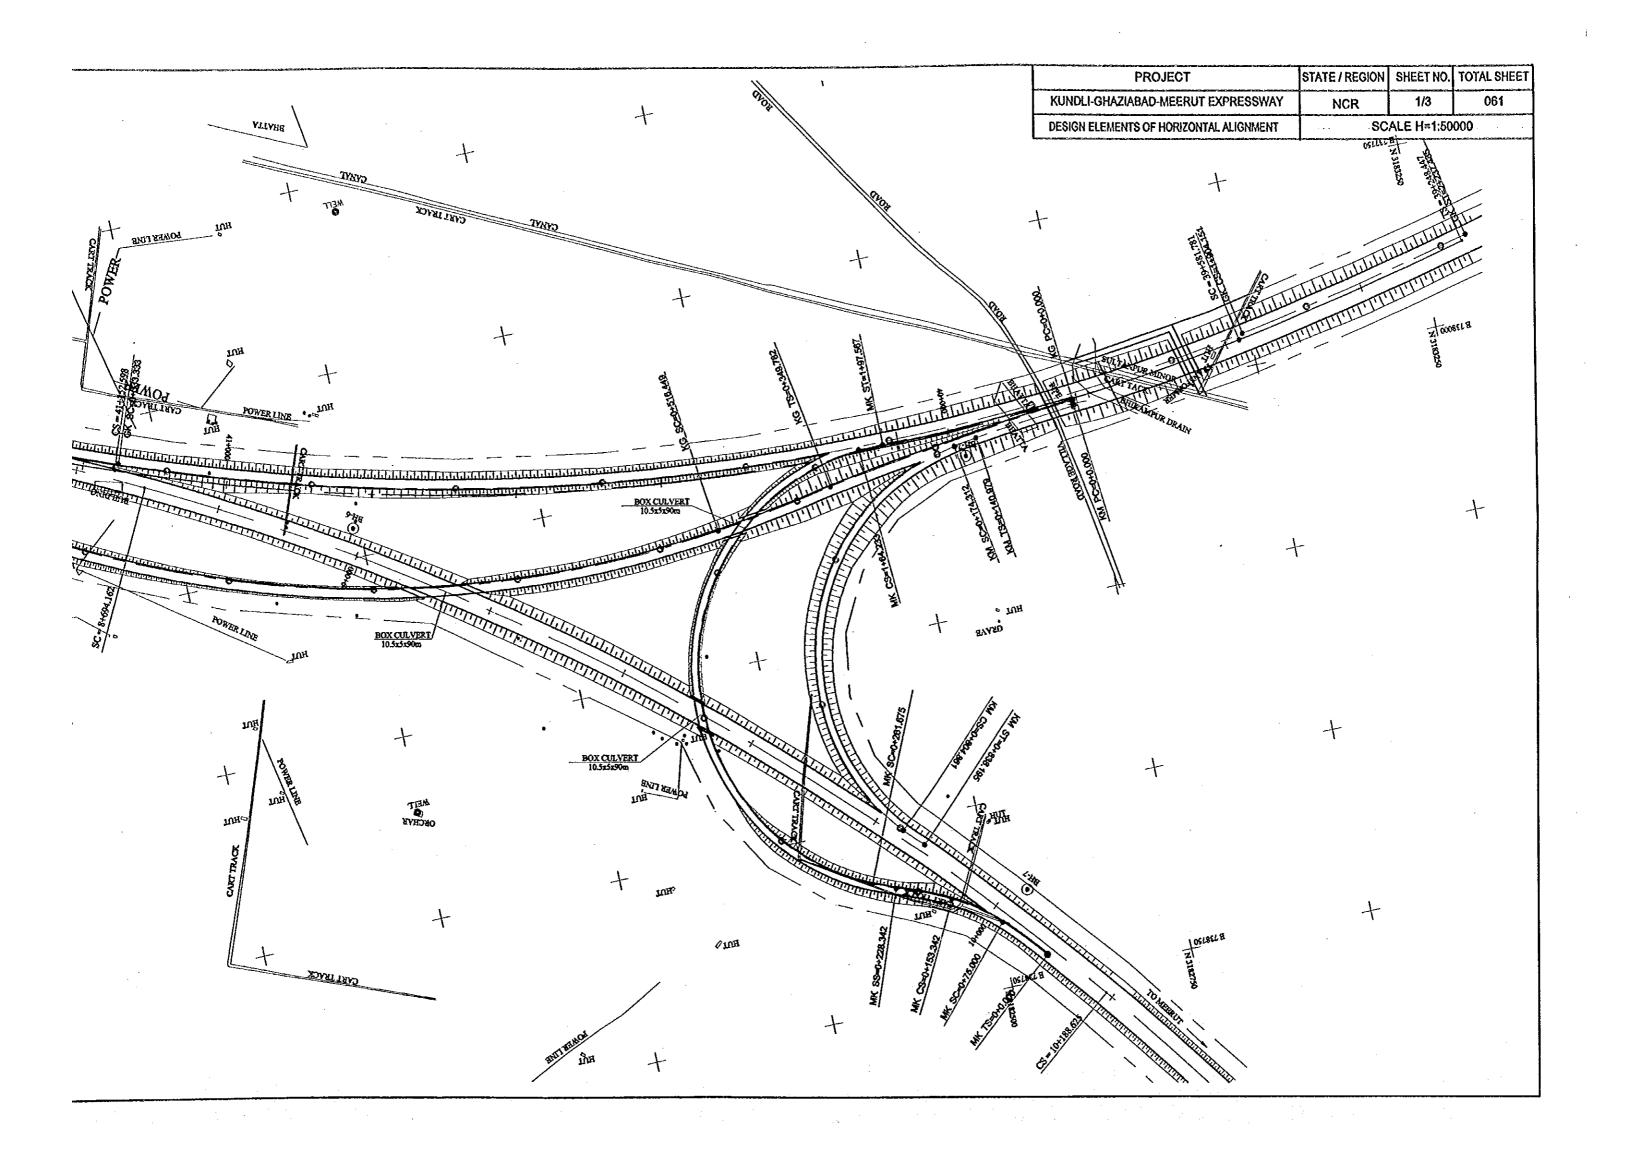


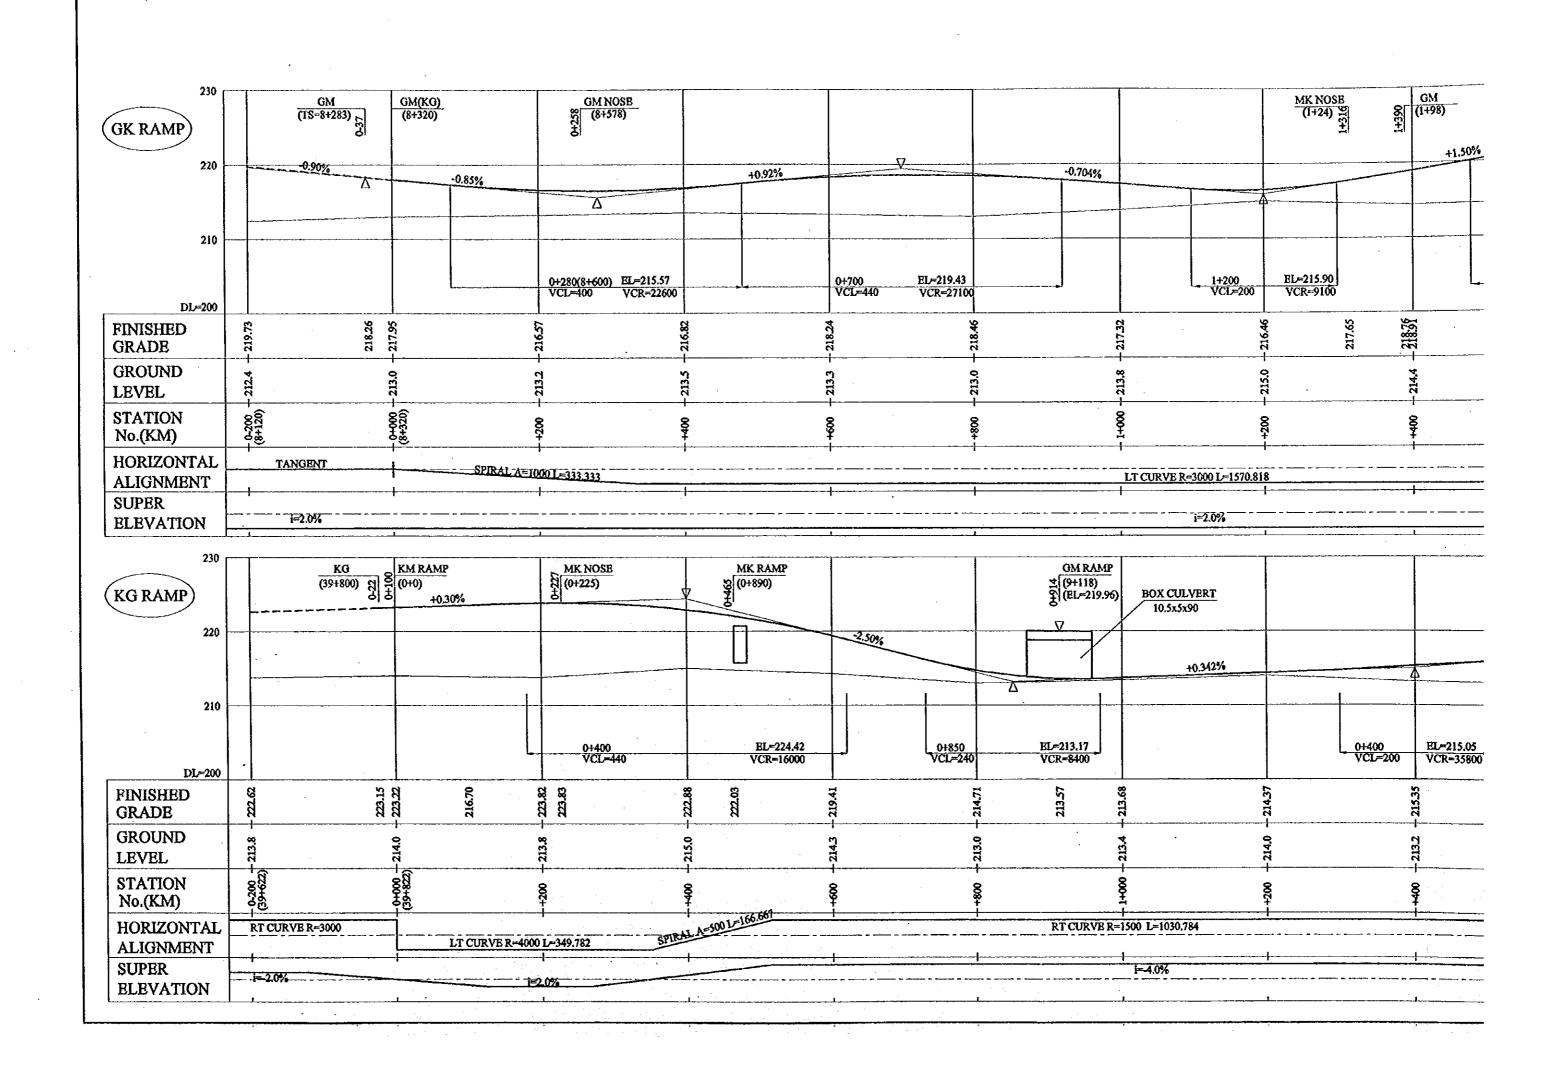


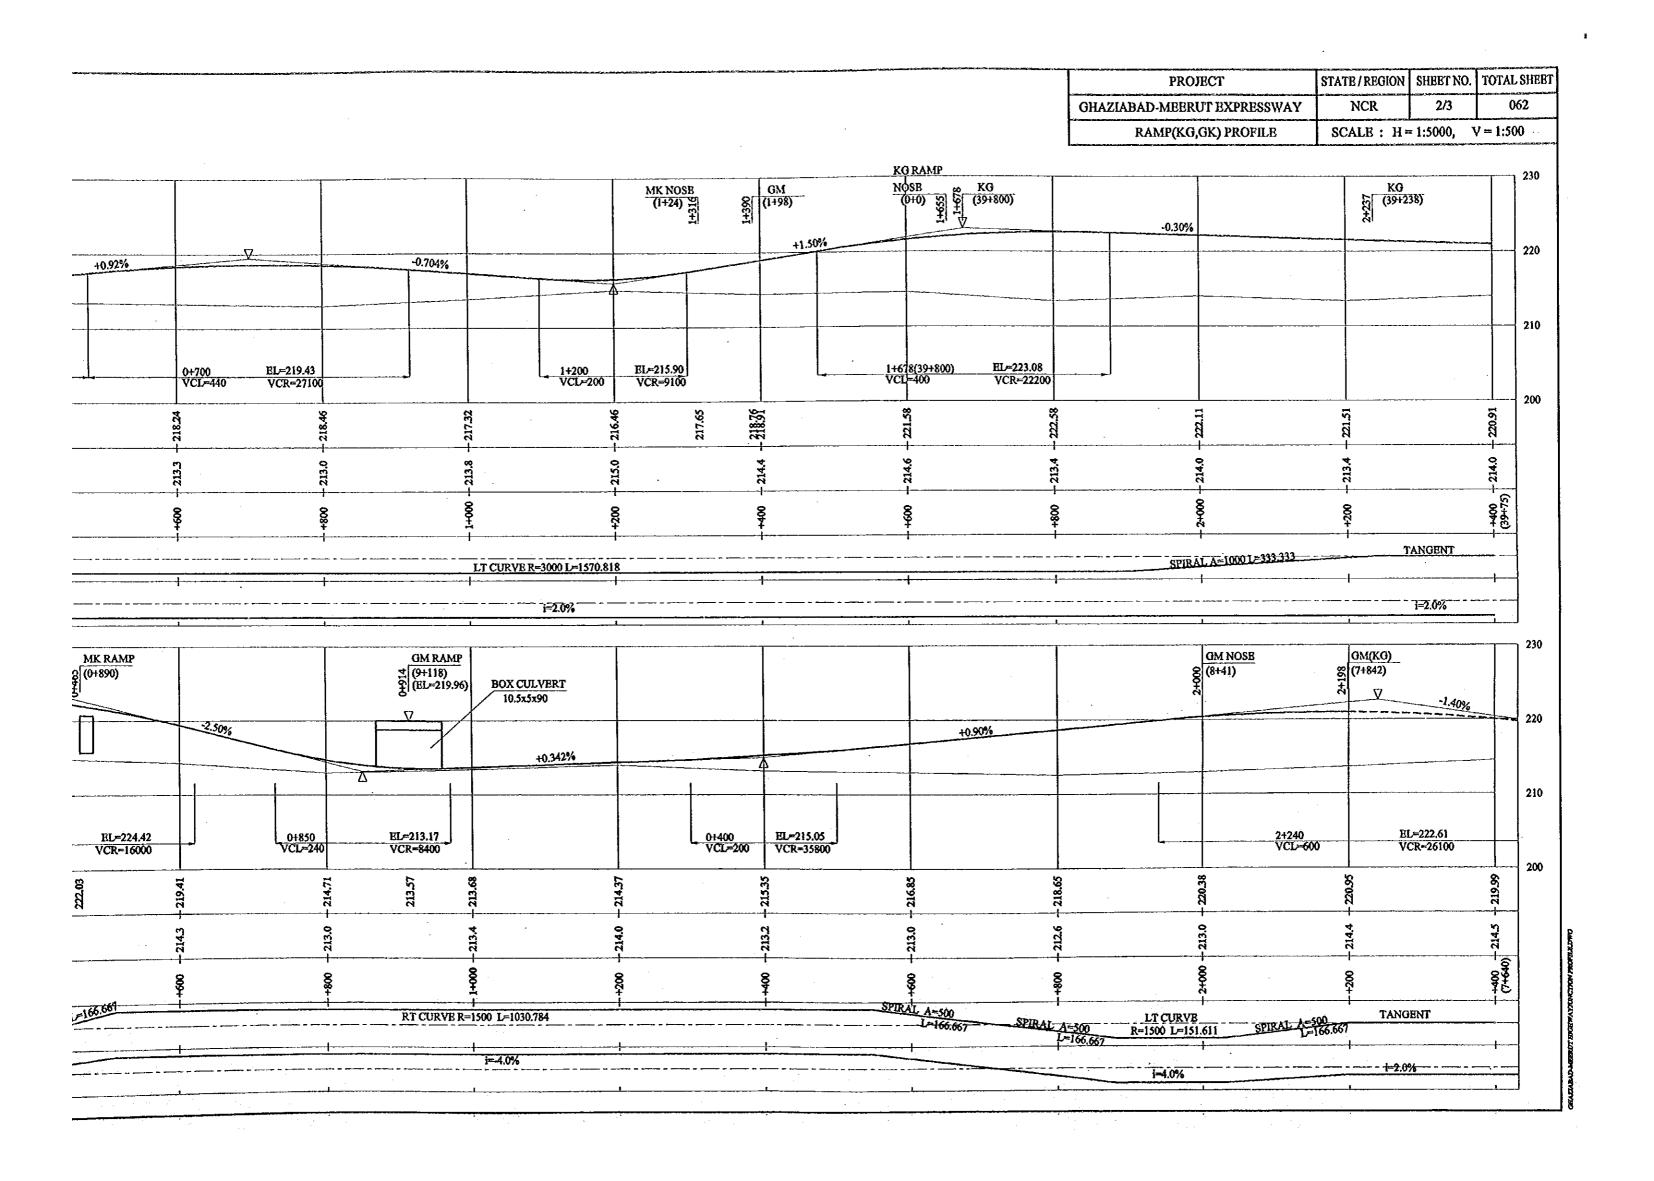


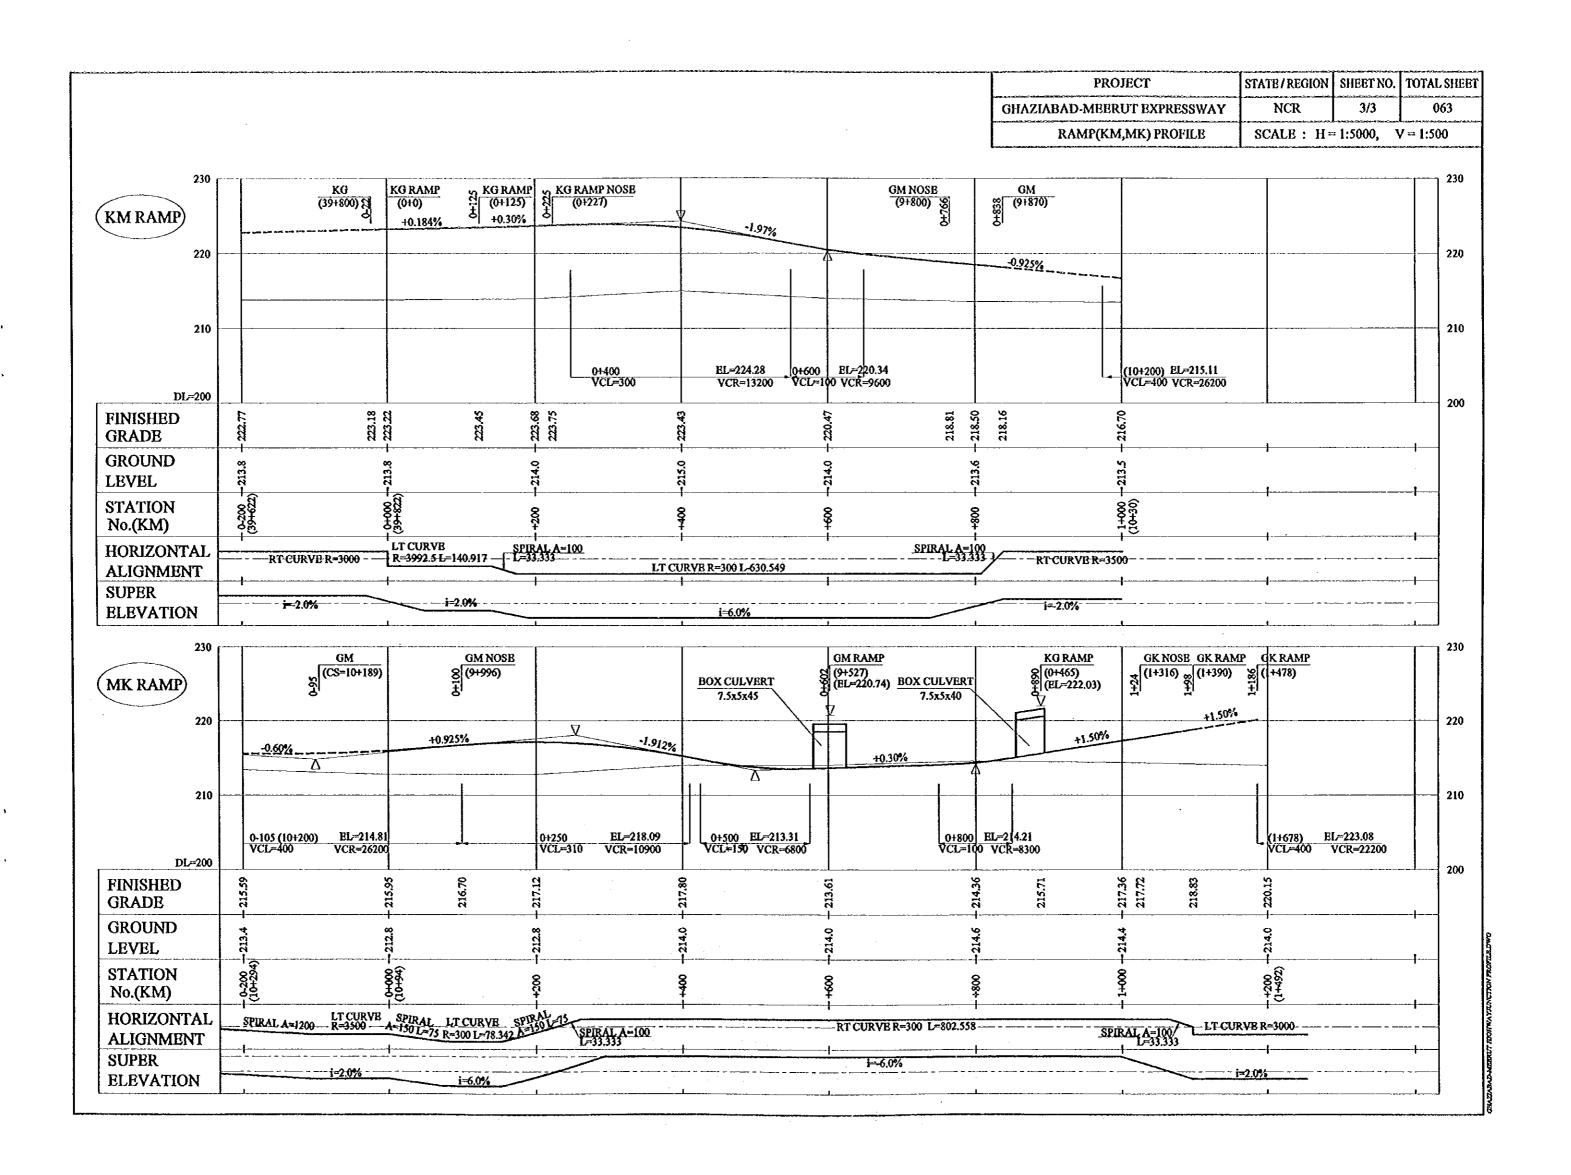


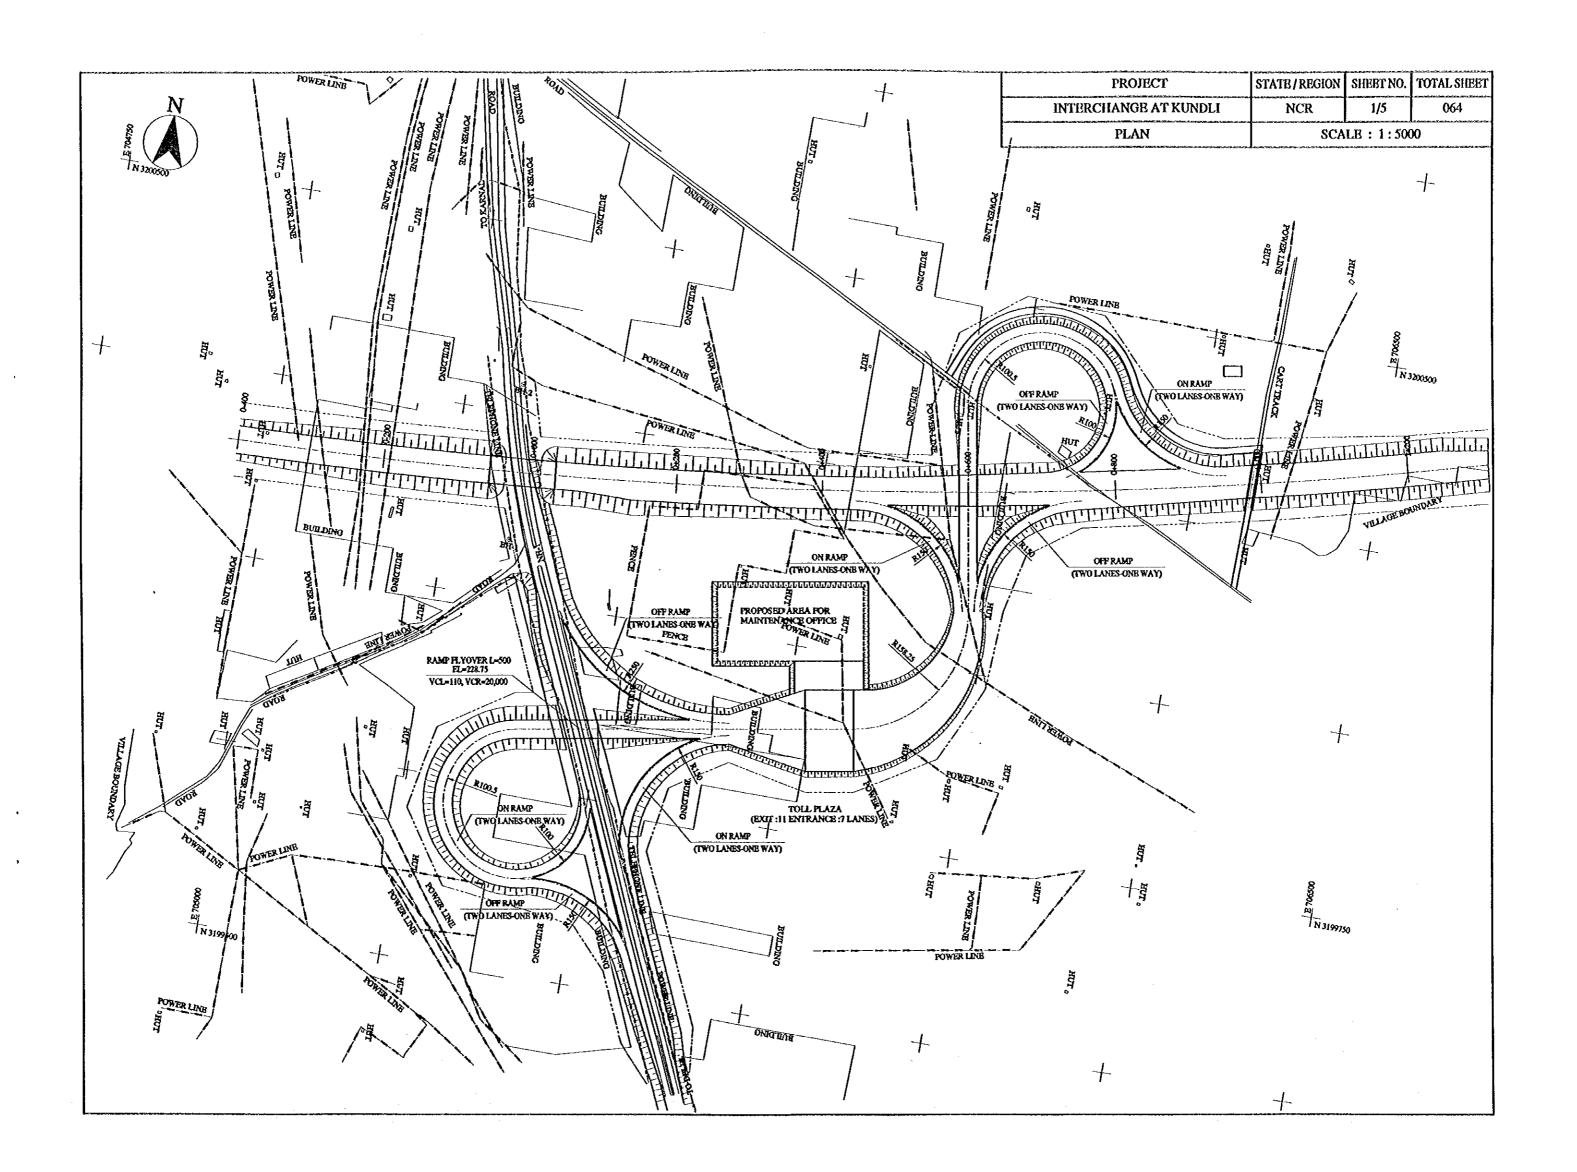


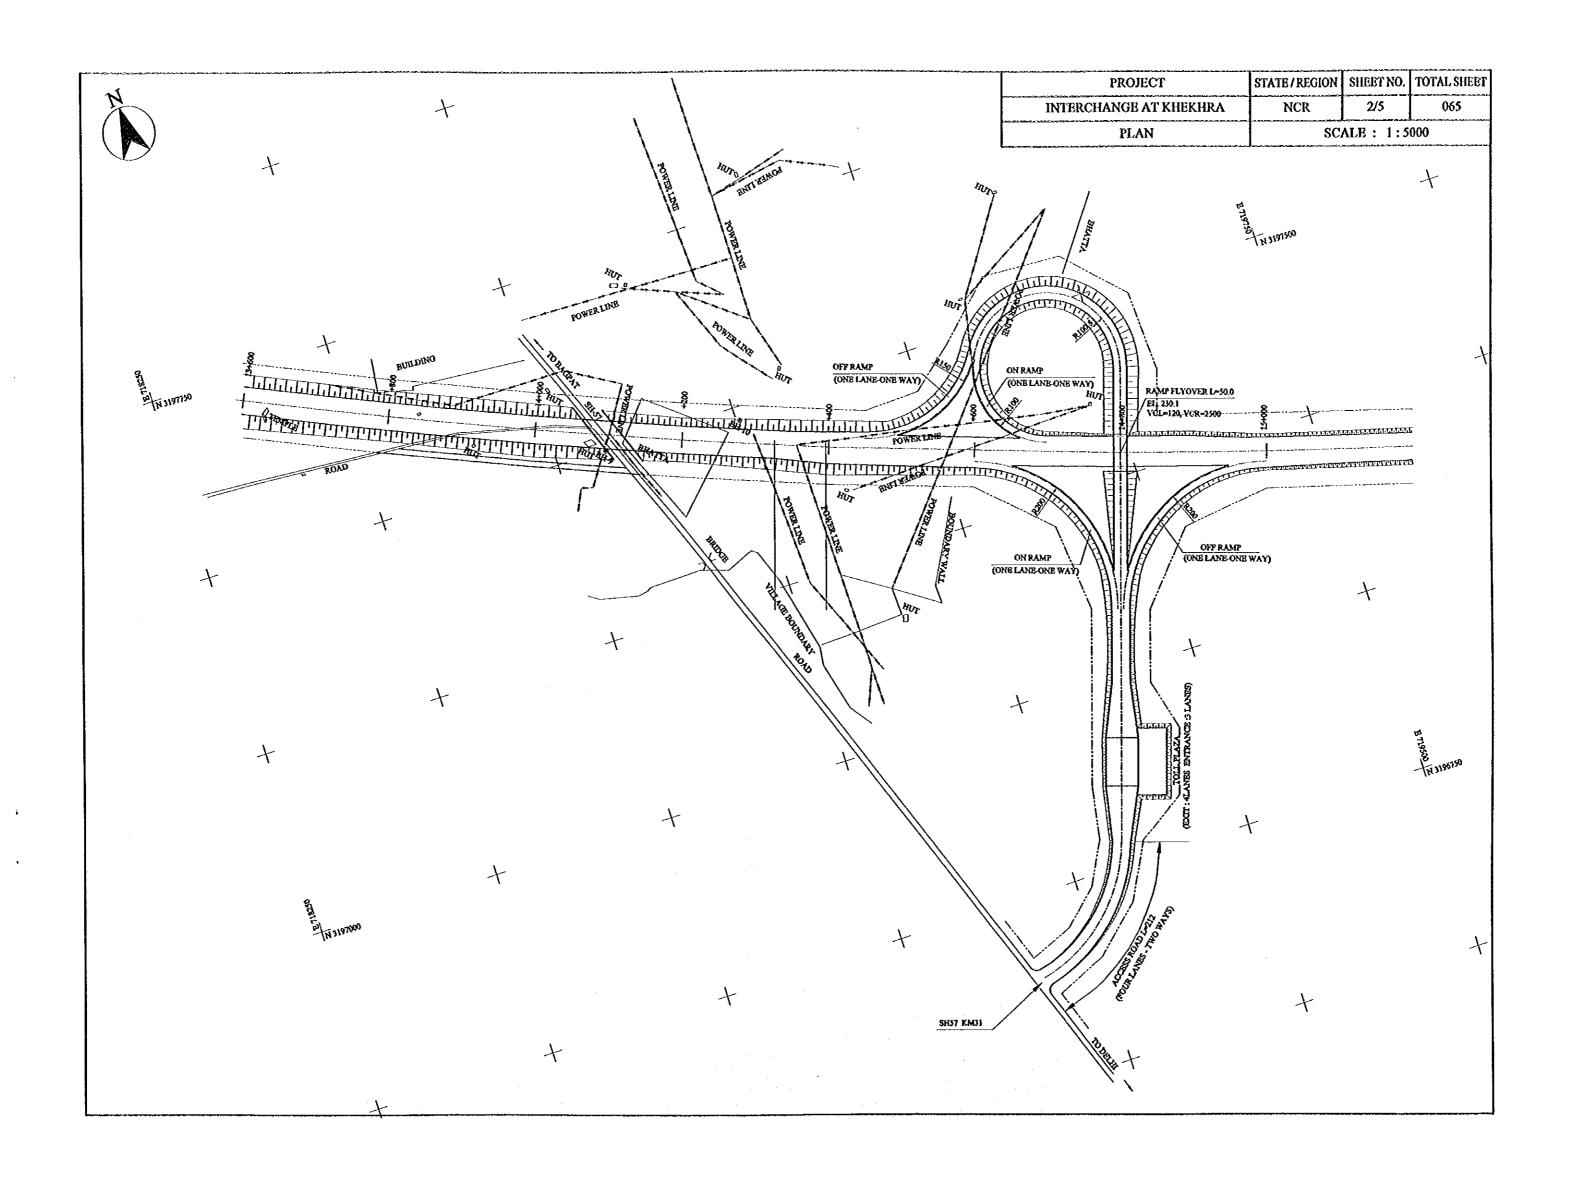

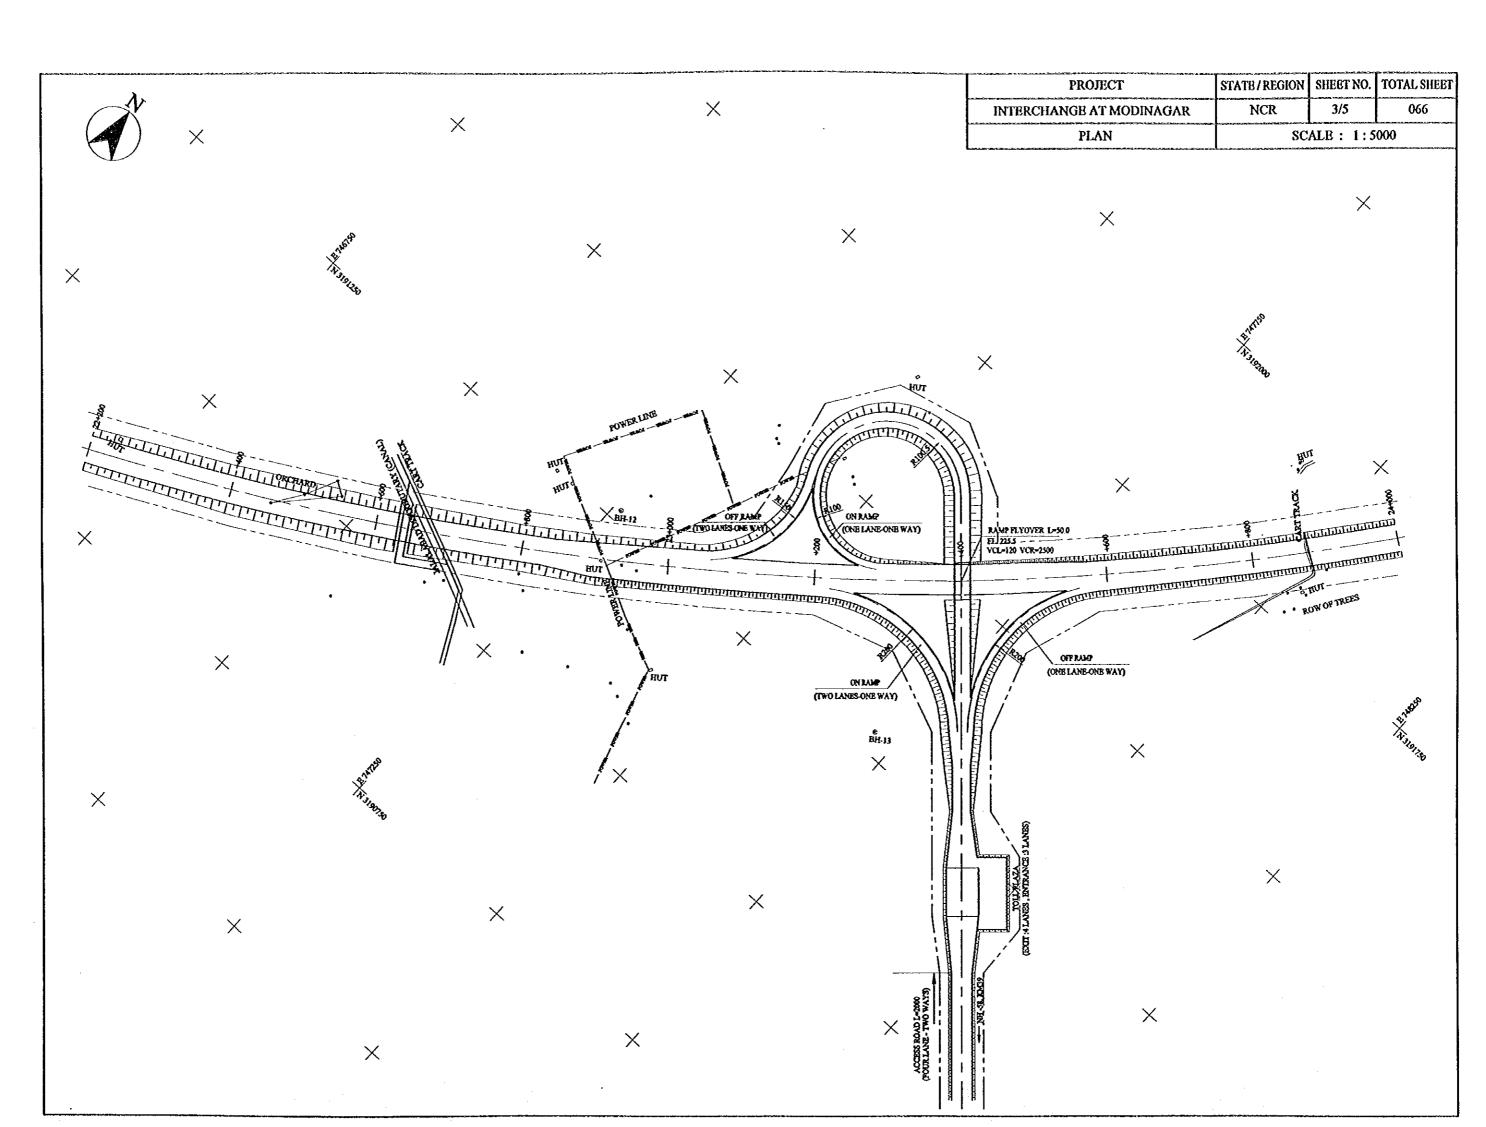

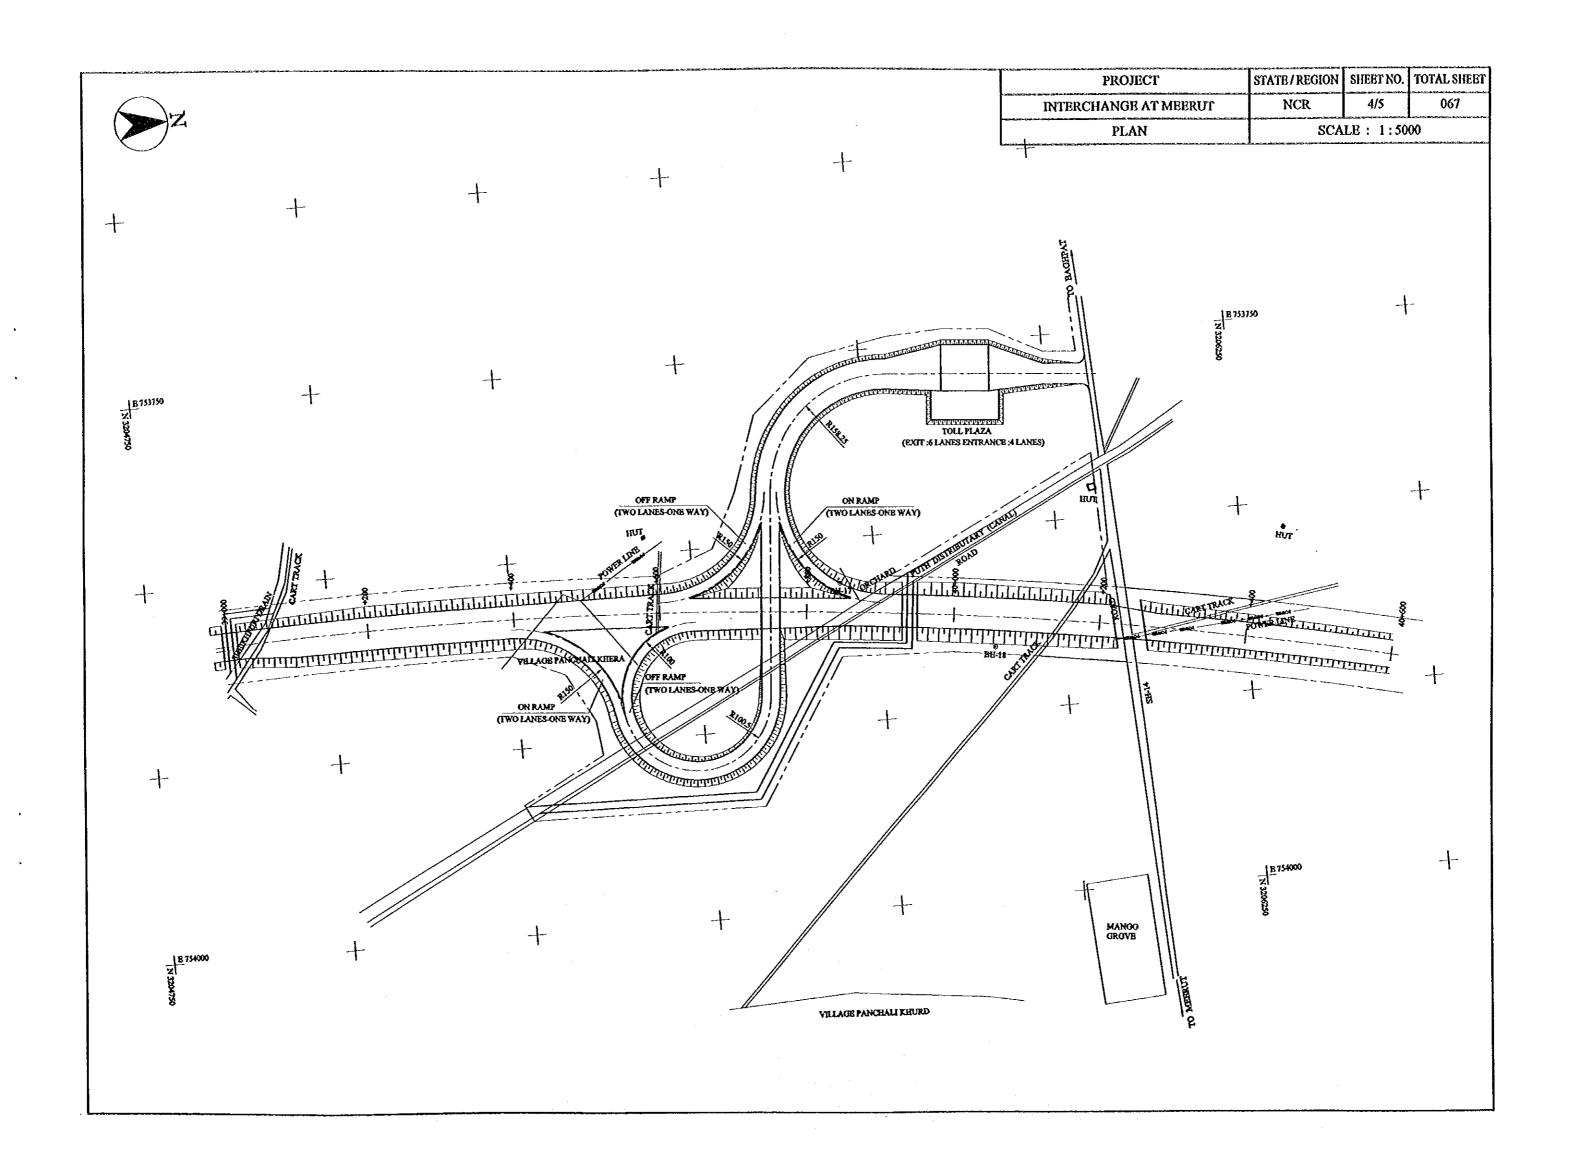


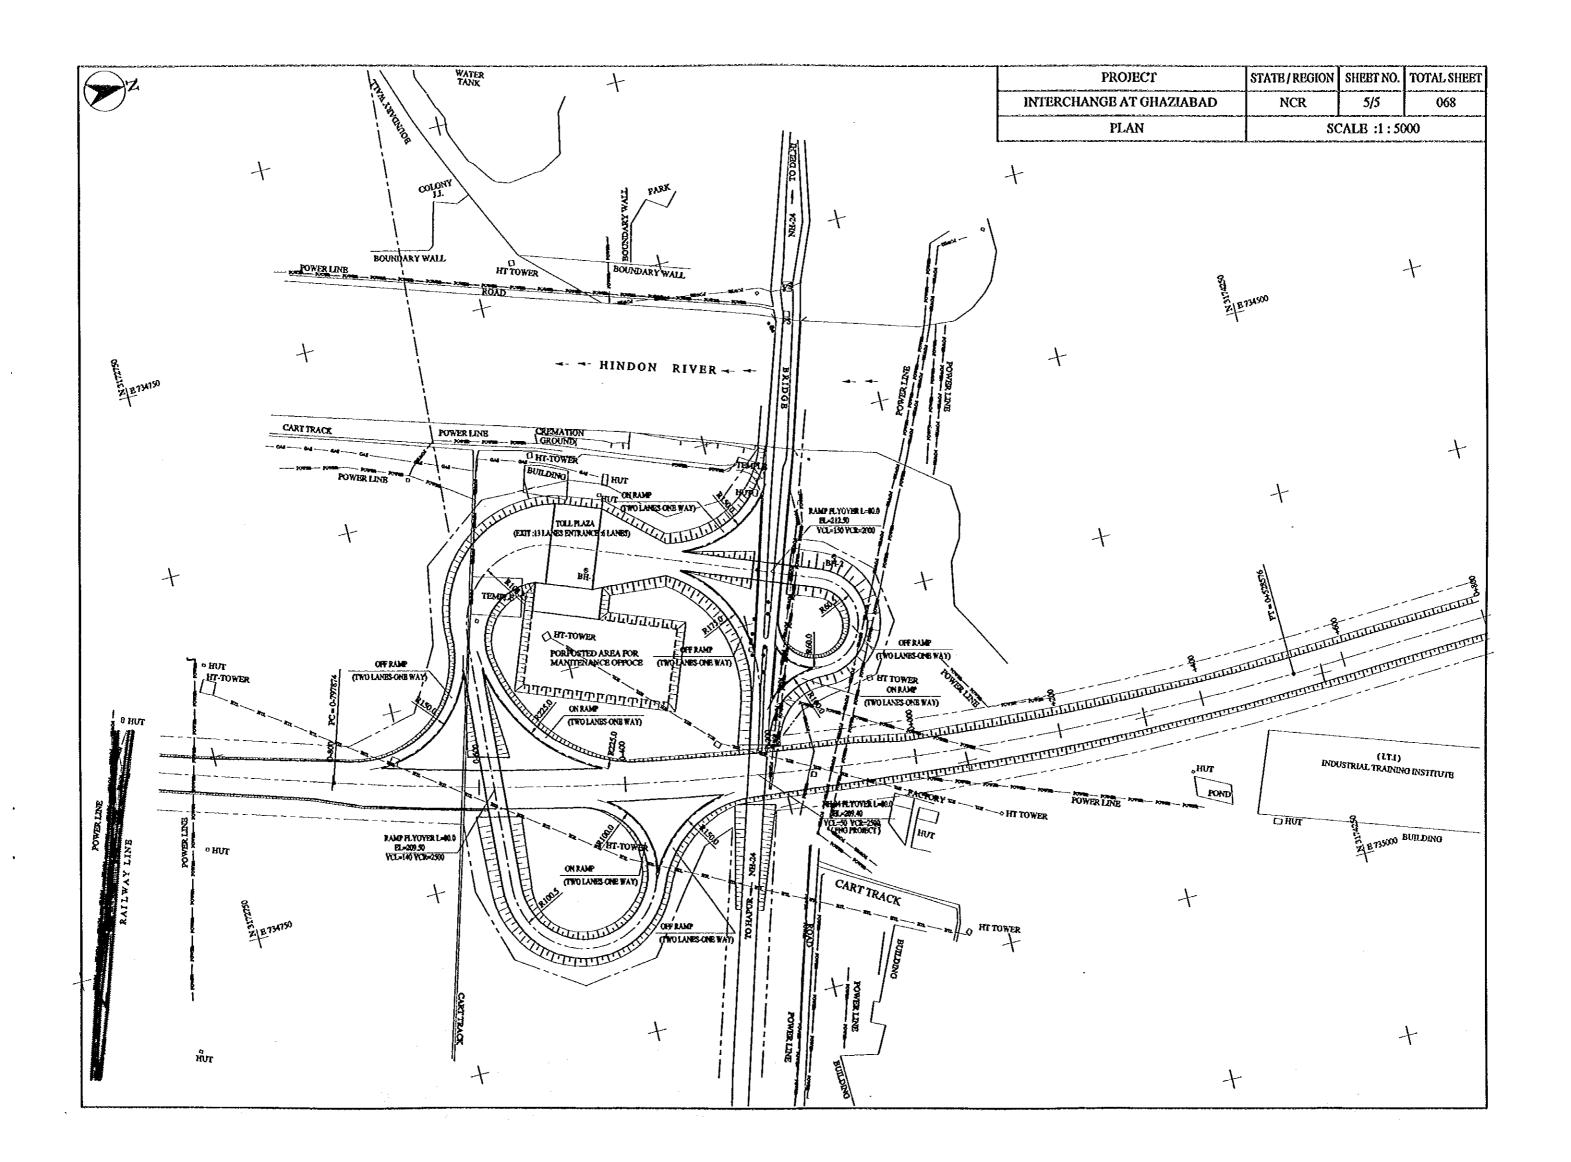

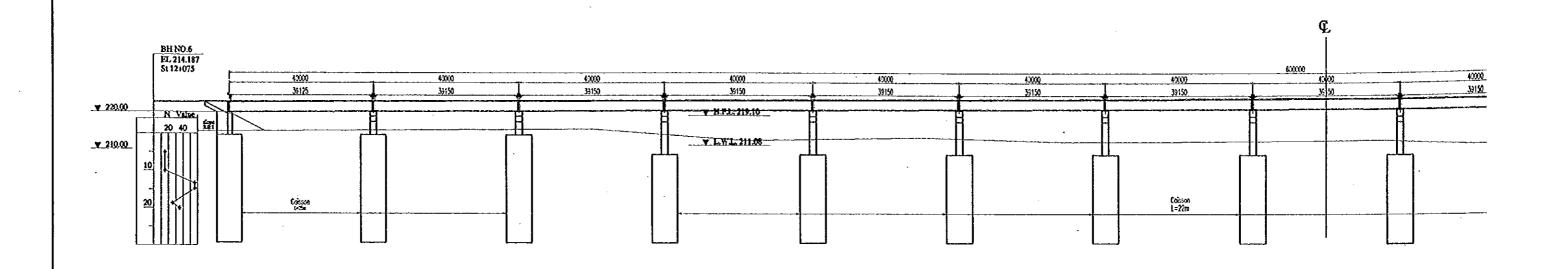



VERTICAL ALIGNMENT		· · · · · · · · · · · · · · · · · · ·		1					0.300%		 			(g)		
VERTICAL CURVE LENGTH	0000		800:0	-0.0125	-0.0125	2007	, 11, 11,	0.1125	8278	-0200	E C		V1=517a	¥ WX=100,000m	03920	
FINISHED GRADE	8777			<b>-</b>	222.80	753.04			<del> </del>	223.09			223.13		133.23	
GROUND LEVEL	- 214.85			<del></del>				12.30		213.167	<u> </u>	212.036	1	1 212.483		211.322
STATION NUMBER	- 12+300		- 12+340	- 124350	088-51 -	12450	!	12442	1.27460	12+500	12,4550	12*280	- 12+580	124605	-1 029-23	- 12-640 -

PROFILE SCALE: 1:500

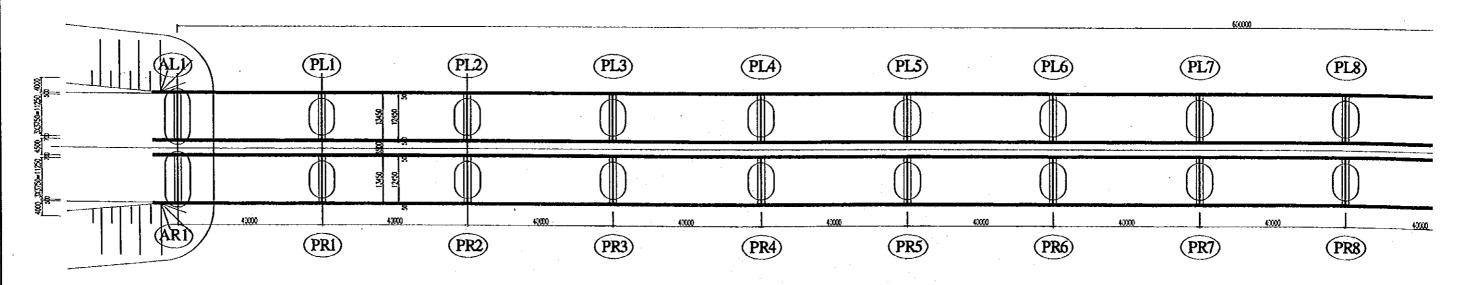


PLAN SCALE: 1:500

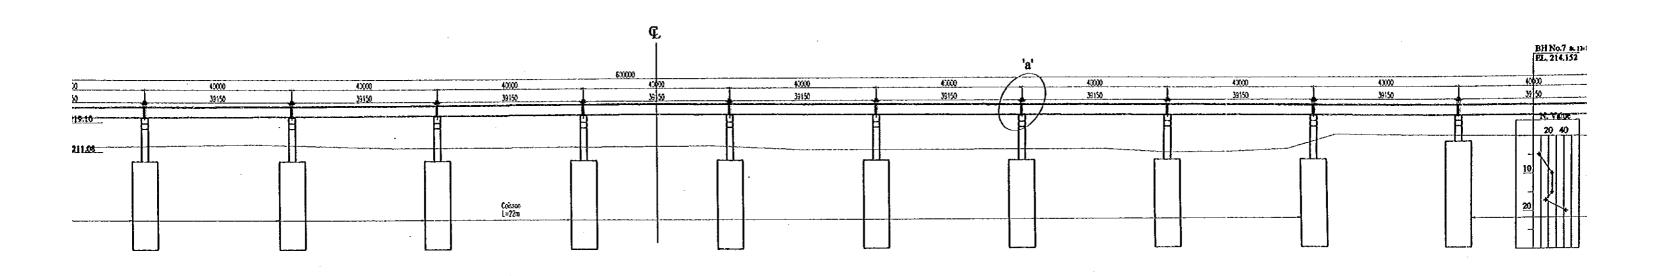


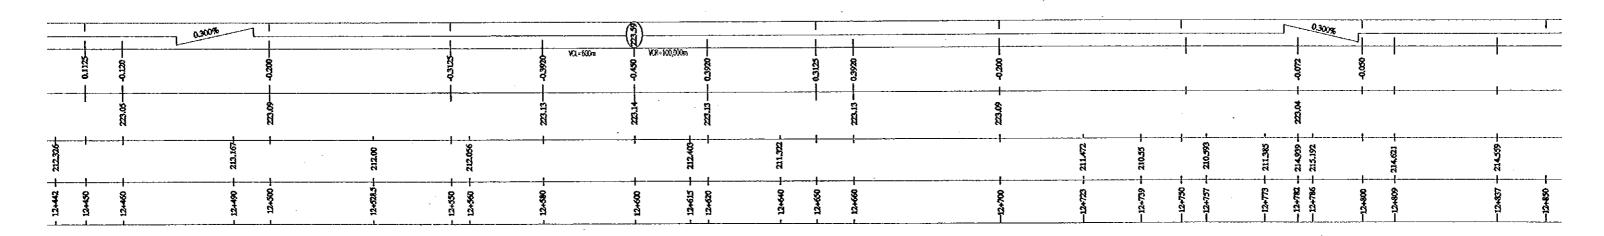



PROFILE SCALE: 1:500

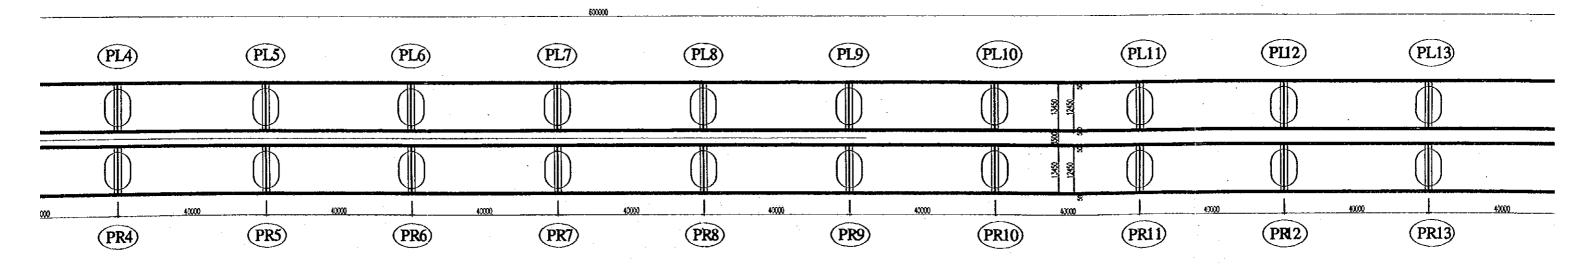


PLAN SCALE: 1:500

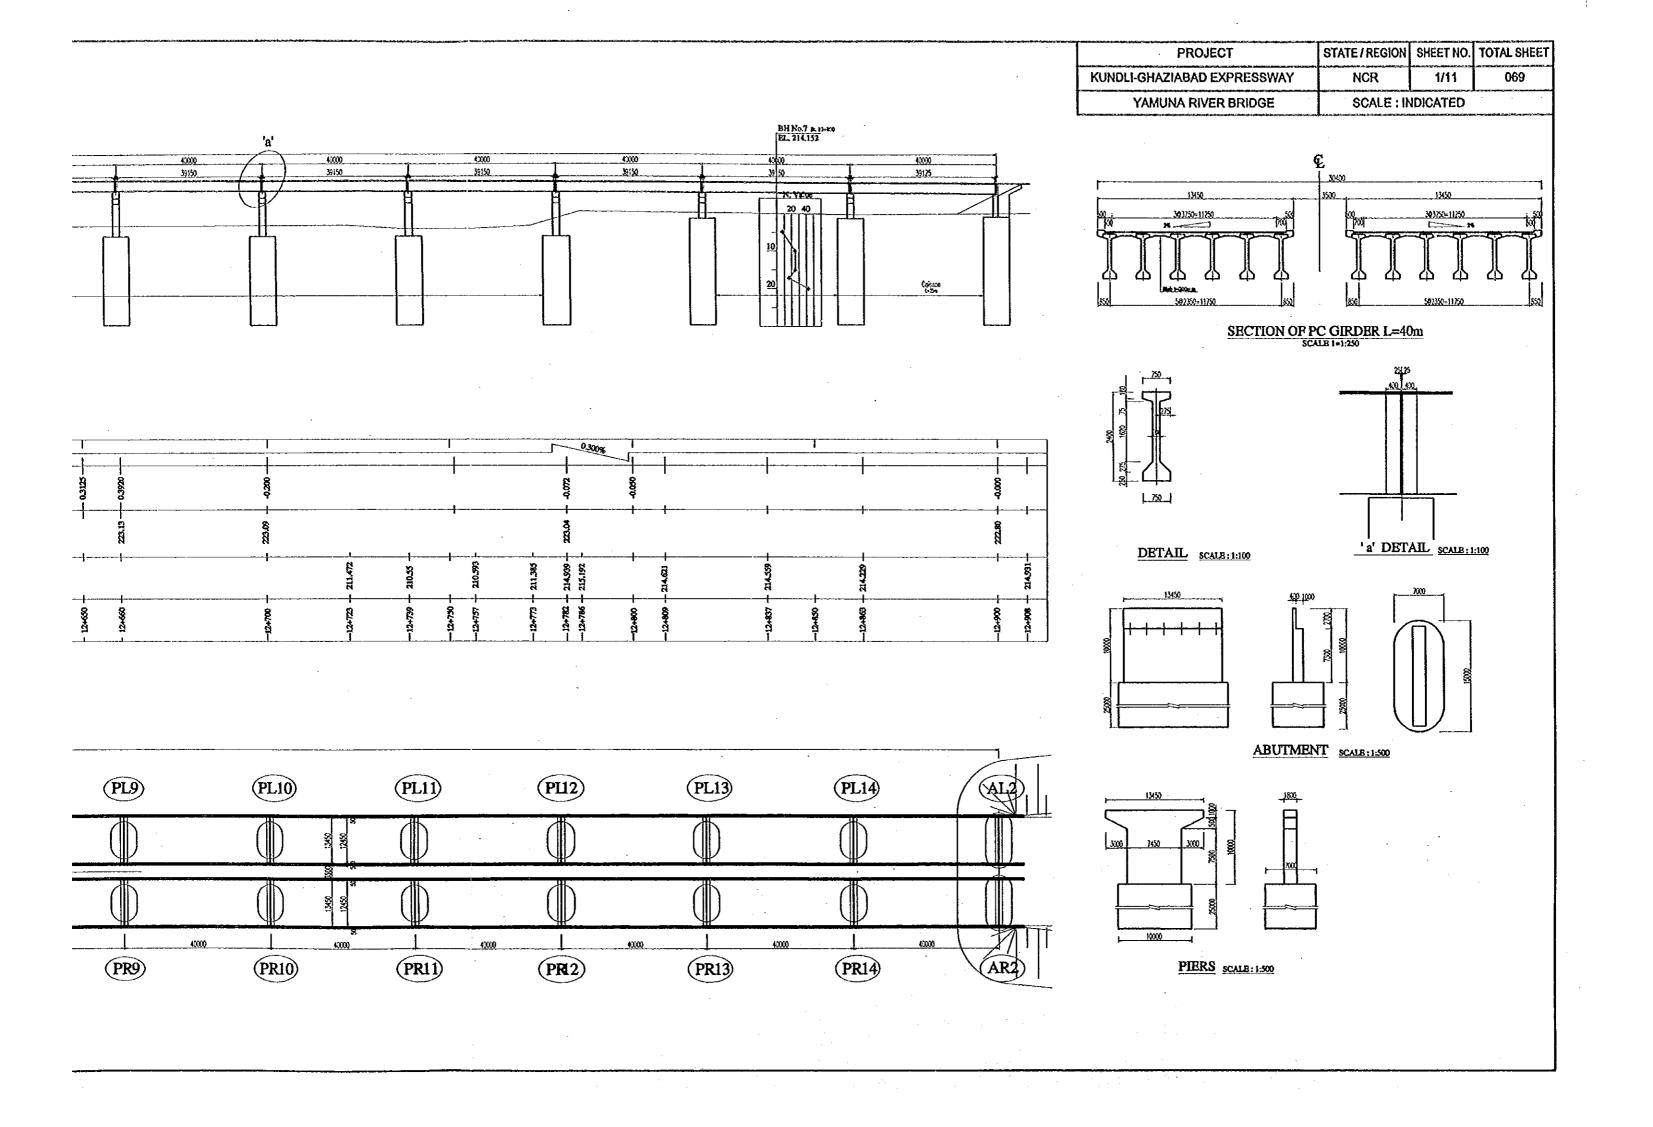

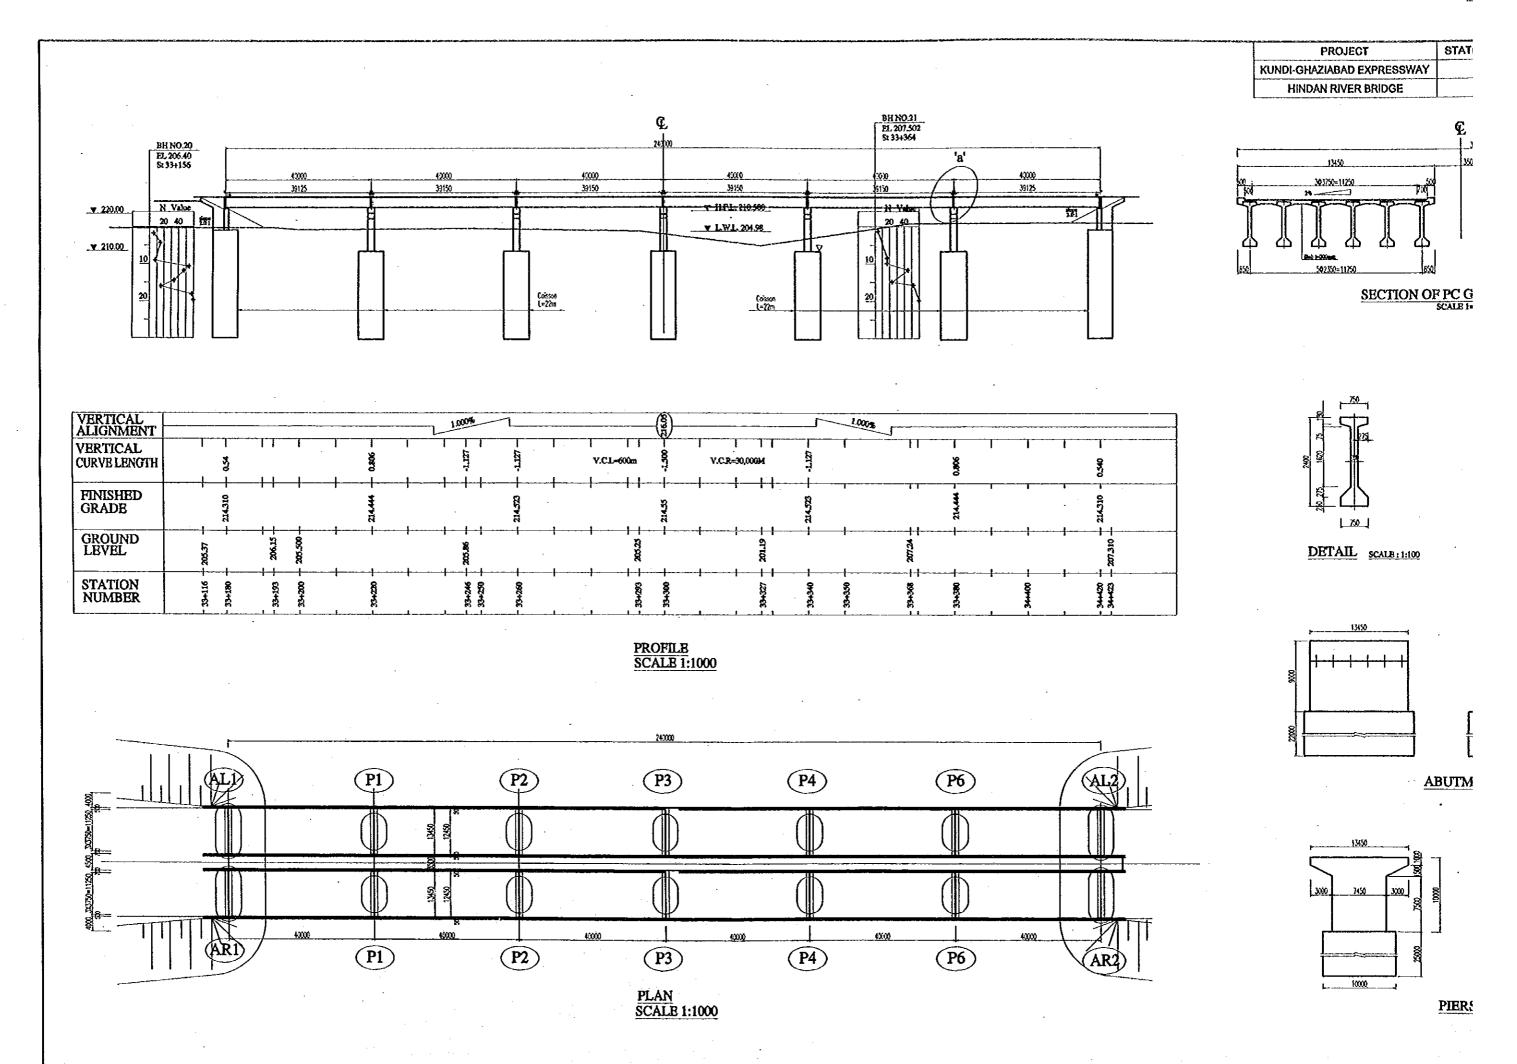


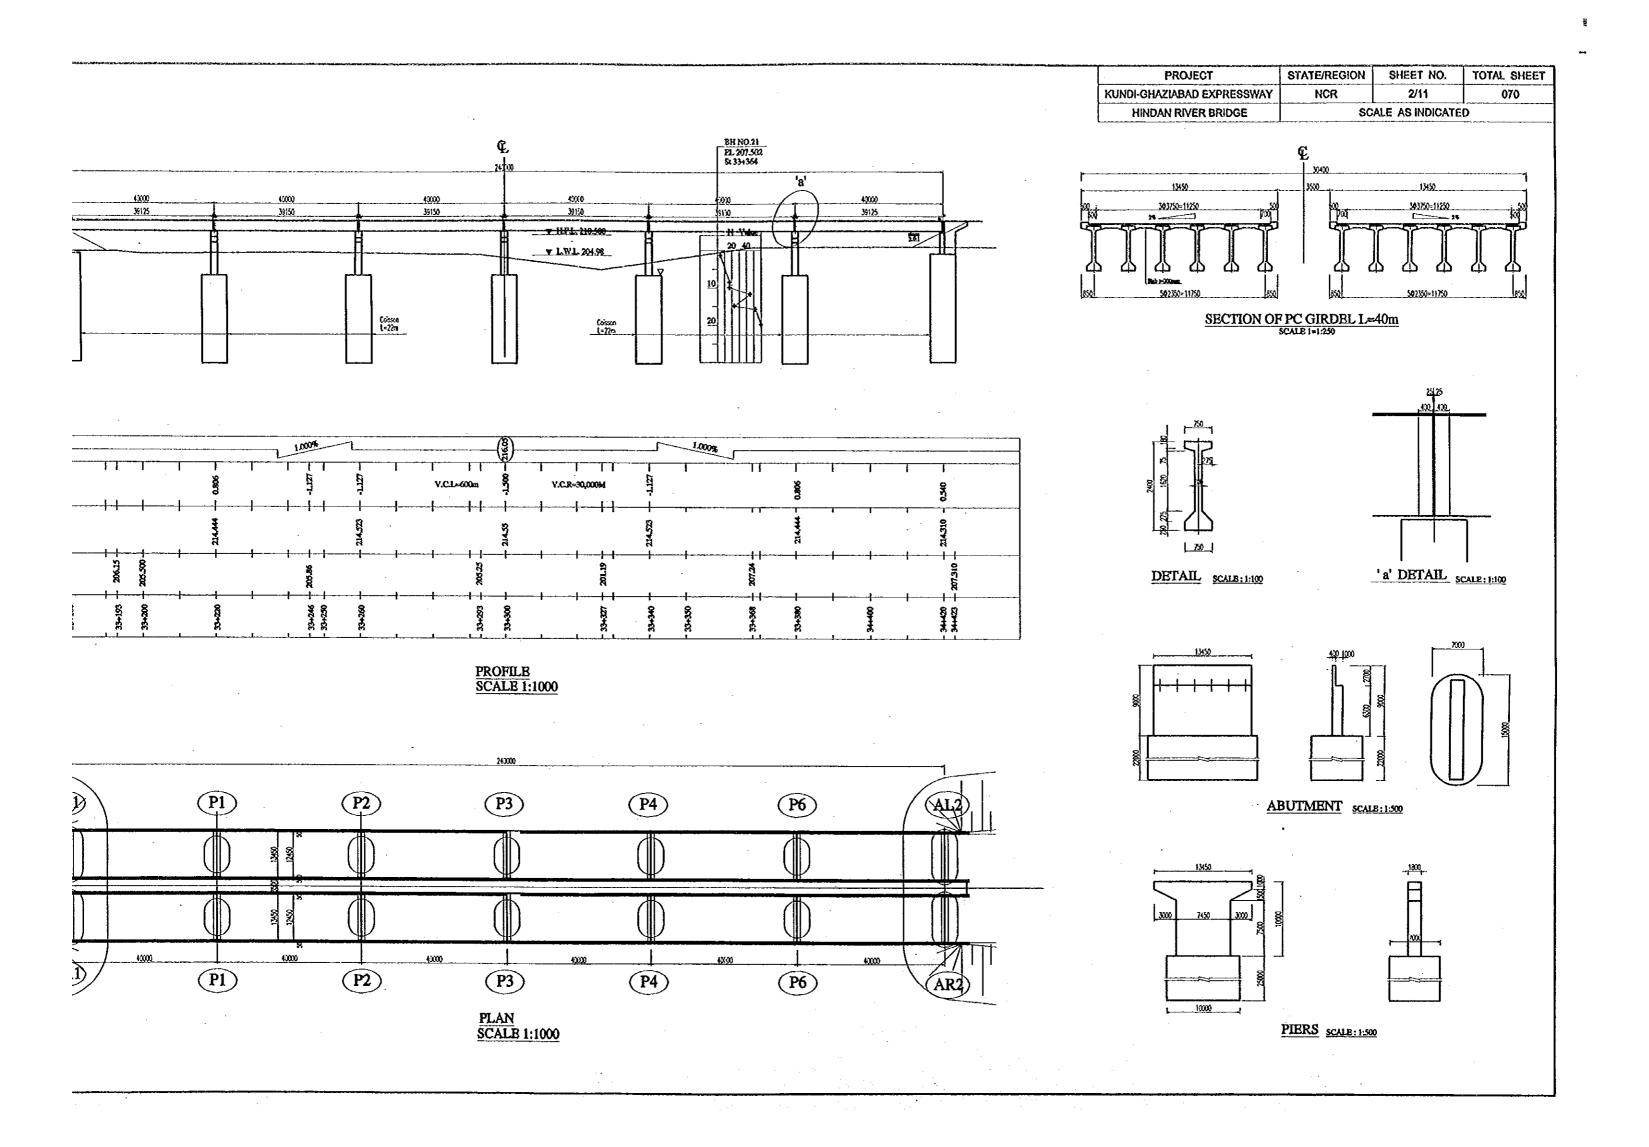

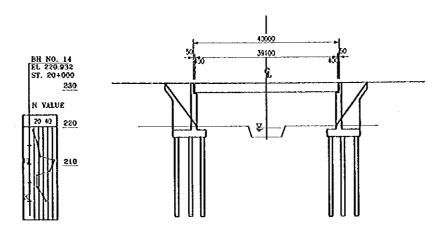



	1.6	00%			
VERTICAL AUGNMENT				<del></del>	·
VERTICAL CURVE LENGTH		1.638	1	, ¥,c. 8 v.c.	L=1000m & R=31,3000m &
FINISHED LEVEL		22.17		47E.025	' "
GROUND LEVEL		- 50.00x		220.214	
STATION NUMBER	. 57	72-22	22+040	734.67	,


PROFILE SCALE 1:1000

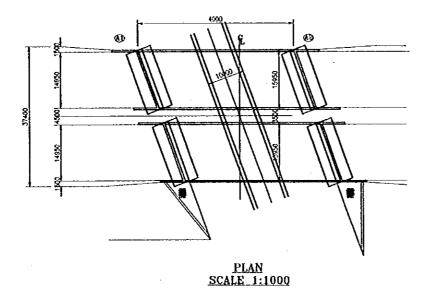


PROJECT STATE/REGION SHEET NO. TOTAL SHEET
KUNDLI-GHAZIABAD EXPRESSWAY NCR 3/11 071
EASTERN YAMUNA CANAL BRIDGE SCALE: INDICATED

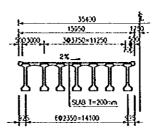


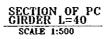

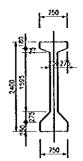


DETAIL SCALE 1:100

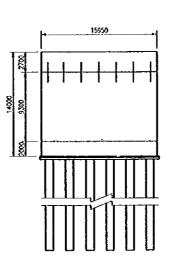

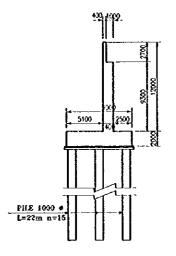


ABUTMENT SCALE 1:500

-7K	PROJECT	STATE/REGION	SHEET NO.	TOTAL SHEET
	KUNDLI-GHAZIABAD EXPRESSWAY	NCR	4/11	072
	UPPER GANGA CANAL BRIDGE		SCALE : INDICATE	)

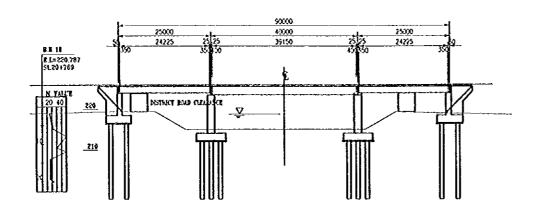


VERTICAL ALIGNMENT	Ŀ				3003	<u>.</u>		8	)				^	1.830%			 	_
VERTICAL CLEVE	187				3		VCL=720m	32	FCR=20,0	X00 <sub>123</sub>	-2890					2461		
nnised level	26.189							252			28.230					8		
GROUND LEVEL	Ι.		213,100						i	9		215.00	219,08			18.58		
STATION NUMBER	Γ	20.45	25.50	7		2		38.4			20+860	23+8;	3463		3448	¥		


PROFILE SCALE 1:1000

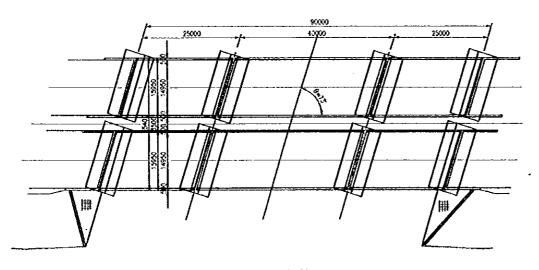


<u>PLAN</u> SCALE 1:1000

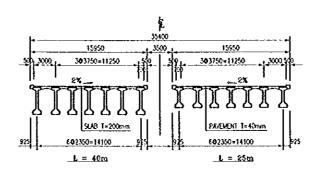


SECTION OF PC GIRDER
SCALE 1:500

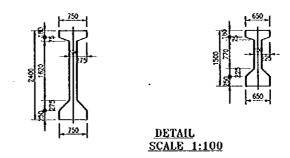


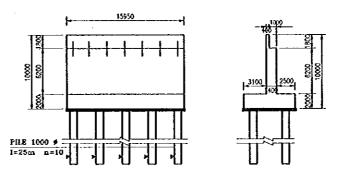

ABUTMENT SCALE 1:500

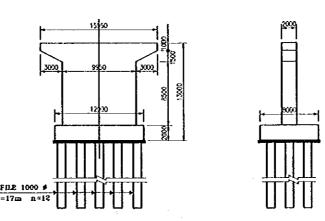


PIER SCALE 1:500

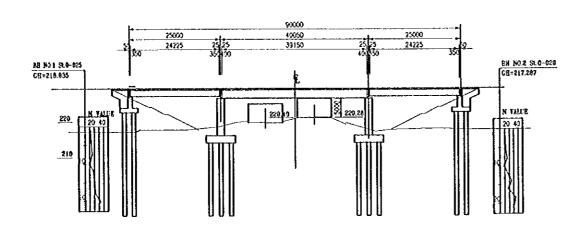


VERTICAL ALICAMENT	13395	1	)	14300	<u> </u>
AERADOT GAKAR ITENGAR	(h)	\$(1=650m )	F(R:23,80)m 2	54.	
ITNISHED LEVEL	281.82		. 5	Z Z	
GROUND LEVEL			ZZOZZ		
STATION NUMBER	550-0		0+400	465	


PROFILE SCALE 1:1000

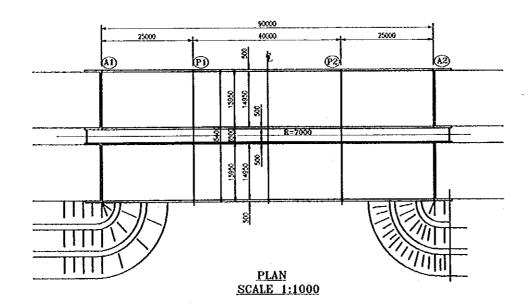

	PROJECT	STATE/REGION	SHEET NO.	TOTAL SHEET
į	KUNDLI-GHAZIABAD EXPRESSWAY	NCR	5/11	073
ĺ	NATIONAL HIGHWAY NO.1 FLY-OVER		SCALE : INDICATED	)

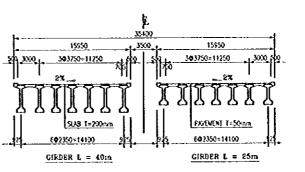


SECTION OF PC SCALE 1:500

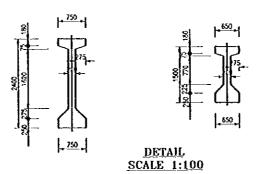


PILE 1000 6

ABUTMENT SCALE 1:500

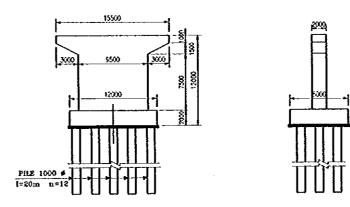


PIER SCALE 1:500


PROJECT	STATE/REGION	SHEET NO.	TOTAL SHEET
KUNDLI-GHAZIABAD EXPRESSWAY	NCR	6/11	074
STATE HIGHWAY NO.57 FLYOVER		SCALE : INDICATE	D

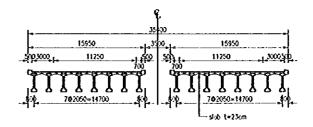


SECTION OF PC GIRDER L=40m SCALE 1:500

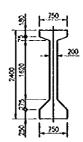

DETAIL SCALE 1:100

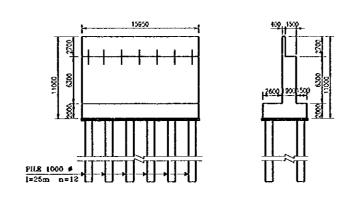


ABUTMENT SCALE 1:500

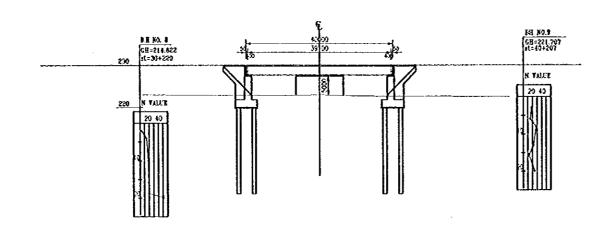


VERTICAL ALIGNMENT		 1200	1		)			2,601	1	, , 	
VERTICAL CURVE LENSTE	267		, (	F1-79a \$	702-29,000-	8	•			788	
FINISHED LEVEL	270.158						100 PM			230,118	
GROUND LEVEL	# 14c		\$ £		* *	\$ 5	¥		8 8	21.70	
STATION NUMBER	WW.71		3		3					<u>ş</u>	


PROFILE SCALE 1:1000

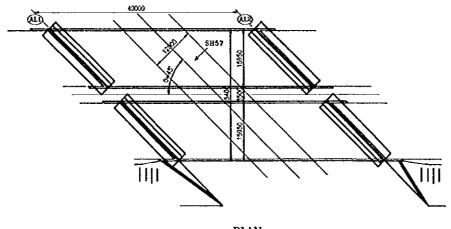


PLAN SCALE 1:1000

 PROJECT	STATE/REGION	SHEET NO.	TOTAL SHEET
KUNDLI-GHAZIABAD EXPRESSWAY	NCR	7/11	075
KHEKRA RAILWAY FLYOVER		SCALE: INDICATE	D

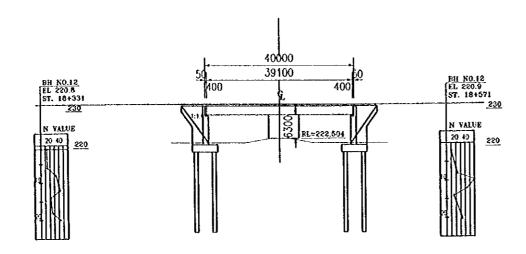

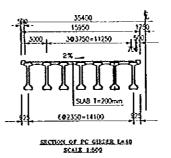


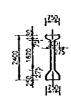


ETIAL SCALE E-100


VERTICAL ALIGNMENT		2.007	()		1	1.50%	
VERNICAL CURVE LENGTH	_ <del></del>	VCL=800m	YCR=220	00m §		7.7882	2.528
MNISHED LEVEL	<del></del>		<del>]</del>			. 8	<del></del>
GROUND LEVEL	220.022		1,000	8	88	1	
STATION NUMBER	24+81		; ;	3	1		

PROFILE SCALE 1:1000

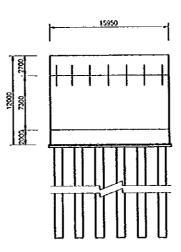

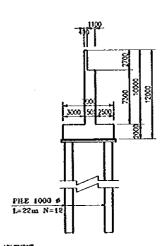


ABUTHENT SCALE 1500

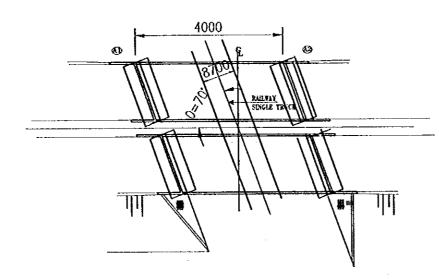


PLAN SCALE 1:1000

	PROJECT	STATE/REGION	SHEET NO.	TOTAL SHEET
	KUNDLI-GHAZIABAD EXPRESSWAY	NCR	8/11	076
Ì	INTERCHANGE FLYOVER		NDICATED	

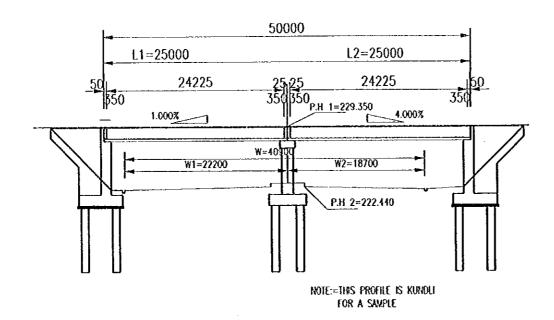



BRIDGE SECTION SCALE 1:250

		]	BRIDGE F	OR RAMP				F	LYOVEREI	ROAD		
STATION	LENGTH(m)				WIDTH(m)		ANGLE	N. M.	WIDTH(m)			REMARKS
	L	Lí	L2	В	В1	B2	(0°)	NAME	W	W1	W2	
KUNDLI	50	25	25	22.90	11.45	11.45	72	EXPRESS	40.90	22.20	18.70	
KHEKHRA	50	25	25	16.40	8.20	8.20	90	EXPRESS	40.90	22.20	18.70	
MODI NAGAR	50	25	25	19.65	8.20	11.45	90	EXPRESS	40.90	22.20	18.70	
GHAZIDABAD(1)	50	25	25	22.90	11.45	11.45	90	N.H No.24	32.00	16.00	16.00	-
GHAZIDABAD(2)	80	40	40	22.90	11.45	11.45	90	EXPRESS	51.65	29.20	22.45	

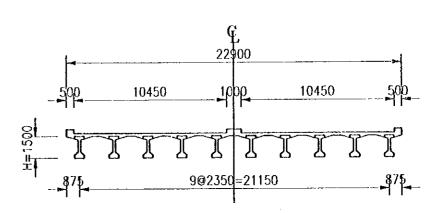


KUNDLI, GHAZIABAD(1) AND (2)

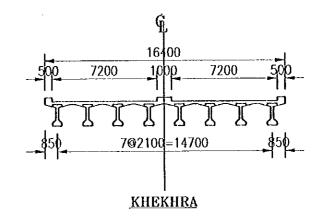

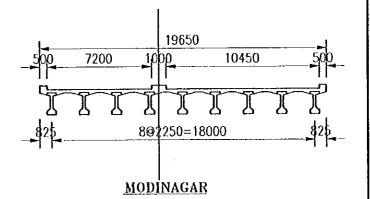


BRIDGE SECTION
SCALE 1:250


 PROJECT	STATE/REGION	SHEET NO.	TOTAL SHEET
KUNDLI-GHAZIABAD EXPRESSWAY	NCR	9/11	077
YAMUNA TRIBUTARY BRIDGE	\$	CALE: INDICATED	

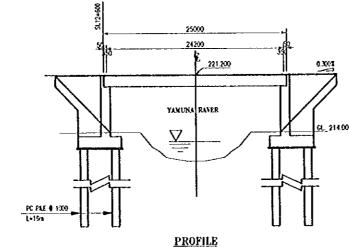




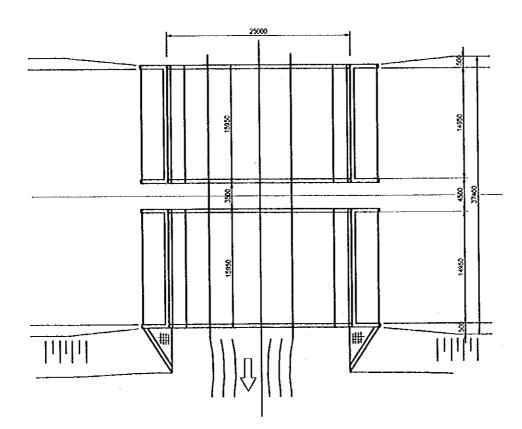


PLAN SCALE 1:500

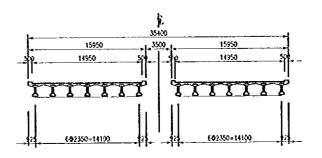

SECTION OF PC GIRDER L=25m SCALE 1:500

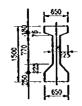



<u>DETAIL</u> SCALE 1:100

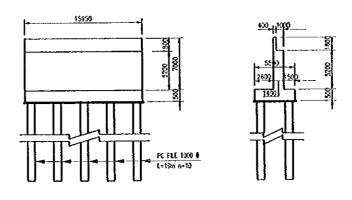


ABUTMENT SCALE 1:500

a cantrab	PROJECT	STATE/REGION	SHEET NO.	TOTAL SHEET
	KUNDLI-GHAZIABAD EXPRESSWAY	NCR	10/11	078
	DRAIN / DISTRIBUTARY BRIDGES		SCALE: INDICATE	D

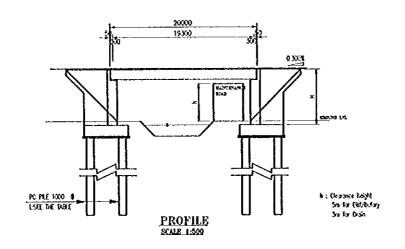


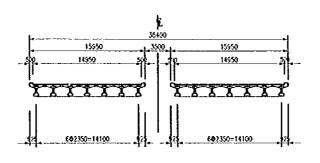

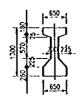


CROSS SECTION
SCALE 1:500


GIRDER DETAIL
SCALE 1:100

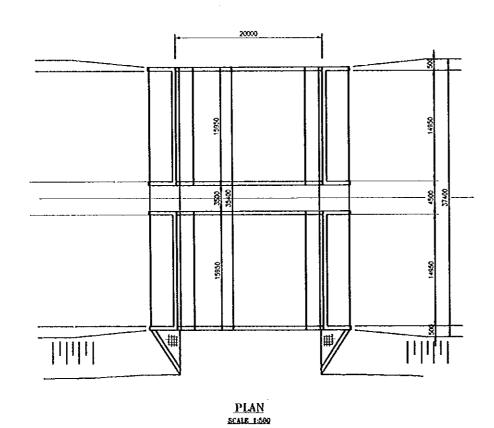


K-G ROUT 20m BRIDGE LOCATION									
NO.	STATION	P.E(m)	G.L(m)	B(m)	L(m)	7 -			
i.	01+975	224.58	218.00	8,6	18	8			
2.	19+230	227.37	220.40	7.0	17	8			
3.	18+619	227.85	229.50	7.4	17	8			
4.	22+640	225.05	217.80	8.2	10	10			
5.	33+660	222.65	213.50	9.1	20	10			

N-G ROUT 20m BRIDGE LOCATION									
NO.	STATION	P.E(m)	C.t(m)	E(m)	L(m)	۰			
1.	12+895	222.36	213.49	9.0	10	19			
2.	191460	223.86	218.90	7.0	11	8			
3.	22+649	225 37	217.40	8.0	11	19			
4.	54+455	228.70	220.40	8.3	15	10			
5.	35+855	224.72	219.40	5.3	15	8			
8.	37+480	225.63	229.50	5.1	15	8			
7.	394010	227.40	221.60	5.8	18	8			

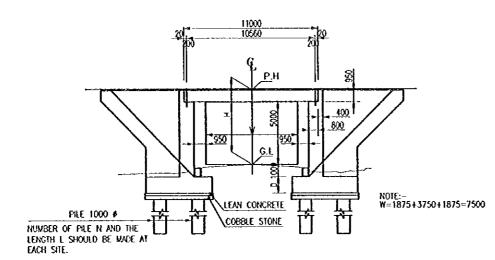

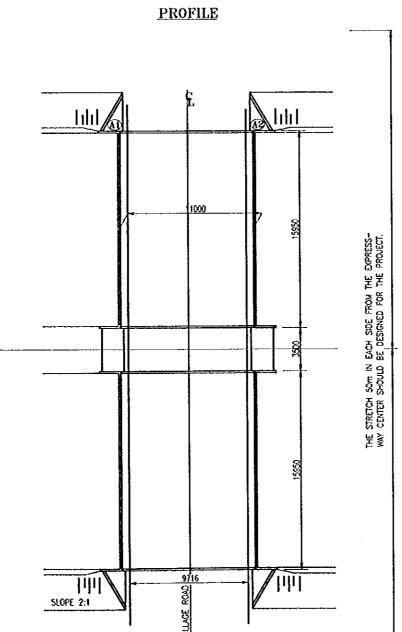

**PLAN** 

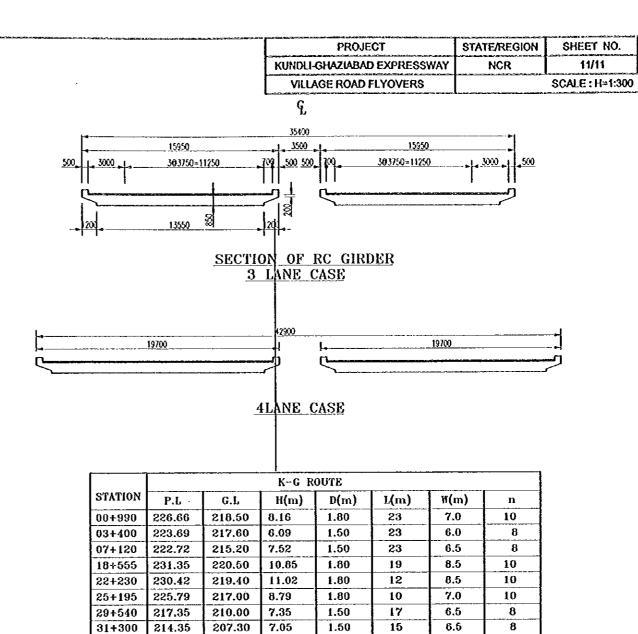

TOTAL SHEET

079

		G-M ROUTE							
STATION	P.L	G.L	H(m)	D(m)	L(m)	Y(m)	n		
01+525	207.30	200.80	6.50	1.50	12	6.0	10		
03+680 <sup>#</sup>	213.62	206.20	7.55	1.50	18	6.5	10		
05+460	219.64	213.00	6.64	1.50	15	6.0	10		
07+755	220.88	214.00	6.88	1.50	16	6.0	10		
11+300	219.76	212.20	7.56	1.50	17	6.5	8		
15+025	219.65	212.20	7.45	1.50	17	6.5	8		
16+235	219.85	213.50	6.35	1.50	15	6.0	8		
23+325	224.28	217.50	6.78	1.50	20	6.0	8		
26+490	224.73	218.50	6.23	1.50	21	6.0	8		
32+150	226.65	220.00	6.65	1.50	15	6.0	8		

1.50

1.50

1.50

12

18

20

6.0

6.5

6.0

8

8

8

## # MARK MEANS THE ROAD WITH 4 LANES.

## NOTES:

214.36

218.86

39+855 221.93

36+880

38+490


207.50

211.50 7.36

215.00 6.93


6.86

- 1) P.H MEANS PLAN HEIGHT
- 2) G.L MEANS GROUND LEVEL
- 3) H MEANS DISTANCE BETWEEN P.H AND G.L
  4) D MEANS FOOTING THICKNESS
- 5) L MEANS LENGHT OF PILE
- 6) N MEANS NUMBER OF PILE

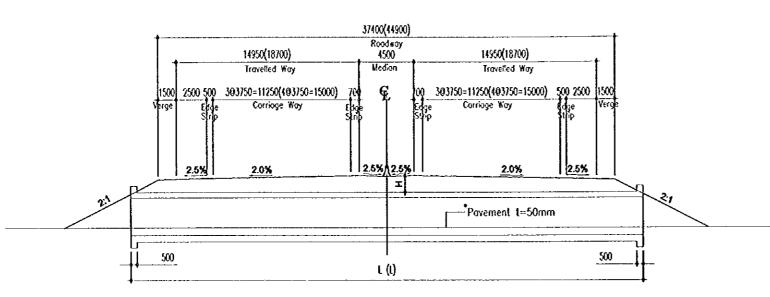

PROFILE SCALE: 1:300


Notes: \* Pavement shall be provided for Carl Track Values in brackets indicate 4 lones road

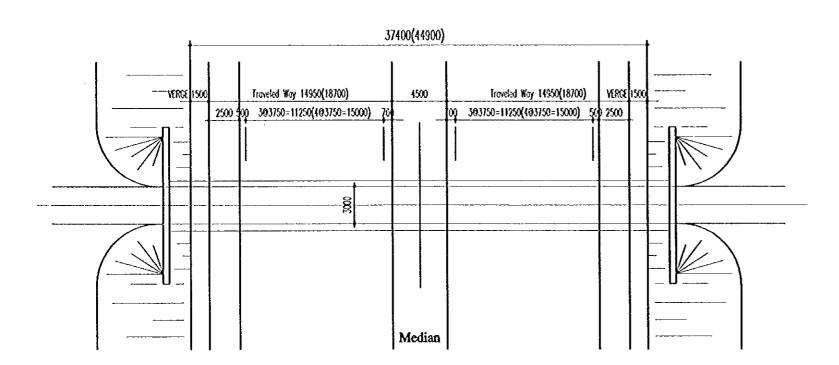

PLAN SCALE: 1:300

 PROJECT	STATE / REGION	SHEET NO.	TOTAL SHEET	
GM AND KG EXPRESSWAY	NCR	1/2	080	
BOX CULVERT	SCALE:H=1:300			


brackets ( )
are for 4 lanes

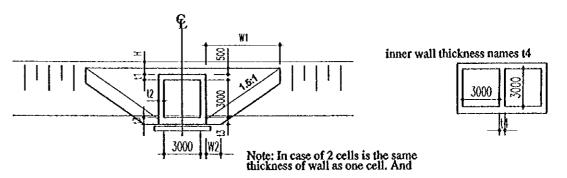


## SECTION SCALE: 1:300

								(Unit	: mm)		
H(m)	t1	t2	t3	t4	W1(m)	W2	L(m)		PB	Note: Values in	
11(11)	••	12			111(11)	112		L(III)	1cell	2cell	brackets ( )
1	450	450	550	250	6.0	700	42(49)	A1	Bi	are for 4 lar	
2	450	450	550	250	6.0	700	46(53)	A2	B2		
3	500	500	600	250	6.0	600	50(57)	A3	В3		
4	550	550	650	250	6.0	550	54(61)	A4	В4		
5	550	550	650	250	6.0	550	58(65)	A5	В5		


K	- G	ROUTE		N	1 - G	ROUTE	
STATION	TYPE	STATION	TYPE	STATION	TYPE	STATION	TYPE
1+360	A5	18+155	A5	00+800	A1	29+255	A2
02+360	A2	19+430	A5	02+795	A1	29+725	B2
02+710	A1	21+605	A2	04+270	A2	31+350	A1
02+975	A1	23+900	A1	05+945	A4	32+630	A3
03+740	A2	24+900	A2	07+490	A3	33+035	A1
04+150	A2	26+475	A1	08+345	A2	33+300	A1
04+865	A1	26+720	В3	10+510	Ai	33+830	A2
05+395	A2	27+675	A1	10+735	B4	34+175	A5
06+150	A1	29+300	A1	11+575	A1	34+720	A2
07+470	A3	31+000	A1	12+200	A2	36+180	Al
07+980	A1	31+600	A1	15+475	A1	37+735	A1
08+465	A3	33+470	A3	17+890	A1	38+890	Aı
09+570	A1	34+635	A2	19+000	Ai	-	
10+525	A2	34+850	A2	20+060	A1		
13+205	A4	35+190	A1	21+950	A1		
15+400	A1	36+555	A4	23+880	Al		
16+430	A1	37+300	A1	25+800	A1		
16+660	A3	39+190	A3	26+190	A3		
17+110	A3	39+660	B5	26+705	A2		
17+425	A1			28+730	A2		

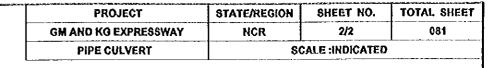

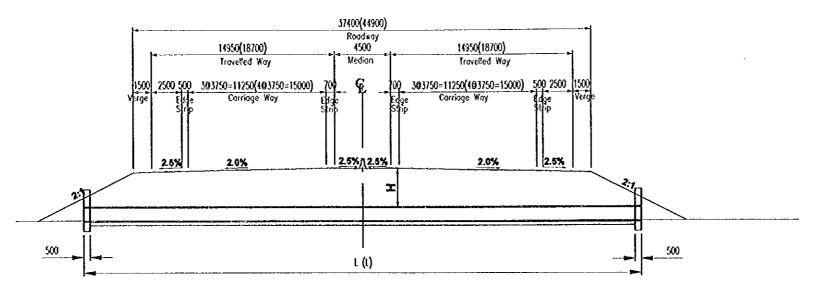

PROFILE SCALE: 1:300


Notes: Values in brackets indicate 4 lanes road

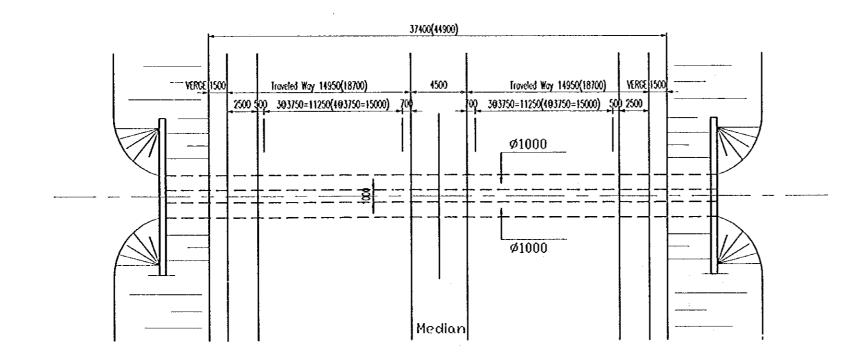

PLAN SCALE : 1:300

	/	Concrete pipe
	Ø1000	
03		]
550		Concrete pipe
	1600	

SECTION OF TYPE A
SCALE 1:50

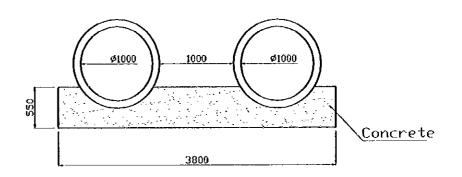

SECTION OF TYPE B SCALE 1:50

К	- G	RO	UTE	G - M ROUTE				
STATION	(m)H	PIPE No	LENGTH(m)	STATION	H(n)	PIPE No	LENGTH(m)	
24+650	3	1	50	1+200	5	1	65	
24+700	5	1	58	25+035	1	5	42	
			AZ	26+390	5	5	58	
			Ai	27+665	5	2	46	
			A2	27+940	2	1	46	
			A1	31+920	5	5	58	
			B3	32+370	5	2	58	
			A1	34+975	S	1	46	