
Drawings

LIST OF DRAWING (1/2)


No.	Drawing No.	Title of Drawing		
1	0001	General Layout	Bimoku Scheme (1/2)	
2	0002	General Layout	Bimoku Scheme (2/2)	
3	0003	General Layout	Oeltua Scheme (1/2)	
4	0004	General Layout	Oeltua Scheme (2/2)	
5	0005	General Layout	Benkoko Scheme	
6	0006	General Layout	Oebuain Scheme (1/3)	
7	. 0007	General Layout	Oebuain Scheme (2/3)	
8	8000	General Layout	Ochuain Scheme (3/3)	
9	0009	General Layout	Matasio Scheme	
10	1001	Bimoku Scheme	Plan and Section of Reservoir	
11	1002	Bimoku Scheme	Profile and Section of Spillway	
12	1003	Bimoku Scheme	Plan and Profile of Intake	
13	1004	Bimoku Scheme	Plan and Profile of Valve House	
14	1005	Bimoku Scheme	Blanket and Fence of Reservoir	
15	1006	Bimoku Scheme	Profile of Pipetine	
-16	2001	Oeltua Scheme	Plan and Section of Reservoir	
17	2002	Oeltua Scheme	Profile and Section of Spillway	
- 18	2003	Oeltua Scheme	Plan and Profile of Intake	
19	2004	Oeltua Scheme	Plan and Profile of Valve House	
20	2005	Oeltua Scheme	Blanket and Fence of Reservoir	
- 21	2006	Oeltua Scheme	Profile of Pipeline	
22	3001	Benkoko Scheme	Plan and Section of Reservoir	
23	3002	Benkoko Scheme	Profile and Section of Spillway	
24	3003	Benkoko Scheme	Plan and Profile of Intake	
25	3004	Benkoko Scheme	Plan and Profile of Valve House	
26	3005	Benkoko Scheme	Blanket and Fence of Reservoir	
27	3006	Benkoko Scheme	Profile of Pipeline (1/2)	
28	3007	Benkoko Scheme	Profile of Pipeline (2/2)	
- 29	3008	Benkoko Scheme	Canal Profile and Related Structures	
30	3009	Benkoko Scheme	Operation and Maintenance Road Profile and Related Structures	


LIST OF DRAWING (2/2)


No.	Drawing No.	Tì	tle of Drawing
31	4001	Oebuain Scheme	Plan and Section of Reservoir
32	4002	Oebuain Scheme	Profile and Section of Spillway
33	4003	Oebuain Scheme	Plan and Profile of Intake
34	4004	Oebuain Scheme	Plan and Profile of Valve House
35	4005	Oebuain Scheme	Blanket and Fence of Reservoir
36	4006	Oebuain Scheme	Profile of Pipeline (1/2)
37	4007	Oebuain Scheme	Profile of Pipeline (2/2)
38	5001	Matasio Scheme	Plan and Section of Reservoir
39	5002	Matasio Scheme	Profile and Section of Spillway
40	5003	Matasio Scheme	Plan and Profile of Intake
41	5004	Matasio Scheme	Plan and Profile of Valve House
42	5005	Matasio Scheme	Profile of Pipeline (1/2)
43	5006	Matasio Scheme	Profile of Pipeline (2/2)
44	5007	Matasio Scheme	Canal Profile and Related Structures
45	5008	Matasio Scheme	Operation and Maintenance Road Profile and Related Structures
46	6001	General	Typical Related Structures of Reservoir (1/2)
47	6002	General	Typical Related Structures of Reservoir (2/2)
48	6003	General	Typical Related Structures of Pipeline

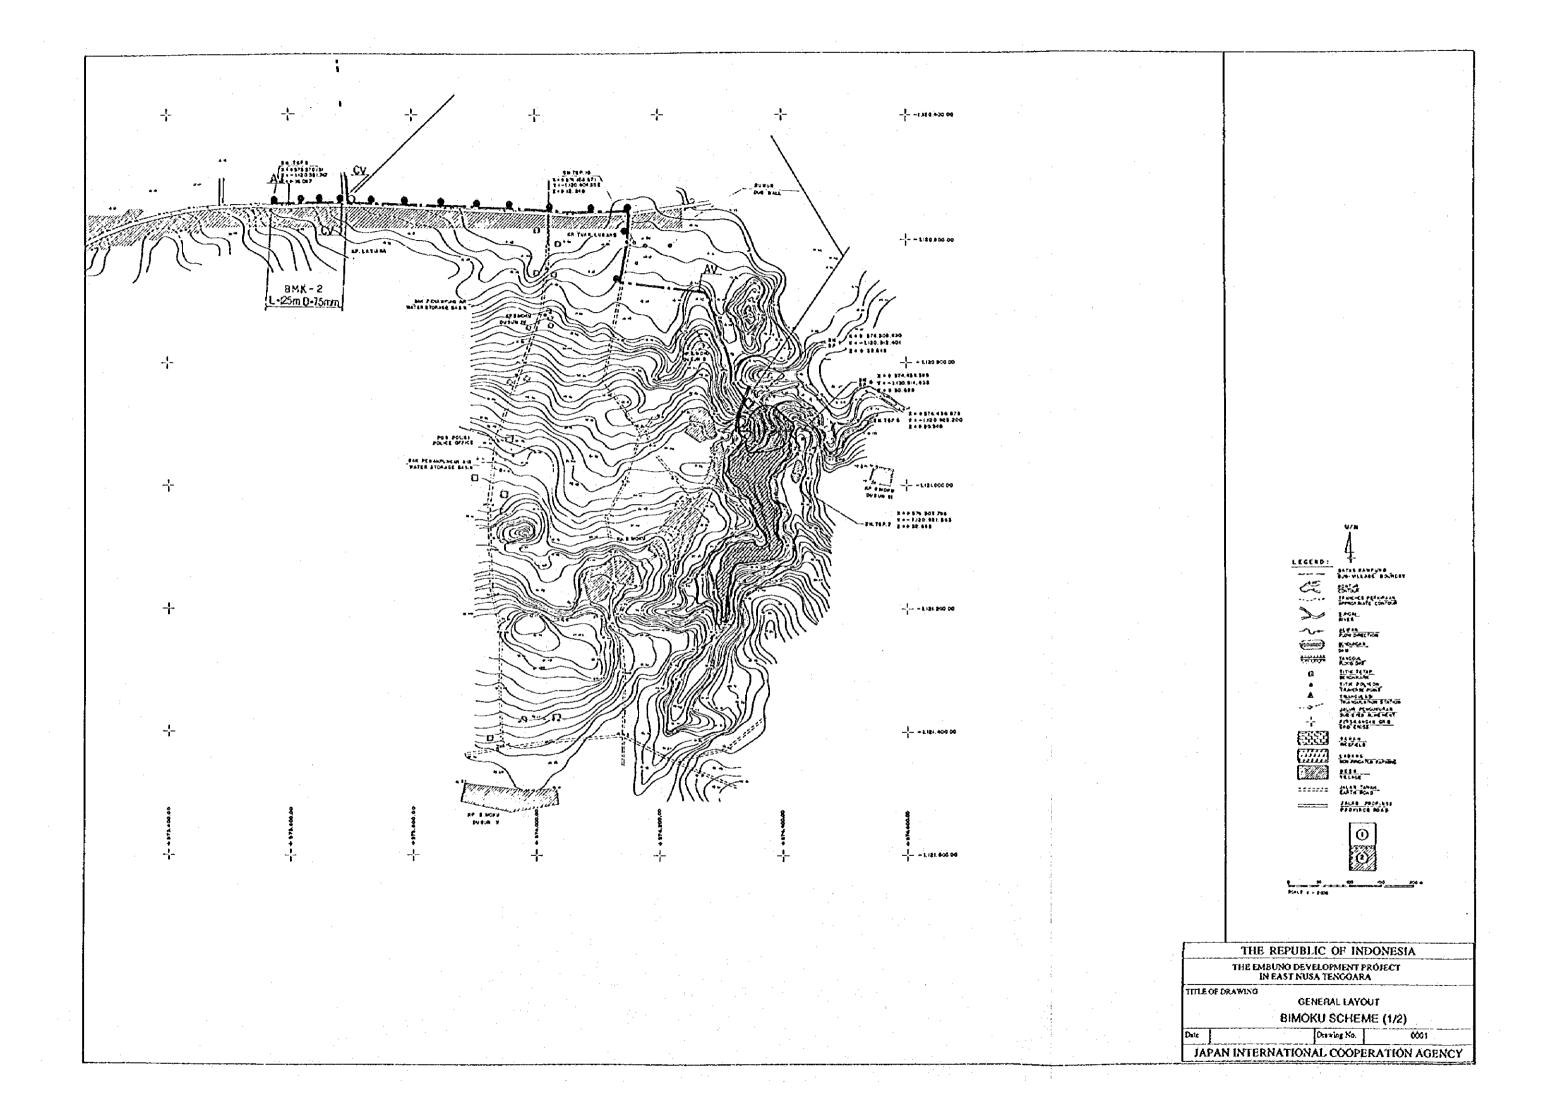





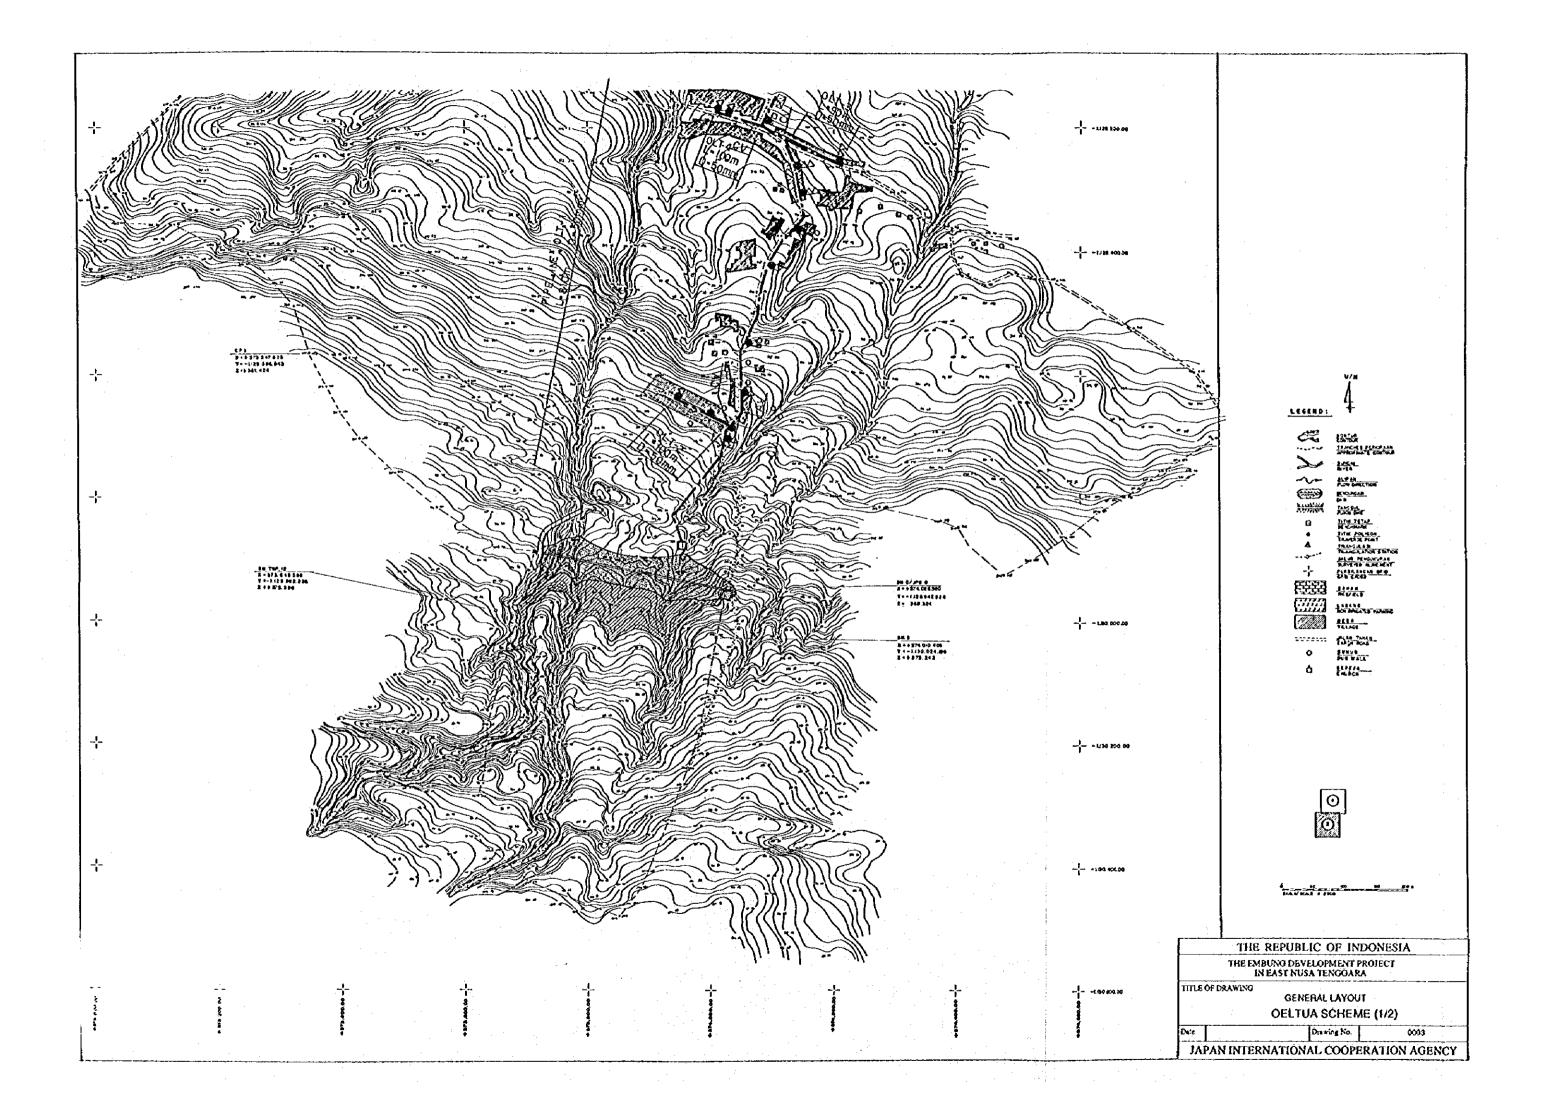


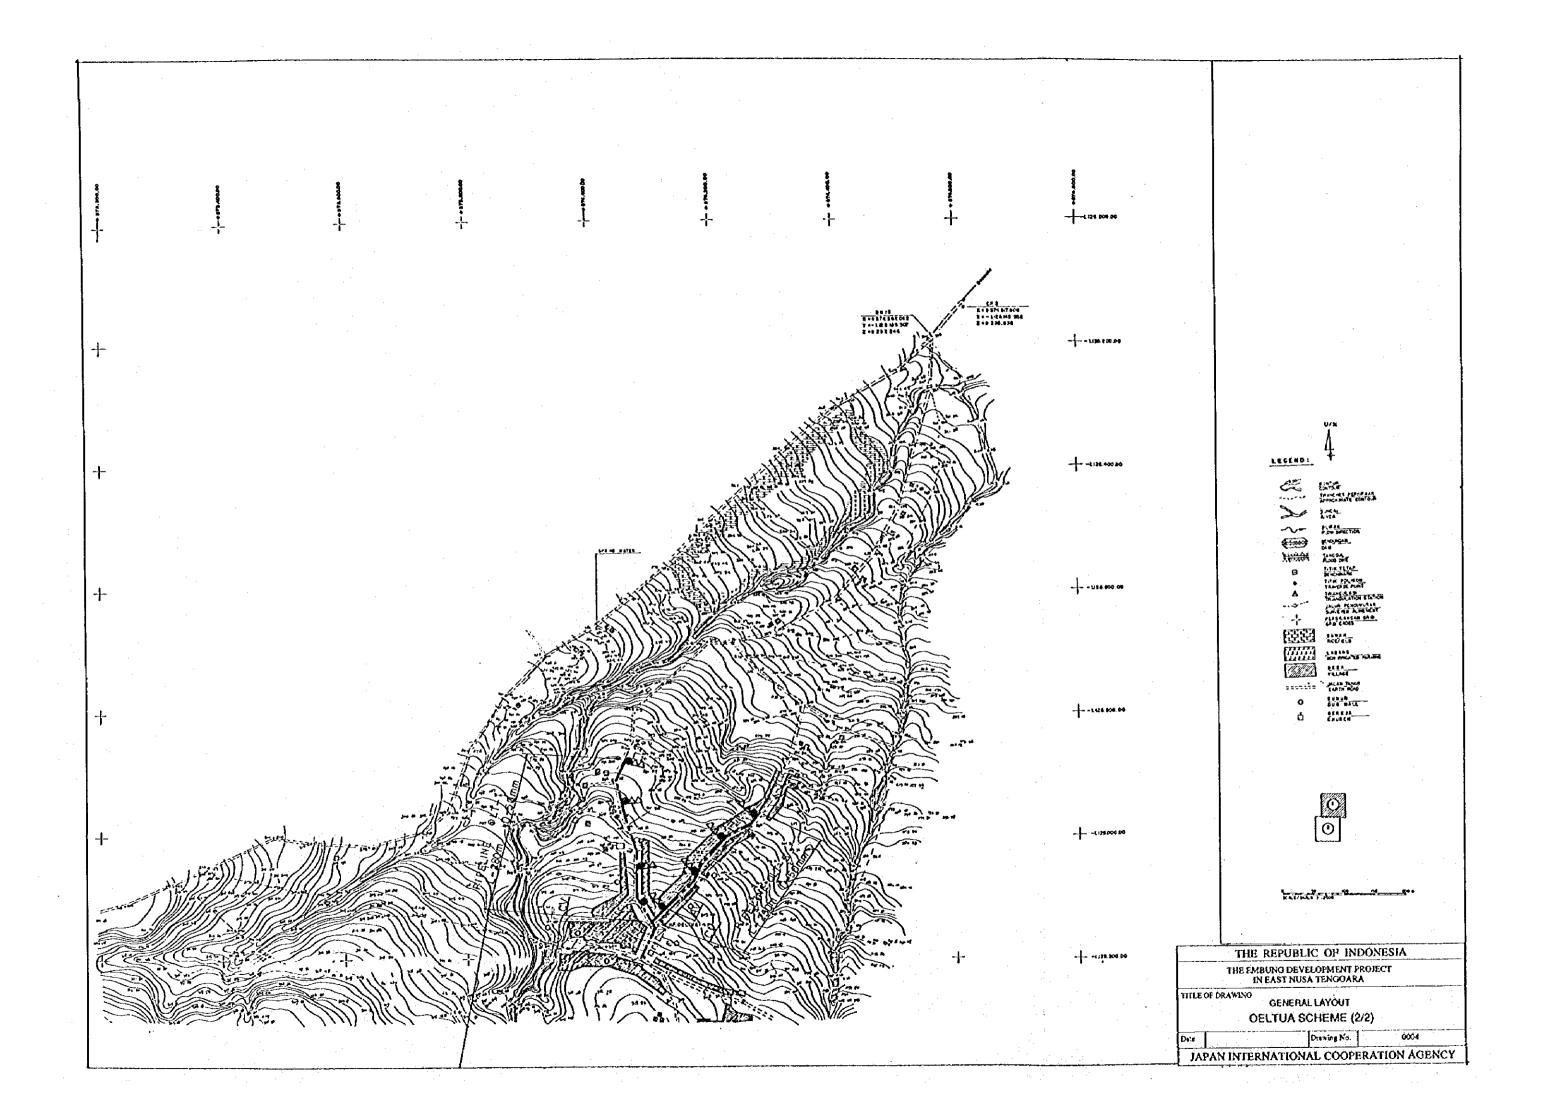


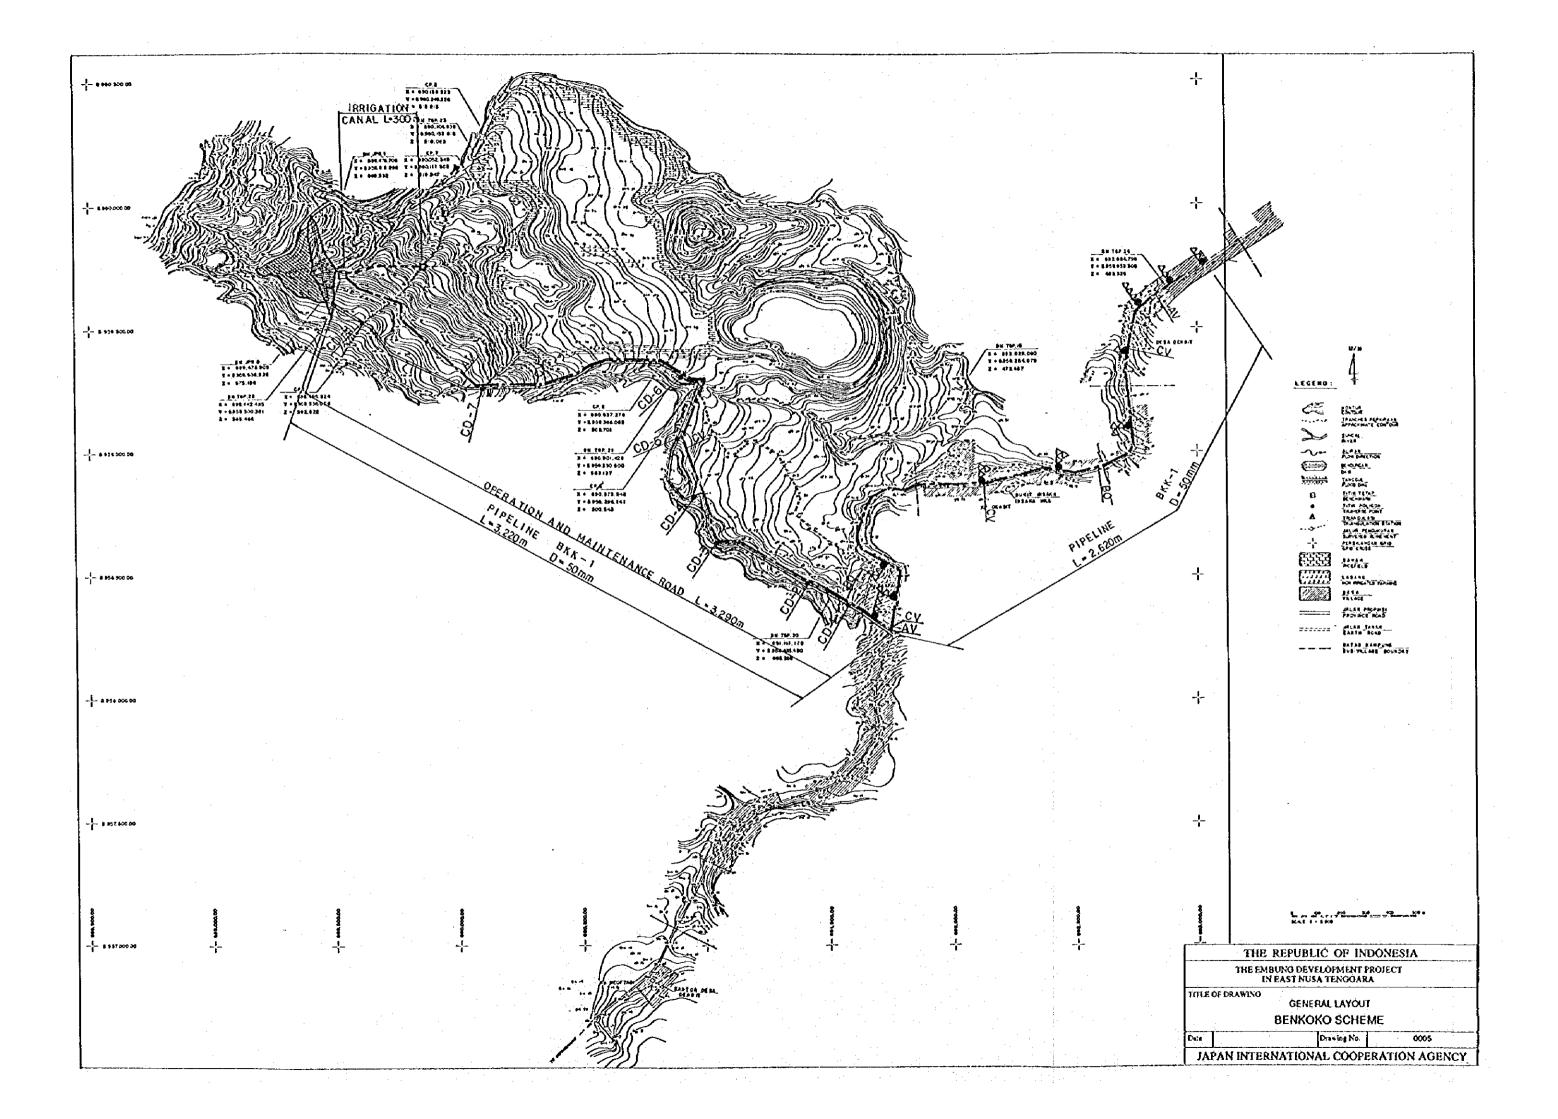


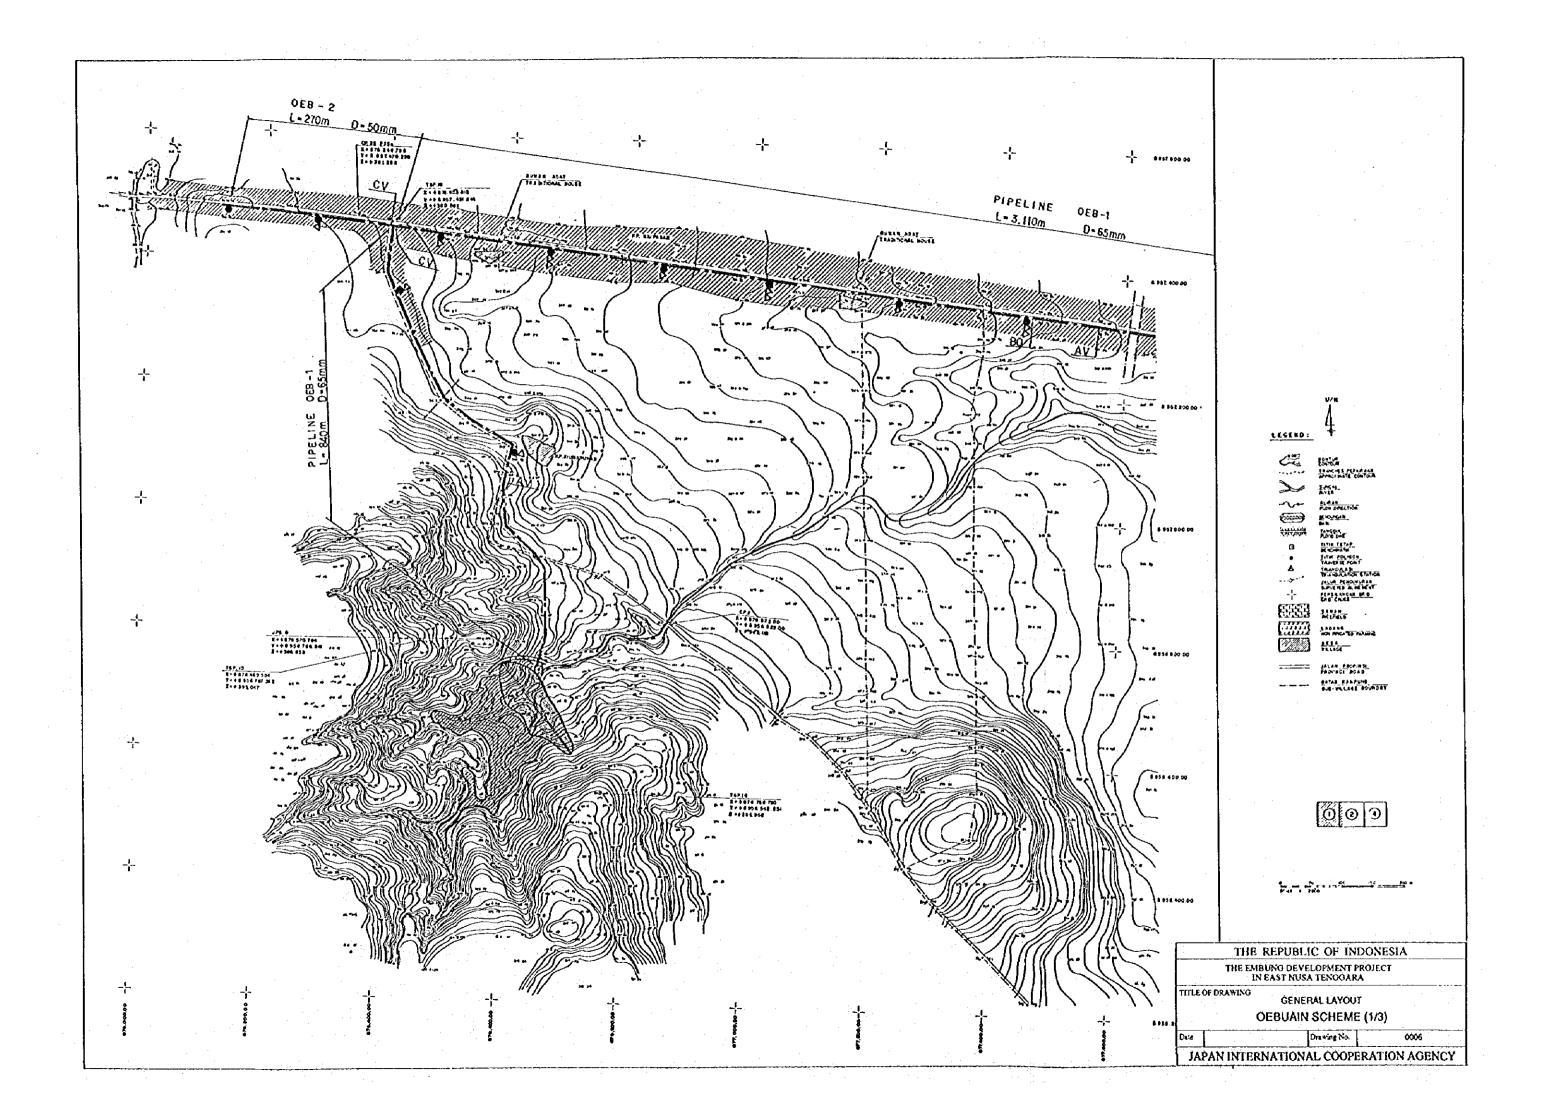

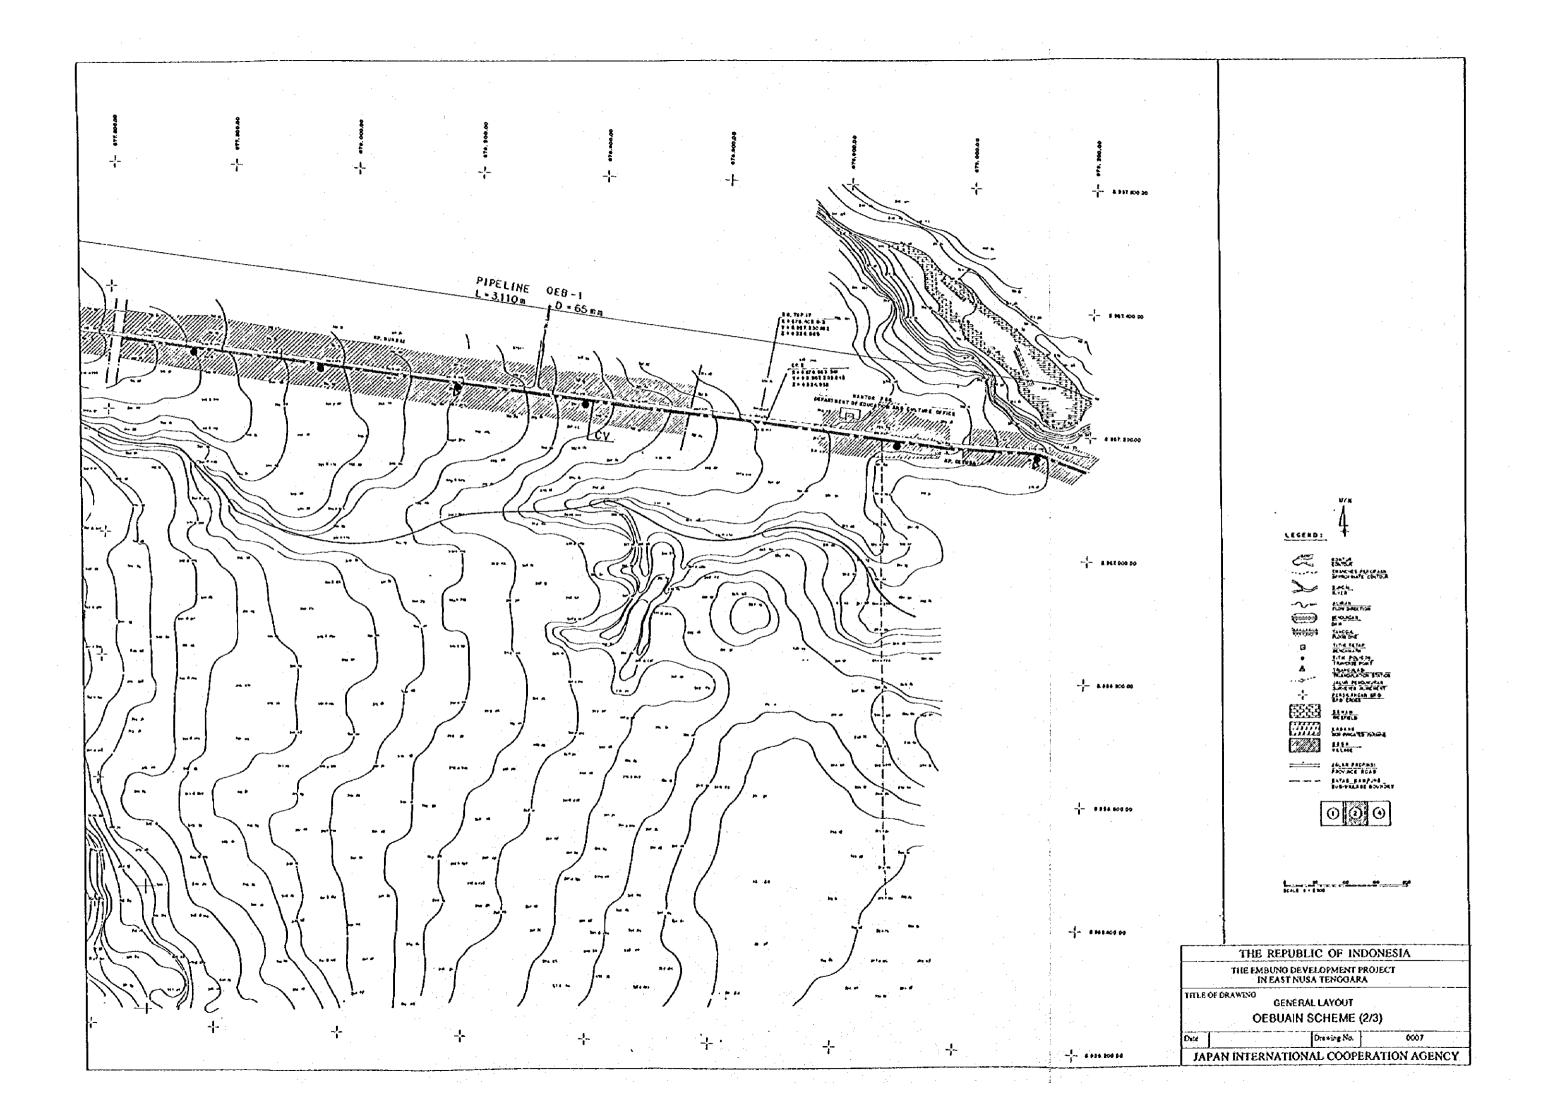


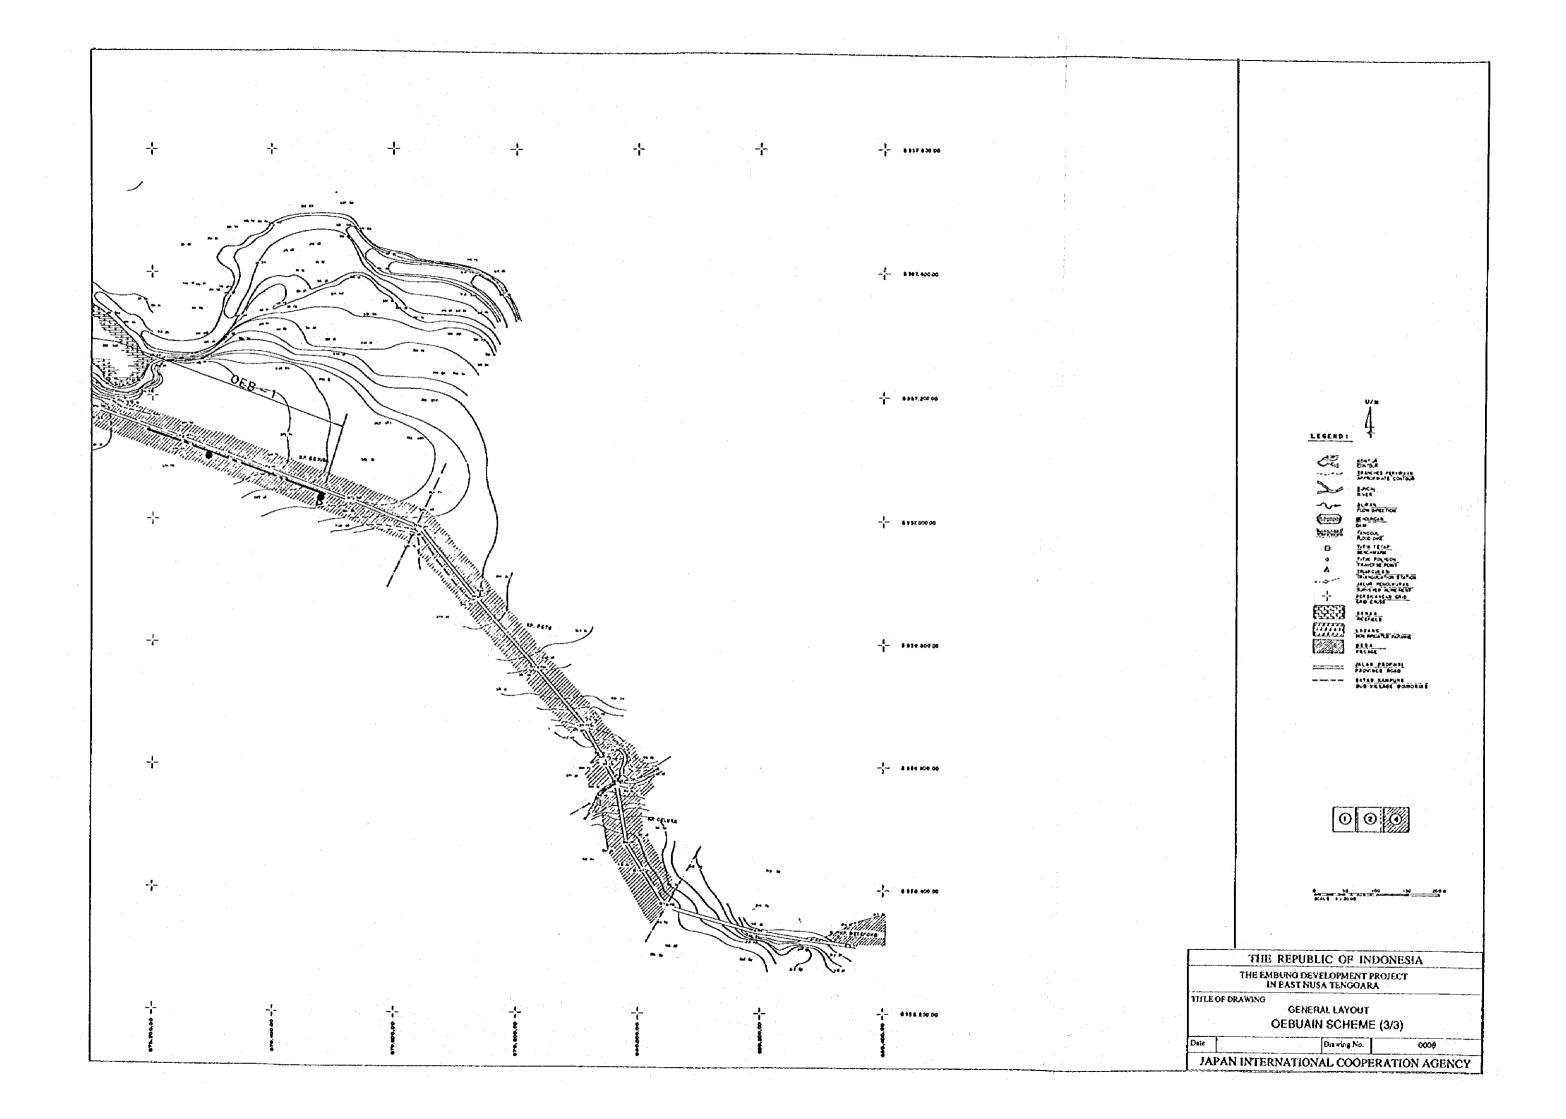

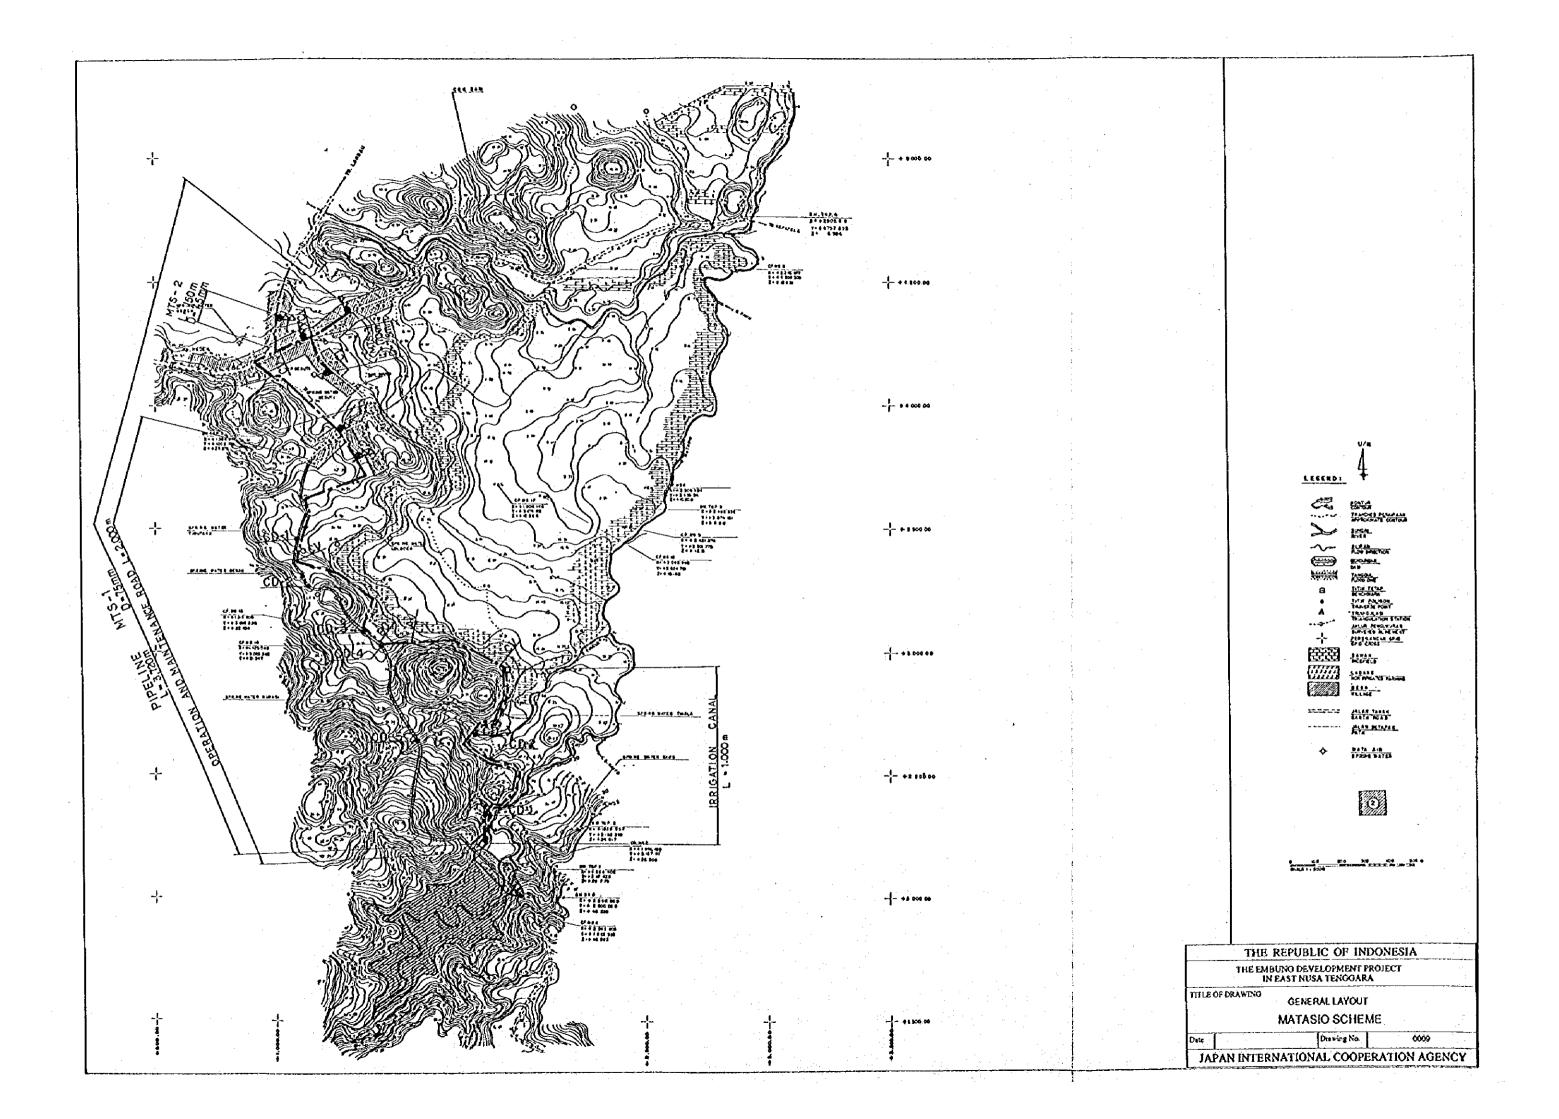


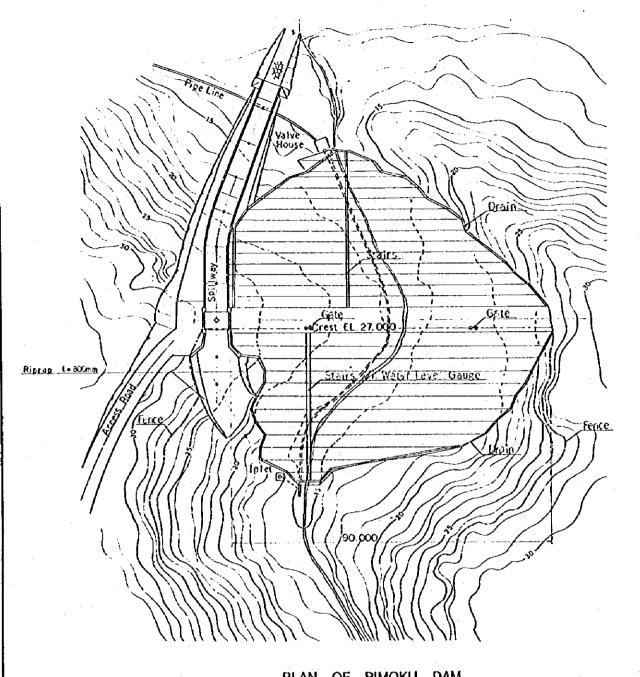


PLAN OF BIMOKU DAM

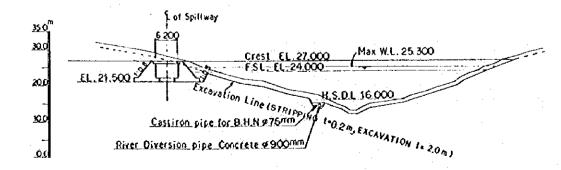


PROFILE OF DAM AXIS

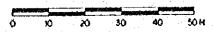

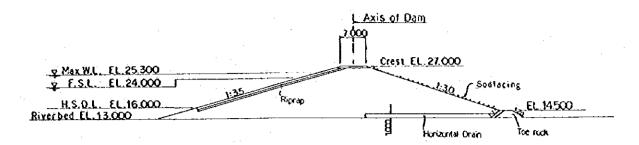


TYPICAL CROSS SECTION



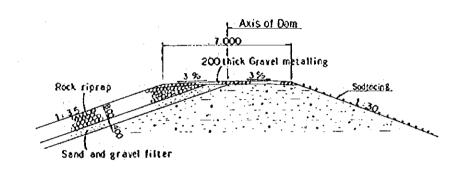

TYPICAL SECTION OF EMBANKMENT CREST




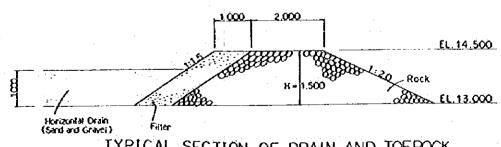



TYPICAL SECTION OF DRAIN AND TOEROCK




	NESIA
NO DEVELOPMENT PROJ AST NUSA TENGOARA	ect ;
BIMOKU SCHEME	
ID SECTION OF RE	SERVOIR
Drewing No.	1001
	BIMOKU SCHEME ID SECTION OF RE

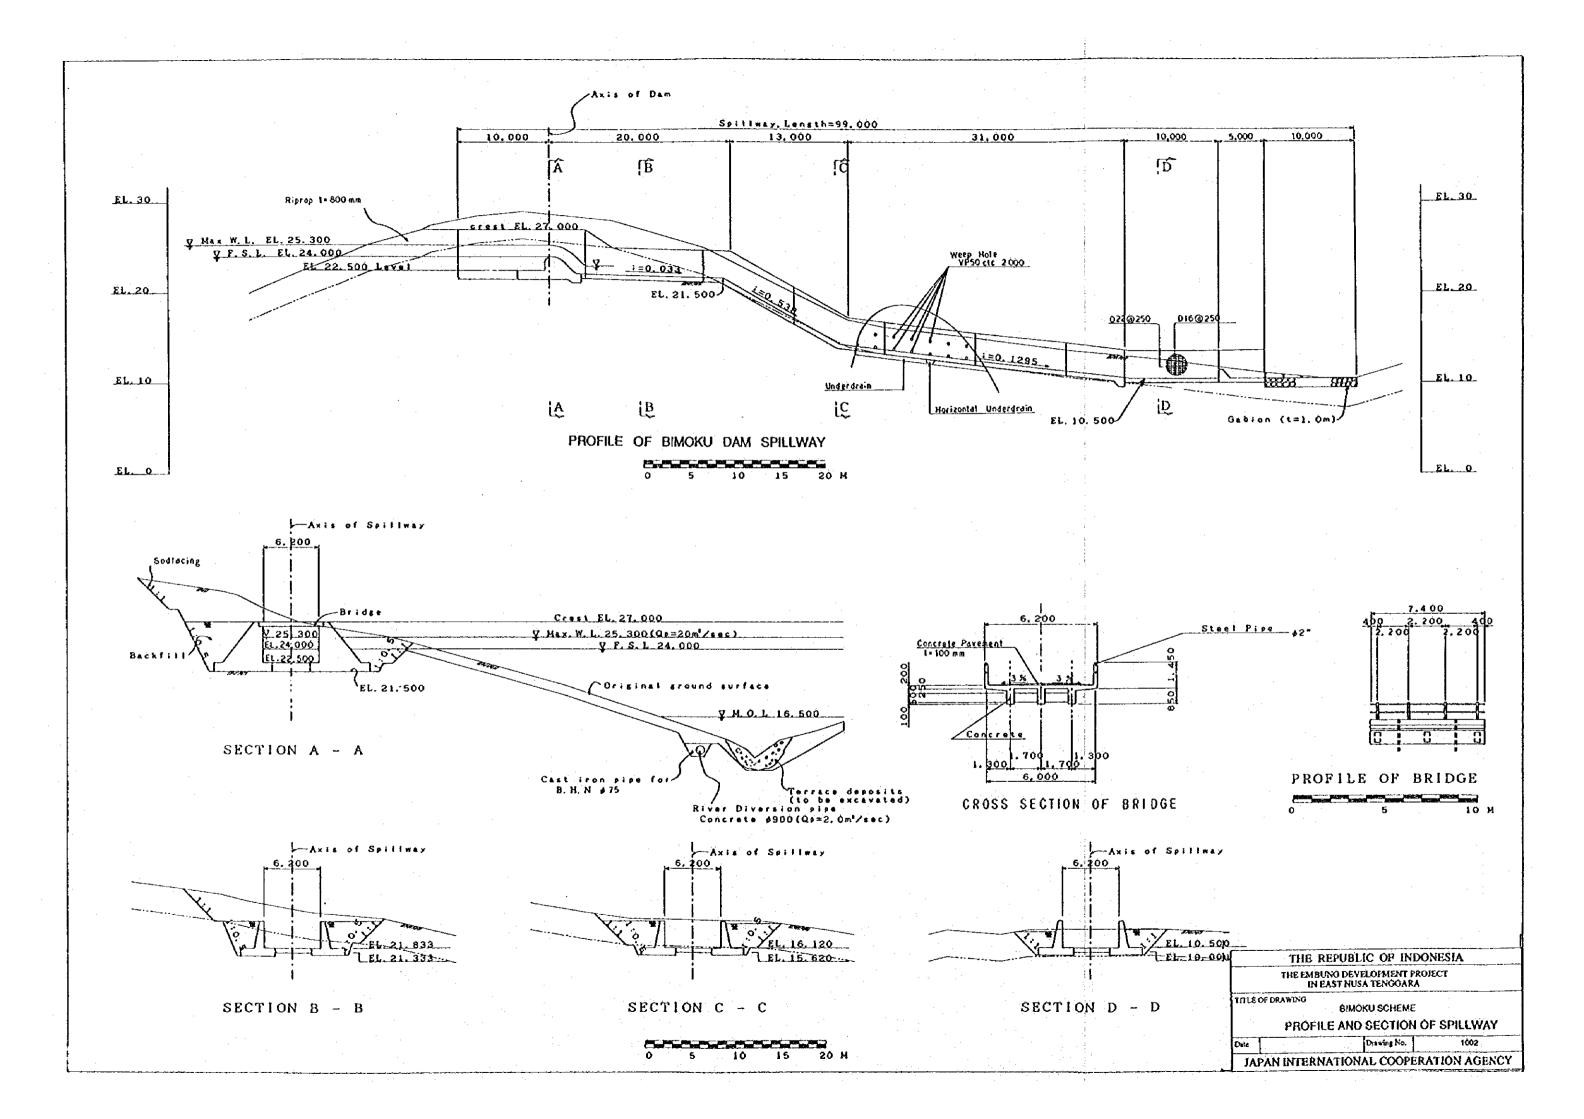

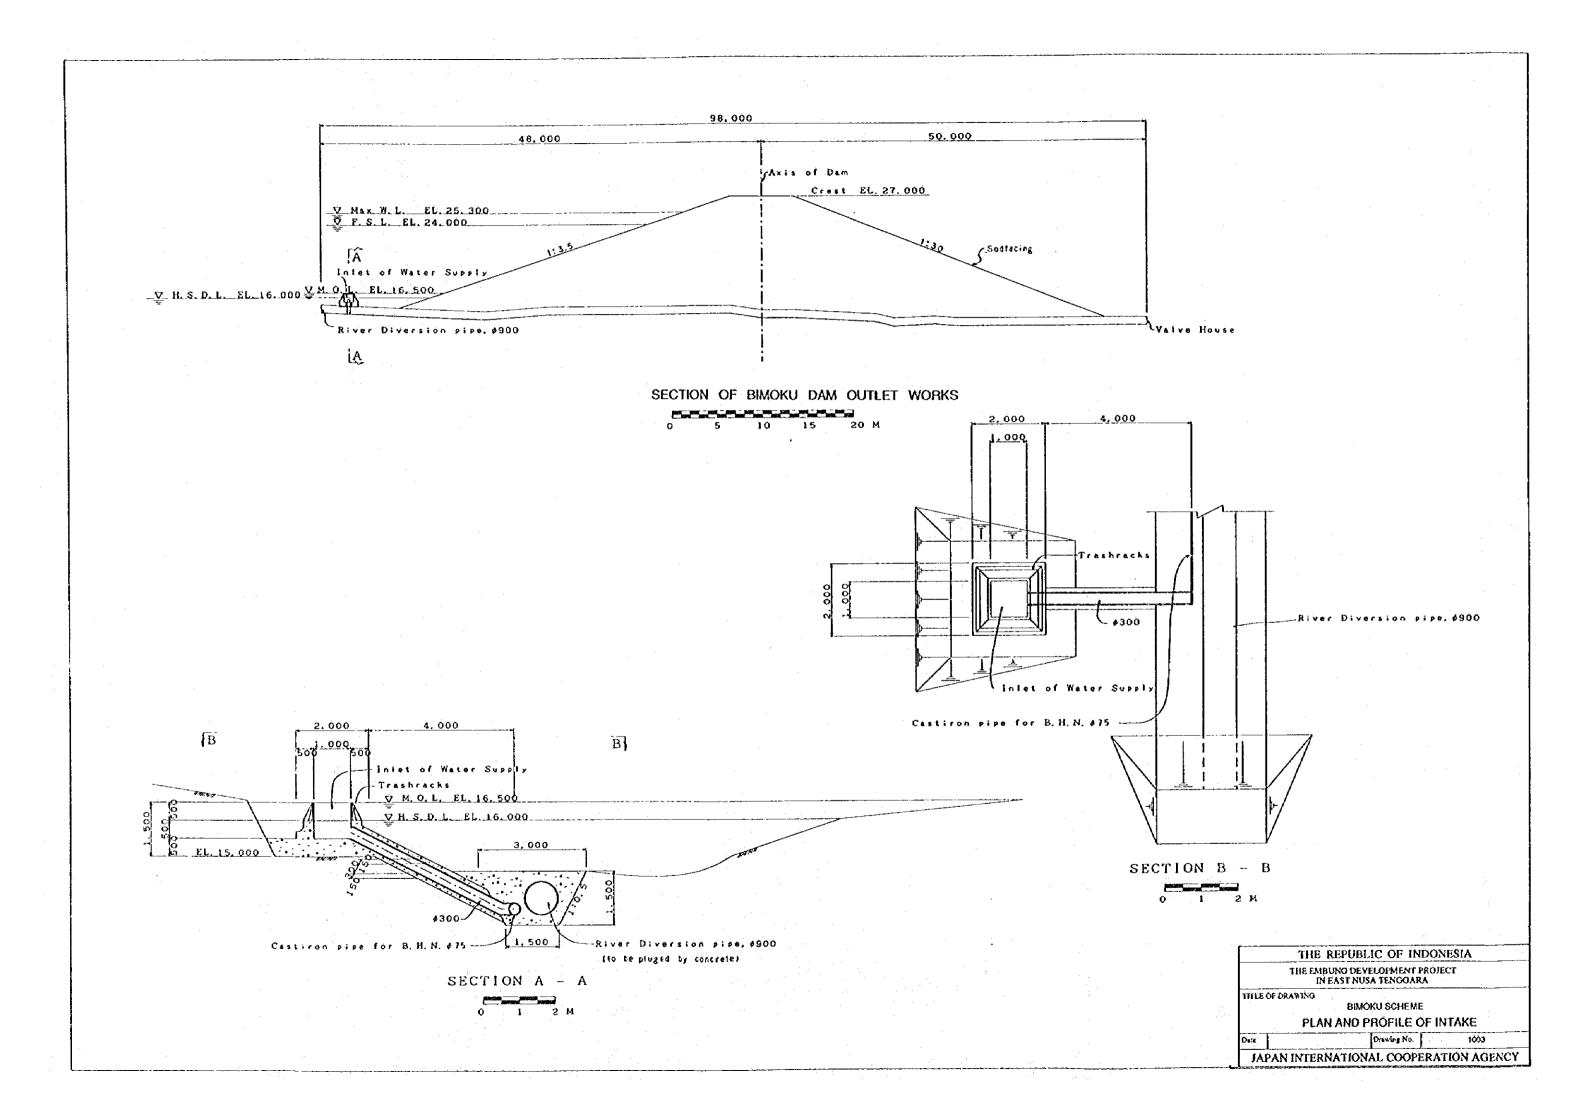

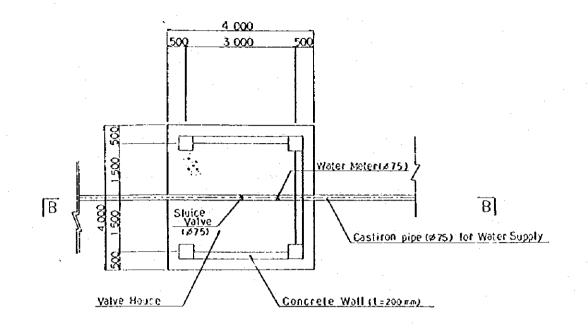

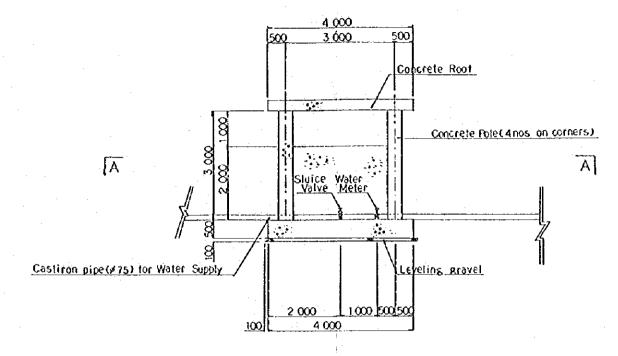

PROFILE OF BIMOKU DAM VALVE HOUSE




LONGITUDINAL SECTION OF VALVE HOUSE


THE REPUBLIC OF INDONESIA

THE EMBUNO DEVELOPMENT PROJECT
IN EAST NUSA TENGGARA


THE OF DRAWING
BIMOKU SCHEME
PLAN AND PROFILE OF VALVE HOUSE

Date Drawing No. 1004
JAPAN INTERNATIONAL COOPERATION AGENCY

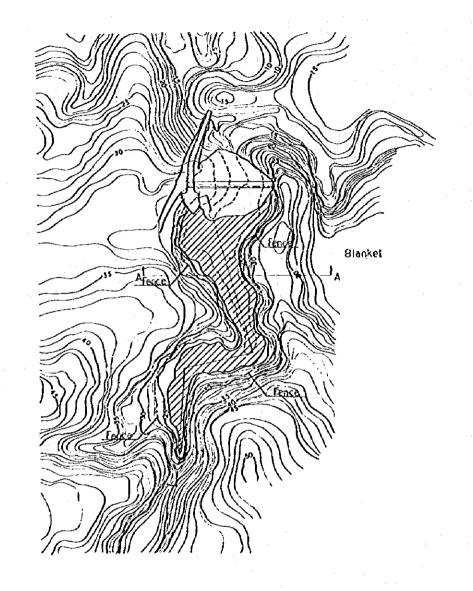

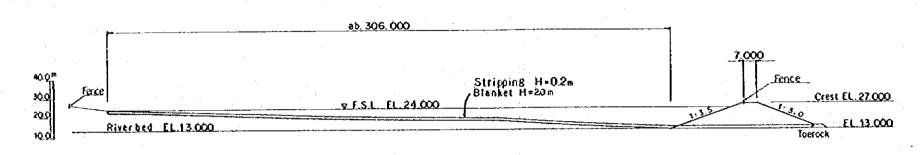


LONGITUDINAL SECTION OF BLANKET

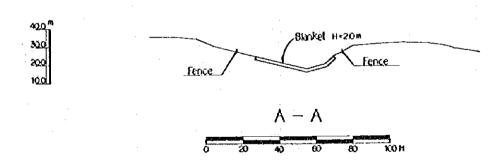



PLAN OF BIMOKU RESERVOIR AREA BLANKET AND FENCE







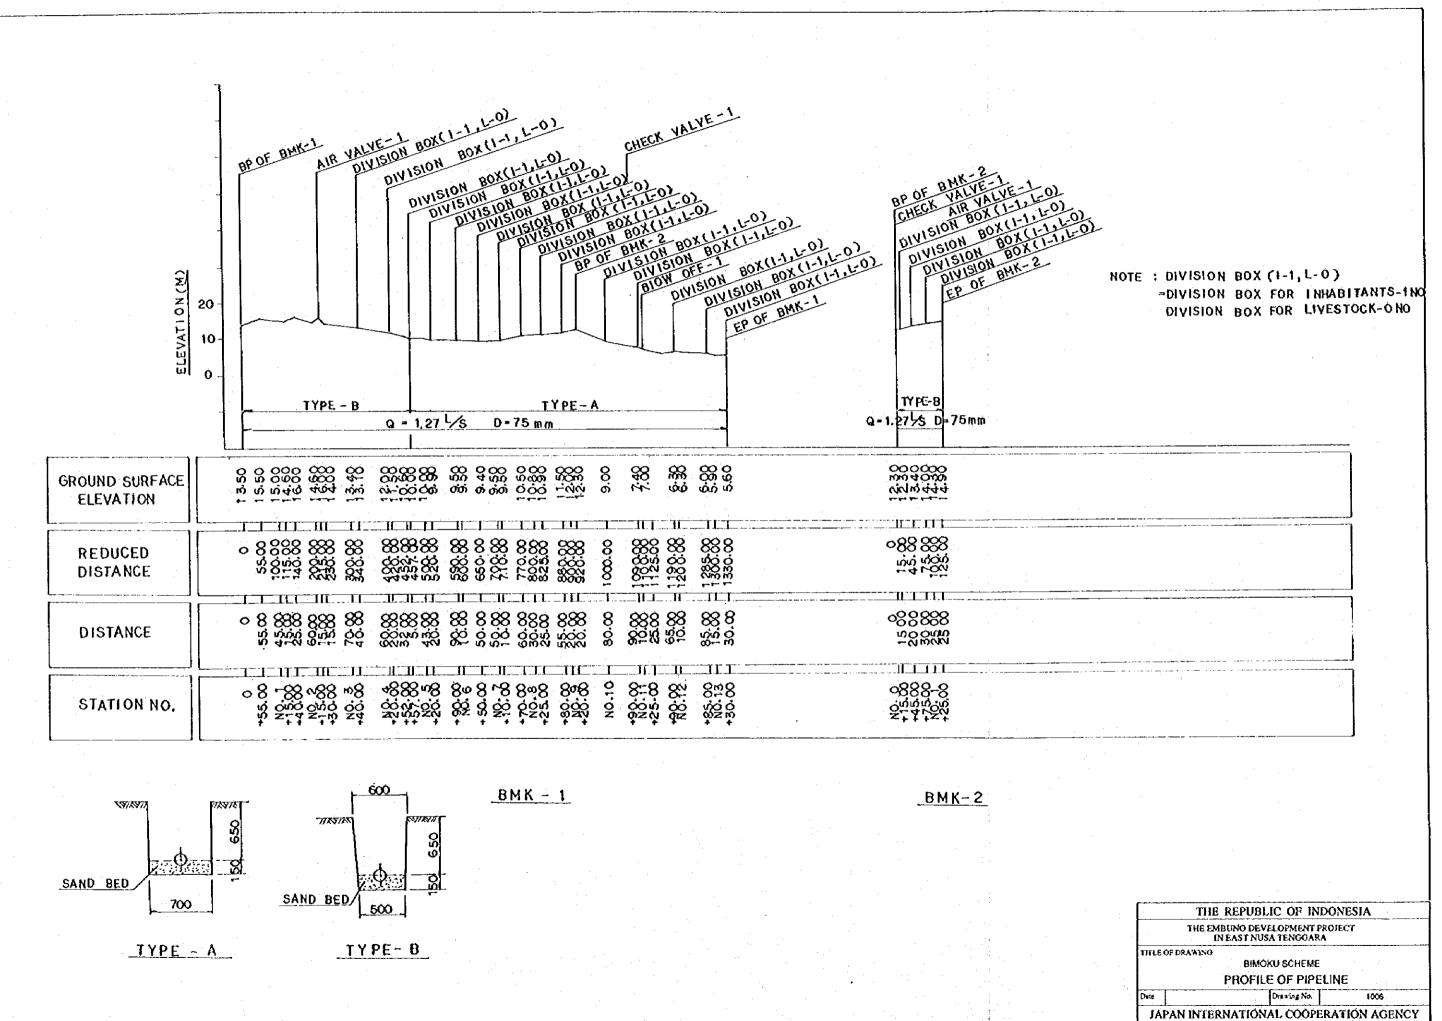


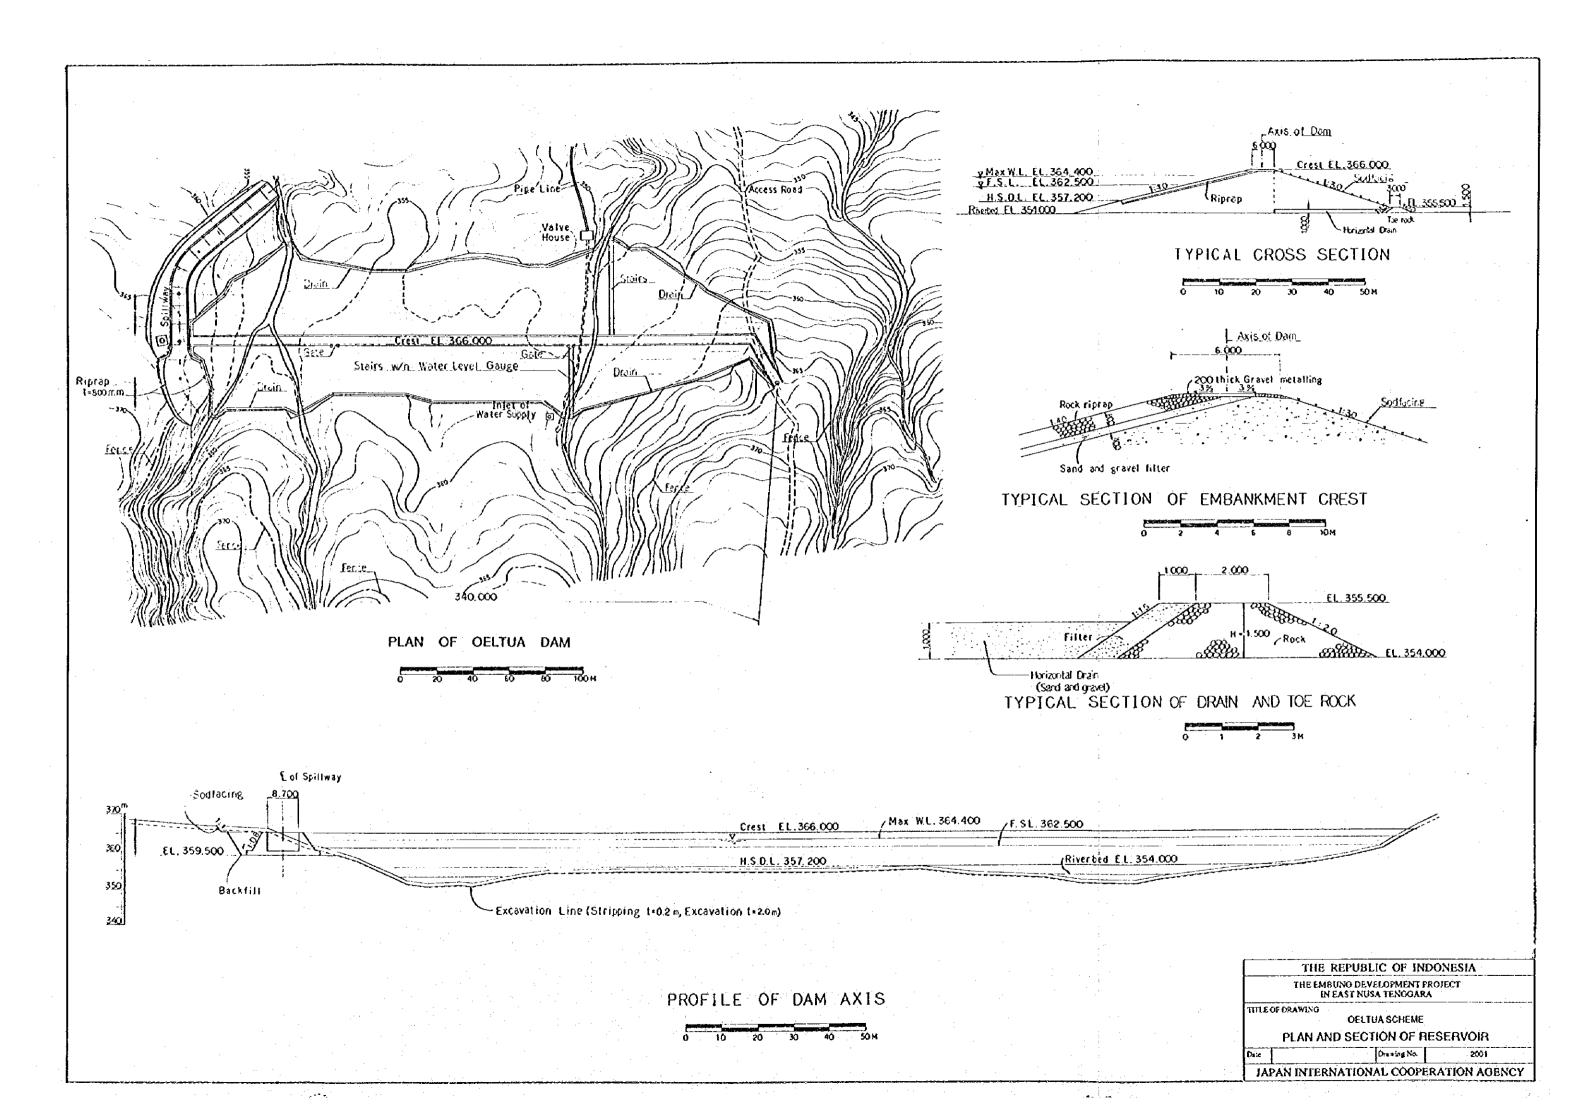

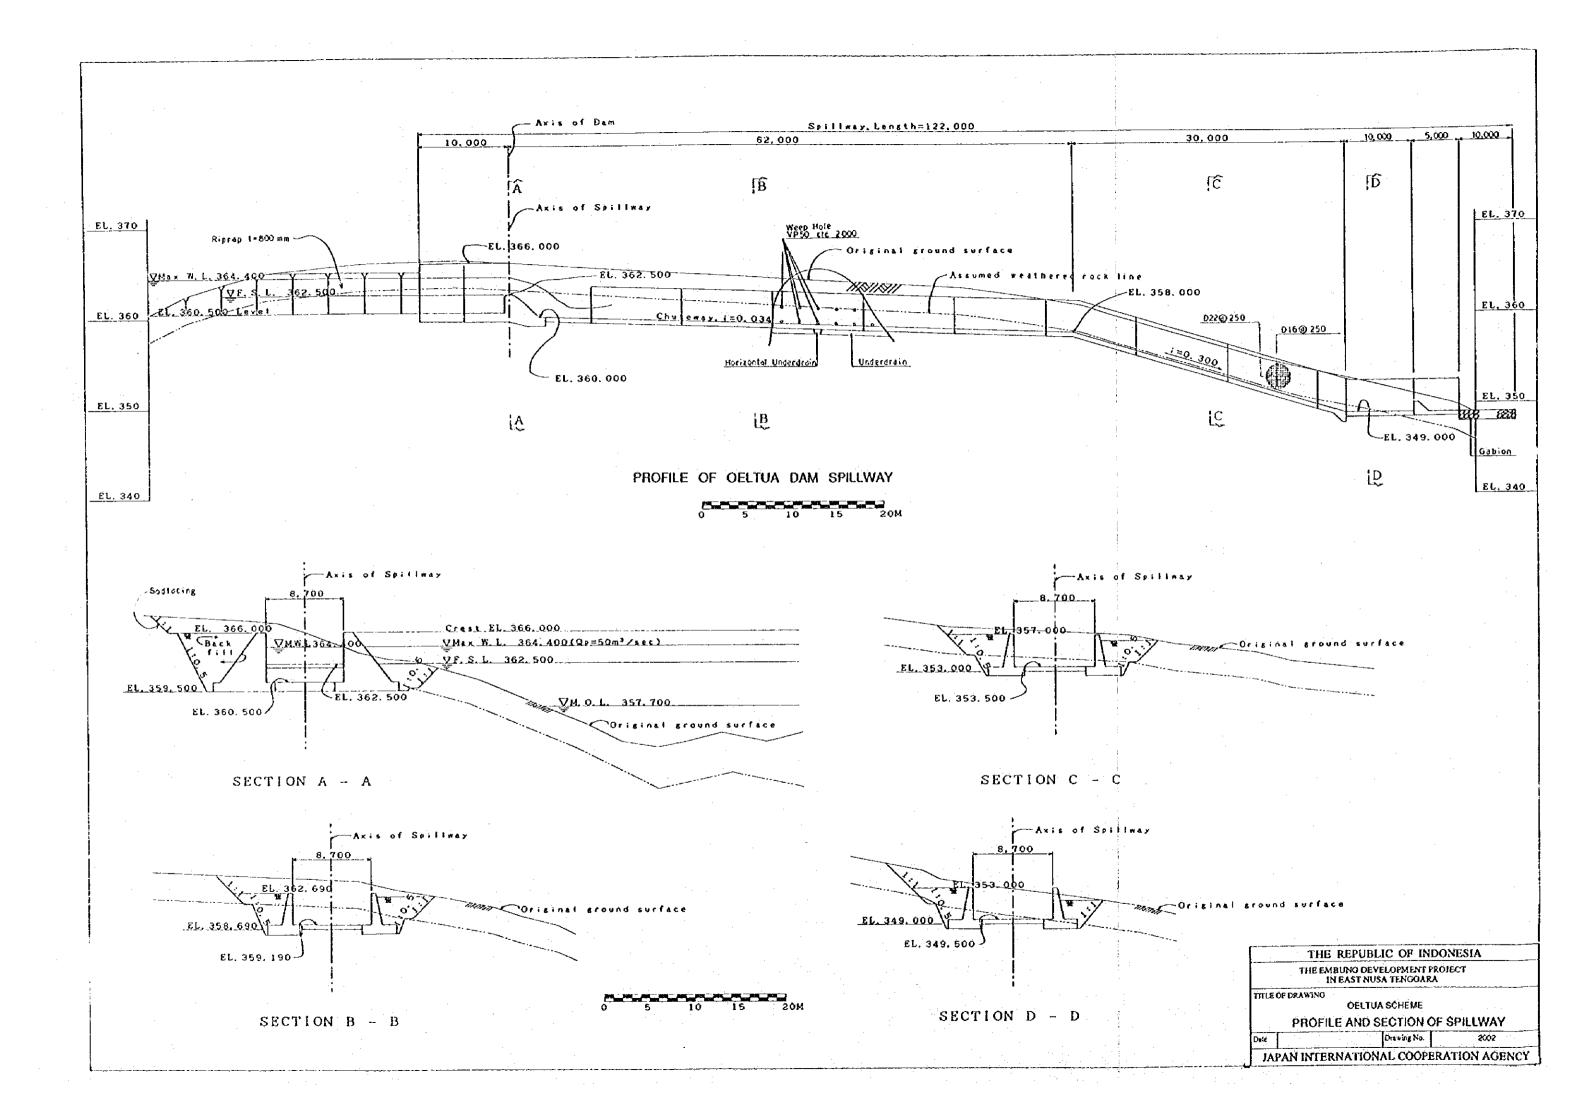

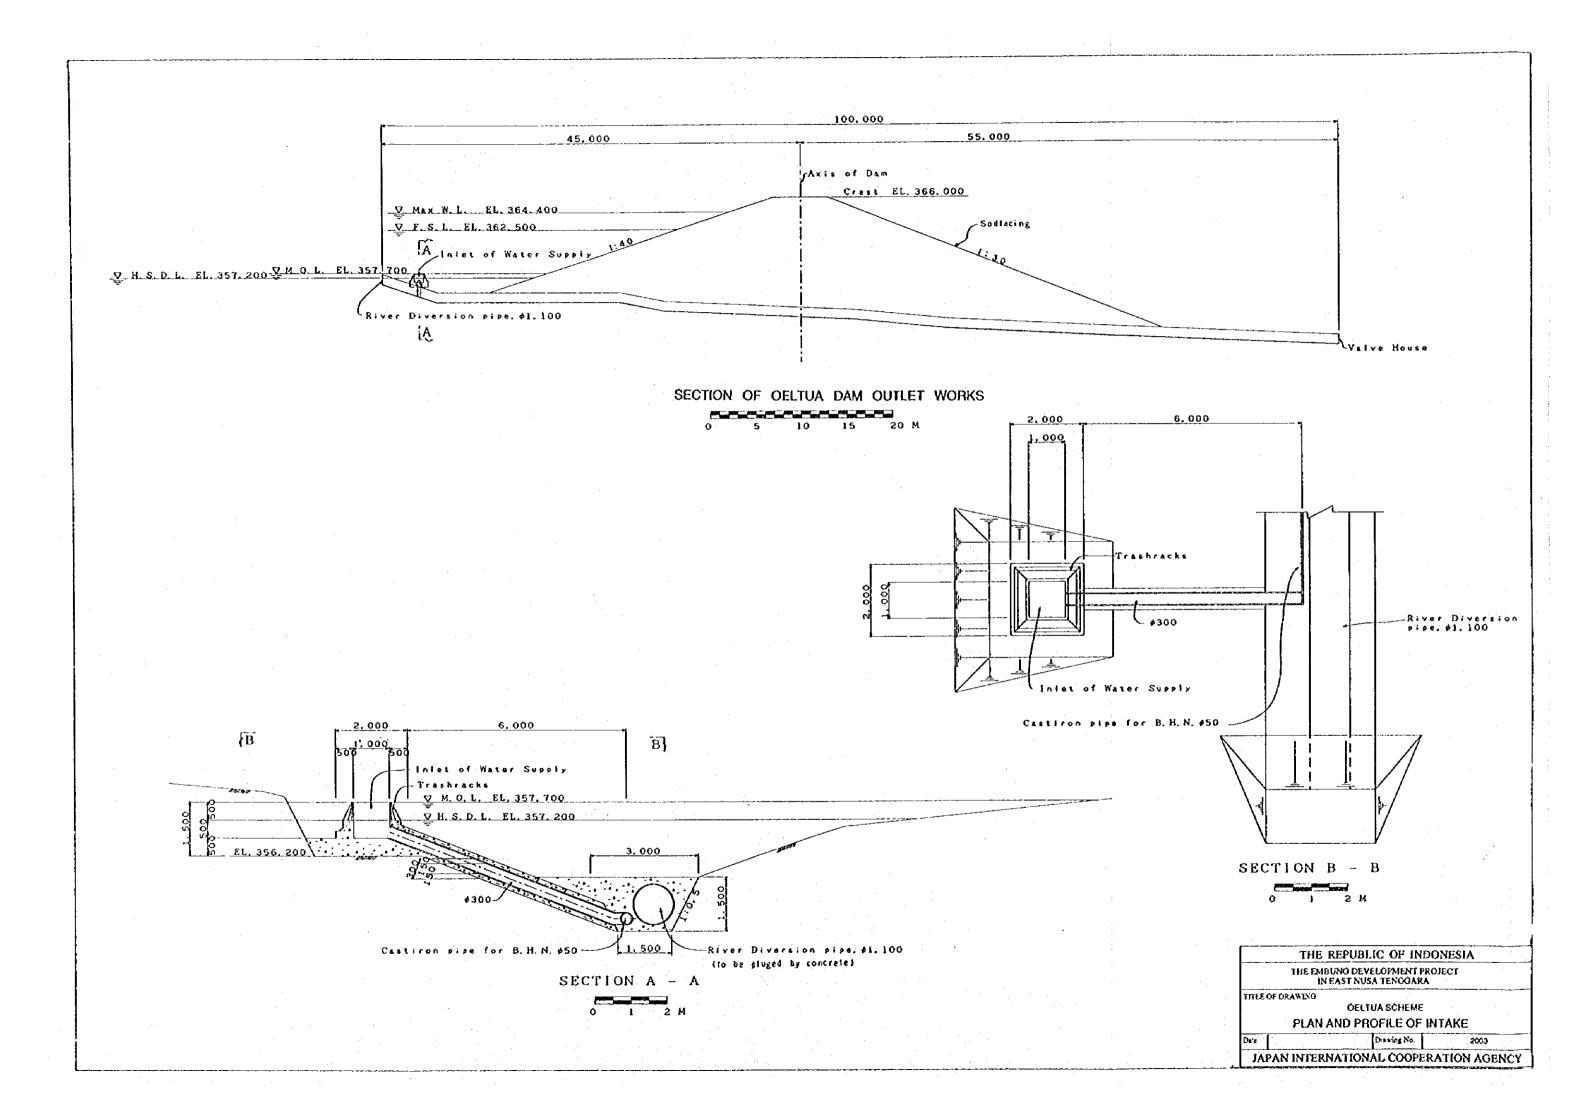

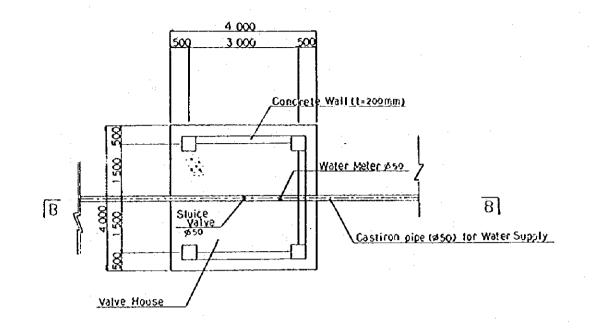

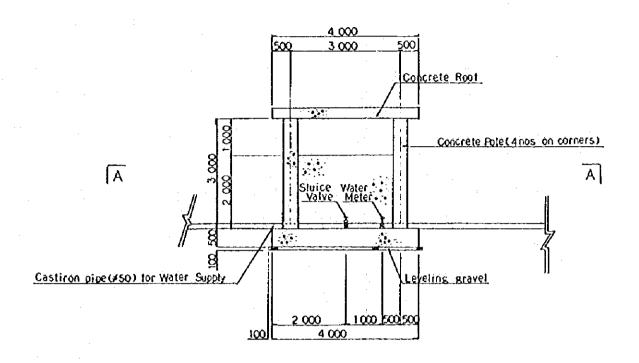

PROFILE OF OELTUA DAM VALVE HOUSE



LONGITUDINAL SECTION OF VALVE HOUSE

THE REPUBLIC OF INDONESIA

THE EMBUNG DEVELOPMENT PROJECT
IN EAST NUSA TENGGARA

TITLE OF DRAWING

OCLITIA SCHEME


PLAN AND PROFILE OF VALVE HOUSE

Date


Date


Drawing No. 2004

JAPAN INTERNATIONAL COOPERATION AGENCY

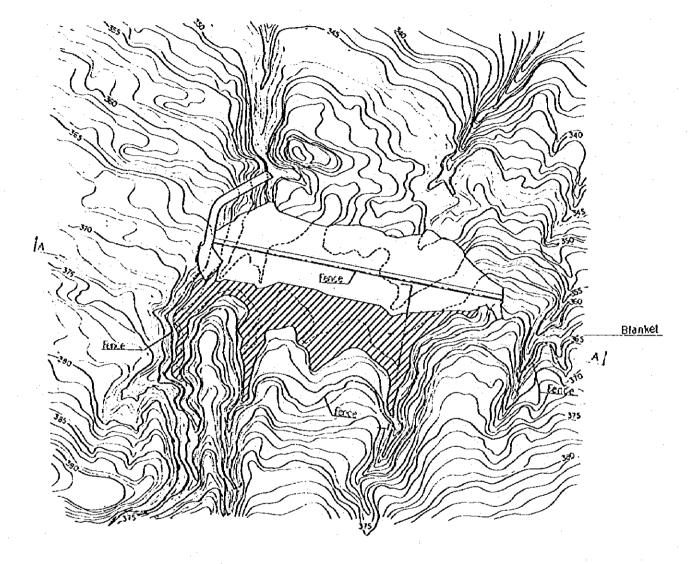

PLAN OF OELTUA RESERVOIR AREA BLANKET AND FENCE

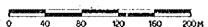


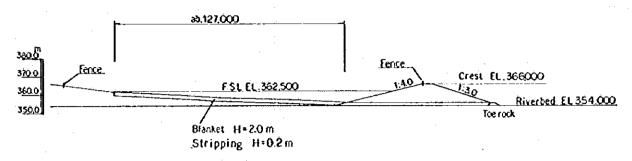


LONGITUDINAL SECTION OF BLANKET AND FENCE







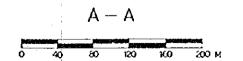





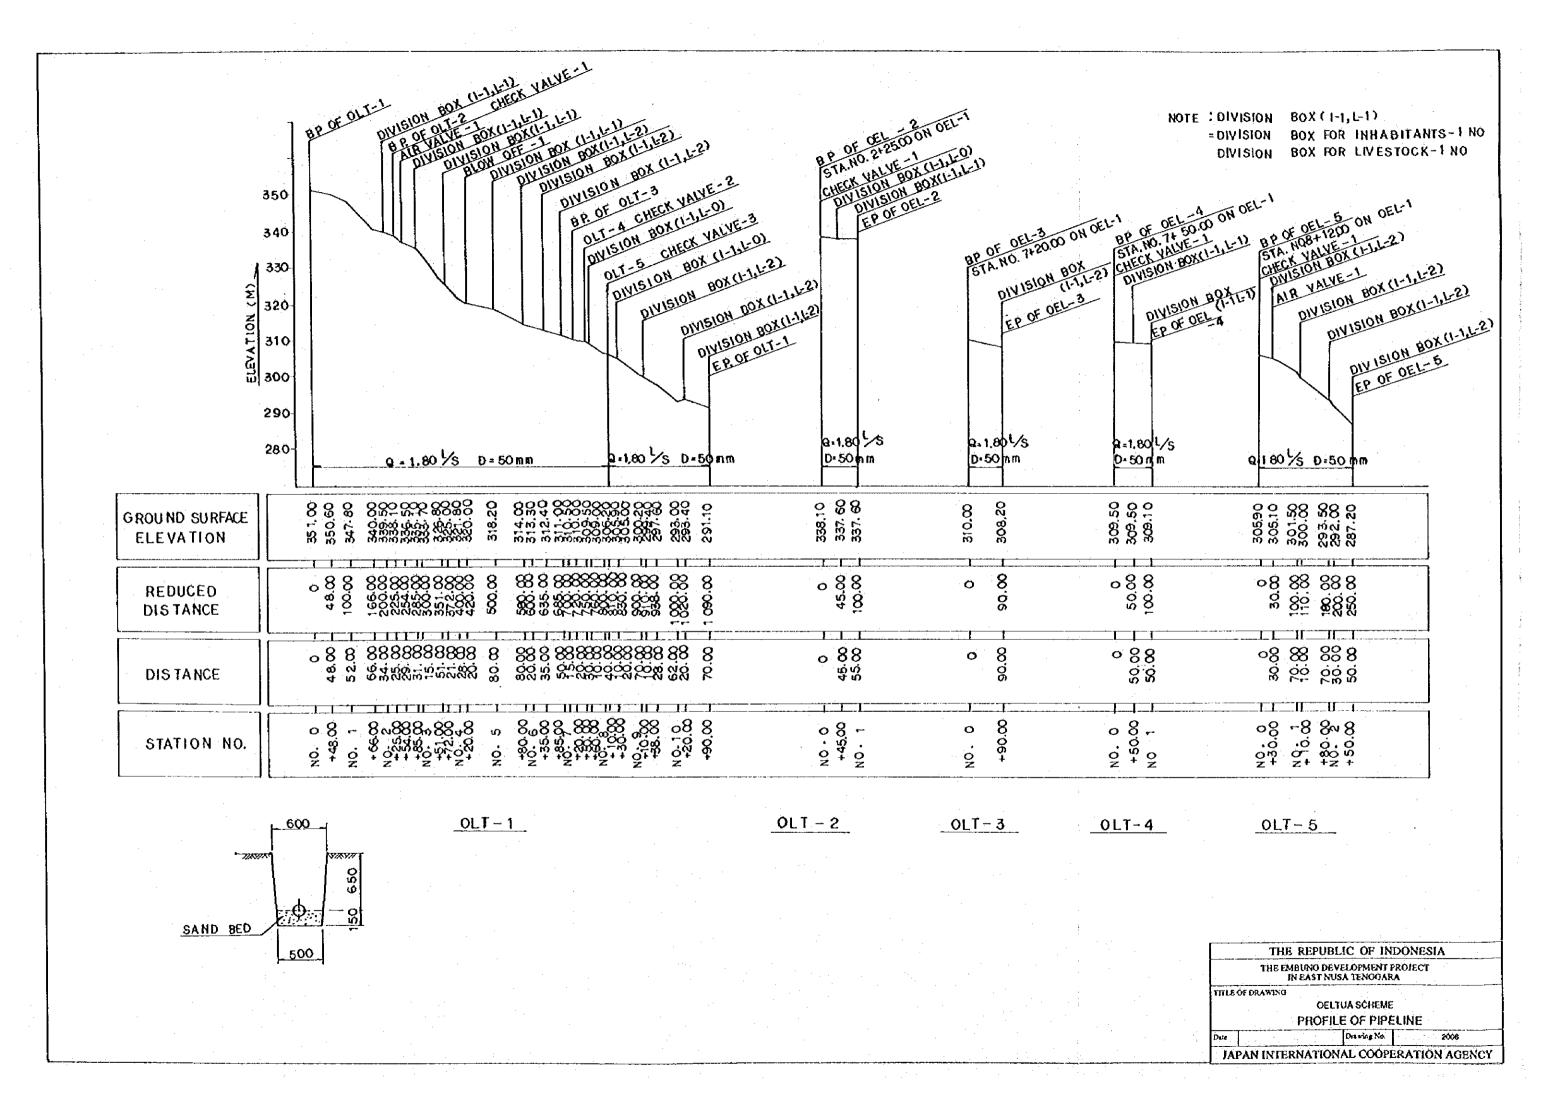


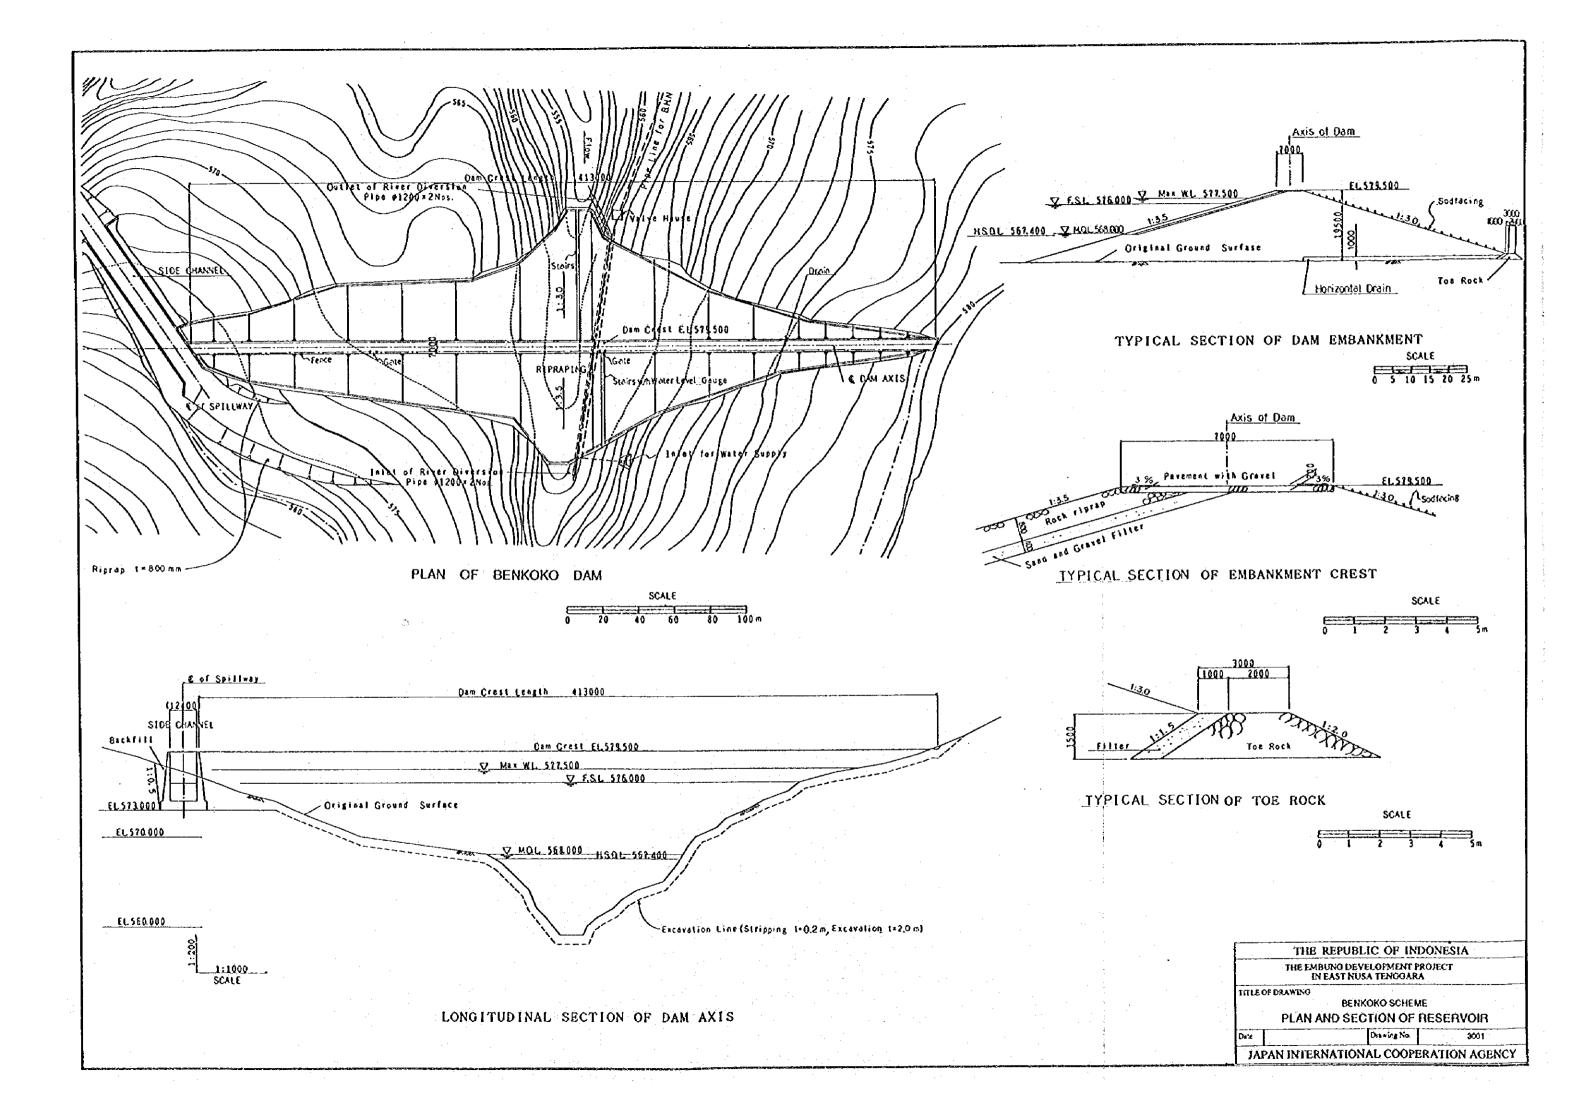

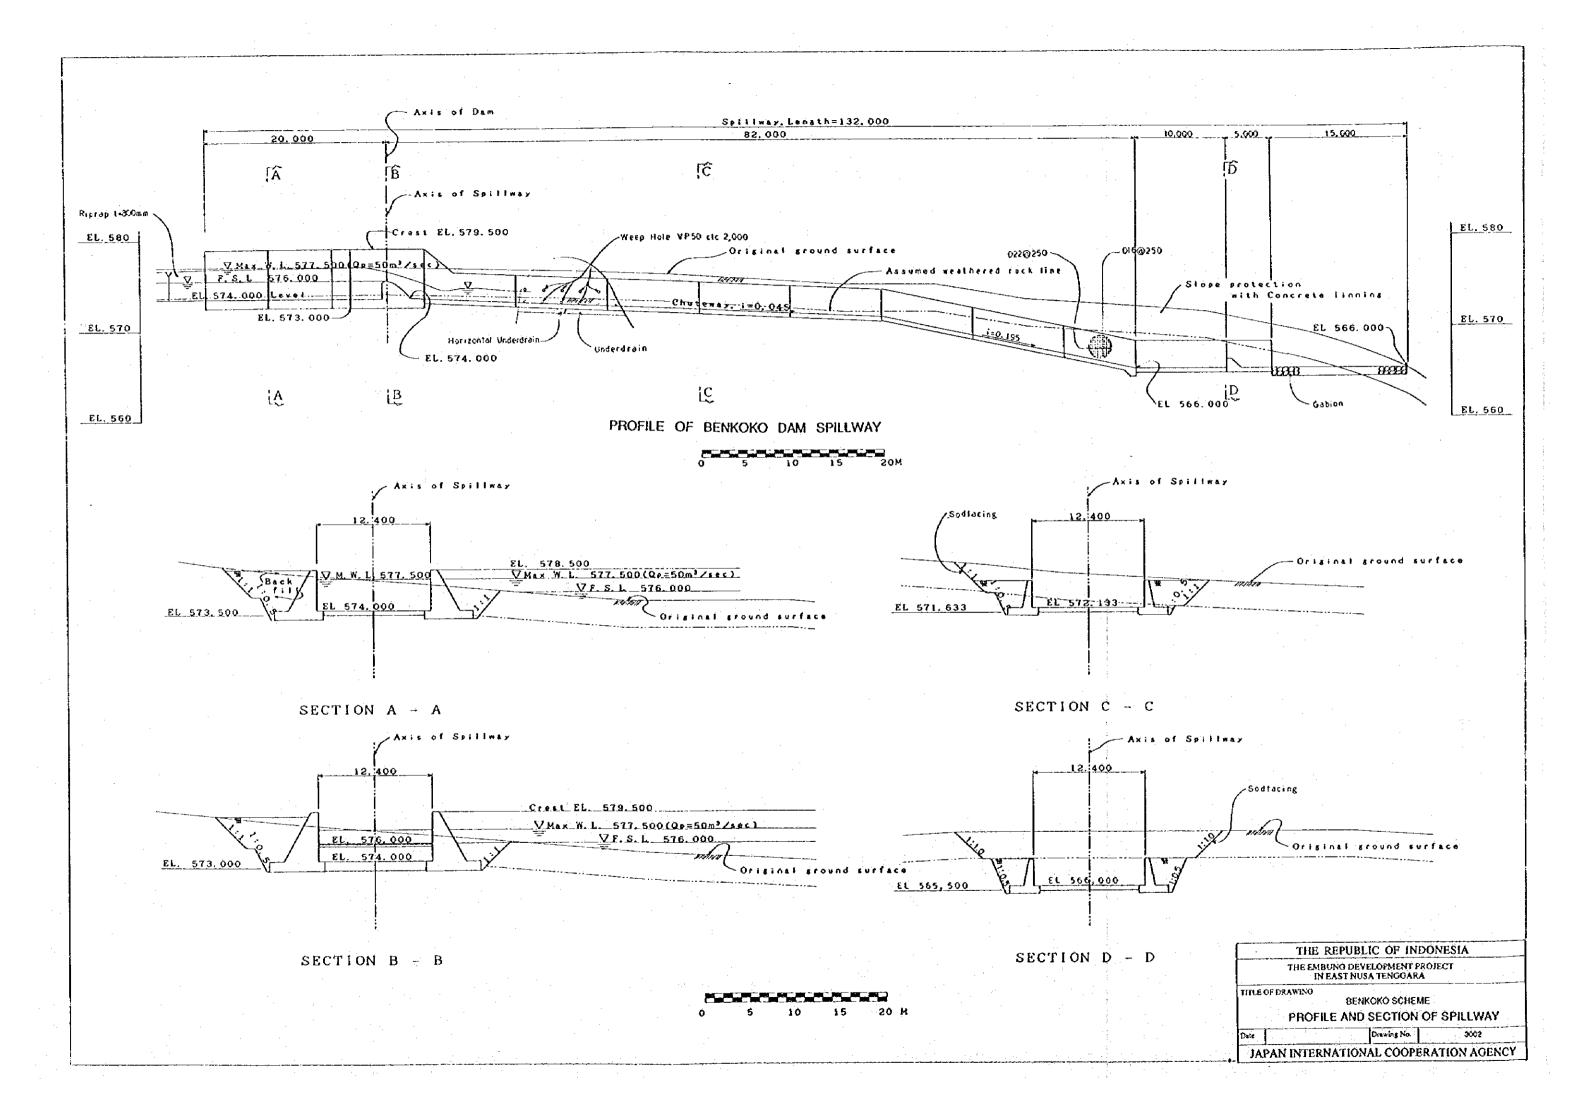

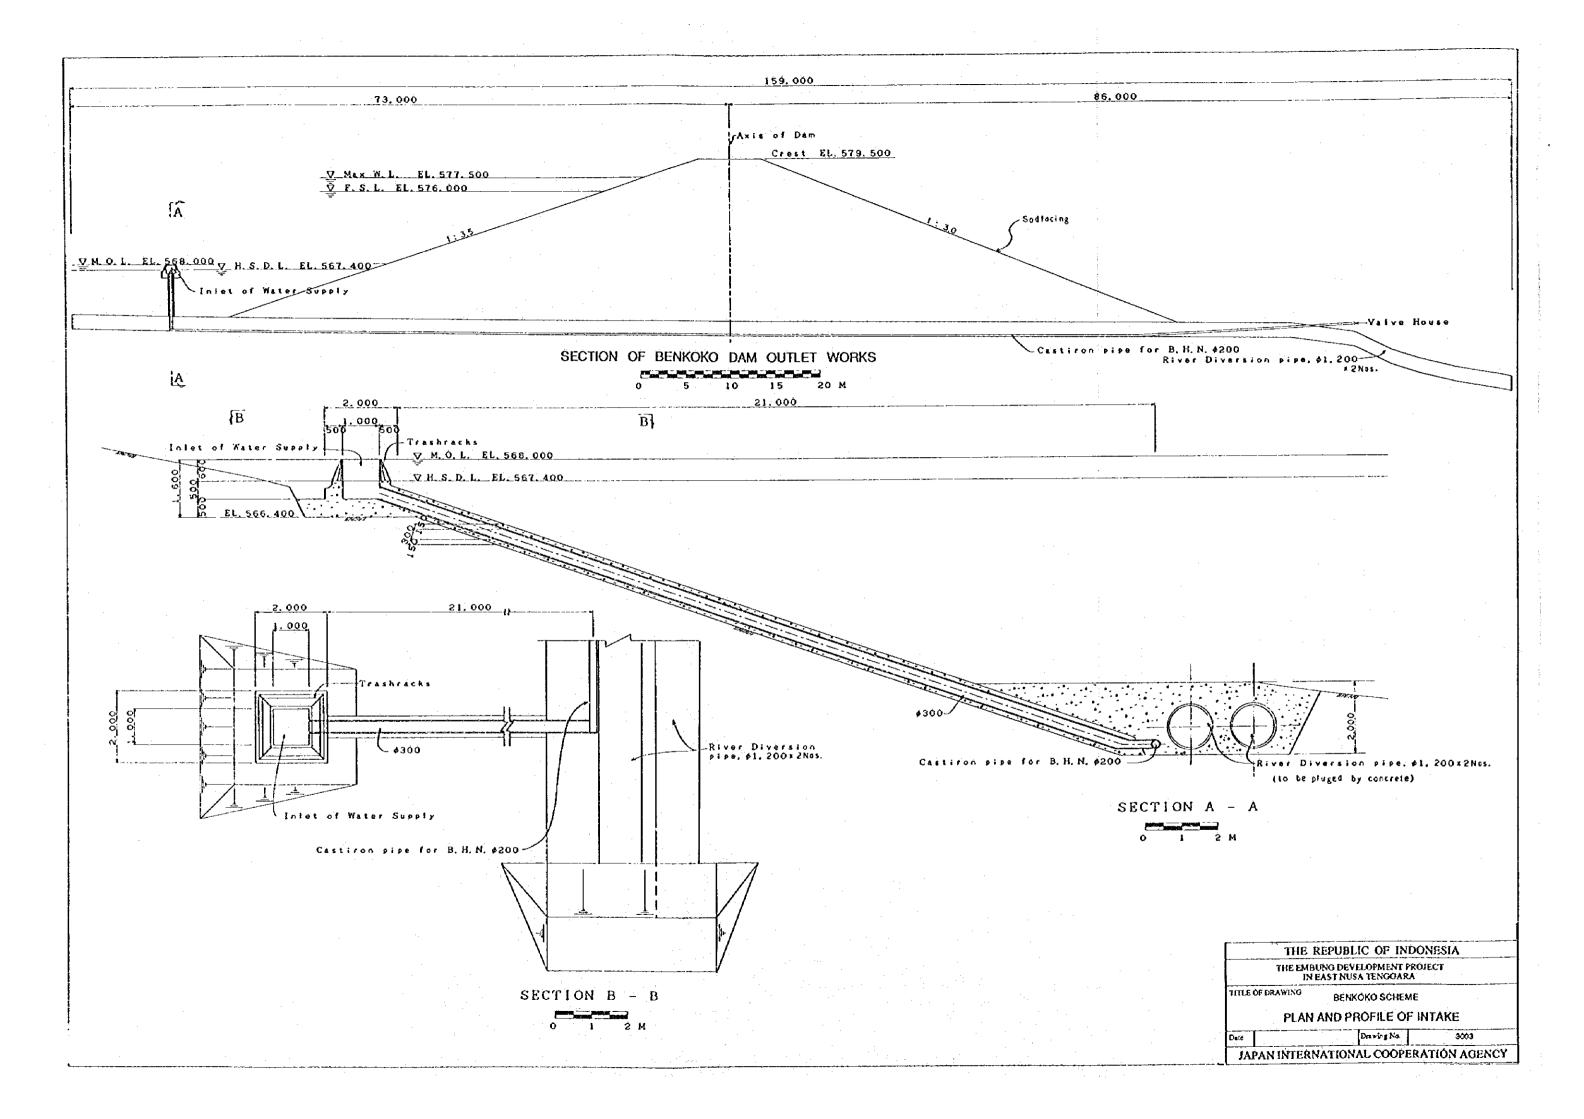

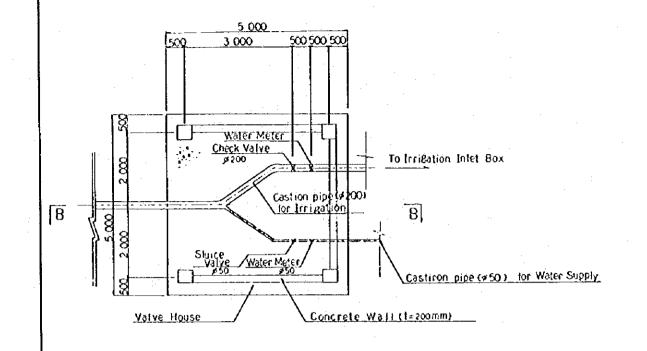

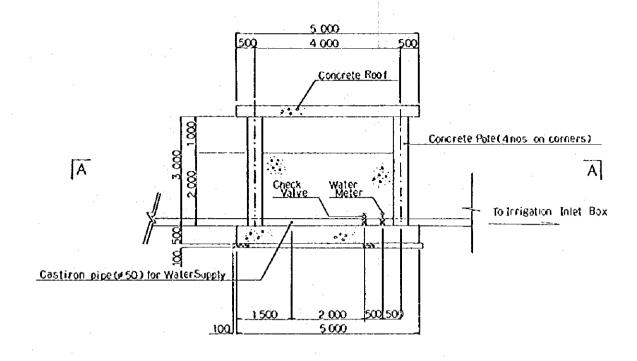

PROFILE OF BENKOKO DAM VALVE HOUSE



LONGITUDINAL SECTION OF VALVE HOUSE

THE REPUBLIC OF INDONESIA

THE EMBUNG DEVELOPMENT PROJECT
IN EAST NUSA TENGGARA


TITLE OF DRAWING


BENKOKO SCHEME


PLAN AND PROFILE OF VALVE HOUSE

Daid Drawing No. 3004


JAPAN INTERNATIONAL COOPERATION AGENCY

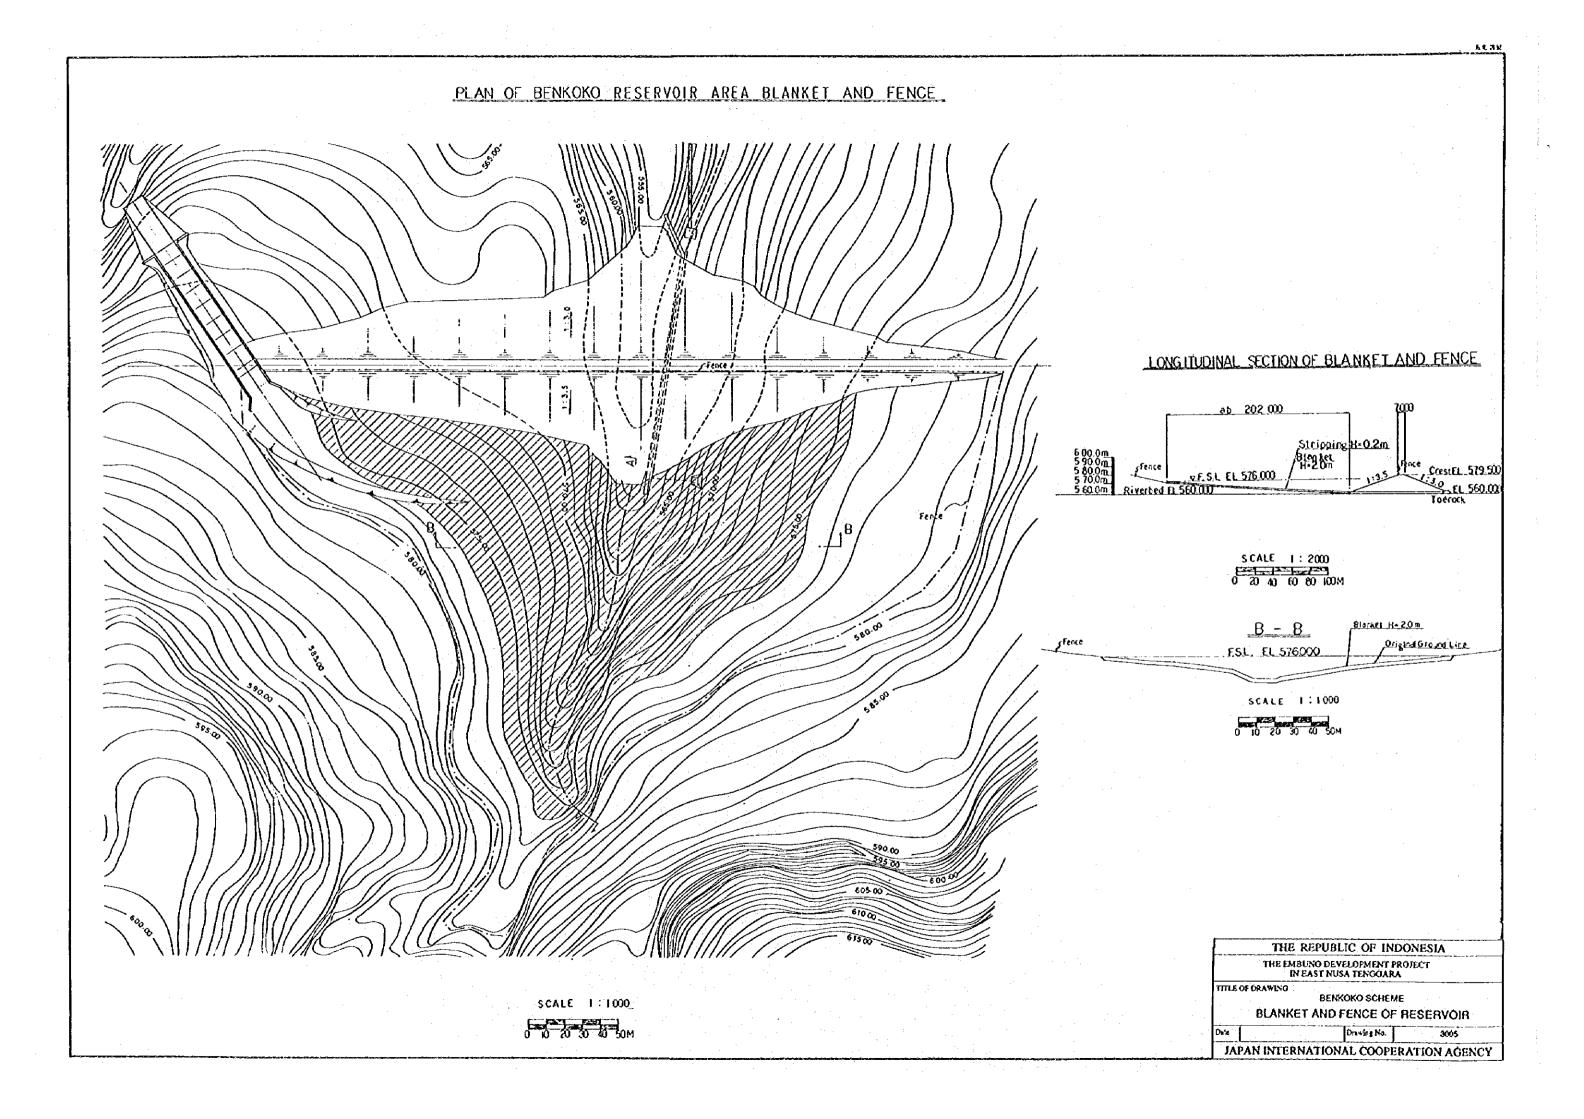


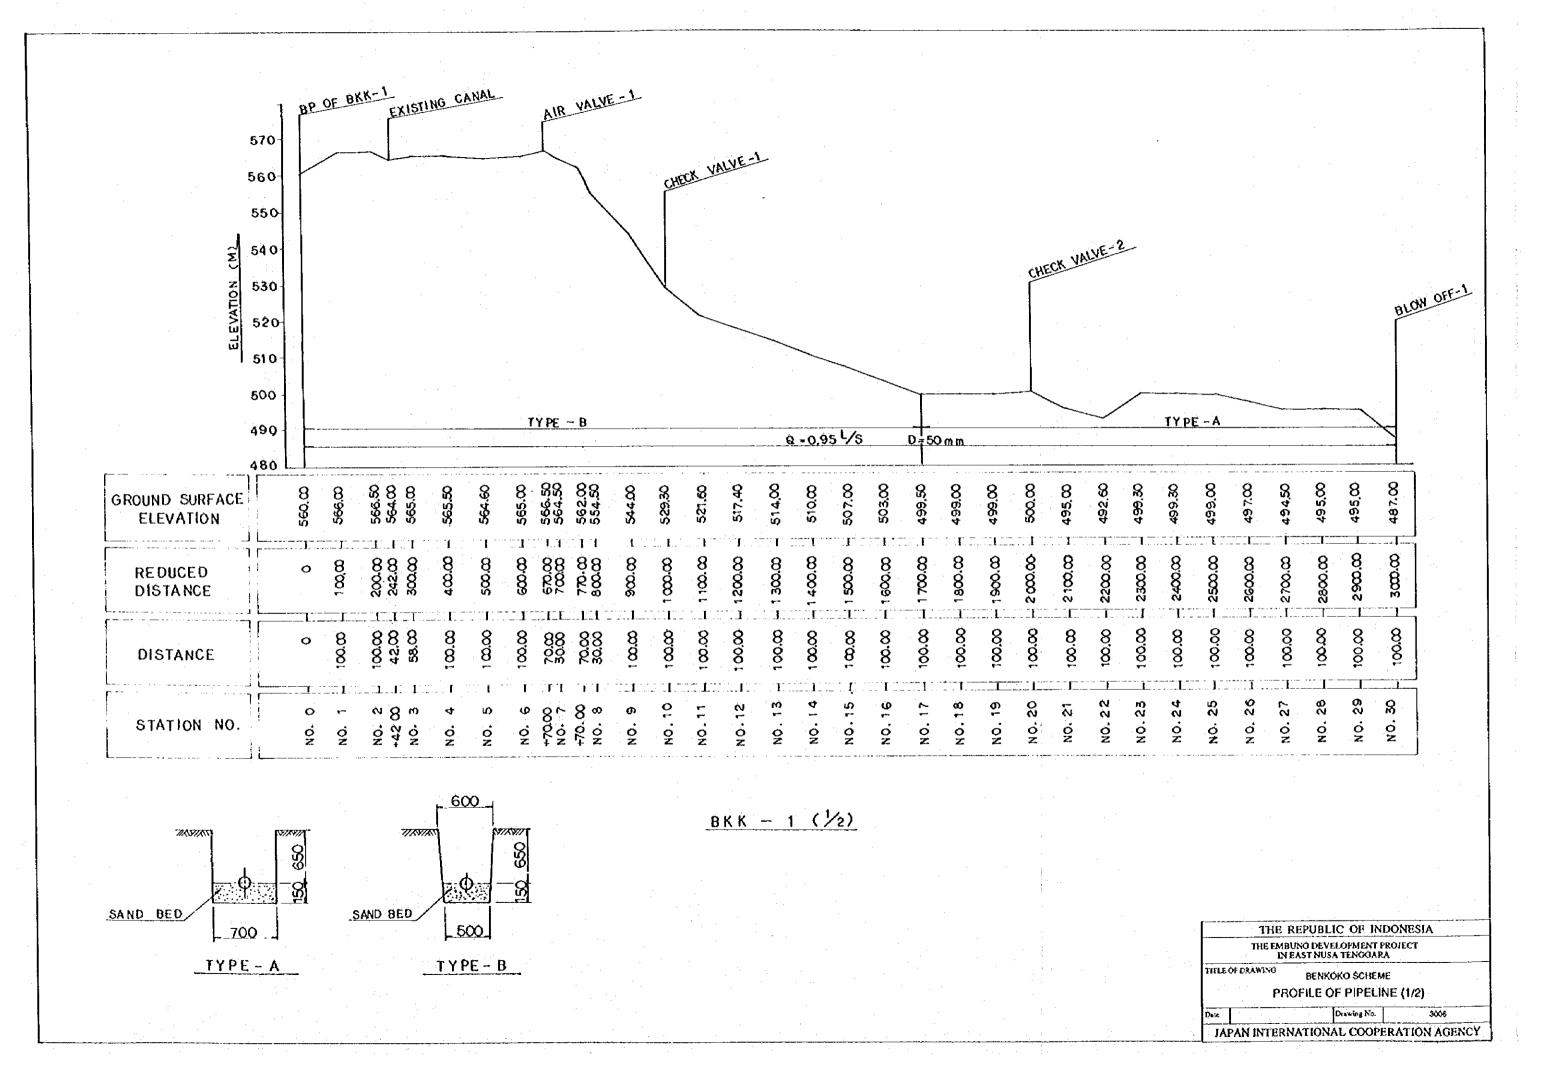

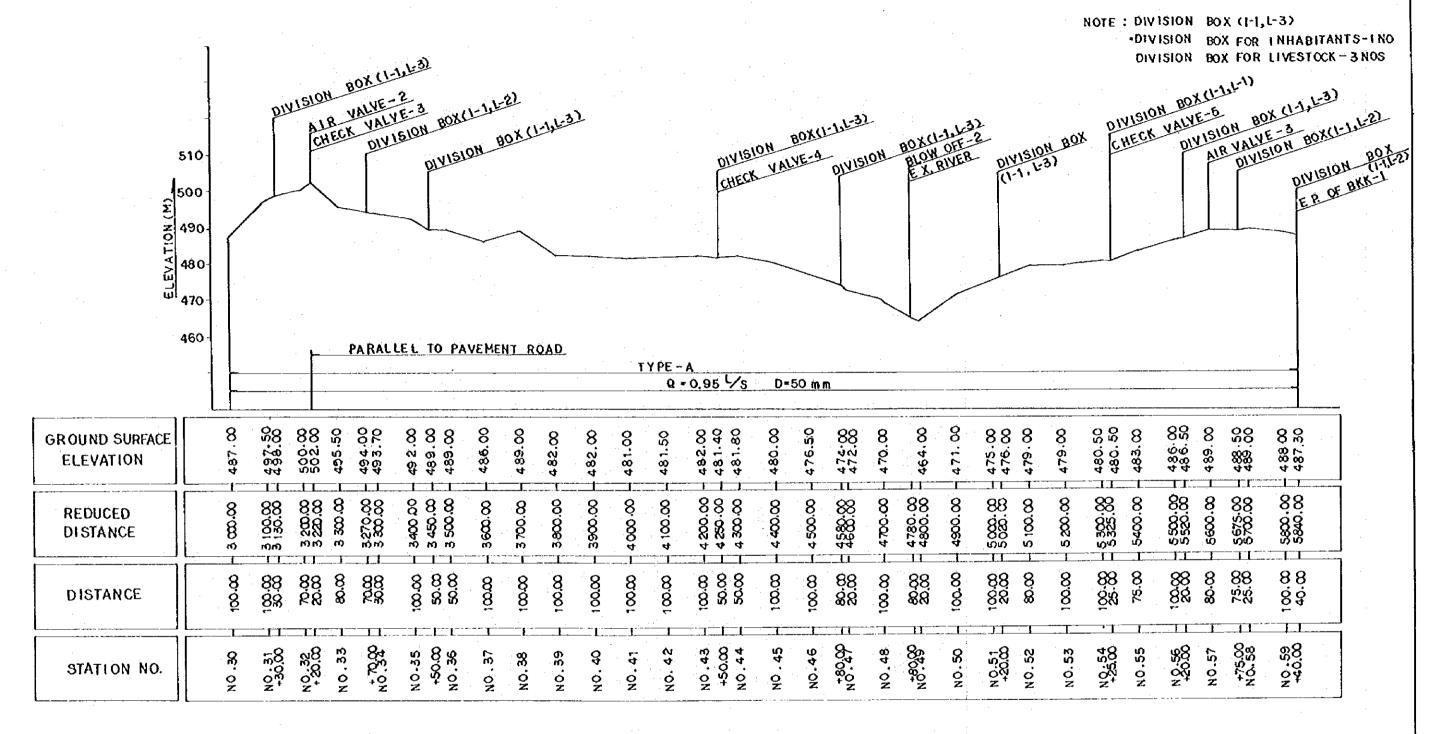

 $BKK-1 (\frac{2}{2})$

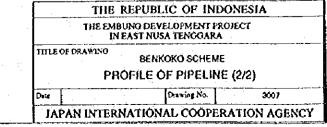

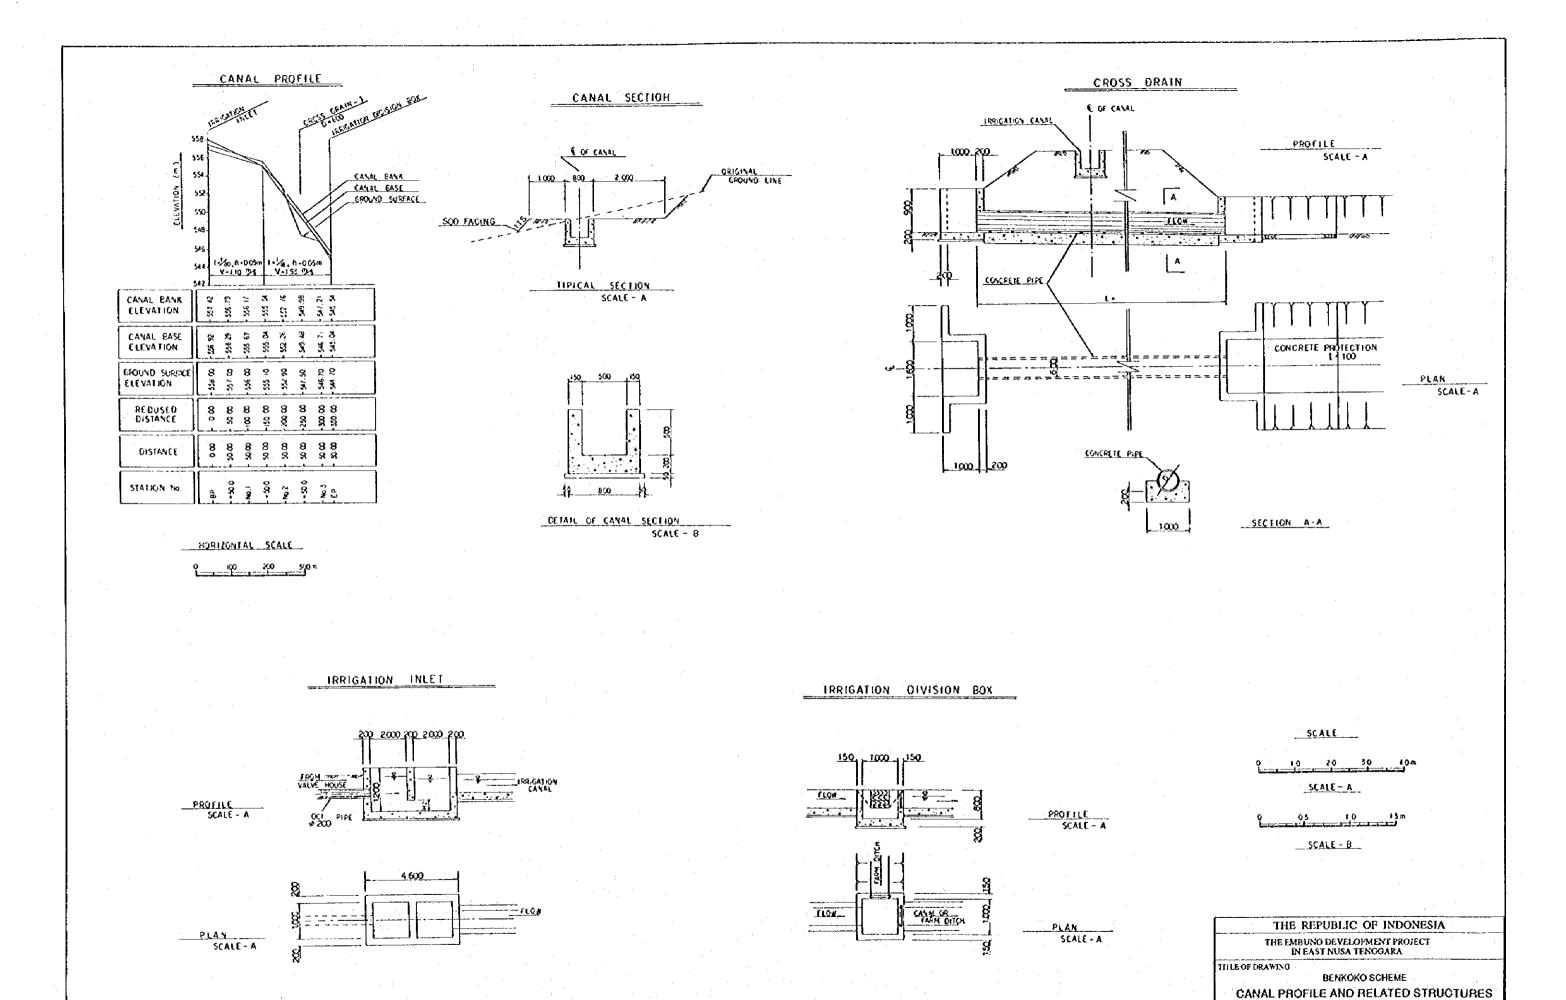


Ē

3008


Drawing No.


JAPAN INTERNATIONAL COOPERATION AGENCY

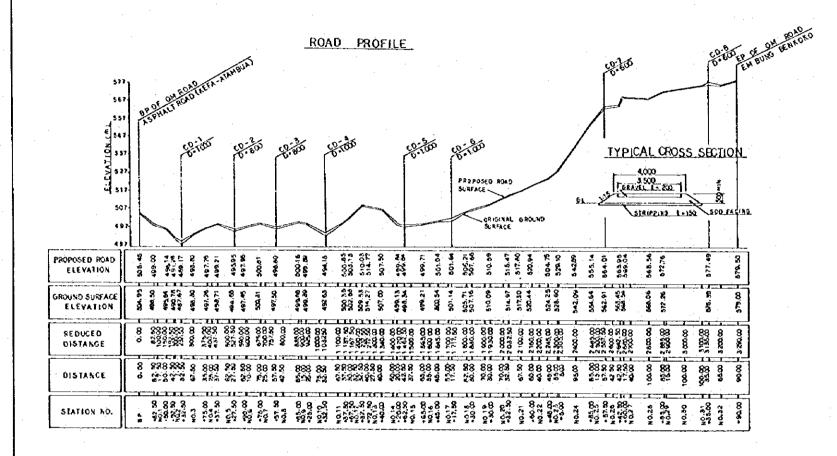



NORIZONTAL SCALE


CROSS DRAIN _2000 ^{*}(3000) CONCRETE PIPE VPLAIN CONCRETE 0-600 (-2000 0-800 (-3000 0-1000 (-3.000 L -12.000 PROFILE SCALE -A ΓÃ ROW ---PROTECTION CONCRETE LA PLAN SCALE - A

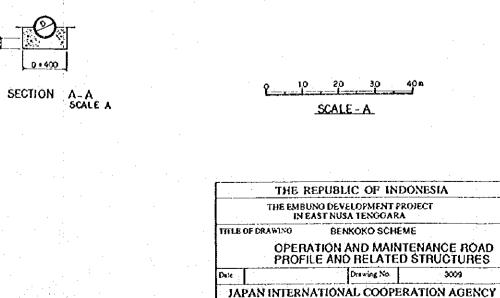


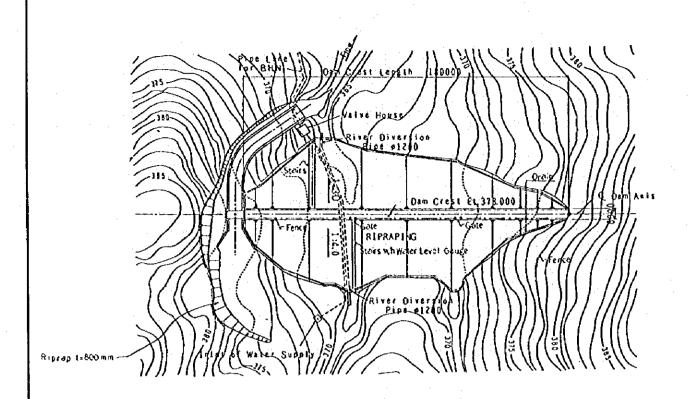

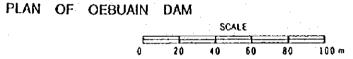


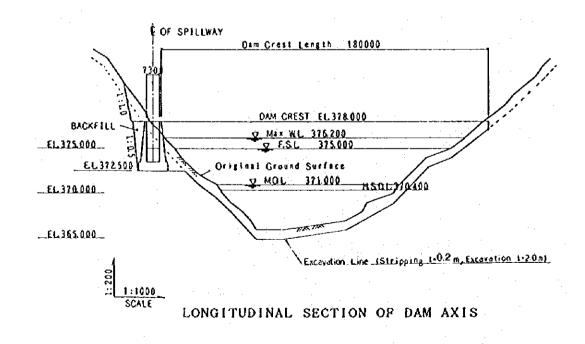


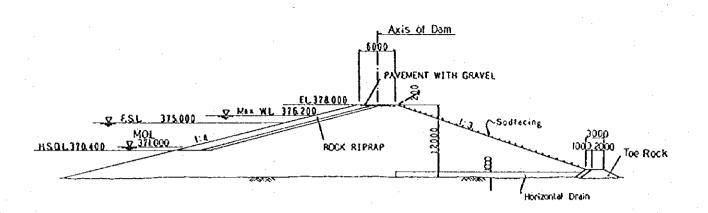


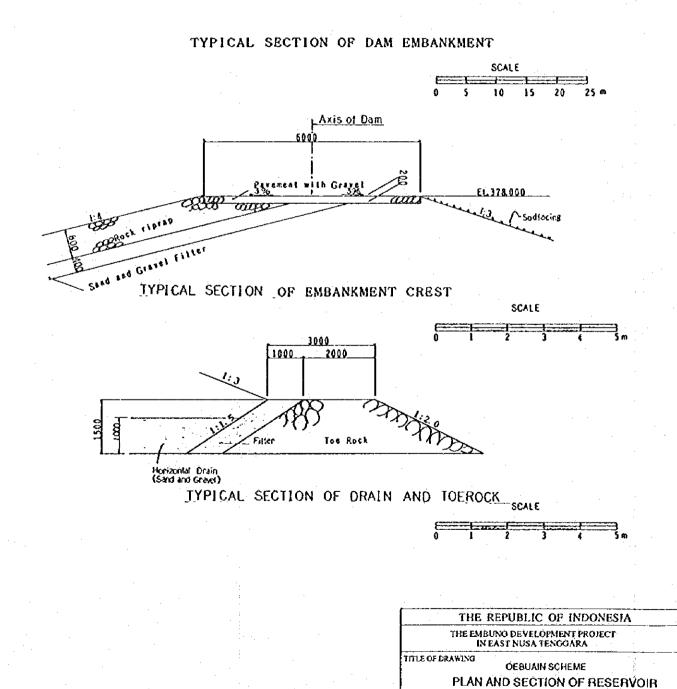


JAPAN INTERNATIONAL COOPERATION ÁGENCY

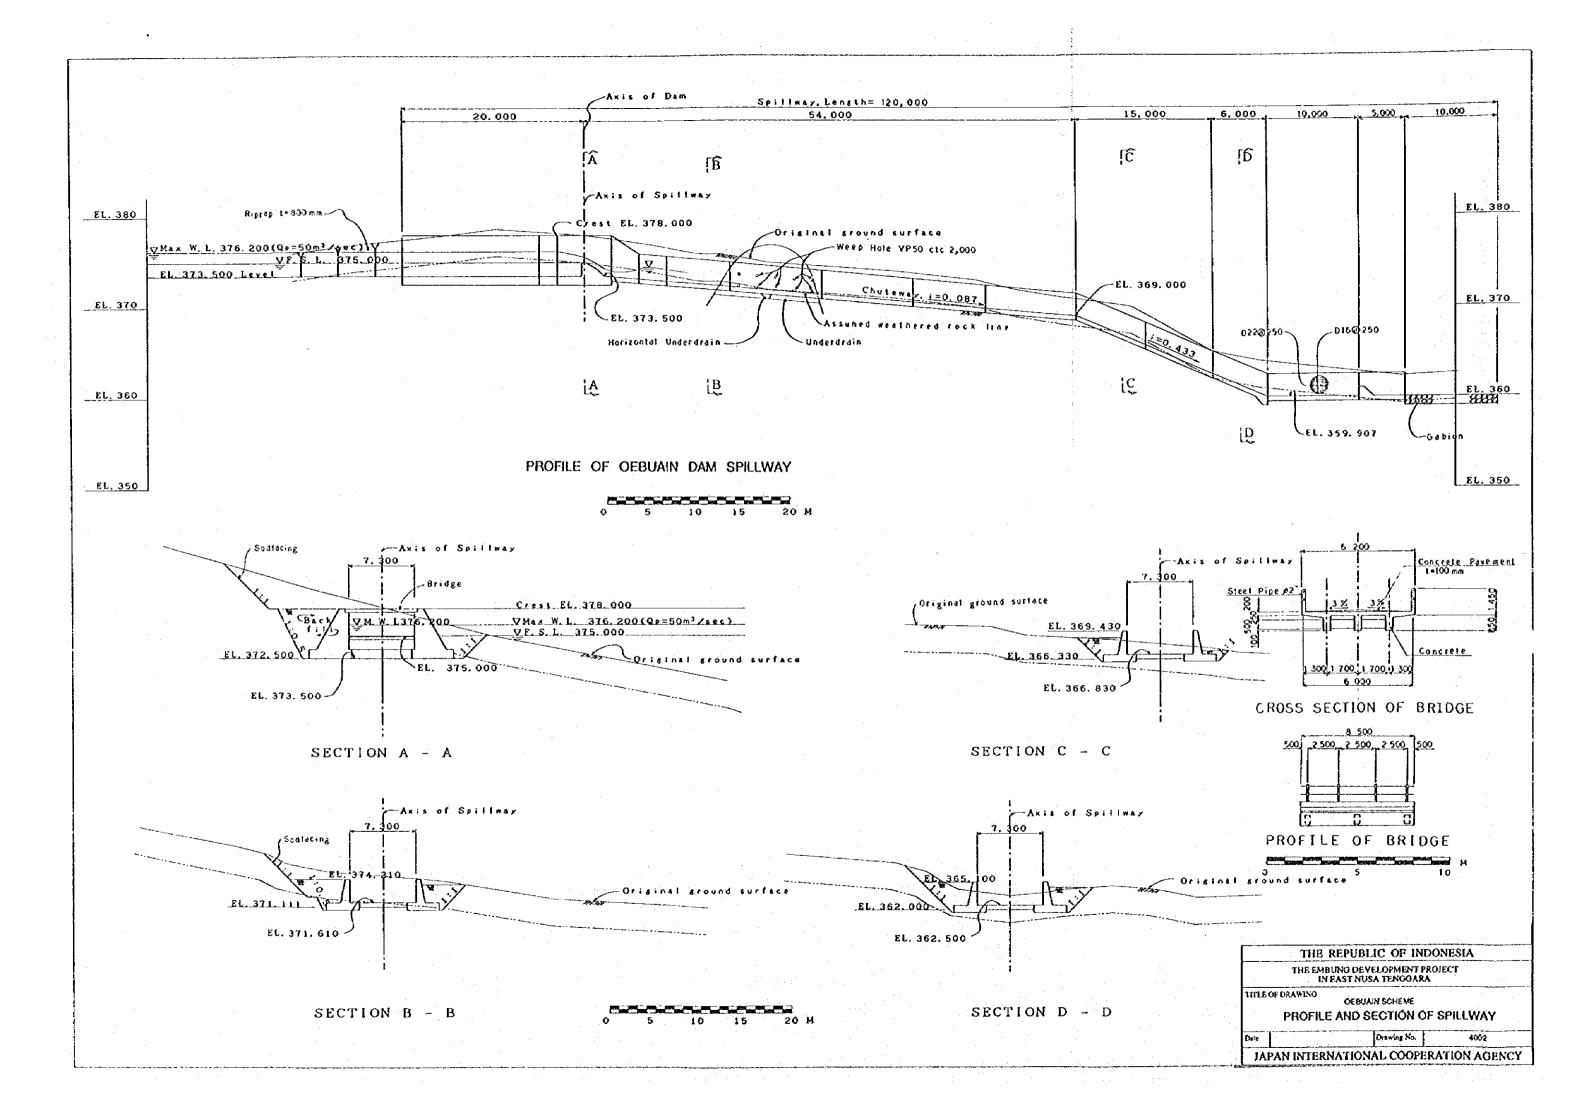


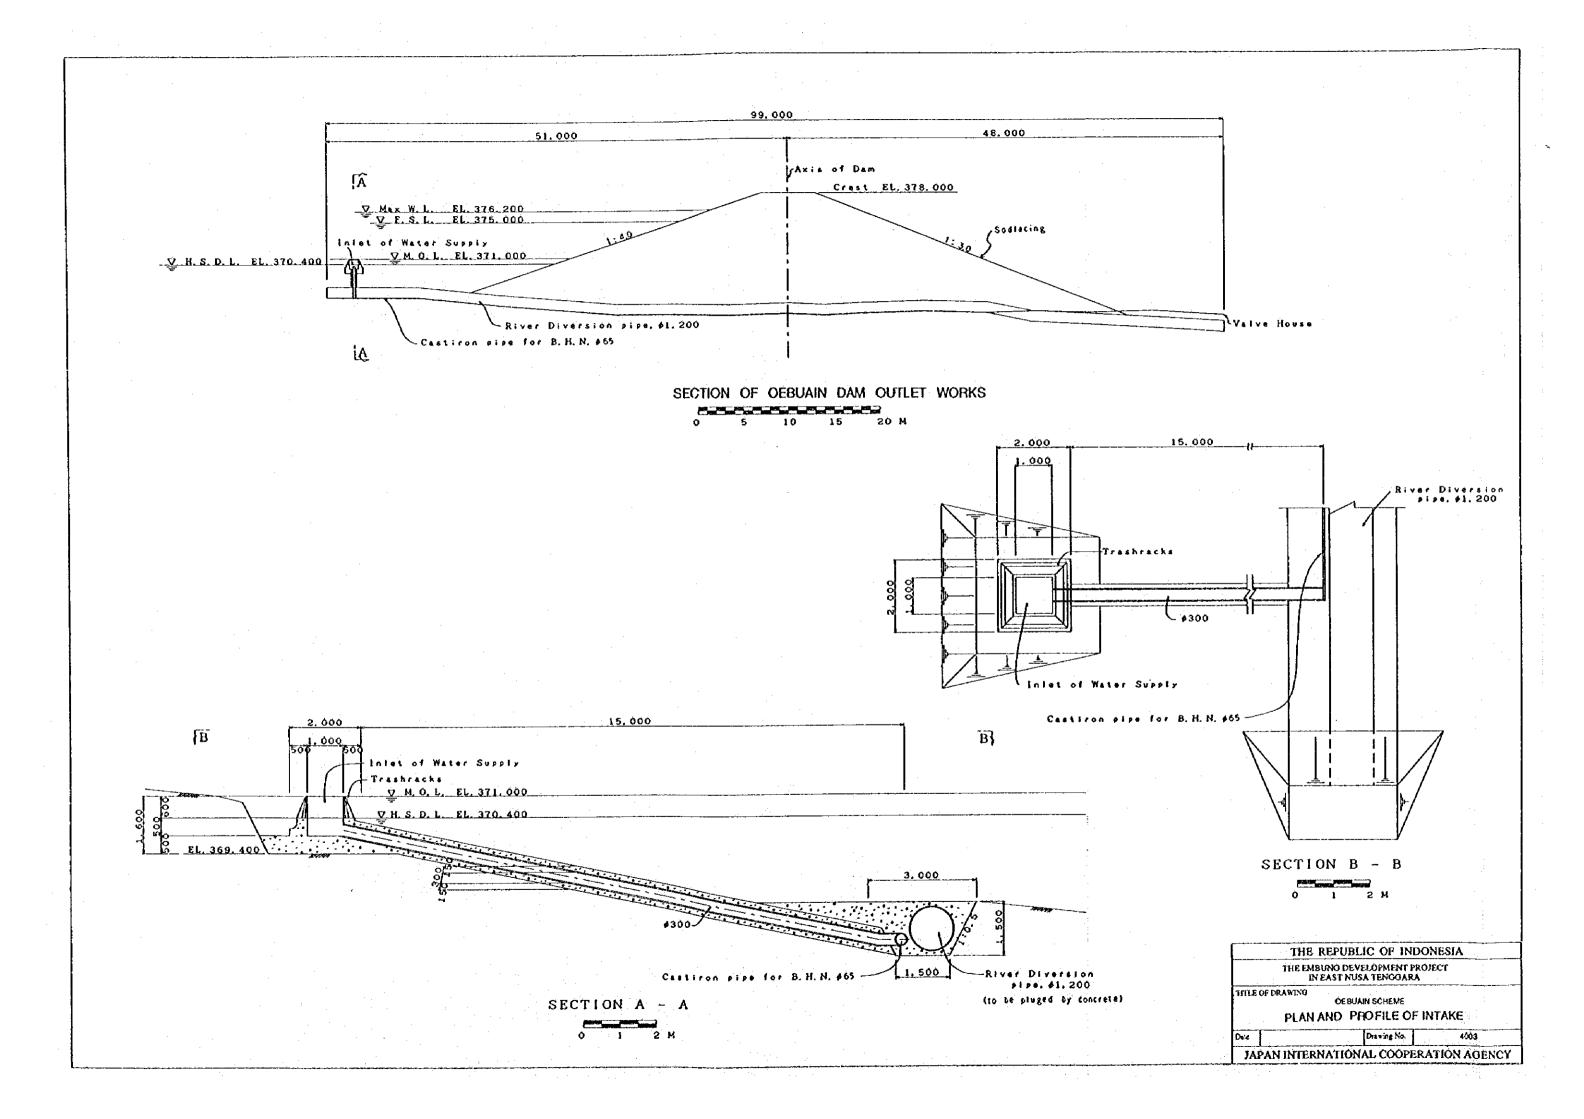

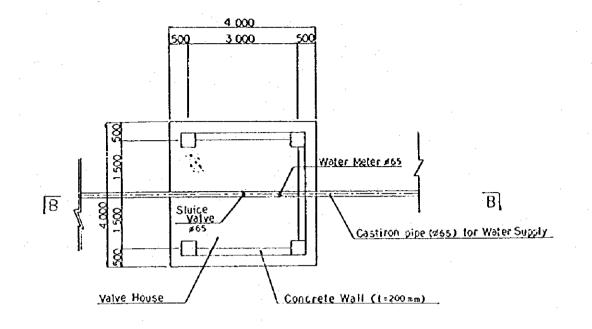

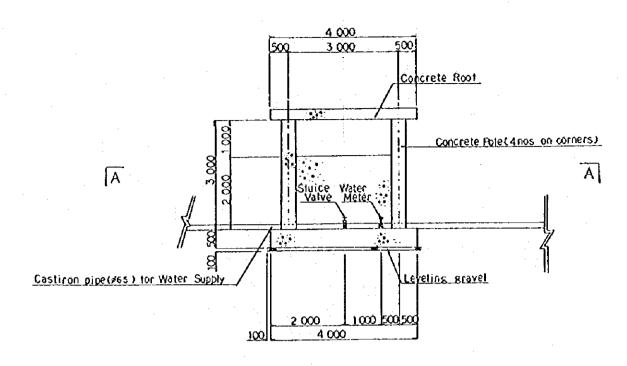

PROFILE OF OEBUAIN DAM VALVE HOUSE

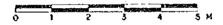

LONGITUDINAL SECTION OF VALVE HOUSE

THE REPUBLIC OF INDONESIA

THE EMBUNG DEVELOPMENT PROJECT
IN EAST NUSA TENGOARA

ITTLE OF DRAWING

OEBUAN SCHEME
PLAN AND PROFILE OF VALVE HOUSE


Date


Date

Date


A004

JAPAN INTERNATIONAL COOPERATION AGENCY

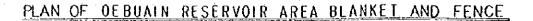

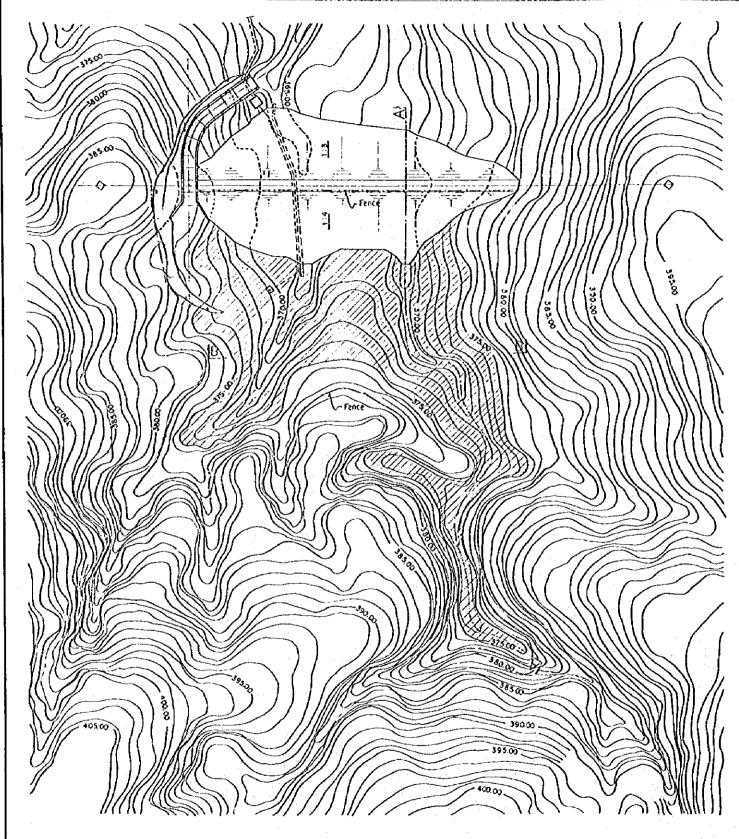


LONGITUDINAL SECTION OF BLANKET AND FENCE (A-A)

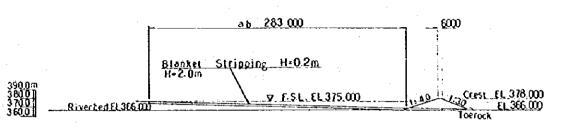

SCALE 1:2000 0 20 40 60 80 100M

<u>B - B</u>

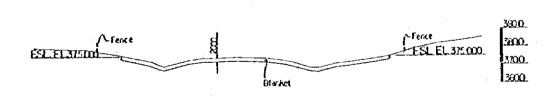

0 10 20 30 40 50

SCALE 1: 1000 0 10 20 30 40 50M THE REPUBLIC OF INDONESIA
THE EMBUNO DEVELOPMENT PROJECT
IN EAST NUSA TENOGARA


TITLE OF DRAWING


OEBUAIN SCHEME

BLANKET AND FENCE OF RESERVOIR

Drawing No.

JAPAN INTERNATIONAL COOPERATION AGENCY

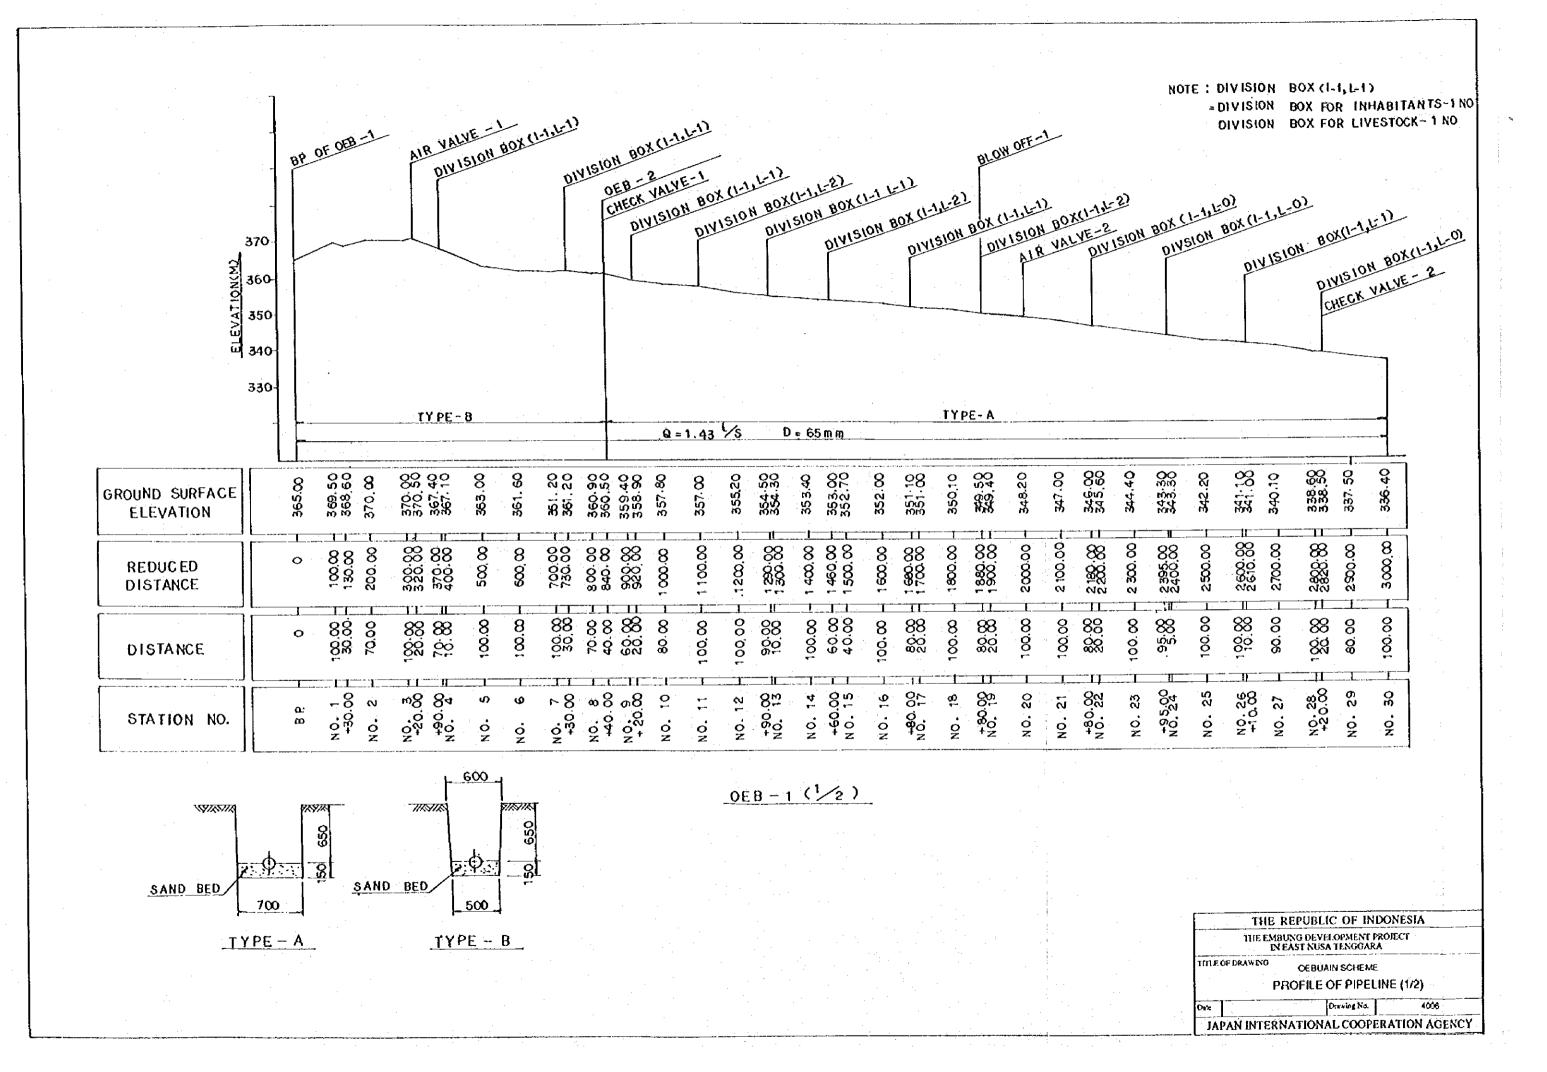


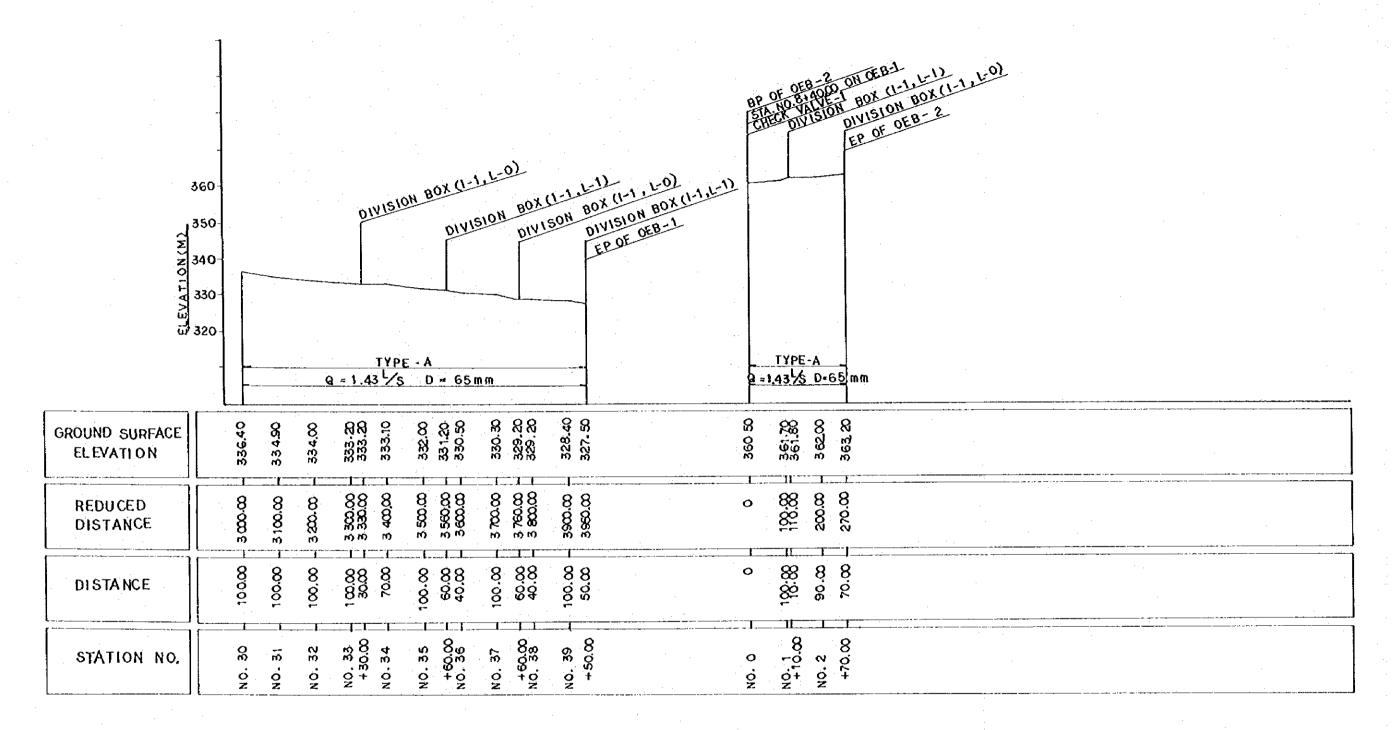



OEB-1(2/2)


0E8 - 2

TH	e republic of indo	NESIA
THEE	MBUNO DEVELOPMENT PRO IN EAST NUSA TENOGARA	JECT
TITLE OF DRAWING	OEBUAIN SCHEME	
	PROFILE OF PIPELINE	E (2/2)
Date	Drawing No.	4007
IAPAN INTE	RNATIONAL COOPERA	ATION AGENCY

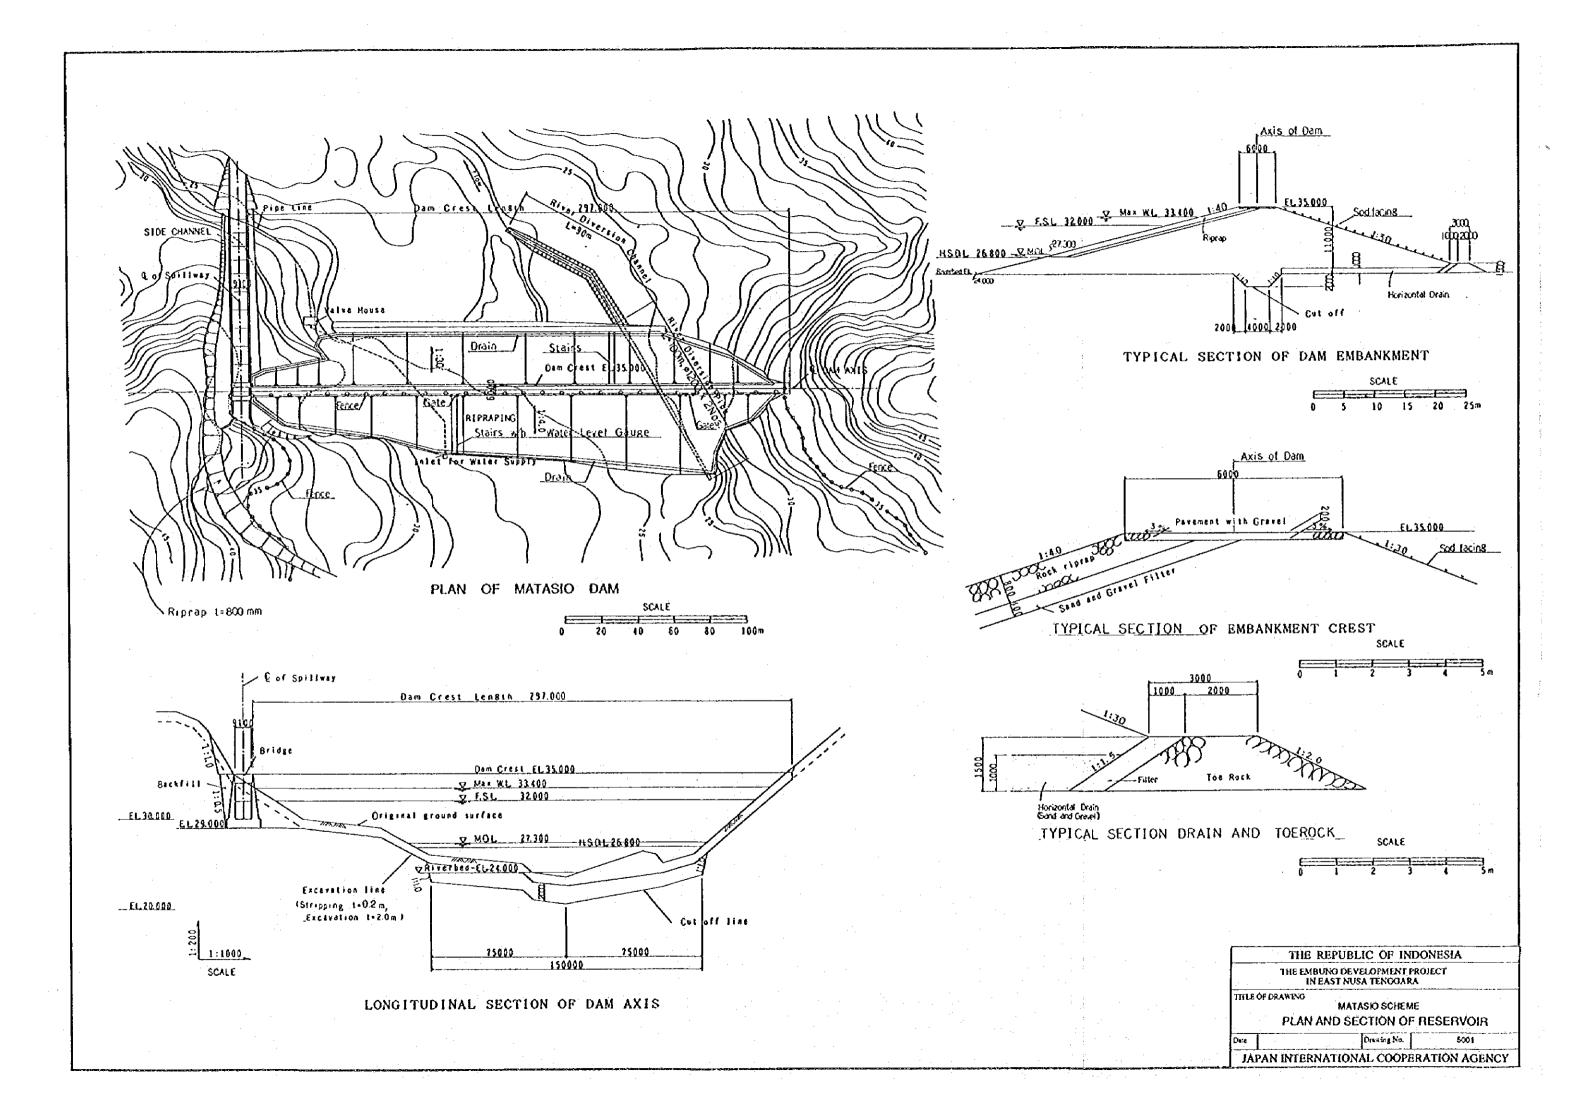

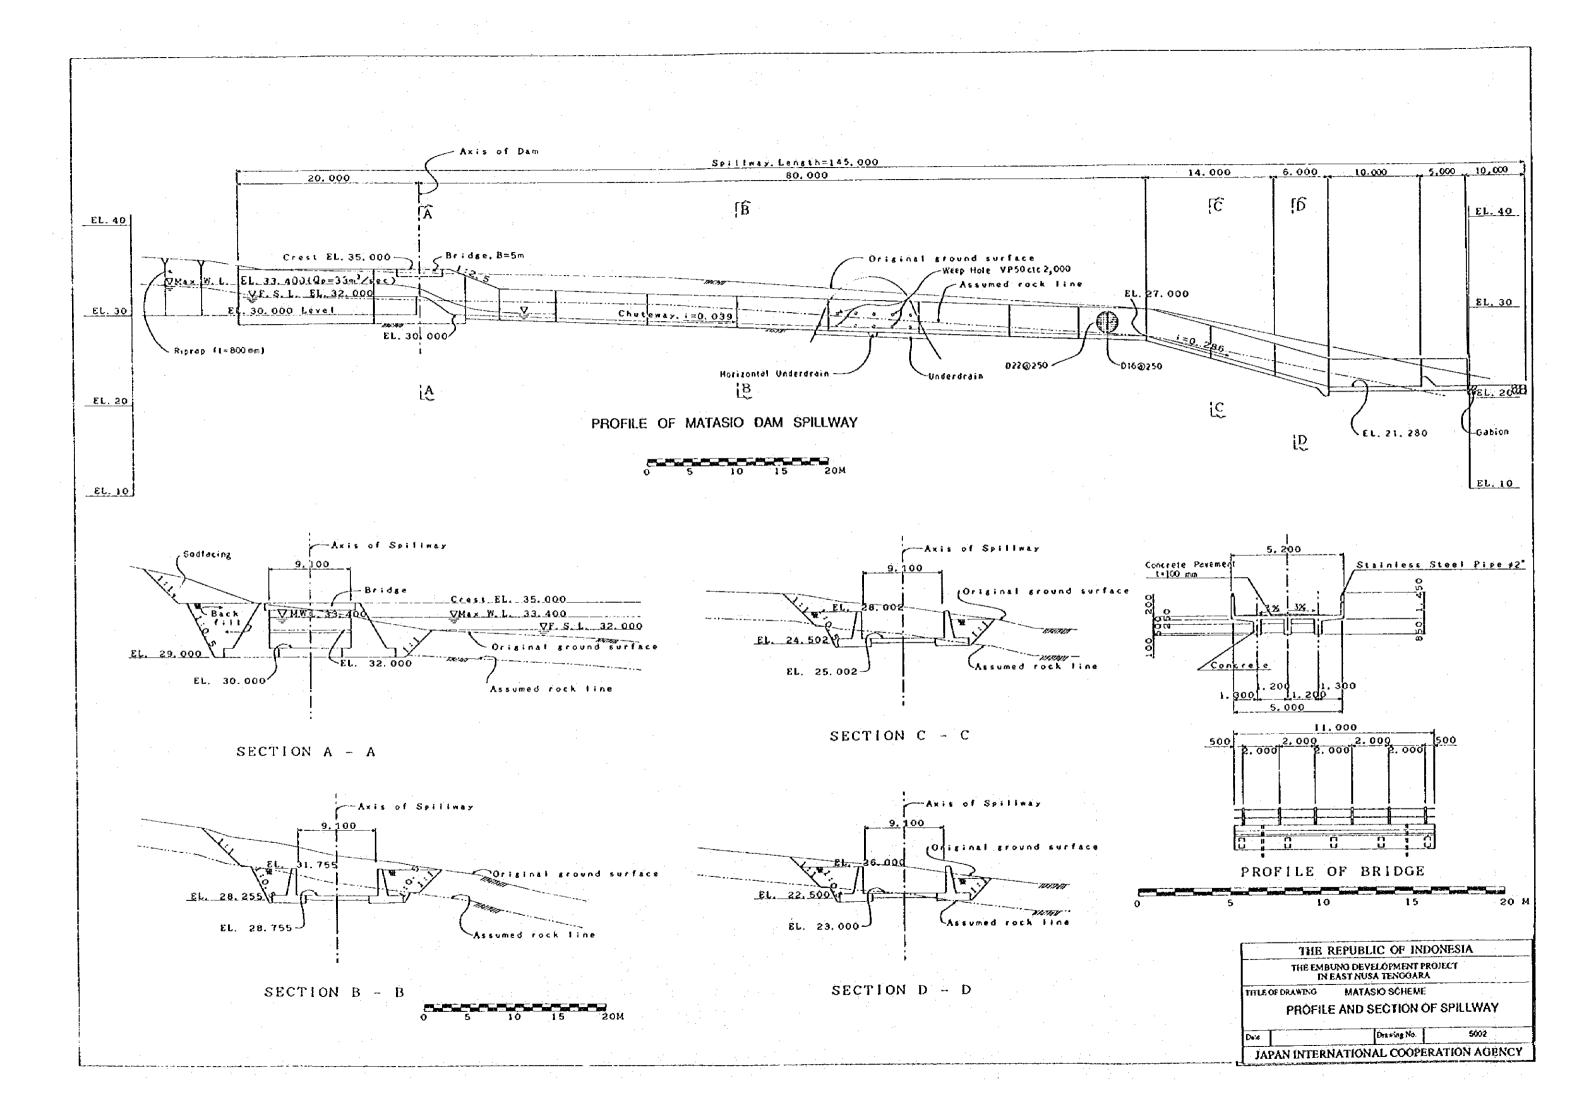


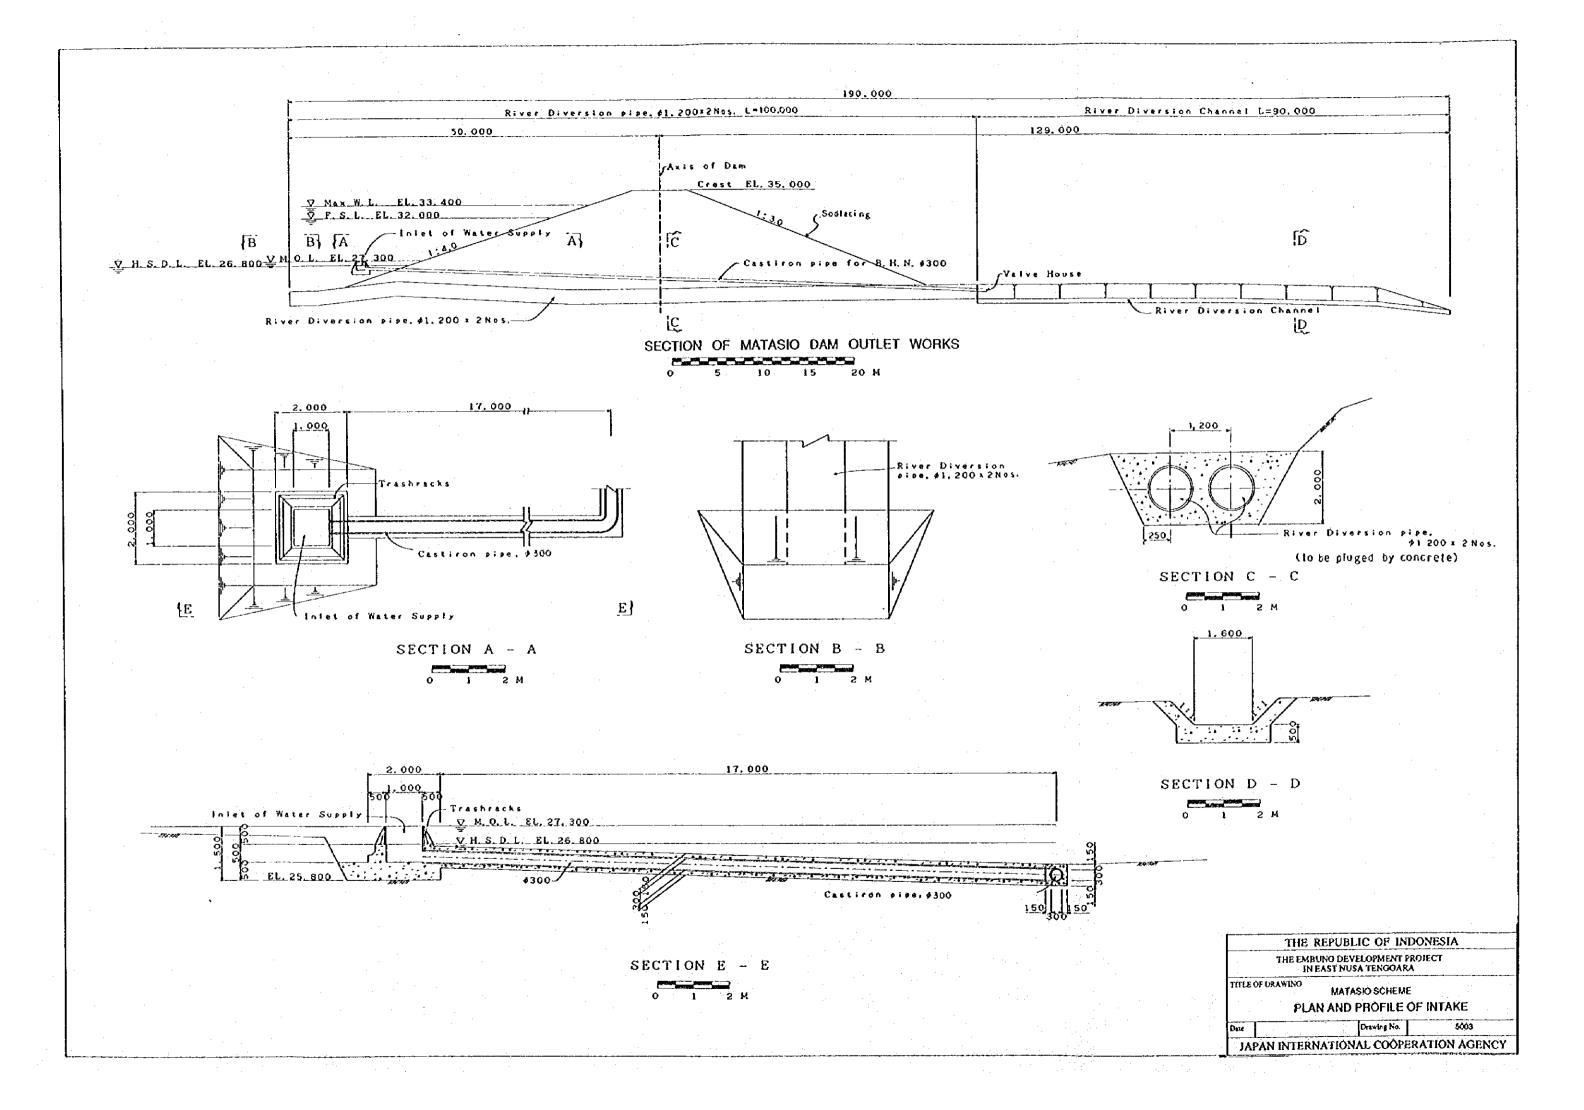

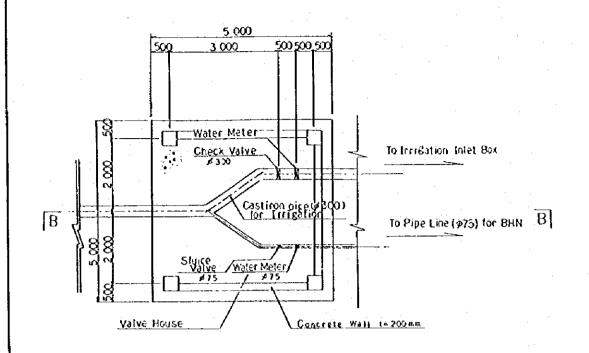

PROFILE OF MATASIO DAM VALVE HOUSE



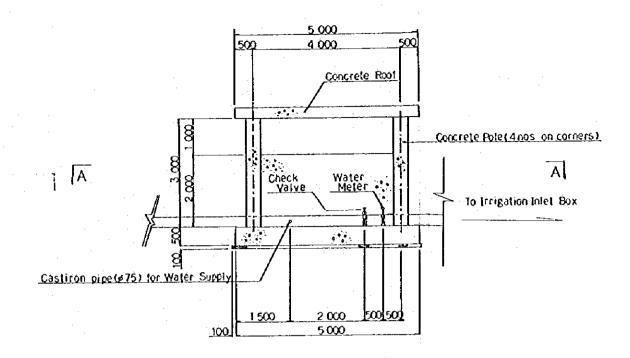

LONGITUDINAL SECTION OF VALVE HOUSE



THE REPUBLIC OF INDONESIA

THE EMBUNG DEVELOPMENT PROJECT
IN EAST NUSA TENGGARA


THE OF DRAWING

MATASIO SCHEME

PLAN AND PROFILE OF VALVE HOUSE

Drawing No. 5004

JAPAN INTERNATIONAL COOPERATION AGENCY

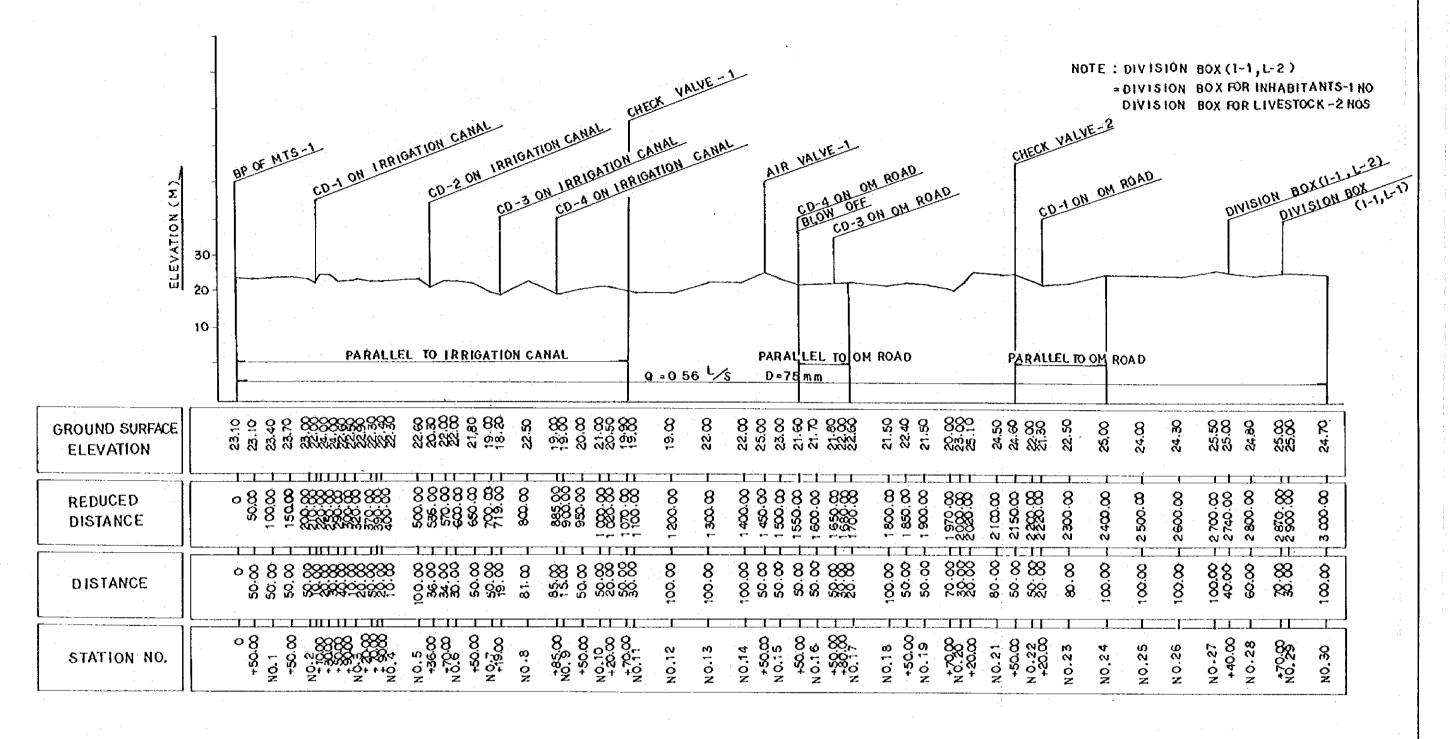

SAND BED 700

MTS-1 (1/2)

THE REPUBLIC OF INDONESIA

THE EMBUNO DEVELOPMENT PROJECT
IN EAST NUSA TENGOARA


TITLE OF DRAWING

MATASIO SCHEME

PROFILE OF PIPELINE (1/2)

Date

Da

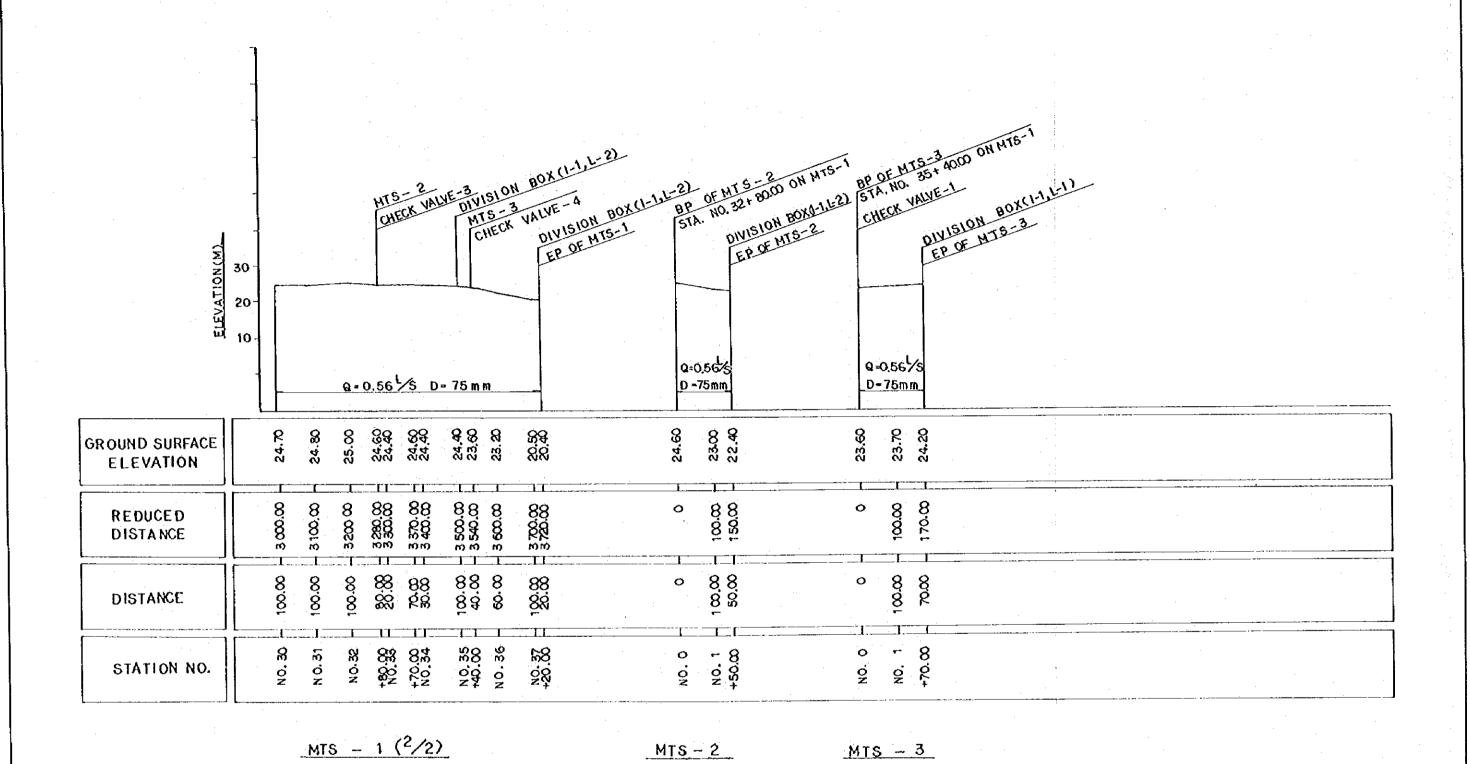

THE EMBUNO DEVELOPMENT PROJECT IN EAST NUSA TENGOARA

TITLE OF DRAWING


MATASIO SCHEME

PROFILE OF PIPELINE(2/2)


Data Drawing No. 5006

JAPAN INTERNATIONAL COOPERATION AGENCY

THE REPUBLIC OF INDONESIA

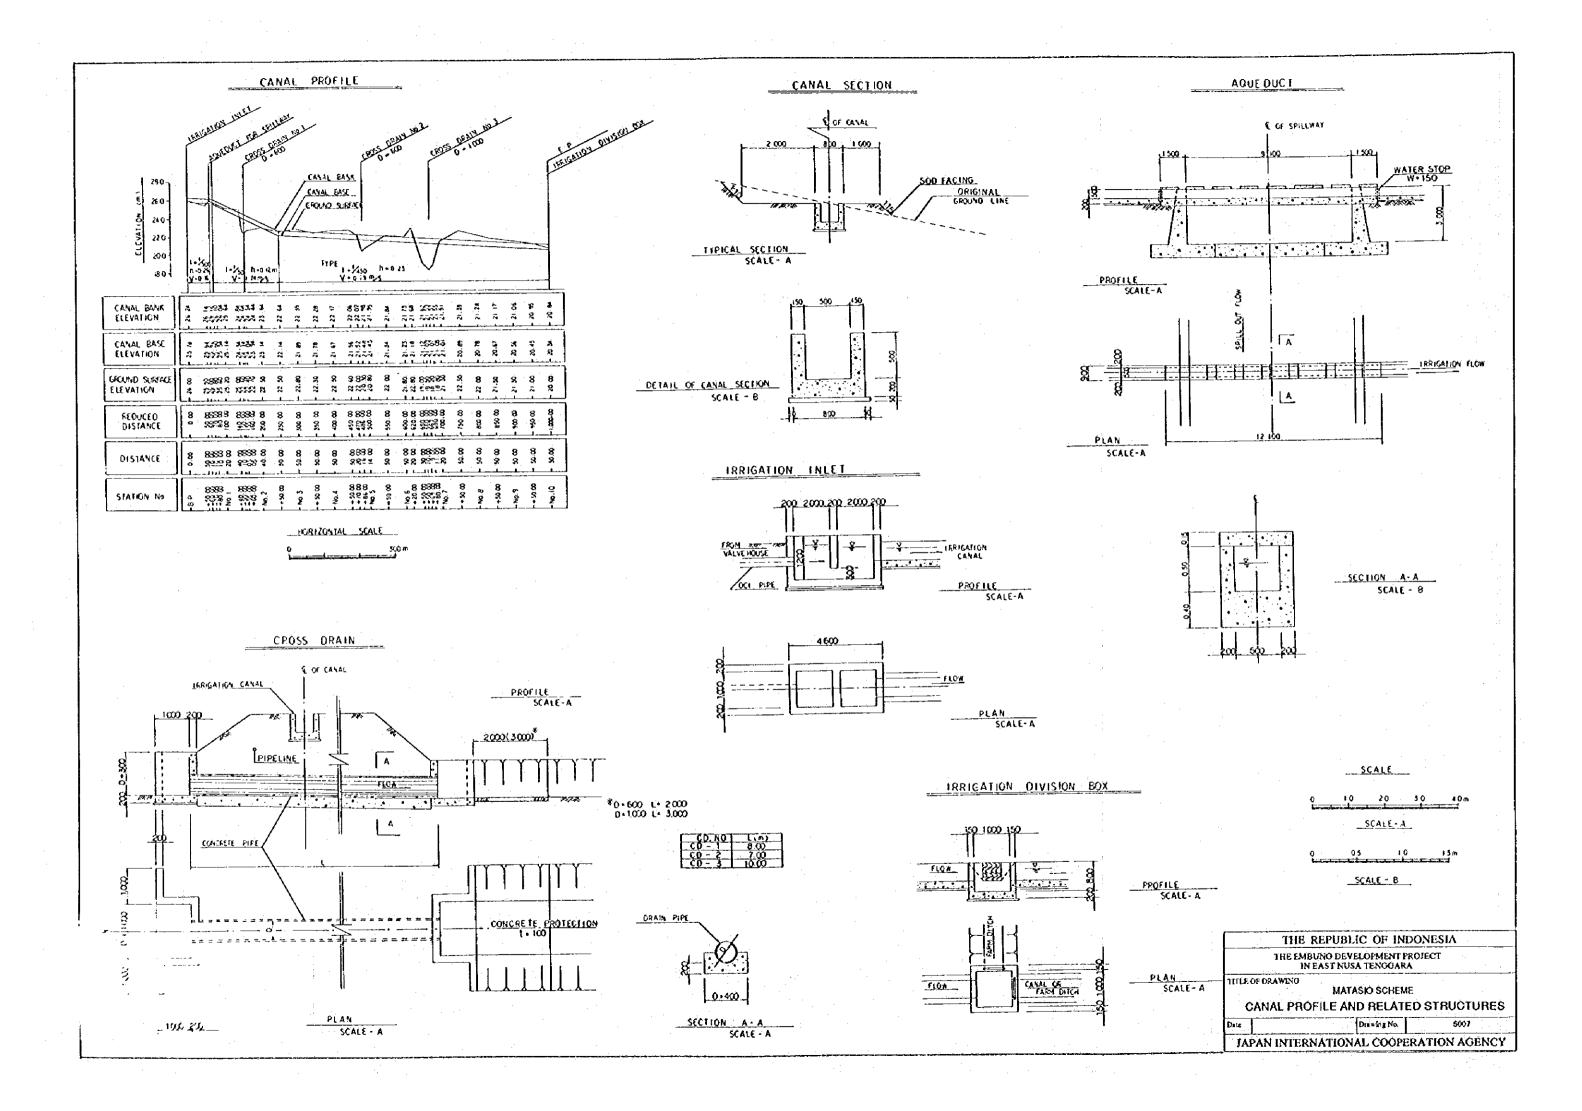



ROAD PROFILE

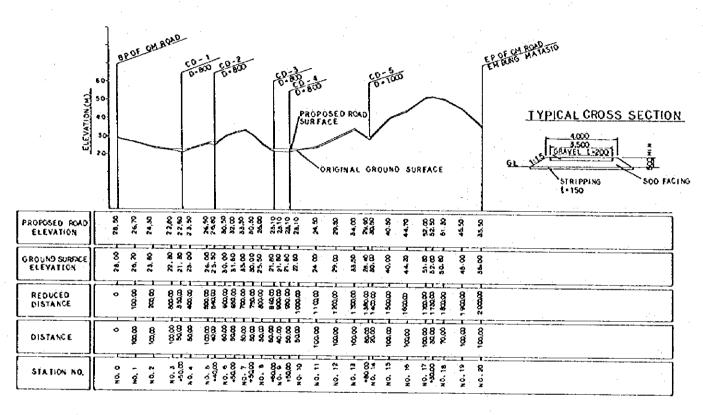


HORIZONTAL SCALE

CROSS DRAIN

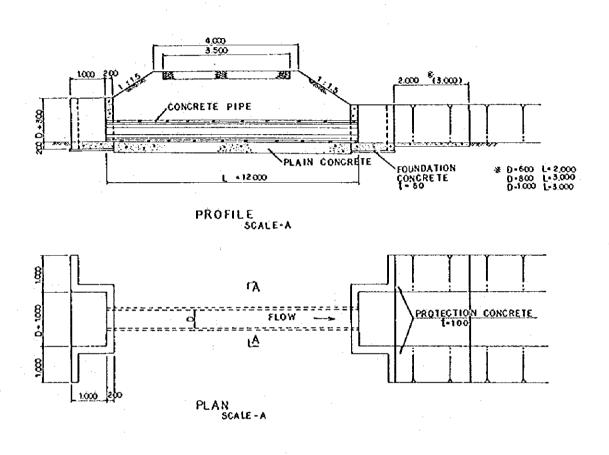

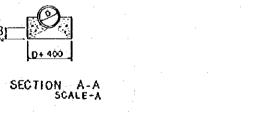

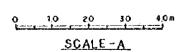

	THE	REPUBLIC OF IN	DONESIA
	THE EMB IN	UNO DEVELOPMENT I EAST NUSA TENGOAR	PROJECT A
TITLE	OF DRAWING	MATASIO SCHEMI	
	PROFILE A	ON AND MAINTEN AND RELATED ST	RUCTURES
Date		Drawing No.	5008
JAI	PAN INTERI	NATIONAL COOP	ERATION AGENCY

