

CONSTRUCTION DRAWINGS


<u>Dwg. No.</u>	<u>Title</u>
DC-001	General Plan
DC-002	The Plan of Erosion Plots & Buildings
DC-003	Erosion Plot
DC-004	Detailed Plan of Collecting Pit
DC-005	Detailed Plan of Erosion Plot
DC-006	Profile of Water Pipeline
CD-007	Site Plan 1/400
DC-008	General Finishings
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DC-010	Laboratory II 1/150
DC-011	Machine Shop 1/150
DC-012	Laboratory Section Detail
DC-013	Machine Shop Section Detail
DC-014	Lavatory Plan Section Detail 1/30
DC-015	Laboratory Structure
DC-016	Machine Shop Structure
DC-017	Structure
DC-018	Site Plan of Plumbing System
DC-019	Flow Diagram of Plumbing System
DC-020	Plumbing & Ventilation System for Lab. Bldg. & Machine Shop
DC-021	Piping Detail for Septic Tank and Washing Pit
DC-022	Piping Detail for Water Storage and Deep Well
DC-023	Site Development Plan
DC-024	Single Line Riser Diagram and Generator Set Schematic Diagram
DC-025	Lighting and Power Lay-out

TOPOGRAPHIC MAP
CENTRAL SOIL & WATER RESOURCES
RESEARCH STATION
 CUYAMBAY, TANAY, RIZAL

NO	DESCRIPTION	UNT	AREA	NO	DESCRIPTION	UNT	AREA
1	EROSION PLOT	50-m	about 100	15	GENERATOR HOUSE	50-m	30
2	EROSION PLOT			16	TOILET		45
3				17	STORAGE TANK	CU-m	32
4				18	DEEP WELL	FM	150
5				19	ACCESS ROAD	SQ-m	340
6				20			
7				21			
8				22			
9	EXAMINATION ROOM		75	23			
10	DRYING ROOM		75	24			
11	WAREHOUSE		75	25			
12	EXHIBITION ROOM		75	26			
13	MACHINE SHOP		150	27			
14	WASHING PIT		35	28			

NOTE

- WATER PIPELINE (URVC)
- 3F. ELECTRIC OVERHEAD WIRE
- 2F. DITTO
- BOUNDARY

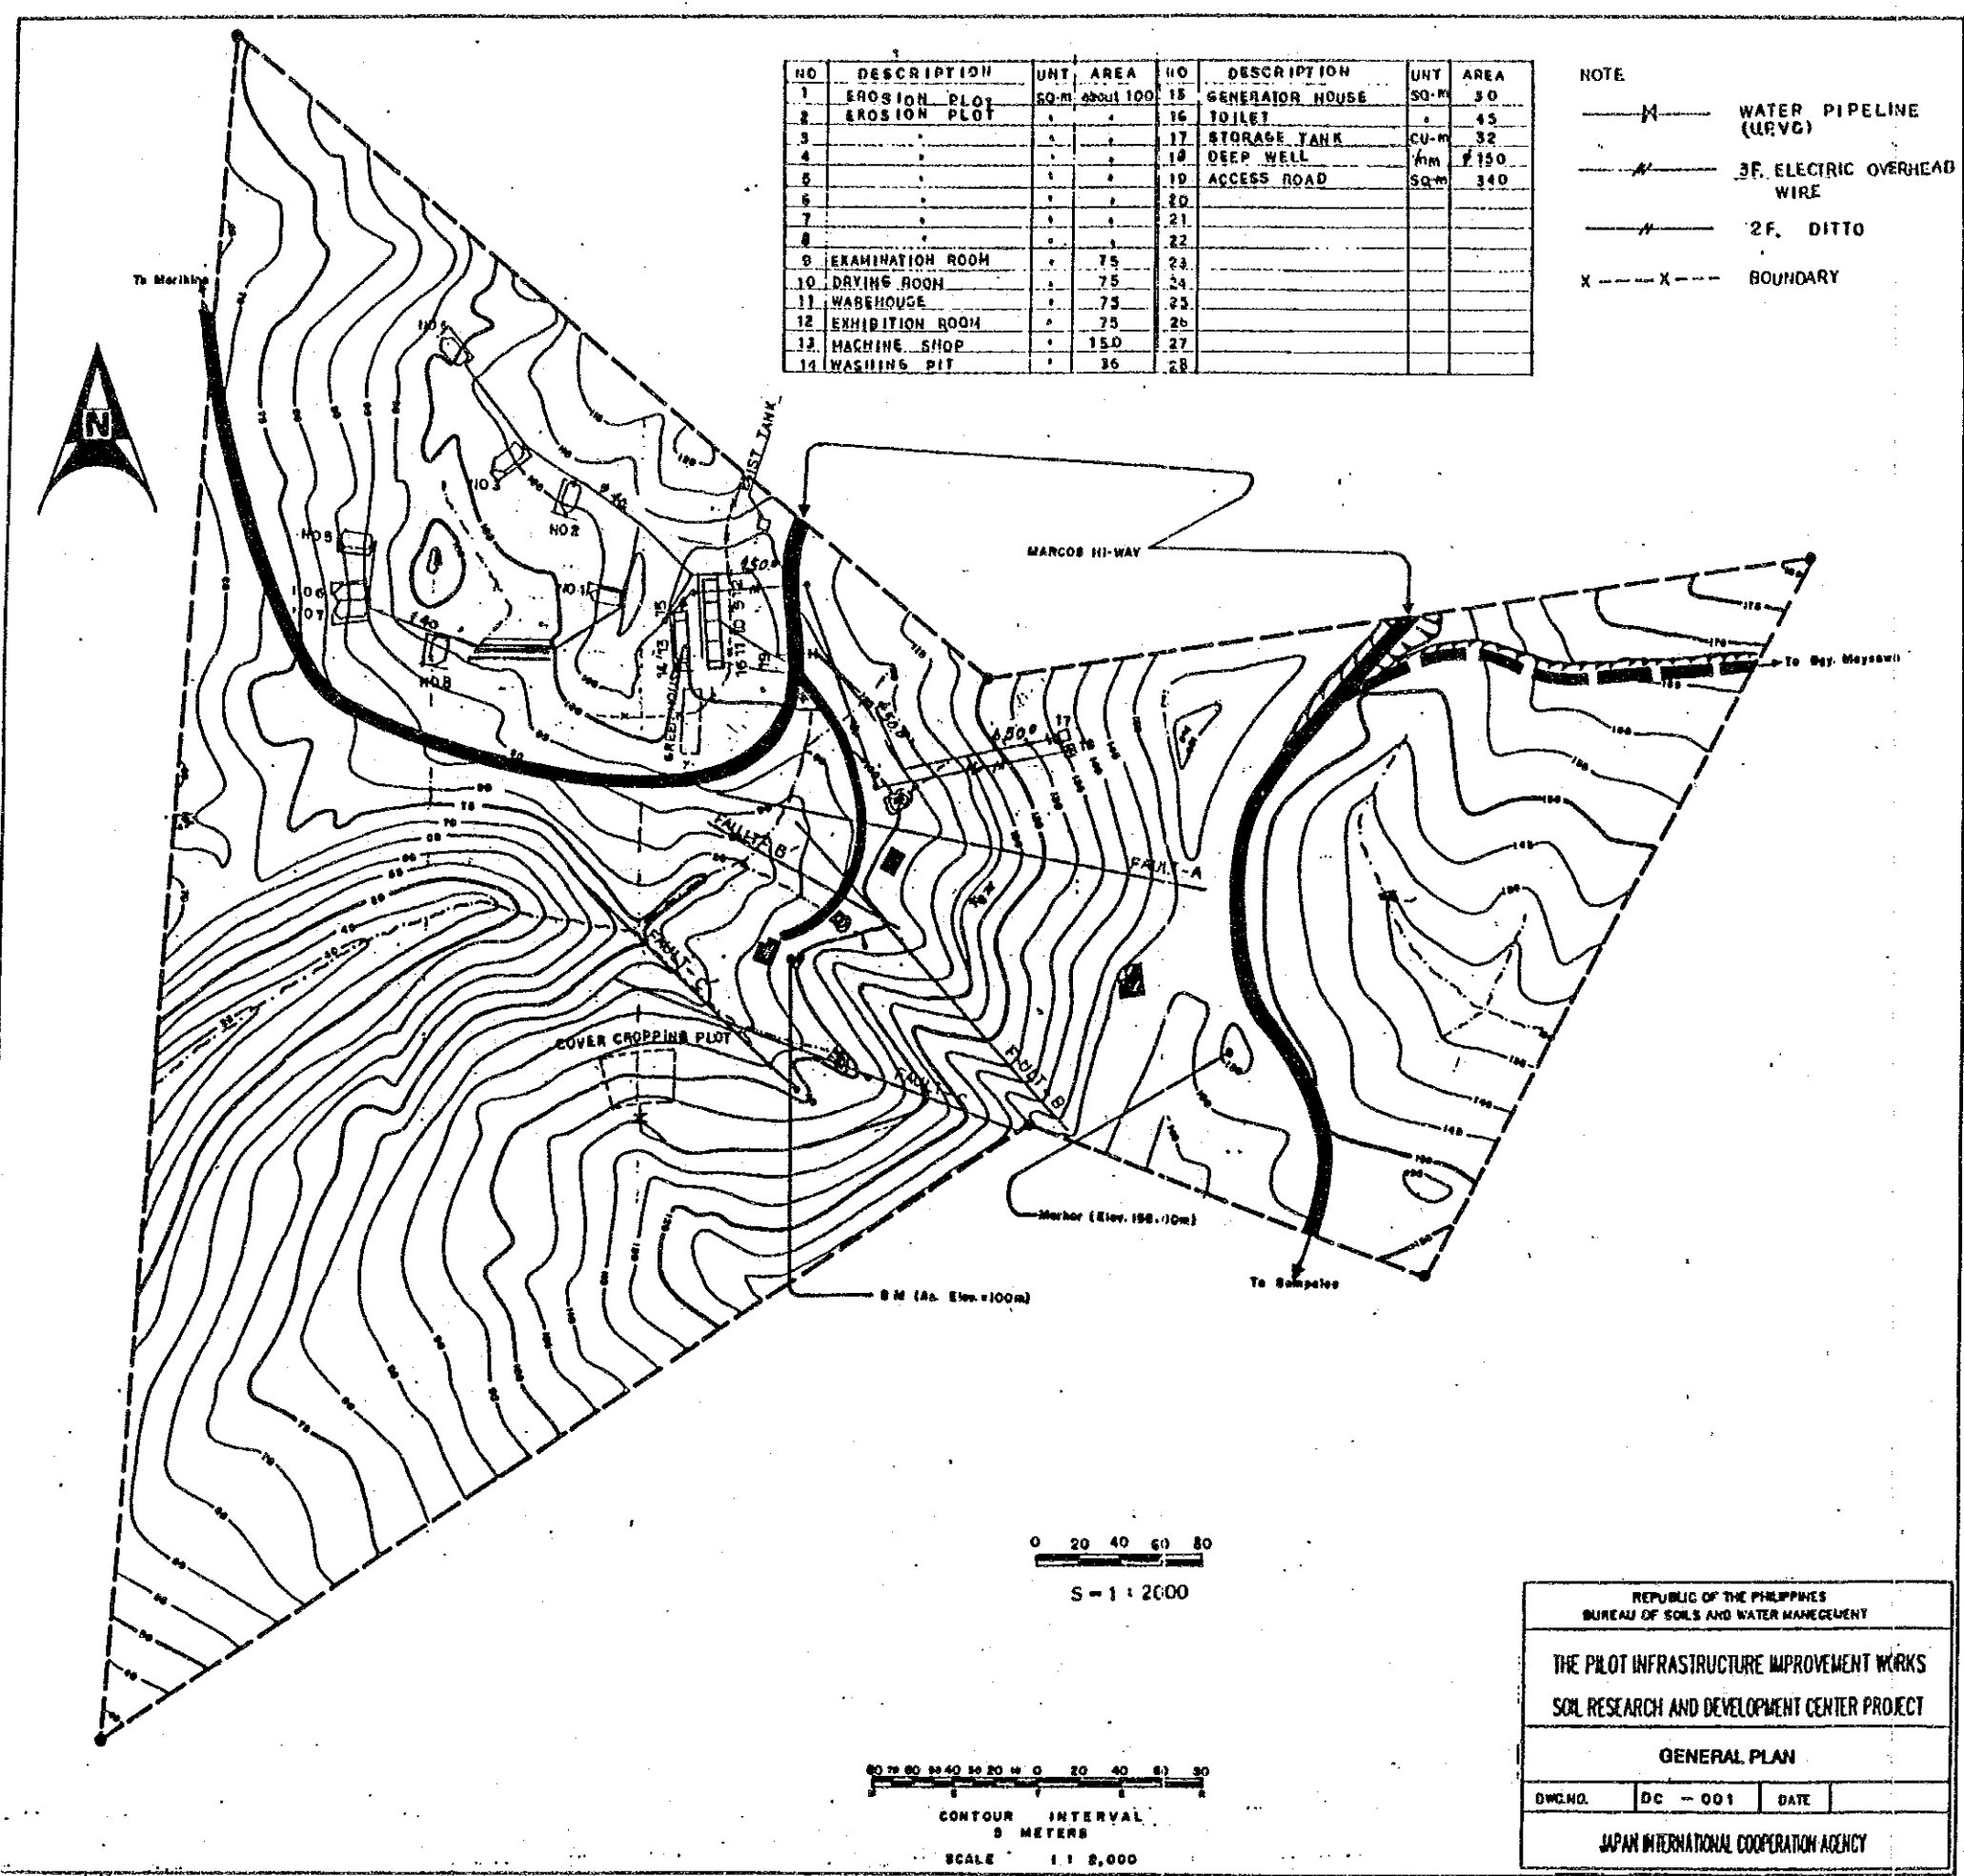

0 20 40 60 80
 S = 1 : 2000

80 70 60 50 40 30 20 10 0 20 40 60 80
 CONTOUR INTERVAL
 5 METERS
 SCALE 1 : 2,000

REPUBLIC OF THE PHILIPPINES
 BUREAU OF SOILS AND WATER MANAGEMENT

THE PILOT INFRASTRUCTURE IMPROVEMENT WORKS
 SOIL RESEARCH AND DEVELOPMENT CENTER PROJECT



GENERAL PLAN

DWG. NO. DC - 001 DATE


JAPAN INTERNATIONAL COOPERATION AGENCY

CONVENTIONAL SIGNS


- ROAD
- ROAD CUT
- DIRT ROAD
- SPRING
- INTERMITTENT CREEK
- CONTOUR LINES
- STATION BOUNDARY
- P.S. MONUMENT
- FARM POND
- MINI POND
- BUILDING
- RESERVOIR

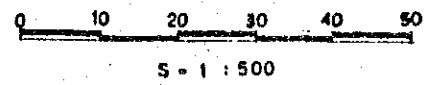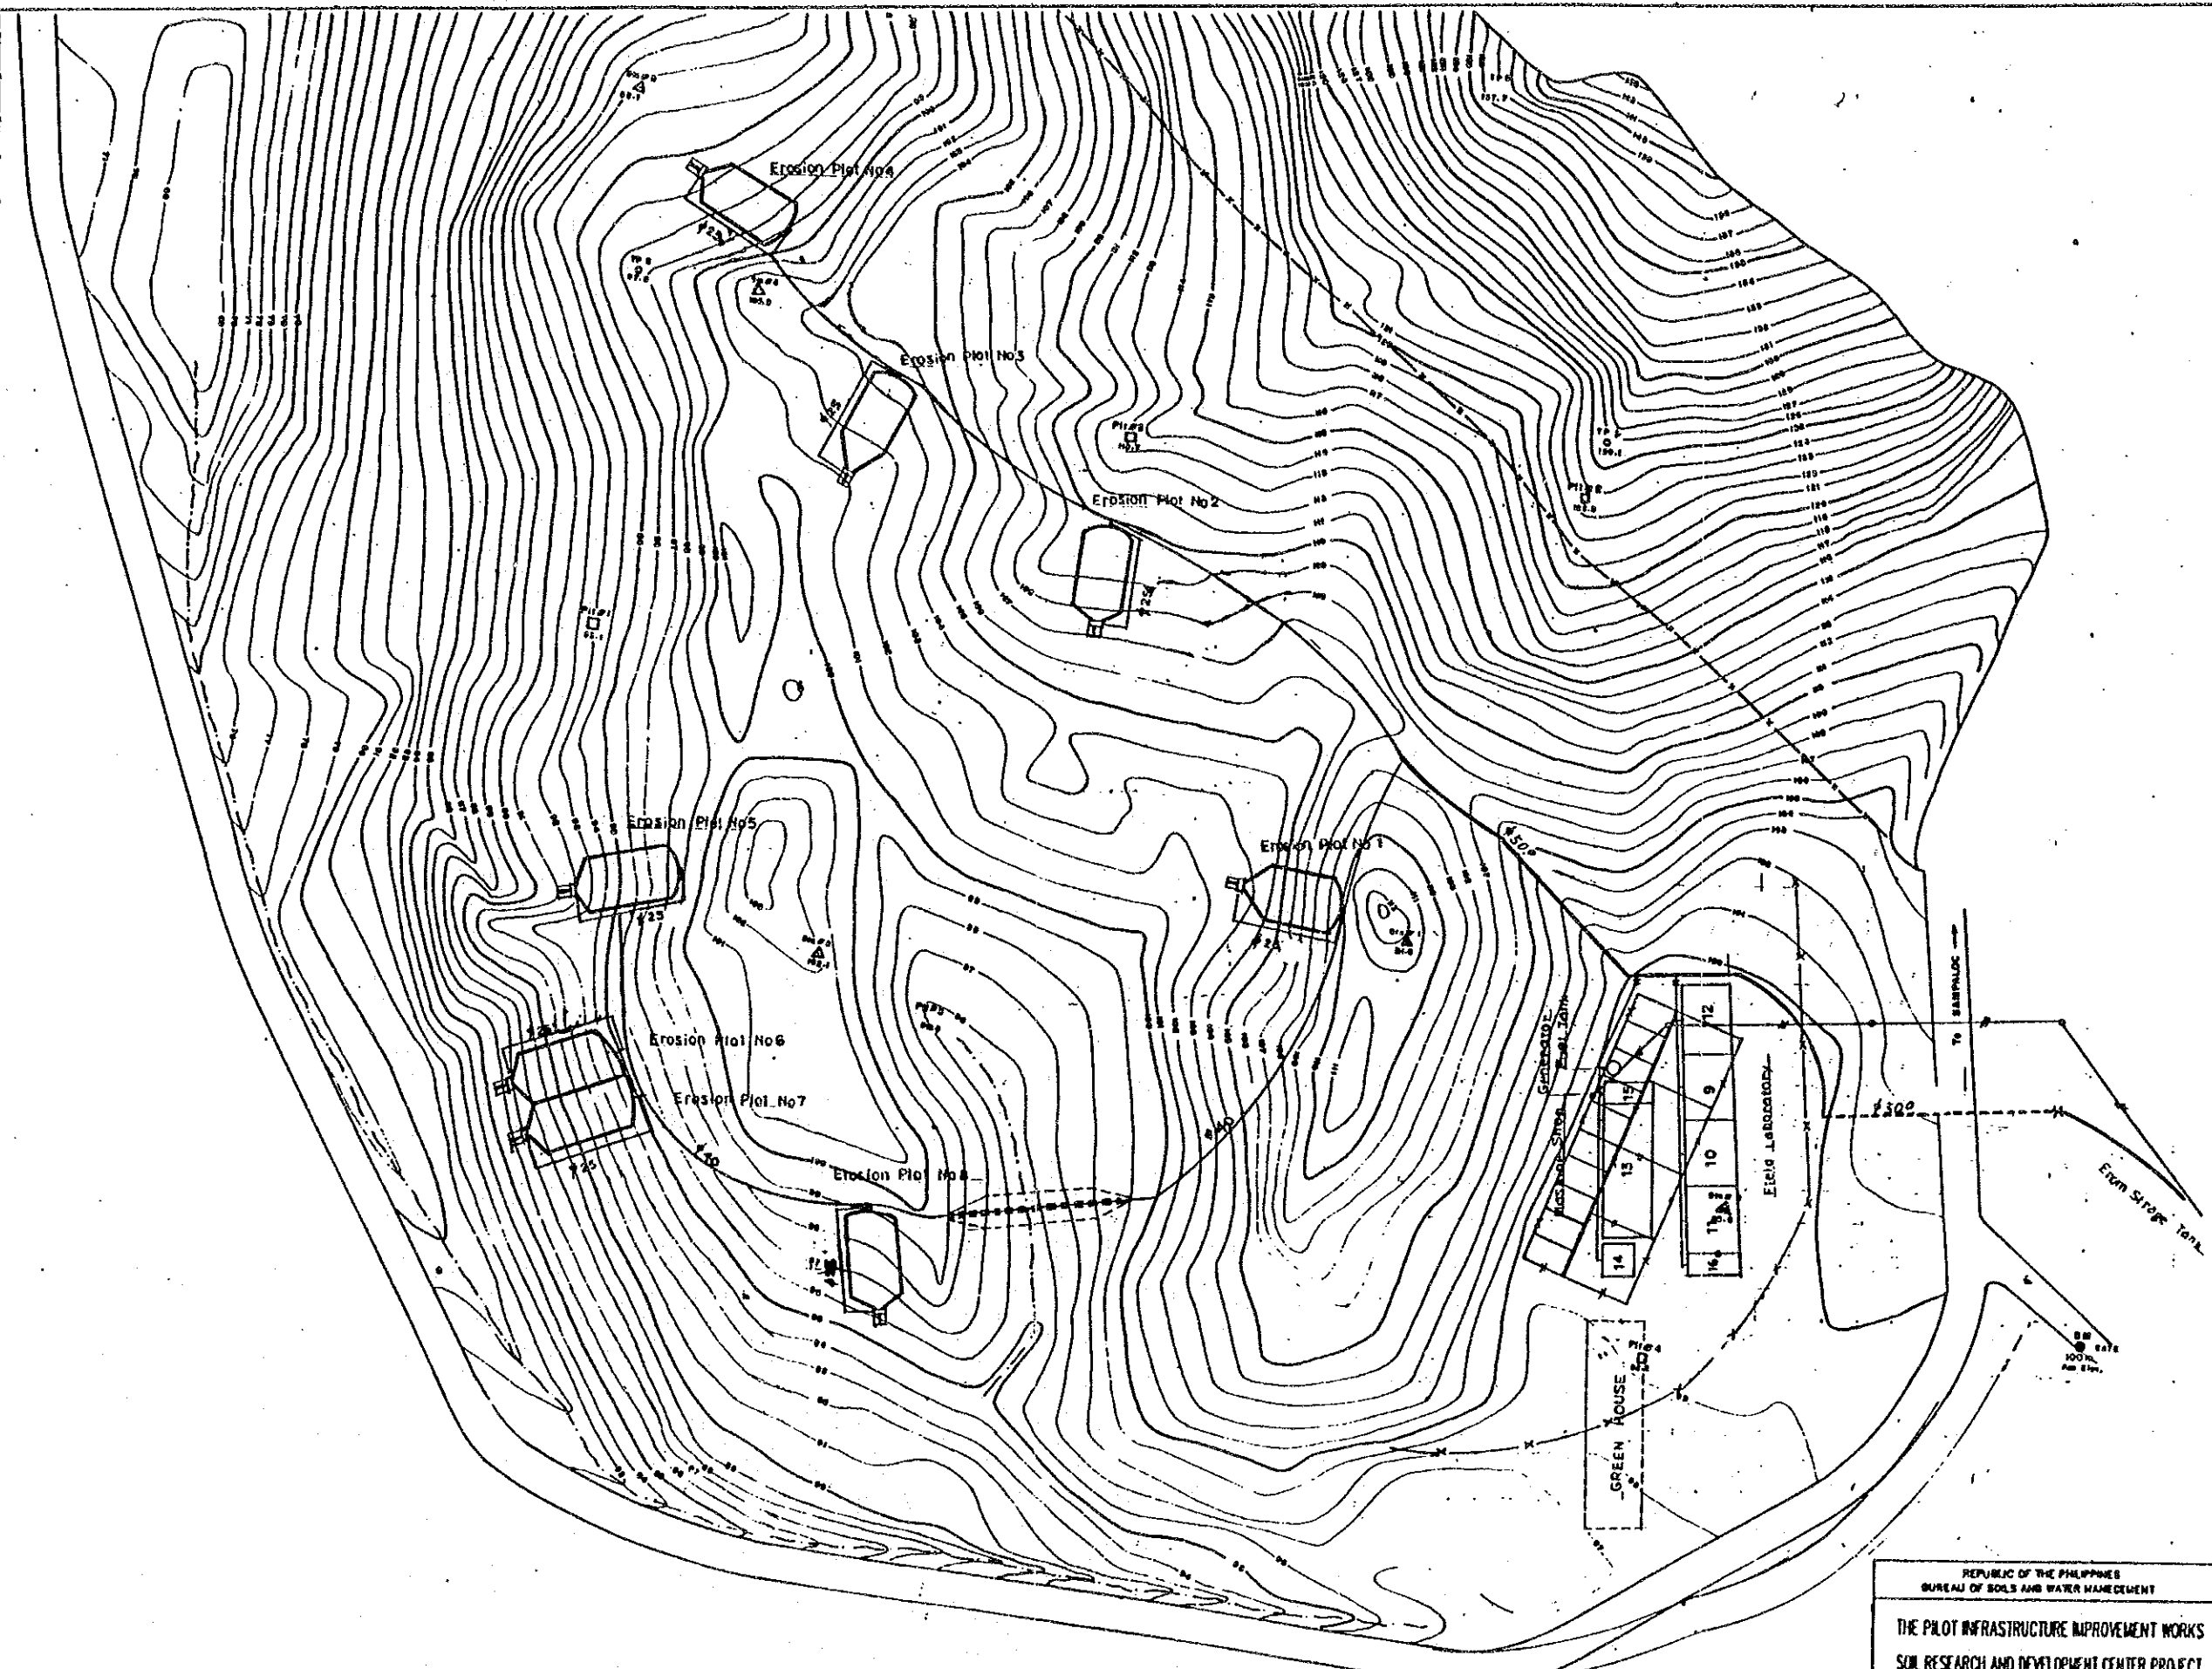

REPUBLIC OF THE PHILIPPINES BUREAU OF SOILS AND WATER MANAGEMENT		
THE PILOT INFRASTRUCTURE IMPROVEMENT WORKS SOIL RESEARCH AND DEVELOPMENT CENTER PROJECT		
THE PLAN OF EROSION PLOTS & BUILDINGS		
GWG. NO.	DC - 002	DATE
JAPAN INTERNATIONAL COOPERATION AGENCY		

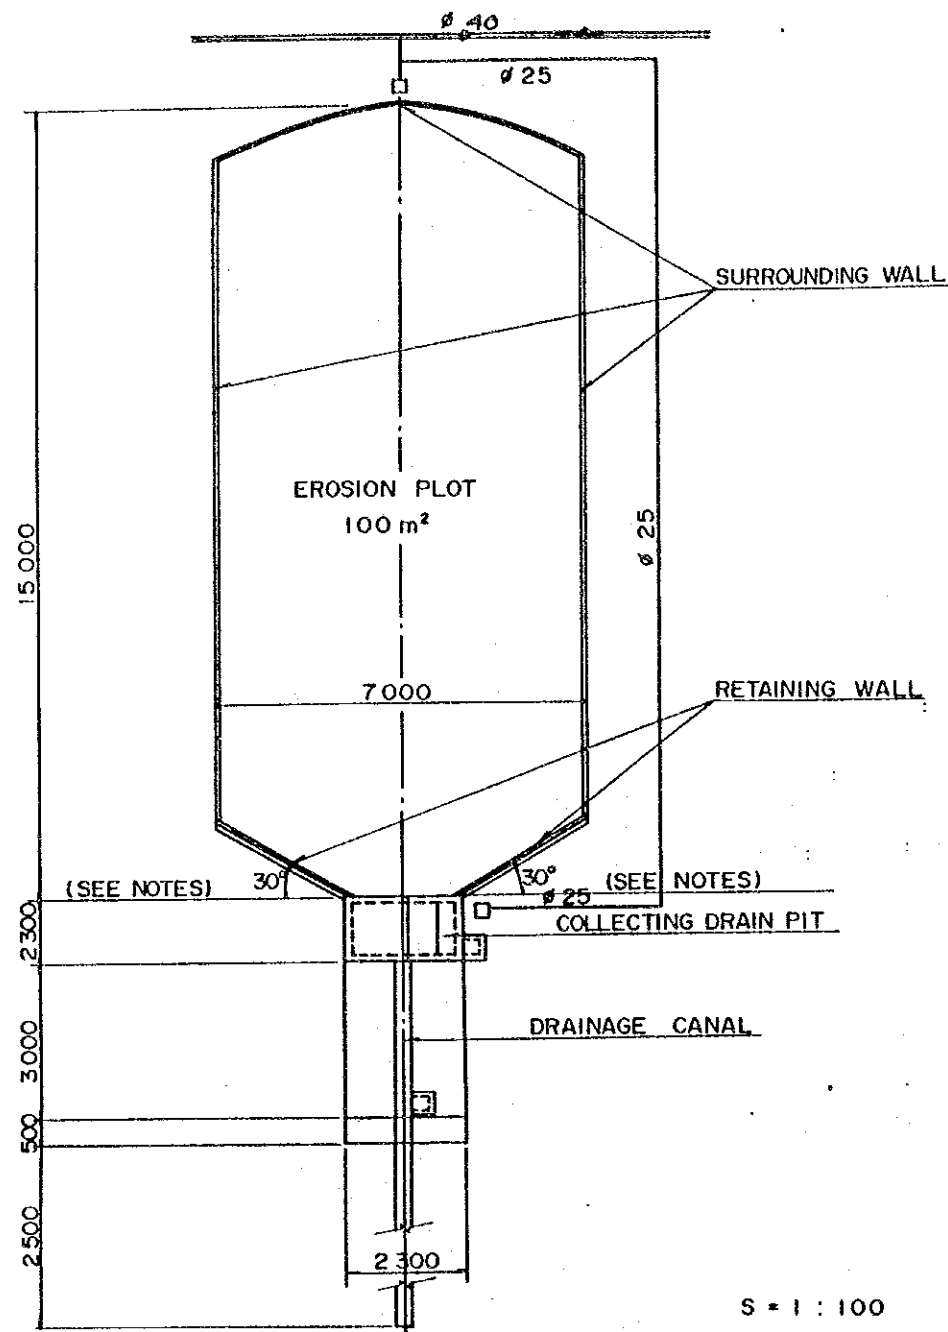

STANDARD PLAN OF EROSION PLOT

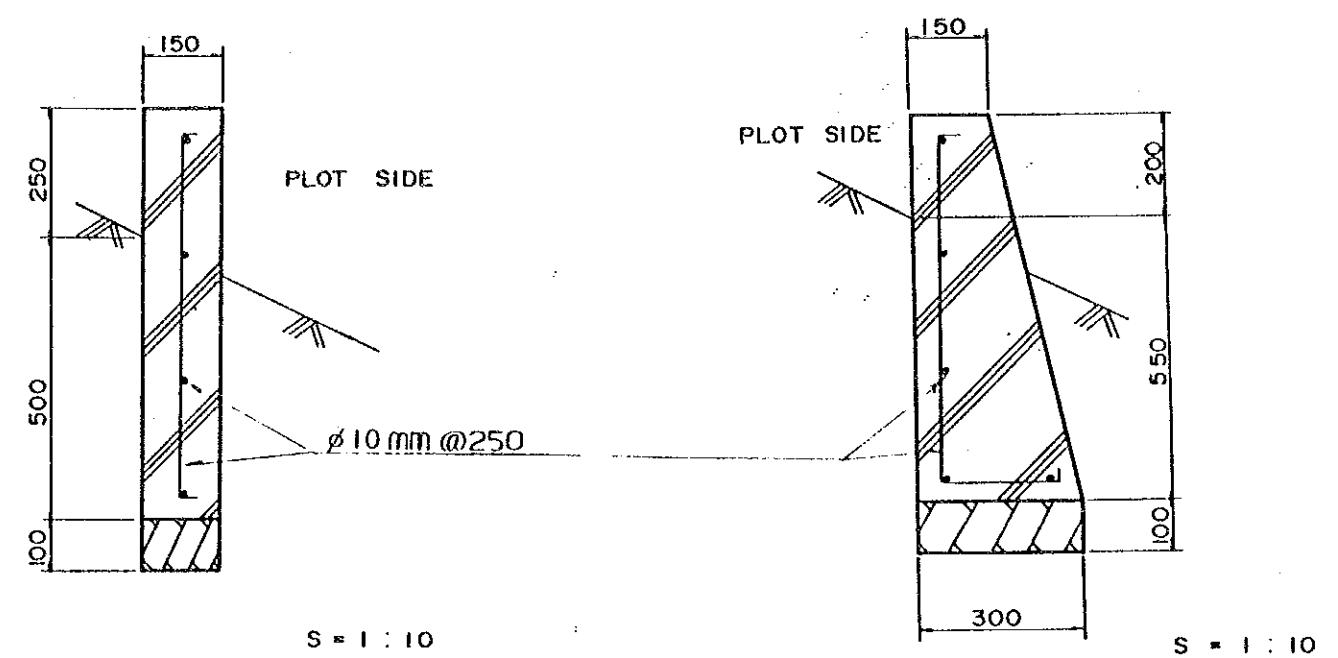


STANDARD SECTION OF SURROUNDING WALL

STANDARD SECTION OF RETAINING WALL


NOTES :

1. ALL DIMENSIONS ARE GIVEN IN MILLI METERS.
2. THE ANGLE SHOWN IN STANDARD PLAN OF EROSION PLOT IS THE STANDARD. IT IS SUBJECT TO CHANGE DUE TO TOPOGRAPHICAL CONDITIONS, AS DIRECTED BY THE ENGINEER.
3. THE LOCATION OF EACH EROSION PLOT WILL BE INDICATED BY THE ENGINEER.
4. ALL PIPES EXCEPT RISE-UP PART ARE BURIED ABOUT 10 CENTIMETERS BELOW GROUND SURFACE.

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THE PILOT INFRASTRUCTURE IMPROVEMENT WORKS SOIL RESEARCH AND DEVELOPMENT CENTER PROJECT			
EROSION PLOT			
DWG. NO.	DC - 003	DATE	
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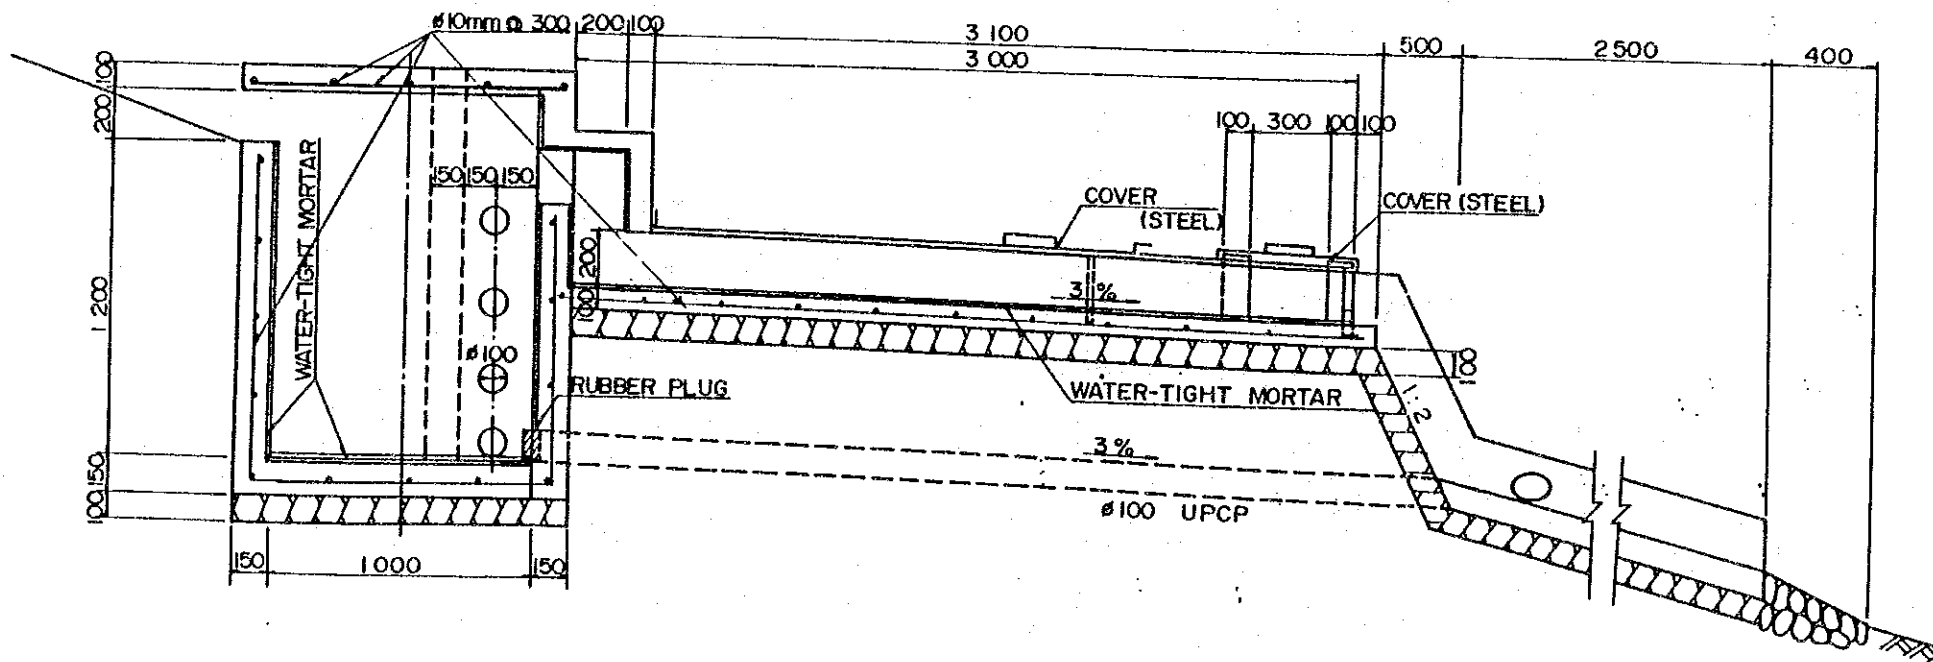
PLAN OF COLLECTING PIT

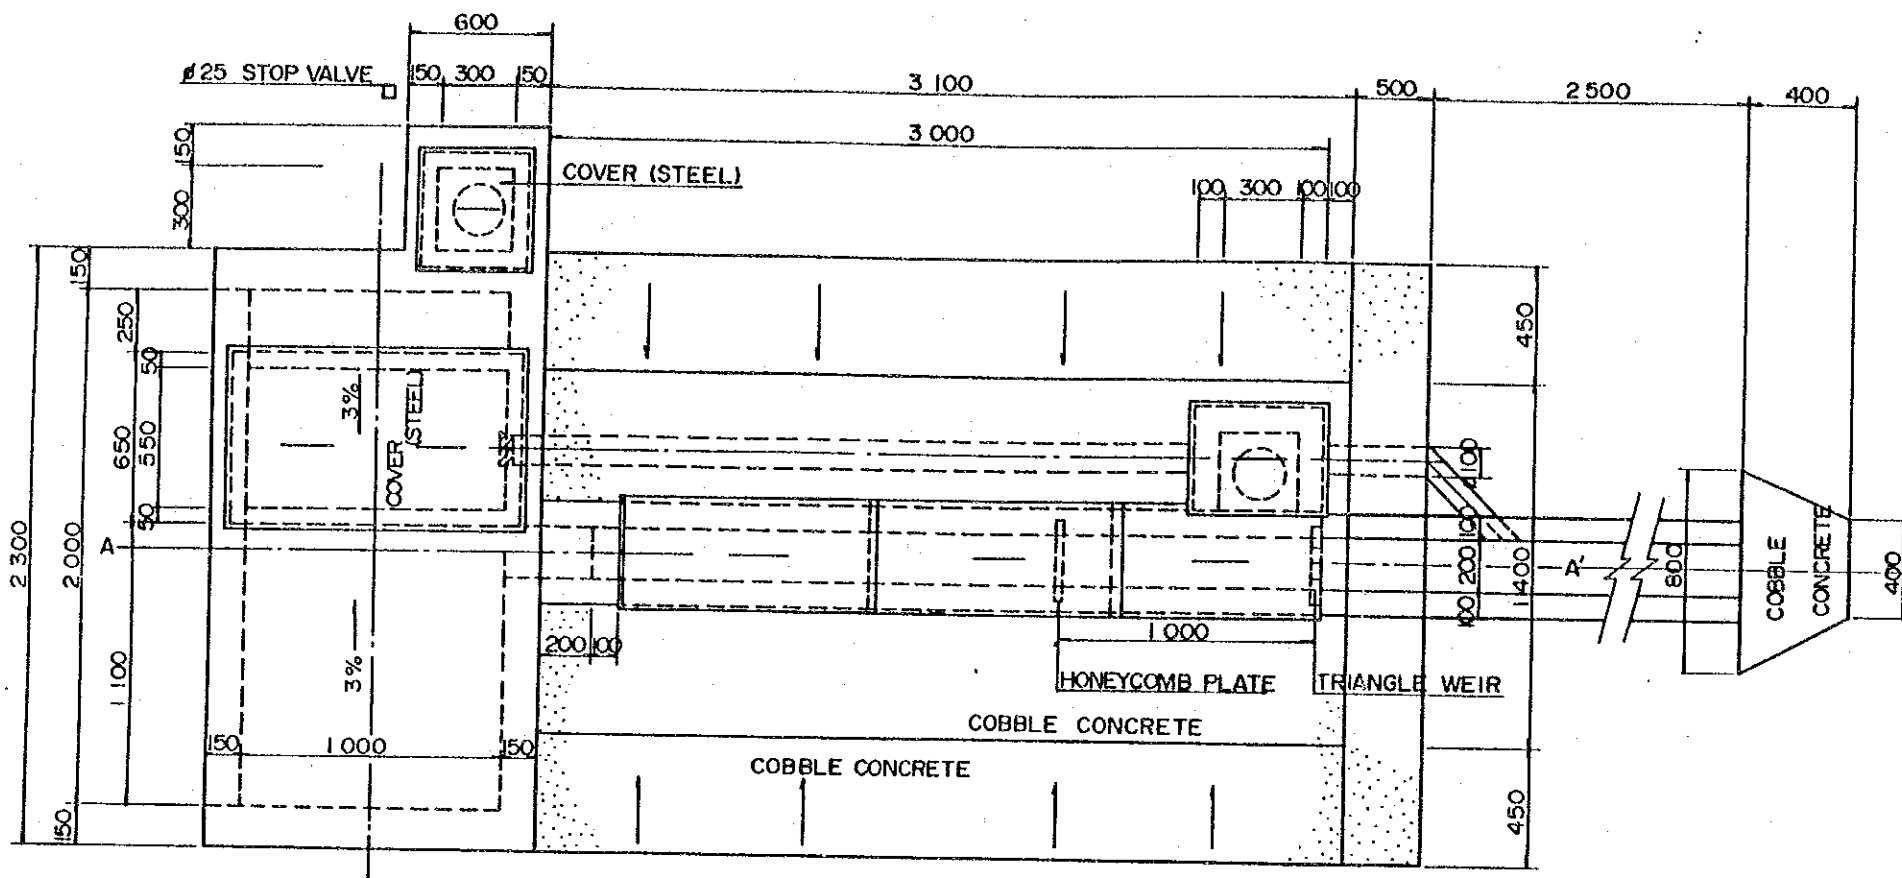

FRONT ELEVATION

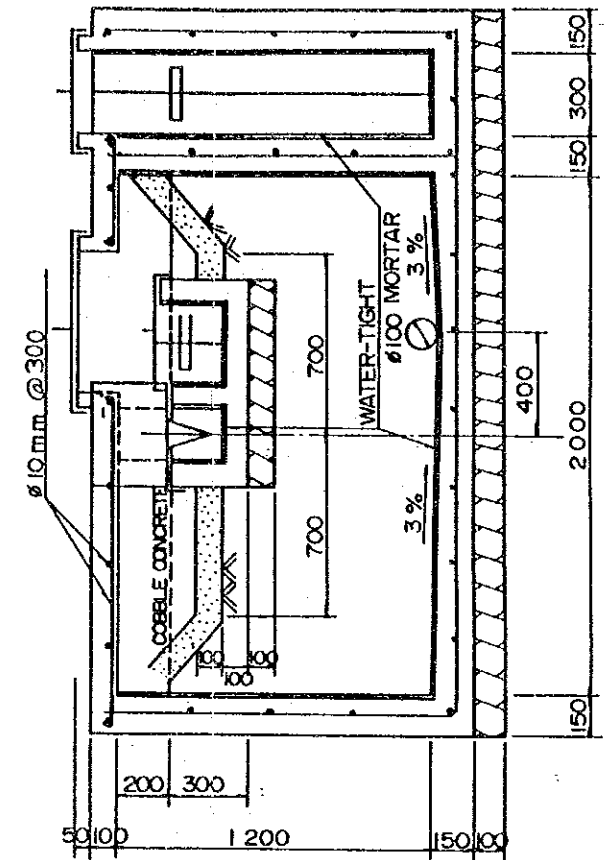
NOTES:

1. ALL DIMENSIONS ARE GIVEN IN MILLIMETERS
2. PIPE INSTALLATION WORKS ARE NOT SHOWN
3. SCALE = 1 : 20




SECTION OF COLLECTING PIT (A ~ A')

REPUBLIC OF THE PHILIPPINES BUREAU OF SOILS AND WATER MANAGEMENT		
THE PILOT INFRASTRUCTURE IMPROVEMENT WORKS SOIL RESEARCH AND DEVELOPMENT CENTER PROJECT		
DETAILED PLAN OF COLLECTING PIT		
DWG. NO.	DC - 004	DATE
JAPAN INTERNATIONAL COOPERATION AGENCY		

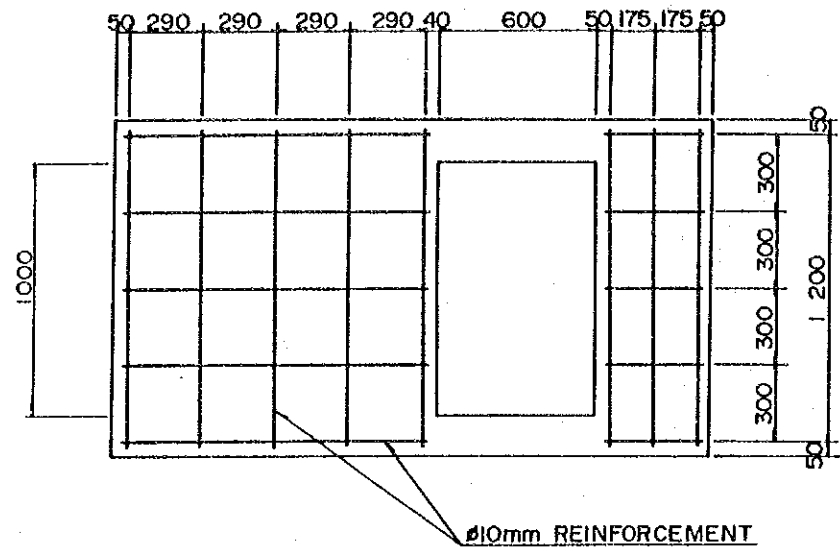


S = 1 : 20

DETAILED PLAN OF REINFORCEMENT FOR COLLECTING PIT

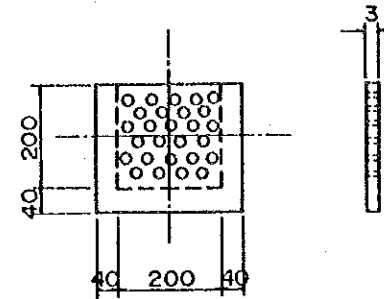


S = 1 : 10

HONZYCOMB PLATE

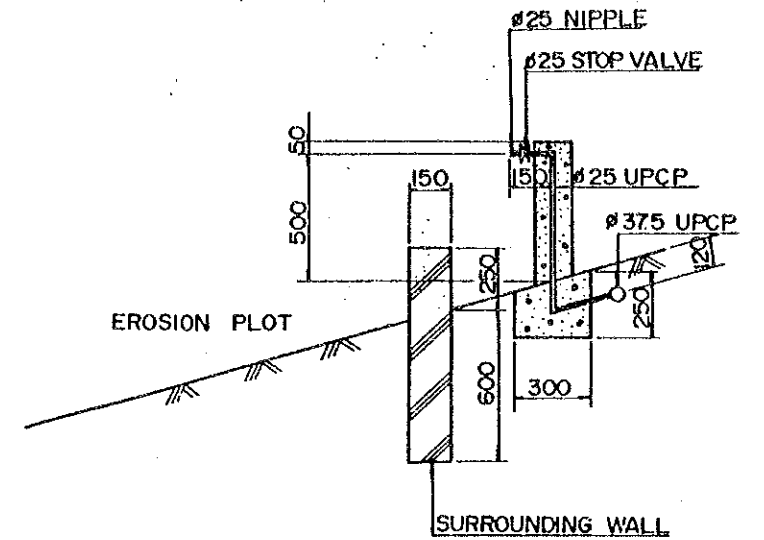


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DETAILED PLAN OF UPSIDE WATER SUPPLY FACILITY

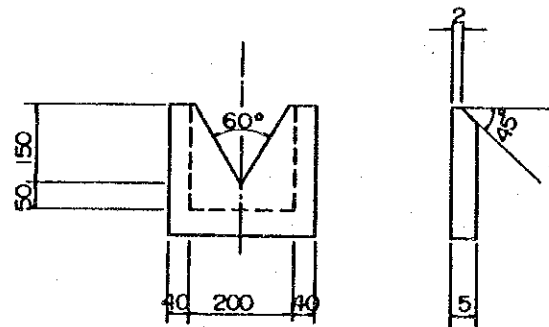


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TRIANGLE WEIR (STAINLESS STEEL)



S = 1 : 10

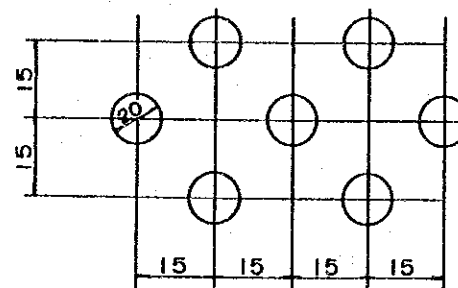
DETAILED PLAN OF HONEYCOMB PLATE

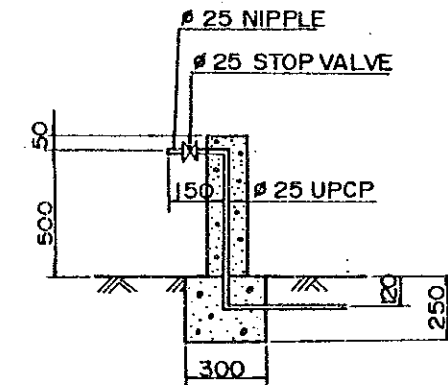

S = 1 : 20

DETAILED PLAN OF DOWNWARD WATER SUPPLY FACILITY

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THE PILOT INFRASTRUCTURE IMPROVEMENT WORKS SOIL RESEARCH AND DEVELOPMENT CENTER PROJECT		
DETAILED PLAN OF EROSION PLOT		
DWG. NO.	DC - 005	DATE
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LEGEND :

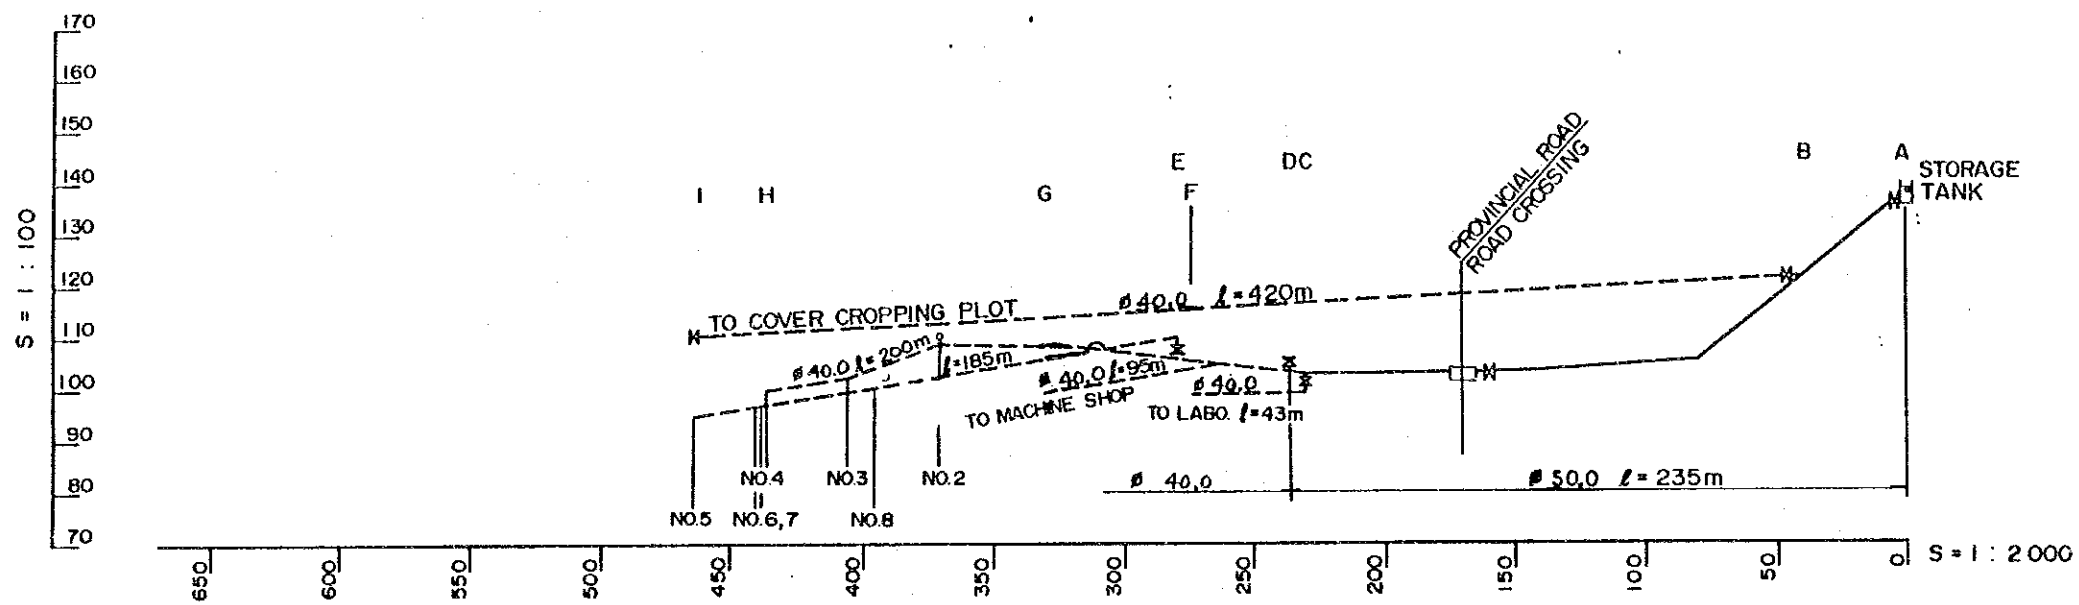
- UNPLASTICIZED POLYVINYL CHLORIDE PIPE
- " " " "
- M BLOCK VALVE
- ⊕ AIR VENT

PIPELINE	Ø	LENGTH
A — D	50.0 mm	235 m
D — H	40.0	200
B — I	40.0	420
C — F	40.0	43
D — G	40.0	95
E — I	40.0	185

NOTES :

1. ALL PIPES EXCEPT RISE-UP PART ARE BURIED ABOUT 10 CENTIMETERS BELOW GROUND SURFACE.
2. ALL PIPES SHALL BE UNPLASTICIZED POLYVINYL CHLORIDE PIPES.

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THE PILOT INFRASTRUCTURE IMPROVEMENT WORKS SOIL RESEARCH AND DEVELOPMENT CENTER PROJECT			
PROFILE OF WATER PIPELINE			
DWG. NO.	DC - 006	DATE	
JAPAN INTERNATIONAL COOPERATION AGENCY			

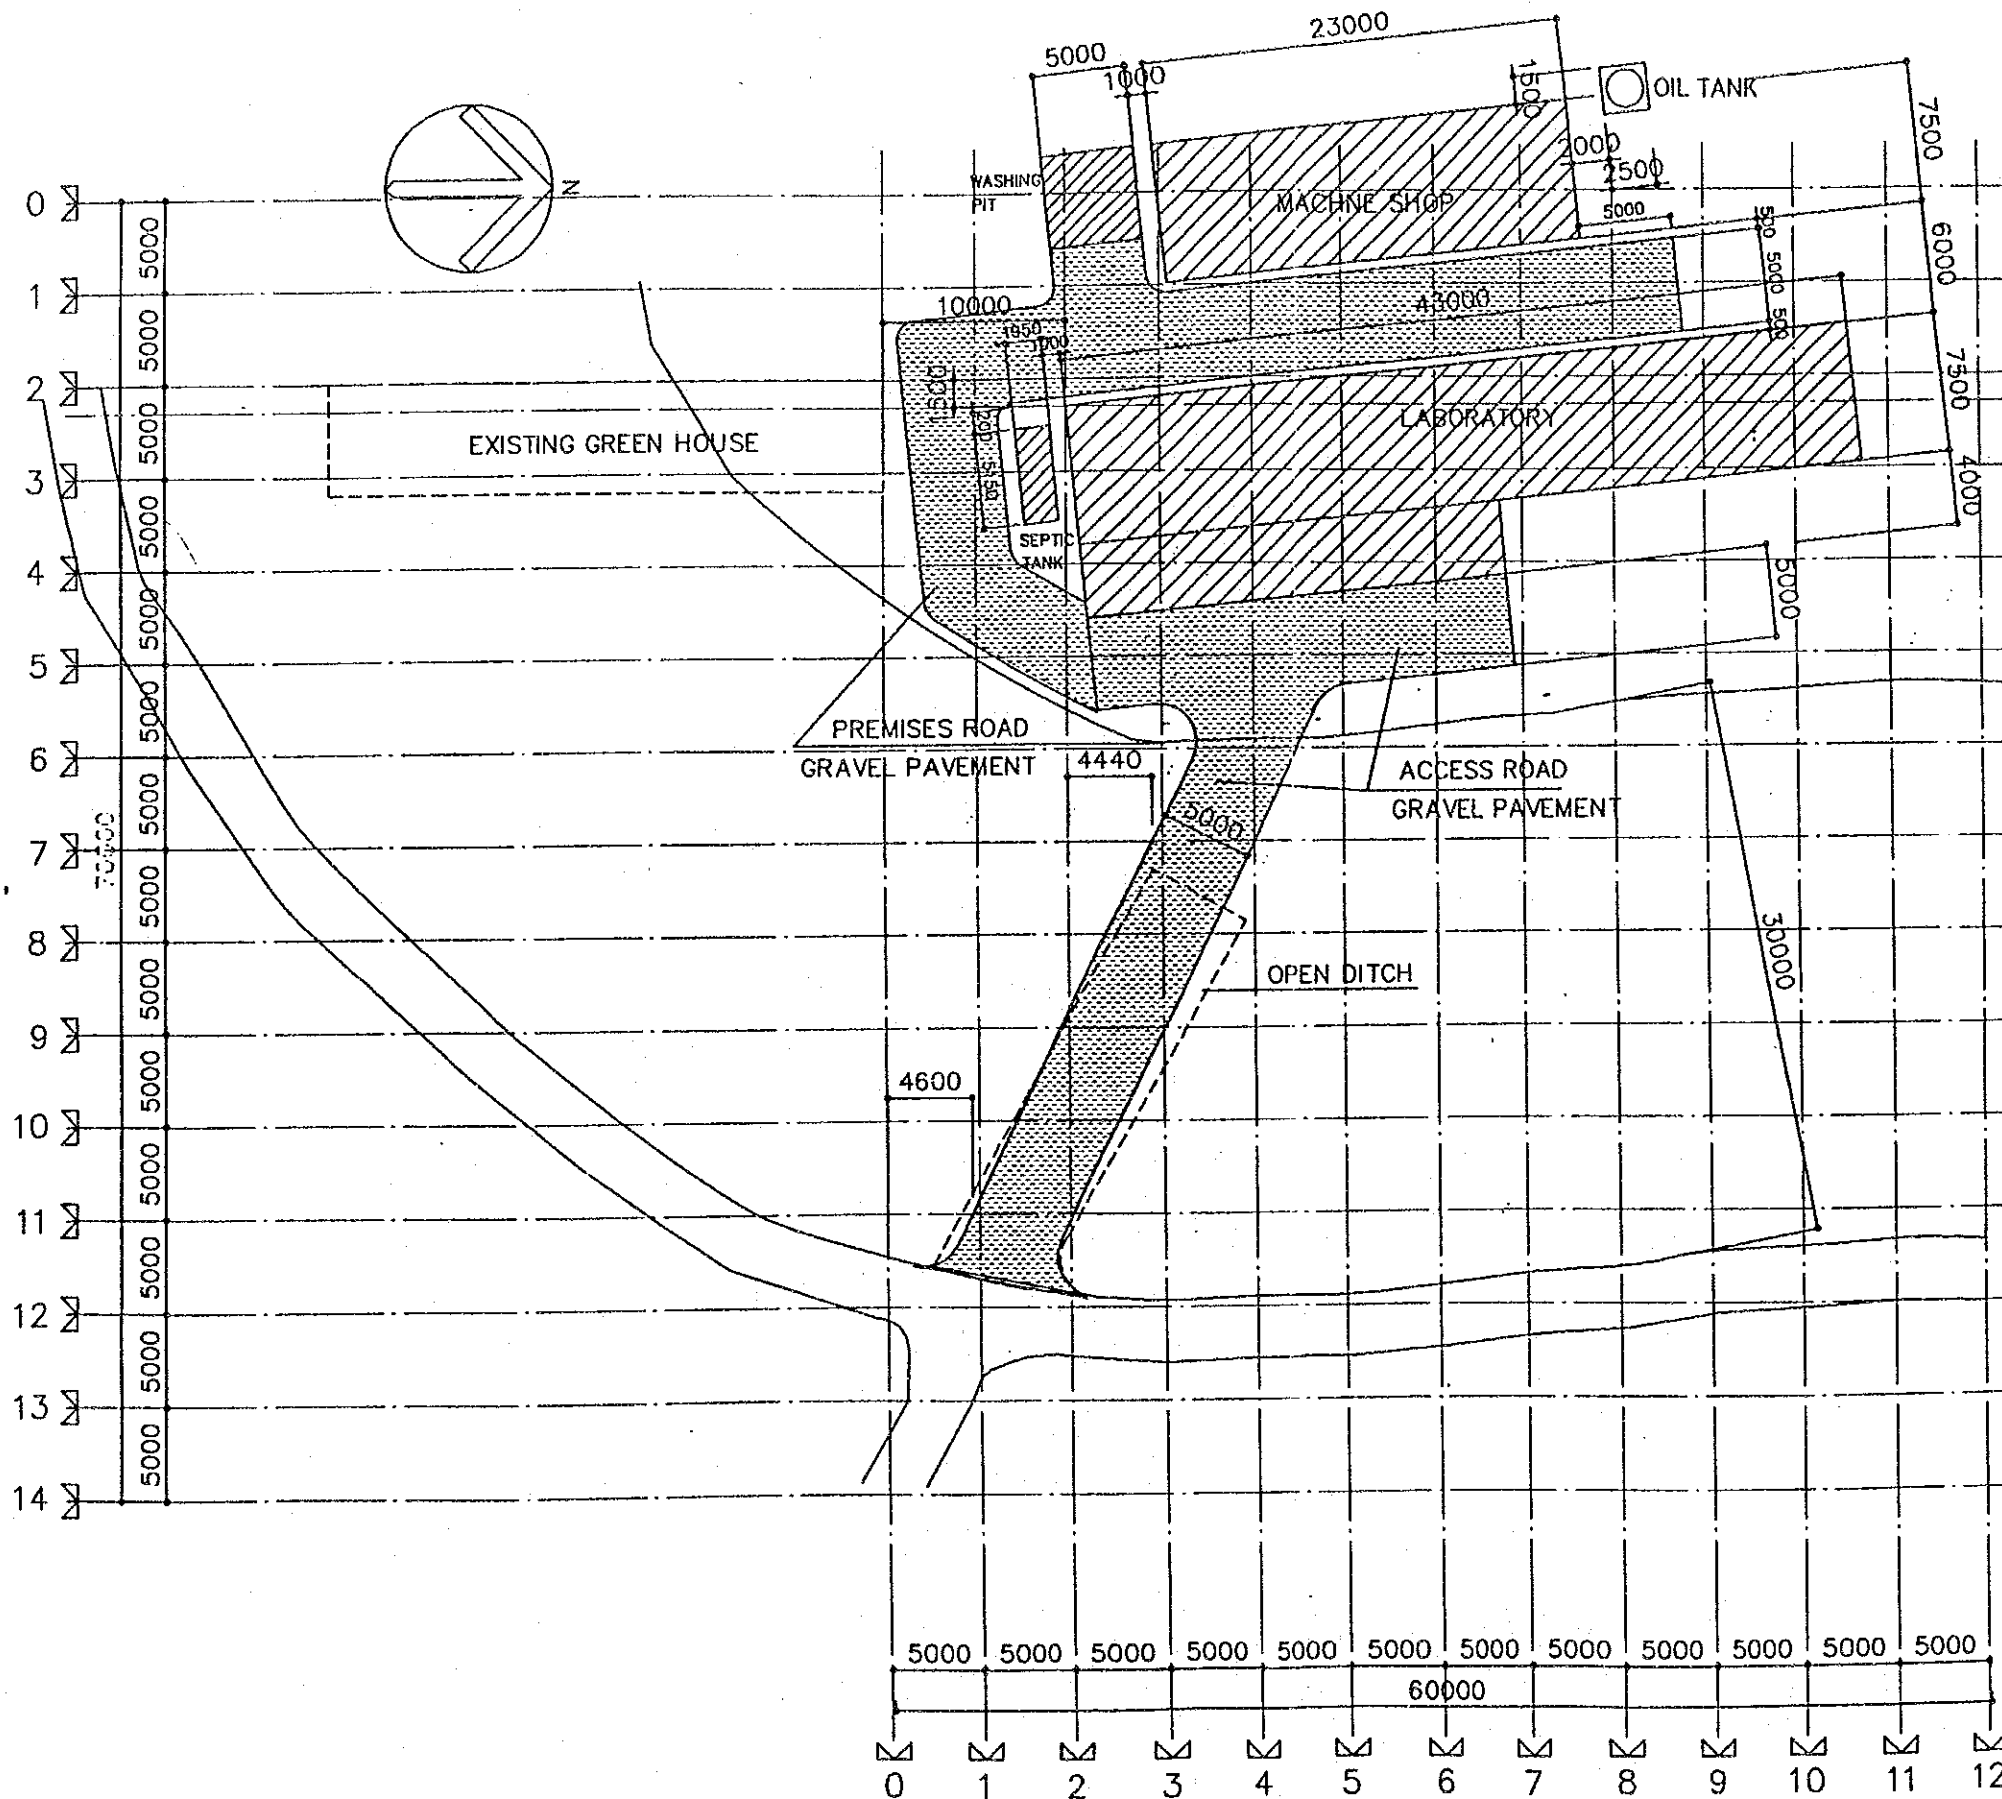


GL=99,500

REPUBLIC OF THE PHILIPPINES BUREAU OF SOILS AND WATER MANAGEMENT			
THE PILOT INFRASTRUCTURE IMPROVEMENT WORKS SOIL RESEARCH AND DEVELOPMENT CENTER PROJECT			
SITE PLAN		1/400	
DWG. NO.	DC-007	DATE	
JAPAN INTERNATIONAL COOPERATION AGENCY			


GENERAL FINISHINGS

	ROOF	EXTERNAL WALL		AREA	FLOOR	SKIRTING	INTERNAL WALL	CEILING
LABORATORY 414.5 M ²	WOODEN TRUSS PRE-PAINTED COLOR ROOF	150mmCHB W/ CEMENT PLASTER FINISH, AND PAINTED EMULSION PAINT	EXHIBITION ROOM	75.0 M ²	LOCAL VINYL TILES 12"x12" T=2.0	WOOD H=100	MORTAR & PAINTED	PLYWOOD(6)EMULSION.P
			RESEARCH ROOM	75.0 M ²	LOCAL VINYL TILES 12"x12" T=2.0	WOOD H=100	MORTAR & PAINTED	PLYWOOD(6)EMULSION.P
			DRYING ROOM	75.0 M ²	MORTAR	MORTAR H=100	MORTAR	—————
			STORAGE	75.0 M ²	MORTAR	MORTAR H=100	EXPOSED CHB	—————
			LAVATORY	22.5 M ²	MOSAIC TILES	—————	CERAMIC TILE H=1800 & PAINTED	PLYWOOD(6)EMULSION.P
			WORKING SPACE	92.0 M ²	CONCRETE FINISH			
MACHINE SHOP 172.5 M ²	WOODEN TRUSS PRE-PAINTED COLOR ROOF	150mmCHB W/ CEMENT PLASTER FINISH, AND PAINTED EMULSION PAINT	WORKING AREA	112.5 M ²	MORTAR	MORTAR H=100	MORTAR	—————
			OFFICE	18.75 M ²	LOCAL VINYL TILES 12"x12" T=2.0	WOOD H=100	MORTAR & PAINTED	PLYWOOD(6)EMULSION.P
			TOOL ROOM 1	7.5 M ²	MORTAR	MORTAR H=100	MORTAR & PAINTED	PLYWOOD(6)EMULSION.P
			TOOL ROOM 2	11.25 M ²	MORTAR	MORTAR H=100	MORTAR & PAINTED	PLYWOOD(6)EMULSION.P
			GENERATOR ROOM	22.5 M ²	MORTAR	MORTAR H=100	—————	—————
WASHING PIT 25.0 M ²	—————	CONCRETE FINISH		CONCRETE FINISH	—————	—————	—————	
STORAGE TANK 30.0 M ²	CONCRETE FINISH	CONCRETE FINISH		WATER PROOF MORTAR (T=30)	—————	WATER PROOF MORTAR (T=30)	—————	
OIL TANK BASE	CONCRETE FINISH							
ACCESS ROAD	GRAVEL PAVEPENT T=100							
PREMISES ROAD	GRAVEL PAVEPENT T=100							

REPUBLIC OF THE PHILIPPINES BUREAU OF SOILS AND WATER MANAGEMENT			
THE PILOT INFRASTRUCTURE IMPROVEMENT WORKS SOIL RESEARCH AND DEVELOPMENT CENTER PROJECT			
GENERAL FINISHINGS			
DWG.NO.	DC-008	DATE	
JAPAN INTERNATIONAL COOPERATION AGENCY			

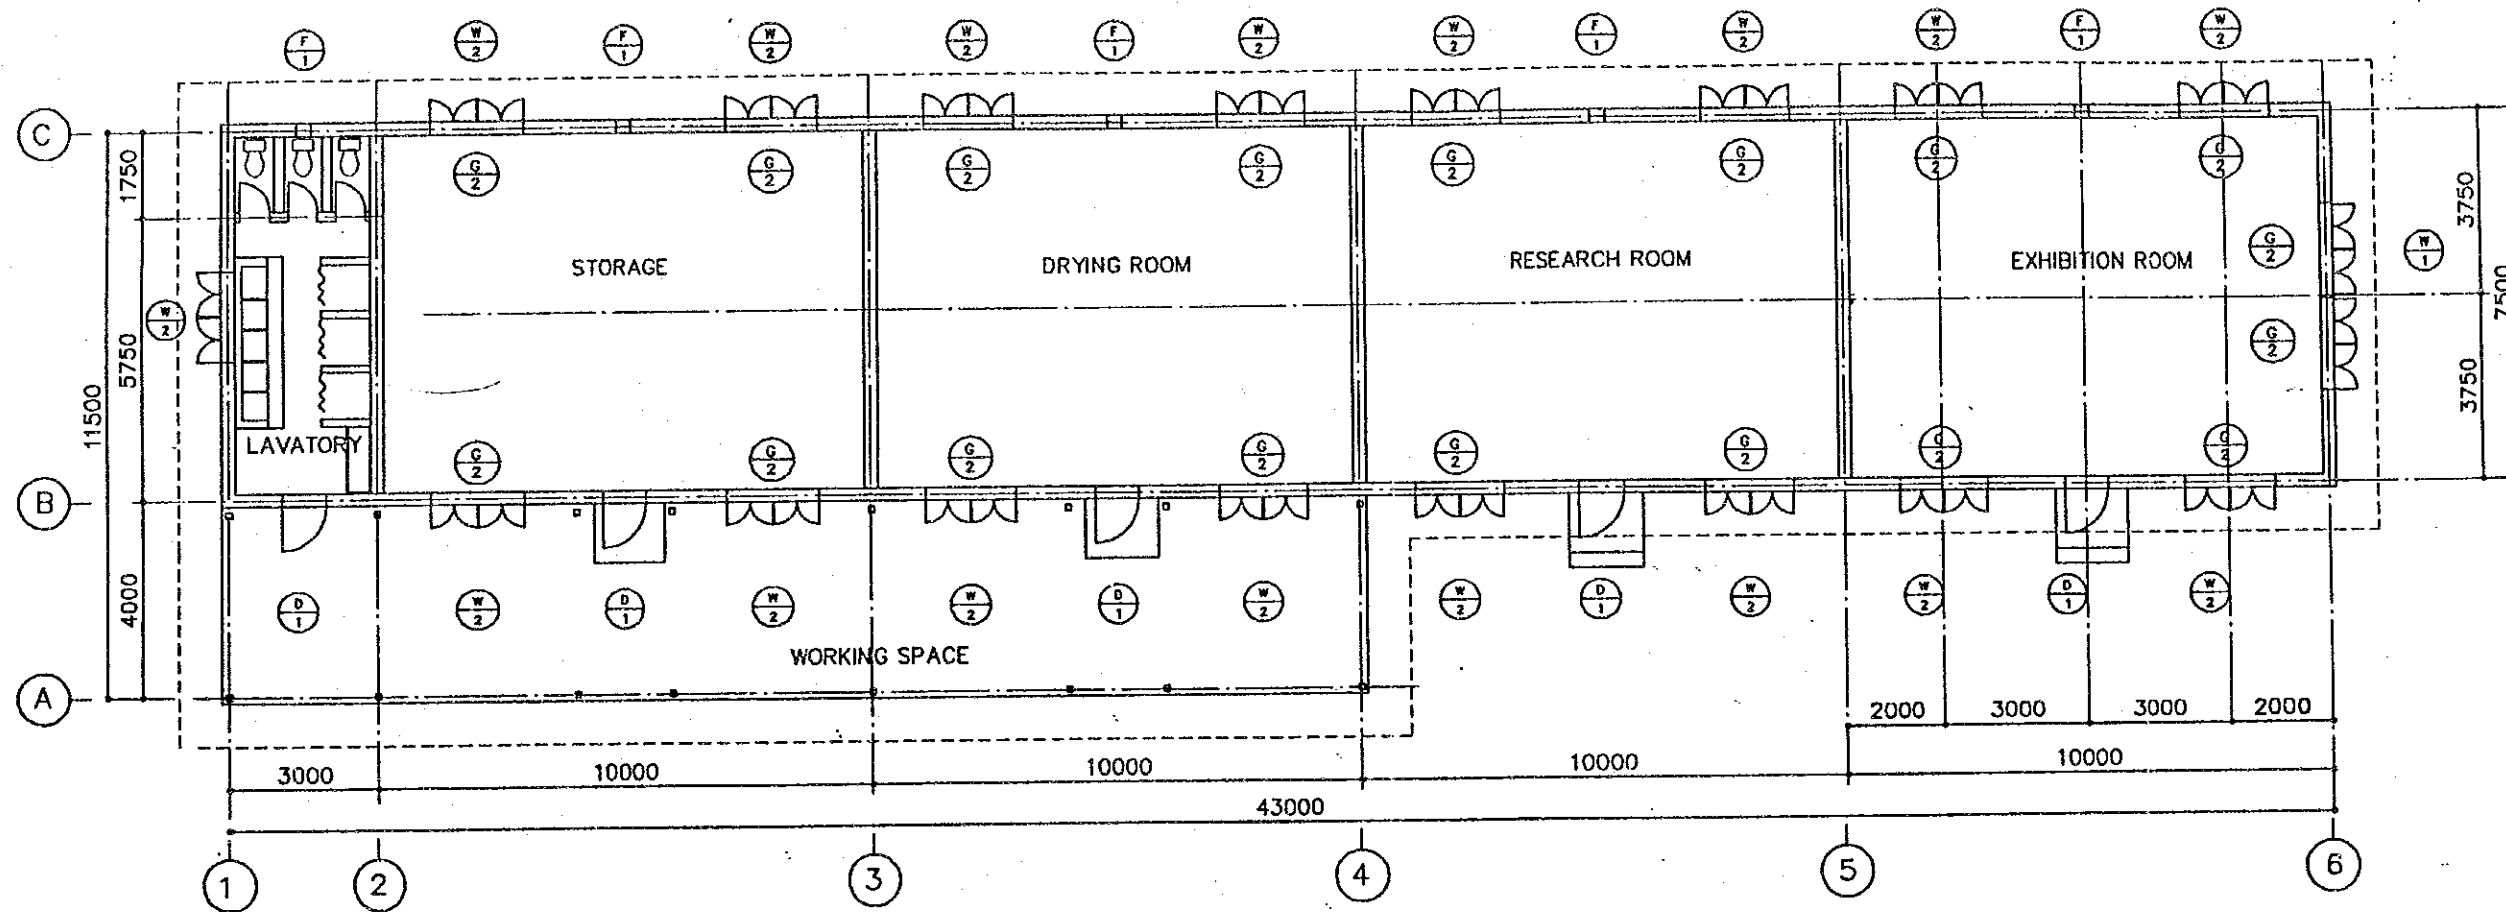


STEEL GRILL STEEL FLAT PLATE T=5 OP

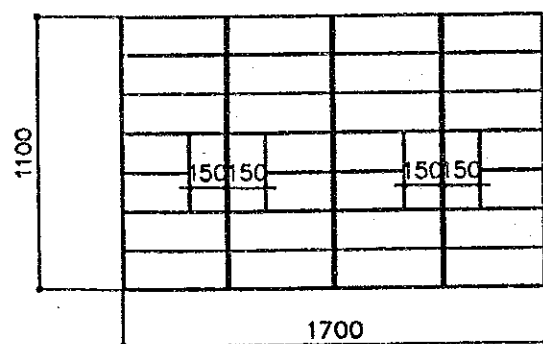


NOTE

MARK	SIZE	TYPE	UNIT	Q.T	
W-1	900x1160x4	STEEL HINGE SIDE OPEN	ea	1	STEEL HINGE CLEAR GLASS T=3
W-2	900x1160x2	"	"	17	HANDLES OIL PAINT
D-1	900x2100	STEEL FLASH DOOR	"	5	HINGES LOCKSET
F-1	φ300	CONT.FAN	"	5	
G-2	1700 x 1100	STEEL GRILL		18	OP


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THE PILOT INFRASTRUCTURE IMPROVEMENT WORKS SOIL RESEARCH AND DEVELOPMENT CENTER PROJECT			
LABORATORY I 1/150			
DWG.NO.	DC- 009	DATE	
JAPAN INTERNATIONAL COOPERATION AGENCY			

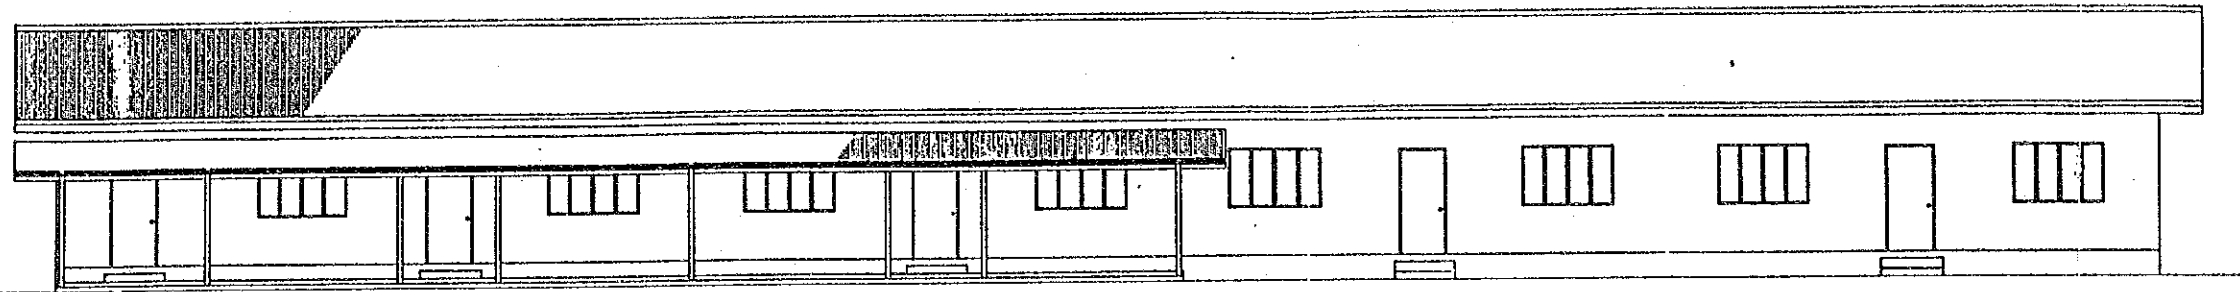


EAST SIDE

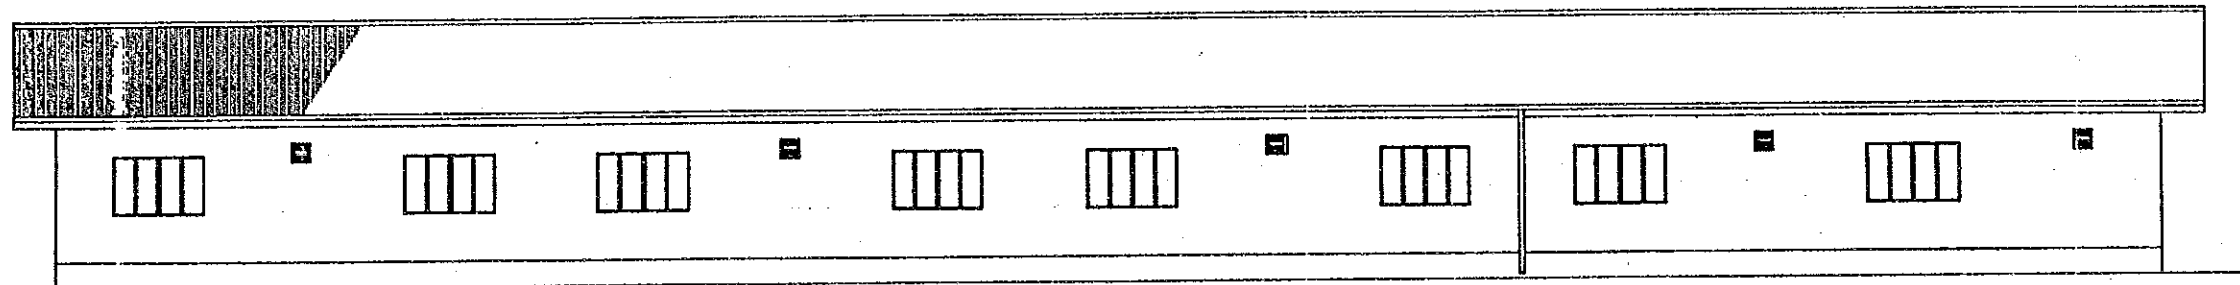


WEST SIDE

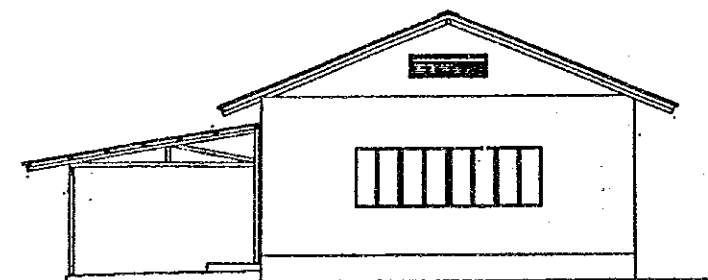


NORTH SIDE

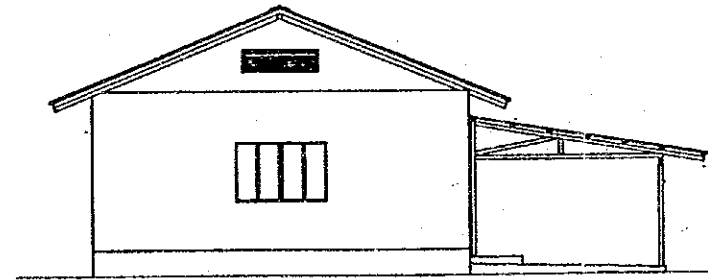

SOUTH SIDE

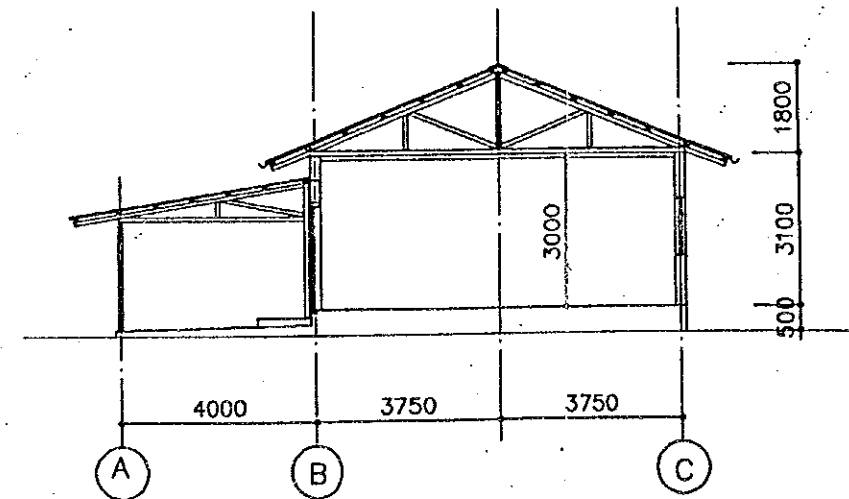




REPUBLIC OF THE PHILIPPINES BUREAU OF SOILS AND WATER MANAGEMENT			
THE PILOT INFRASTRUCTURE IMPROVEMENT WORKS SOIL RESEARCH AND DEVELOPMENT CENTER PROJECT			
LABORATORY I 1/150			
DWG. NO.	DC- 010	DATE	
JAPAN INTERNATIONAL COOPERATION AGENCY			

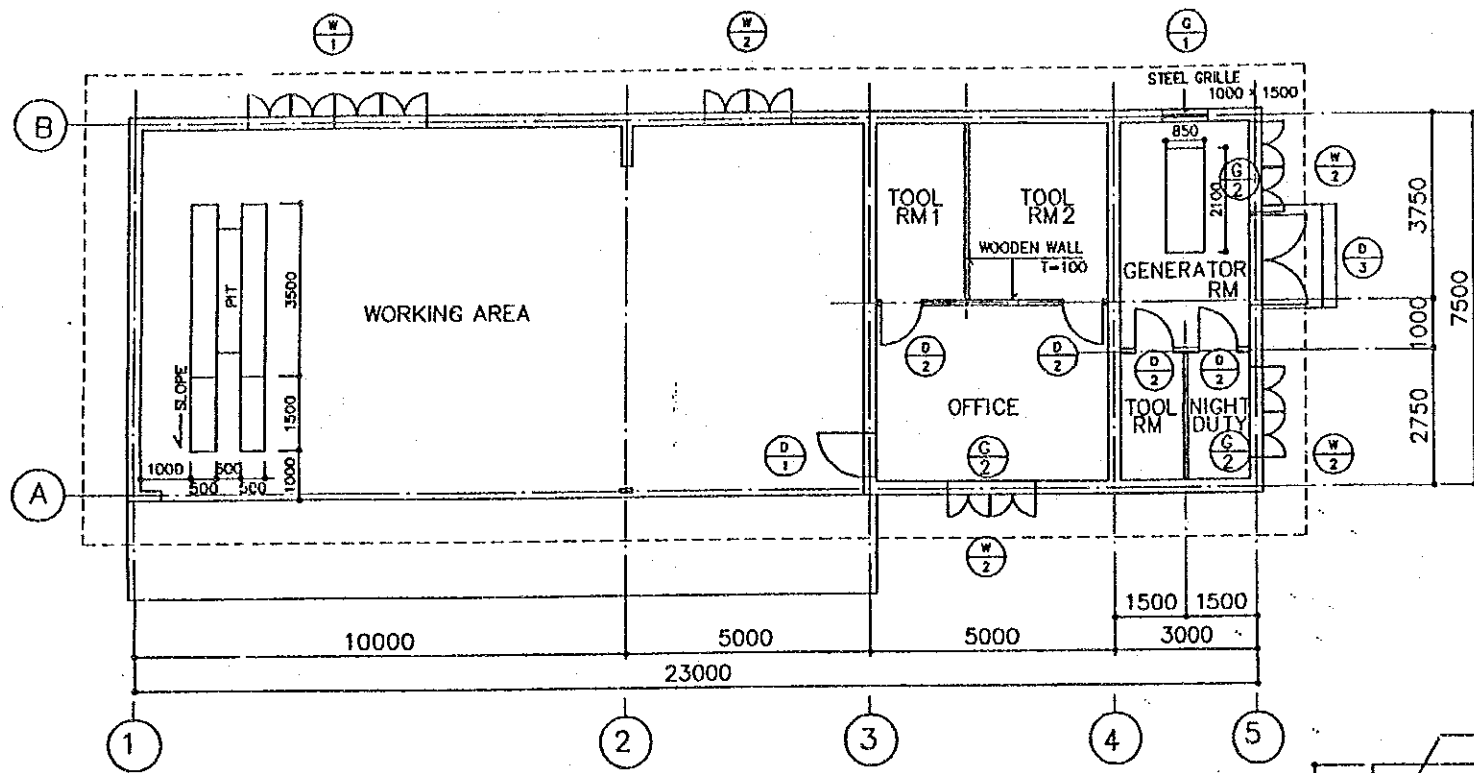

MACHINE SHOP 1/150

NOTE


MARK	SIZE	TYPE	UNIT	Q.T	
W-1	900x1160x4	STEEL, HINGE SIDE OPEN	ea	1	CLEAR GLASS T=3
W-2	900x1160x2	"	"	4	HINGE HANDLES
D-1	900x2100	STEEL FLASH DOOR	"	1	OP
D-2	800x2100	WOODEN FLASH DOOR	"	4	OP
D-3	2000x2100	STEEL FLASH DOOR	"	1	STEEL GRILLE OP
G-1	1000 x 1500	STEEL GRILLE			OP
G-2	1700 x 1100	STEEL GRILLE		3	OP

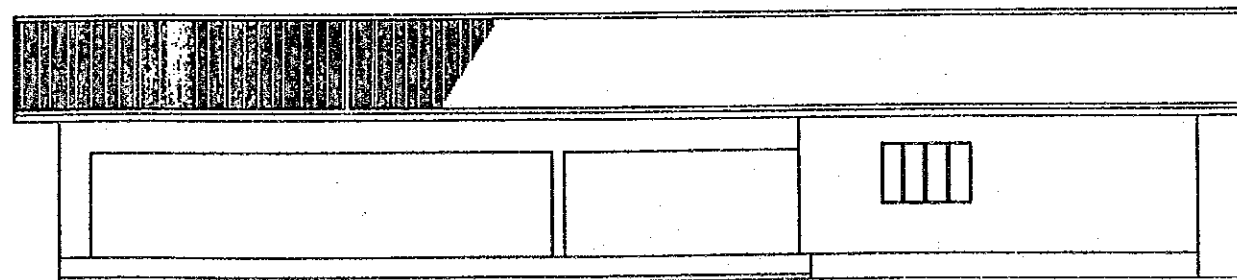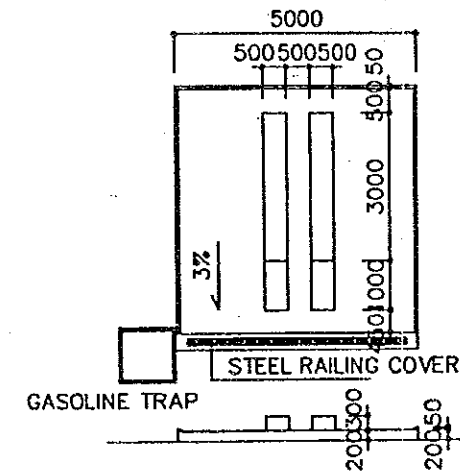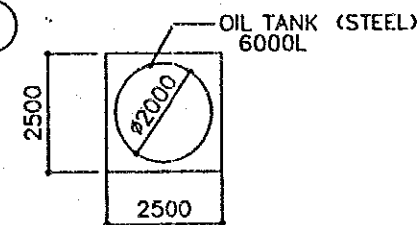


EAST SIDE



NORTH SIDE

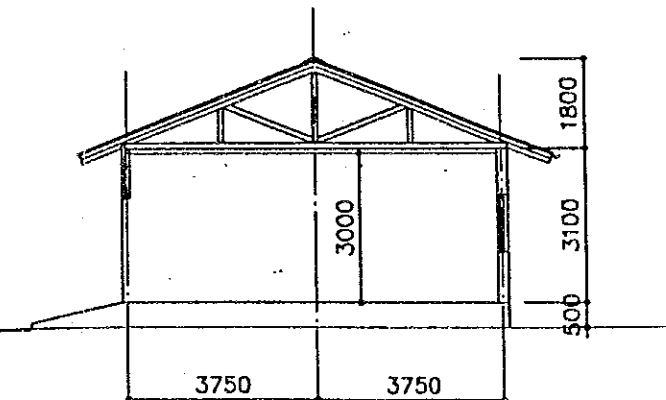


SOUTH SIDE


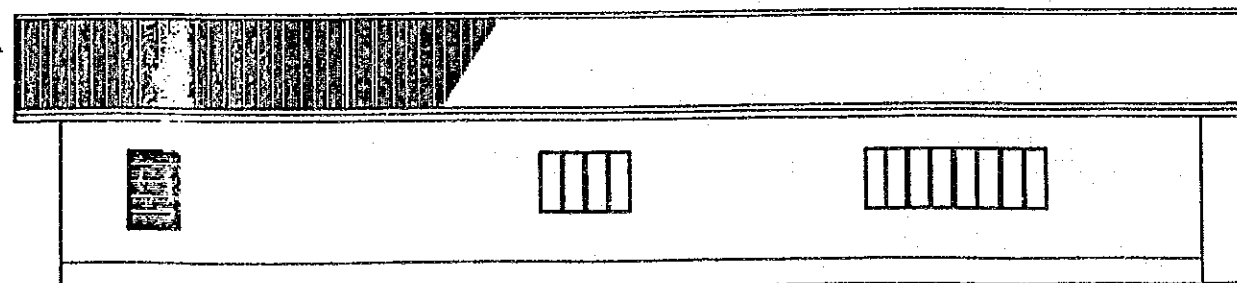


WEST SIDE


REPUBLIC OF THE PHILIPPINES BUREAU OF SOILS AND WATER MANAGEMENT		
THE PILOT INFRASTRUCTURE IMPROVEMENT WORKS SOIL RESEARCH AND DEVELOPMENT CENTER PROJECT		
MACHINE SHOP 1/150		
DWG. NO. ... DC-011	DATE	
JAPAN INTERNATIONAL COOPERATION AGENCY		

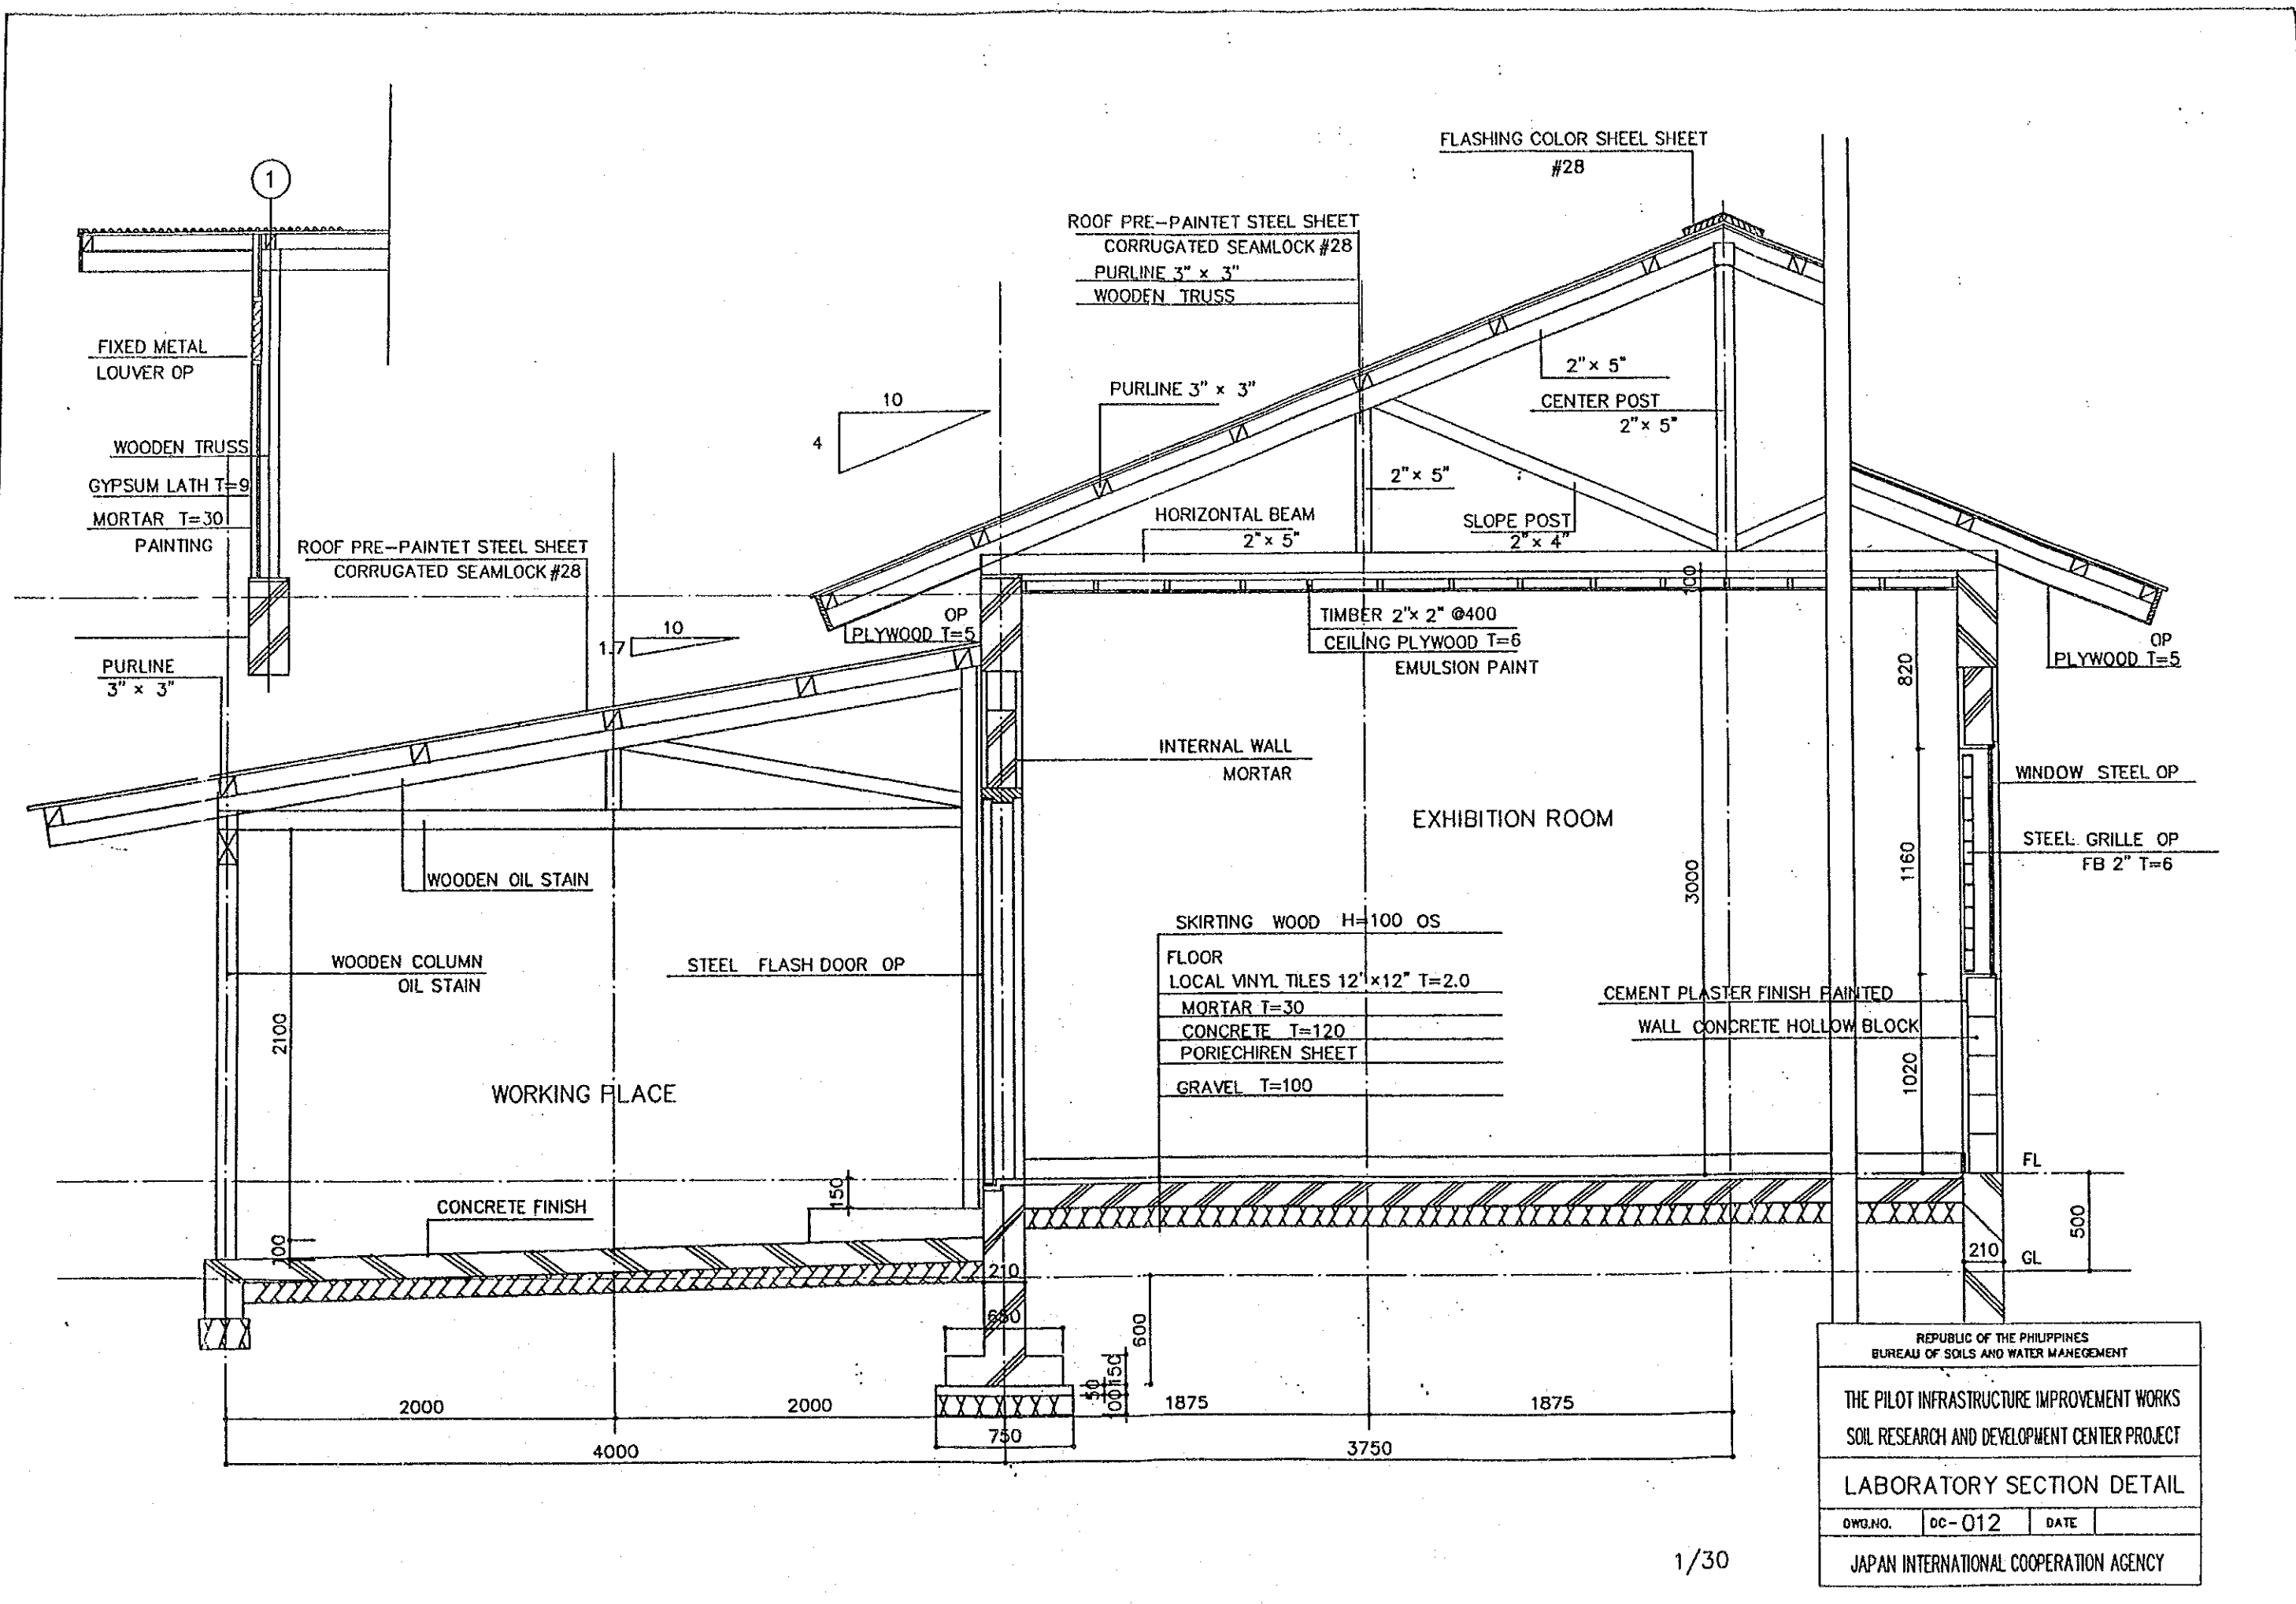


REPUBLIC OF THE PHILIPPINES
 BUREAU OF SOILS AND WATER MANAGEMENT
 THE PILOT INFRASTRUCTURE IMPROVEMENT WORKS
 SOIL RESEARCH AND DEVELOPMENT CENTER PROJECT
 LABORATORY SECTION DETAIL
 DWG. NO. DC-012 DATE
 JAPAN INTERNATIONAL COOPERATION AGENCY

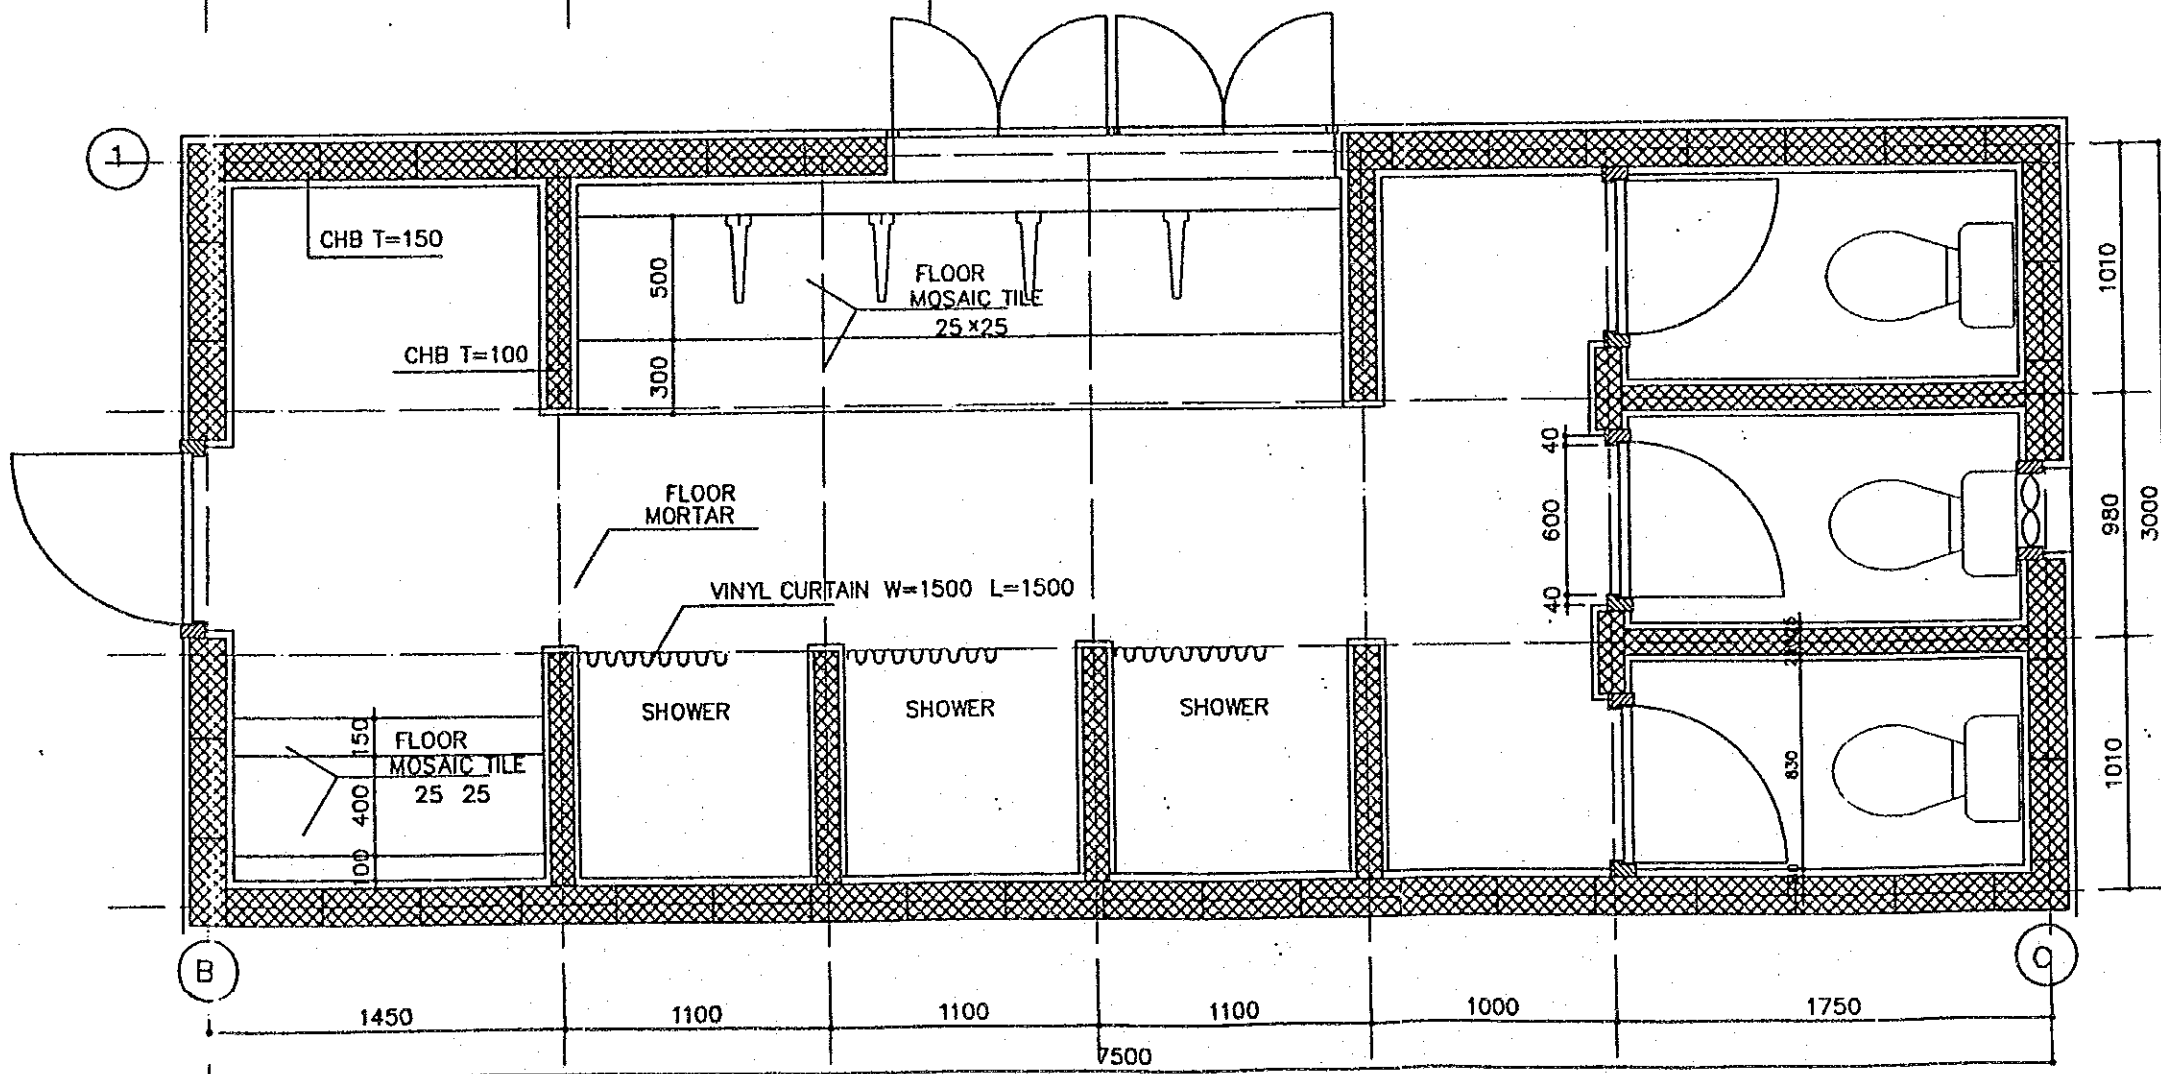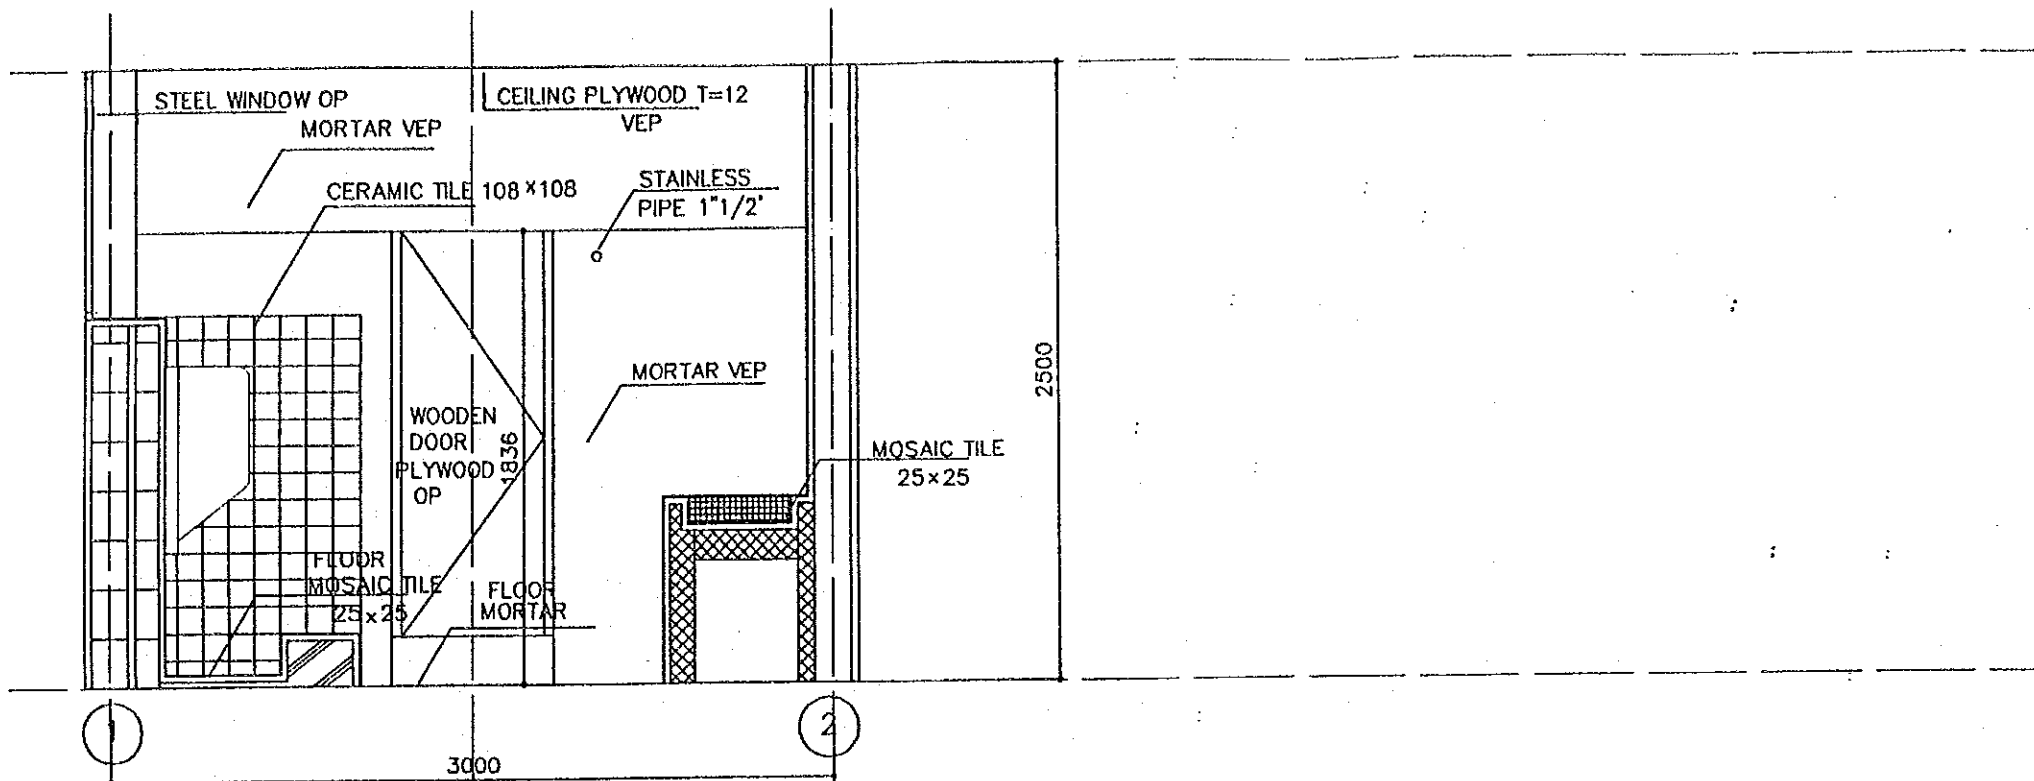


REPUBLIC OF THE PHILIPPINES			
BUREAU OF SOILS AND WATER MANAGEMENT			
THE PILOT INFRASTRUCTURE IMPROVEMENT WORKS			
SOIL RESEARCH AND DEVELOPMENT CENTER PROJECT			
LAVATORY PLAN SECTION DETAIL 1/30			
DWG. NO.	DC-014	DATE	
JAPAN INTERNATIONAL COOPERATION AGENCY			

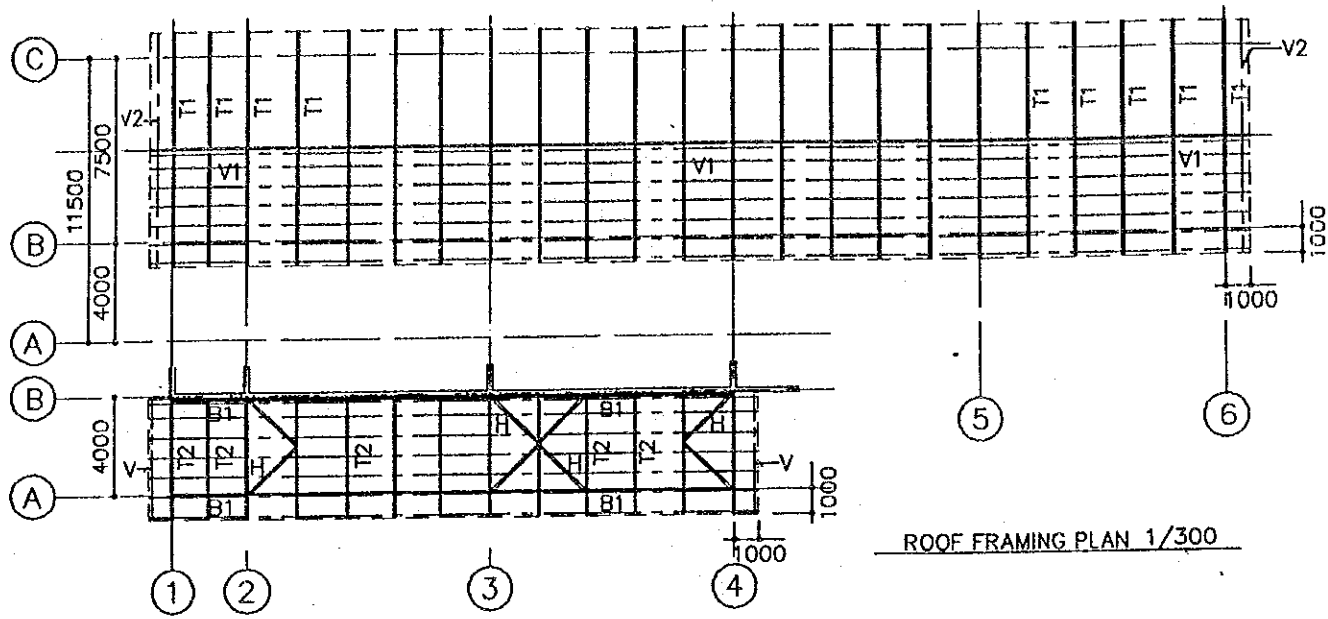


ROOF FRAMING PLAN 1/300

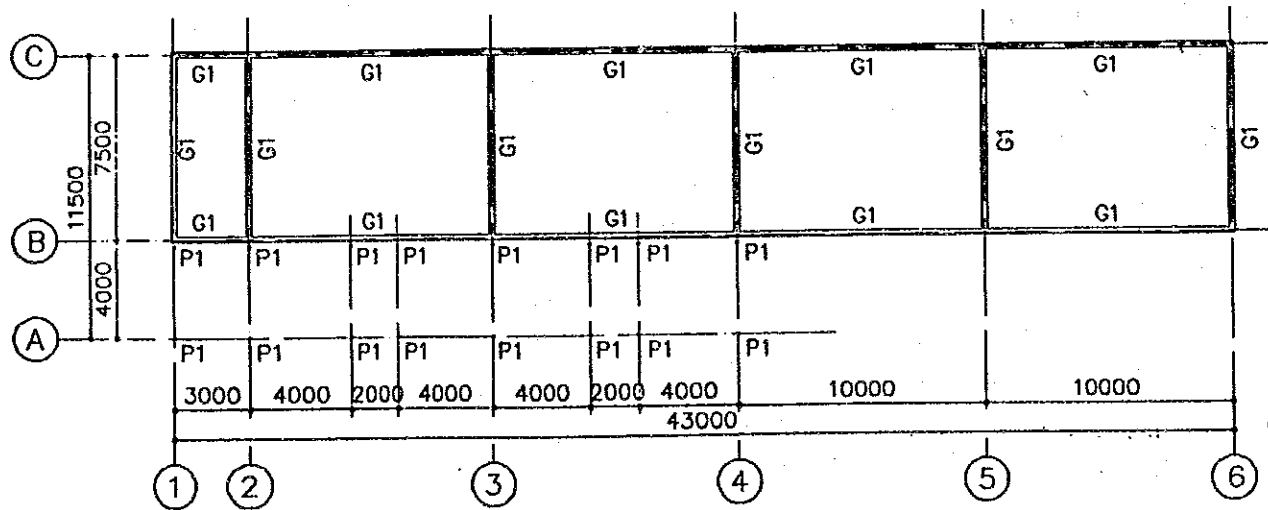

WALL TOP BEAM PLAN 1/300

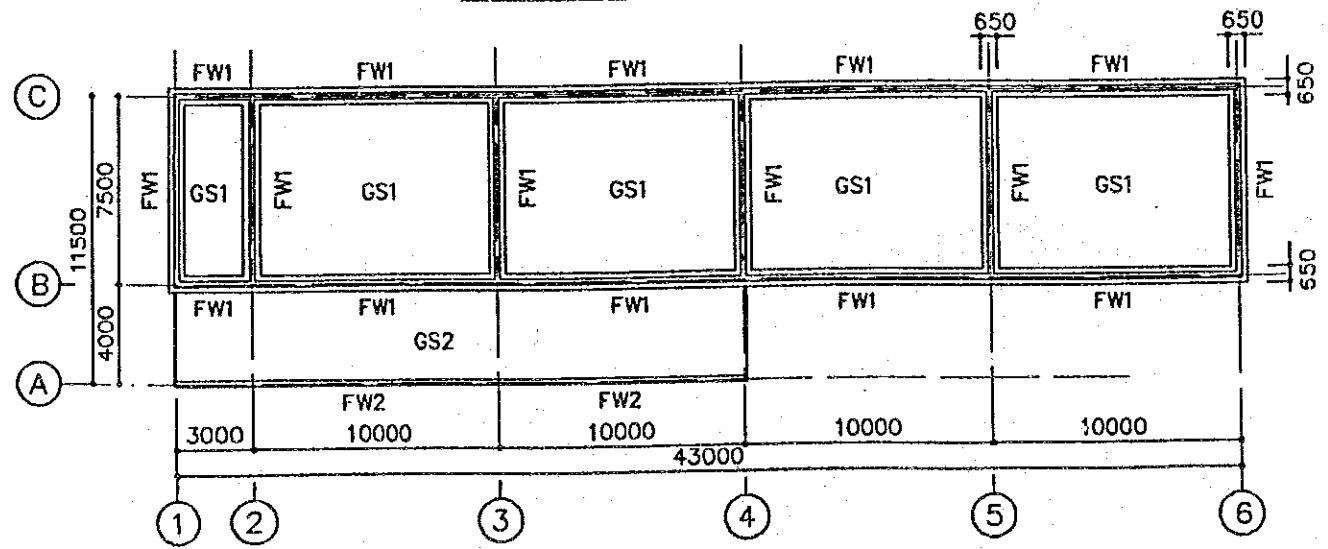


FOUNDATION PLAN 1/300

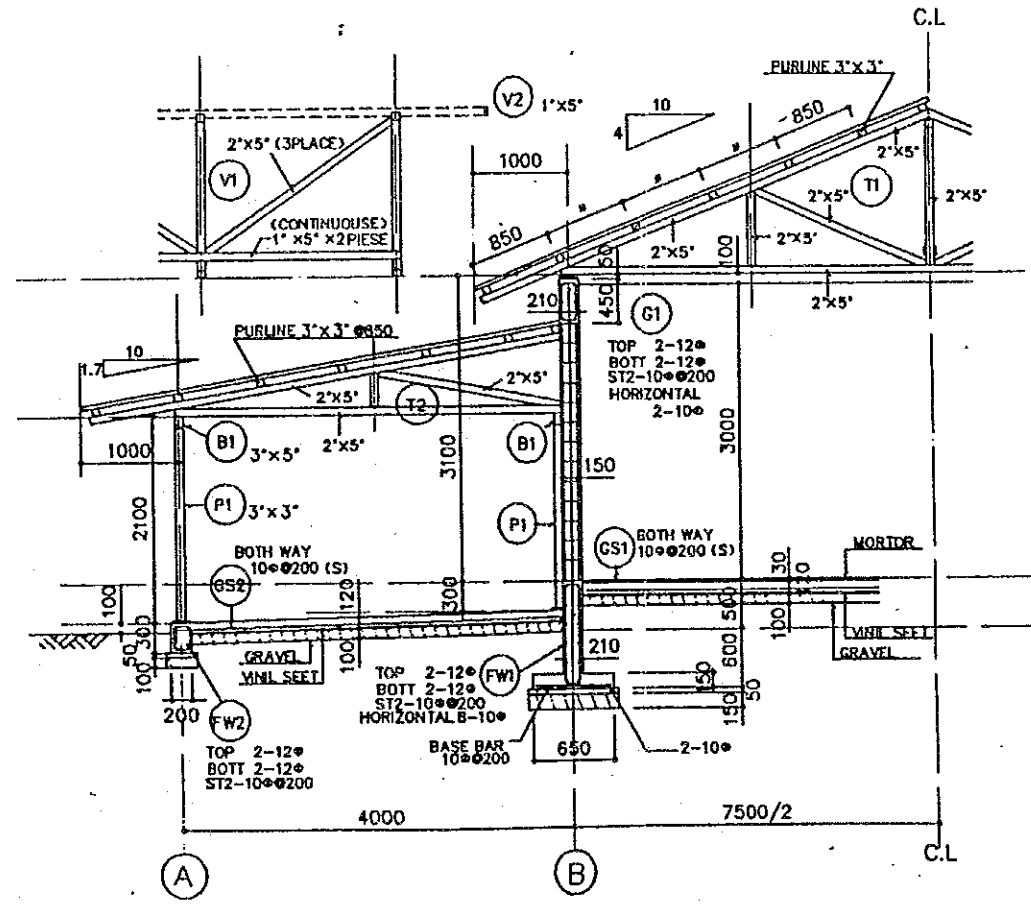


SECTION DETAIL 1/75


REPUBLIC OF THE PHILIPPINES BUREAU OF SOILS AND WATER MANAGEMENT		
THE PILOT INFRASTRUCTURE IMPROVEMENT WORKS SOIL RESEARCH AND DEVELOPMENT CENTER PROJECT		
LABORATORY STRUCTURE		
DWG. NO.	DC- 015	DATE
JAPAN INTERNATIONAL COOPERATION AGENCY		

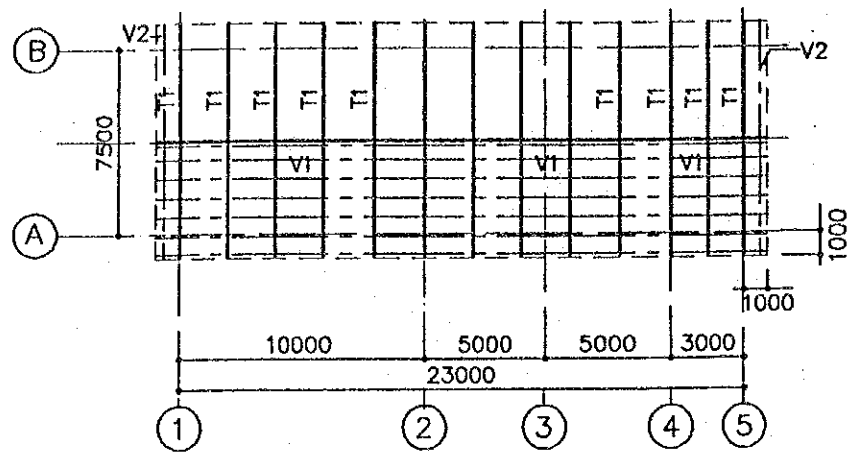




ROOF FRAMING PLAN 1/300

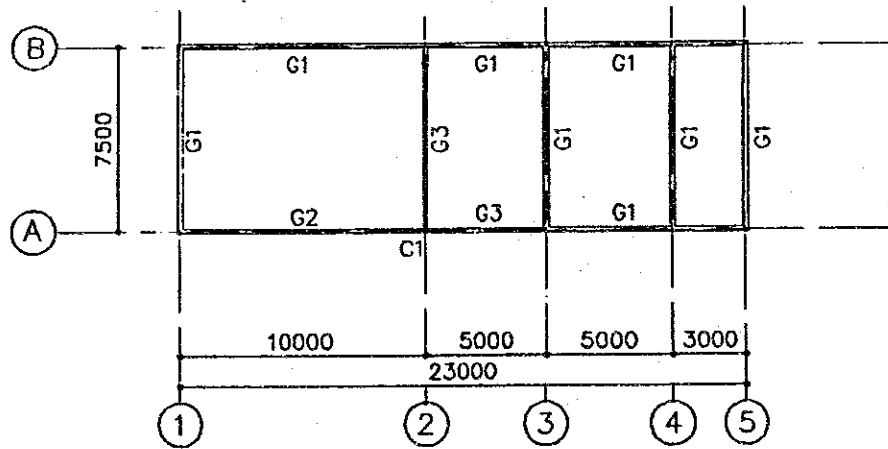



WALL TOP BEAM PLAN 1/300

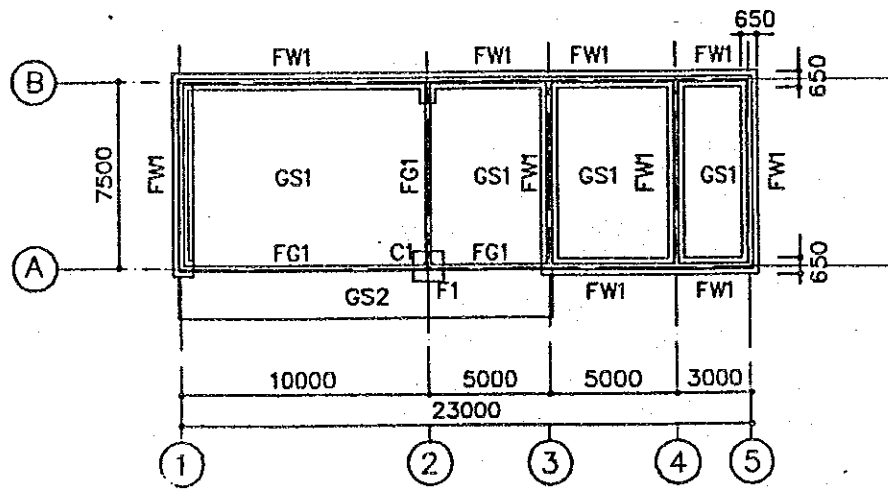

FOUNDATION PLAN 1/300

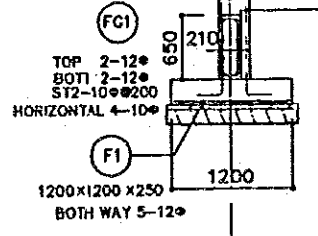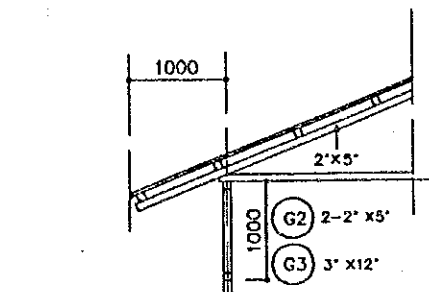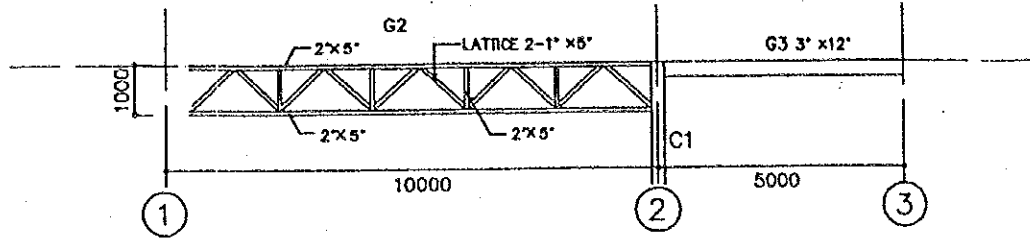


SECTION DETAIL 1/75

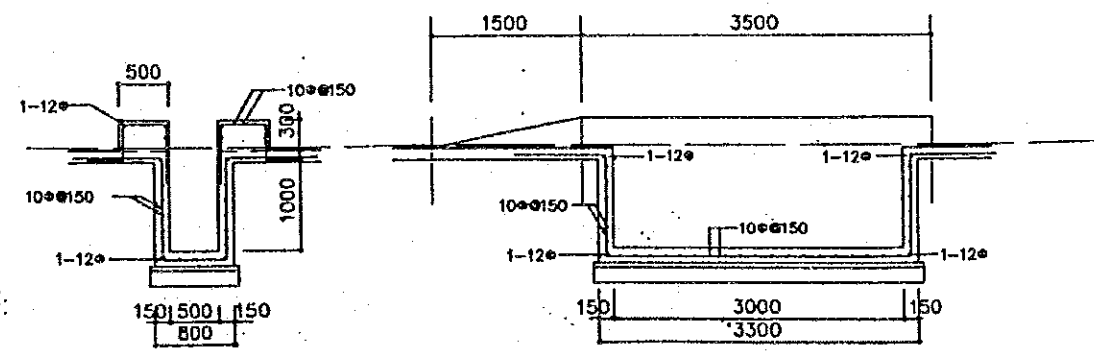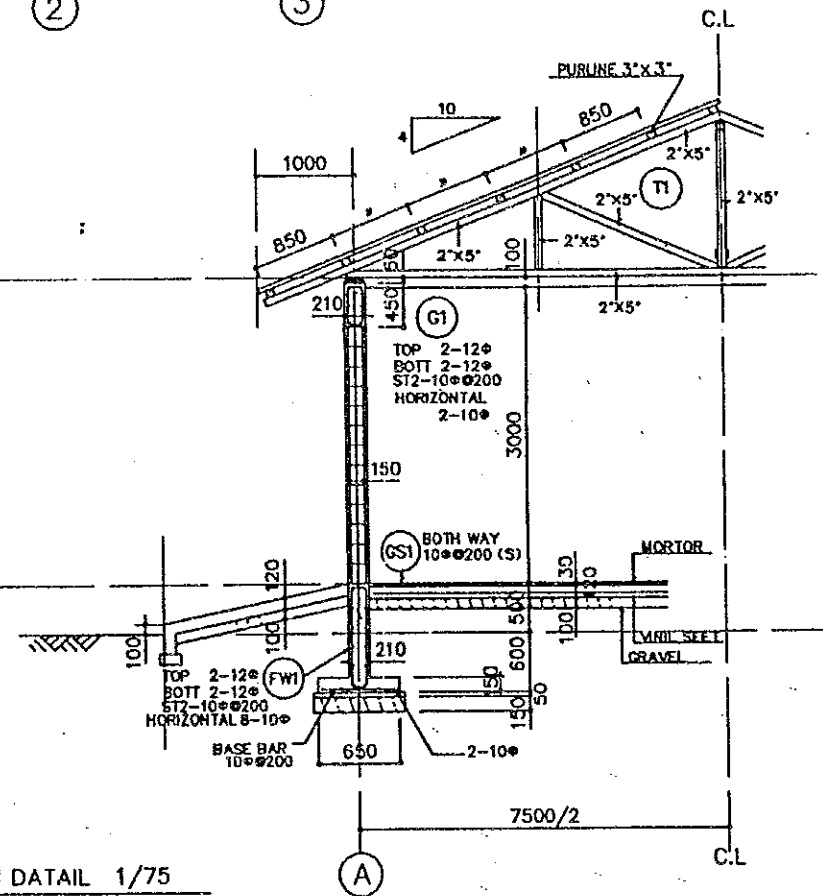


PIT SECTION DETAIL 1/75


REPUBLIC OF THE PHILIPPINES			
BUREAU OF SOILS AND WATER MANAGEMENT			
THE PILOT INFRASTRUCTURE IMPROVEMENT WORKS			
SOIL RESEARCH AND DEVELOPMENT CENTER PROJECT			
MACHINE SHOP STRUCTURE			
DWG. NO.	DC- 016	DATE	
JAPAN INTERNATIONAL COOPERATION AGENCY			

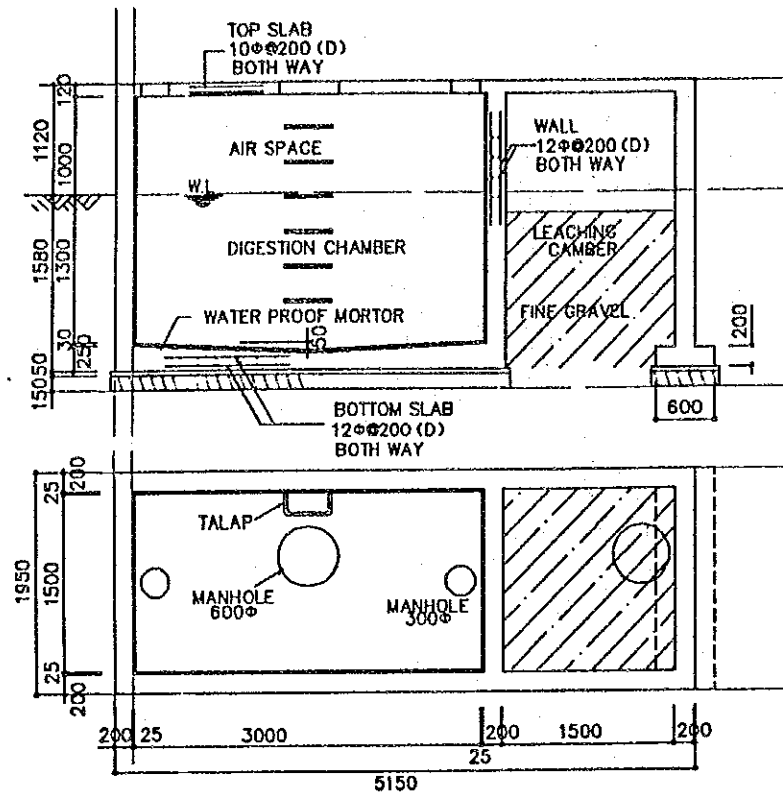


SEPTIC TANK 1/75

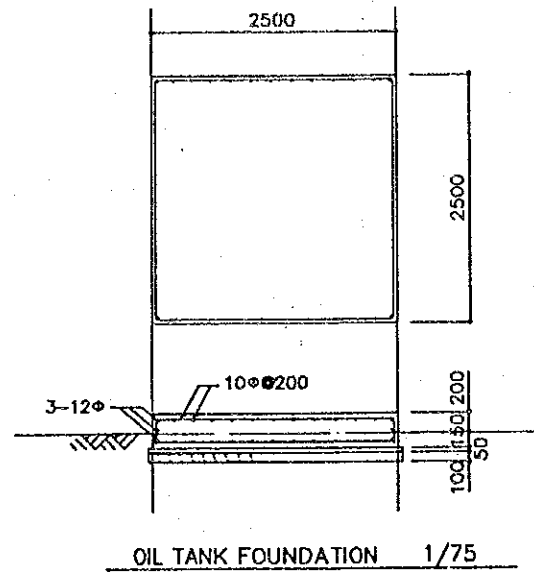

OIL TANK FOUNDATION 1/75

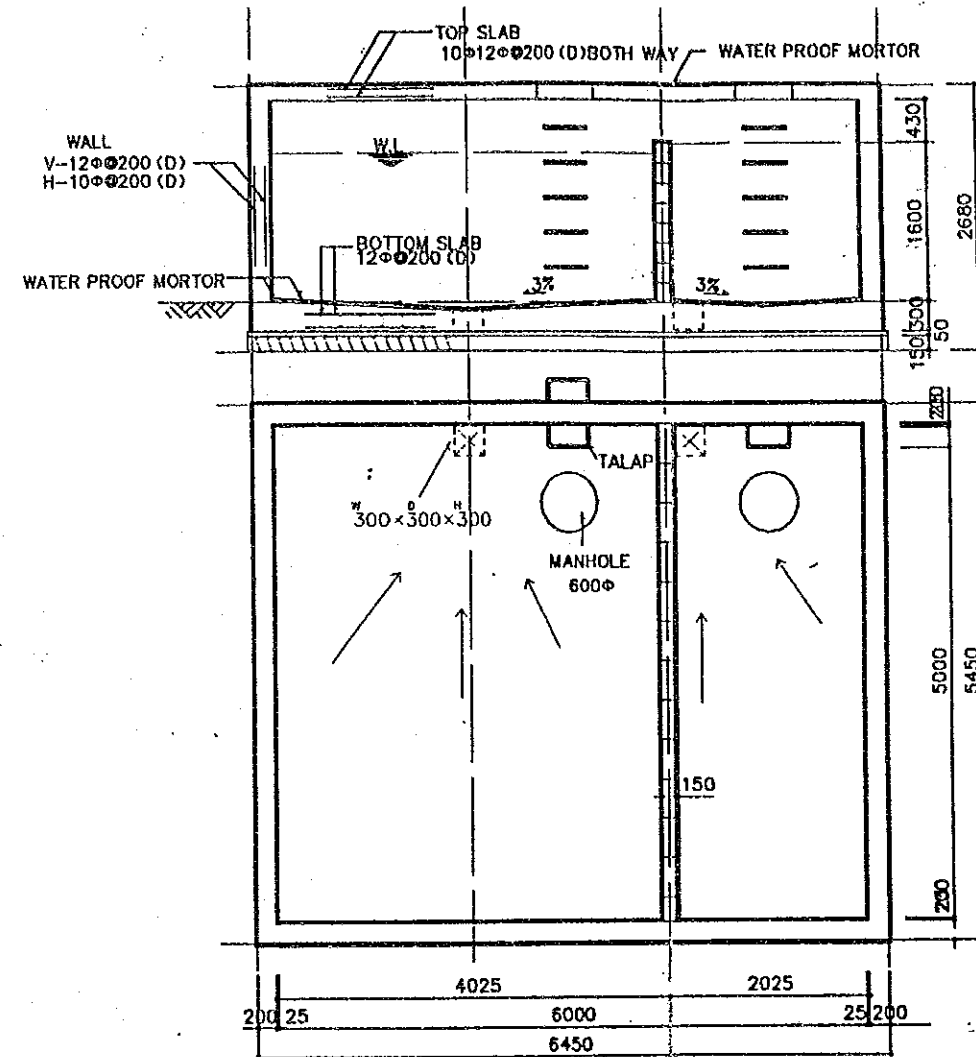

WATER STORAGE TANK 1/75

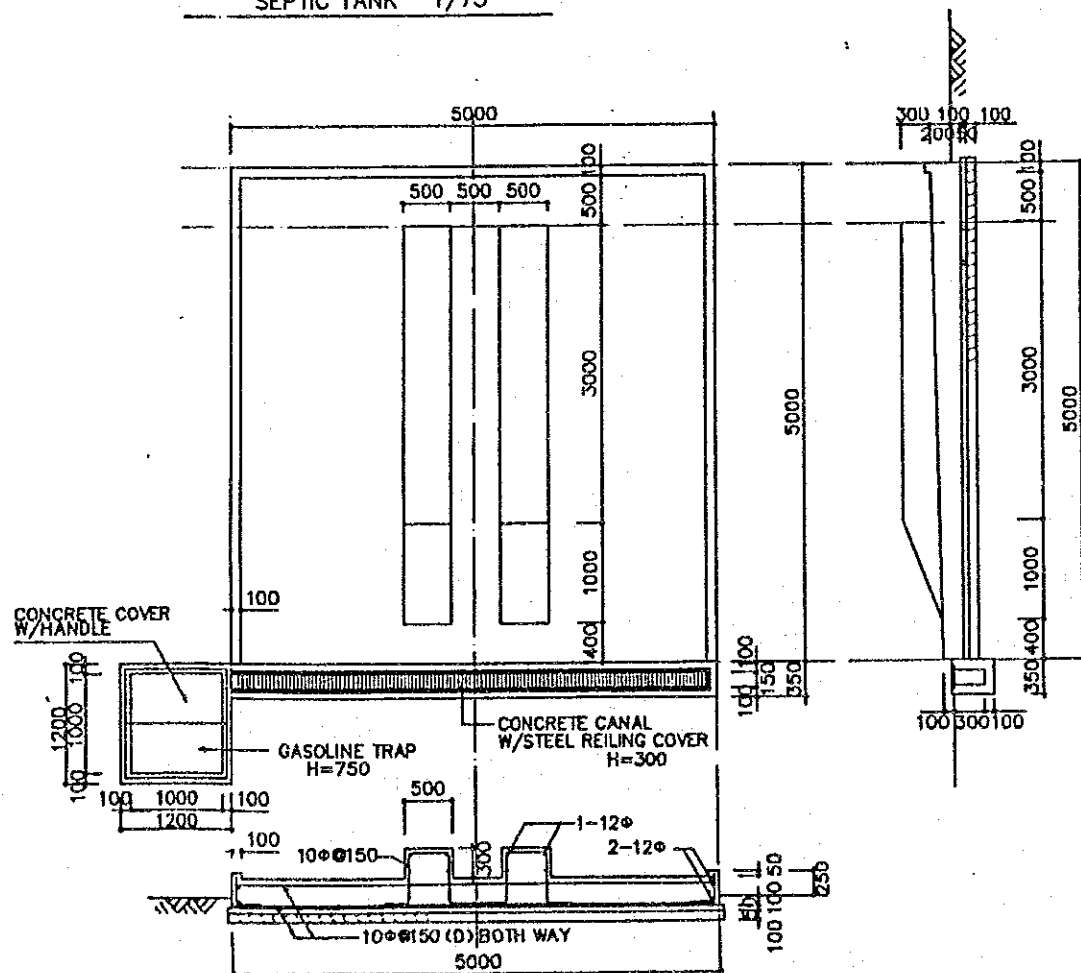

WASHING PIT 1/75

STRUCTURAL MATERIALE




- | | |
|--------------------------|---|
| (1) ROOF TRUSS MENBER | TIMBER |
| (2) CONCRETE | NORMAL CONCRETE
4WEEK STRENGHT $F_c=180\text{kg/cm}^2$ |
| (3) REINFORCING BAR | STEEL DEFORMED BAR
SUITABLE SS400 |
| (4) WALL | CHB $t=150$ (CONCRETE HOLLOW BLOCK) |
| (5) SOIL BEARING CAPCITY | $F_e=5.0\text{t/m}^2$ |

REPUBLIC OF THE PHILIPPINES BUREAU OF SOILS AND WATER MANEGEMENT	
THE PILOT INFRASTRUCTURE IMPROVEMENT WORKS SOIL RESEARCH AND DEVELOPMENT CENTER PROJECT	
STRUCTURE	
DWG.NO.	DC- 017
DATE	
JAPAN INTERNATIONAL COOPERATION AGENCY	

NO	DESCRIPTION	UNT	AREA	NO	DESCRIPTION	UNT	AREA
1	EROSION PLOT	Sq-m	about 100	15	GENERATOR HOUSE	Sq-m	30
2	EROSION PLOT			16	TOILET		45
				17	STORAGE TANK	Cu-m	25
				18	DEEP WELL (BY OTHERS)	mm	150
				19	ACCESS ROAD	Sq-m	340
				20			
				21			
				22			
9	RESERCH ROOM		75	23			
10	DRYING ROOM		75	24			
11	WAREHOUSE		75	25			
12	EXHIBITION ROOM		75	26			
13	MACHINE SHOP		150	27			
14	WASHING PIT		16	28			

SYMBOL:

- WATER SUPPLY
- DRAINAGE
- ☒^A CATCH BASIN 'A' (600 X 600)
- ☒^B -DITTO- 'B' (450 X 450)

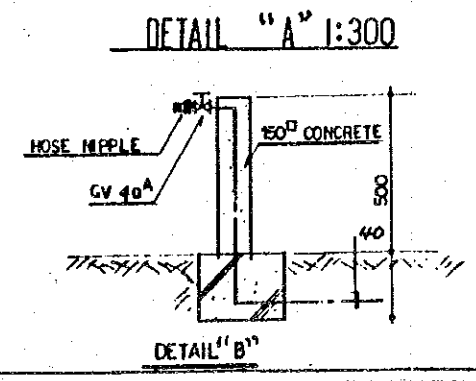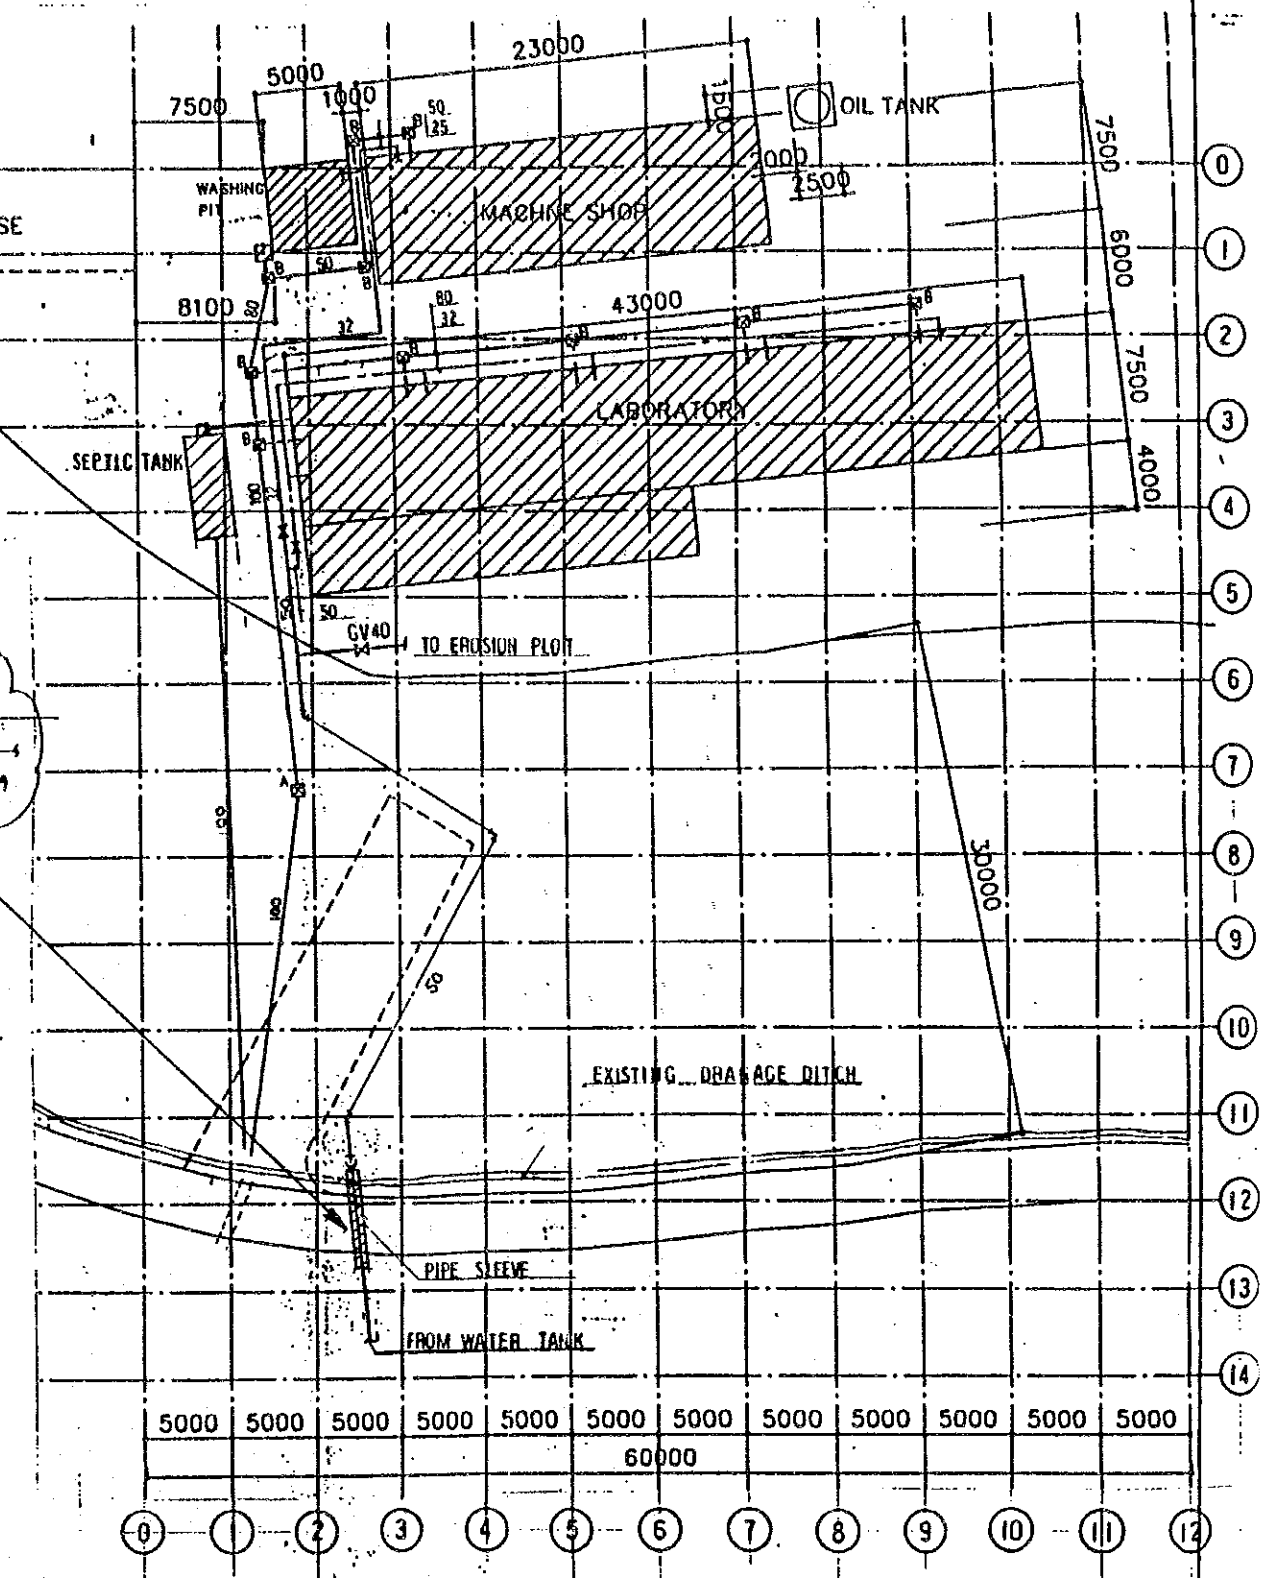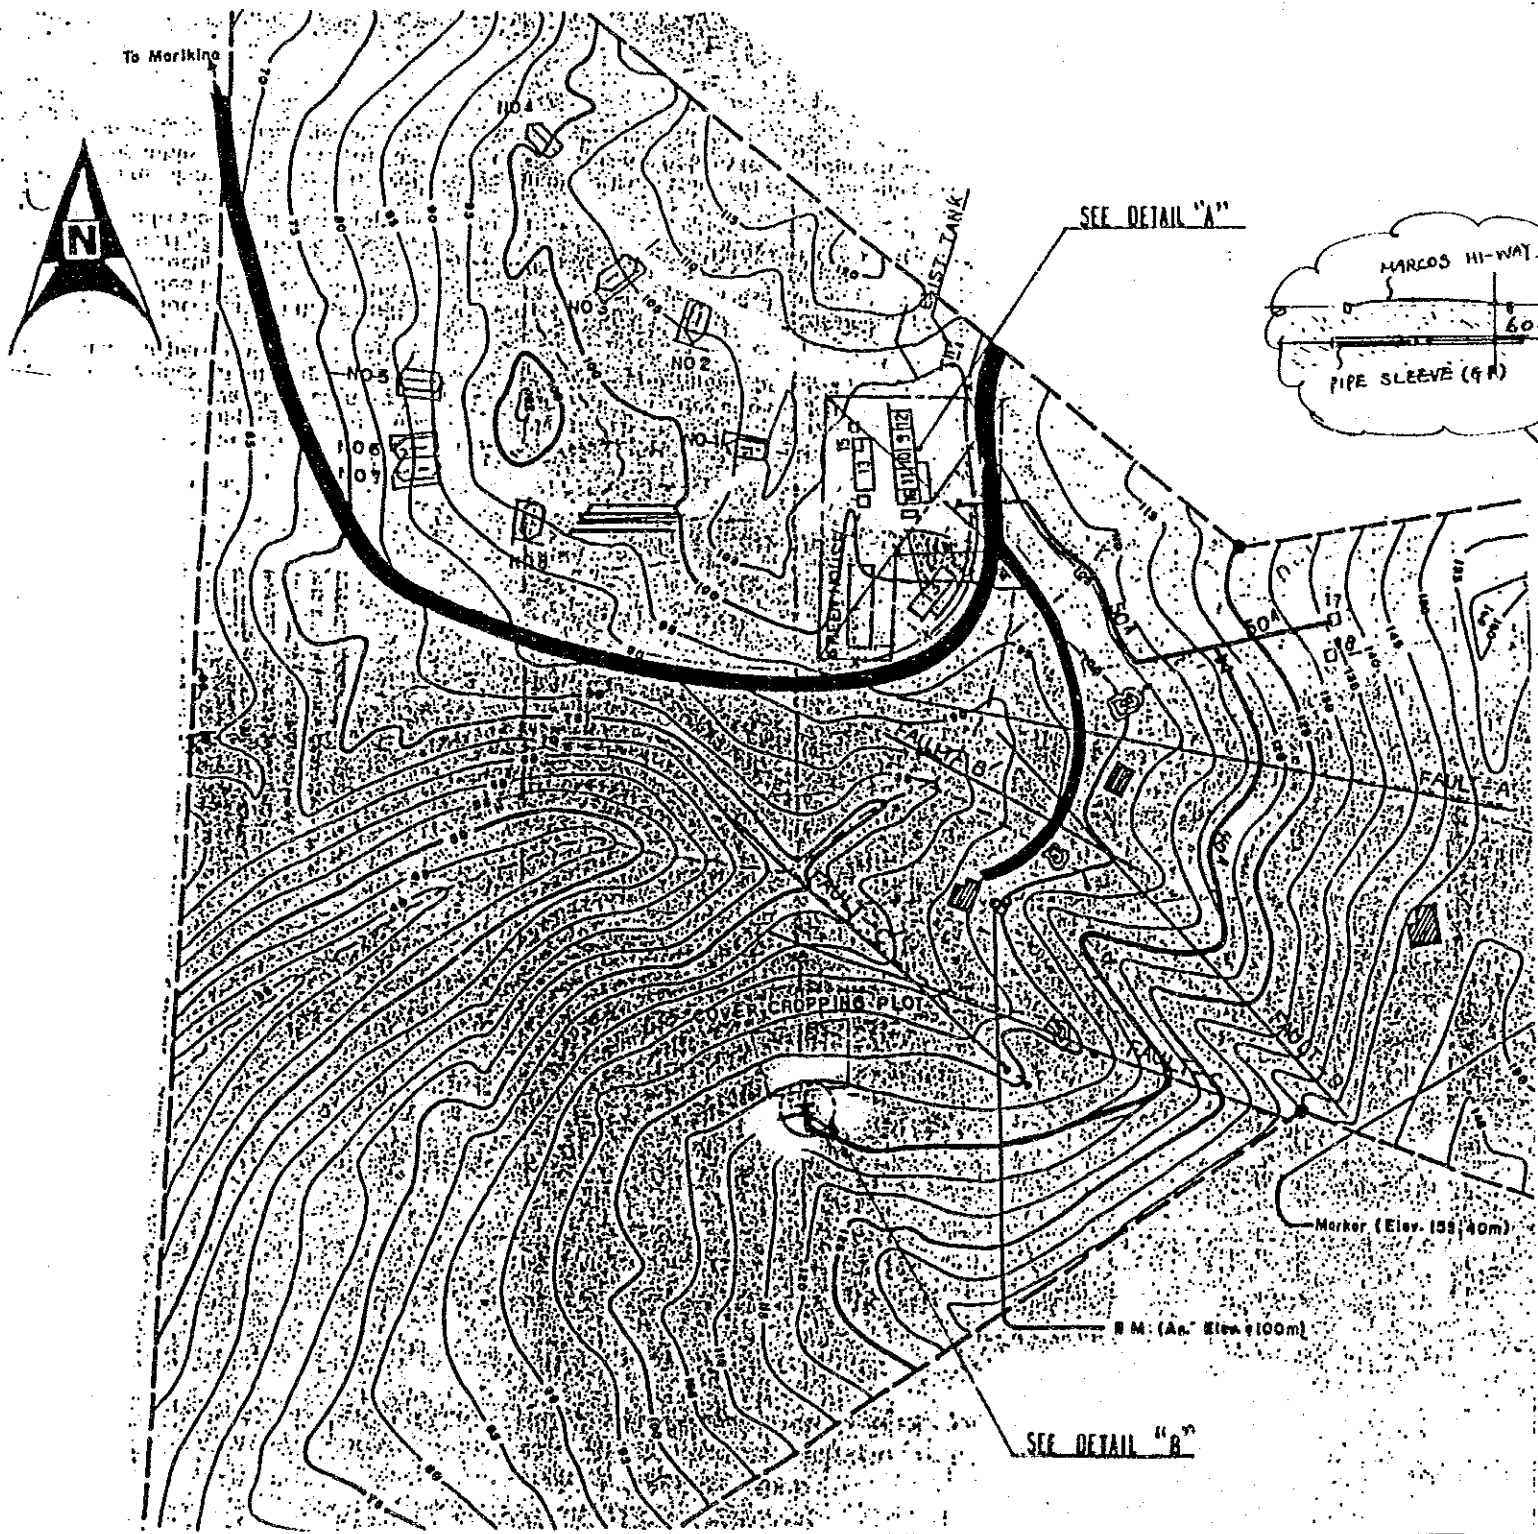


REPUBLIC OF THE PHILIPPINES
BUREAU OF SOILS AND WATER MANAGEMENT

THE PILOT INFRASTRUCTURE IMPROVEMENT WORKS
SOIL RESEARCH AND DEVELOPMENT CENTER PROJECT

SITE PLAN OF PLUMBING SYSTEM


DWG. NO. DC-018 DATE 92-9-11

JAPAN INTERNATIONAL COOPERATION AGENCY

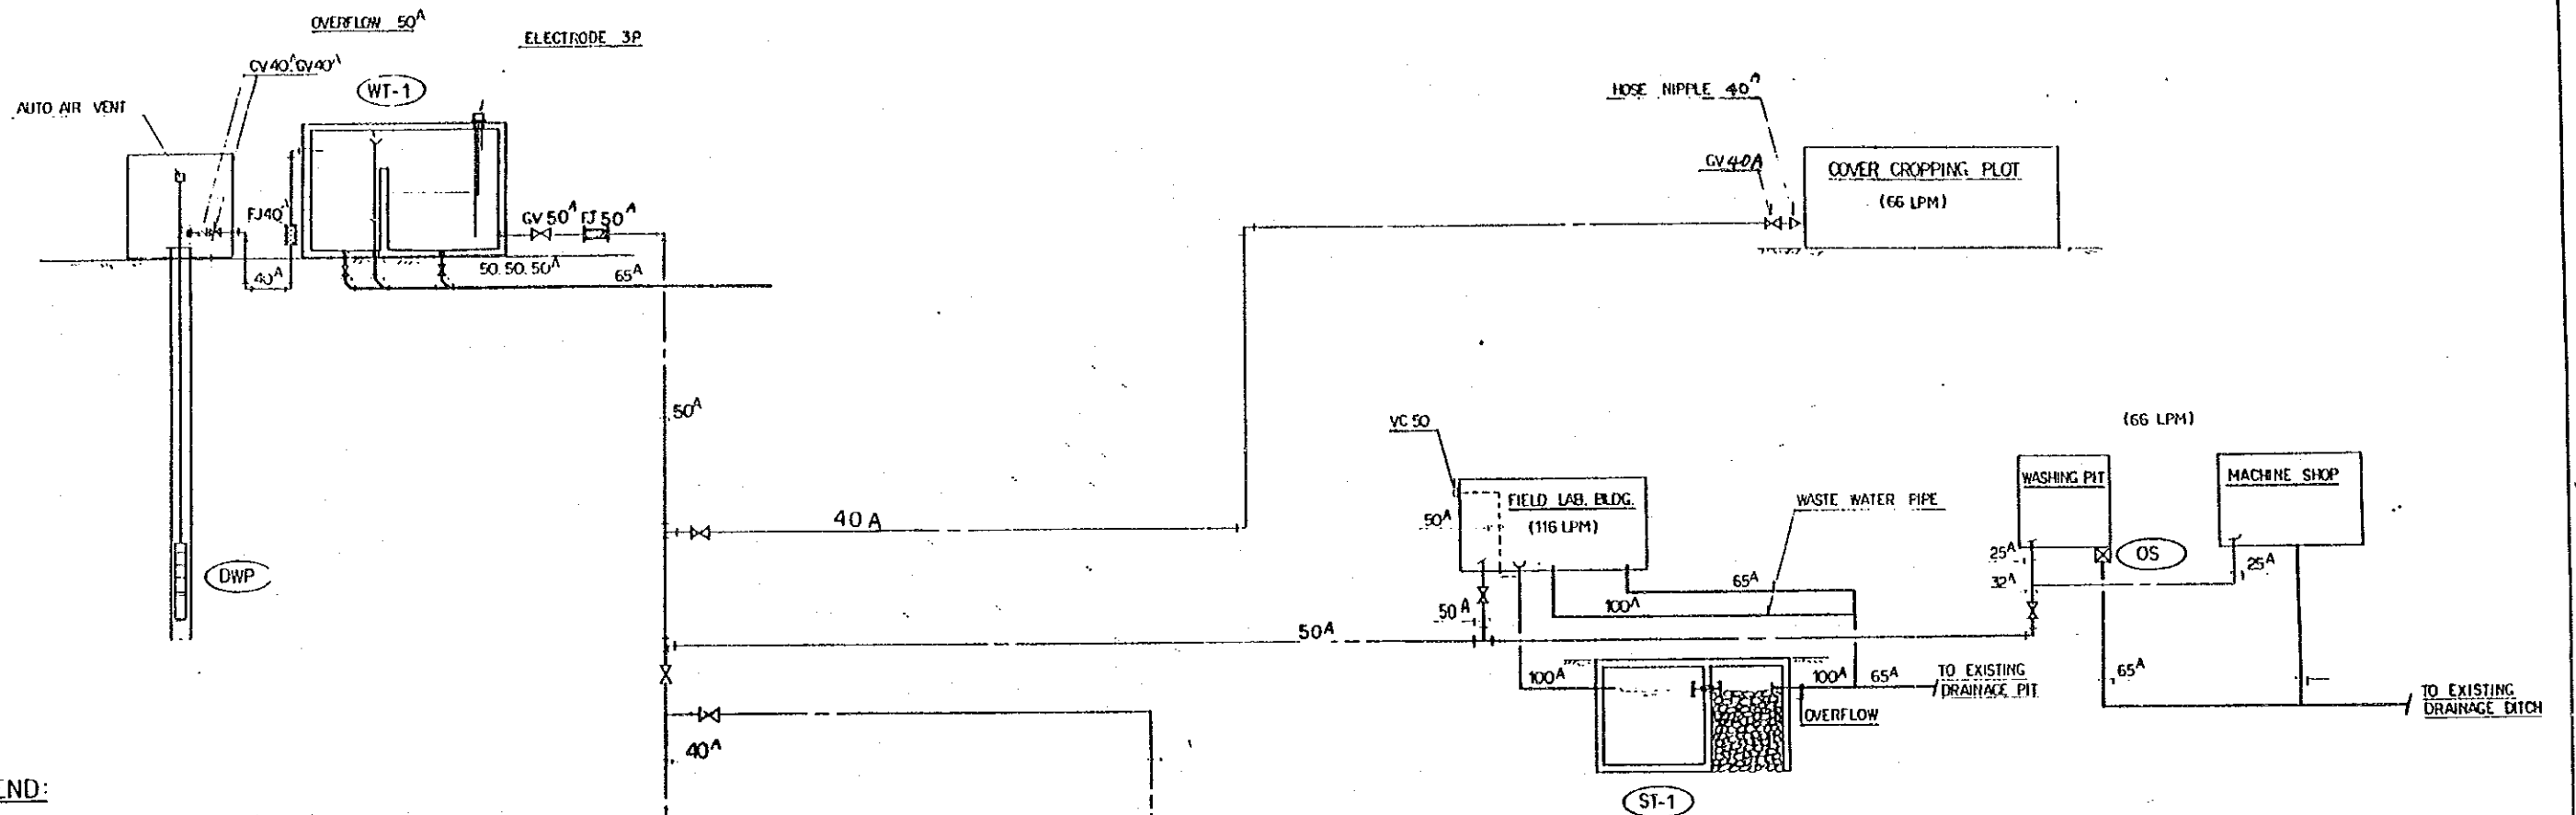

LEGEND:

SYMBOL	DESCRIPTION	SPECIFICATION	REMARKS
---	WATER SUPPLY PIPE	UPVC CLASS 150	
---	SOIL PIPE	UPVC S1000	
---	WASTE WATER PIPE	- DITTO -	
---	VENT PIPE	- DITTO -	
⌘	GATE VALVE	JIS 5K SCREW TYPE	
⌘	CHECK VALVE	- DITTO -	
⌘	FLEXIBLE JOINT	SUS JIS5K	
WT-1	WATER TANK	EFFECTIVE CAP: 36 M ³ W/ SEPARATOR	
ST-1	SEPTIC TANK	FOR 30 PERSONS	
OS	OIL SEPARATOR	CONCRETE MADE	
DWP	DEEPWELL PUMP	3.7 KW	PUMP HEAD TO BE CONFIRMED

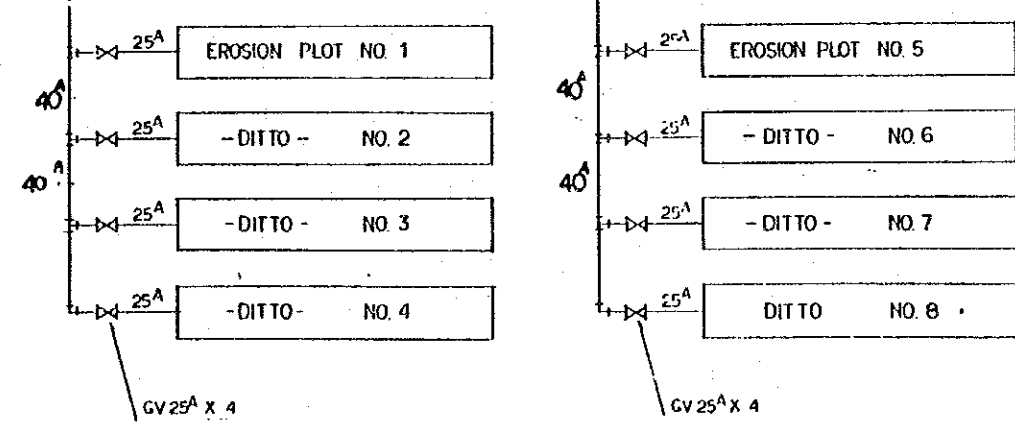




REPUBLIC OF THE PHILIPPINES
BUREAU OF SOILS AND WATER MANAGEMENT

THE PILOT INFRASTRUCTURE IMPROVEMENT WORKS
SOIL RESEARCH AND DEVELOPMENT CENTER PROJECT

FLOW DIAGRAM OF PLUMBING
SYSTEM


DWG. NO.	BC- 019	DATE	92 - 9 - 11
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JAPAN INTERNATIONAL COOPERATION AGENCY

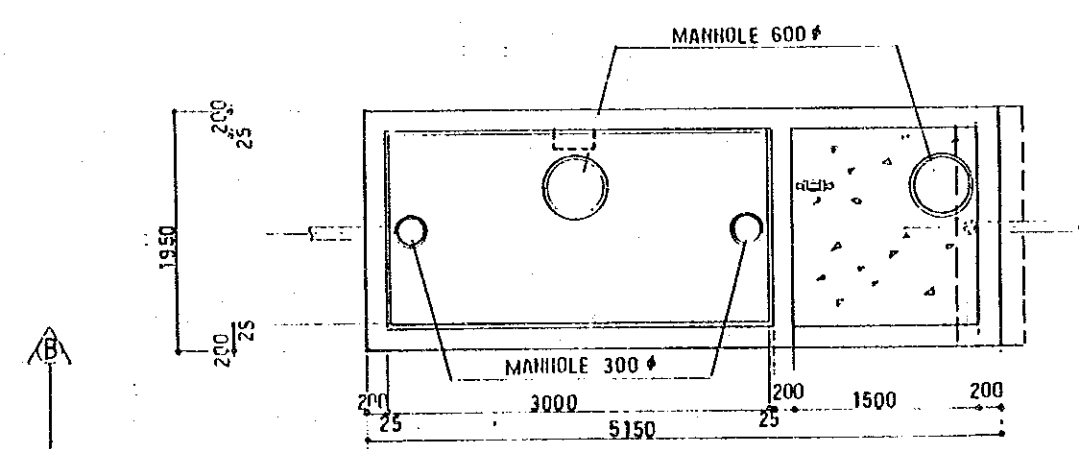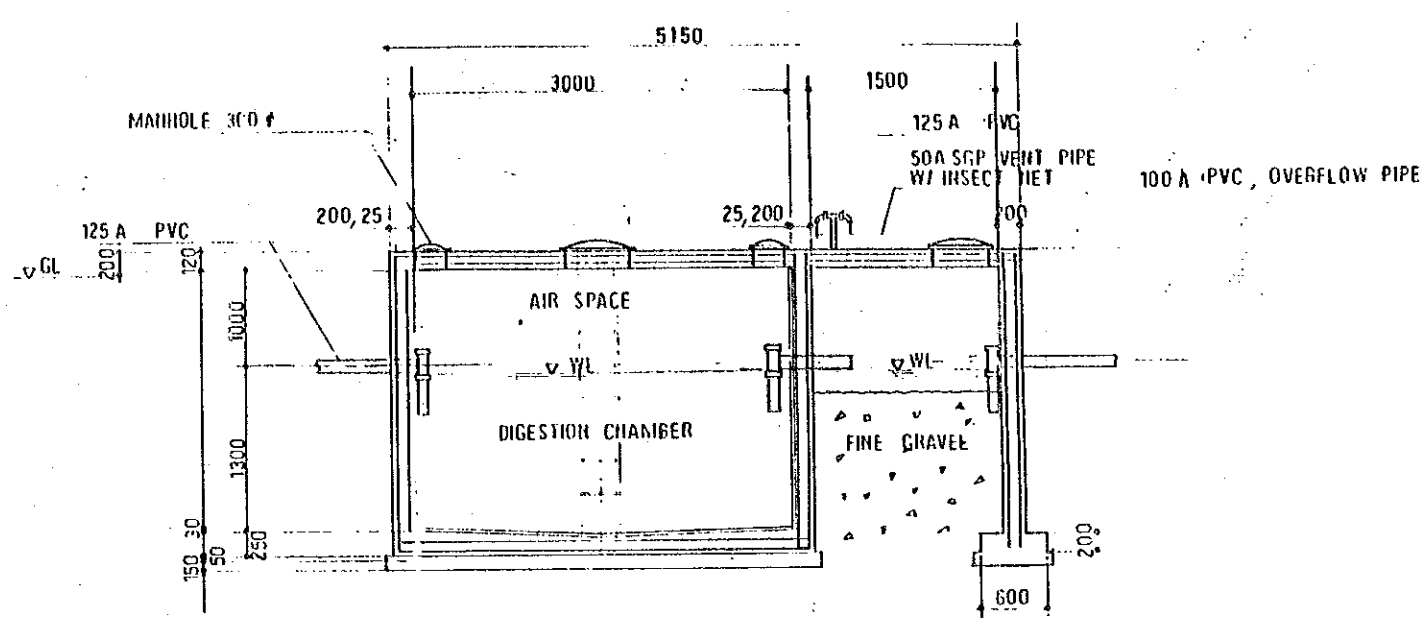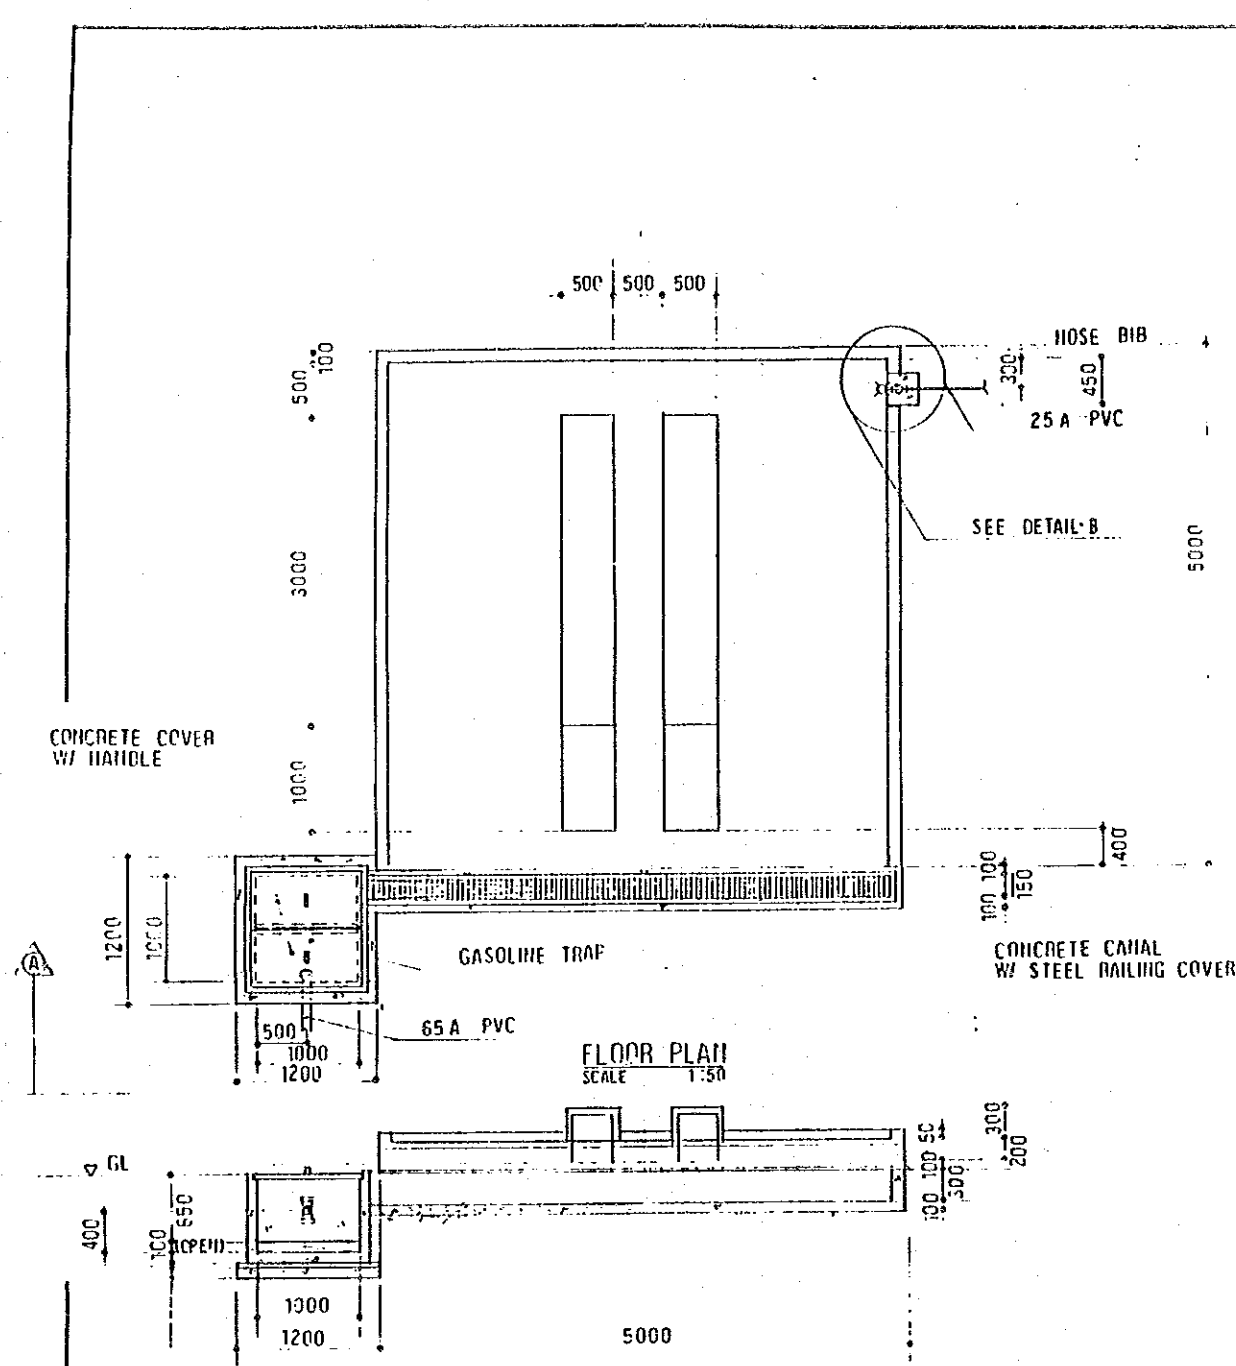


SEPTIC TANK (30 PERSON)
SCALE 1:50


REPUBLIC OF THE PHILIPPINES BUREAU OF SOILS AND WATER MANAGEMENT		
THE PILOT INFRASTRUCTURE IMPROVEMENT WORKS SOIL RESEARCH AND DEVELOPMENT CENTER PROJECT		
PIPING DETAIL FOR SEPTIC TANK AND WASHING PIT		
DWG. NO.	DC- 021	DATE
JAPAN INTERNATIONAL COOPERATION AGENCY		

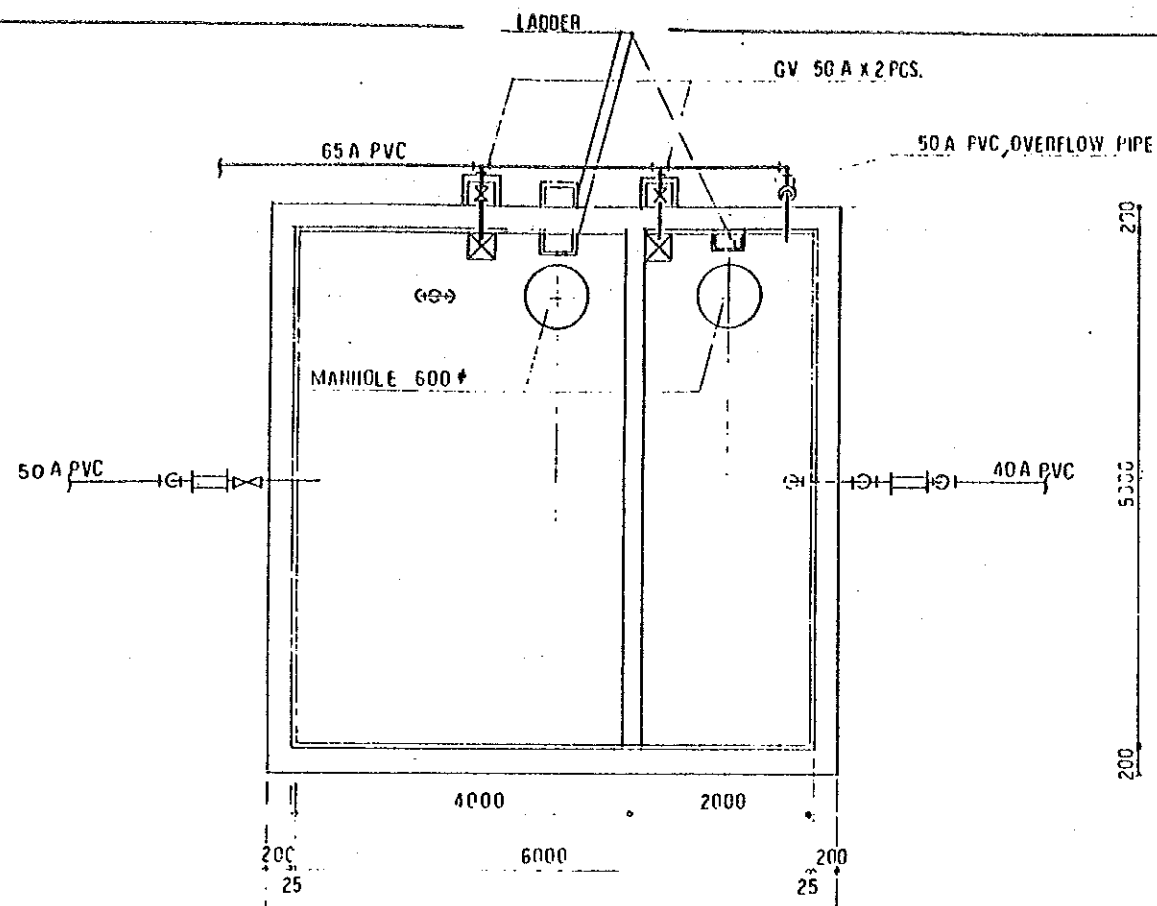

PLAN
NOT TO SCALE

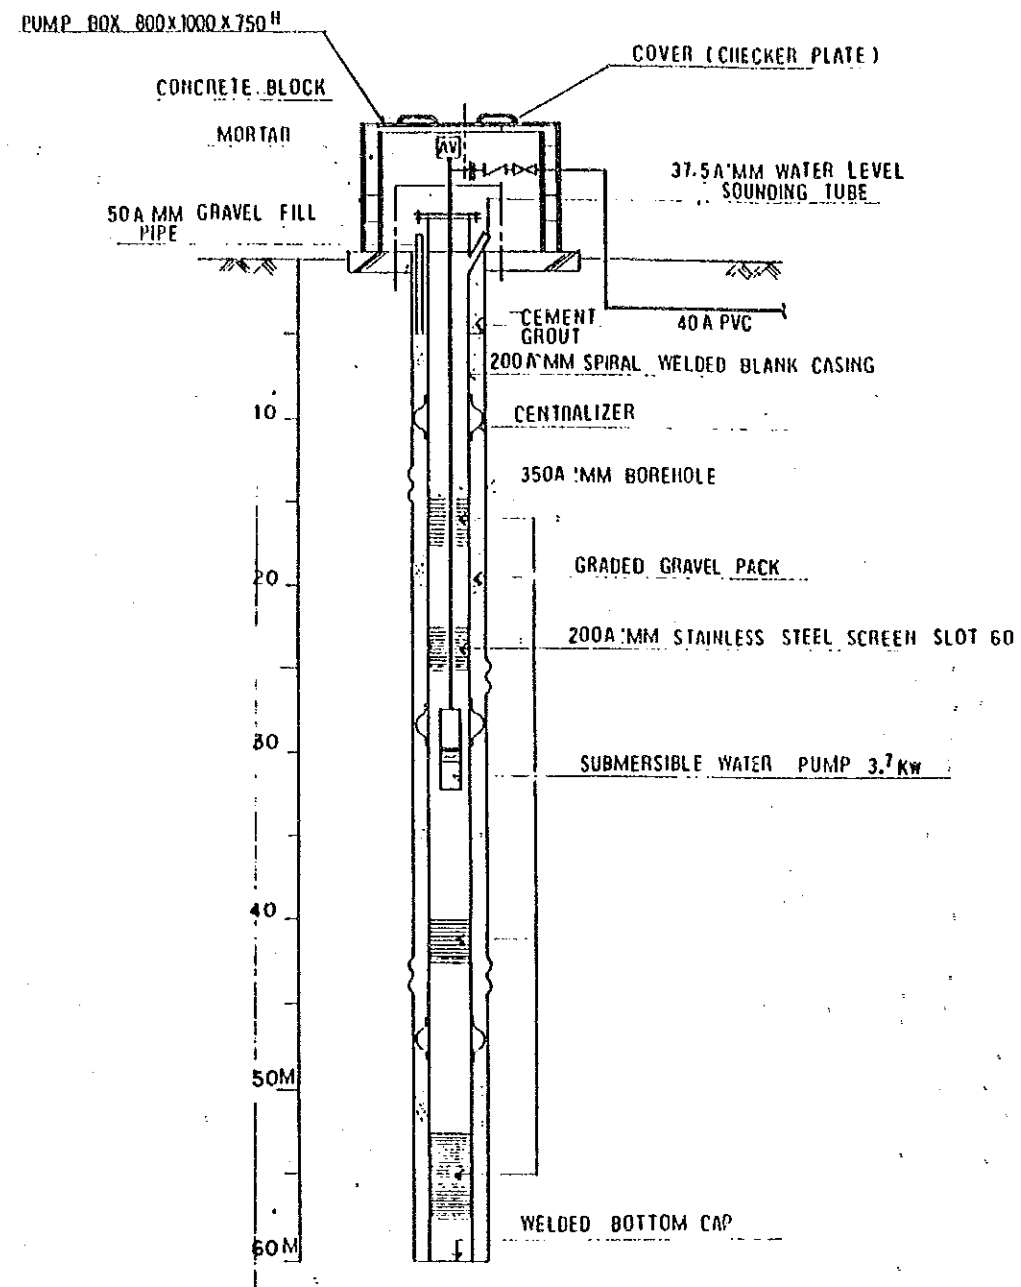

DETAIL FOR DEEPWELL
NOT TO SCALE


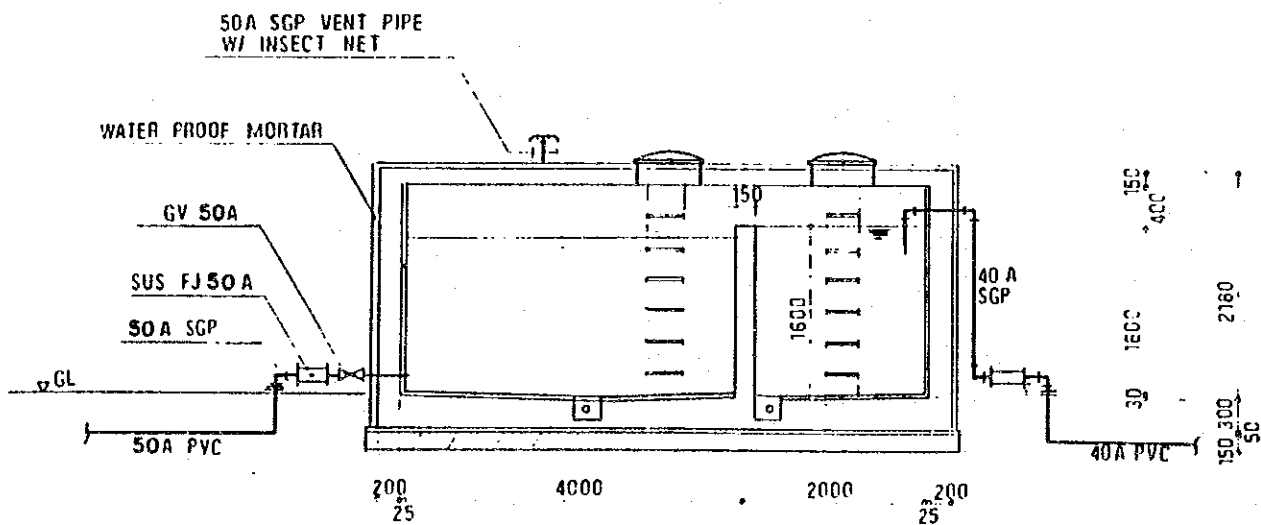


SECTION
NOT TO SCALE

WATER STORAGE TANK
NOT TO SCALE




REPUBLIC OF THE PHILIPPINES BUREAU OF SOILS AND WATER MANAGEMENT			
THE PILOT INFRASTRUCTURE IMPROVEMENT WORKS SOIL RESEARCH AND DEVELOPMENT CENTER PROJECT			
PIPING DETAIL FOR WATER STORAGE AND DEEPWELL			
DWG. NO.	DC-022	DATE	
JAPAN INTERNATIONAL COOPERATION AGENCY			

NO	DESCRIPTION	UNT.	AREA	NO	DESCRIPTION	UNT.	AREA
1	EROSION PLOT	SQ.m	about 100	15	GENERATOR HOUSE	SQ.m	30
2	EROSION PLOT			16	TOILET		45
3				17	STORAGE TANK	CU.m	25
4				18	DEEP WELL	mm	φ 150
5				19	ACCESS ROAD	SQ.m	340
6				20			
7				21			
8				22			
9	RESEARCH ROOM		75	23			
10	DRYING ROOM		75	24			
11	WAREHOUSE		75	25			
12	EXHIBITION ROOM		75	26			
13	MACHINE SHOP		150	27			
14	WASHING PIT		76	28			

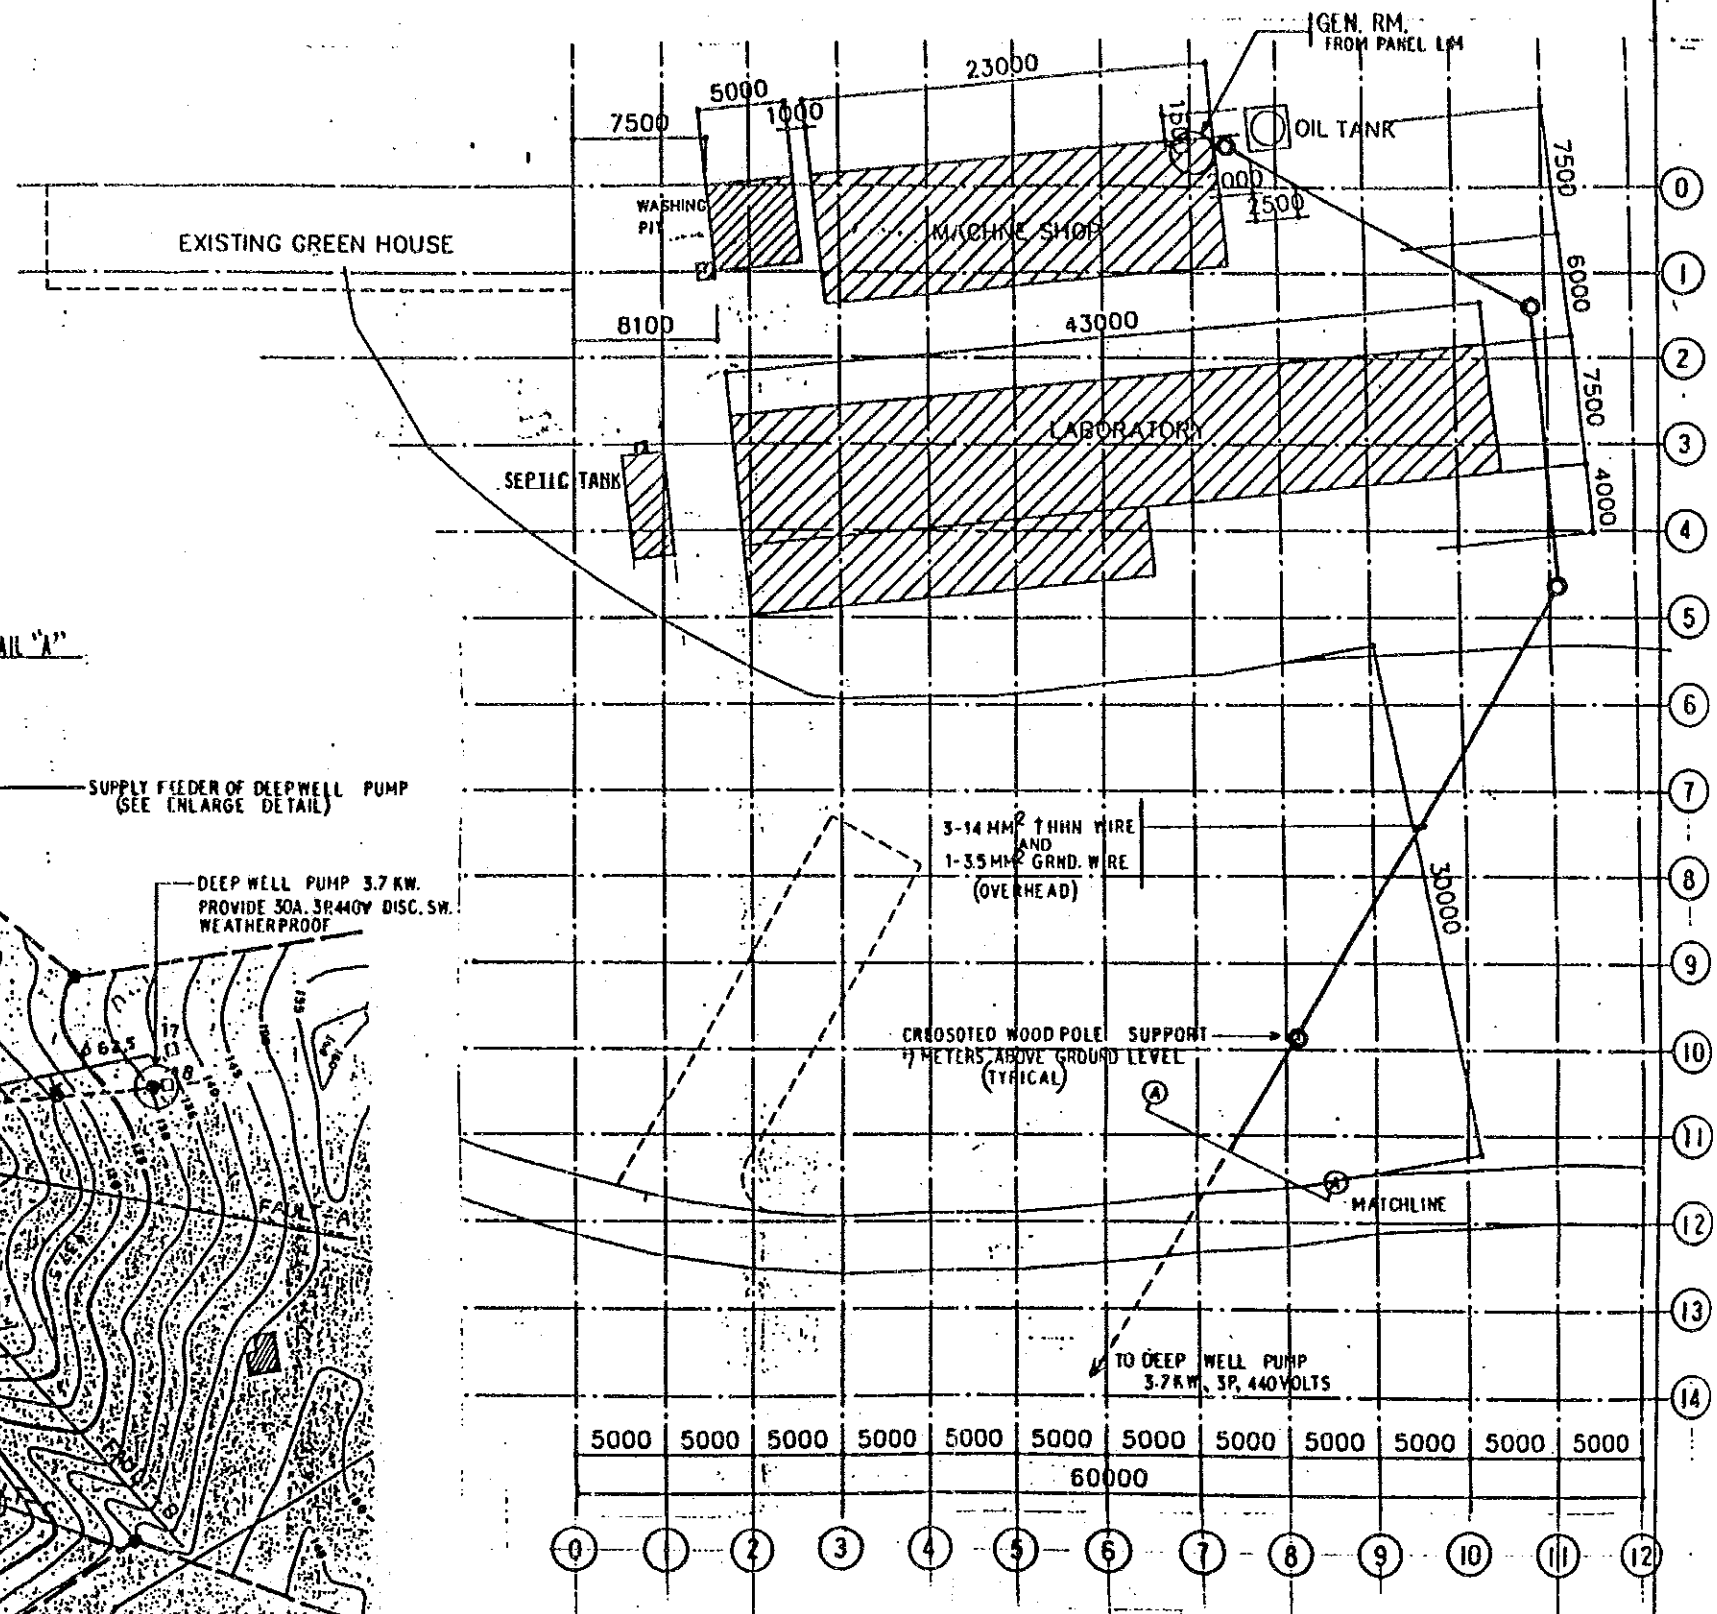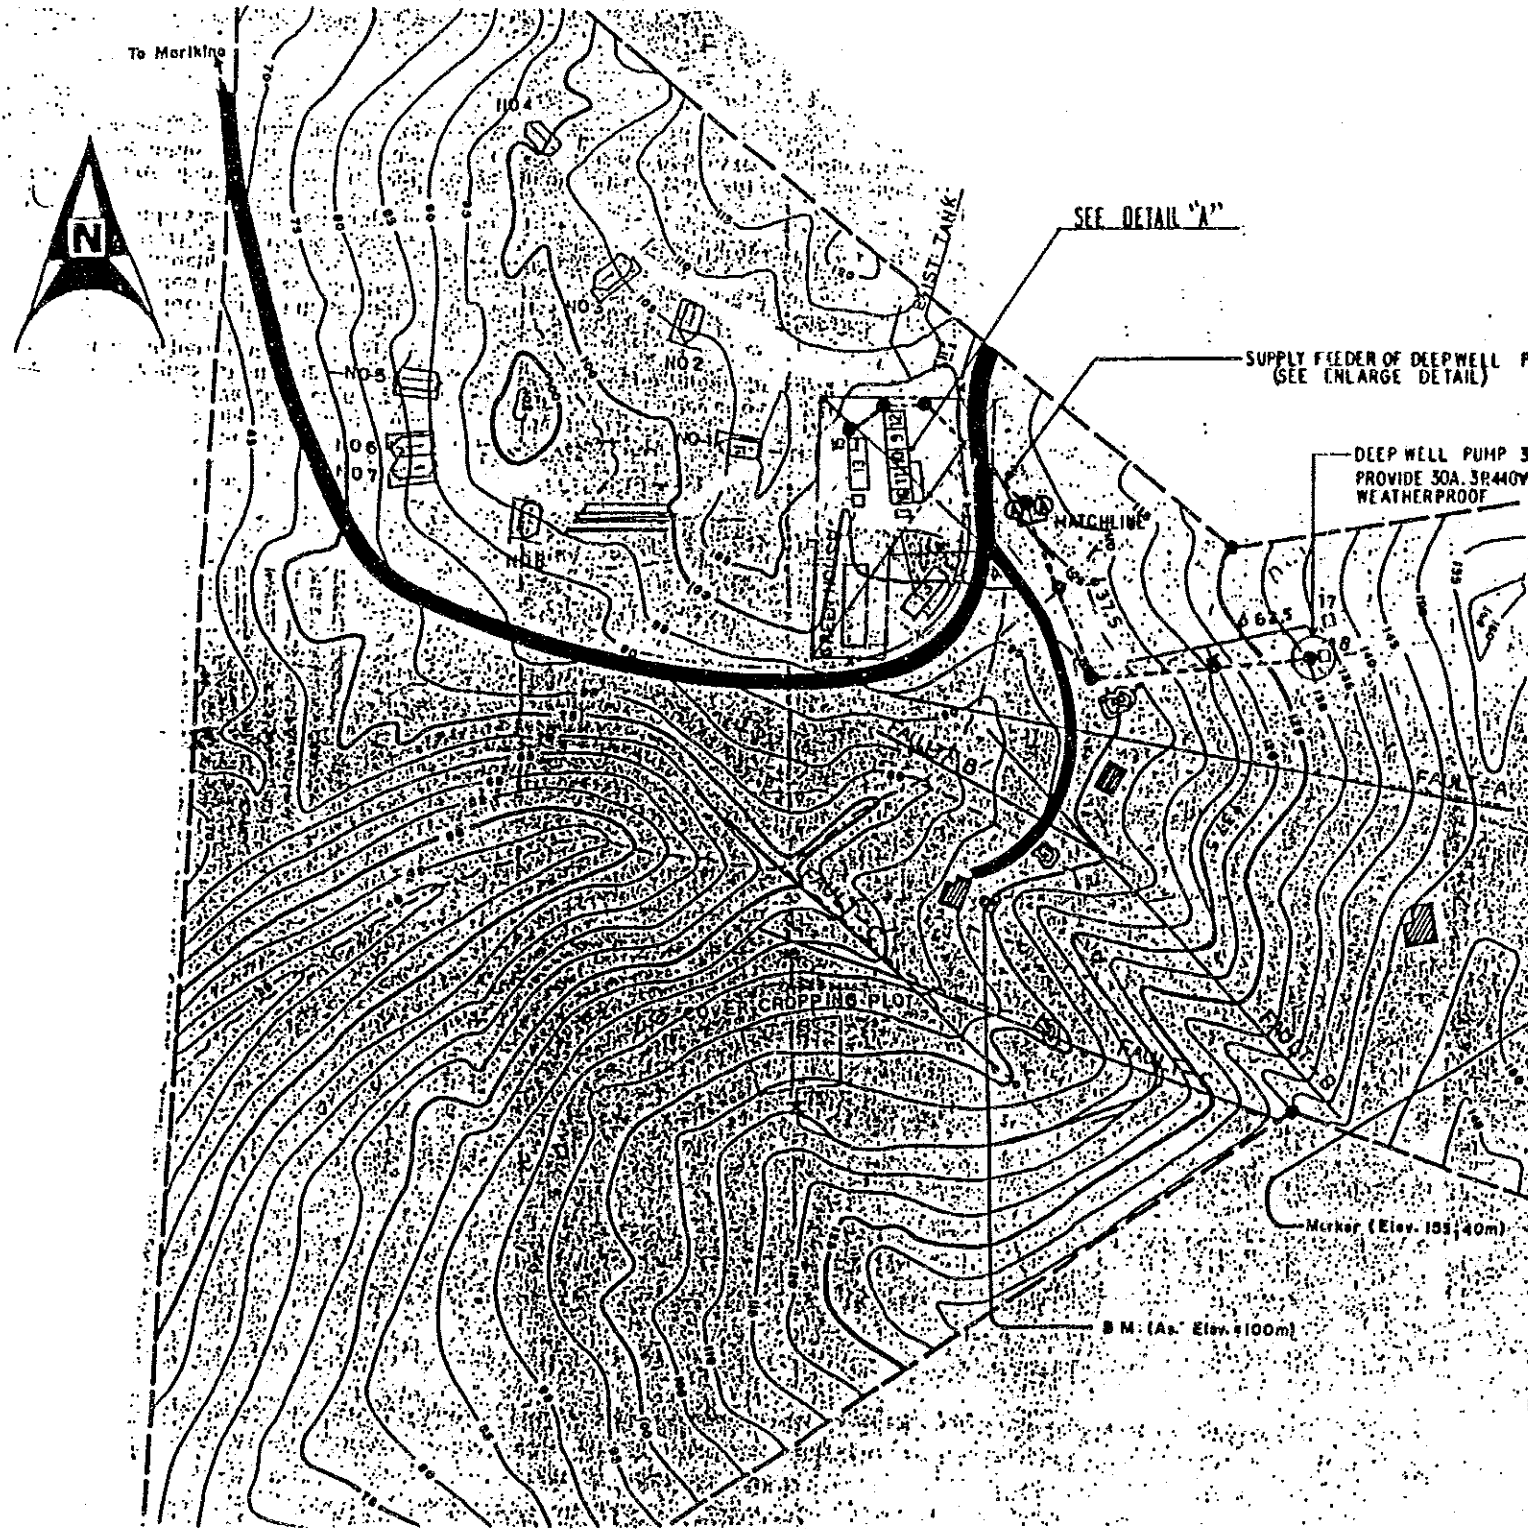

DETAIL "A" 1:300


REPUBLIC OF THE PHILIPPINES			
BUREAU OF SOILS AND WATER MANAGEMENT			
THE PILOT INFRASTRUCTURE IMPROVEMENT WORKS			
SOIL RESEARCH AND DEVELOPMENT CENTER PROJECT			
SITE DEVELOPMENT PLAN			
DWG. NO.	DC-023	DATE	9-11-92
JAPAN INTERNATIONAL COOPERATION AGENCY			

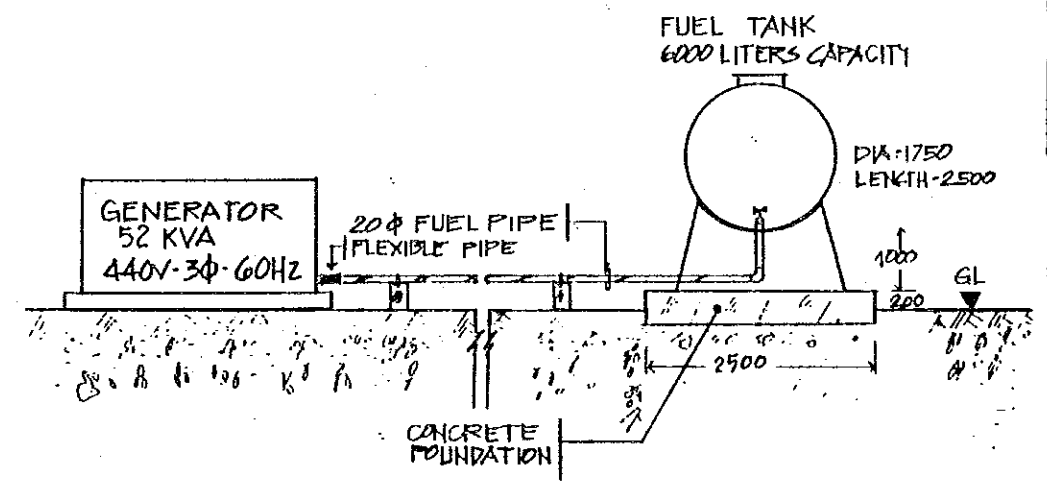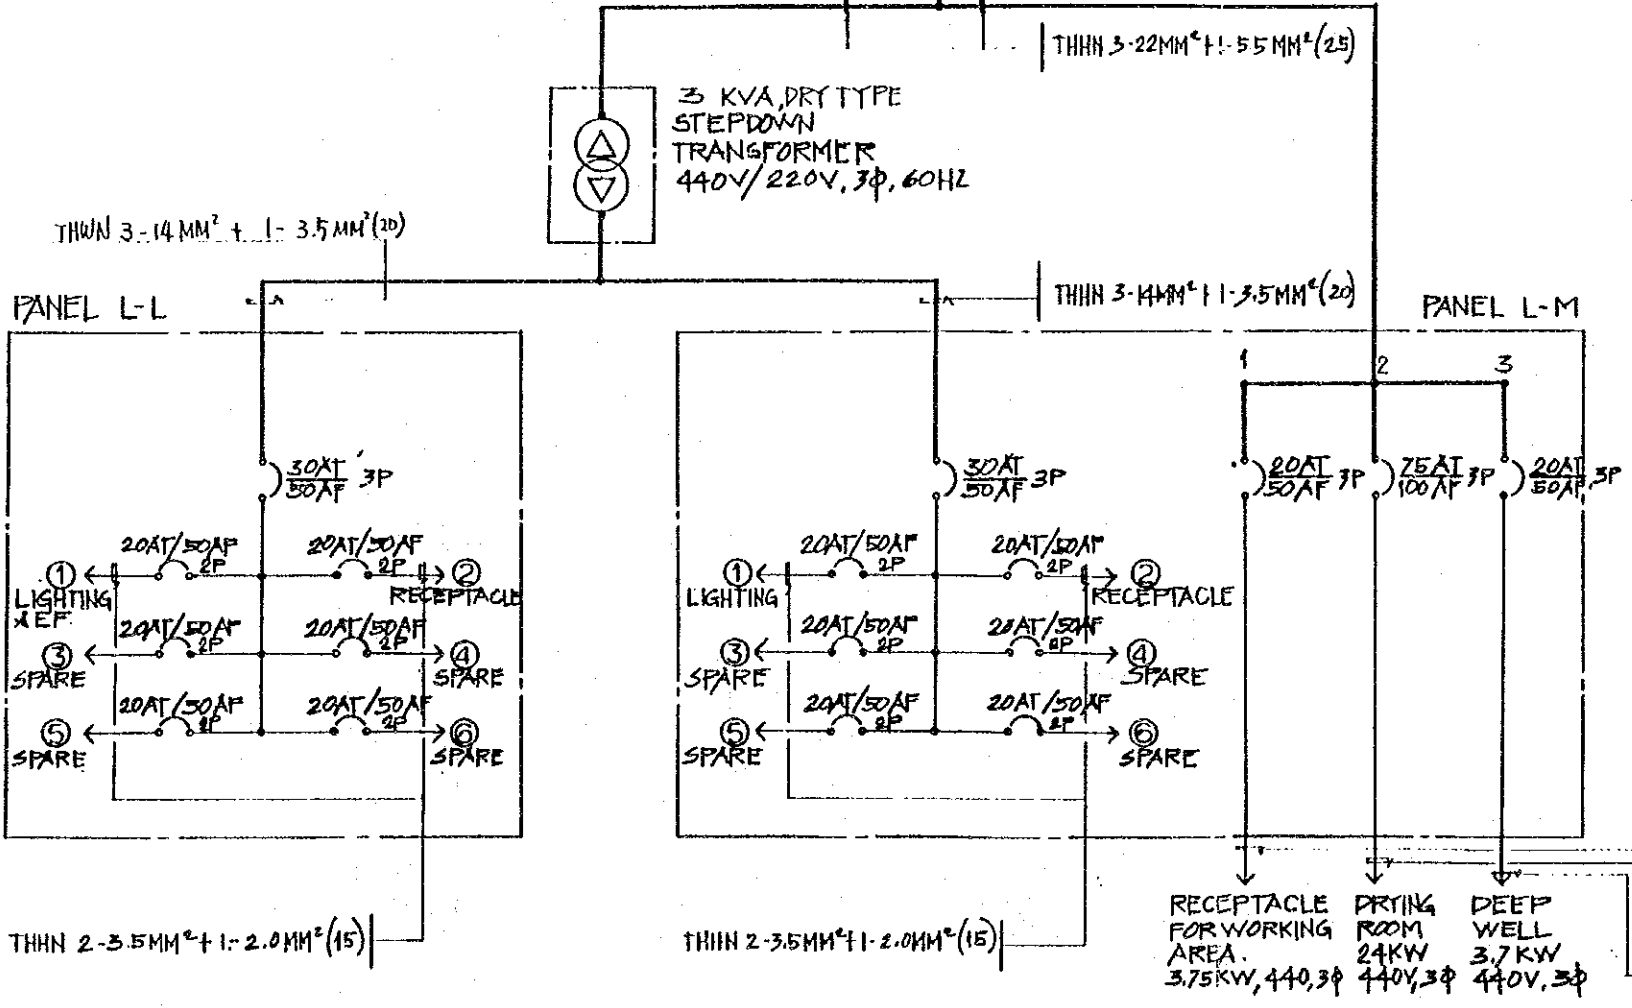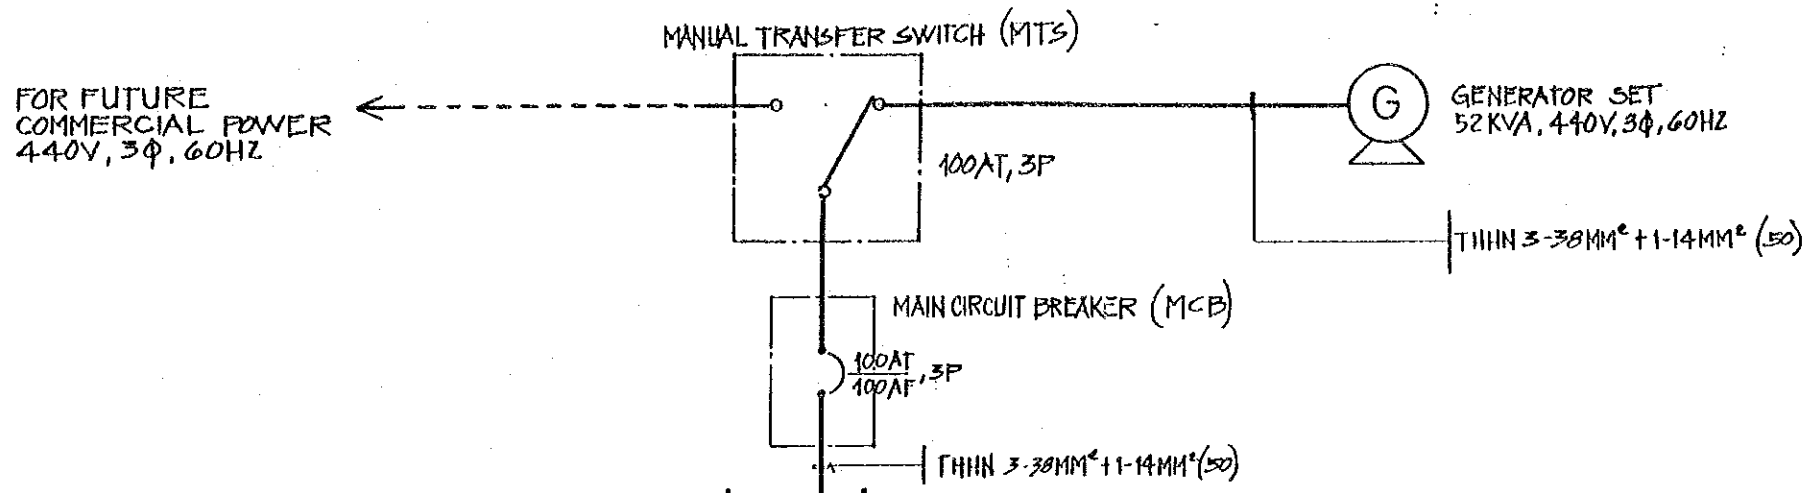


○ GENERATOR SET SCHEMATIC DIAGRAM
SCALE: NONE

○ SINGLE LINE RISER DIAGRAM
SCALE: NONE

REPUBLIC OF THE PHILIPPINES BUREAU OF SOILS AND WATER MANAGEMENT			
THE PILOT INFRASTRUCTURE IMPROVEMENT WORKS SQL RESEARCH AND DEVELOPMENT CENTER PROJECT			
SINGLE LINE RISER DIAGRAM AND GENERATOR SET SCHEMATIC DIAGRAM			
DWG. NO. E-01	DC-024	DATE	9-11-92
JAPAN INTERNATIONAL COOPERATION AGENCY			

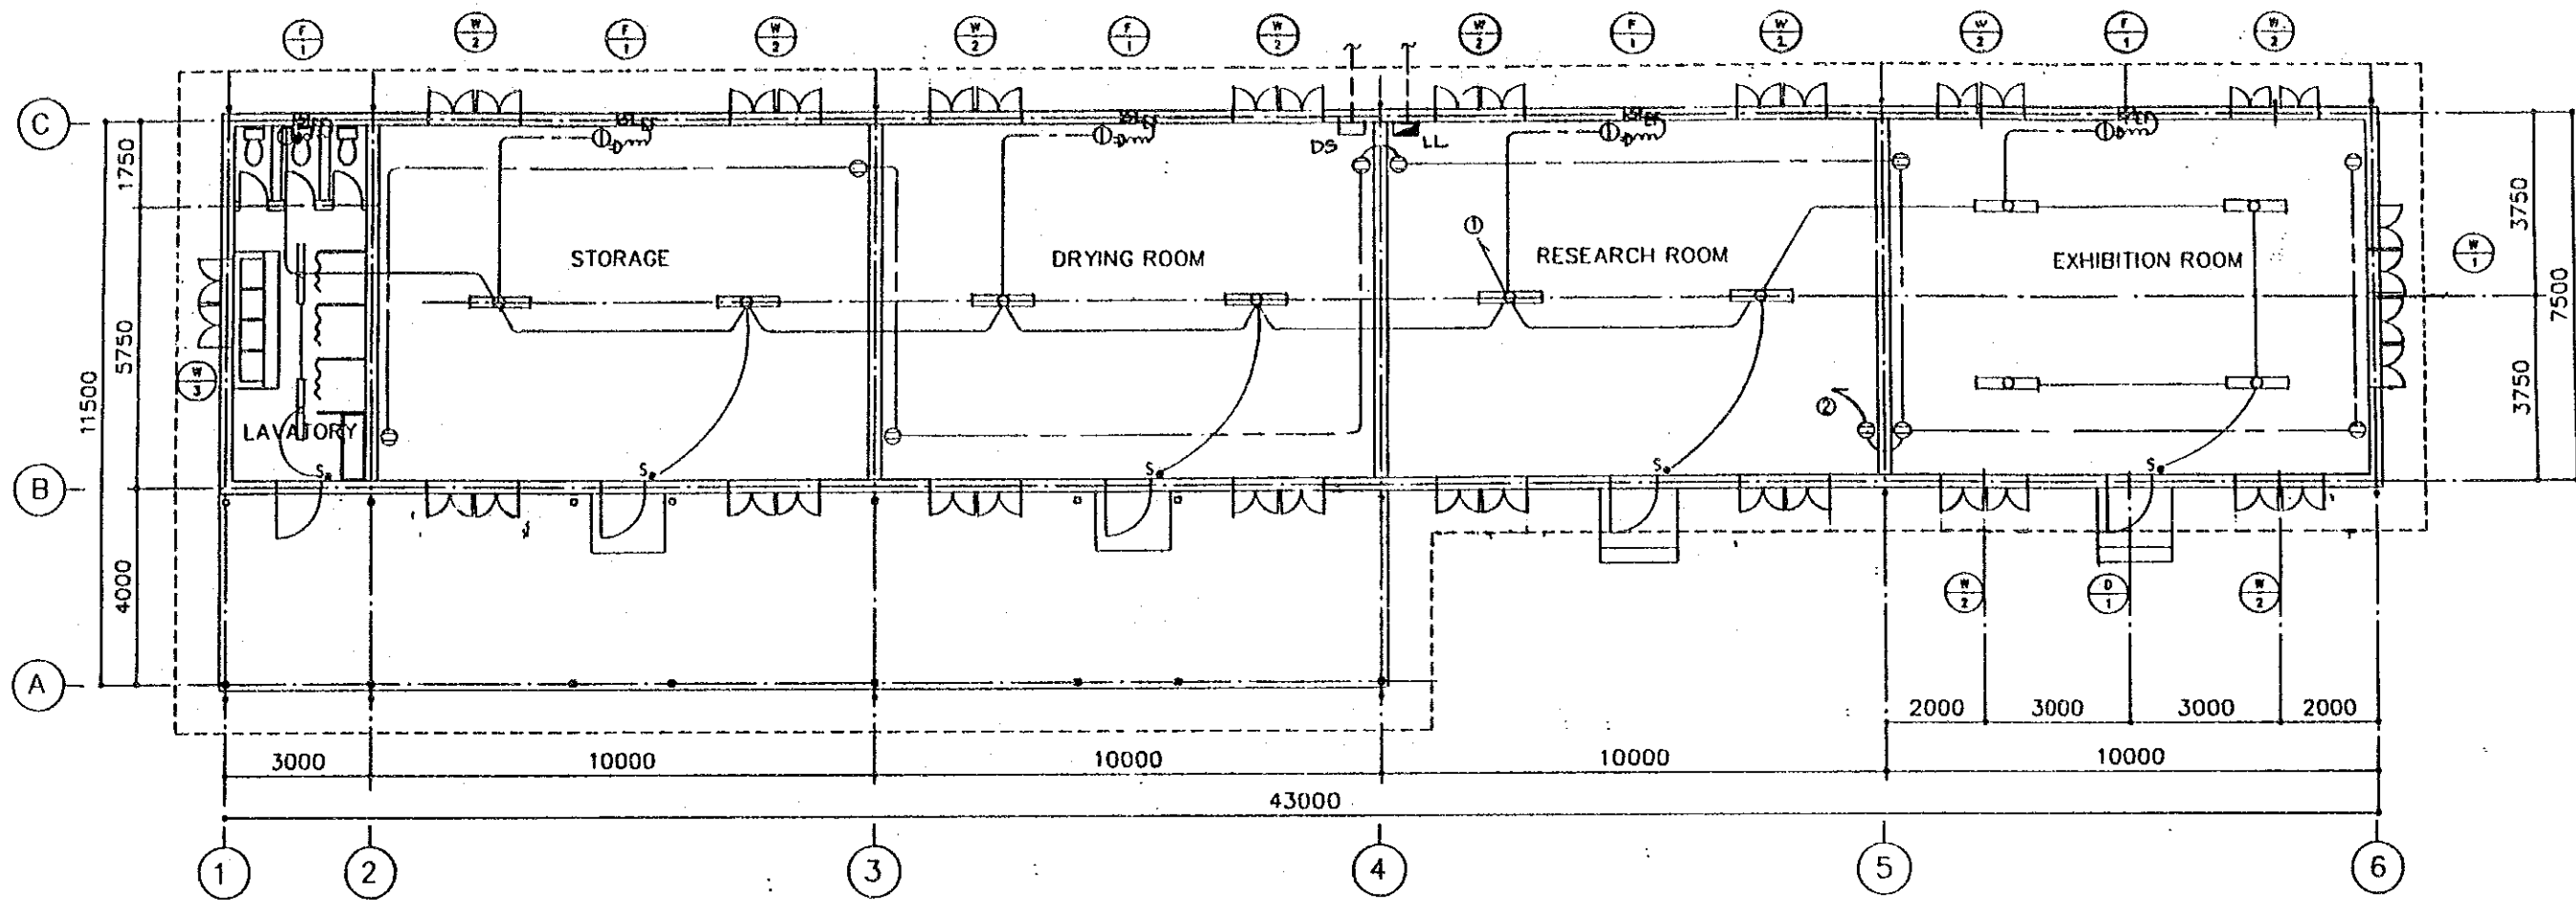

LABORATORY 1/100

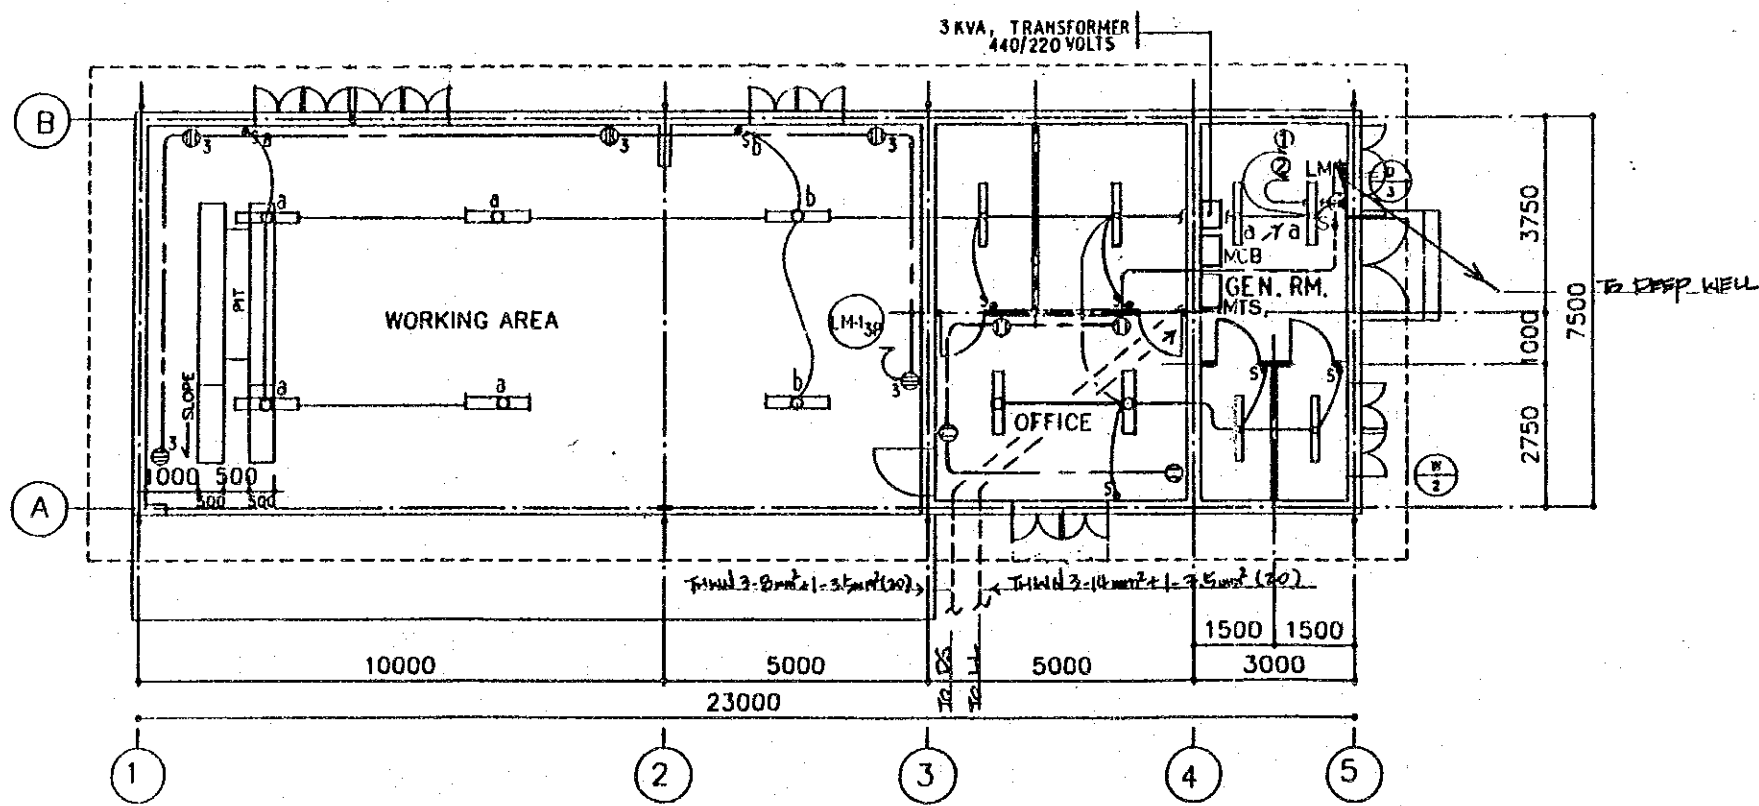

MACHINE SHOP 1/100

LEGEND:

- LIGHTING/POWER PANELBOARD
- DISCONNECT SWITCH
- MANUAL TRANSFER SWITCH
- 2-40W FL. SURFACE MTD. BOX TYPE
- 1-40W FL. SURFACE MTD. BOX TYPE
- THREE PHASE C. O.
- DUPLEX C. O.
- SINGLE C. O.
- CONDUIT RUN CONCEALED IN CEILING OR DOUBLE WALL PARTITION
- CONDUIT RUN EMBEDDED IN SLAB OR CHB WALL
- CKT. HOMERUN TO PANELBOARD. SUBSCRIPT DEMOTES CKT. NO.
- SWITCH
- EXHAUST FAN WALL MTD. (MECHANICAL WORKS)

REPUBLIC OF THE PHILIPPINES BUREAU OF SOILS AND WATER MANAGEMENT			
THE PILOT INFRASTRUCTURE IMPROVEMENT WORKS SOIL RESEARCH AND DEVELOPMENT CENTER PROJECT			
LIGHTING AND POWER LAY-OUT			
DWG. NO. 02	DC- 025	DATE	9-11-92
JAPAN INTERNATIONAL COOPERATION AGENCY			

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