


OVER BRIDGES

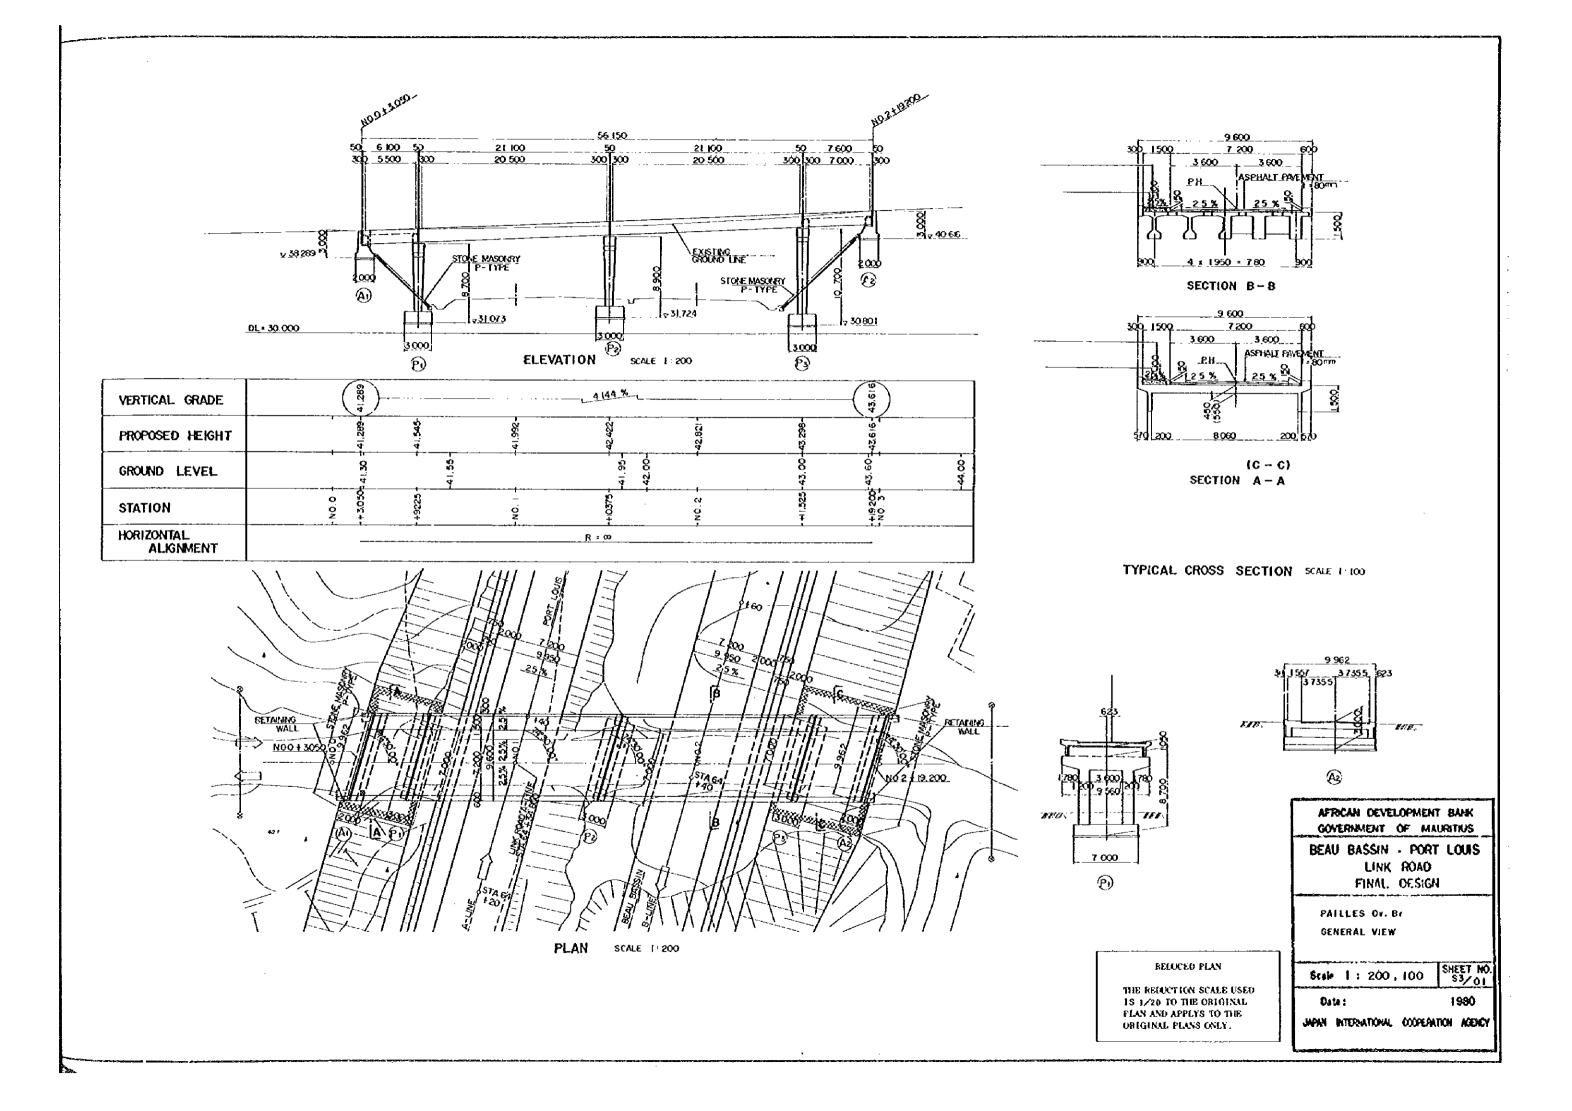


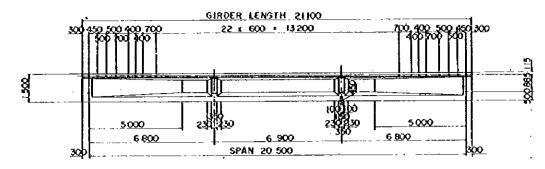


SIDE ELEVATION SCALE 1:100

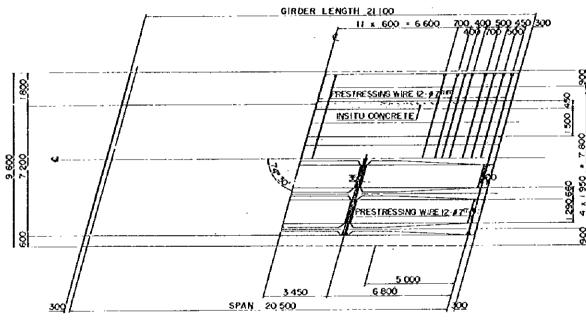

PLAN SCALE 1:100

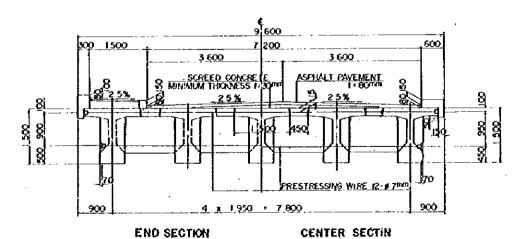

. CROSS SECTION SCALE 1:50

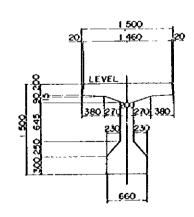

GIRDER SECTION SCALE 1:30

REDUCED PLAN

THE RELUCTION SCALE USED IS 1/20 TO THE ORIGINAL PLAN AND APPLYS TO THE ORIGINAL PLANS ONLY.

AFRICAN DEVELOPMENT BANK GOVERNMENT OF MAURITIUS

BEAU BASSIN - PORT LOUIS LINK ROAD FINAL DESIGN

PAILLES OV. Br.


PC T - GIRDER
GIRDER AND CROSSBEAM DIMENSIONS


\$cols 1: 100, 50,30 | size 1 NO. 52 / 62

Date:


1980

JAPAN INTERNATIONAL COOPERATION AGENCY

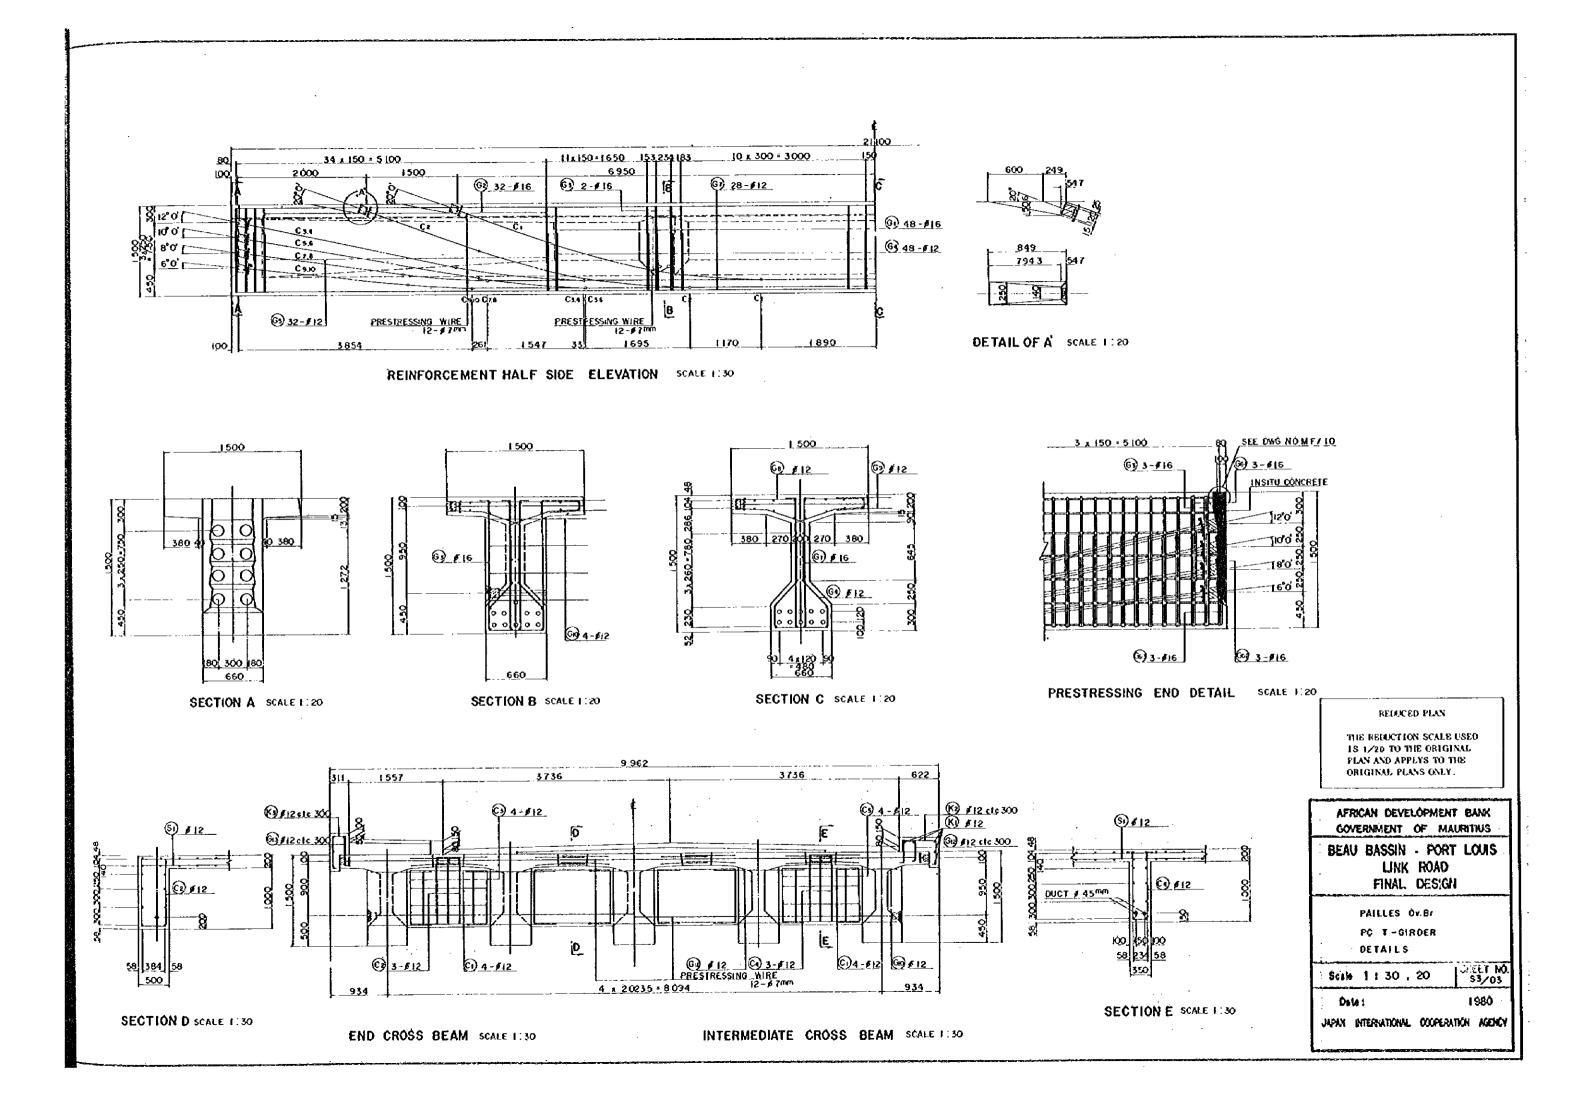

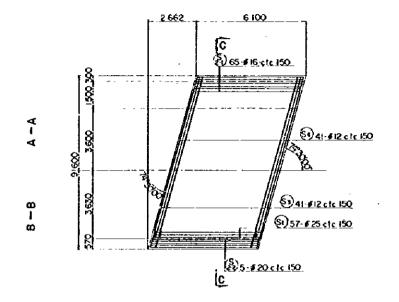


PLAN SCALE 1, 100

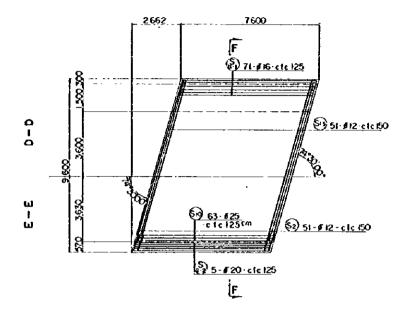



PLAN SCALE 1:100

LINK ROAD FREE CESSES

SHEET NO. \$3/04

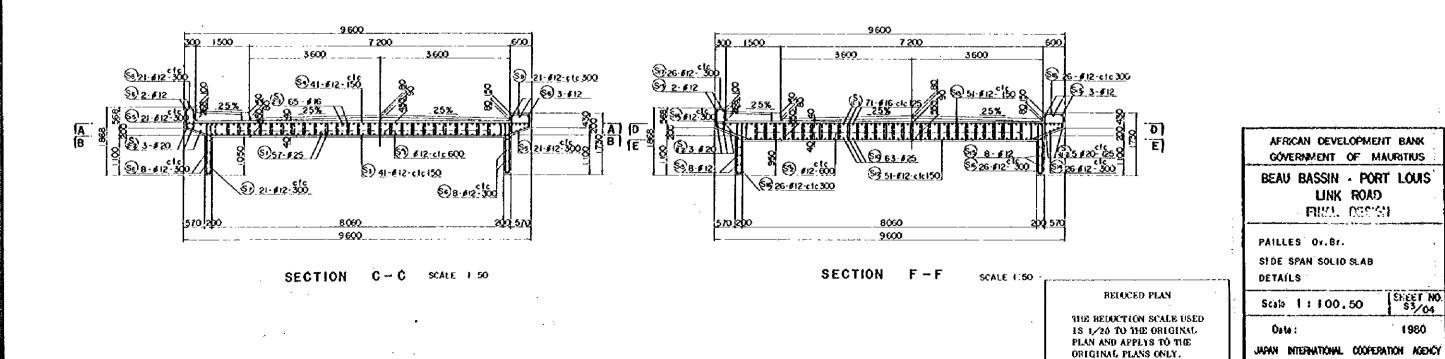

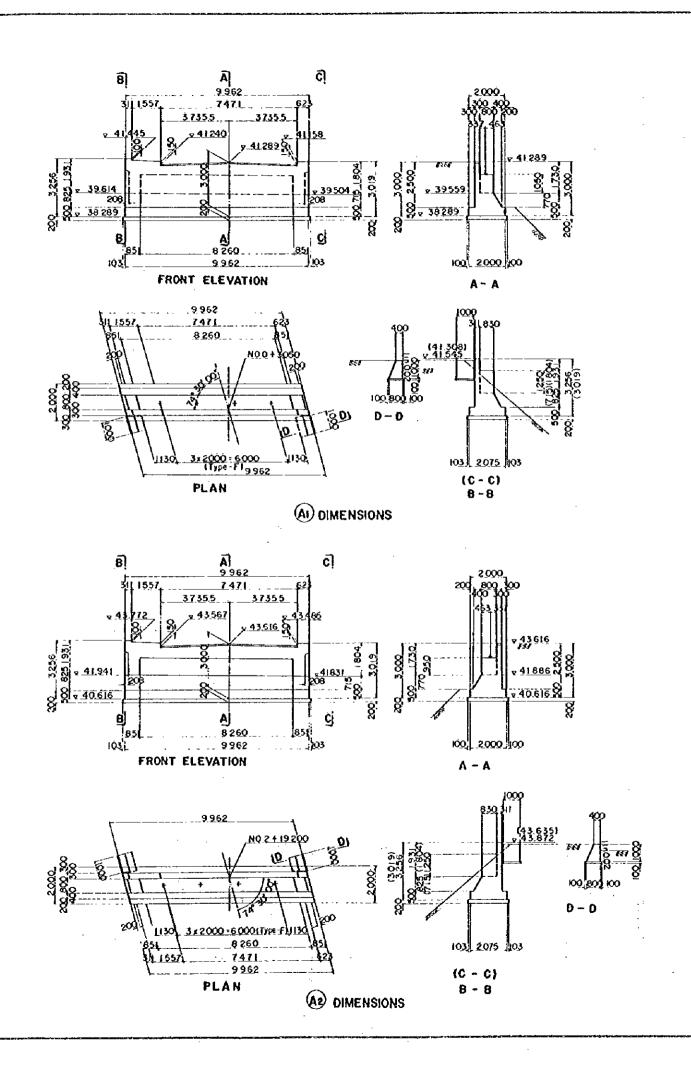

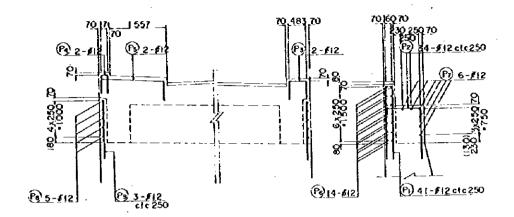

ELEVATION


TYPICAL SECTION


REINFORCEMENT DETAILS


REDUCED PLAN


THE REDUCTION SCALE USED


IS 1/20 TO THE ORIGINAL PLAN AND APPLYS TO THE ORIGINAL PLANS ONLY.

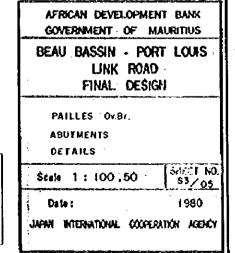

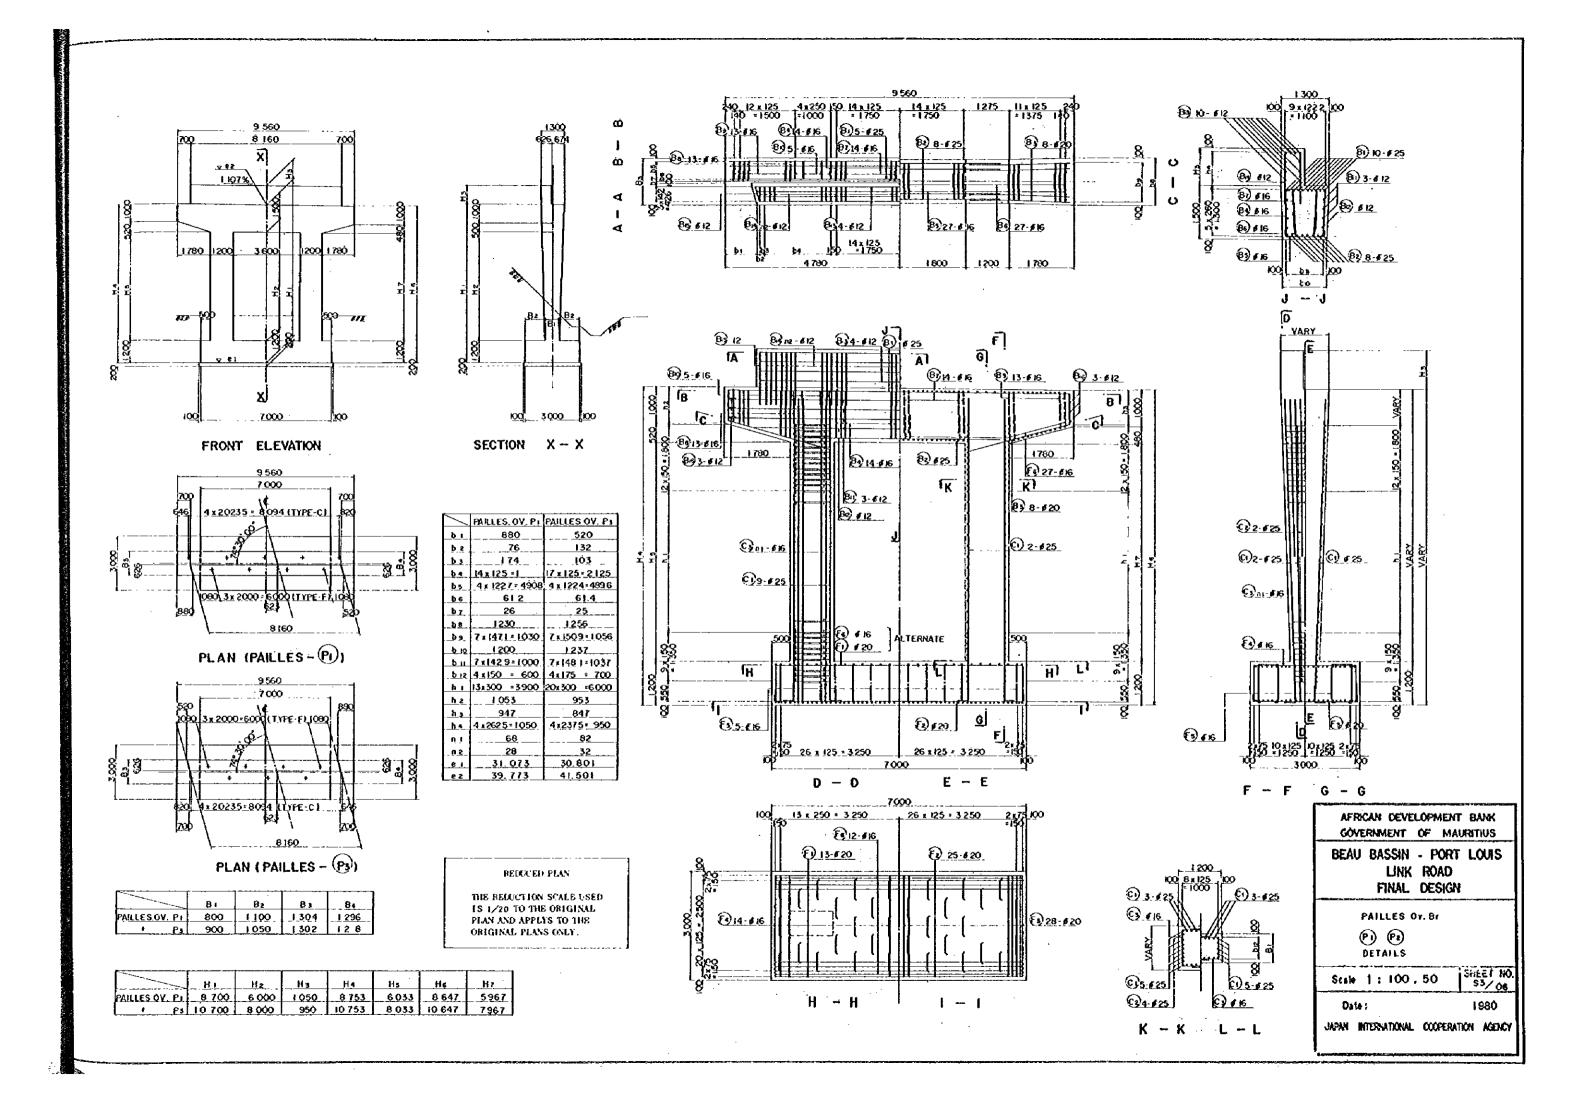


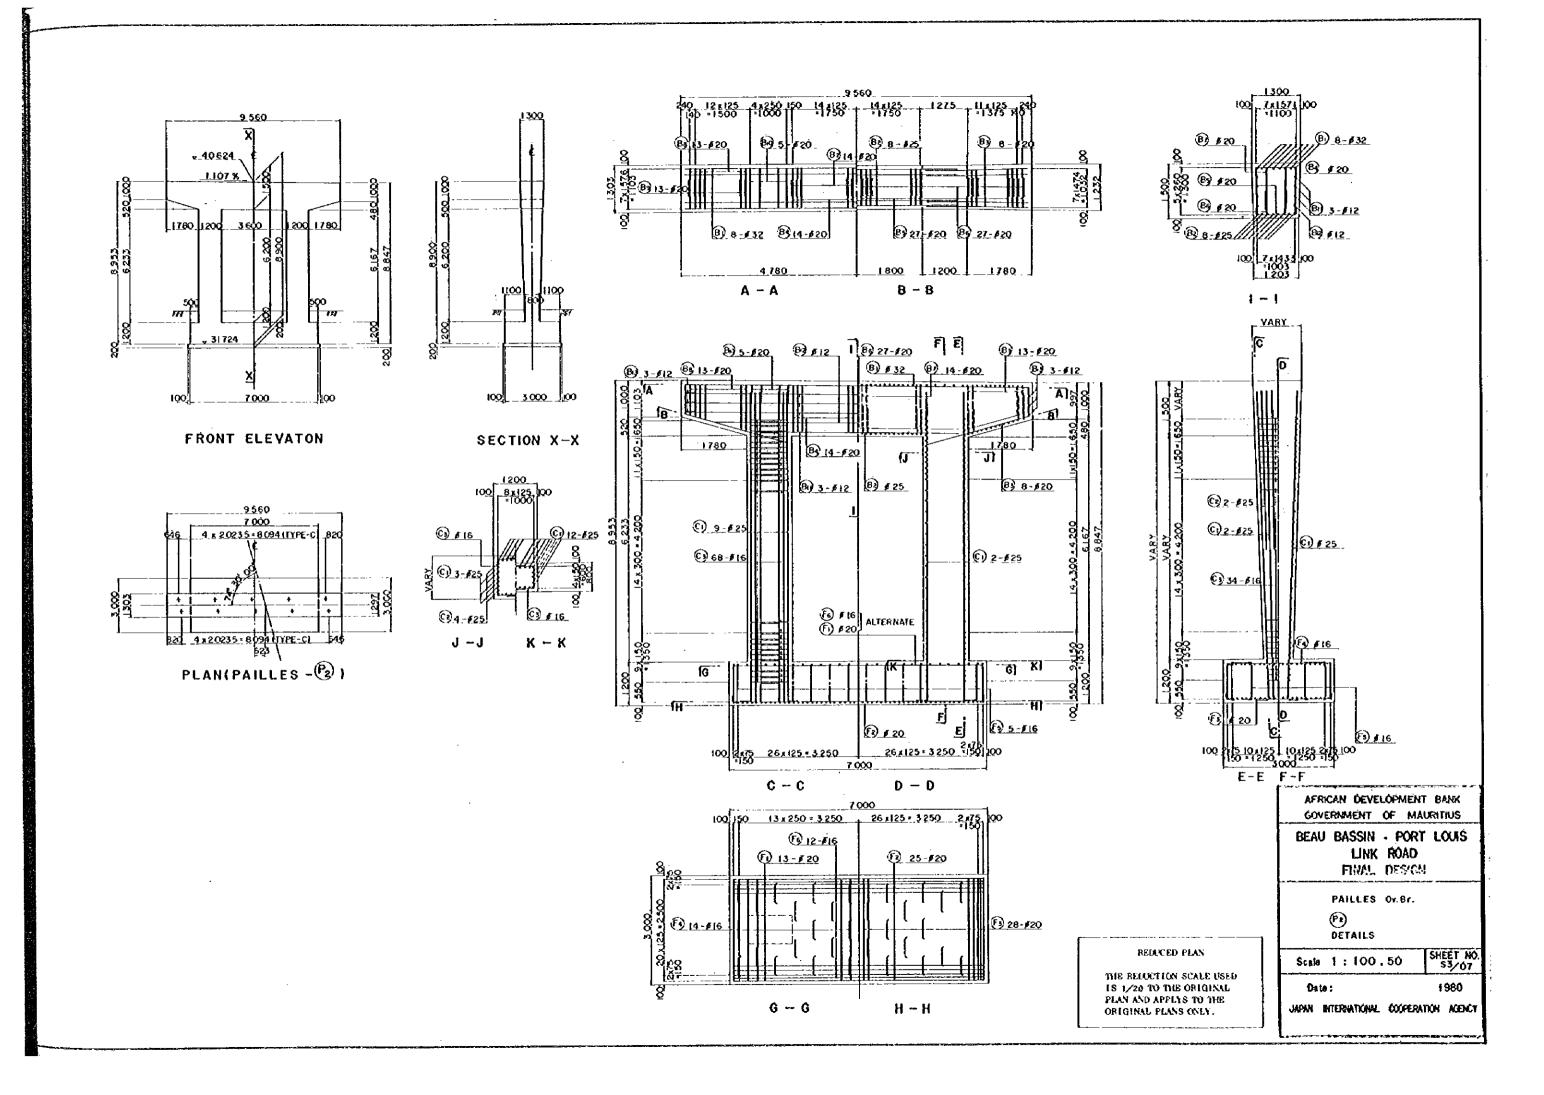

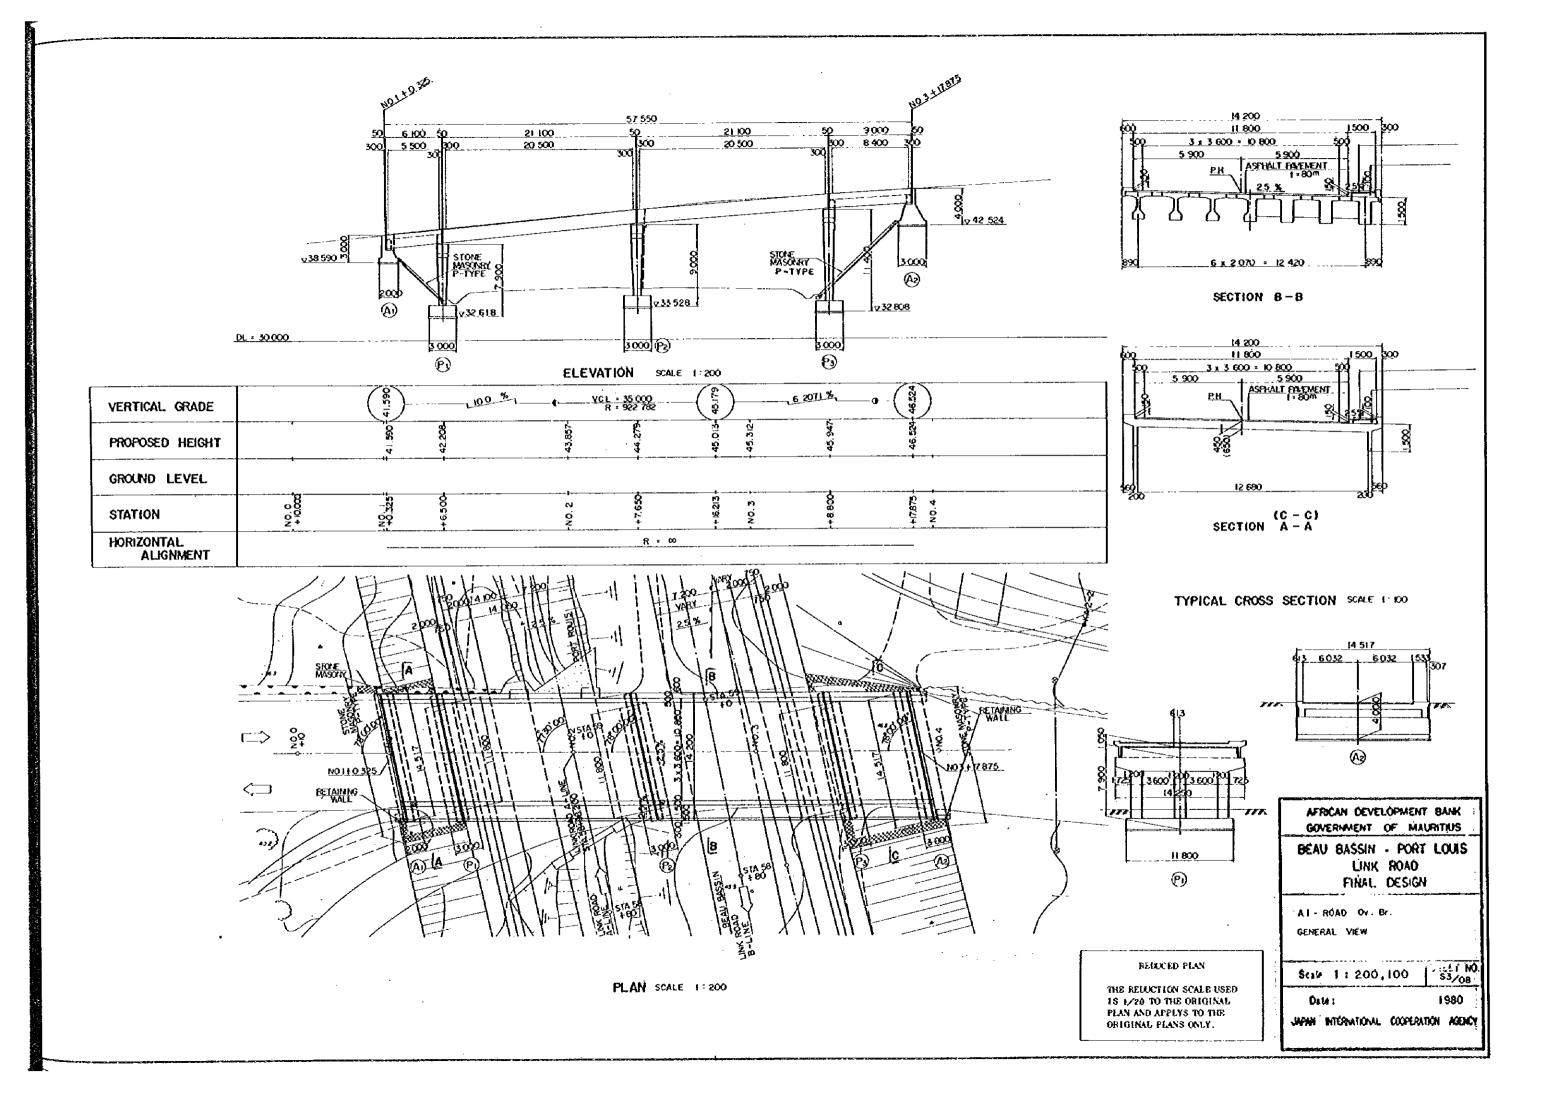


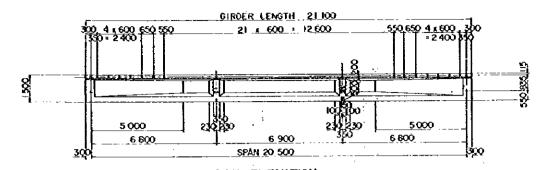

SIDE ELEVATION SCALE I 100

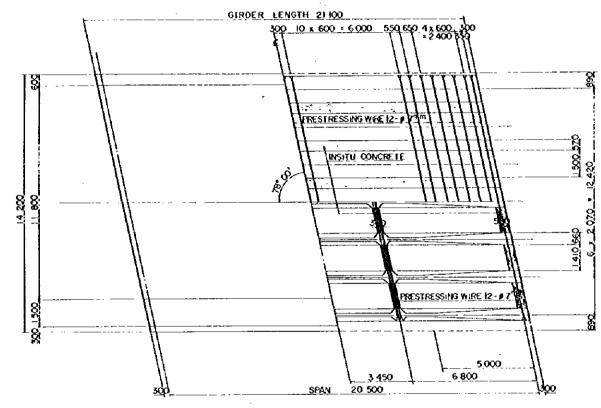


PLAN SCALE 1:100

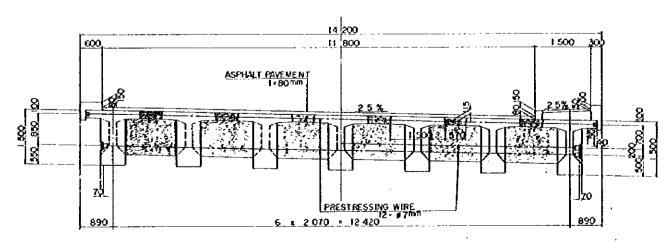

END SECTION

CENTER SECTION

CROSS SECTION SCALE 150

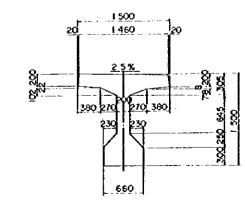

GIRDER SECTION SCALE 1:30

REDUCED PLAN

ME REDUCTION SCALE USED IS 1/20 TO THE ORIGINAL PLAN AND APPLYS TO THE ORIGINAL PLANS ONLY.

AFRICAN DEVELOPMENT BANK GOVERNMENT OF MAURITIUS

BEAU BASSIN - PORT LOUIS LINK ROAD FINAL DESIGN

At - ROAD Ov. Br


PC T + GIRDER
GIRDER AND CROSSBEAM DIMENSIONS


Scale 1:30,50,100 SHEET NO. \$3/09


Date:


1980

JAPAN INTERNATIONAL COOPERATION AGENCY

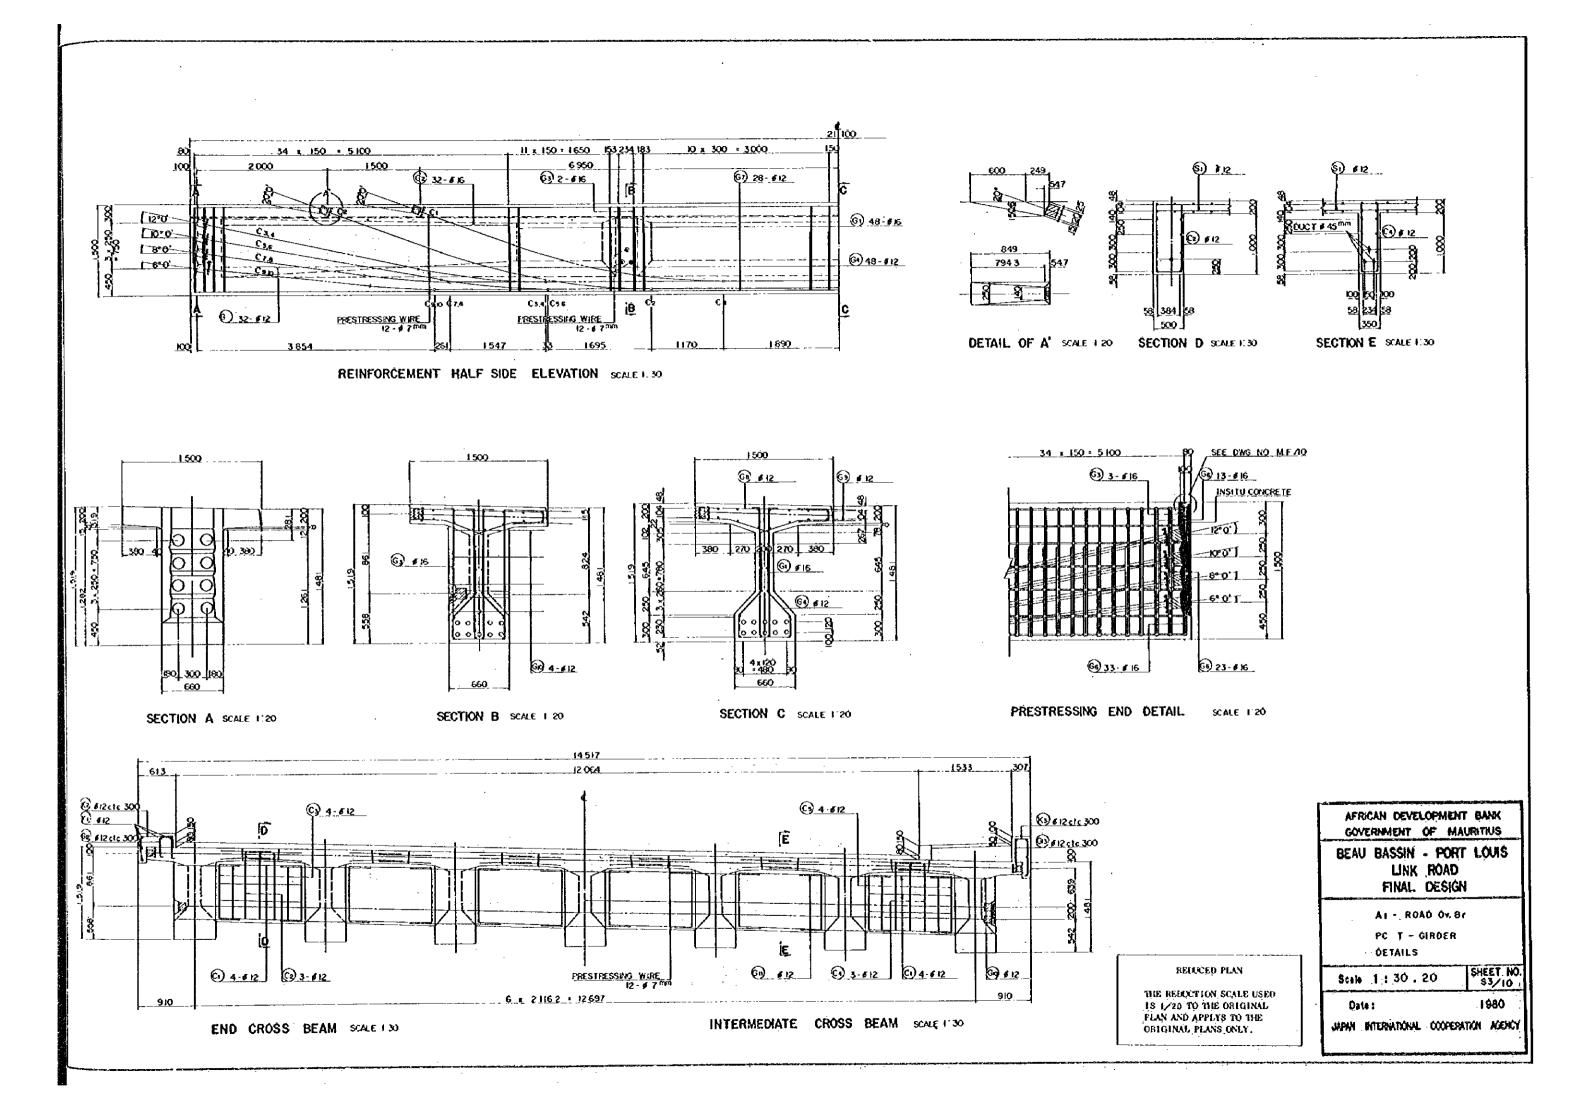

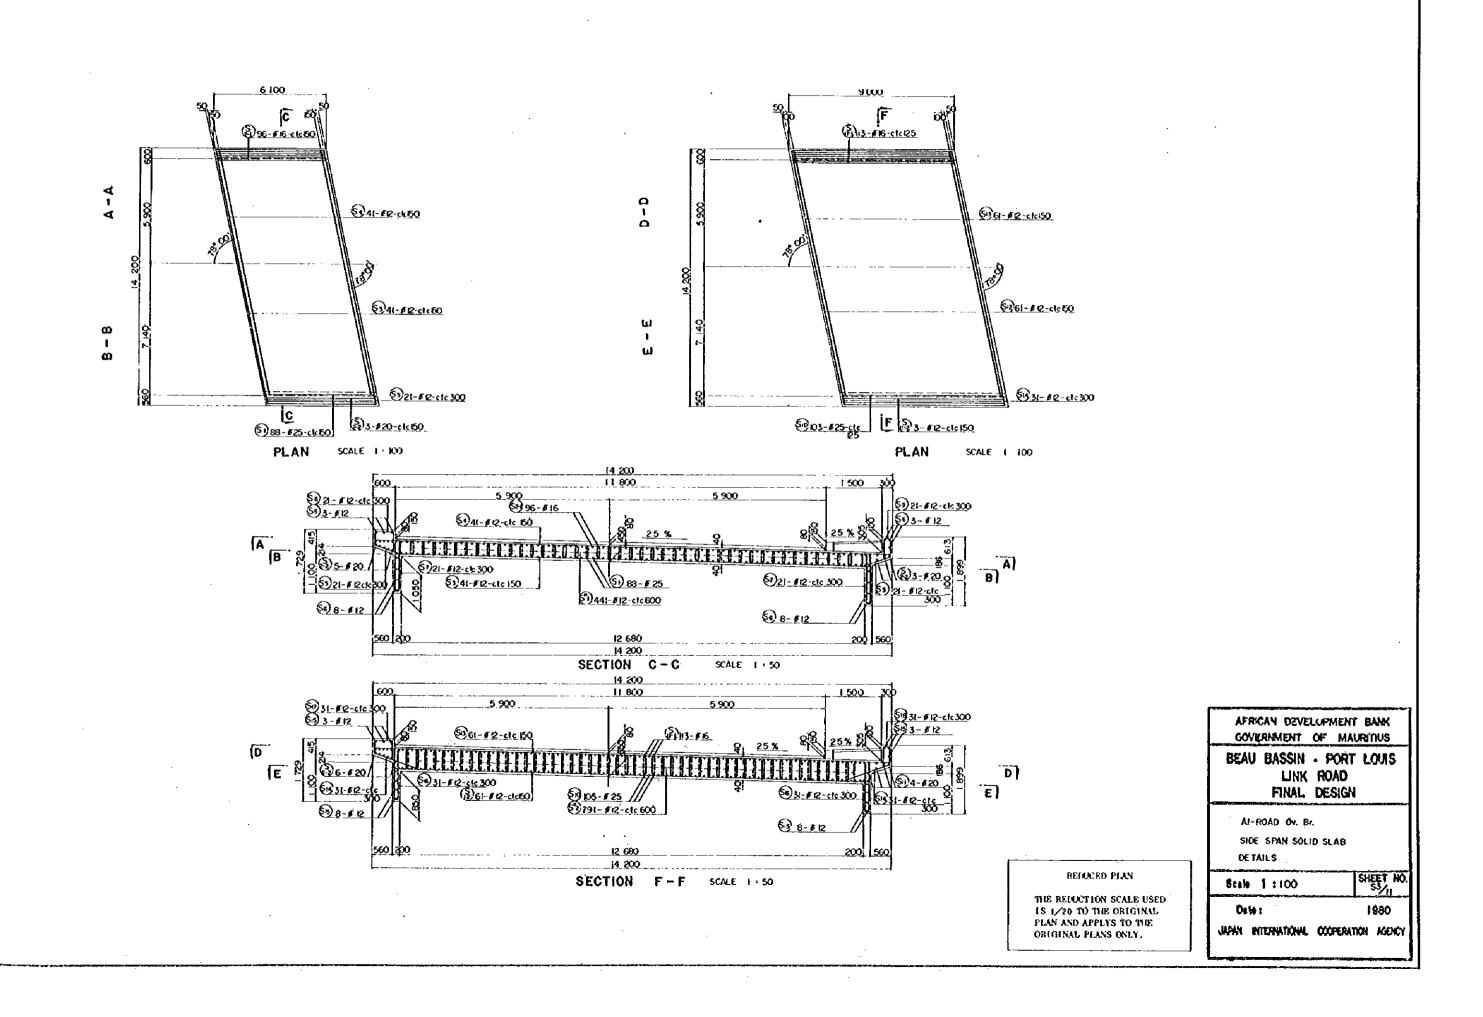

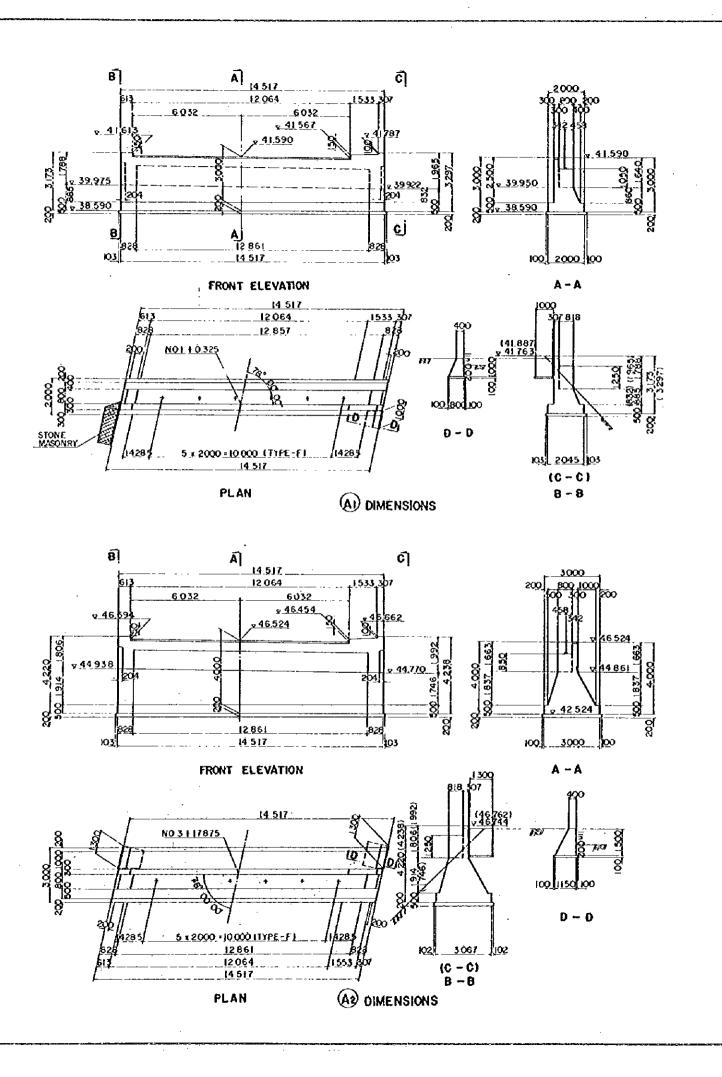

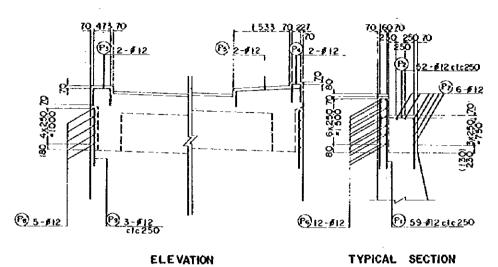

REINFORCEMENT DETAILS

RELUCED PLAN

THE RELUCTION SCALE USED IS 1/20 TO THE ORIGINAL

PLAN AND APPLYS TO THE ORIGINAL PLANS ONLY.

AFRICAN DEVELOPMENT BANK GOVERNMENT OF MAURITHUS BEAU BASSIN - PORT LOUIS

LINK ROAD FINAL DESIGN


> AT - ROAD Ov. Br ABUTMENTS DETAILS


.\$cale 1:100.50


1980


SHEET NO.

JAPAN INTERNATIONAL COOPERATION ASSISCY

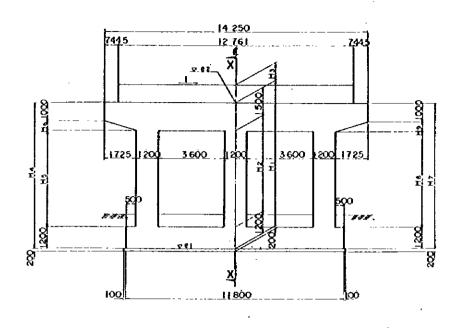

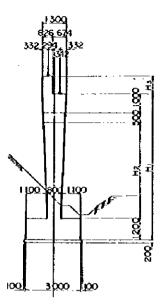

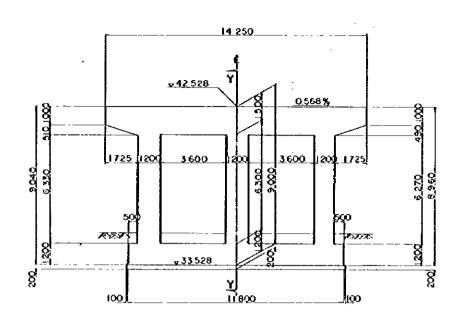

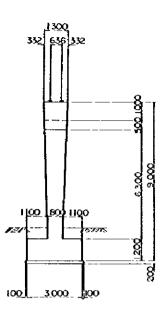



FRONT ELEVATION


SECTION X-X

FRONT ELEVATION

SECTION Y-Y

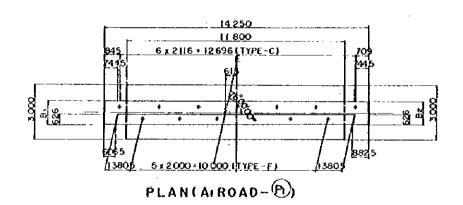

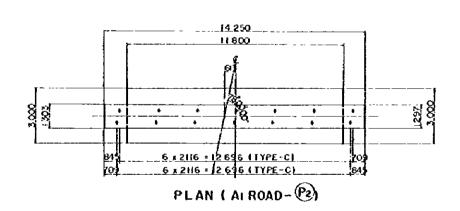

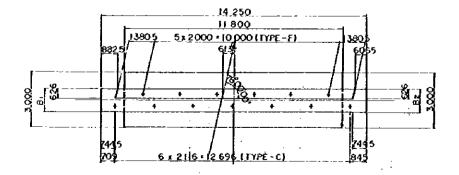

PLAN(A	ROAD	- (Pd)
--------	------	--------

	1 %	e i	ez
A ROAD - Pi	0.366	32 618	40.518
At ROAD 'Ps	1.044	32 808	44.208

	81	82	Hi	H2	Нs	H4	Hs	He	Hr	Нв	He
At ROAD - Pt	1 302	1 298	7 900	5 200	1050	7 926	5 220	506	7 874	5 (80	494
ATROAD - Pa	1 304	1296	11400	8 700	850	11 474	8 756	518	11 326	8 644	482

REDUCED PLAN

THE REDUCTION SCALE USED 18 1/20 TO THE ORIGINAL PLAN AND APPEYS TO THE ORIGINAL PLANS ONLY. AFRICAN DEVELOPMENT BANK GOVERNMENT OF MAURITIUS BEAU BASSIN - PORT LOUIS

BEAU BASSIN - PORT LOUIS LINK ROAD FINAL DESIGN

A1 - ROAD OV. Br.


PIERS DIMENSIONS


Scale 1:100 | SicEY |


Date:

JAPAN BITERNATIONAL COOPERATION AGENCY


1980

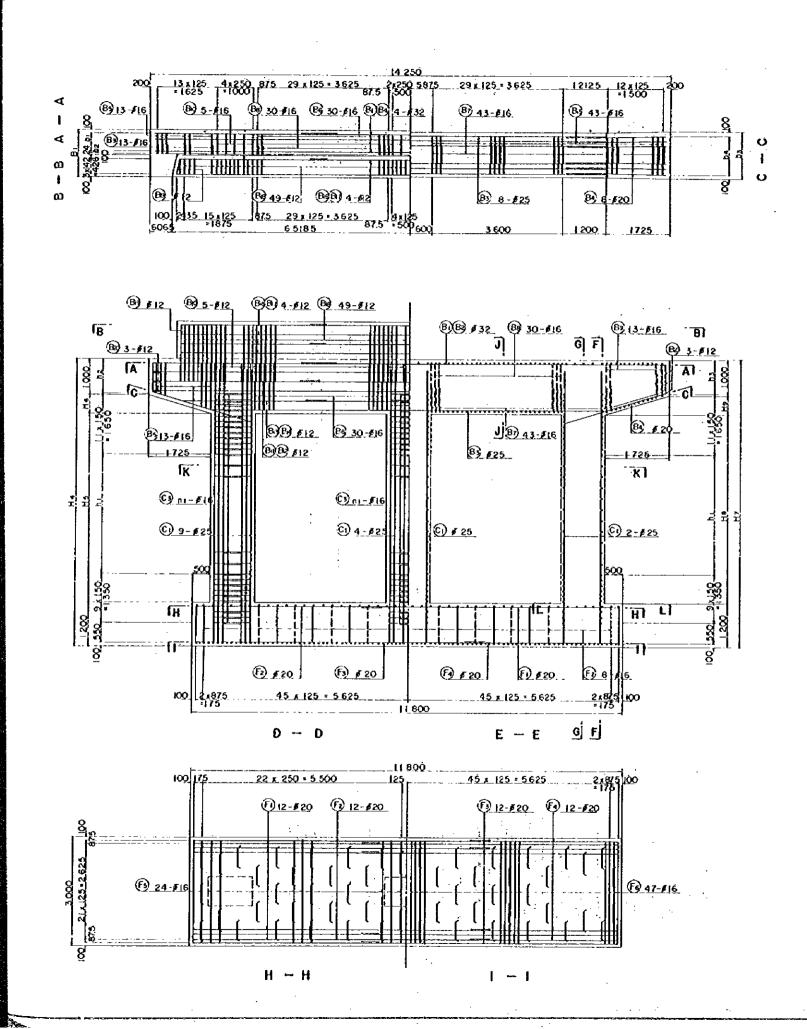

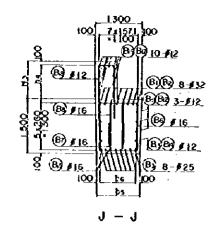

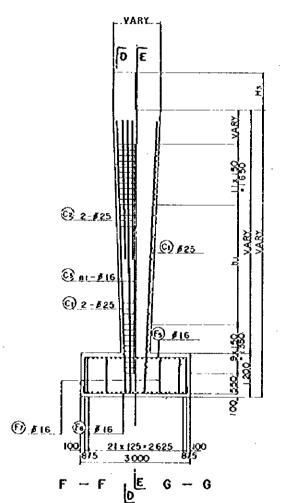

	Ai ROAD - Pi	A1ROAD - Ps
bı	3 x 157.4 = 472	3x157.7 = 473
b 2	79	79
b s	1223	1 247
54	7 (146) =1023	7 x 149 6 =1047
bs_	1188	1226
b 6	7 x 141.1 = 988	7 x 146.6 = 1026
Ьı	1 <u>1 a</u> 300 = 3 300	23 x 300 = 6 900
. b z	976	924
b s	924	776
B 4	4 / 2625:1050	3 : 2838 : 850
01	31	43

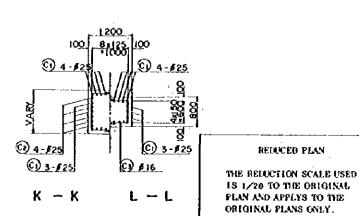

AFRICAN DEVELOPMENT BANK GOVERNMENT OF MAURITIUS

BEAU BASSIN . PORT LOUIS LINK ROAD FIRM, MOIGN

A I - ROAD Ov. Br.


(P) (P) REIFORCEMENT DETAILS


STATE NO Scale 1:50 1960


Date:

REDUCED PLAN


JAPAN INTERNATIONAL COOPERATION AGENCY

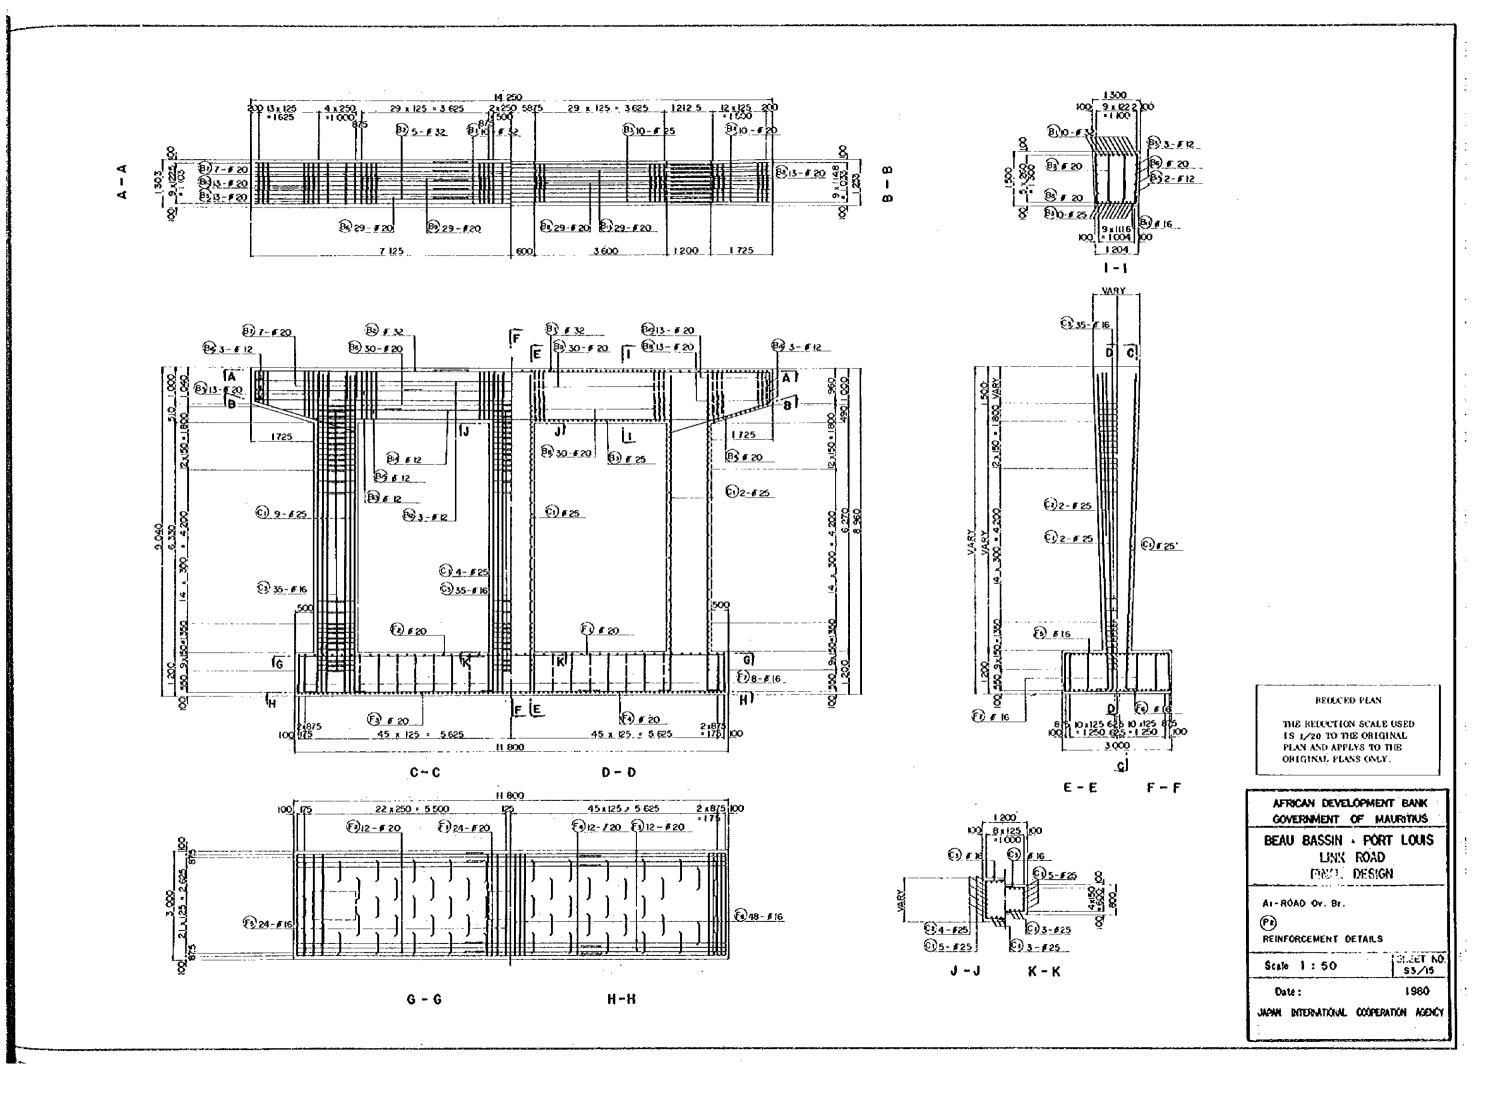


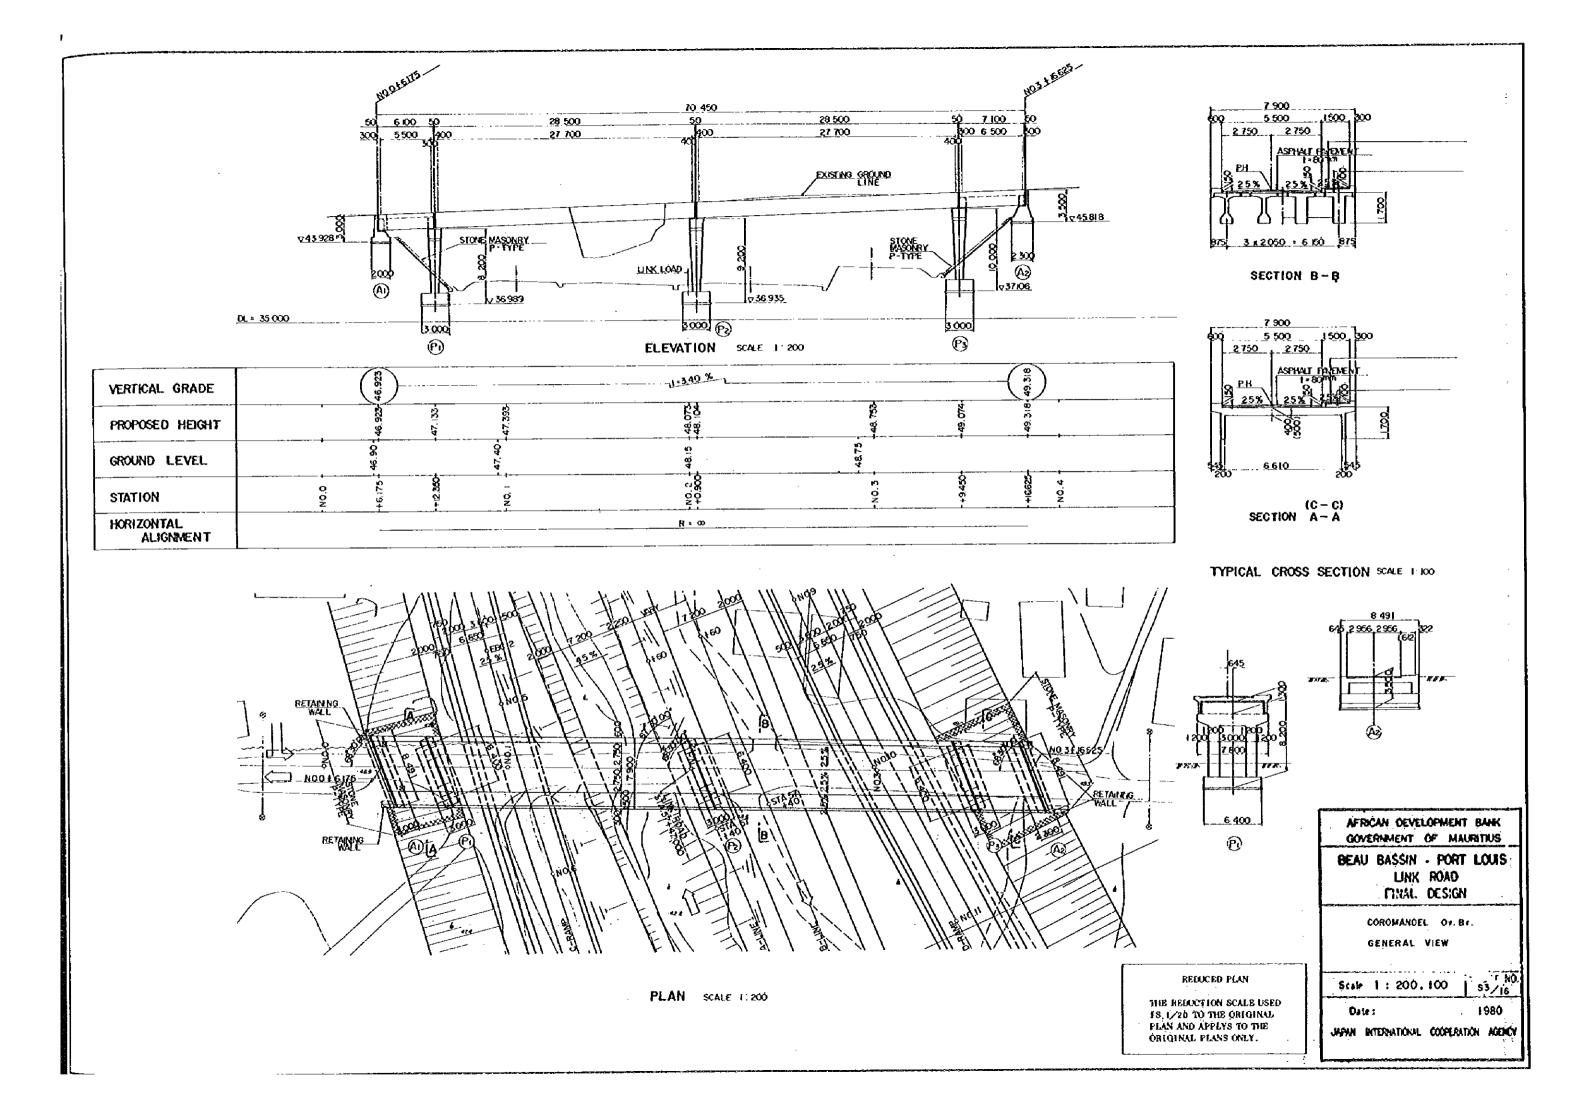

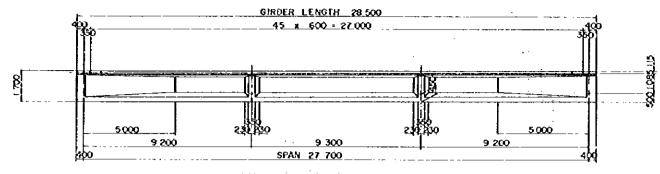


SIDE ELEVATION SCALE 1.100

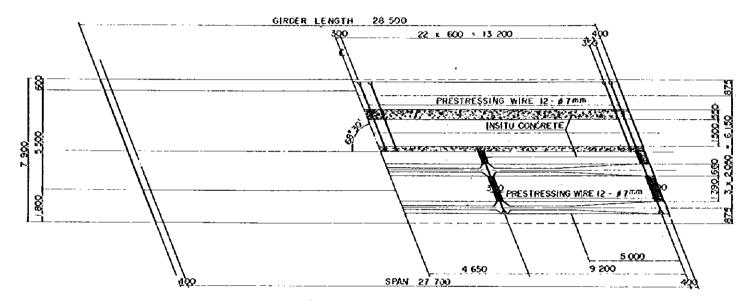

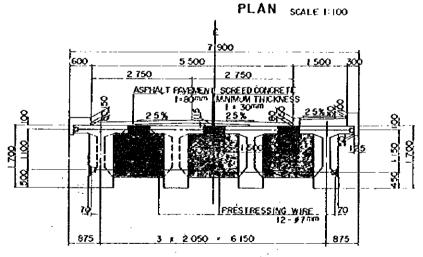

END SECTION CENTER SECTION

CROSS SECTION SCALE 1.50

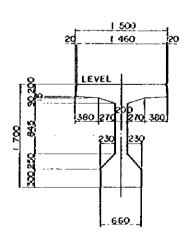

GIRDER SECTION SCALE 1:30

AFRICAN DEVELOPMENT BANK GOVERNMENT OF MAURITHUS

GALVANIZE STEEL PIPE

FURNISHING DETAIL SCALE 1:20

BEAU BASSIN - PORT LOUIS UNK ROAD FINAL DESIGN

CÓROMANOEL OV. Br.

PC Y - GIRDER GIERDER AND CROSSBEAM DMENSIONS

\$cals 1:100,50,30,20 SHEET NO. \$3/17

Deles

JAPAN BITERNATIONAL COOPERATION ACENCY


1980


RELUCED PLAN


INSERT ANCHOR #16


<u>#16 : 750</u> <u>#16 : 1 100</u> <u>1 -75:75:19:750</u>


THE RELECTION SCALE USED 18 1/20 TO THE ORIGINAL PLAN AND APPLYS TO THE ORIGINAL PLANS ONLY.

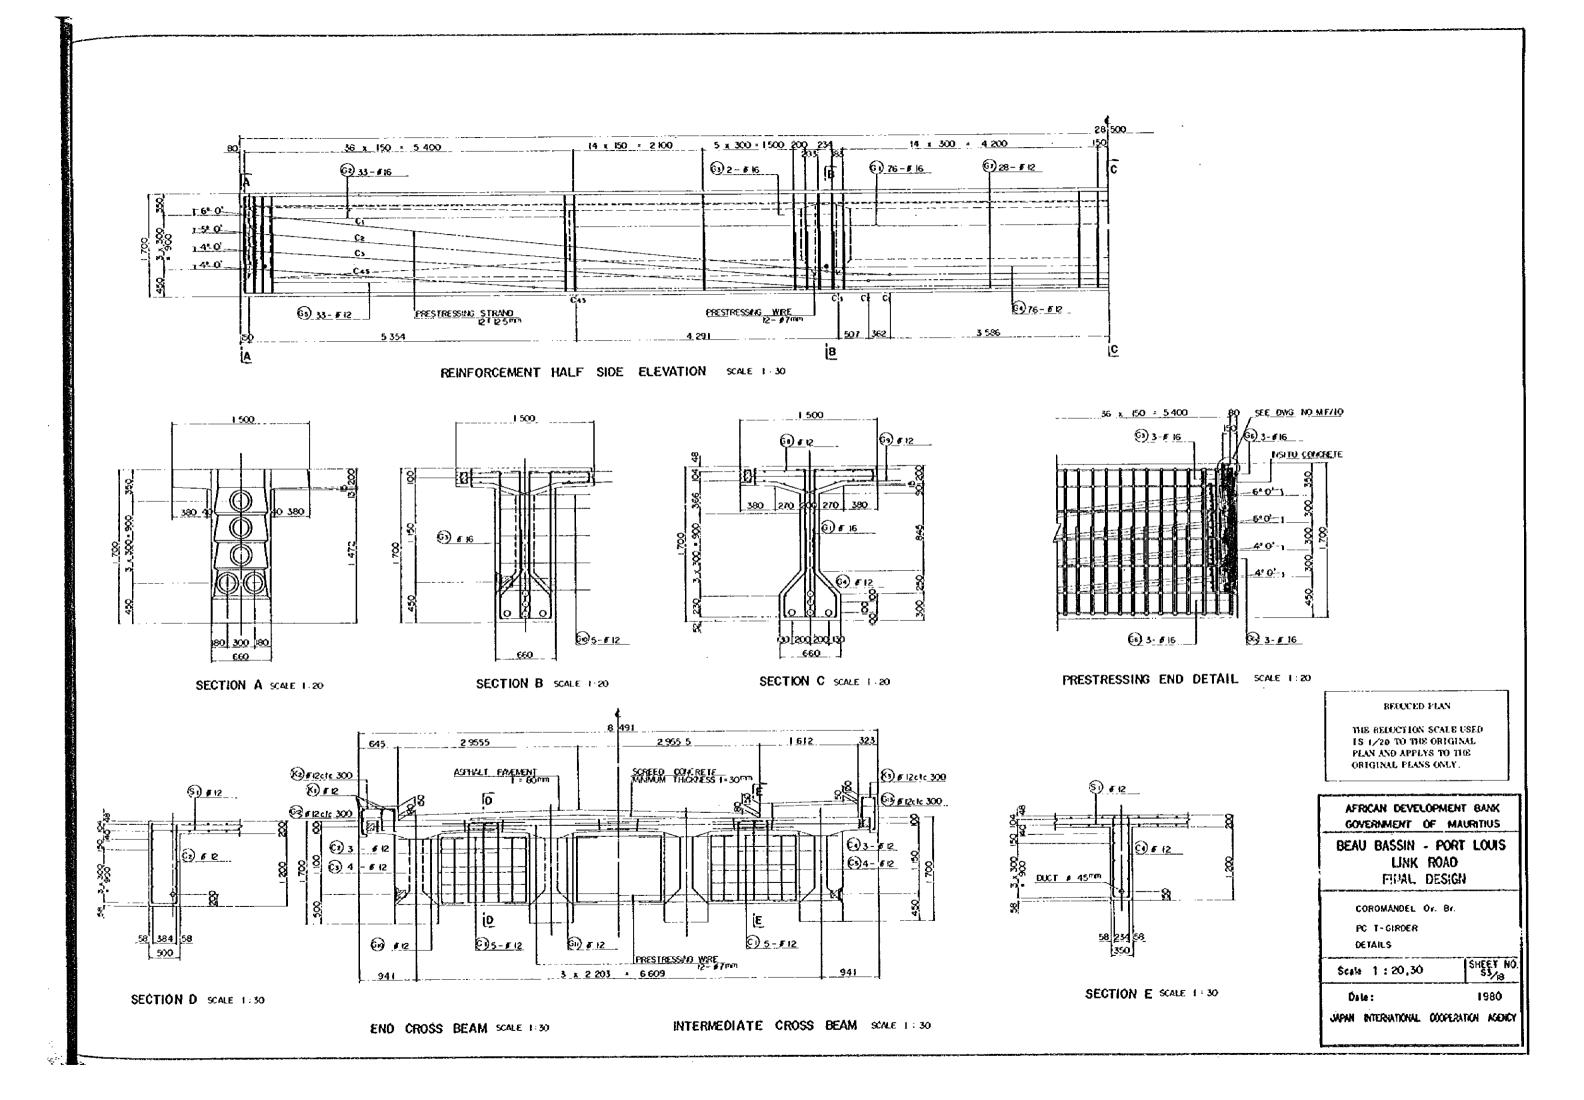


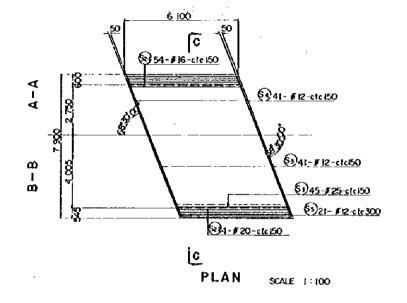

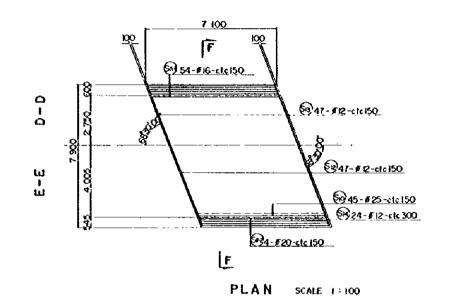

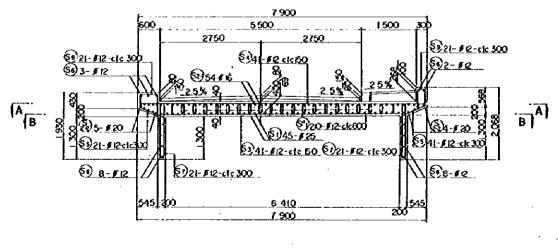

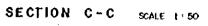

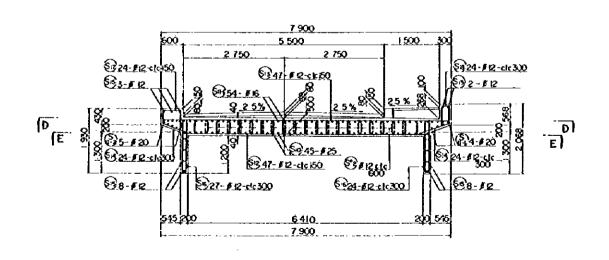

SECTION F-F

RELUCED PLAN

THE REJUCTION SCALE USED
18 1/20 TO THE ORIGINAL
PLAN AND APPLYS TO THE
ORIGINAL PLANS ONLY.

SCALE 1:50

AFRICAN DEVELOPMENT BINK
GOVERNMENT OF MAURITUS

BEAU BASSIN - PORT LOUIS

LIFE RIDAD

COROMANDEL OV. BI

SIDE SPAN SOLIO SLAB


DETAILS


Scale 1:50,100 GREET NO.

S3/19

Data: 1980

JAPAN INTERNATIONAL COOPERATION ASSICY

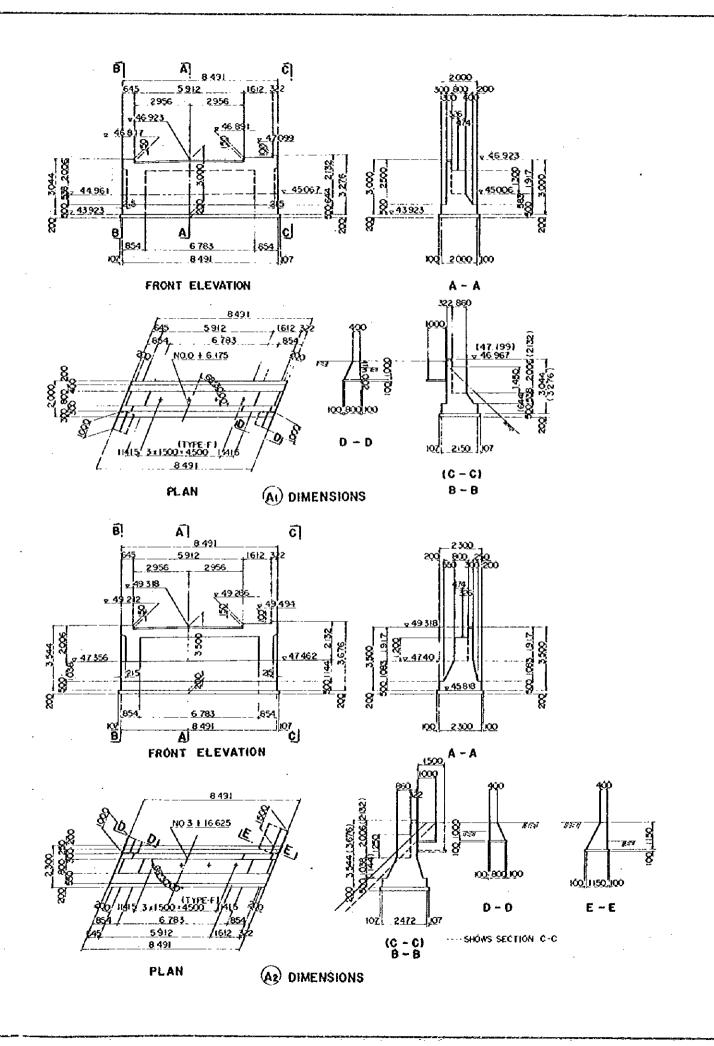

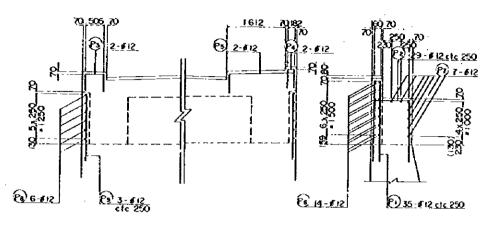

ELEVATION

TYPICAL SECTION

REINFORCEMENT DETAILS



COROMANDEL Ov. Br.

ABUTMENTS

DETAILS

Seale 1 : 50, 100

SHEET NO. 53/20


1980

Date :

JAPAN BITERNATIONAL COOFERATION ASSENCY

RELUCED PLAN

THE REDUCTION SCALE USED IS 1/20 TO THE ORIGINAL PLAN AND APPLYS TO THE ORIGINAL PLANS ONLY.

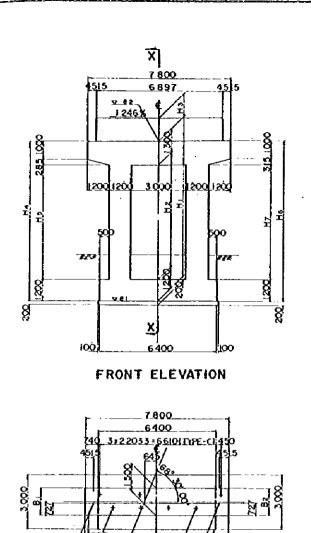


6897

6 4 Ó Ó

1504

PLAN (COROMANDEL - (PI))

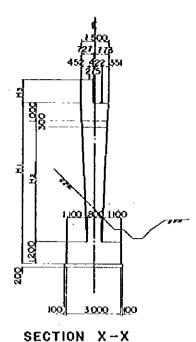

COROMANDEL-PI COROMANDEL-P

8x1506=1206 8x153=122

8<u>x1463:1170 8x1496:119</u>

7465

68

3 0 3.5

2 x 125 = 250

1424

1397

4 x 1439 = 57

19 x 300 ± 5 70

601

699

_5_x 240 = 1 200

21

37.106 47.106

21

1565

146

247.5

6:125 - 750

1405

1370

4 x 1439 = 576

20.5

13 x 300 = 3900

601

699

5 x 260 x 1300

25


36.989 45.189

hı

hz

ħ4

n i

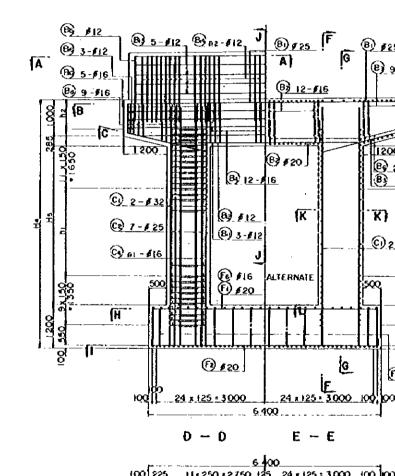

9x125 4x250 12x125 1125 1000 7 1500

12 1125 1225 8 125 1

B 21-516

(E) 9-116

@ 21-116 B 9-120

K}


G


E - E

(1) 2-532

1 4-#16


1500 1200

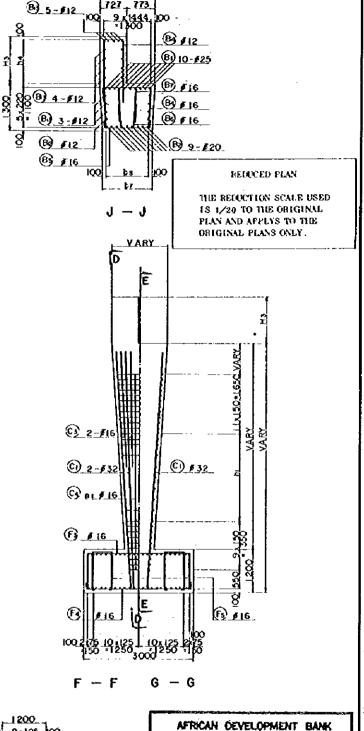

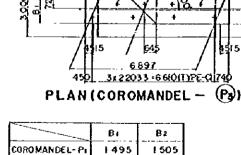


COROMANDEL-P3 1496


				-			
	881	Нz	Нэ	Н4	Hs		Hz
COROMANDEL - PI	8200	5 700	. 1300	8 5	5 666	8 24 9	5 7 3 4
COROMANDEL - P3	10 000	7 500	1200	9 951	7466	10049	7 5 34

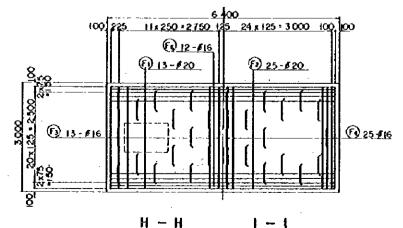


B) 3-#12

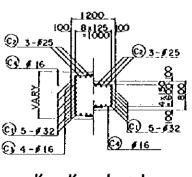



GOVERNMENT OF MAURITIUS BEAU BASSIN - PORT LOUIS LINK ROAD FINAL DESIGN COROMANDEL Or. Br. (P) (P) DETAILS Scale 1: 100.50 Date: 1980 JAPAN INTERNATIONAL COOPERATION ACENCY

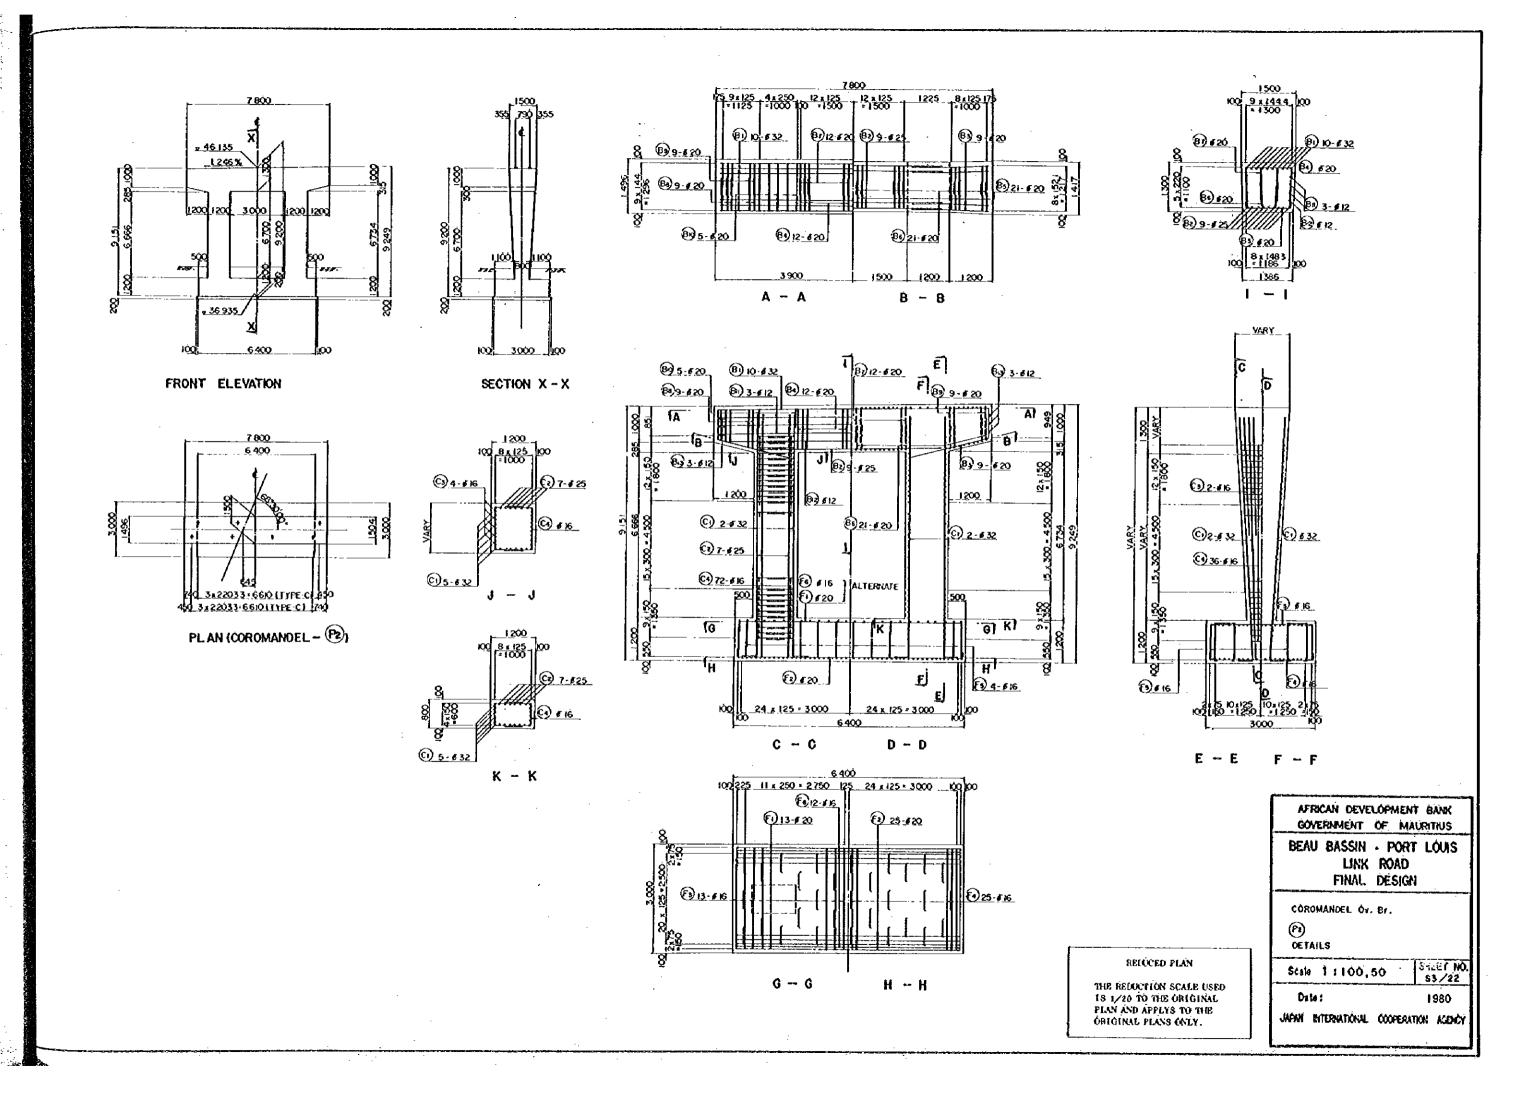

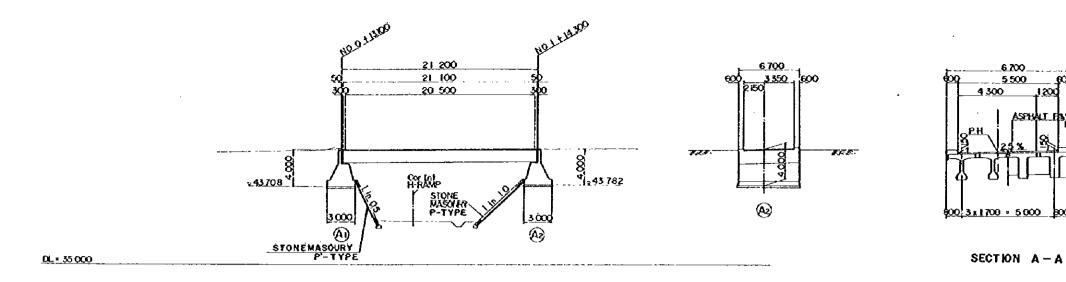


ELEVATION SCALE 1: 200

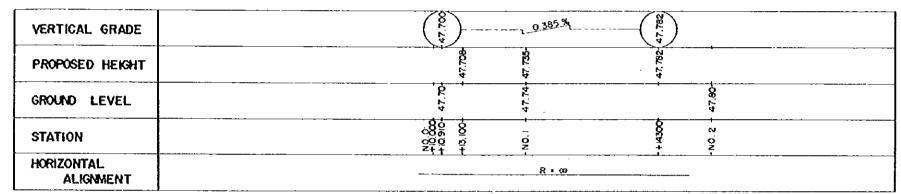

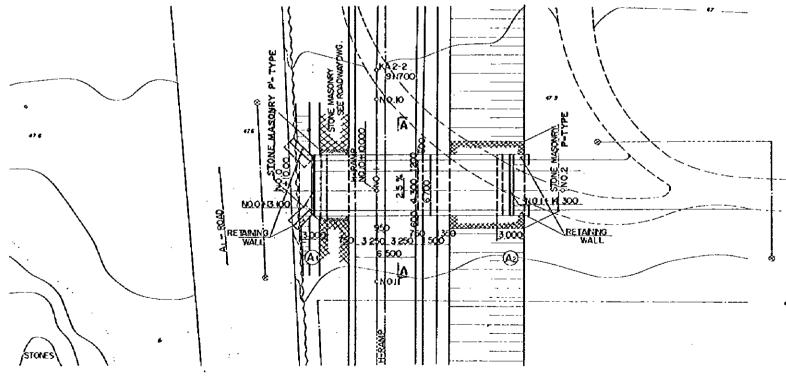

PLAN SCALE 1:200

TYPICAL CROSS SECTION SCALE 1: 100

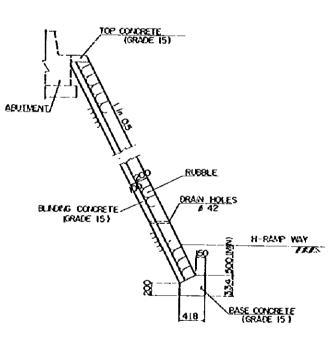

STONE MASONRY PTYPE DETAILS SCALE 1:30

BEDUCED PLAN

THE REDUCTION SCALE USED IS 1/20 TO THE ORIGINAL

PLAN AND APPLYS TO THE

ORIGINAL PLANS ONLY.

AFRICAN DEVELOPMENT BANK GOVERNMENT OF MAURITIUS


BEAU BASSIN - PORT LOUIS LINK ROAD FINAL DESIGN

Cor.Inl. H-Rp. Ov. Br. GENERAL VIEW


SHEET NO. Seile 1 : 200,100, 20

JAPAN INTERNATIONAL COOPERATION AGENCY


1980

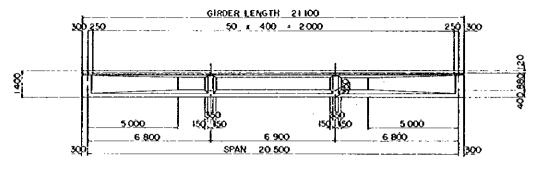

SIDE ELEVATION SCALE 1:100

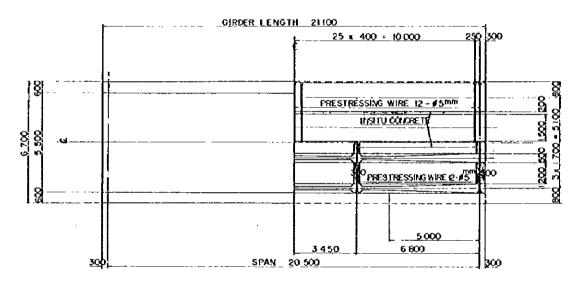


PLAN SCALE 1:100

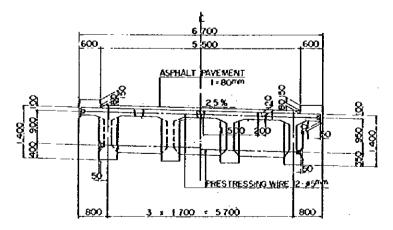

END SECTION CENTER SECTION

CROSS SECTION SCALE 1:50

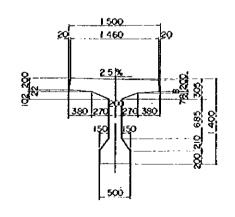

GIRDER SECTION SCALE 1:30

RELUCED PLAN

THE REDUCTION SCALE USED IS 1/20 TO THE ORIGINAL PLAN AND APPLYS TO THE ORIGINAL PLANS ONLY. AFRICAN DEVELOPMENT BANK GOVERNMENT OF MAURITIUS

BEAU BASSIN - PORT LOUIS LINK ROAD FINAL DESIGN

Cor. Inf. H-Rp Ov. Br.

PC T-GIRDER GIRDER AND CROSSBEAM


Stale 1: 30,50,100

5,100 SREET 100 53/24


1960

Casa:


JAPAN BITETHATIONAL COOPERATION ASSURE

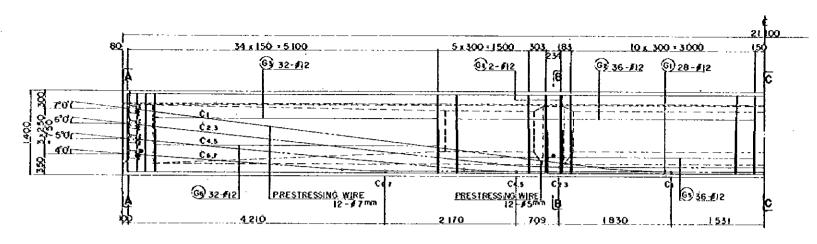

REINFORCEMENT HALF SIDE ELEVATION SCALE 1:30

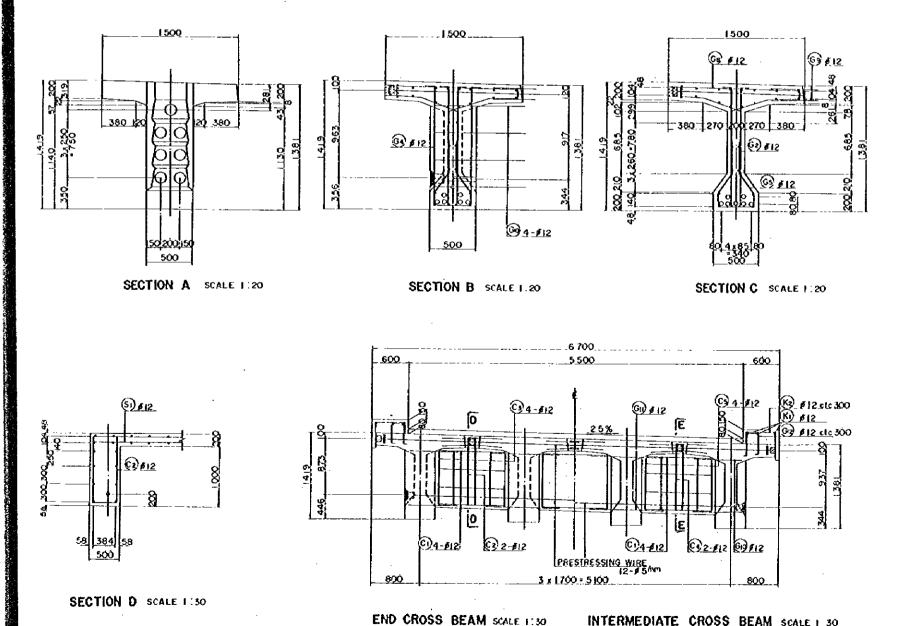


INTERMEDIATE CROSS BEAM SCALE 1 30

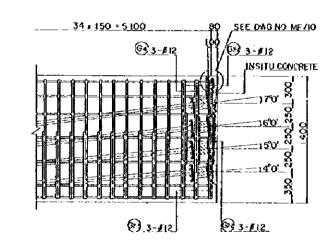

PRESTRESSING END DETAIL SCALE 1:20


RELUCED PLAN


THE REDUCTION SCALE USED IS 1/20 TO THE ORIGINAL PLAN AND APPLYS TO THE ORIGINAL PLANS ONLY.

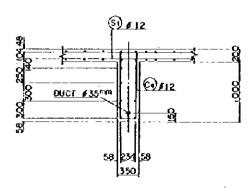

SECTION E SCALE 1:30

AFRICAN DEVELOPMENT BANK GOVERNMENT OF MAURITIUS BEAU BASSIN - PORT LOUIS UNK ROAD FINAL DESIGN Cor. Int. H-Rp Ov. Br. PC T-GIROER DETAILS SHEET MO Scale 1:20,30 JAPAN INTERNATIONAL COOPERATION ACENCY

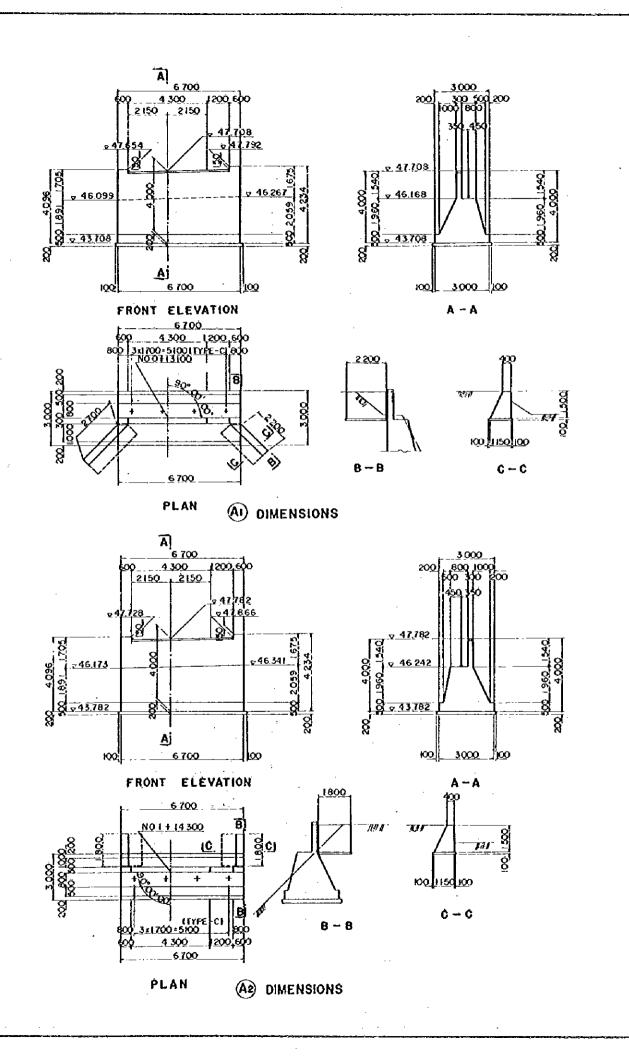

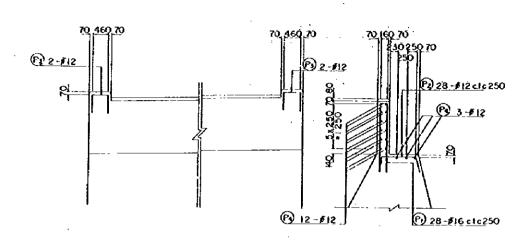

ELEVATION

TYPICAL SECTION

REINFORCEMENT DETAILS

RELUCED PLAN

THE REDUCTION SCALE USED

IS 1/20 TO THE ORIGINAL

PLAN AND APPLYS TO THE

ORIGINAL PLANS ONLY.

AFRICAN DEVELOPMENT BANK GOVERNMENT OF MAURITIUS

BEAU BASSIN - PORT LOUIS LINK ROAD FINAL DESIGN


Cor. Int. H - Rp Ov. Br. ABUTMENTS DETAILS


Stale 1: 100, 50


Date:

1980 JAPAN INTERNATIONAL COOPERATION AGENCY


\$1.1.ET NO \$3/26

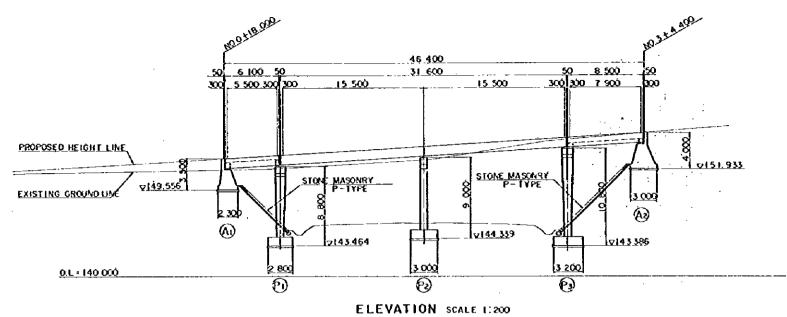

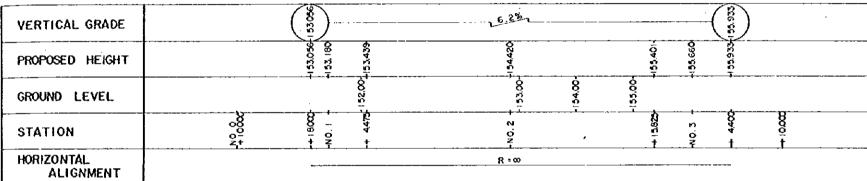

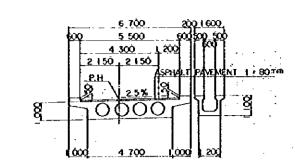

SECTION B-B

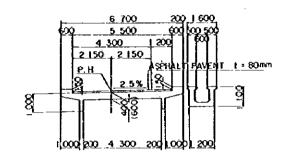



SECTION A-A (C-C)

TYPICAL CROSS SECTION SCALE 11100

EXISTING GROUND LINE

STA 22 AQUEDUCT

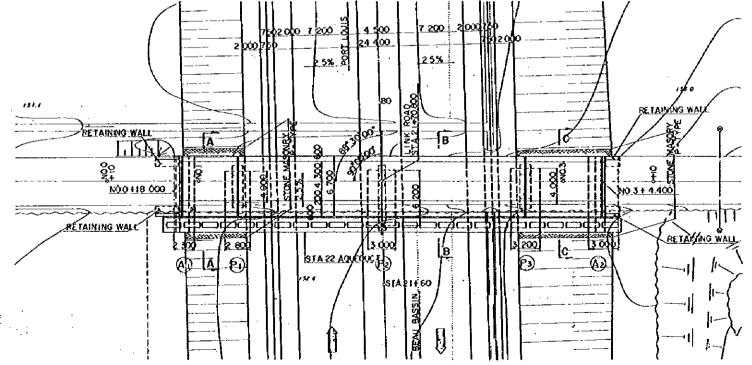

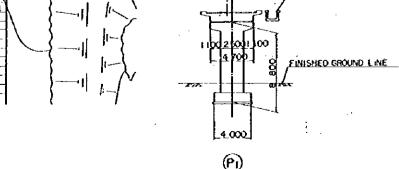

<u>နော် 5 500 တွေ့ 5</u>00

(A2)

REDUCED PLAN

THE RELUCTION SCALE USED IS 1/20 TO THE ORIGINAL PLAN AND APPLYS TO THE ORIGINAL PLANS ONLY.

AFRICAN DEVELOPMENT BANK GOVERNMENT OF MAURITIUS

BEAU BASSIN - PORT LOUIS LINK ROAD FINAL DESIGN

STA 22 Or. Br

Scale 1: 200, 100


Date:


1980


SHEET NO.


JAPAN INTERNATIONAL COOPERATION AGENCY


PLAN SCALE 1,200

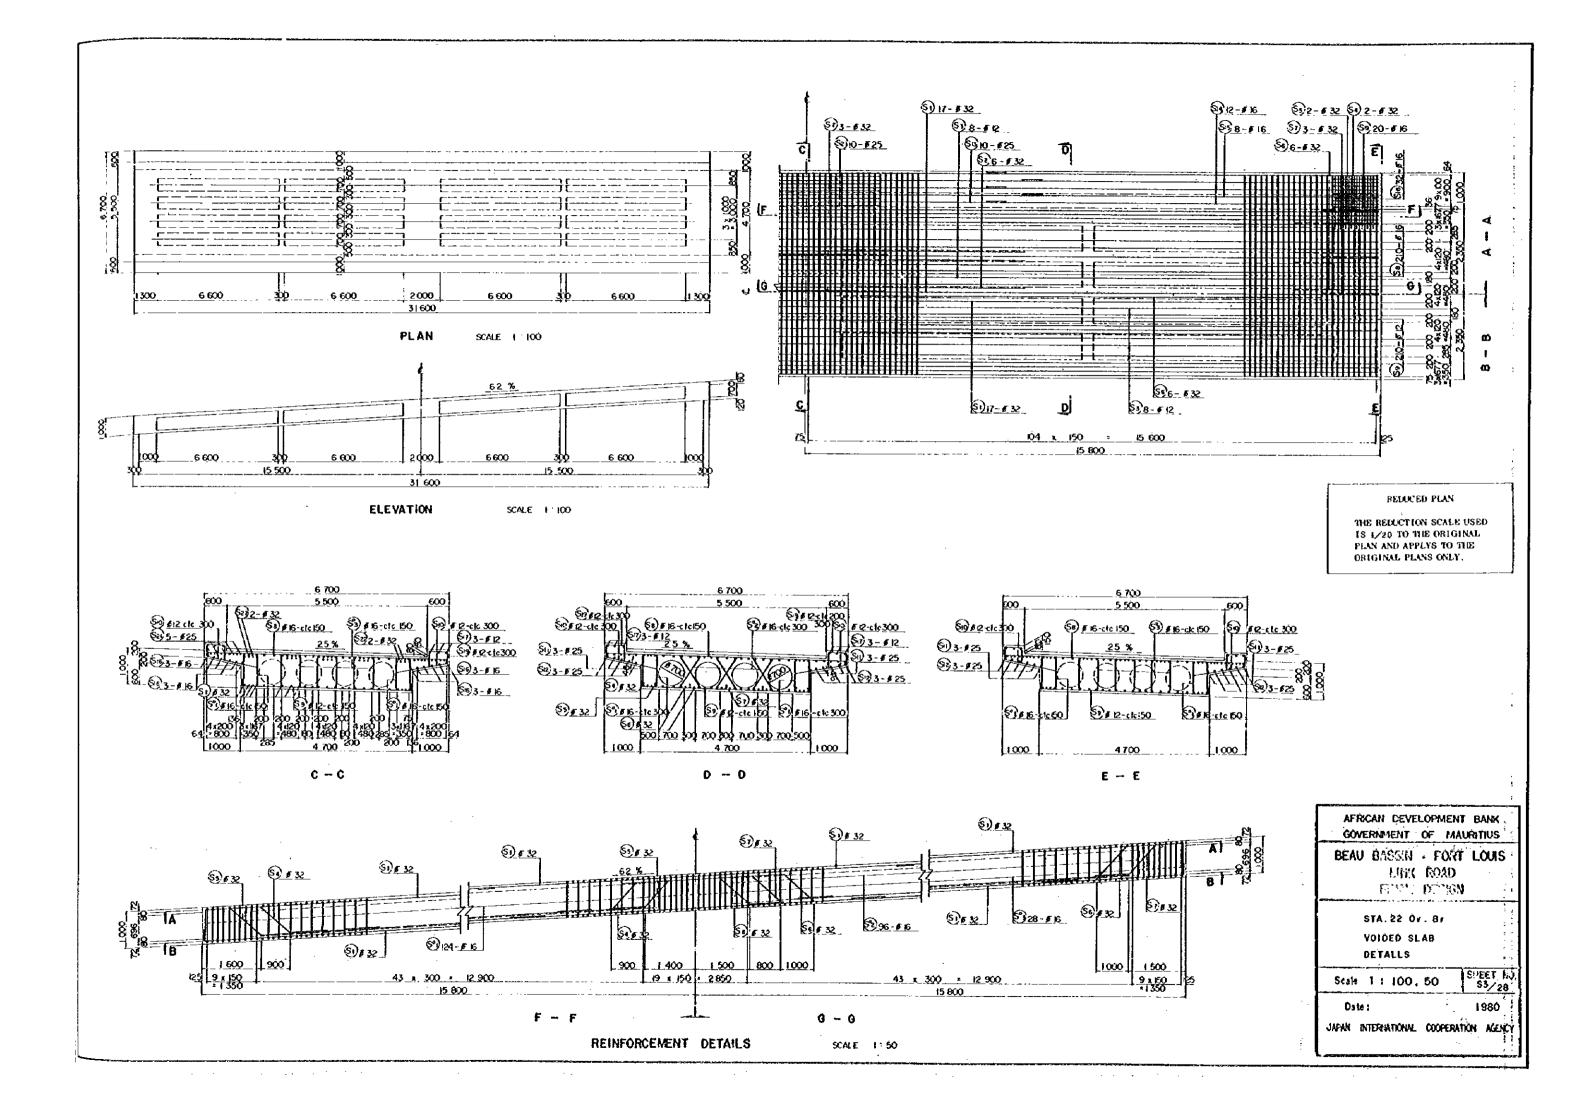

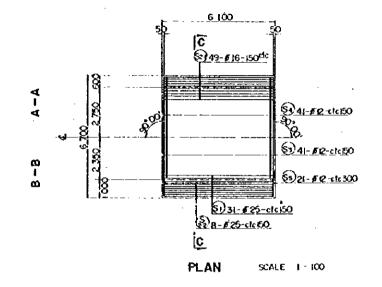

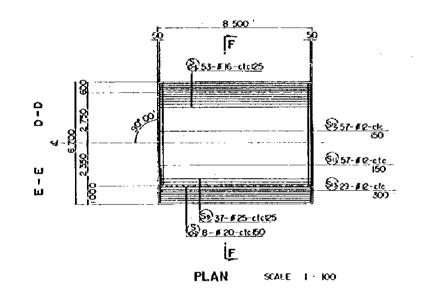

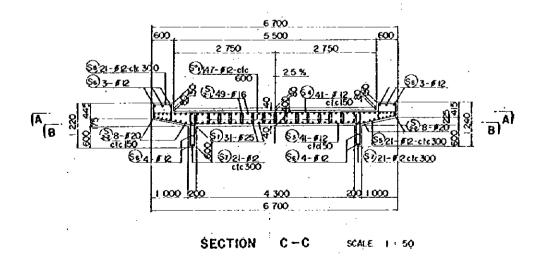

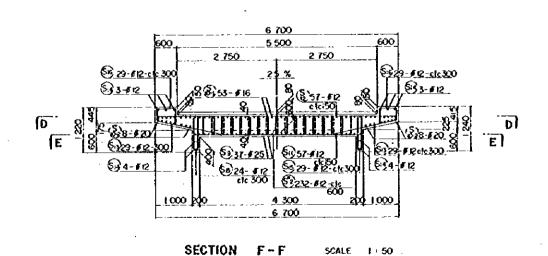

18 1/20 TO THE ORIGINAL PLAN AND APPLYS TO THE ORIGINAL PLANS ONLY.

RELUCED PLAN THE REDUCTION SCALE USED

AFRICAN DEVELOPMENT BANK GOVERNMENT OF MAURITIUS

BEAU BASSIN . PORT LOUIS LINK ROAD FINAL DESIGN

STA, 22 Ov. Br.


SIDE SPAN SOLID SLAB DETAILS


Scale . 1 : 100

Date:

JAPAN INTERNATIONAL COOPERATION AGENCY

1980

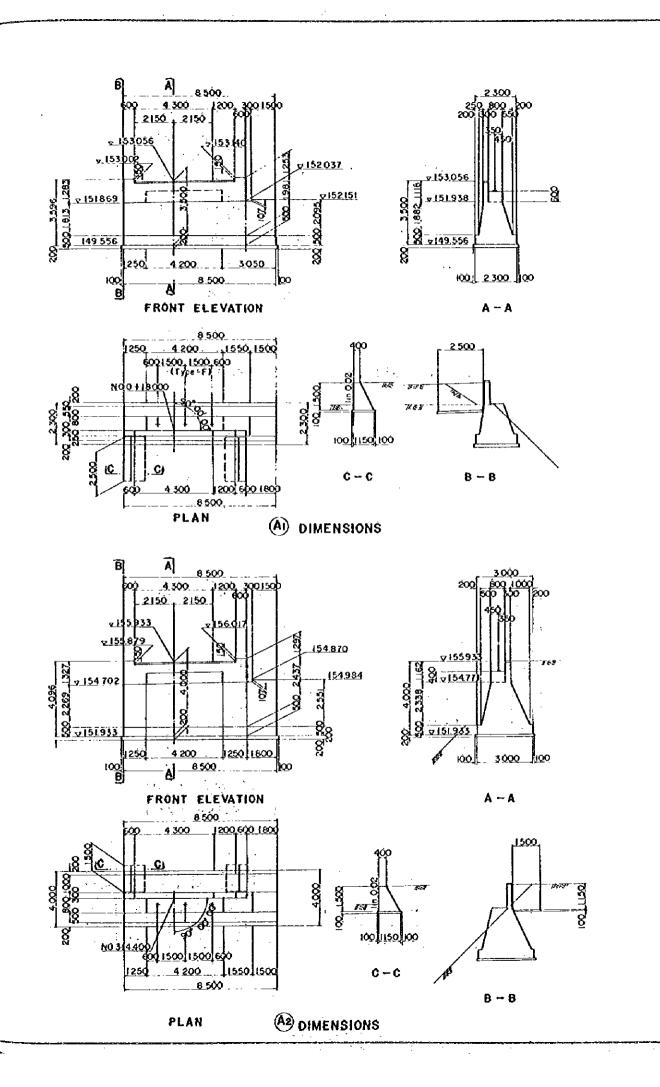

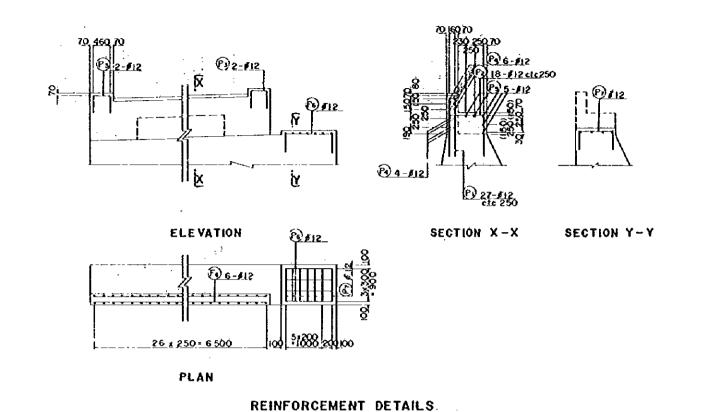

GOVERNMENT OF MAURITIUS
BEAU BASSIN - PORT LOUIS

LINK ROAD
FINAL DESIGN

AFRICAN DEVELOPMENT BANK

STA. 22 OFBE ABUTMENTS DETAILS

Scale 1: 100, 50

Date:


JAPAN INTERNATIONAL COOPERATION ASSINCY


\$3,/30


1980


RELUCED PLAN

THE REDUCTION SCALE USED IS 1/20 TO THE ORIGINAL PLAN AND APPLYS TO THE ORIGINAL PLANS ONLY.

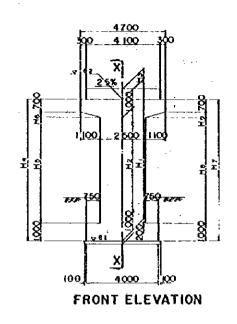

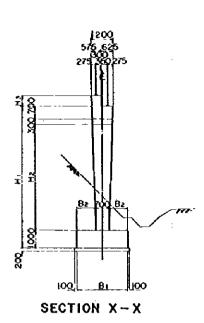

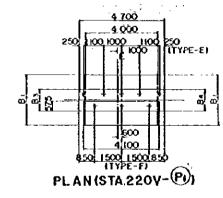


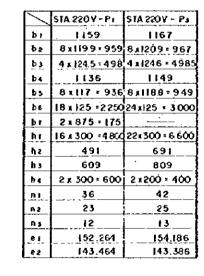



ì			700		1
E	\$0_1.	500	000 150	o s	50 (TYPE-F)
6 B 6			,		m
L		4	60 60 60		
²∞q PLA					250 - (3)

	Ві.	82	81	84	
STA 22-Pr	2 800	1050	1196	1 204	
5TA 22-P3	3 200	1250	1197	1203	

	Hi	H2	Hs	H4	Hs.	Hs	Hz	Нв	Ho
STAZZ-P	8 800	6 800	600	8741	6 769	272	8859	6 8 3 1	328
STA 22 - P	10 800	8 800	400	10741	8 769	272	10859	8831	328

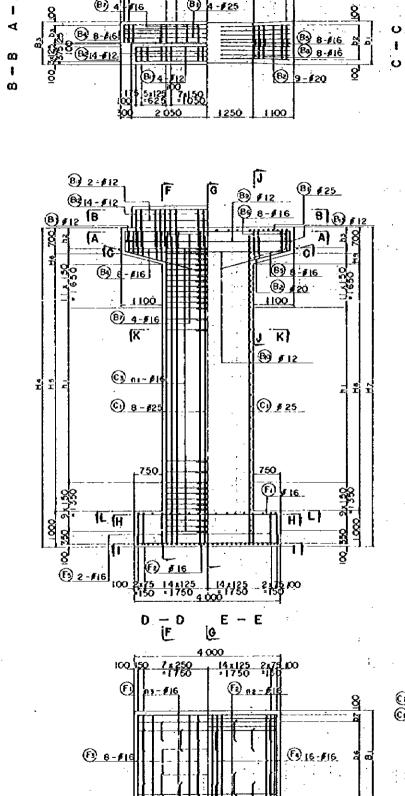

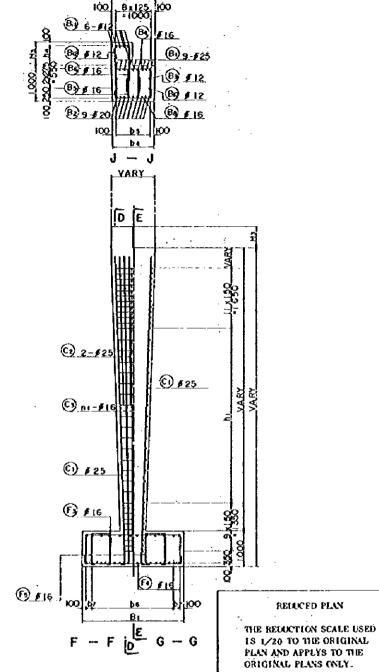

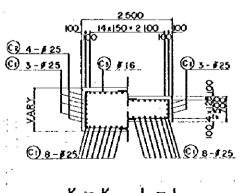

AFRICAN DEVELOPMENT BANK GOVERNMENT OF MAURITHUS

BEAU BASSIN - PORT LOUIS
LINK ROAD
FINAL DESIGN

STA , 22 Ov. Br.

Scale 1:100.50


Date:

DETAILS


JAPAN INTERNATIONAL COOPERATION INSENCY


585£€ NO. \$3/31

1980

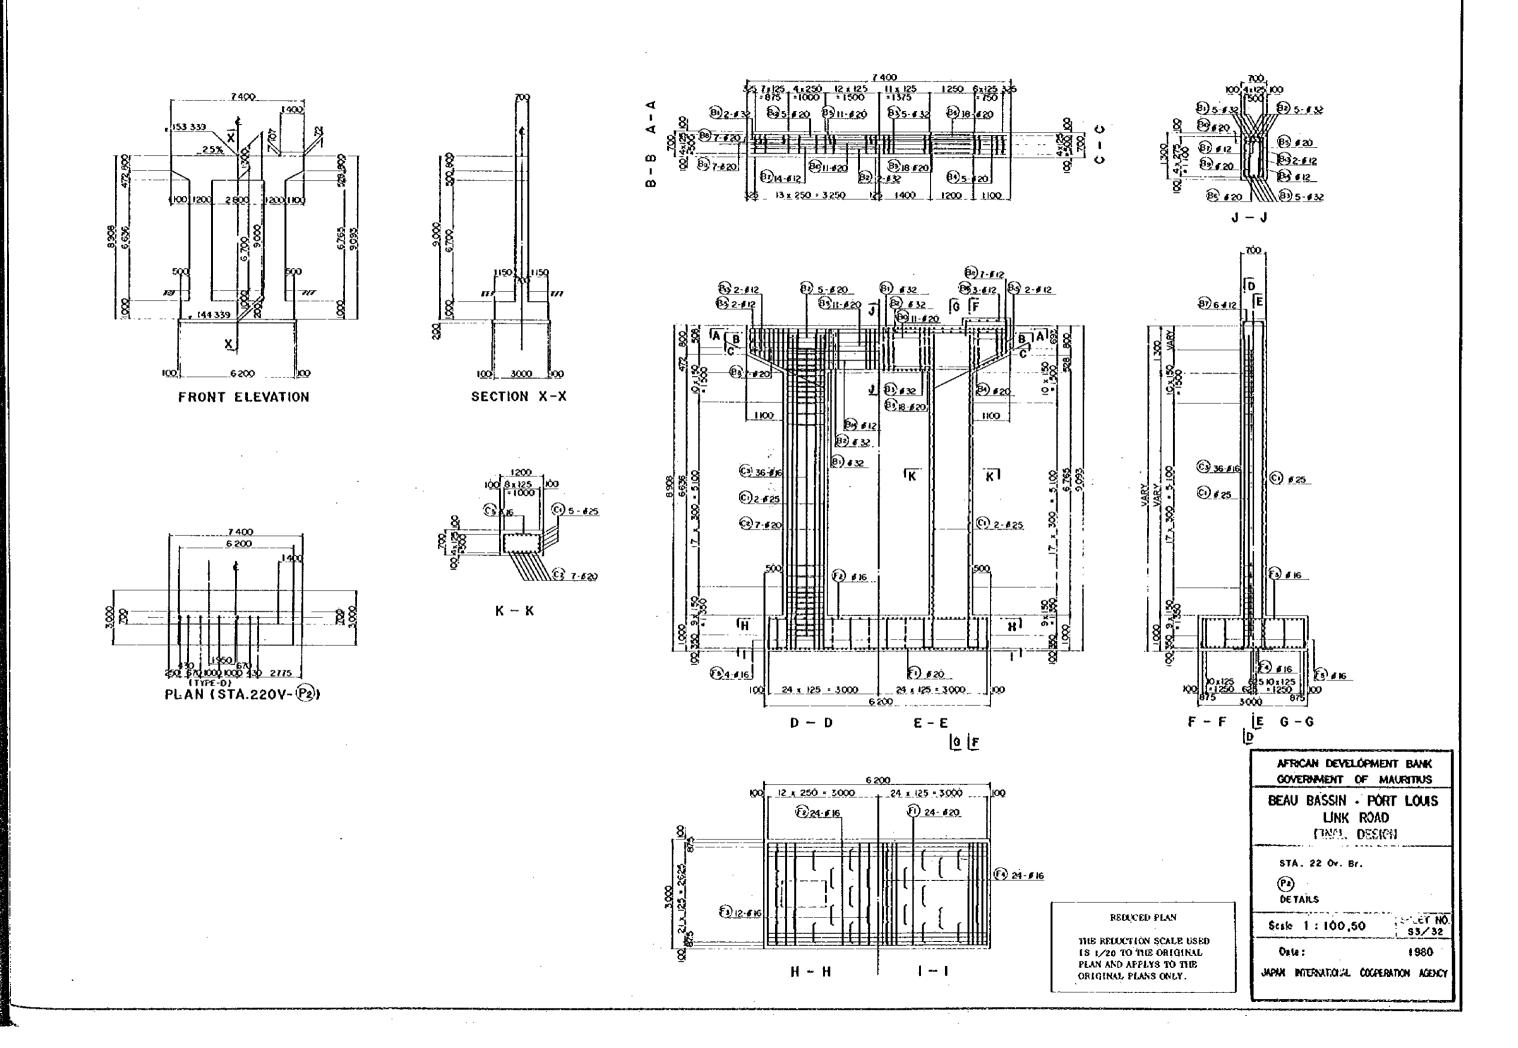

PEDESTRIAN BRIDGES

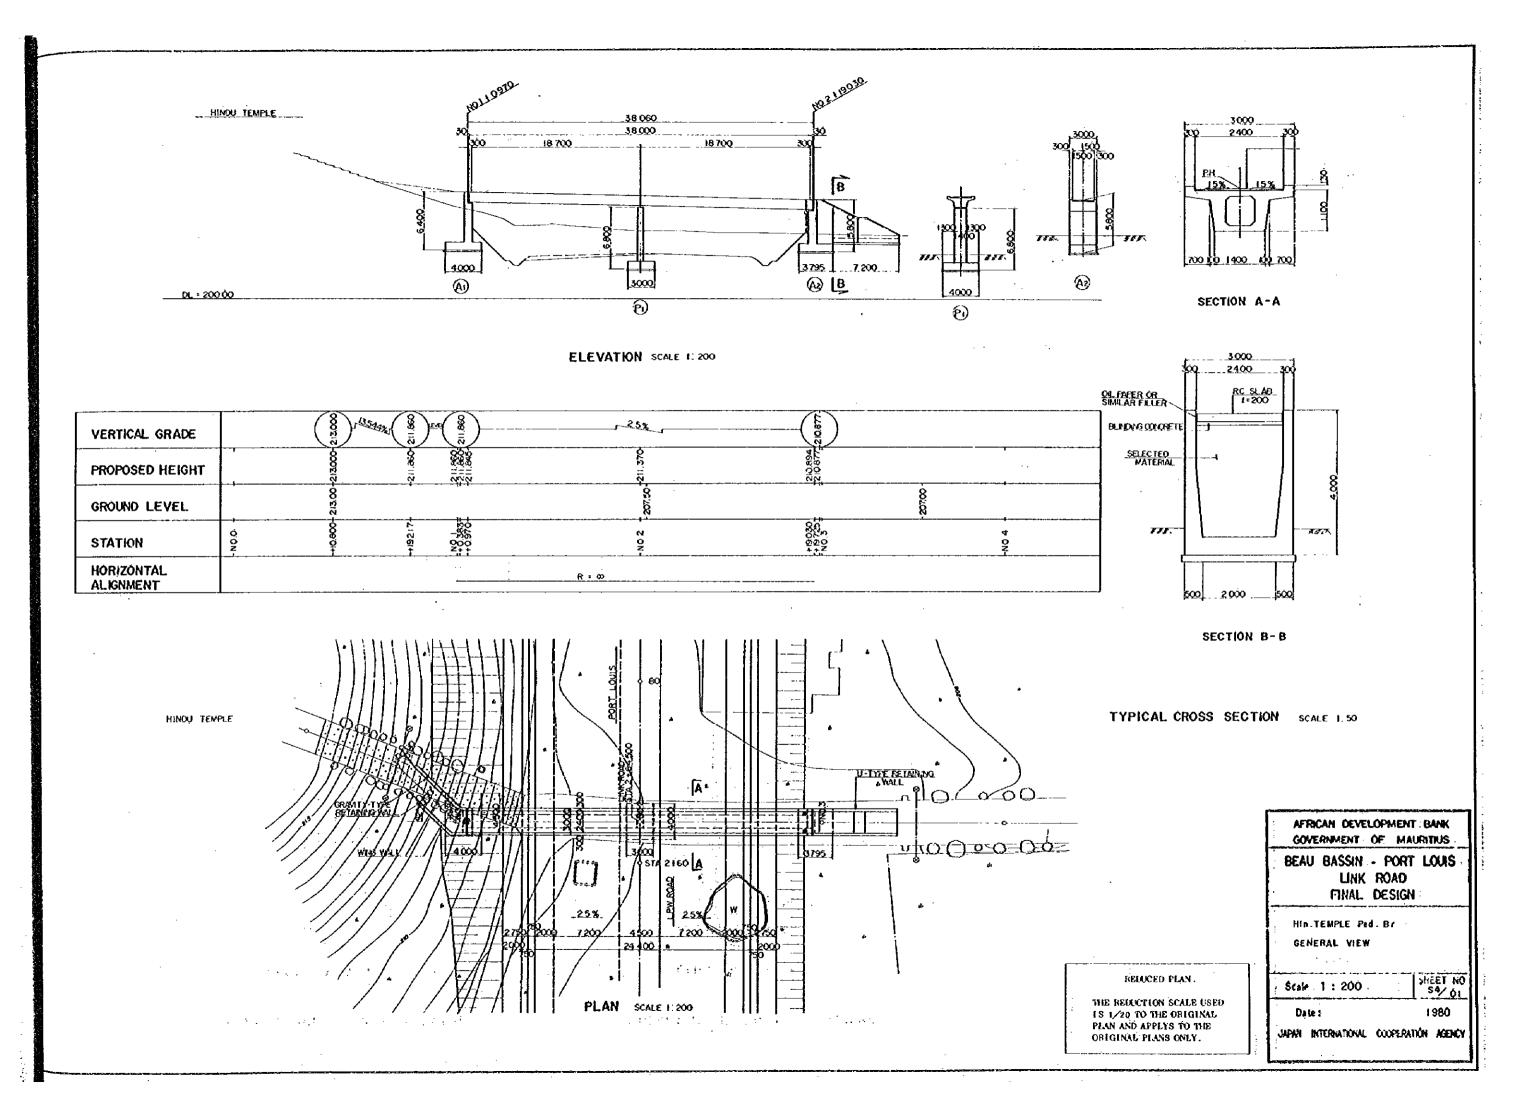


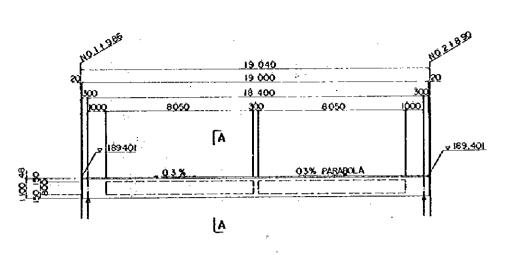


v 210.894 211.846

ELEVATION SCALE 1: 100


ELEVATION SCALE 1:100

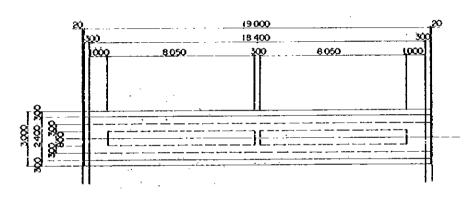

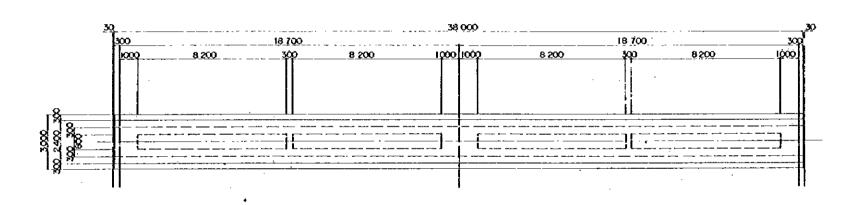


PLAN SCALE 1, 100

PLAN SCALE 1:100

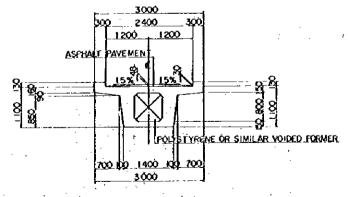

SECTIONE A-A SCALE 1:50

BEAU BASSIN PEDESTRIAN BRIDGE

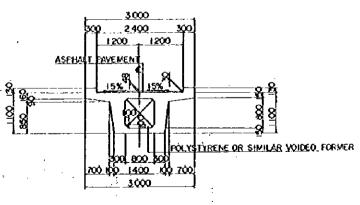

SECTION B-B SCALE 1:50

HINDU TEMPLE PEDESTRIAN BRIDGE

AFRICAN DEVELOPMENT BANK GOVERNMENT OF MAURITIUS BEAU BASSIN - PORT LOUIS

LINK ROAD FINAL DESIGN

Hin. TEMPLE Ped, Br. VOIDED BEAM OIMENSIONS

Scale 1 : 100 , 50

REDUCED PLAN

THE REDUCTION SCALE USED

13 1/20 TO THE ORIGINAL


PLAN AND APPLYS TO THE

ORIGINAL PLANS ONLY.


1980


JAPAN INTERNATIONAL COOPERATION AGENCY


A SECTION OF STREET

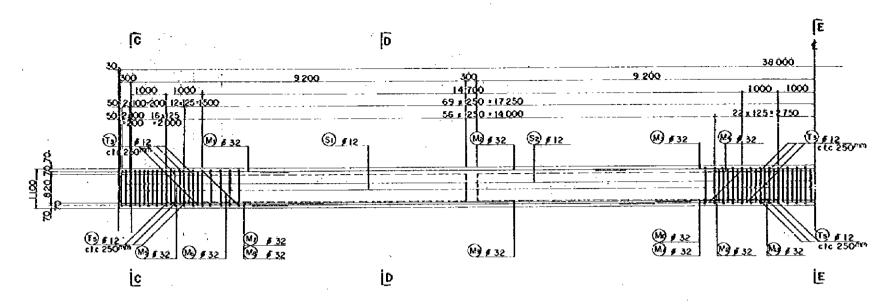


REINFORCEMENT ELEVATION SCALE 1:50

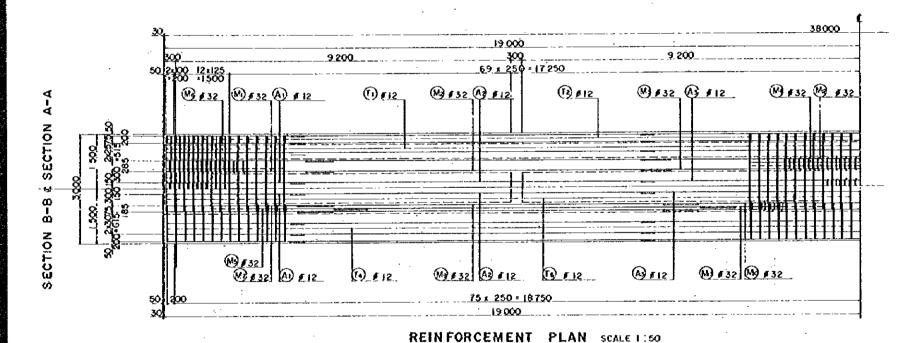

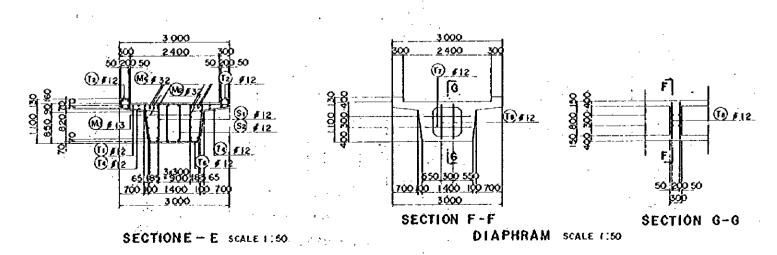

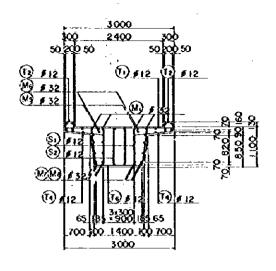

SECTION C-C SCALE 1:50

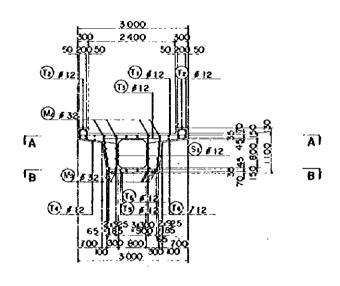



SECTION D-D SCALE 1:50


RELUCED PLAN


THE REDUCTION SCALE USED IS 1/20 TO THE ORIGINAL PLAN AND APPLYS TO THE


ORIGINAL PLANS ONLY.

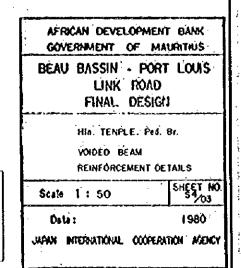


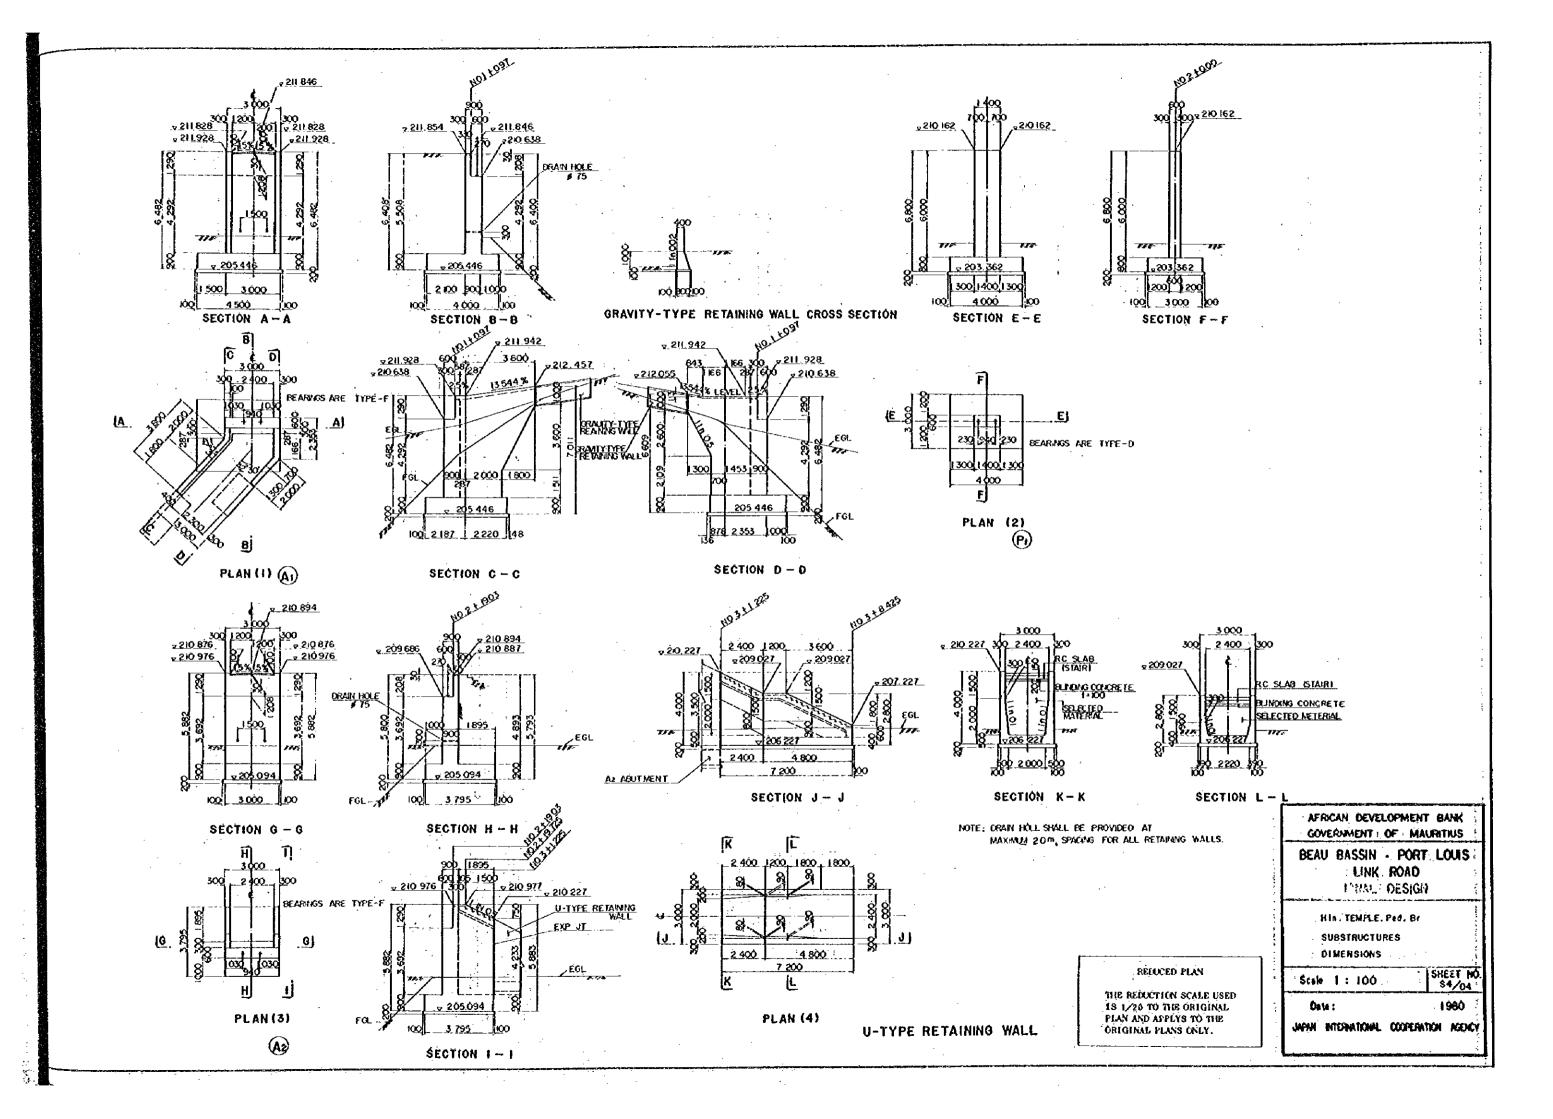

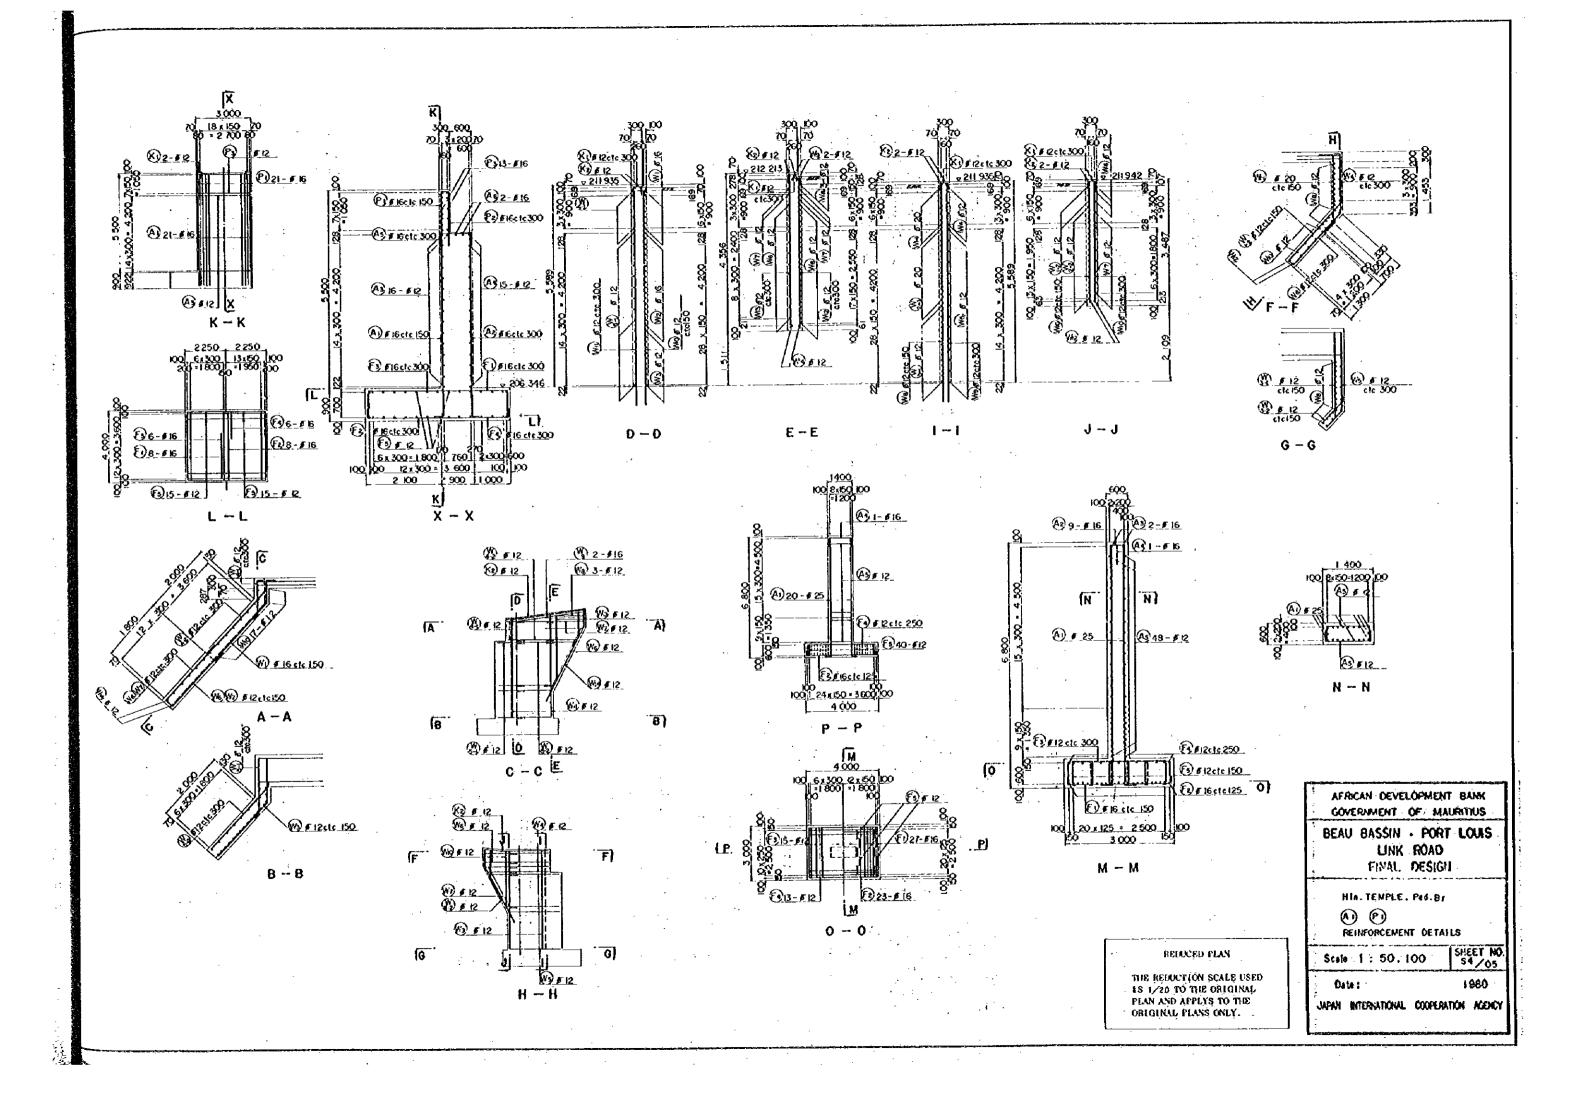


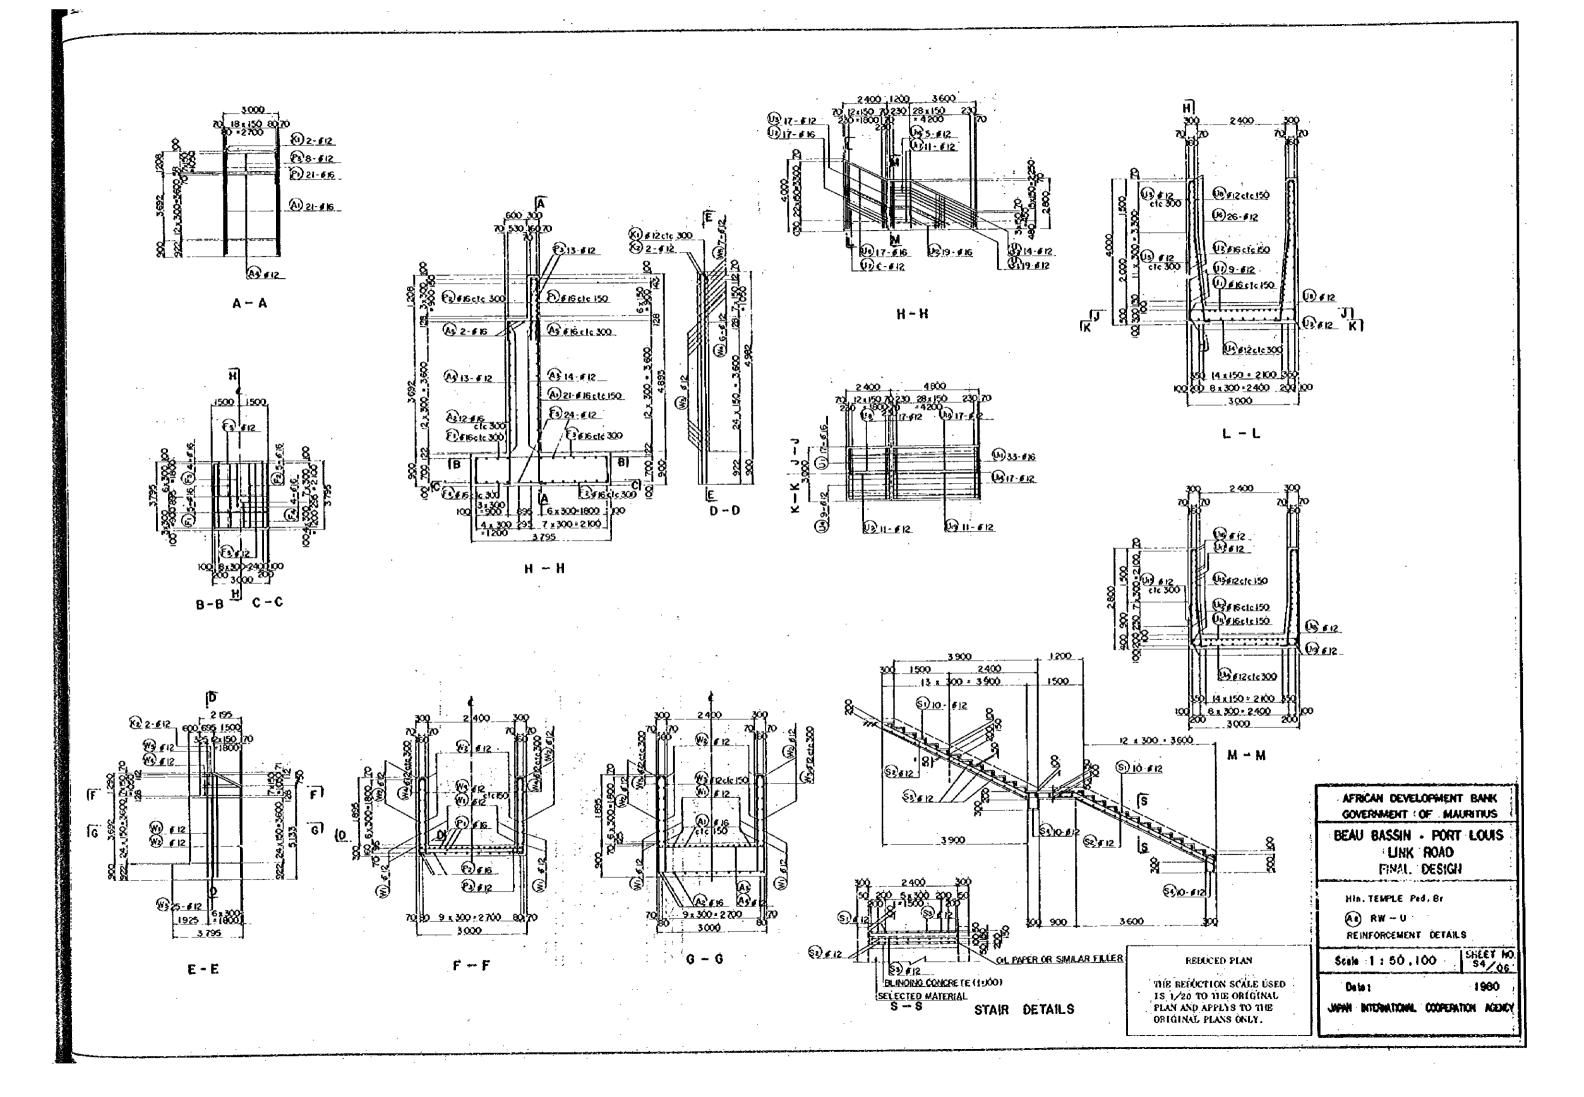


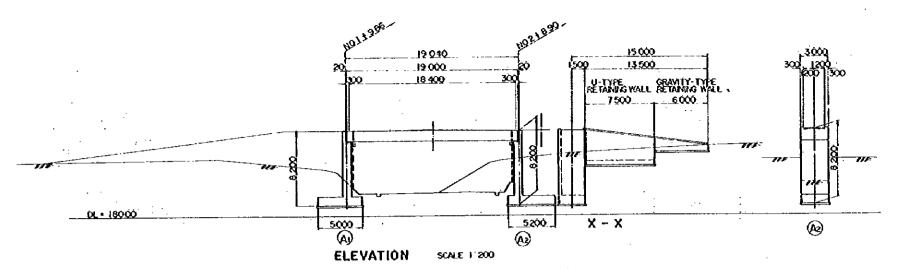

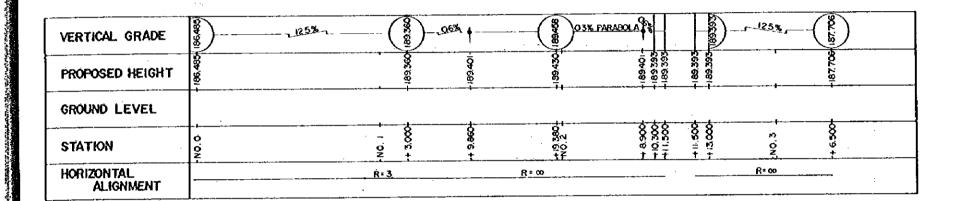


 $\mathcal{L}^{\mathcal{A}_{G,G}}(\mathcal{B}_{G}^{\mathcal{A}_{G}})$

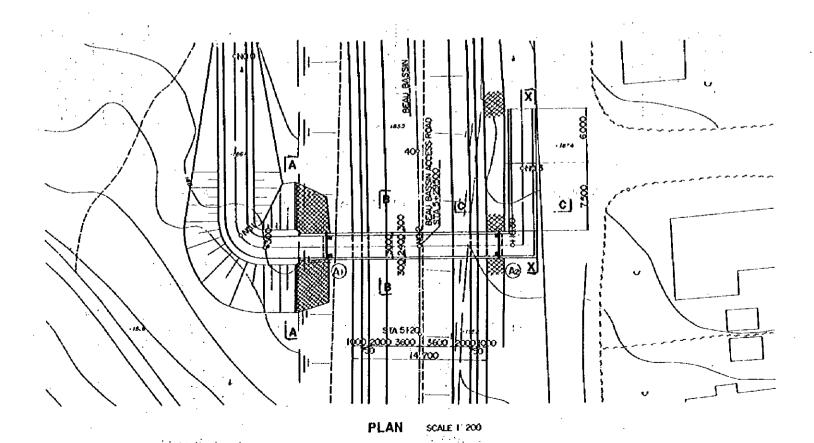


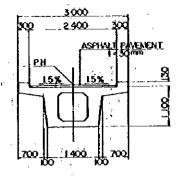

SECTION B-B

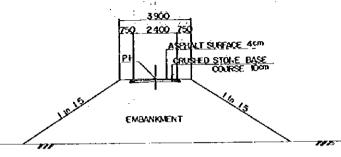

SECTION A-A

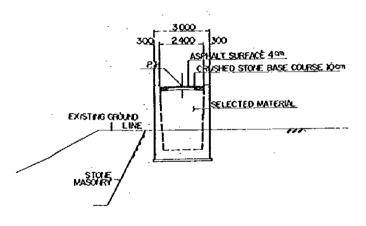

SECTION C-C

TYPICAL CROSS SECTION SCALE 1:00


REDUCED PLAN


THE REDUCTION SCALE USED
18 1/20 TO THE ORIGINAL

PLAN AND APPLYS TO THE


ORIGINAL PLANS ONLY.

AFRICAN DEVELOPMENT GOVERNMENT OF MAL	
BEAU BASSIN - PORT	LOU
LINK ROAD	
FINAL DESIGN	
B. B. Ped . Br GENERAL VIEW	
	٠.
Stale 1 : 200, 100, 150	SHEET S4/
Dete:	1980
JAPAN INTERNATIONAL COOPERAT	

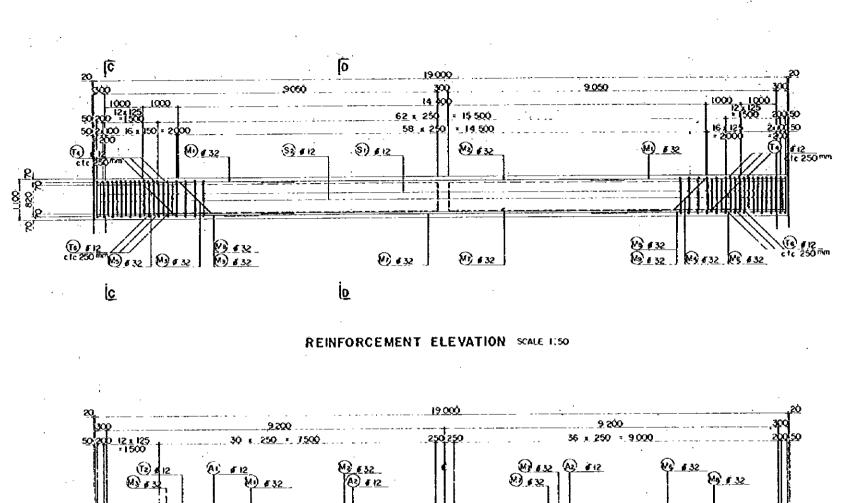


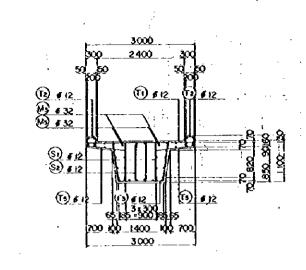


SECTION C-C SCALE 1150

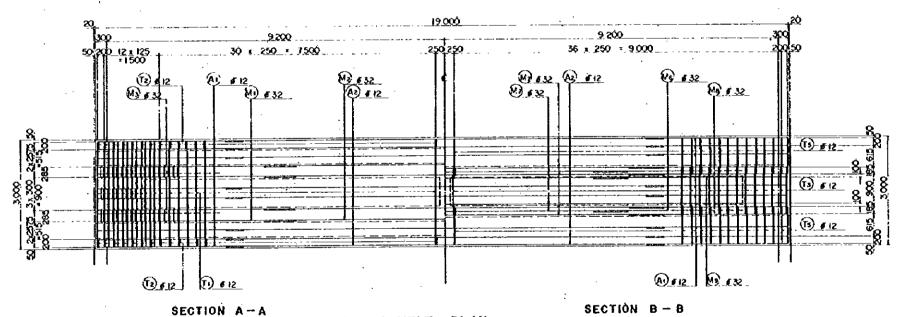

REINFORCEMENT PLAN SCALE 1:50

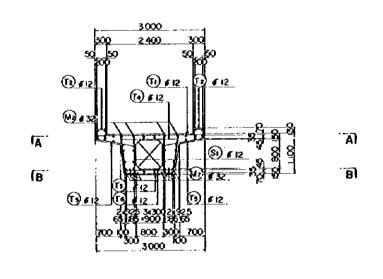

SECTION D-D SCALE 1:50

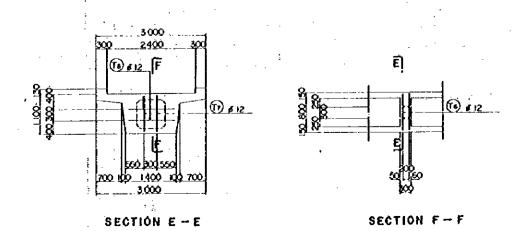

DIAPHRAM SCALE 1:50

NOTE, FOR DIMENSIONS, REFER TO DWG \$4/02


REDUCED PLAN
THE REPUCTION SCALE USED
IS 1/20 TO THE ORIGINAL
PLAN AND APPLYS TO THE
ORIGINAL PLANS ONLY.


AFRICAN DEVELOPMENT BANK:
GOVERNMENT OF MAURITHUS:
BEAU BASSIN + PORT LOUIS
LINK ROAD
FINAL DESIGN


B. B. P. B.
VOIDED BEAM
REINFORCEMENT CETAILS

Scale 1:50
SHEET NO.
\$4/68

Date: 1980

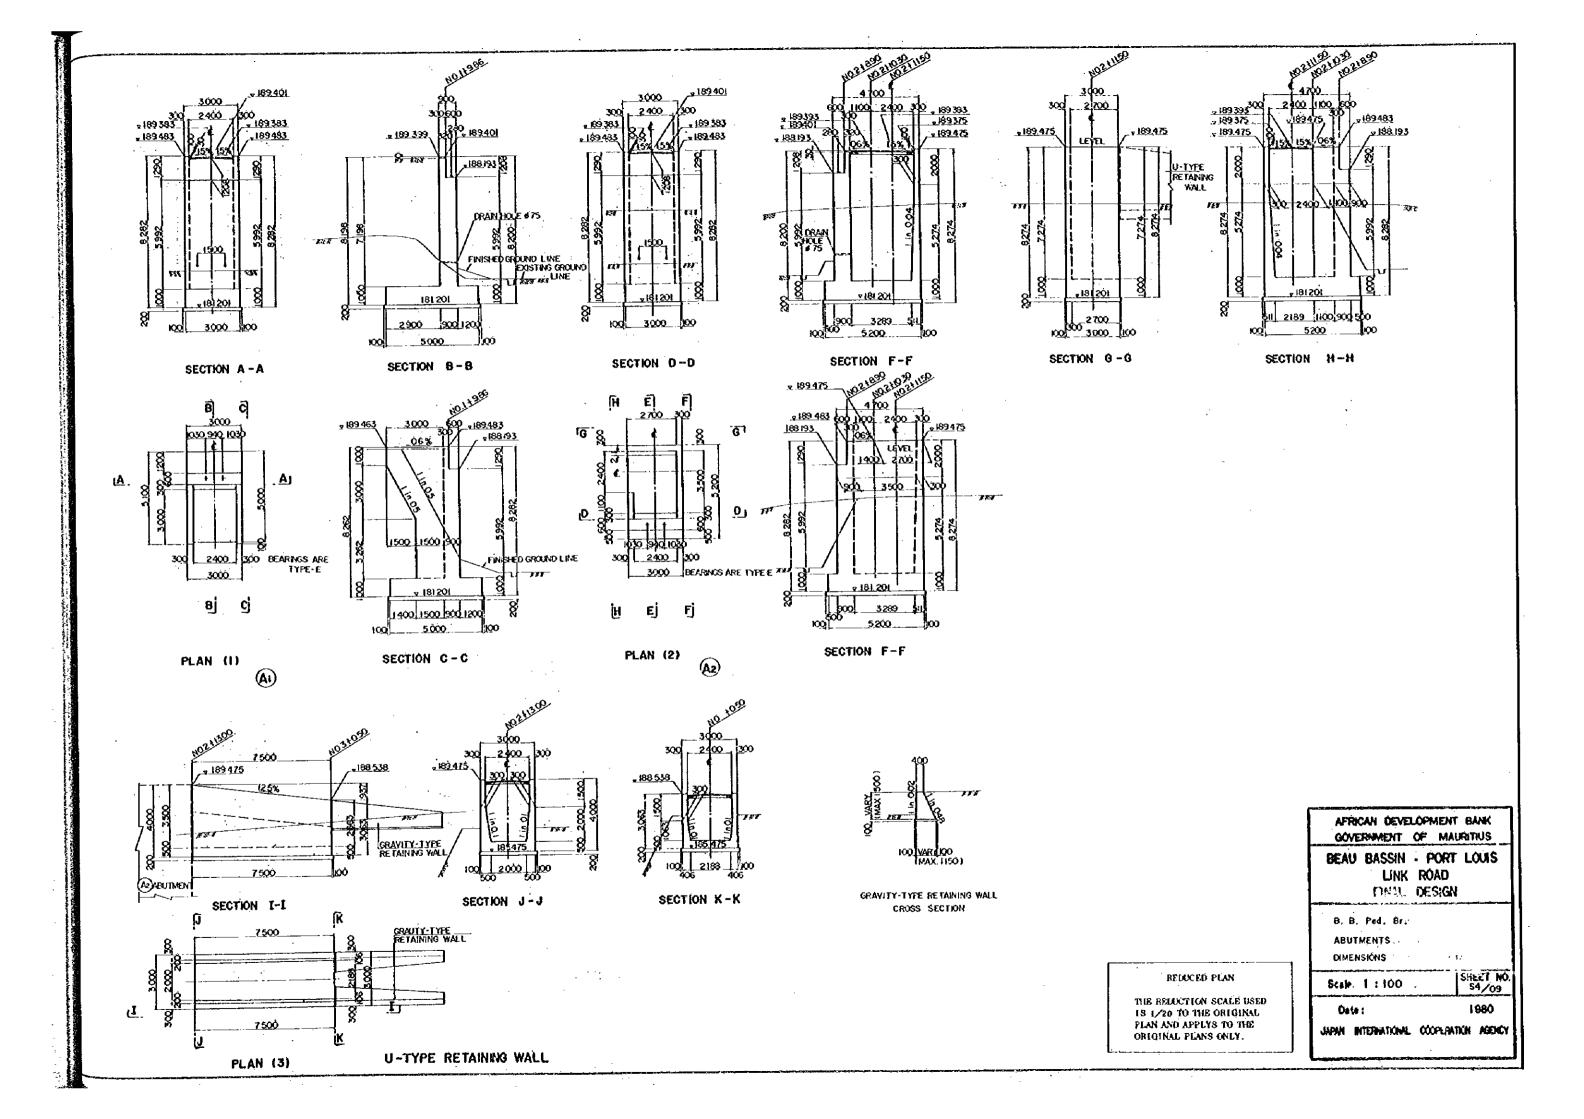

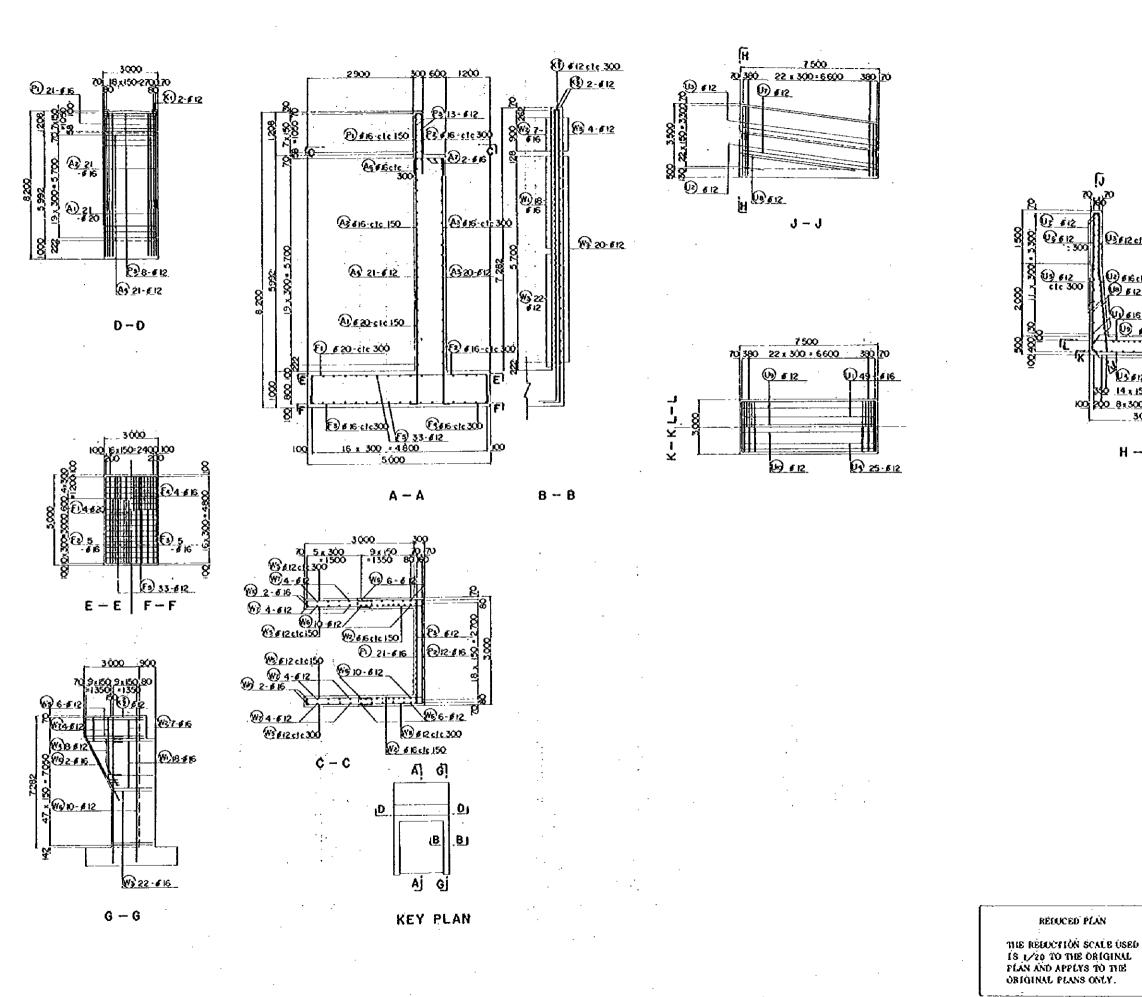

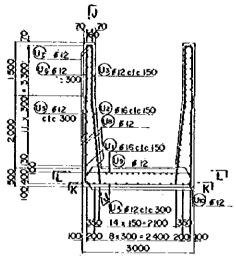

H - H

RESUCED PLAN

AFRICAN DEVELOPMENT BANK GOVERNMENT OF MAURITHUS

BEAU BASSIN - PORT LOUIS LINK ROAD' FINAL DESIGN


> B. B. Ped. Br. (A) RW-U PEINFORCEMENT DETAILS

Scale 1:100.50


Date:


1980


JAPAN INTERNATIONAL COOPERATION AGENCY

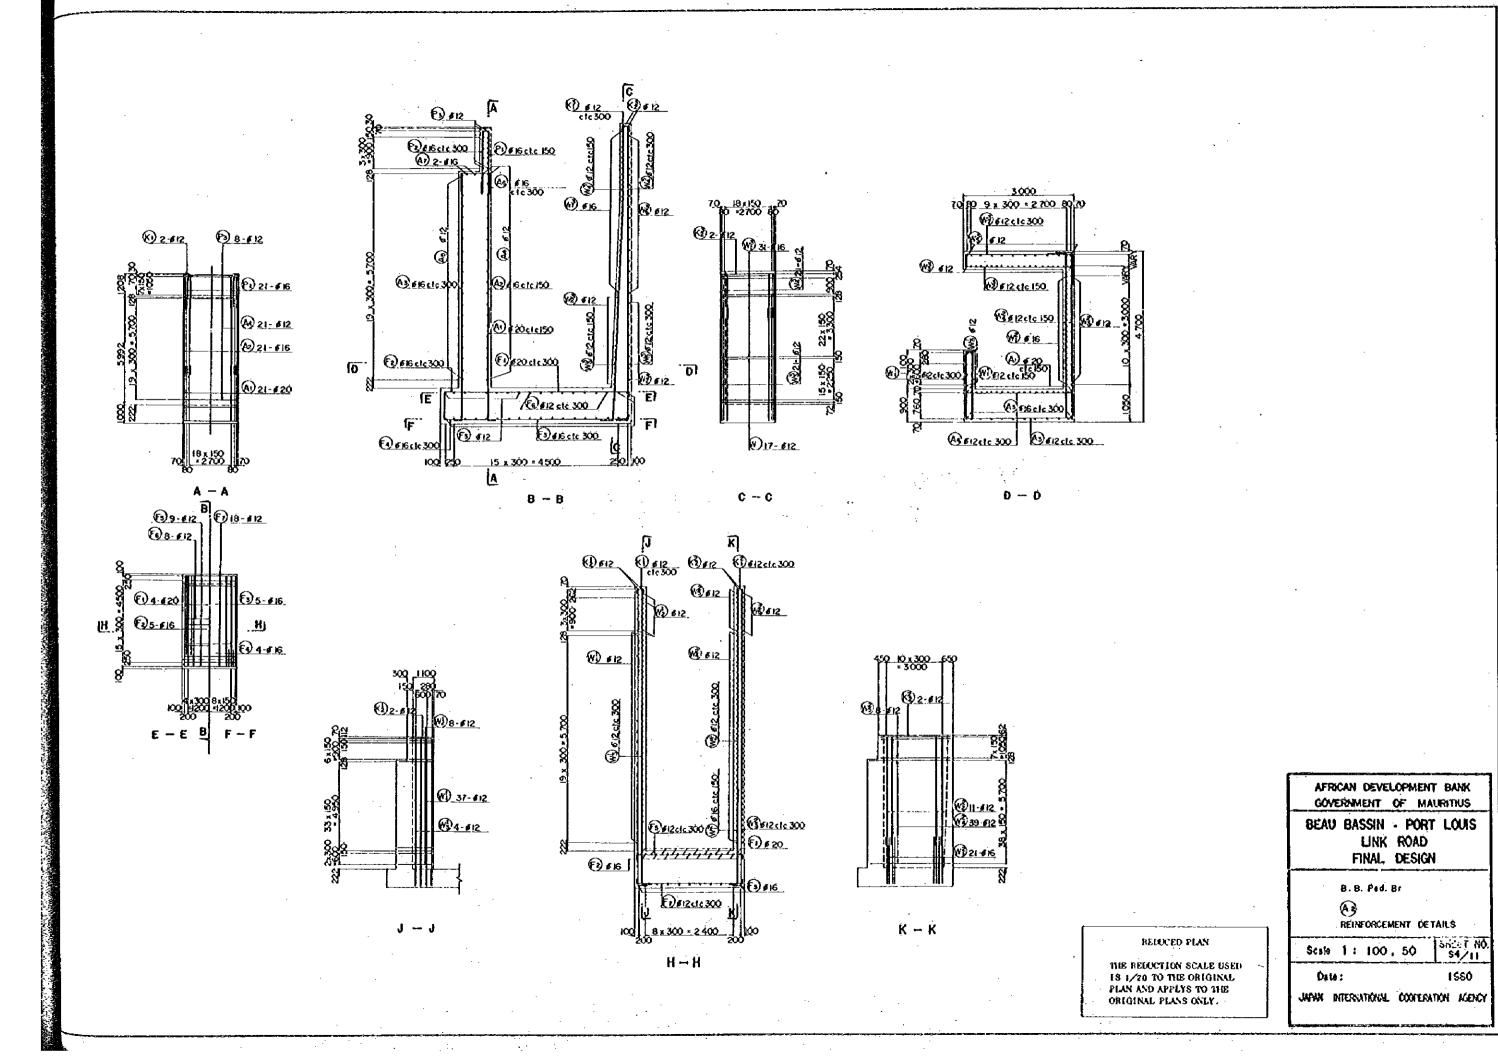


AQUEDUCT

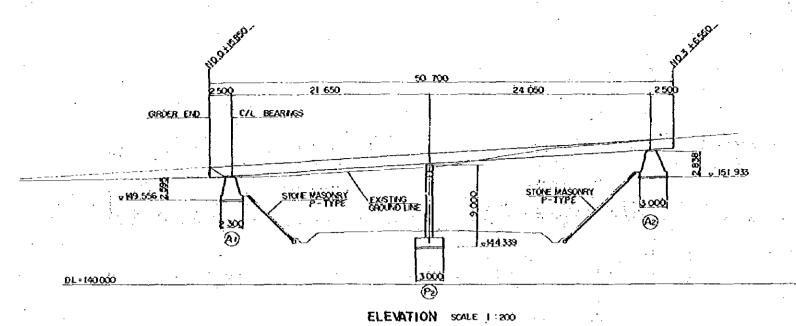

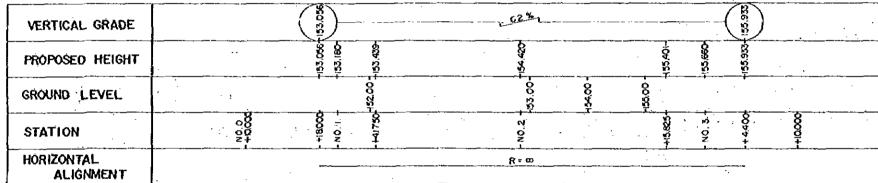

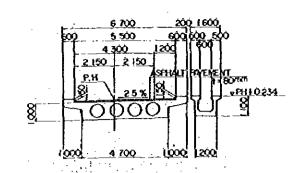


SECTION 8-8

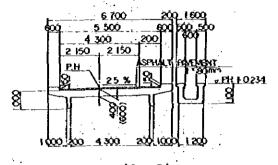


SECTION A-A

TYPICAL CROSS SECTION SCALE 1.100

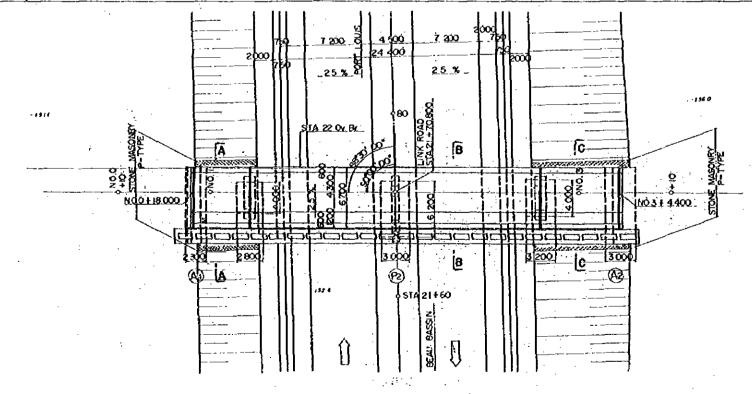

PLAN SCALE 1: 200

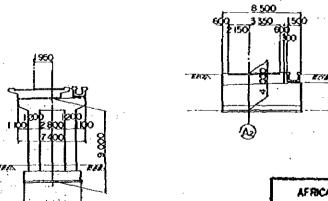

NOTE, FOR PIERS AND ABUTMENTS. REFER TO DWG 53/30; 53/32

(P3)

DL - 140 000

RELOCED PLAN

THE REJUCTION SCALE USED 13 1/20 TO THE ORIGINAL PLAN AND APPLYS TO THE ORIGINAL PLANS ONLY. AFRICAN DEVELOPMENT BANK COVERNMENT OF MAURITIUS

BEAU BASSIN - PORT LOUIS LINK ROAD FINAL DESIGN

STA.22 AQUEOUCT GENERAL VIEW


i. : ·


Scale 1: 200, 100 | SHEET NO. 55/01


ė:


MANN INTERNATIONAL COOPLEATION AGENCY


1980

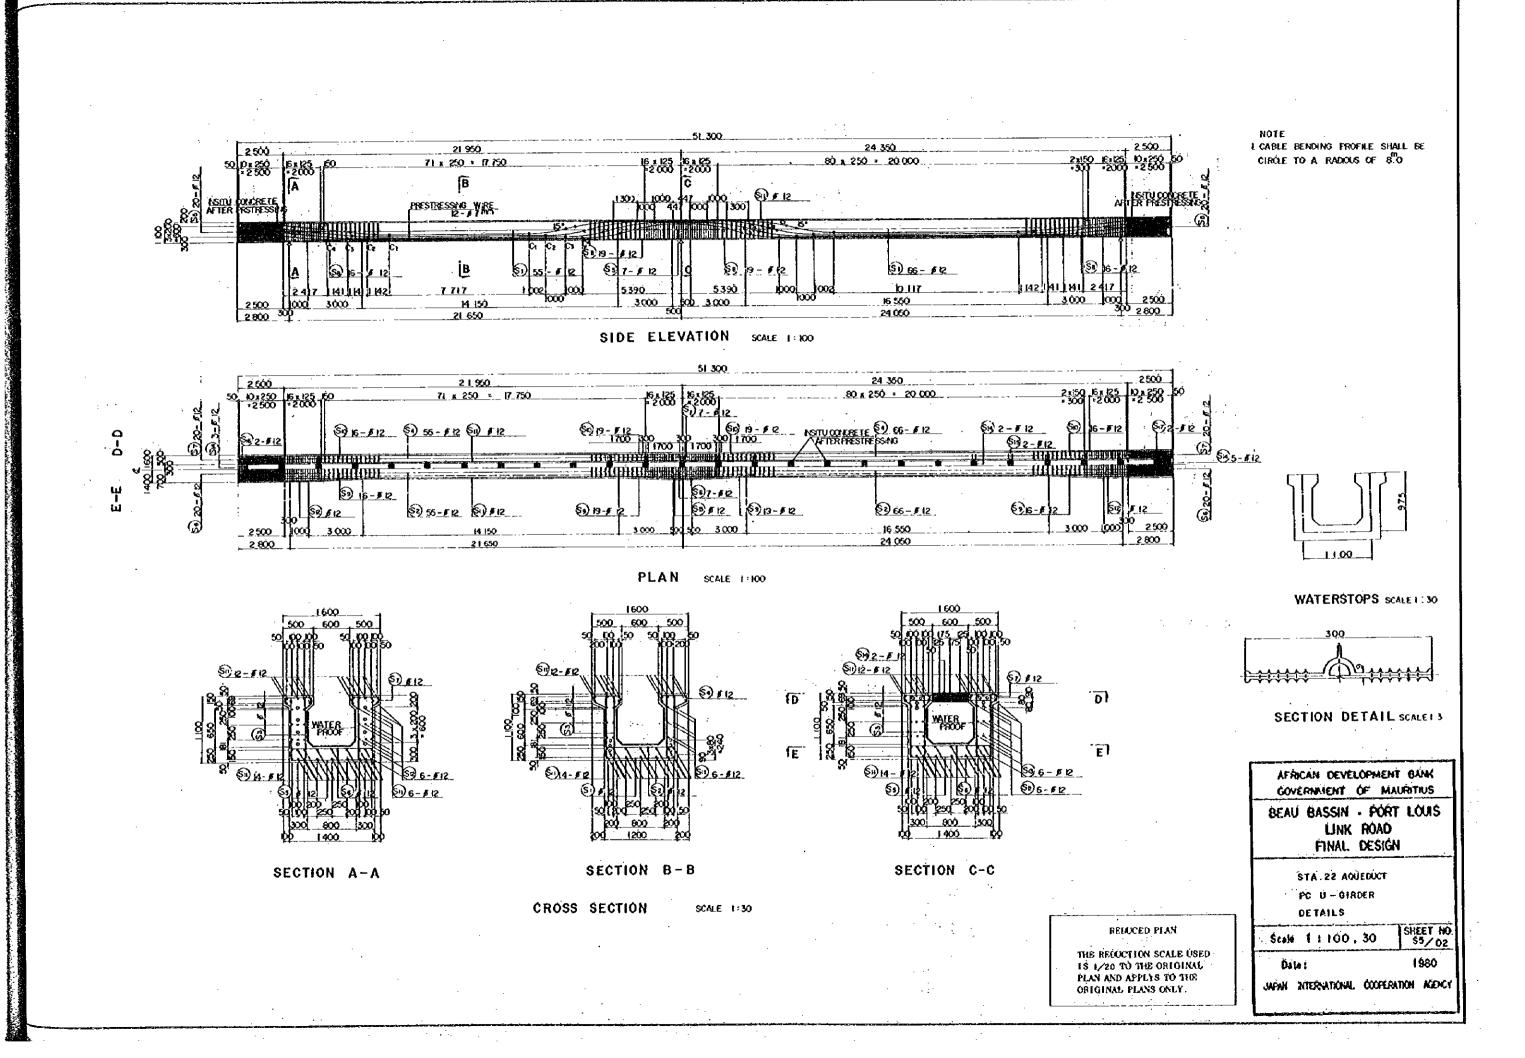


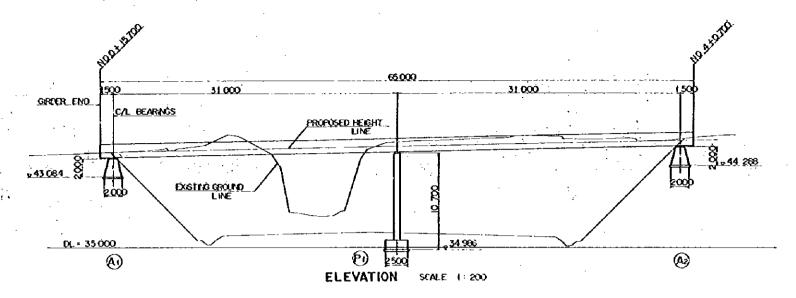


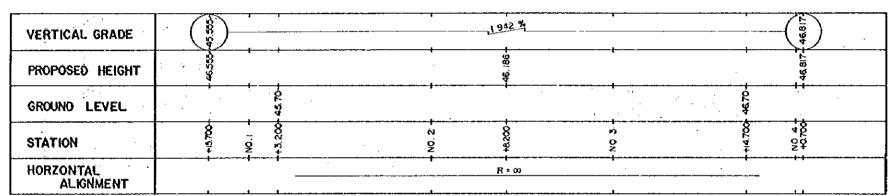

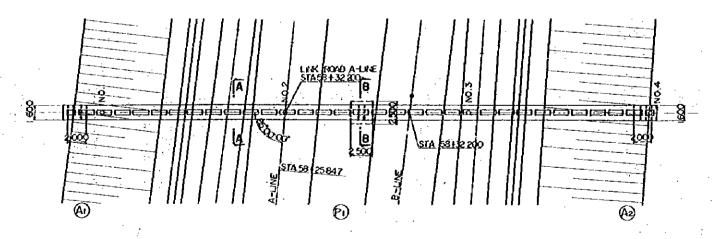

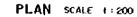

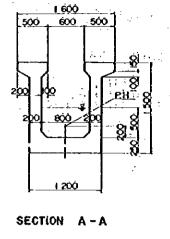

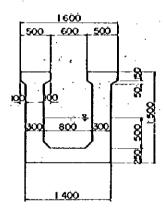

SECTION B-B

TYPICAL CROSS SECTION SCALE 1:30

RELUCED PLAN

THE REDUCTION SCALE USED 18 1/20 TO THE ORIGINAL PLAN AND APPLYS TO THE ORIGINAL PLANS ONLY.

AFRICAN DEVELOPMENT BANK
GOVERNMENT OF MAURITHUS
BEAU BASSIN - PORT LOUIS
LINK ROAD
FINAL DESIGN

STA 57 AQUEDUCT
GENERAL VIEW

SCALE 1: 200, 30 SHEET HO.
S5/03

Onto: 1980

JAPAN INTERNATIONAL COOPERATION ACCRET

