



PROJECT	SHEET NO.	TOTAL SHEET
BELURU / LONG LAMA / LIMBANG TRUNK ROAD CONSTRUCTION PROJECT	38	54
PLAN AND PROFILE	SCALE	H = 1 : 20,000 V = 1 : 2,000


PLAN

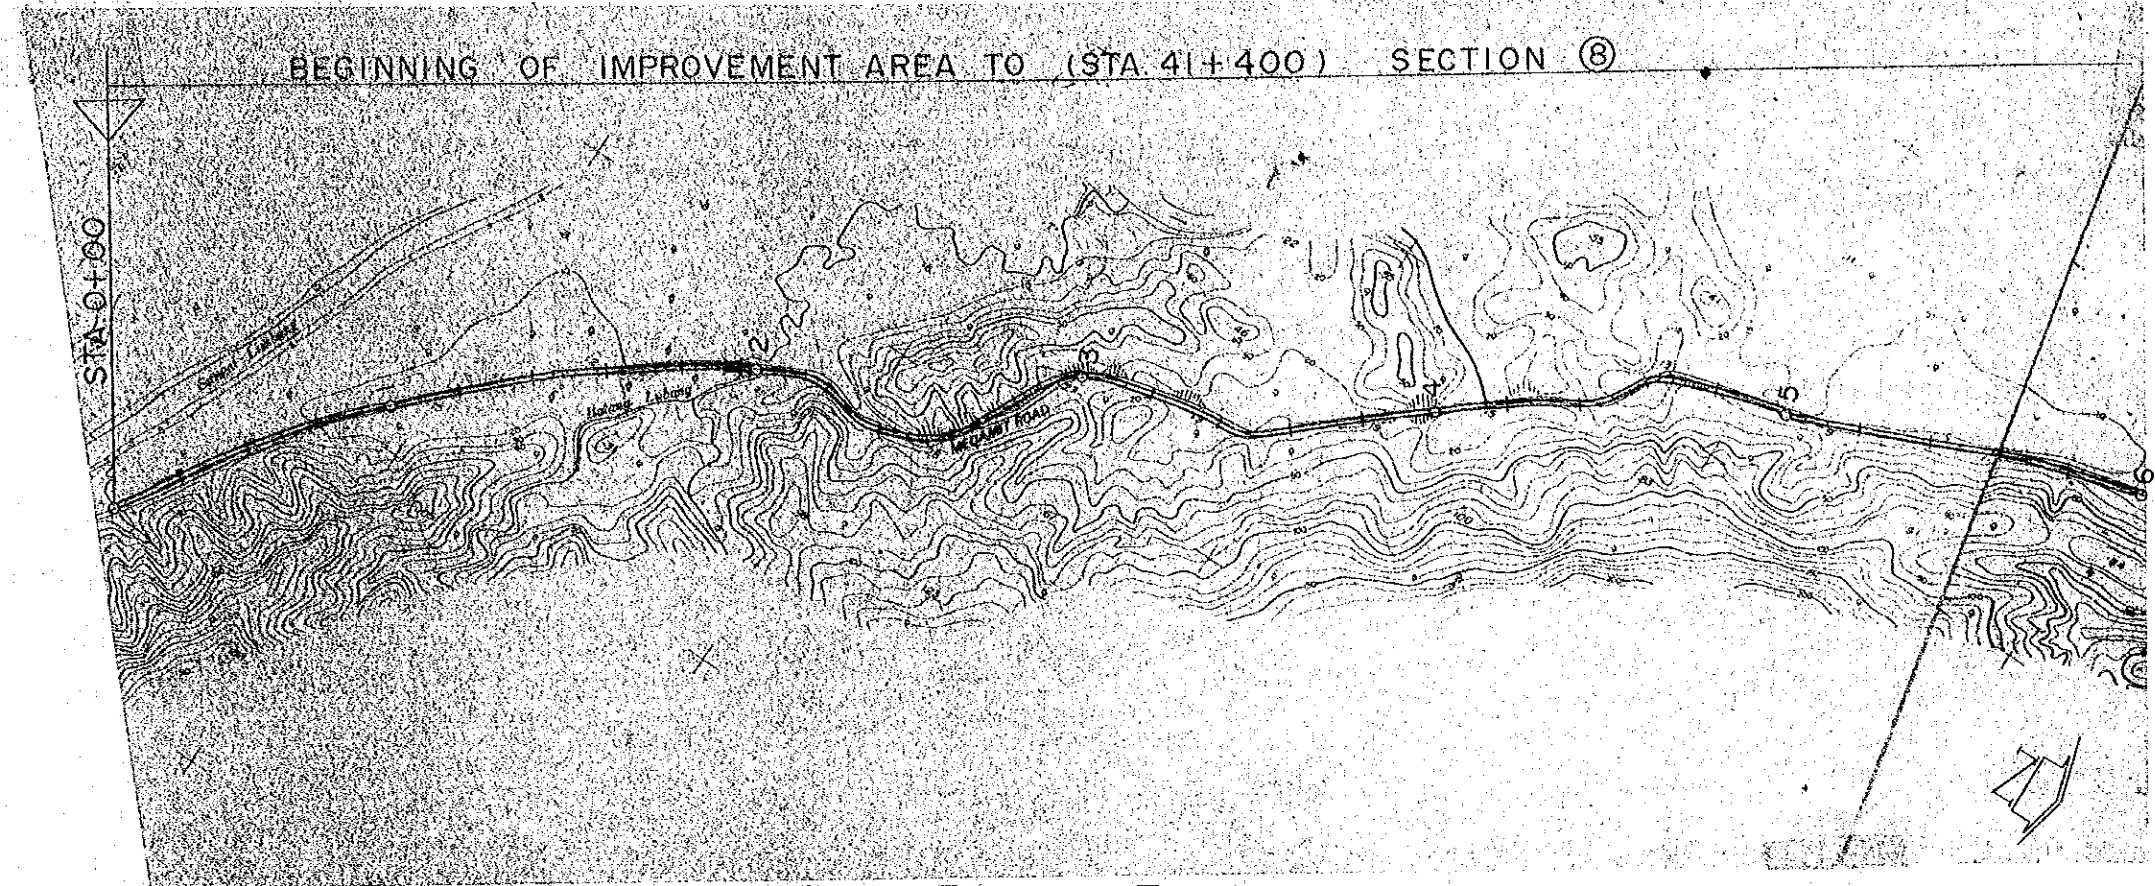


KEY MAP

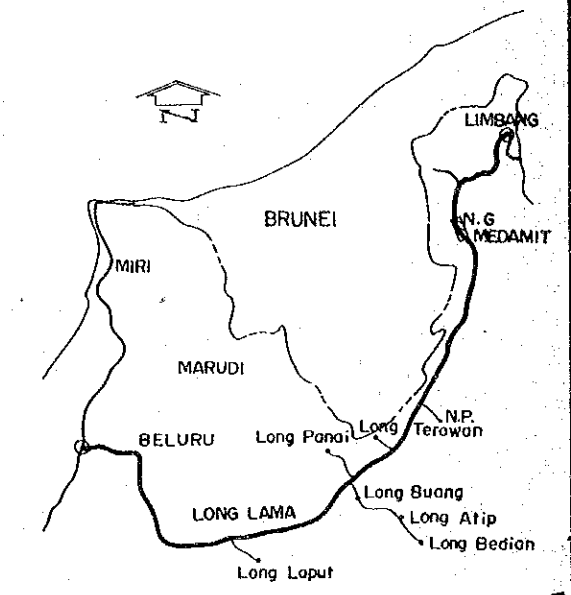


PROFILE

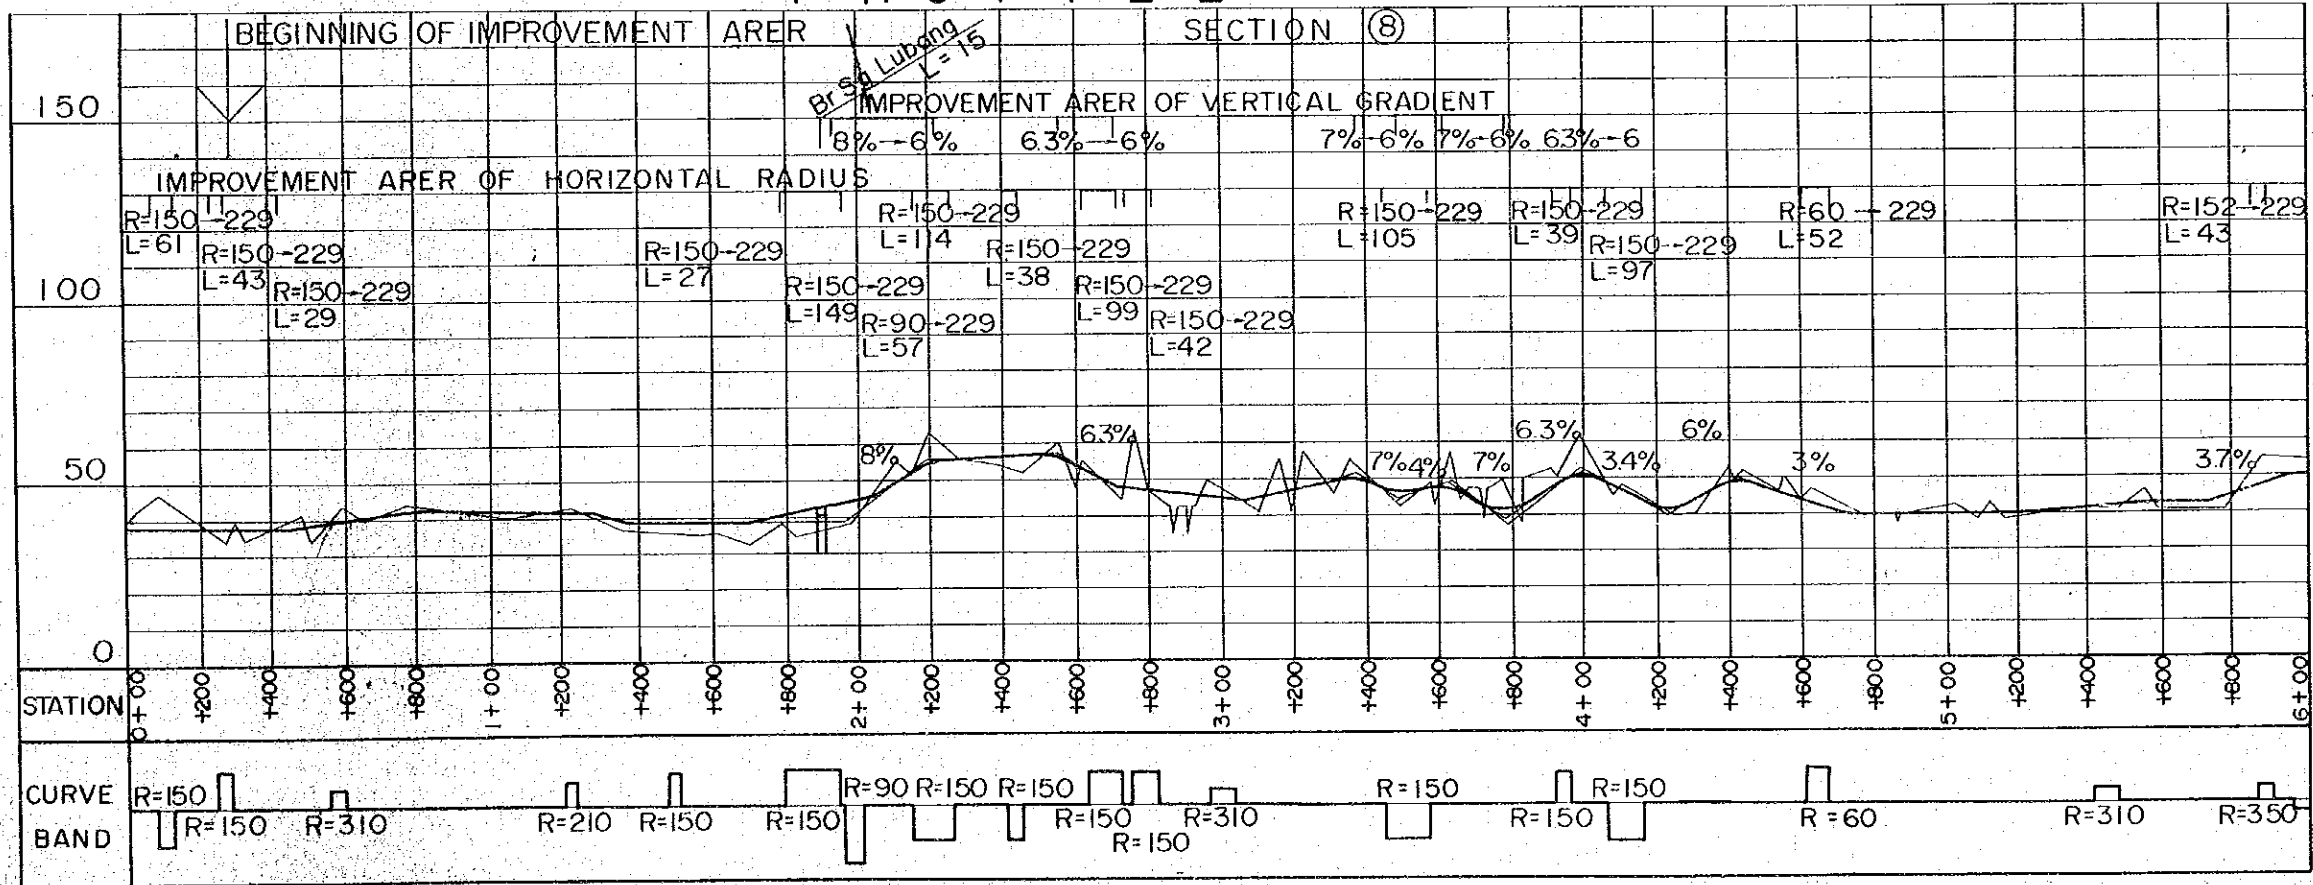

HORIZONTAL ALIGNMENT


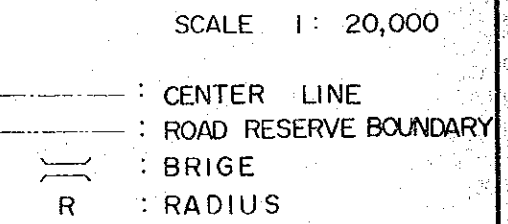


VERTICAL ALIGNMENT

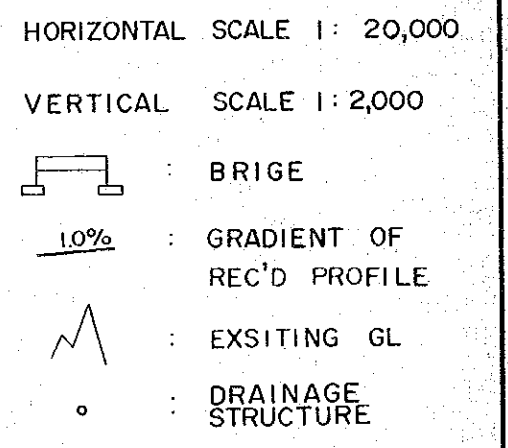


PROJECT	SHEET NO.	TOTAL SHEET
BELURU / LONG LAMA / LIMBANG TRUNK ROAD CONSTRUCTION PROJECT	39	54
PLAN AND PROFILE	SCALE	H = 1: 20,000 V = 1: 2,000

PLAN

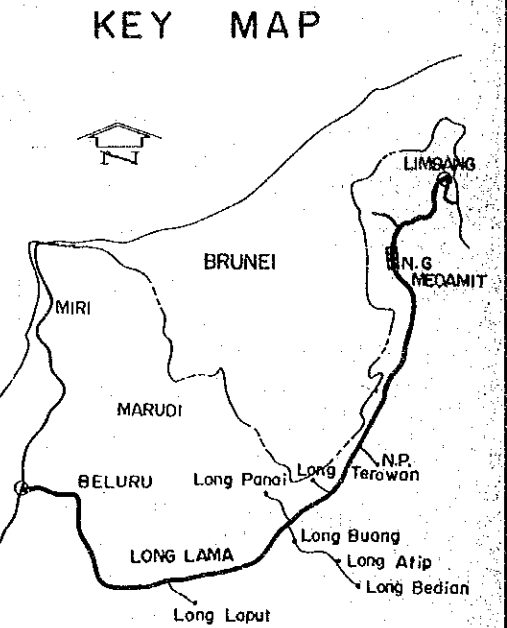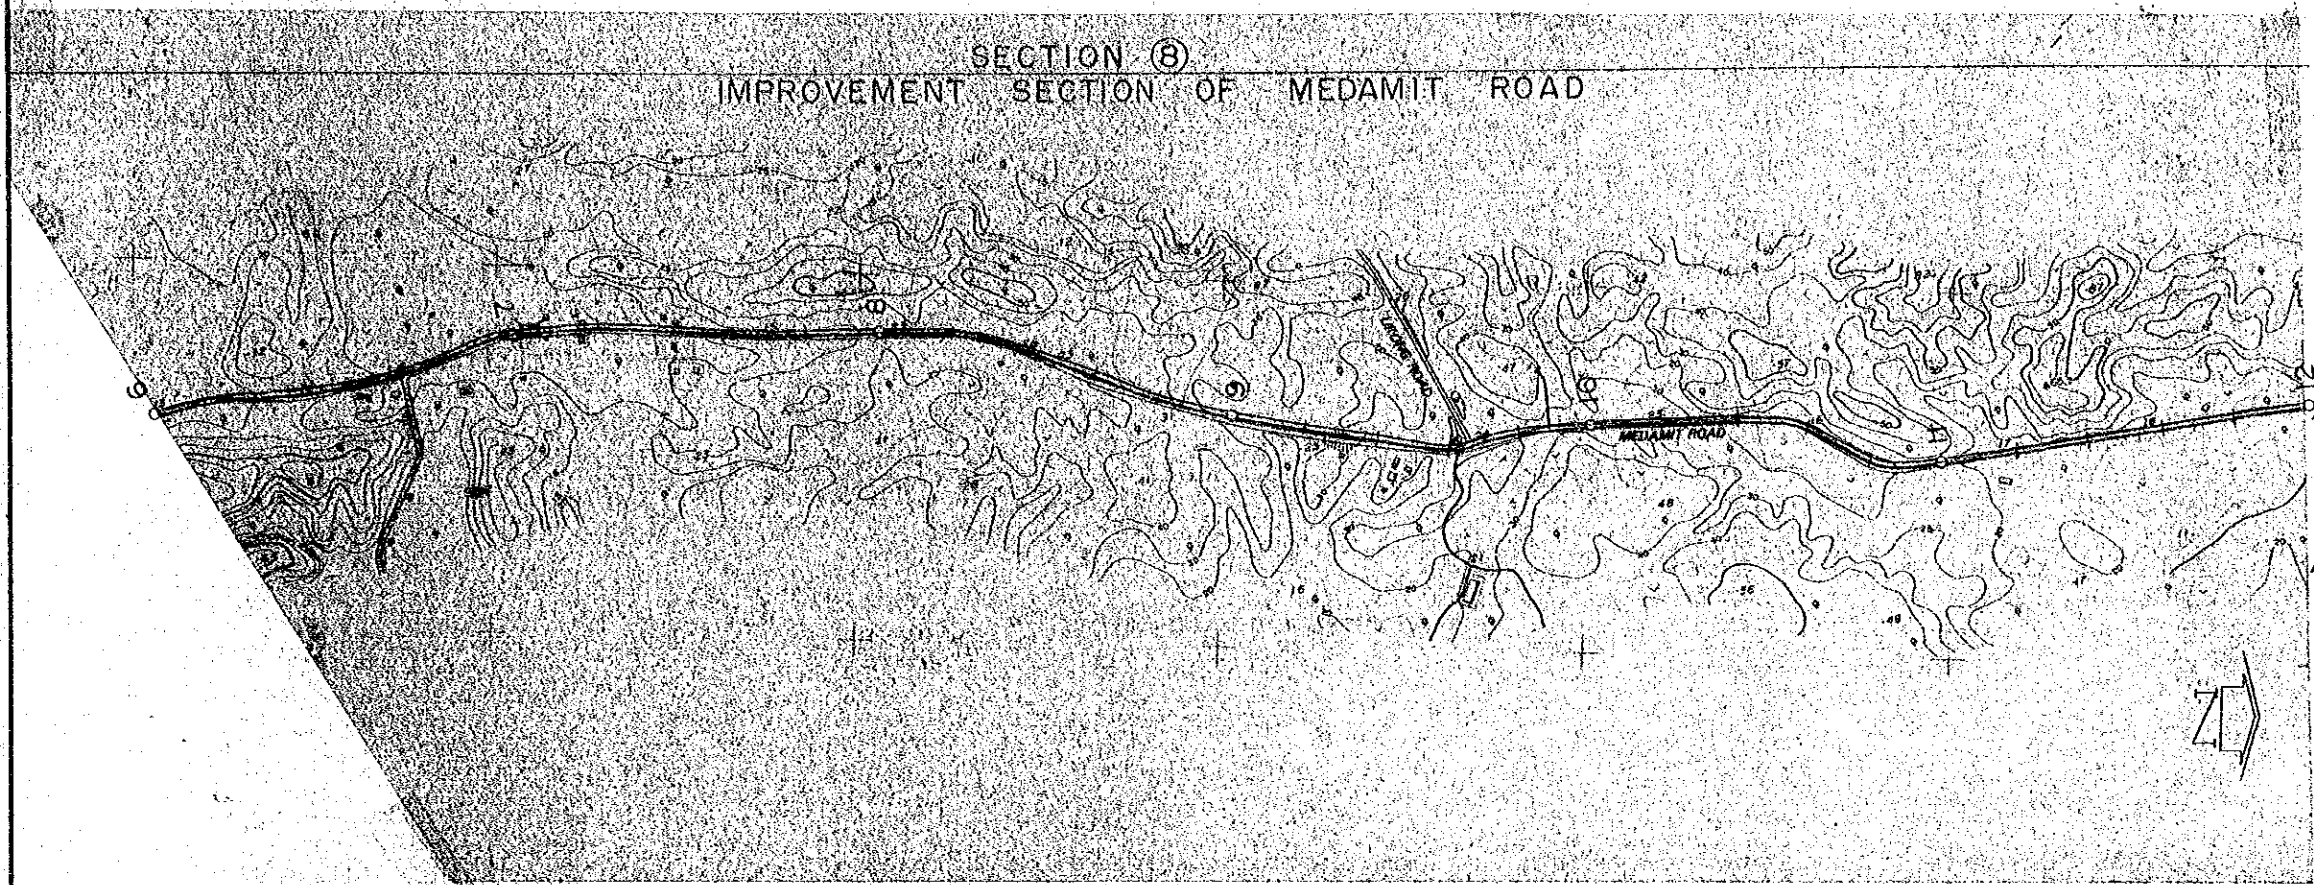

PROFILE

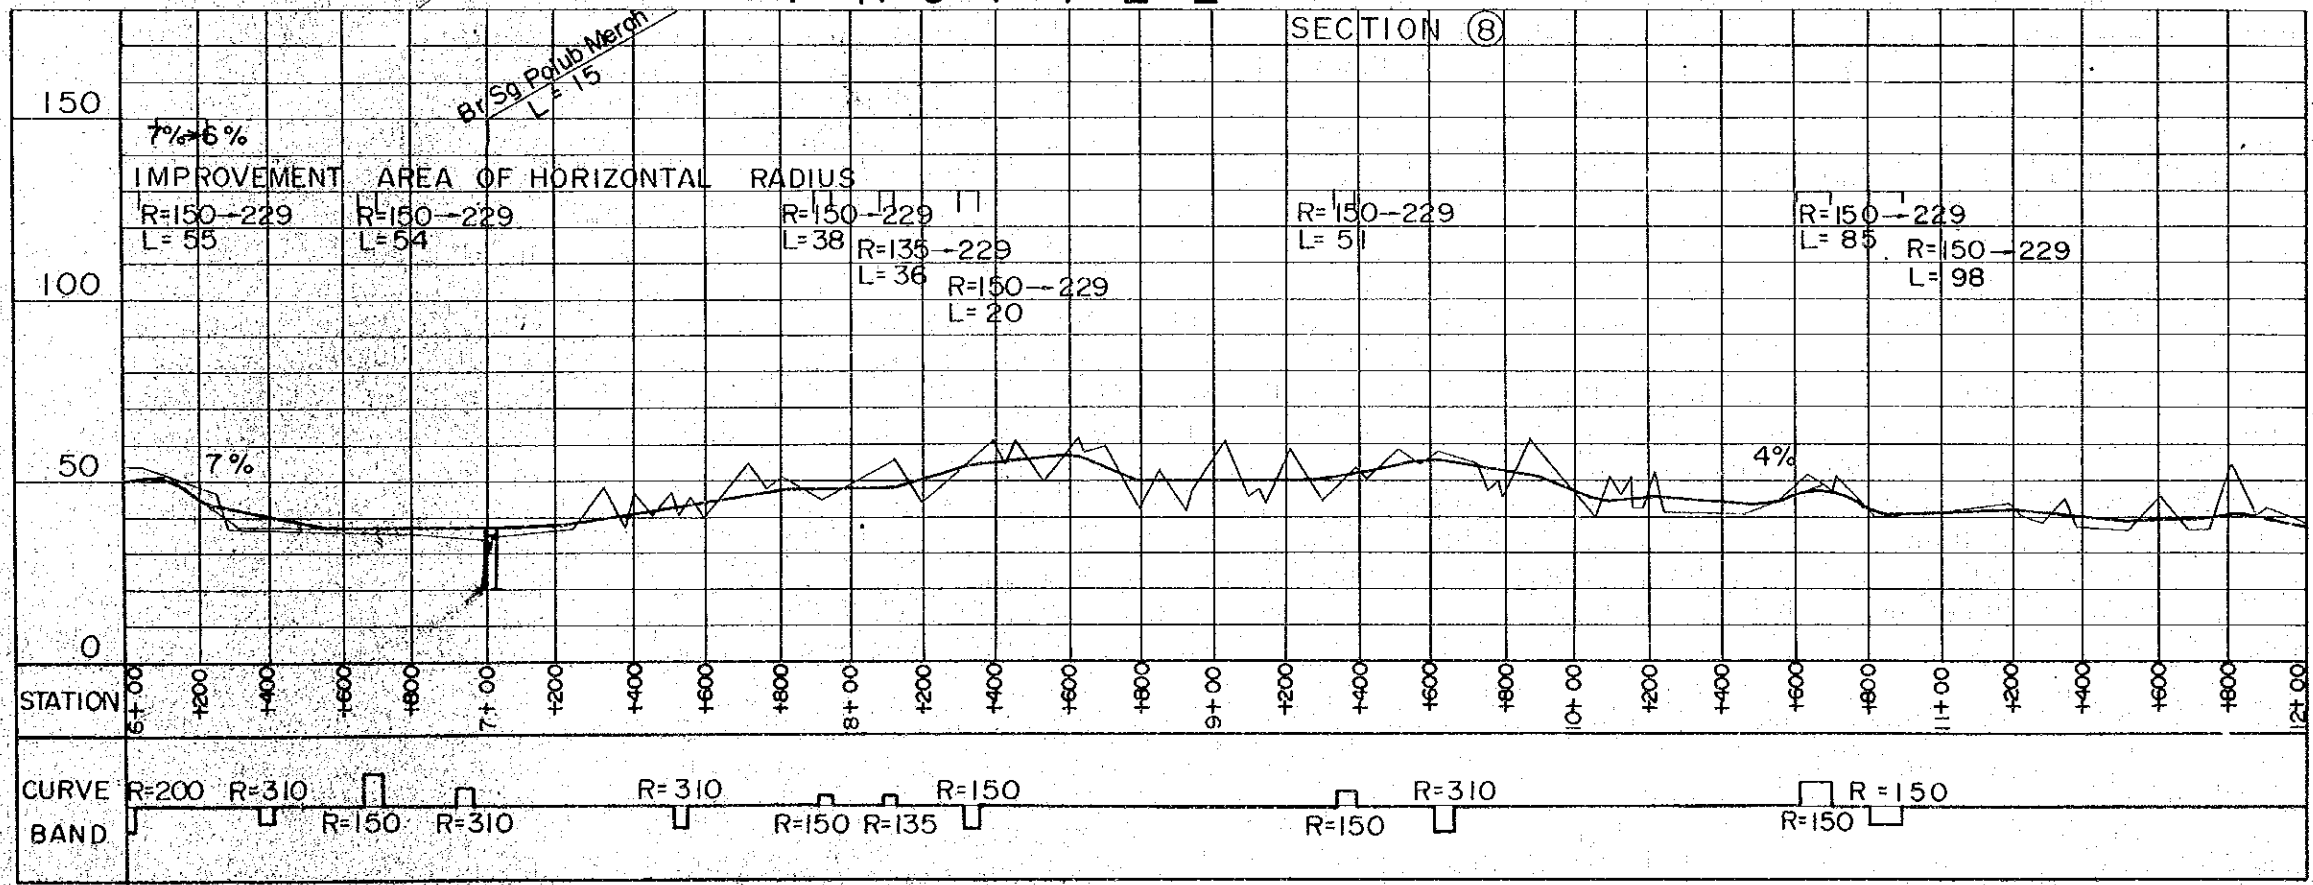

HORIZONTAL ALIGNMENT



- SCALE 1: 20,000
- : CENTER LINE
 - : ROAD RESERVE BOUNDARY
 - : BRIGE
 - R : RADIUS

VERTICAL ALIGNMENT


- HORIZONTAL SCALE 1: 20,000
VERTICAL SCALE 1: 2,000
- : BRIGE
 - 1.0% : GRADIENT OF REC'D PROFILE
 - : EXSITING GL
 - o : DRAINAGE STRUCTURE

PROJECT	SHEET NO.	TOTAL SHEET
BELURU / LONG LAMA / LIMBANG TRUNK ROAD CONSTRUCTION PROJECT	40	54
PLAN AND PROFILE	SCALE	H=1:20,000 V=1:2,000

PLAN

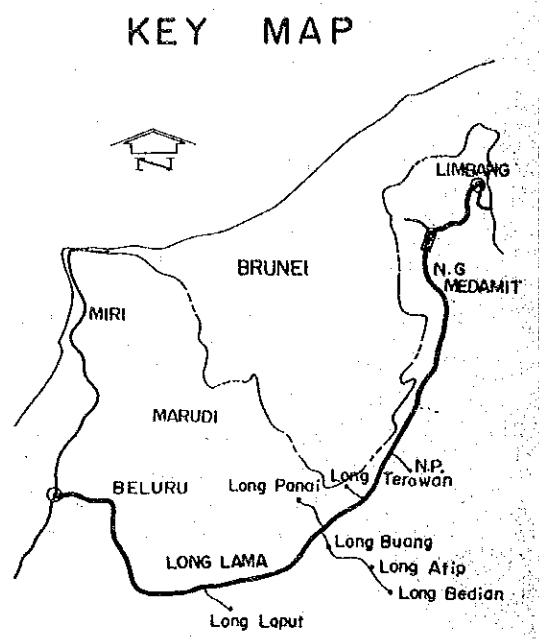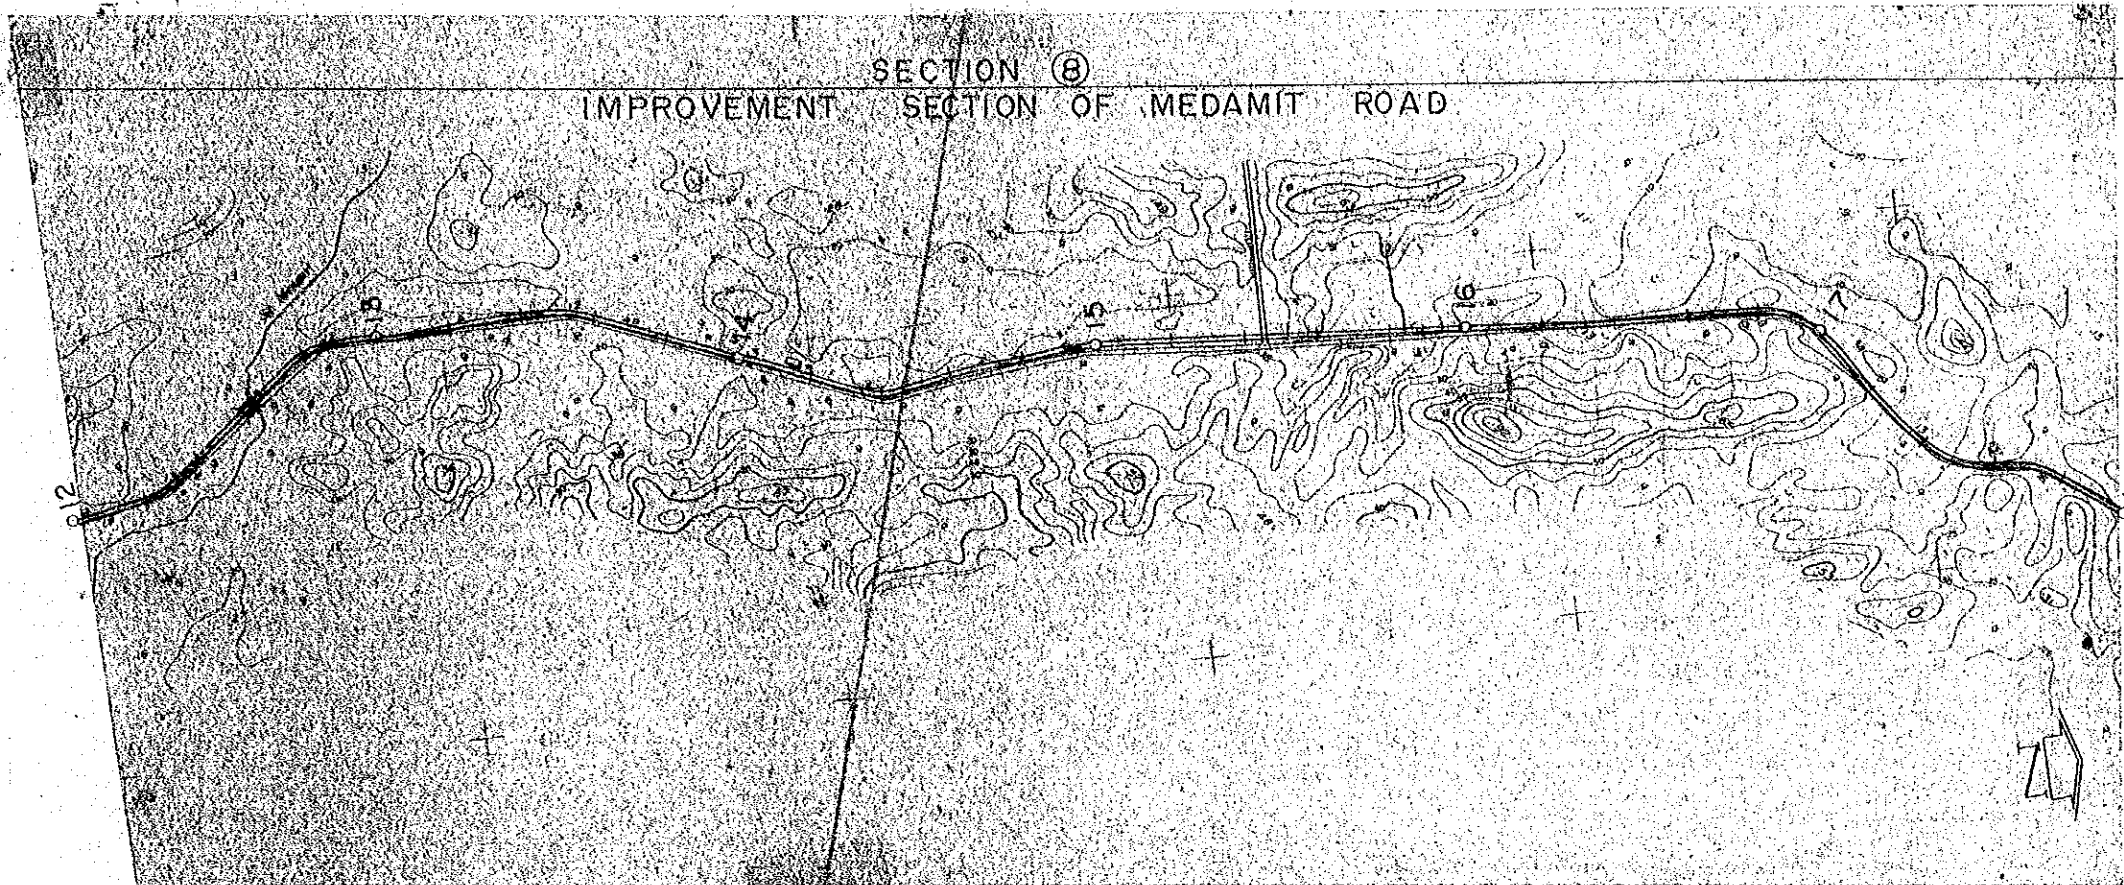

PROFILE

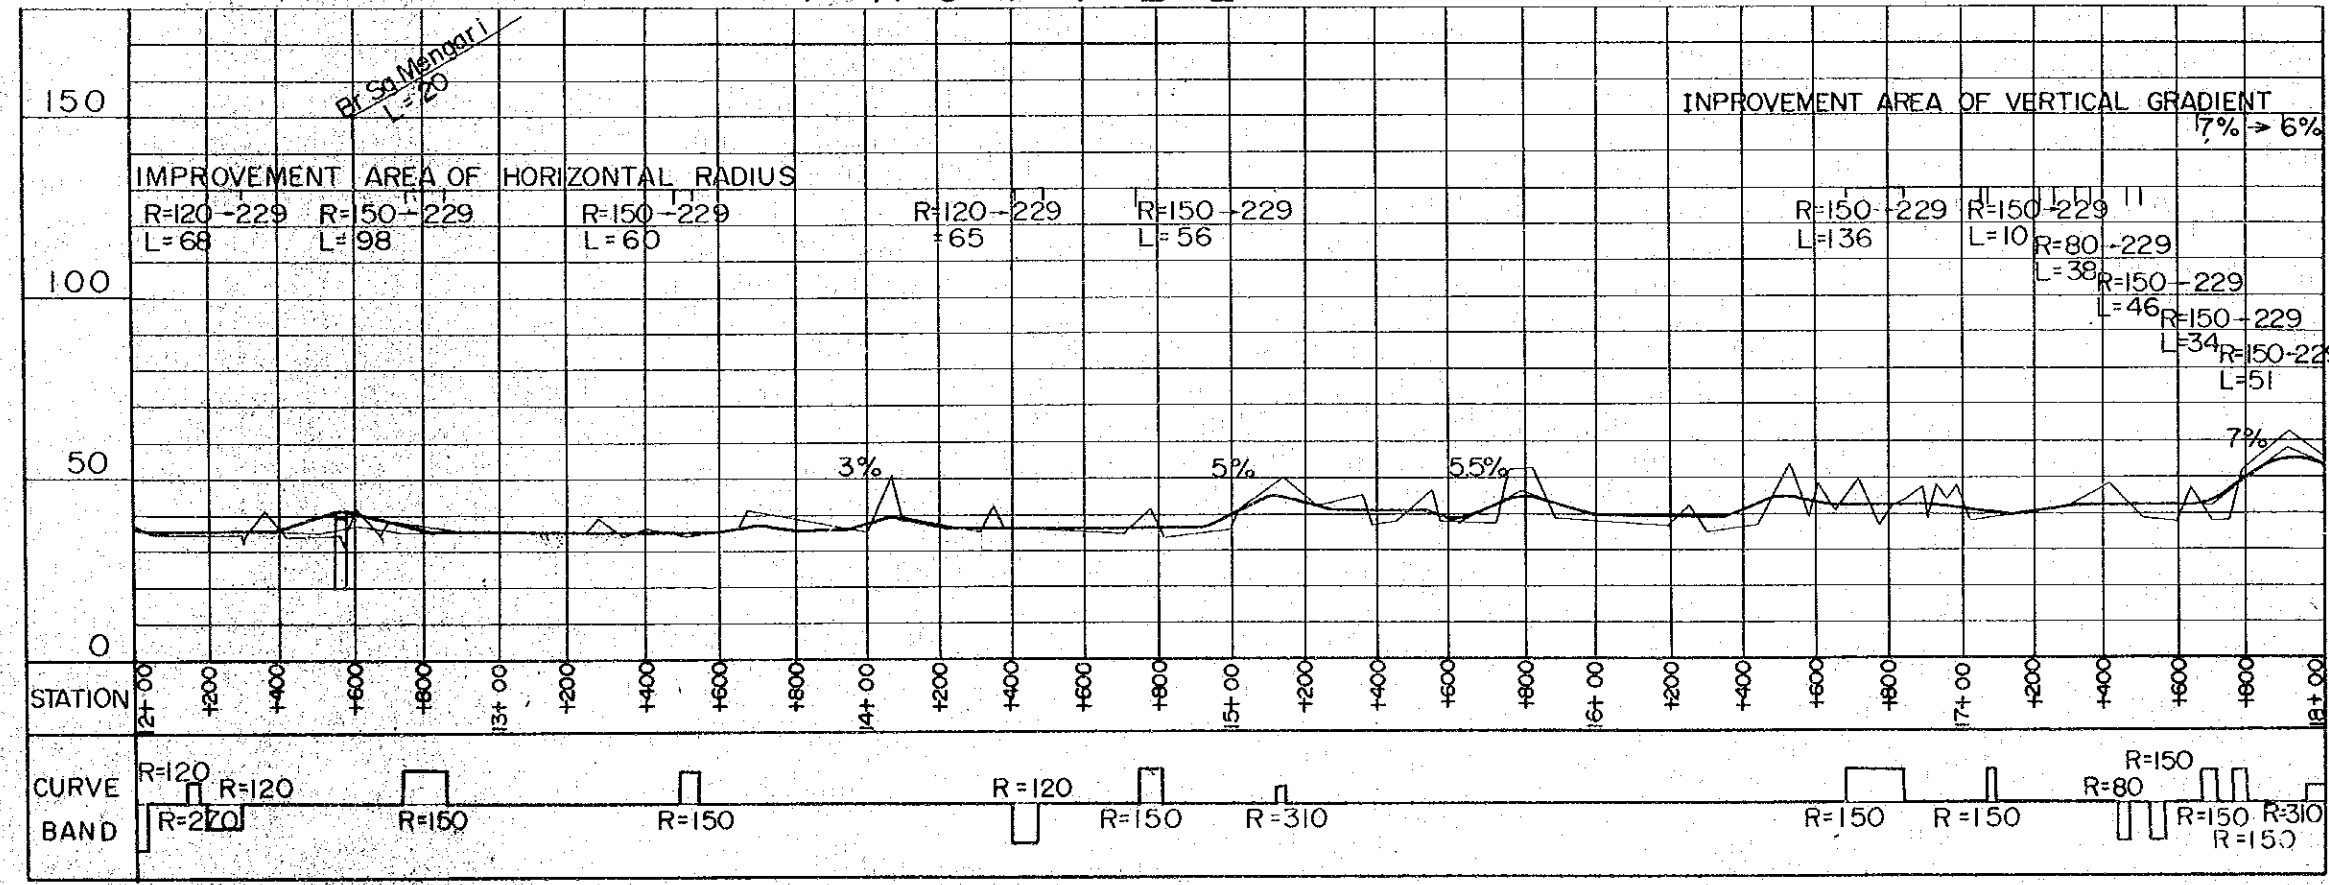

HORIZONTAL ALIGNMENT



- SCALE 1: 20,000
- : CENTER LINE
 - : ROAD RESERVE BOUNDARY
 - : BRIDGE
 - R : RADIUS

VERTICAL ALIGNMENT


- HORIZONTAL SCALE 1: 20,000
- VERTICAL SCALE 1: 2,000
- : BRIDGE
 - 1.0% : GRADIENT OF REC'D PROFILE
 - : EXISTING GL
 - : DRAINAGE STRUCTURE

PROJECT BELURU / LONG LAMA / LIMBANG TRUNK ROAD CONSTRUCTION PROJECT	SHEET NO.	TOTAL SHEET
	41	54
PLAN AND PROFILE		SCALE H=1:20,000 V=1:2,000

PLAN

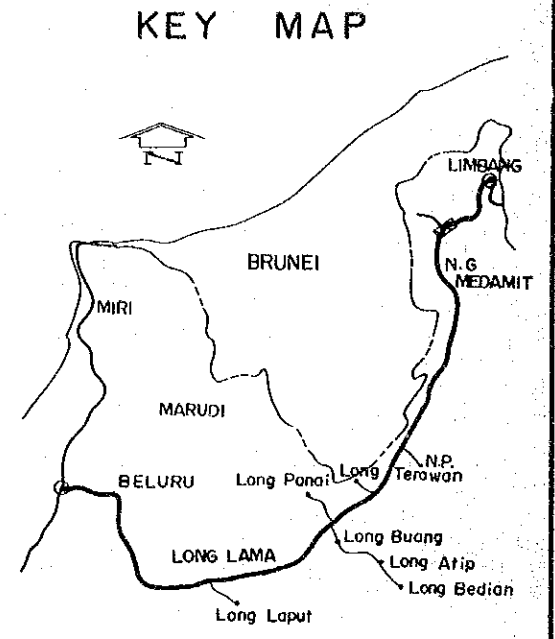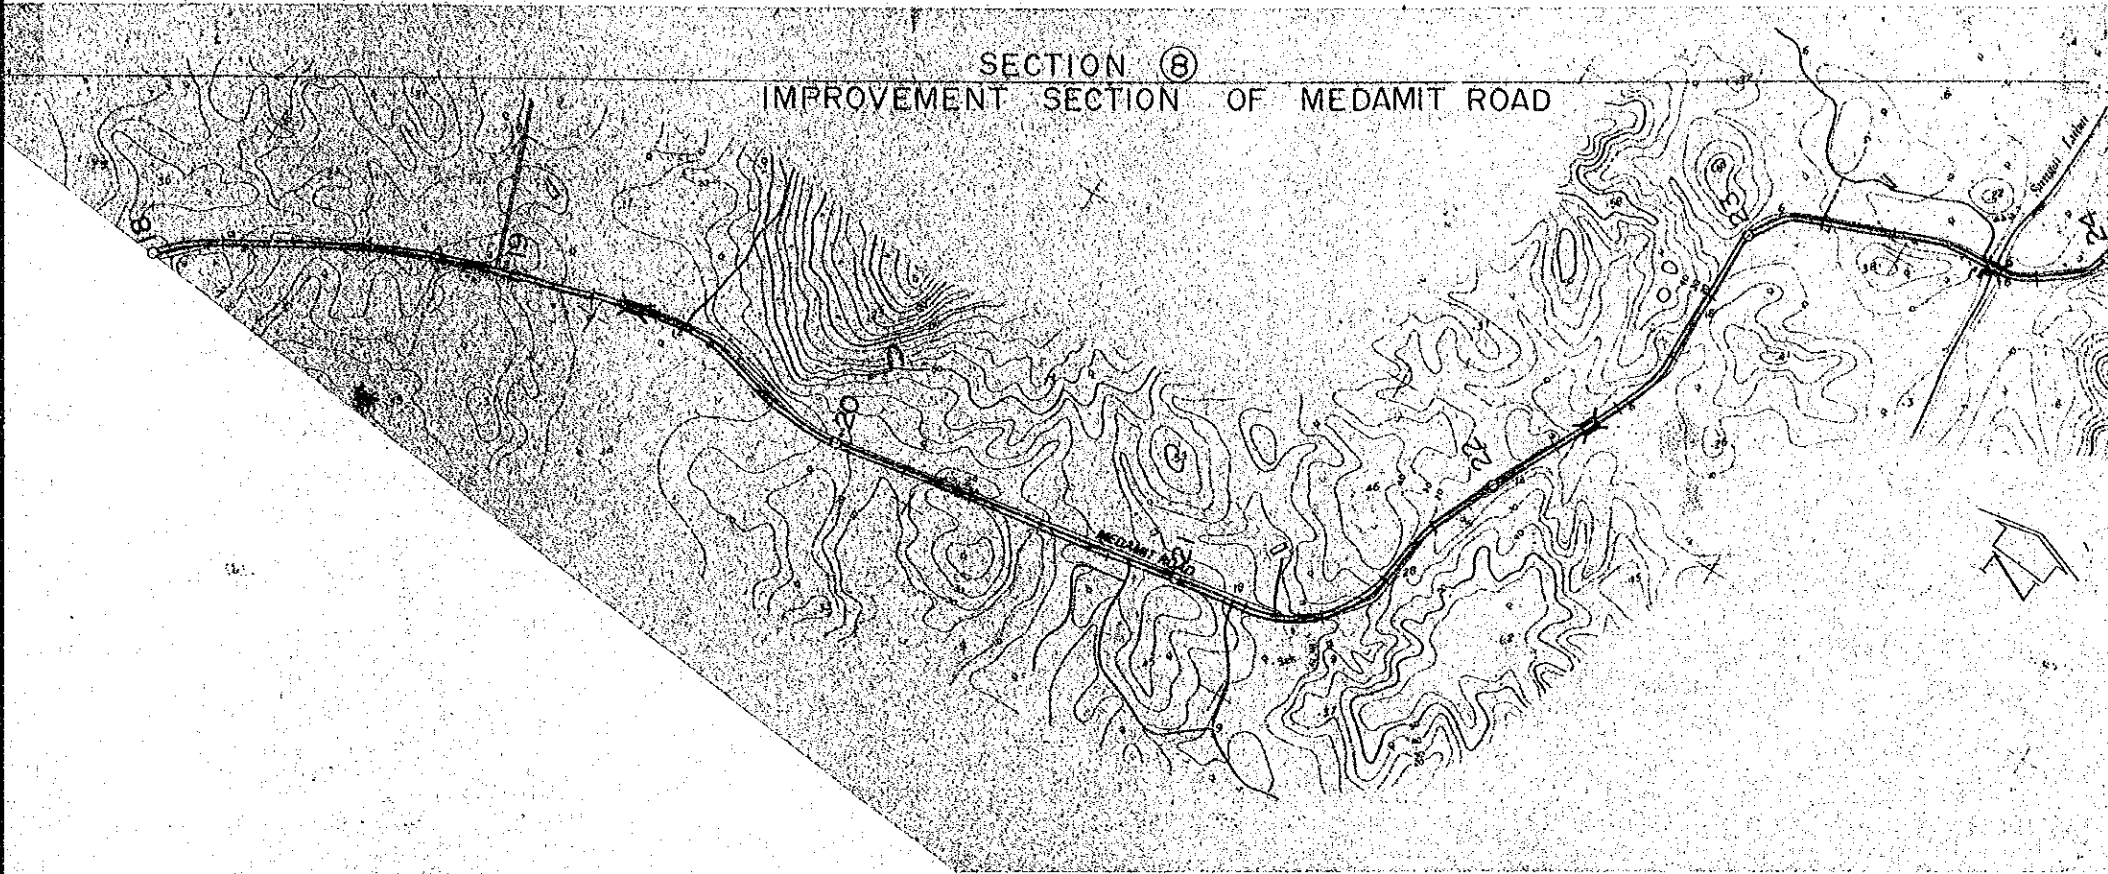


PROFILE

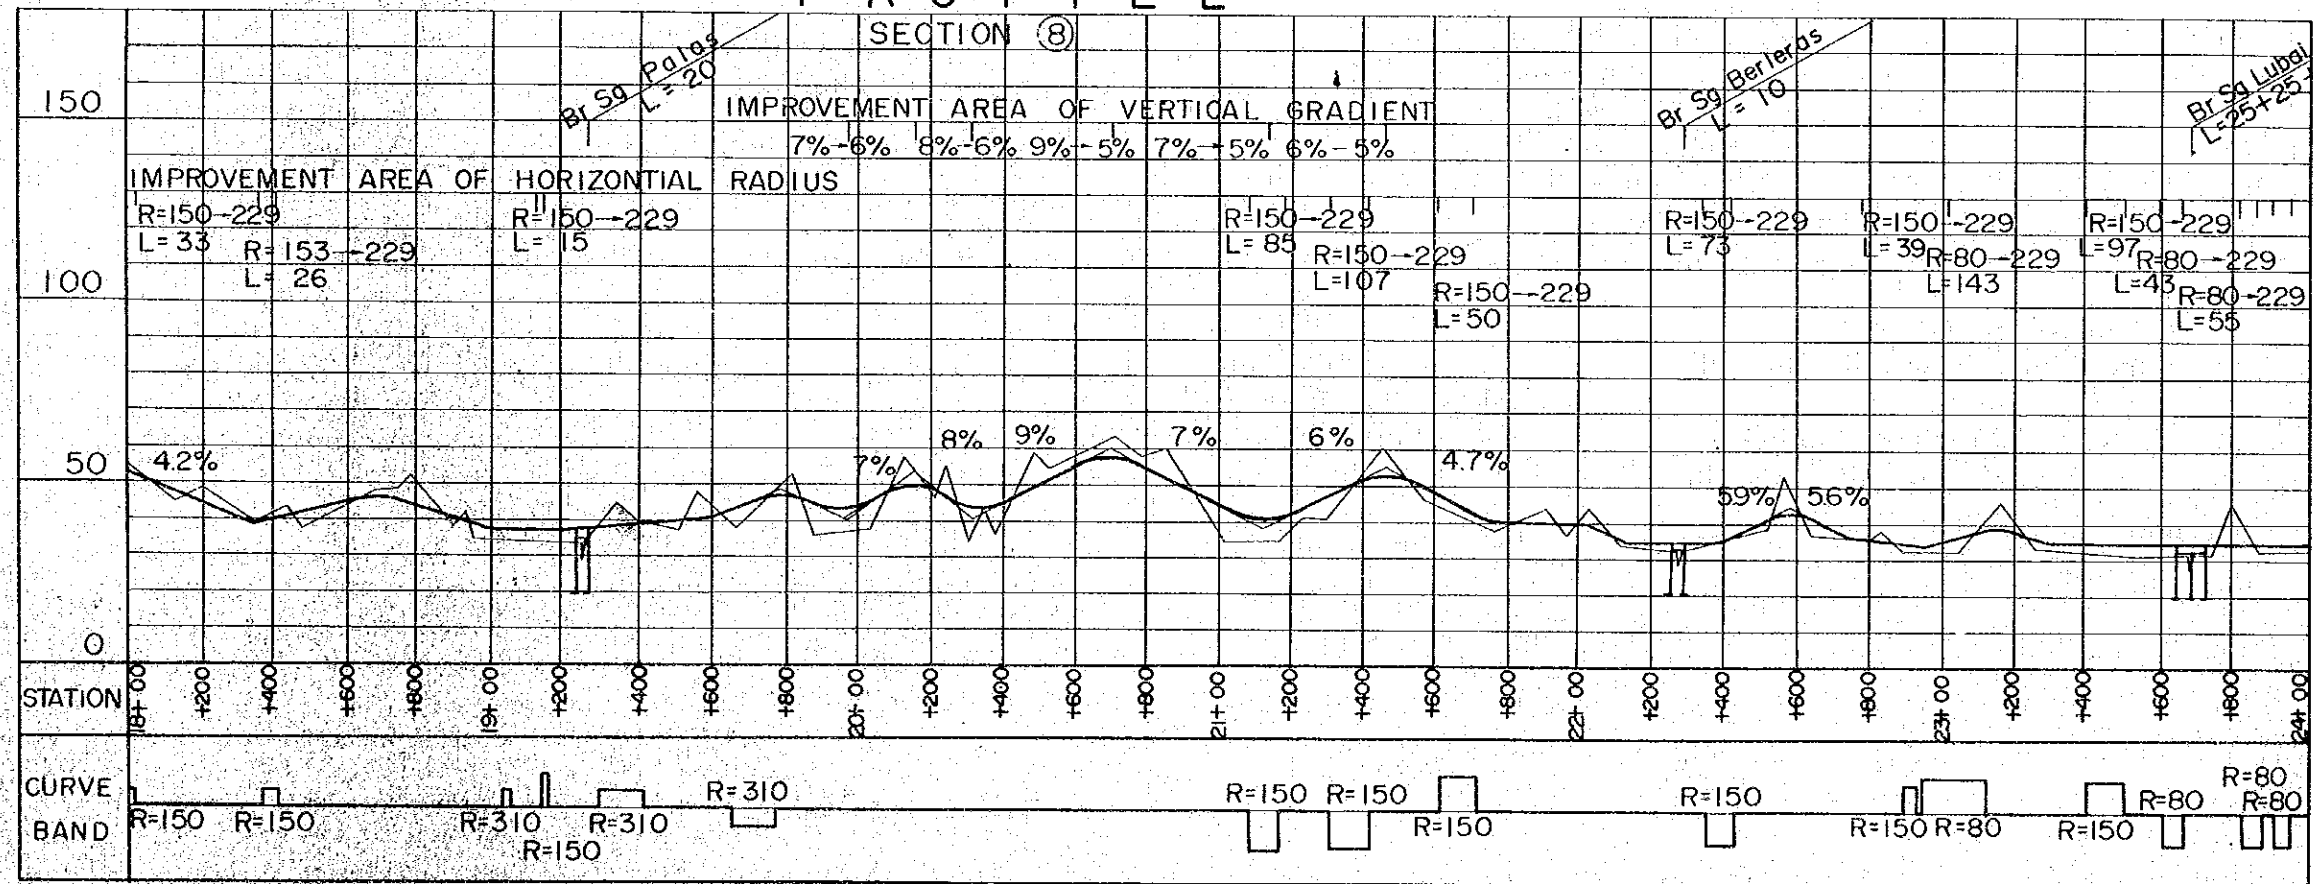


- HORIZONTAL ALIGNMENT
- SCALE 1: 20,000
- : CENTER LINE
 - : ROAD RESERVE BOUNDARY
 - : BRIGE
 - R : RADIUS
- VERTICAL ALIGNMENT
- HORIZONTAL SCALE 1: 20,000
- VERTICAL SCALE 1: 2,000
- : BRIGE
 - 1.0% : GRADIENT OF REC'D PROFILE
 - : EXSITING GL
 - o : DRAINAGE STRUCTURE

PROJECT	SHEET NO.	TOTAL SHEET
BELURU / LONG LAMA / LIMBANG TRUNK ROAD CONSTRUCTION PROJECT	42	54
PLAN AND PROFILE	SCALE	H=1:20,000 V=1:2,000


PLAN

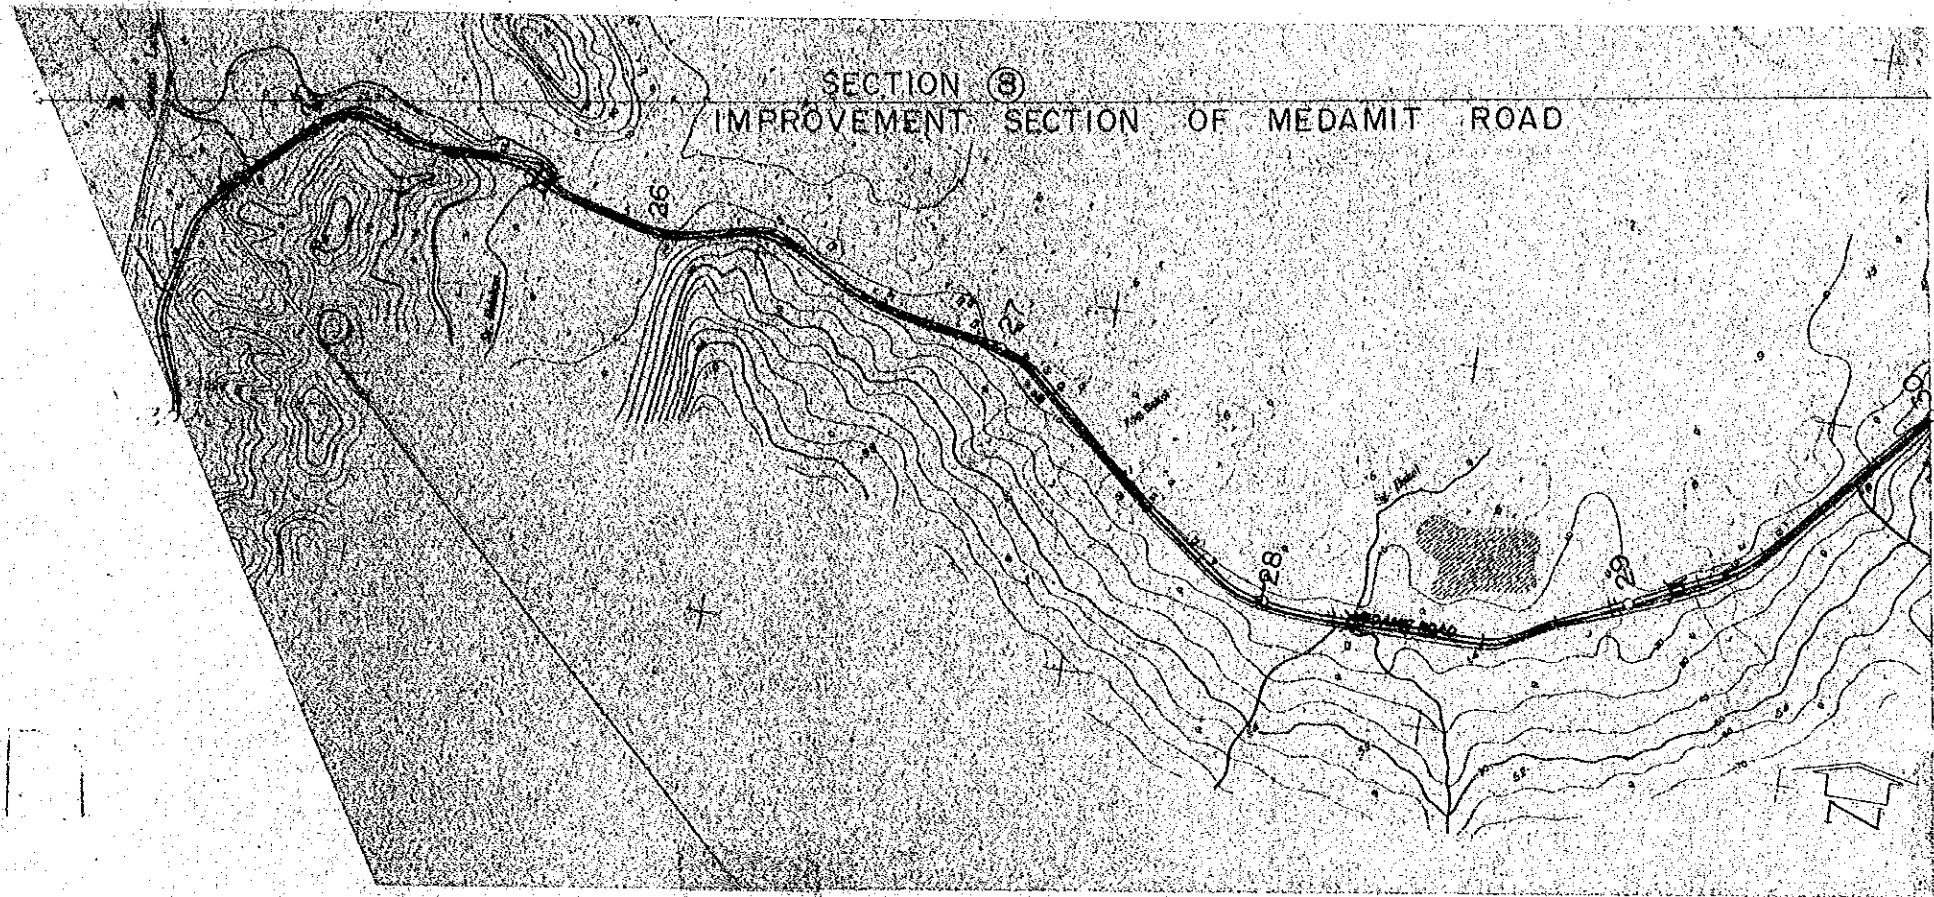


KEY MAP

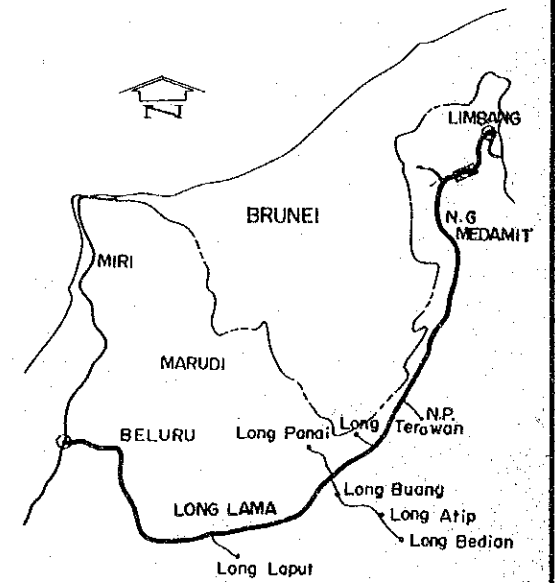


PROFILE

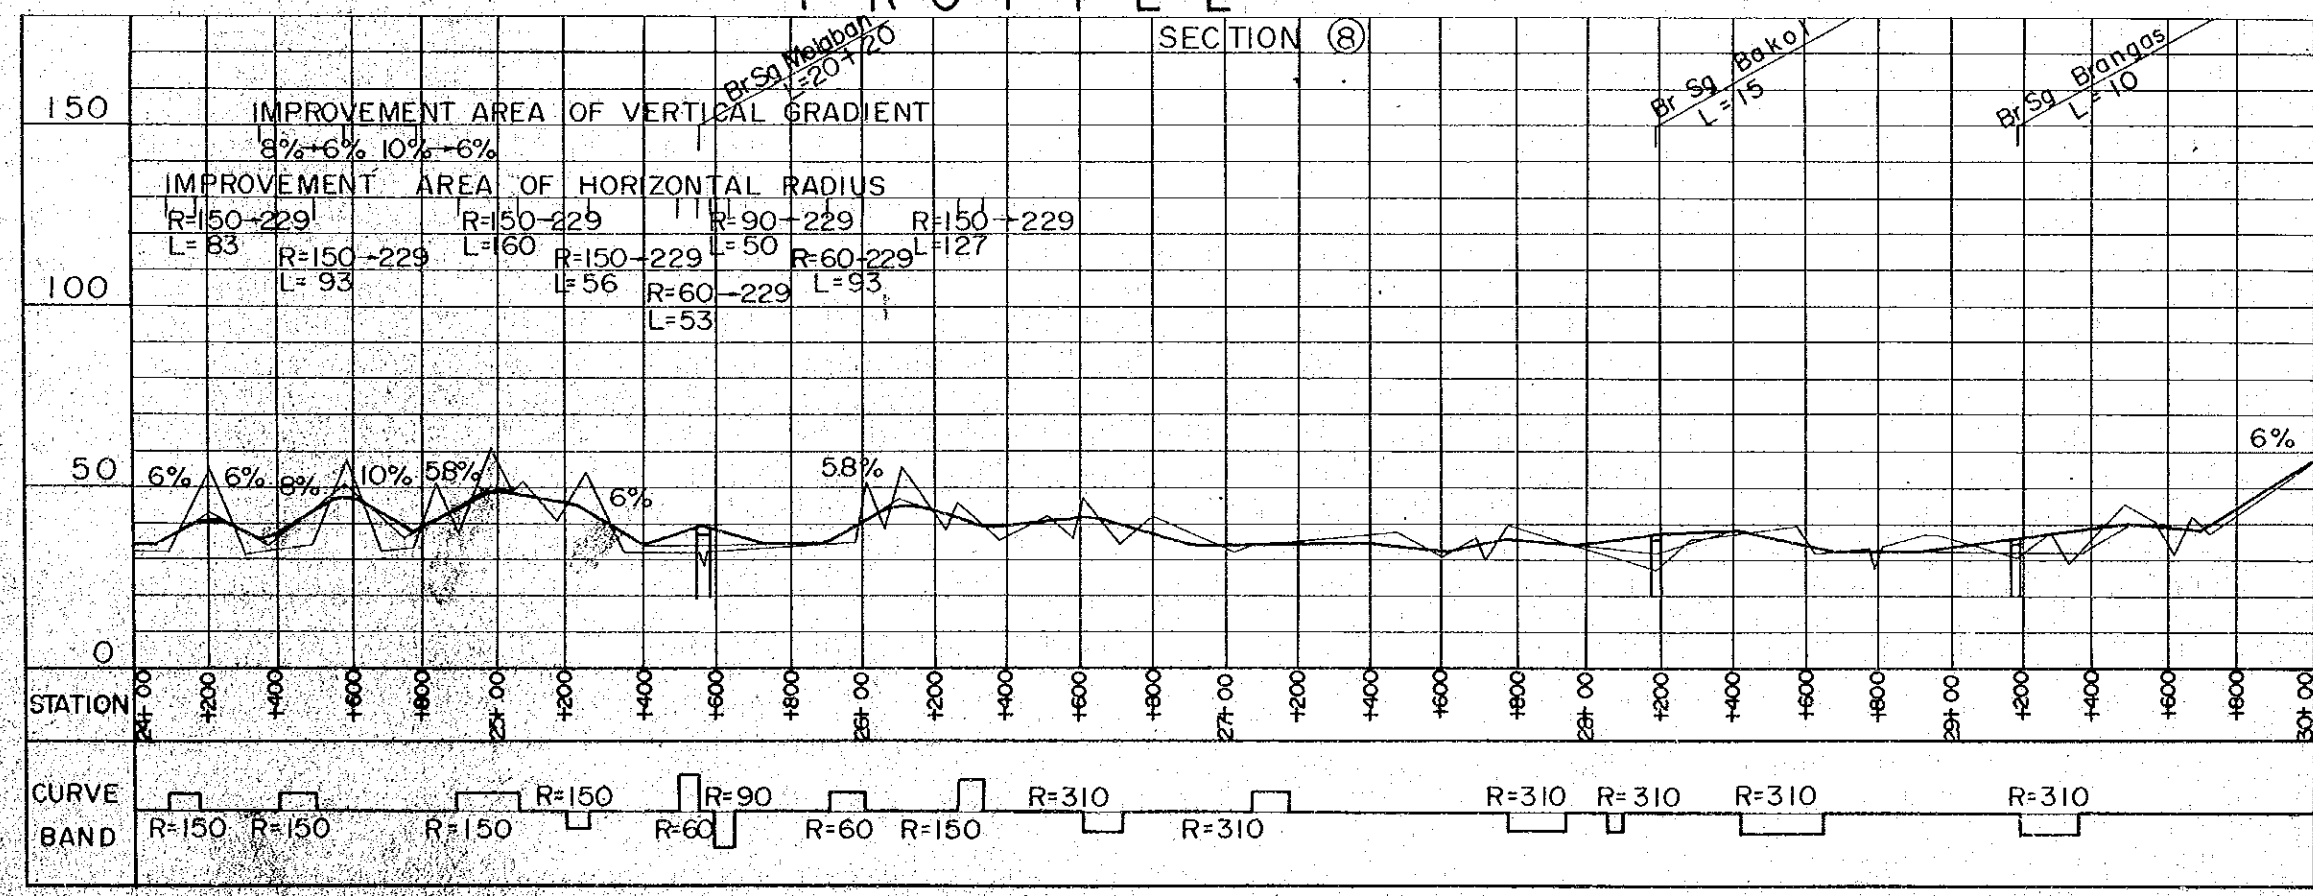

HORIZONTAL ALIGNMENT

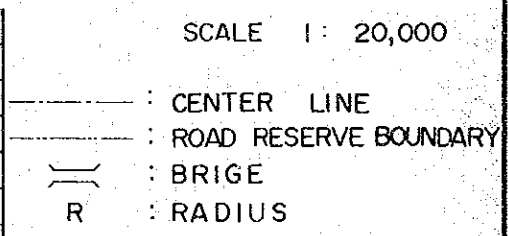


VERTICAL ALIGNMENT

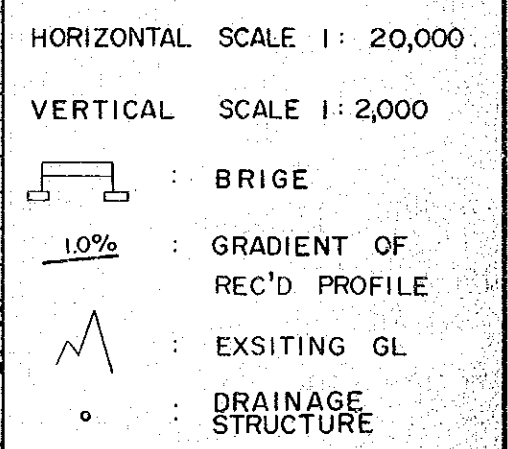


PROJECT	SHEET NO.	TOTAL SHEET
BELURU / LONG LAMA / LIMBANG TRUNK ROAD CONSTRUCTION PROJECT	43	54
PLAN AND PROFILE	SCALE	H=1:20,000 V=1:2,000


PLAN

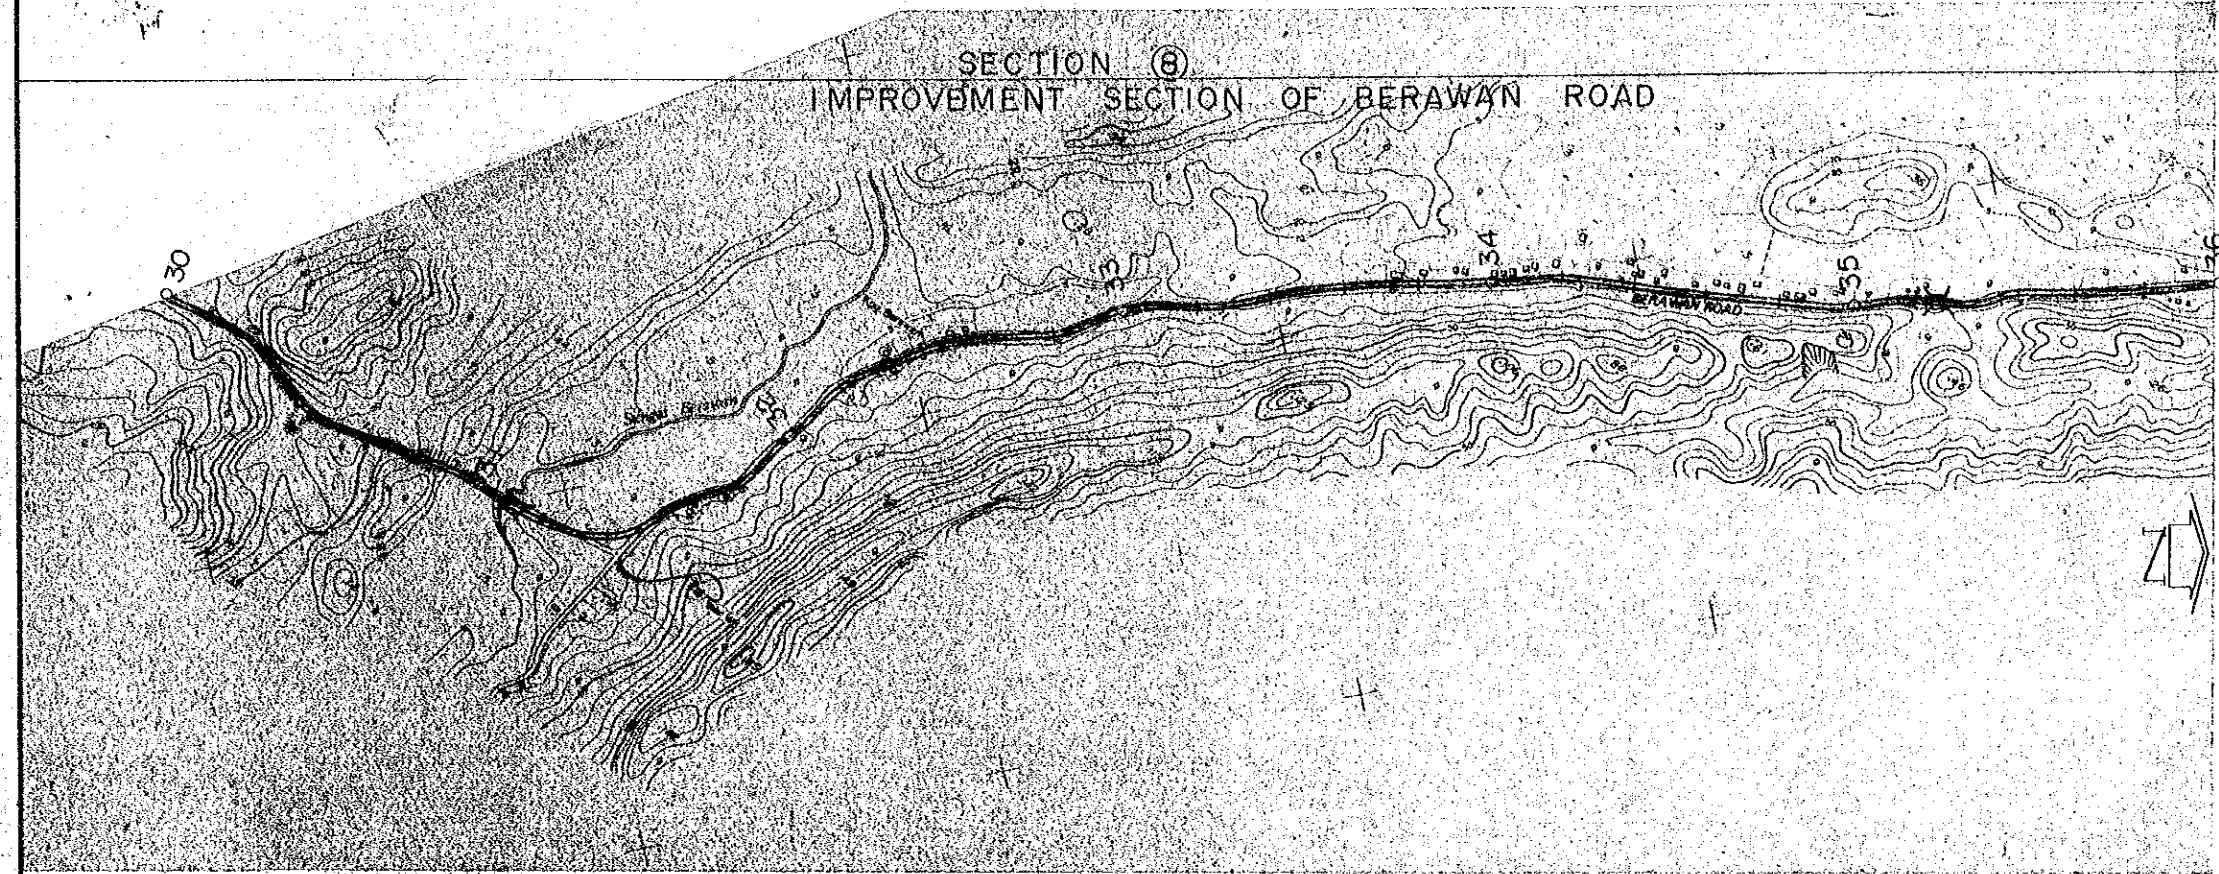


KEY MAP

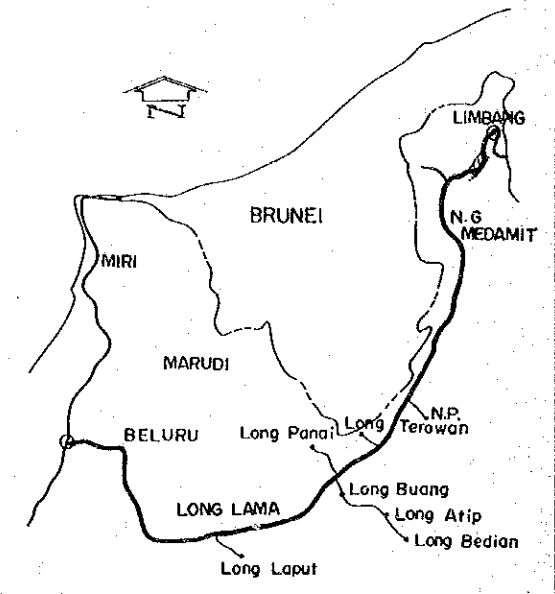


PROFILE

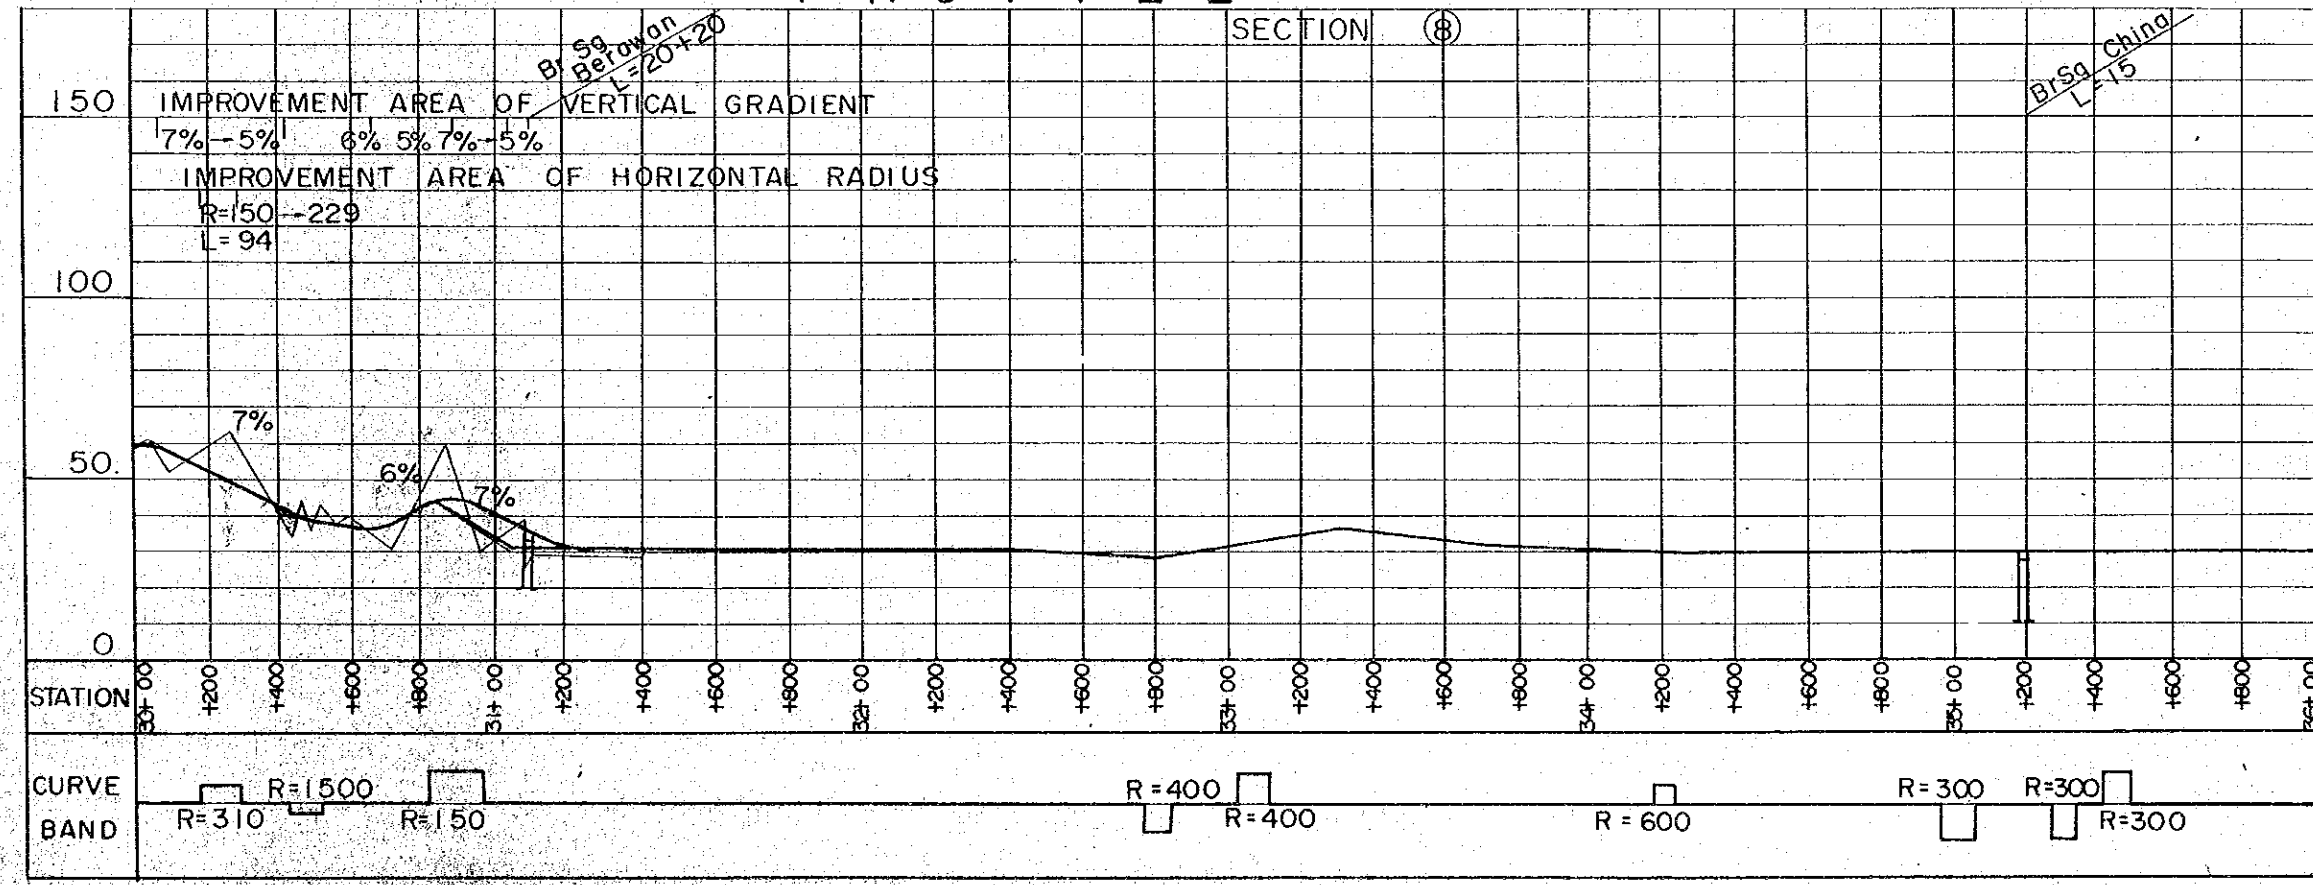

HORIZONTAL ALIGNMENT


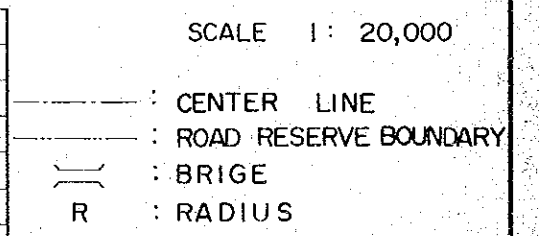


VERTICAL ALIGNMENT

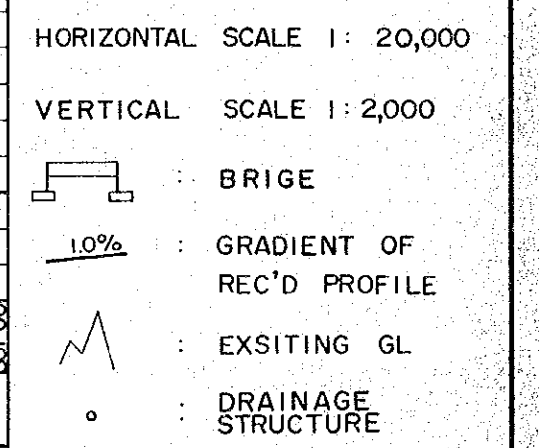


PROJECT	SHEET NO.	TOTAL SHEET
BELURU / LONG LAMA / LIMBANG TRUNK ROAD CONSTRUCTION PROJECT	44	54
PLAN AND PROFILE	SCALE	H = 1: 20,000 V = 1: 2,000

PLAN

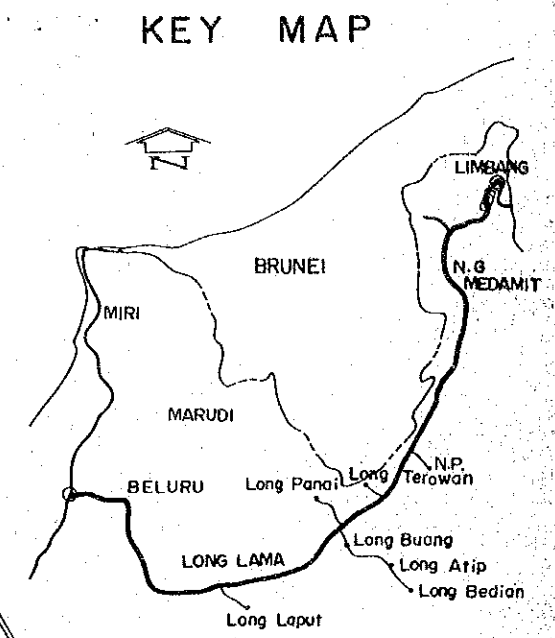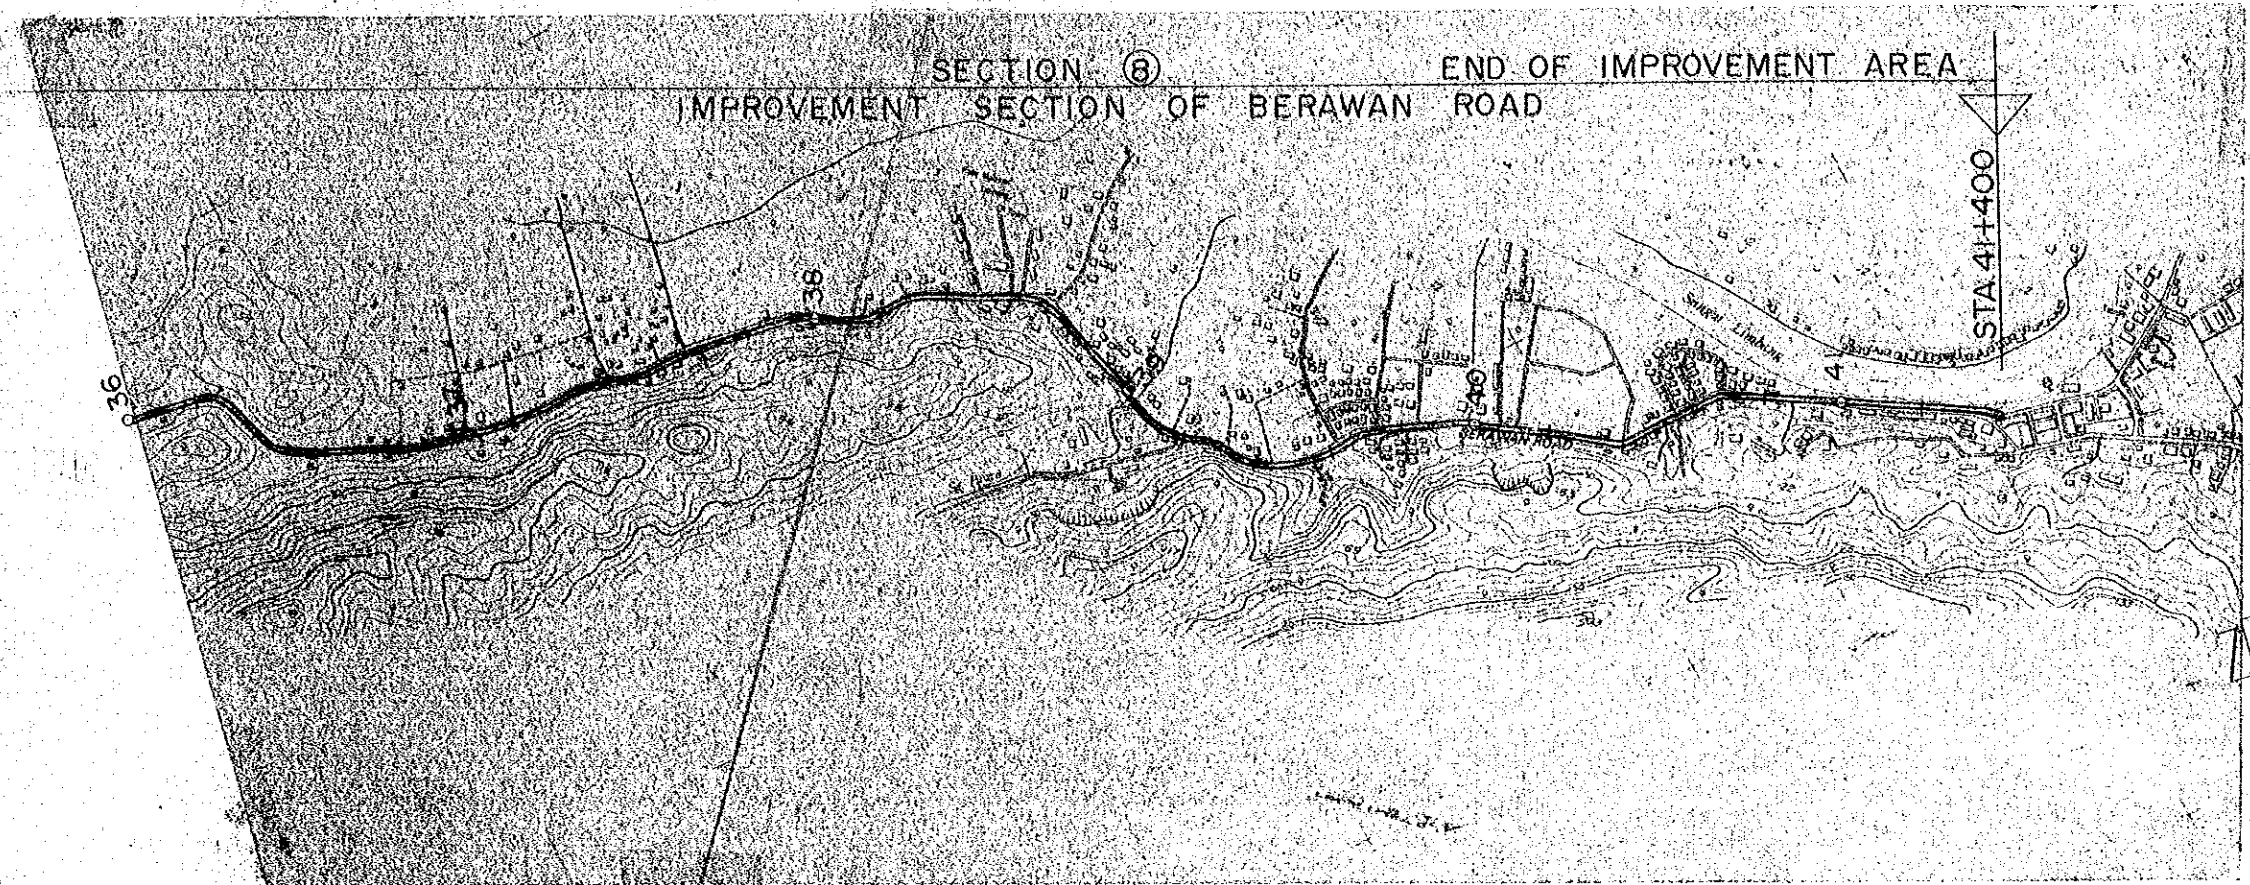

PROFILE

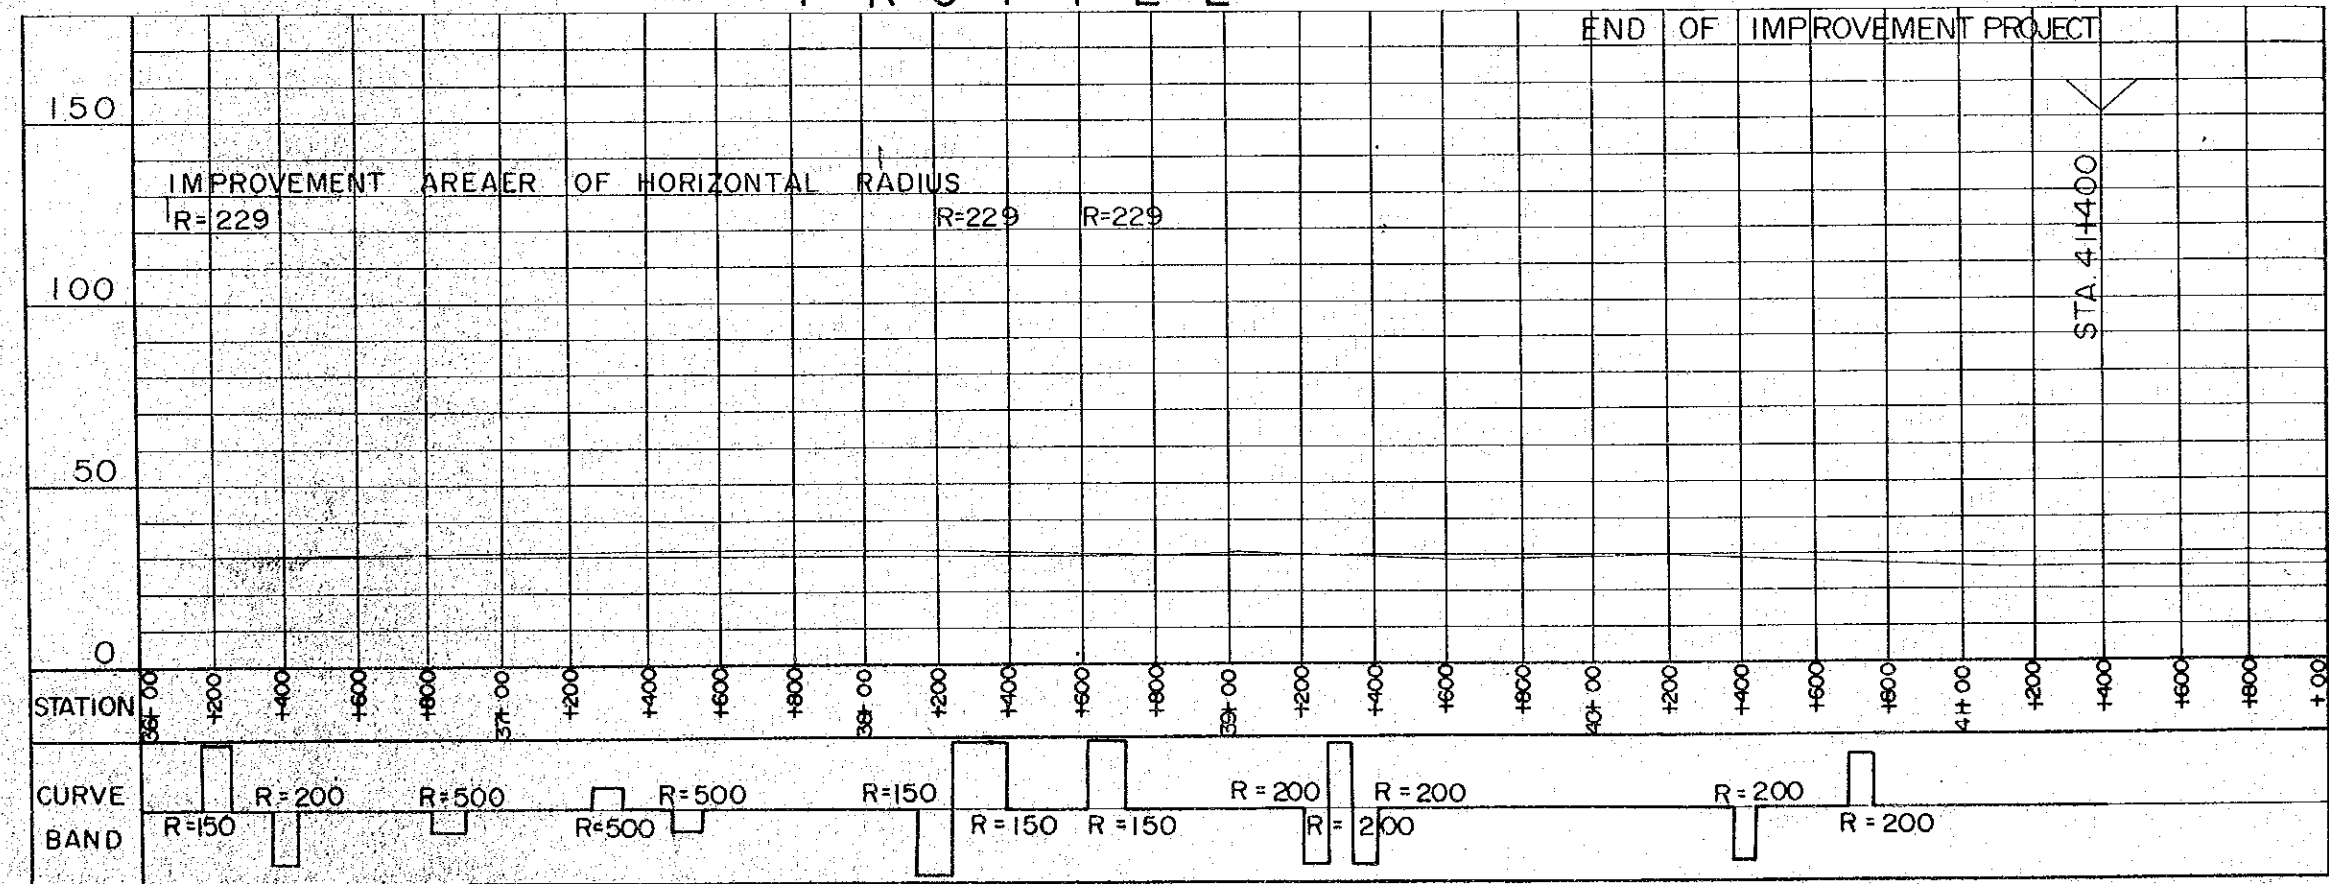

HORIZONTAL ALIGNMENT


- SCALE 1: 20,000
- : CENTER LINE
 - : ROAD RESERVE BOUNDARY
 - : BRIGE
 - R : RADIUS

VERTICAL ALIGNMENT


- HORIZONTAL SCALE 1: 20,000
VERTICAL SCALE 1: 2,000
- : BRIGE
 - 1.0% : GRADIENT OF REC'D PROFILE
 - : EXSITING GL
 - o : DRAINAGE STRUCTURE

PROJECT	SHEET NO.	TOTAL SHEET
BELURU / LONG LAMA / LIMBANG TRUNK ROAD CONSTRUCTION PROJECT	45	54
PLAN AND PROFILE	SCALE	H=1:50,000 V=1:1,000


PLAN

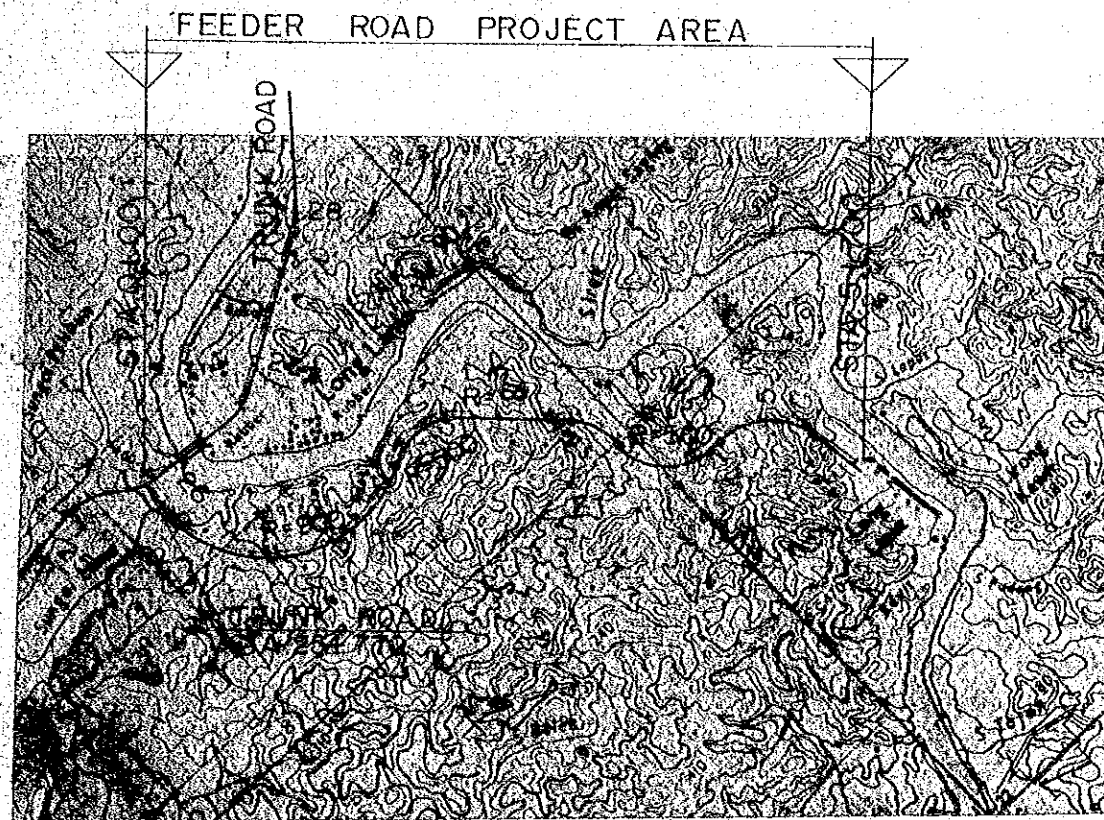

KEY MAP

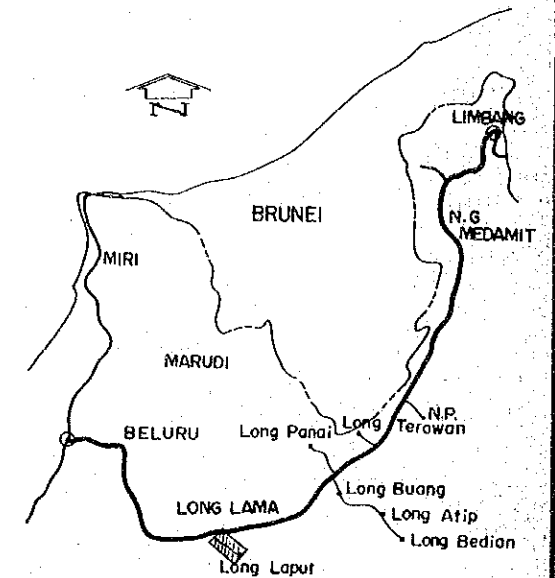

PROFILE

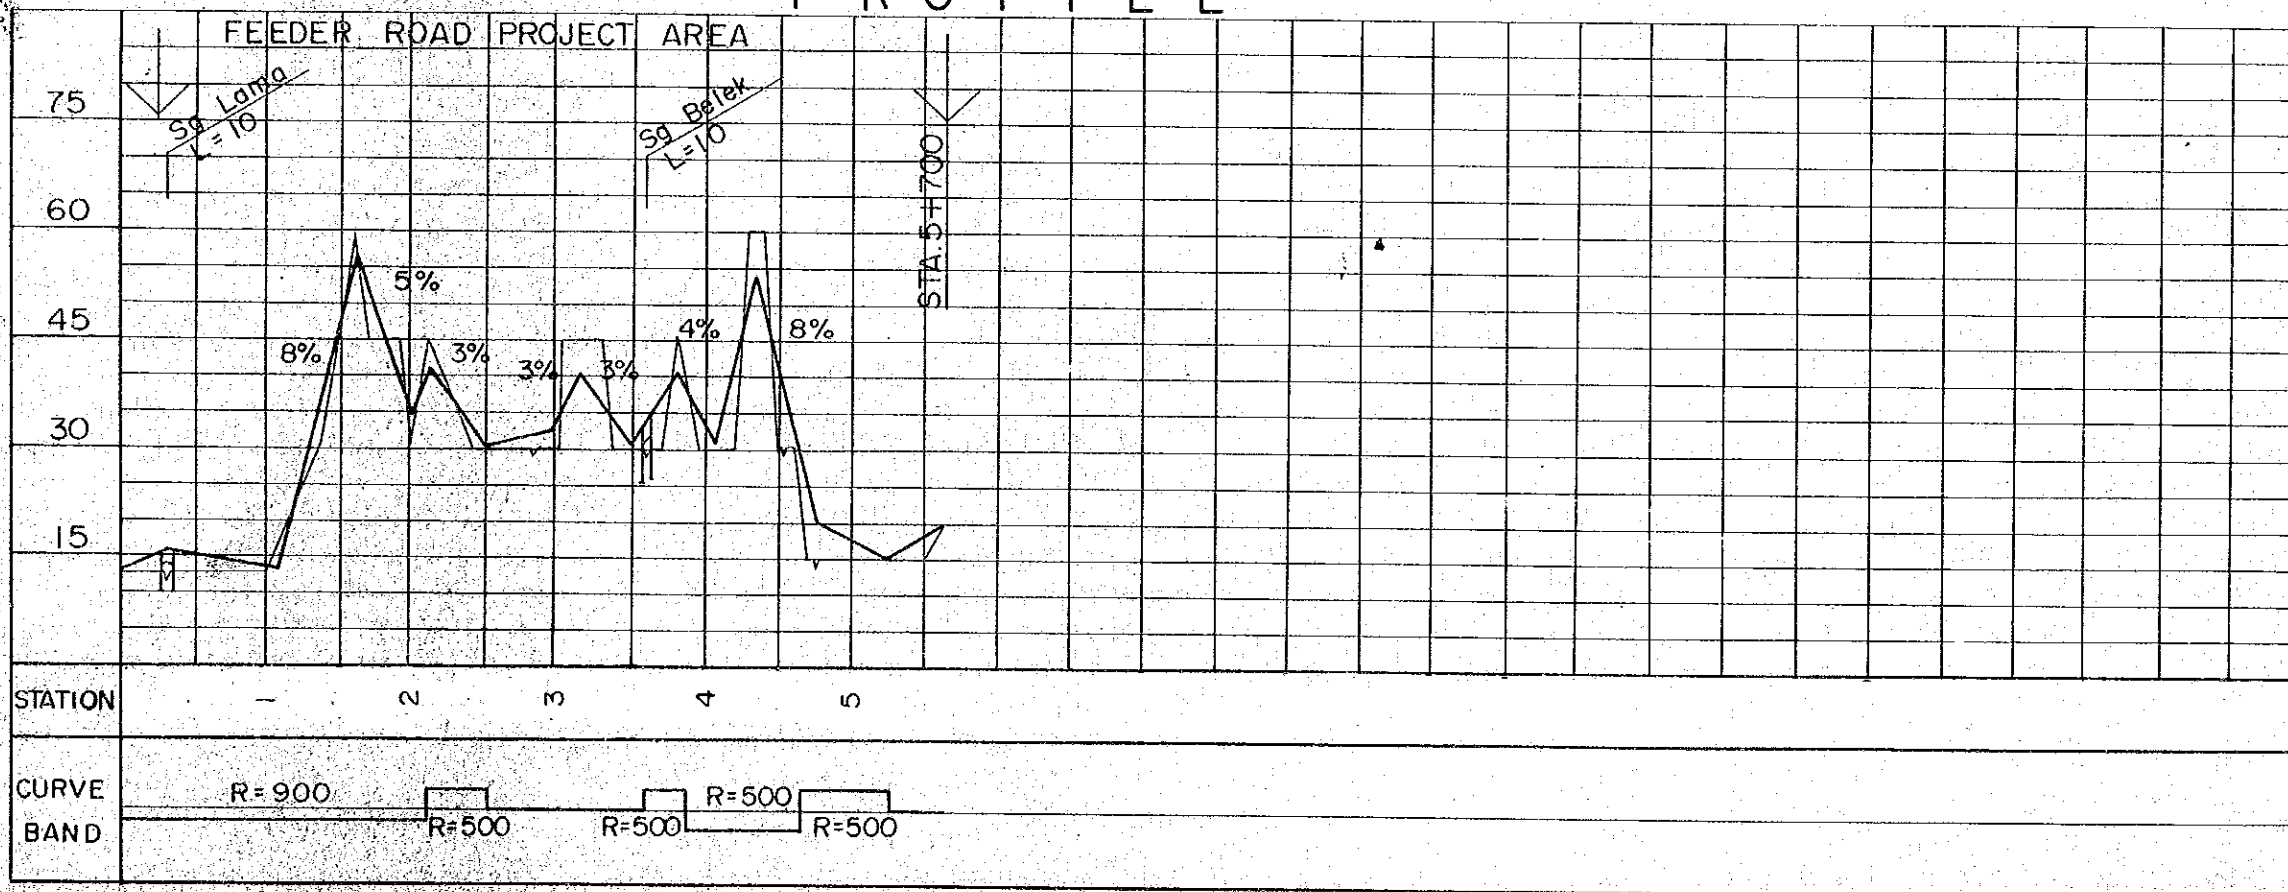

HORIZONTAL ALIGNMENT

SCALE 1:50,000

- : CENTER LINE
- : ROAD RESERVE BOUNDARY
- : BRIDGE
- R : RADIUS

VERTICAL ALIGNMENT

HORIZONTAL SCALE 1:50,000


VERTICAL SCALE 1:1,000

- : BRIDGE
- 10% : GRADIENT OF REC'D PROFILE
- : EXSITING GL
- o : DRAINAGE STRUCTURE


PROJECT	SHEET NO.	TOTAL SHEET
BELURU / LONG LAMA / LIMBANG TRUNK ROAD CONSTRUCTION PROJECT	46	54
PLAN AND PROFILE	SCALE	H = 1 : 50,000 V = 1 : 1,000

PLAN

FEEDER ROAD PROJECT AREA

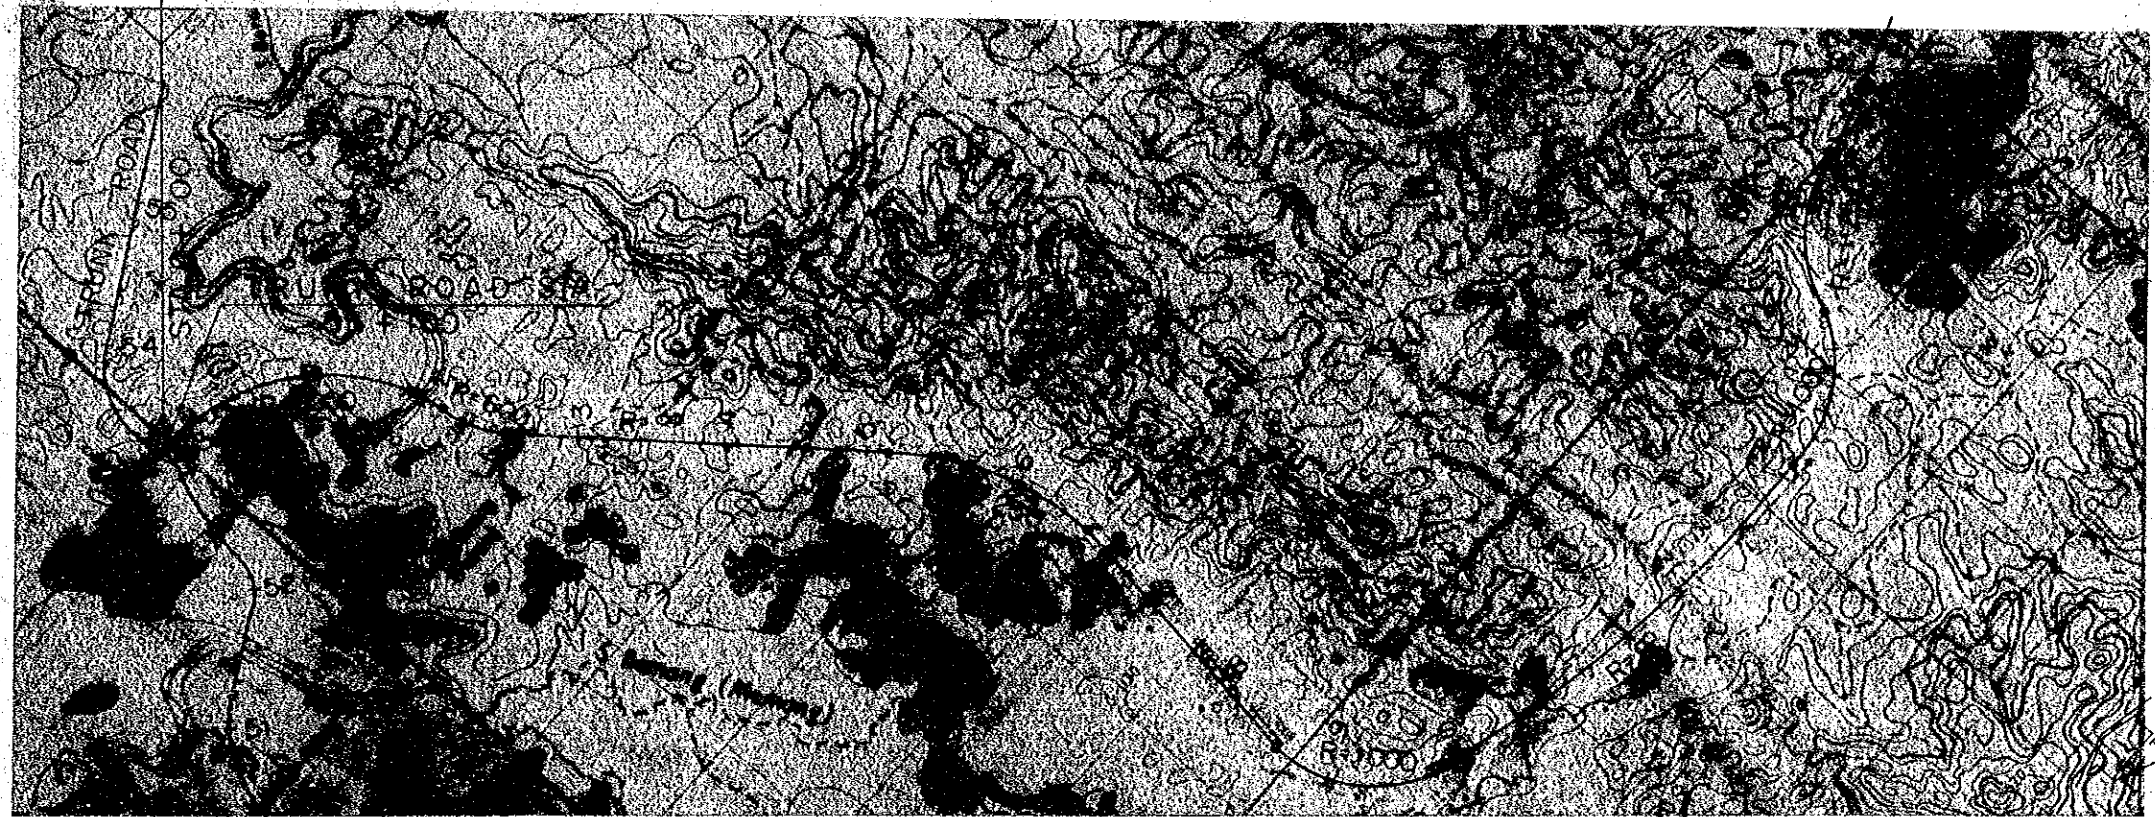


KEY MAP

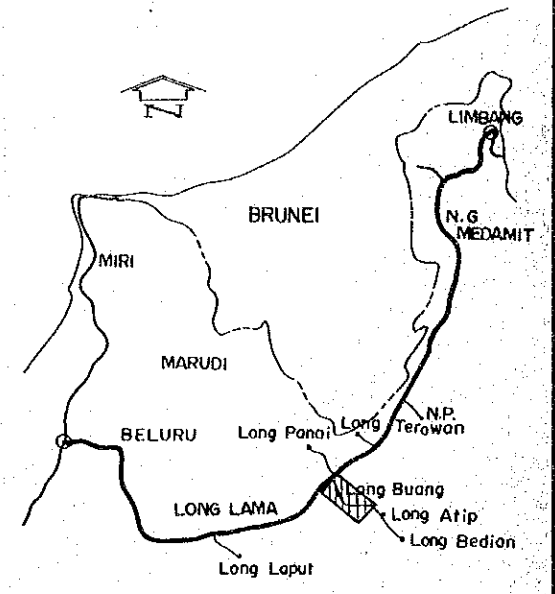

PROFILE

FEEDER ROAD PROJECT AREA

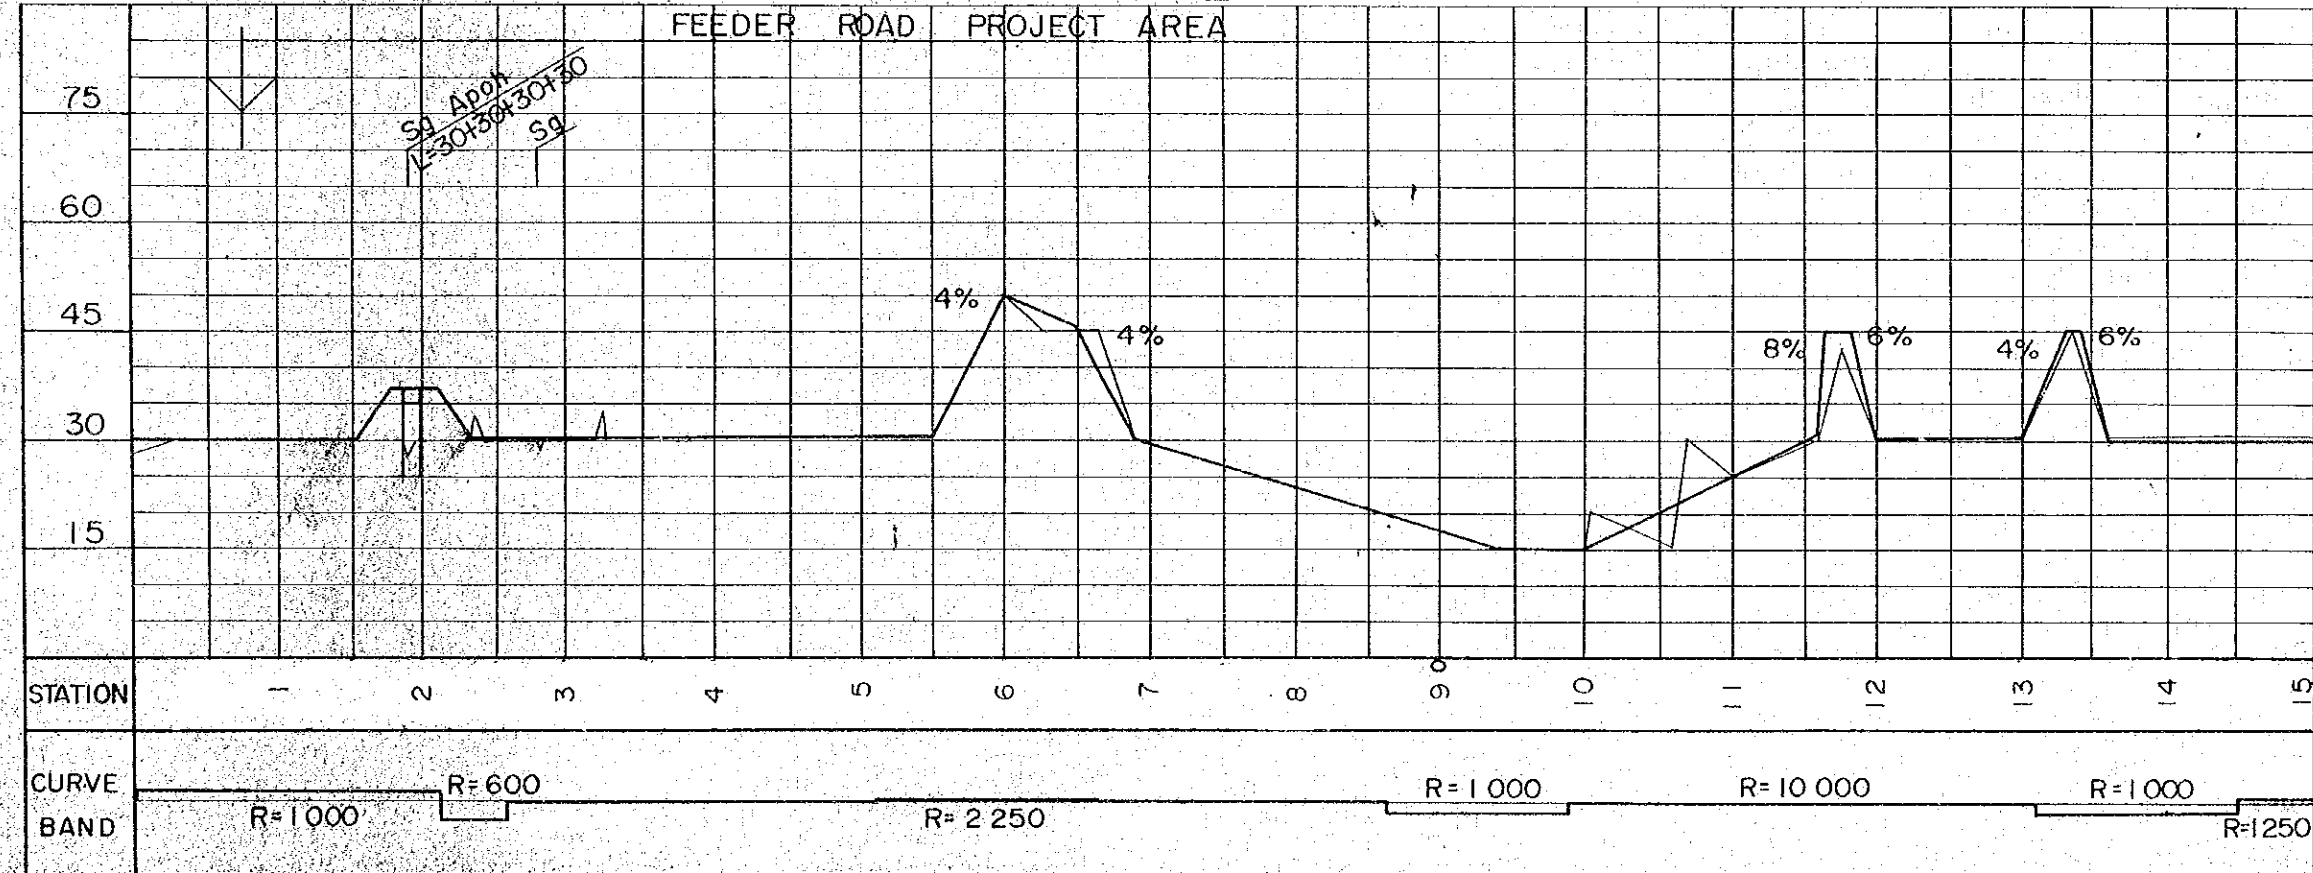

HORIZONTAL ALIGNMENT

SCALE 1 : 50,000

- : CENTER LINE
- : ROAD RESERVE BOUNDARY
- == : BRIGE
- R : RADIUS

VERTICAL ALIGNMENT

HORIZONTAL SCALE 1 : 50,000

VERTICAL SCALE 1 : 1,000

- : BRIGE
- 10% : GRADIENT OF REC'D PROFILE
- ~ : EXSITING GL
- o : DRAINAGE STRUCTURE


PROJECT	SHEET NO.	TOTAL SHEET
BELURU / LONG LAMA / LIMBANG TRUNK ROAD CONSTRUCTION PROJECT	47	54
PLAN AND PROFILE	SCALE	H = 1 : 50,000 V = 1 : 1,000

PLAN


FEEDER ROAD PROJECT AREA



KEY MAP

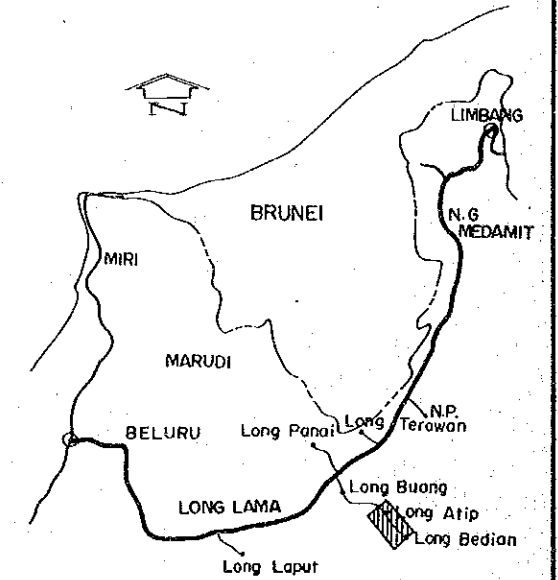

PROFILE

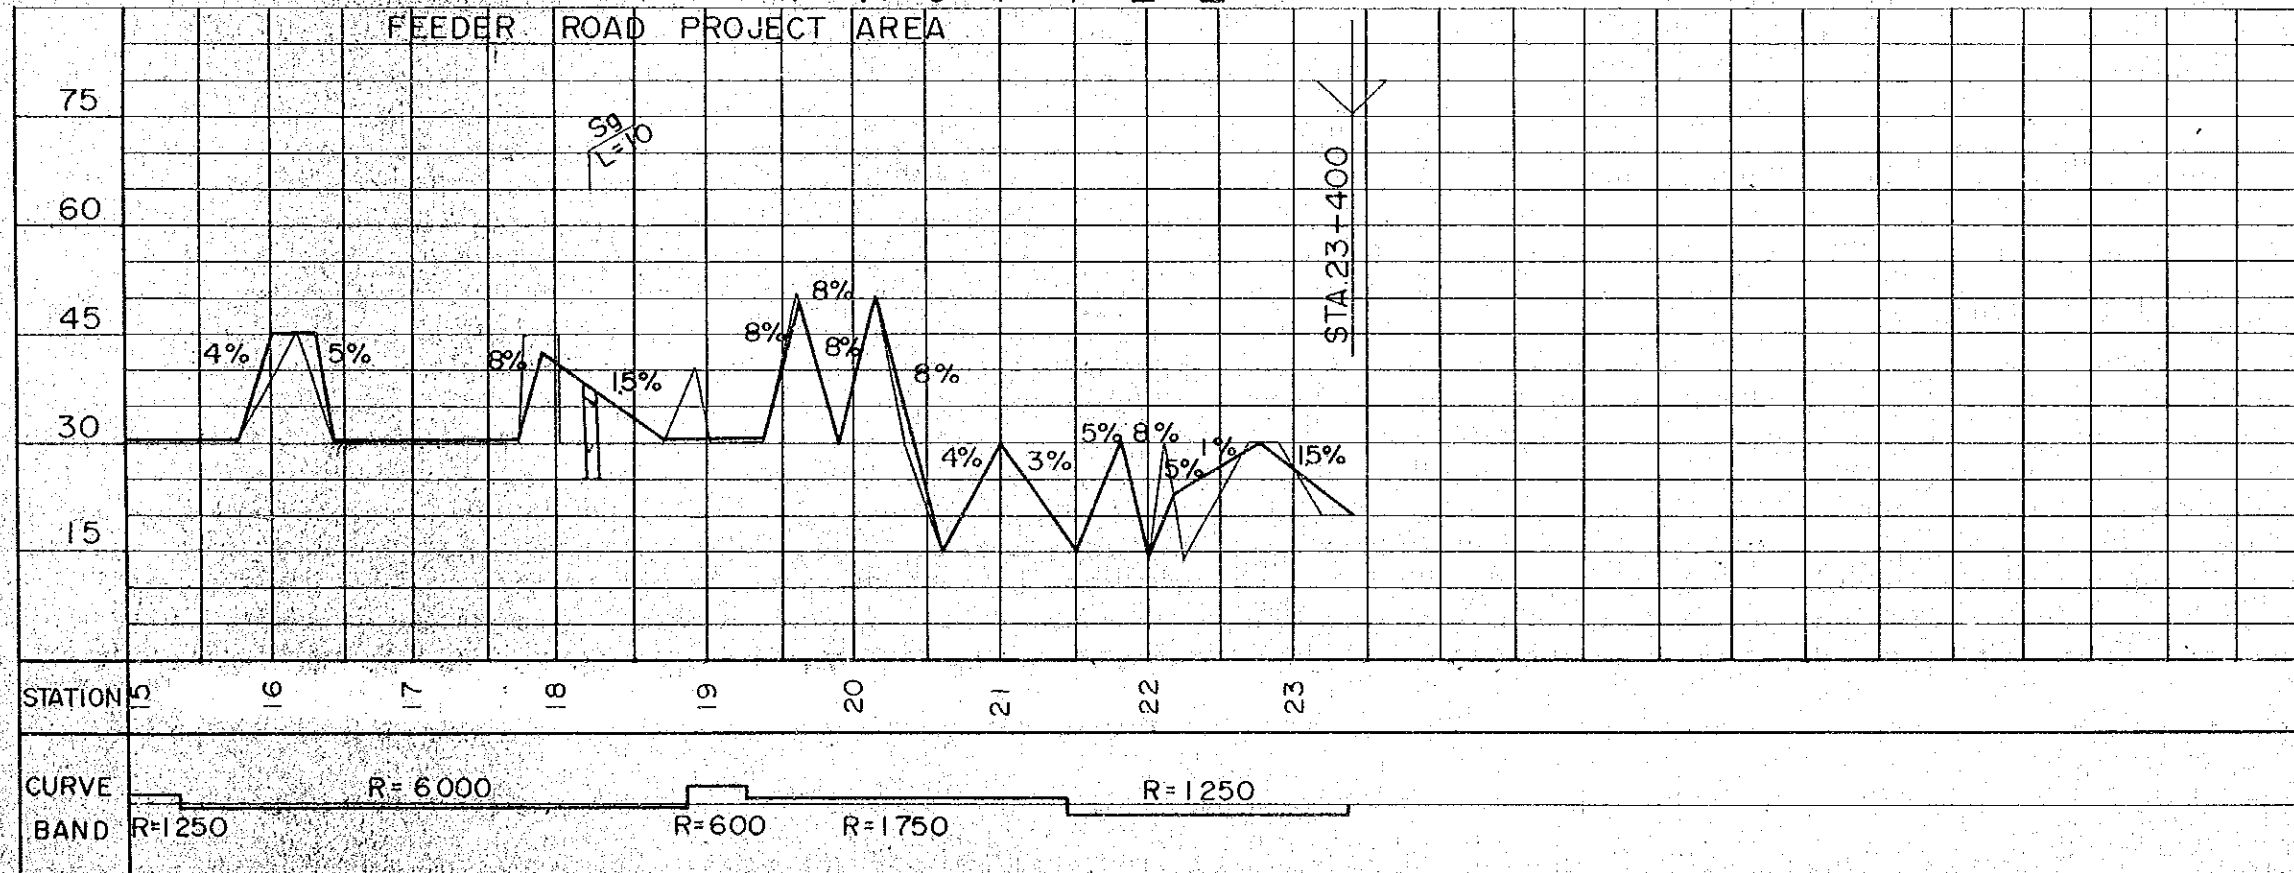

HORIZONTAL ALIGNMENT

SCALE 1 : 50,000

- : CENTER LINE
- : ROAD RESERVE BOUNDARY
- ==== : BRIDGE
- R : RADIUS

VERTICAL ALIGNMENT

HORIZONTAL SCALE 1 : 50,000

VERTICAL SCALE 1 : 1,000

- : BRIDGE
- : GRADIENT OF REC'D PROFILE
- : EXSITING GL
- : DRAINAGE STRUCTURE