



PROJECT BELURU / LONG LAMA / LIMBANG TRUNK ROAD CONSTRUCTION PROJECT PLAN AND PROFILE	SHEET NO.	TOTAL SHEET
	18	54
	SCALE	H=1:20,000 V=1:2,000


PLAN

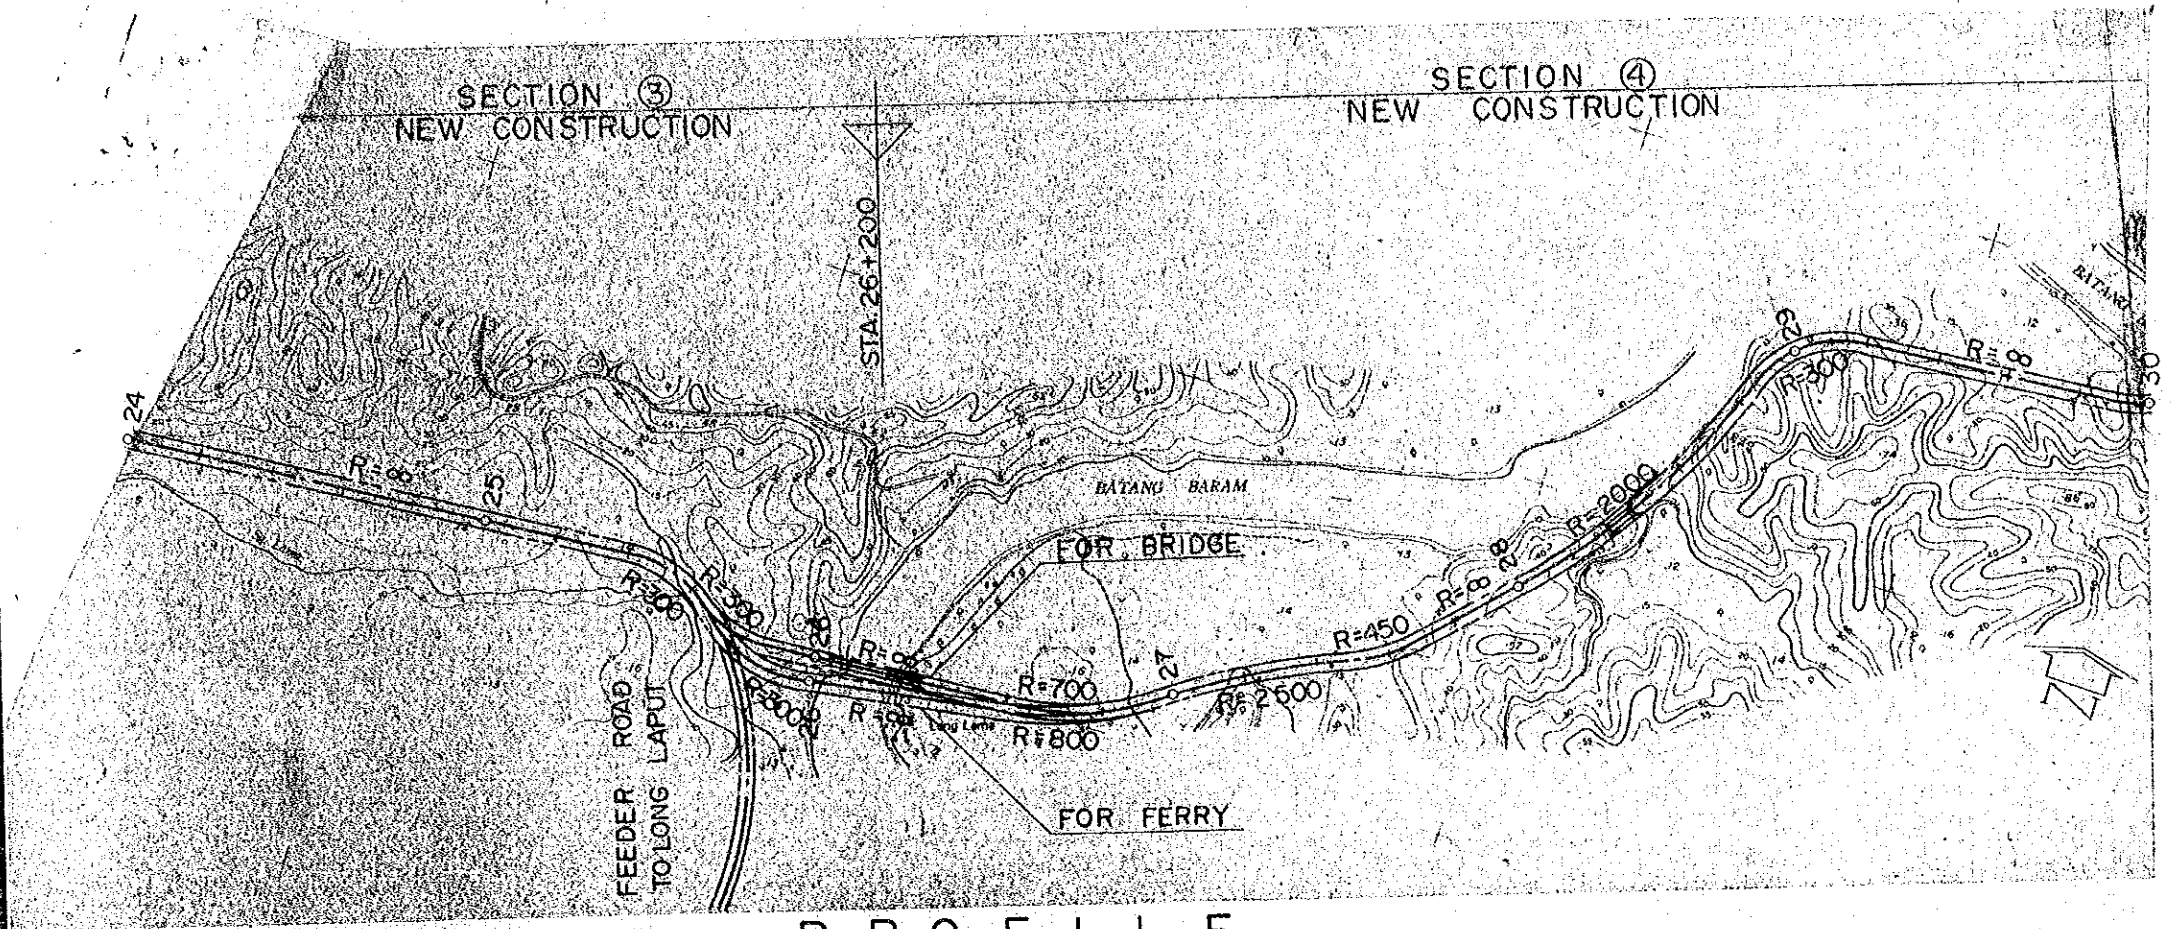


KEY MAP

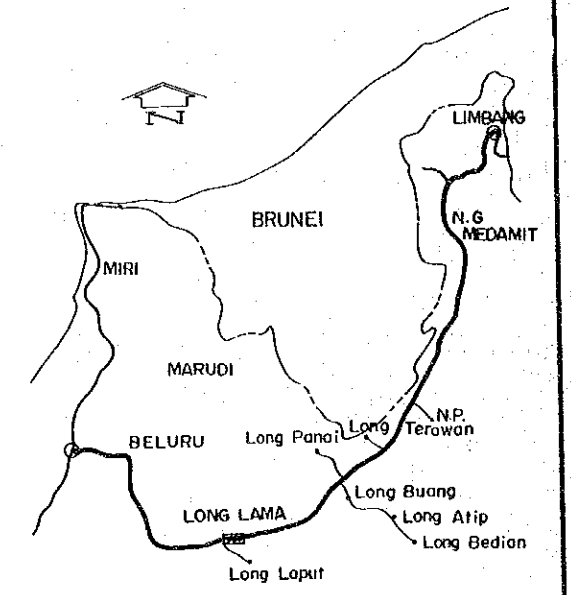


PROFILE

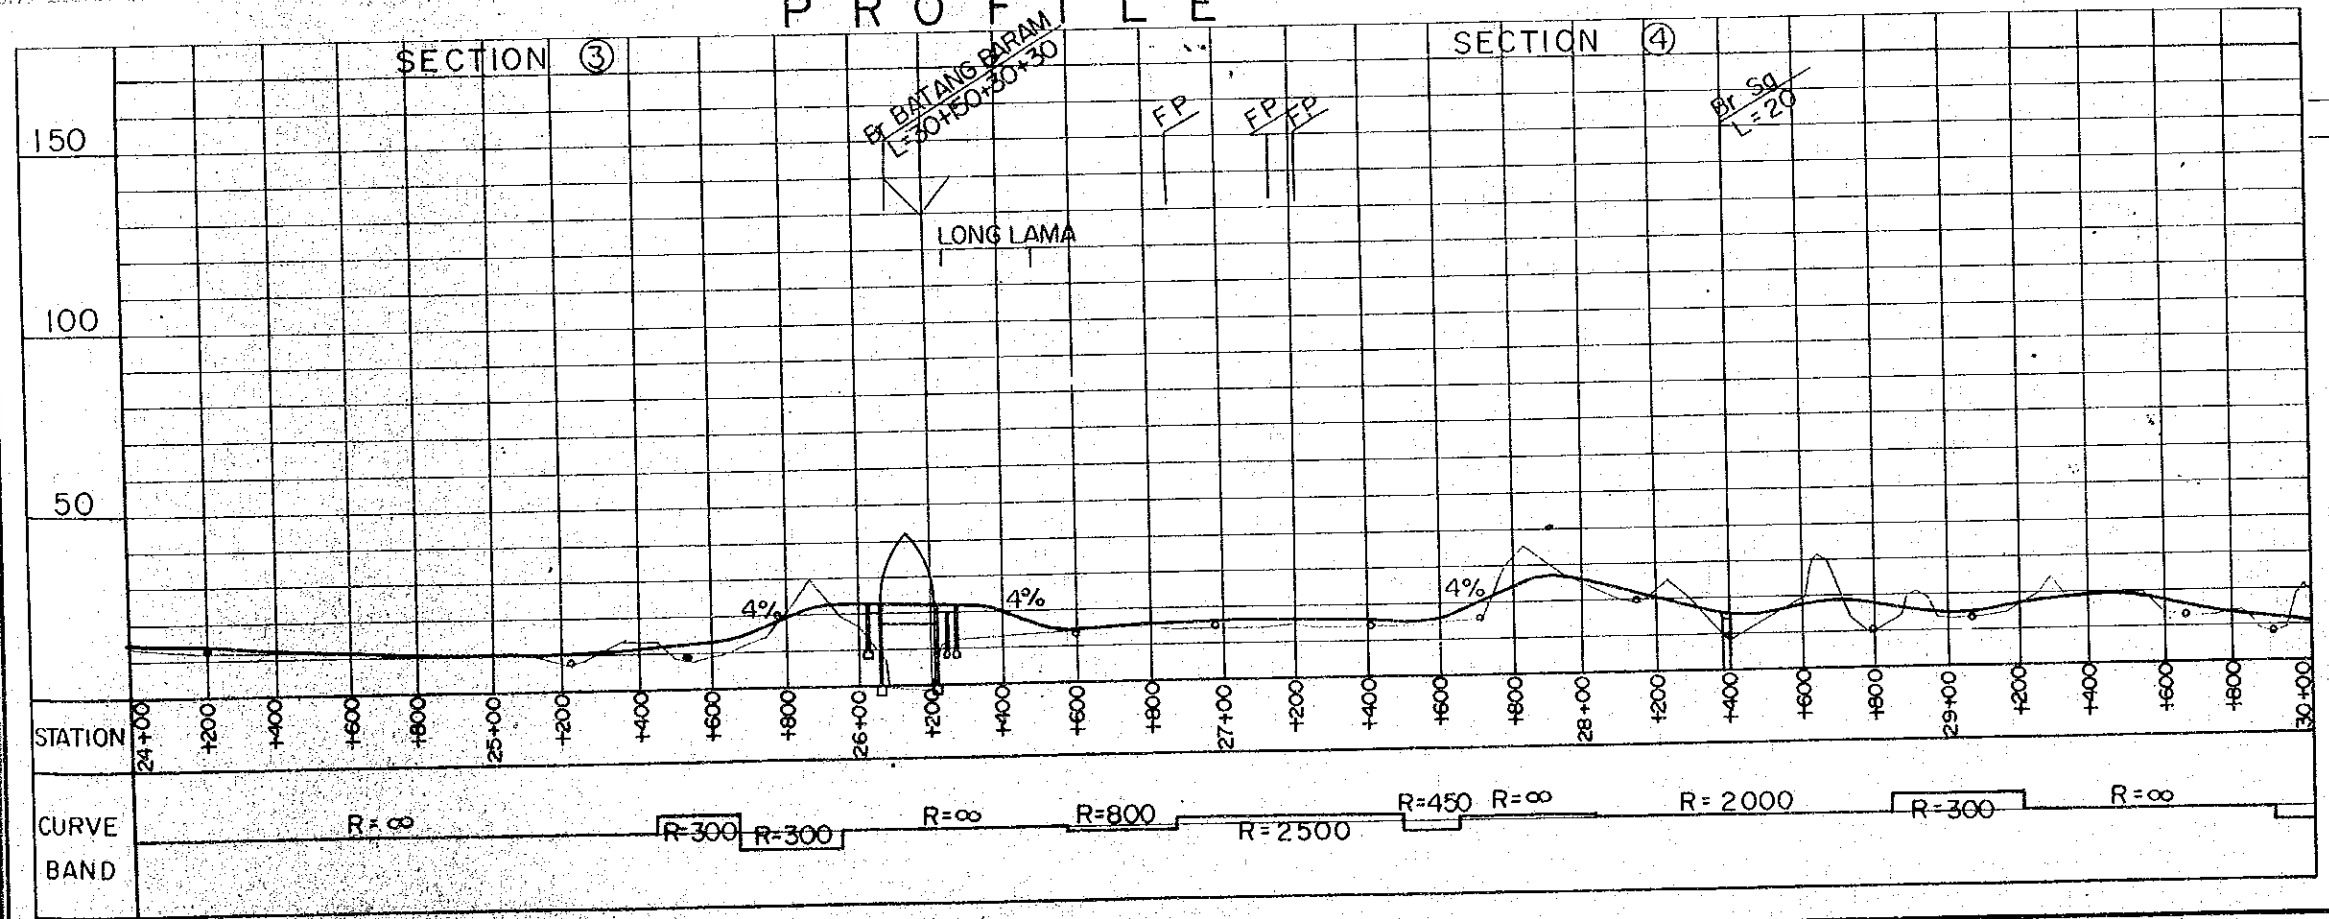

HORIZONTAL ALIGNMENT

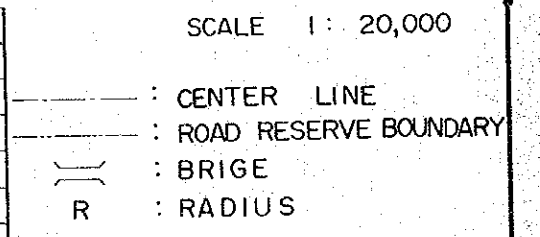



VERTICAL ALIGNMENT

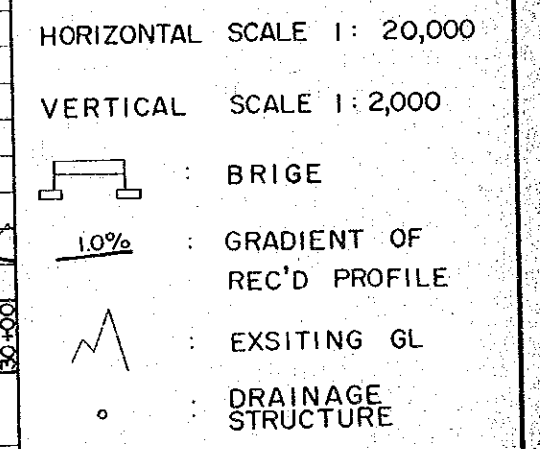

PROJECT	SHEET NO.	TOTAL SHEET
BELURU / LONG LAMA / LIMBANG TRUNK ROAD CONSTRUCTION PROJECT	19	54
PLAN AND PROFILE	SCALE	H = 1 : 20,000 V = 1 : 2,000


PLAN

KEY MAP

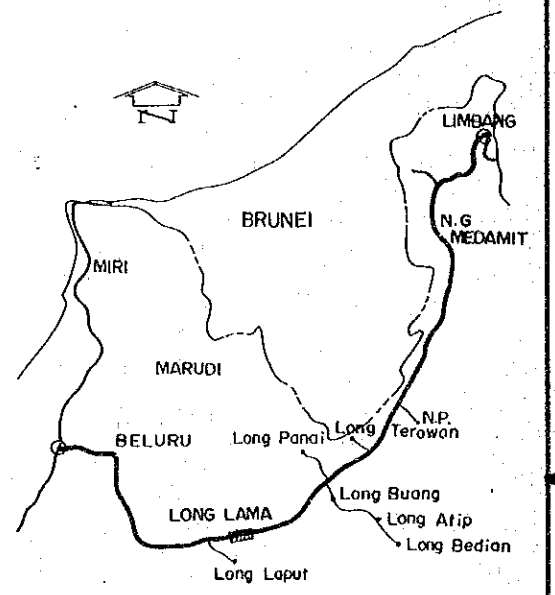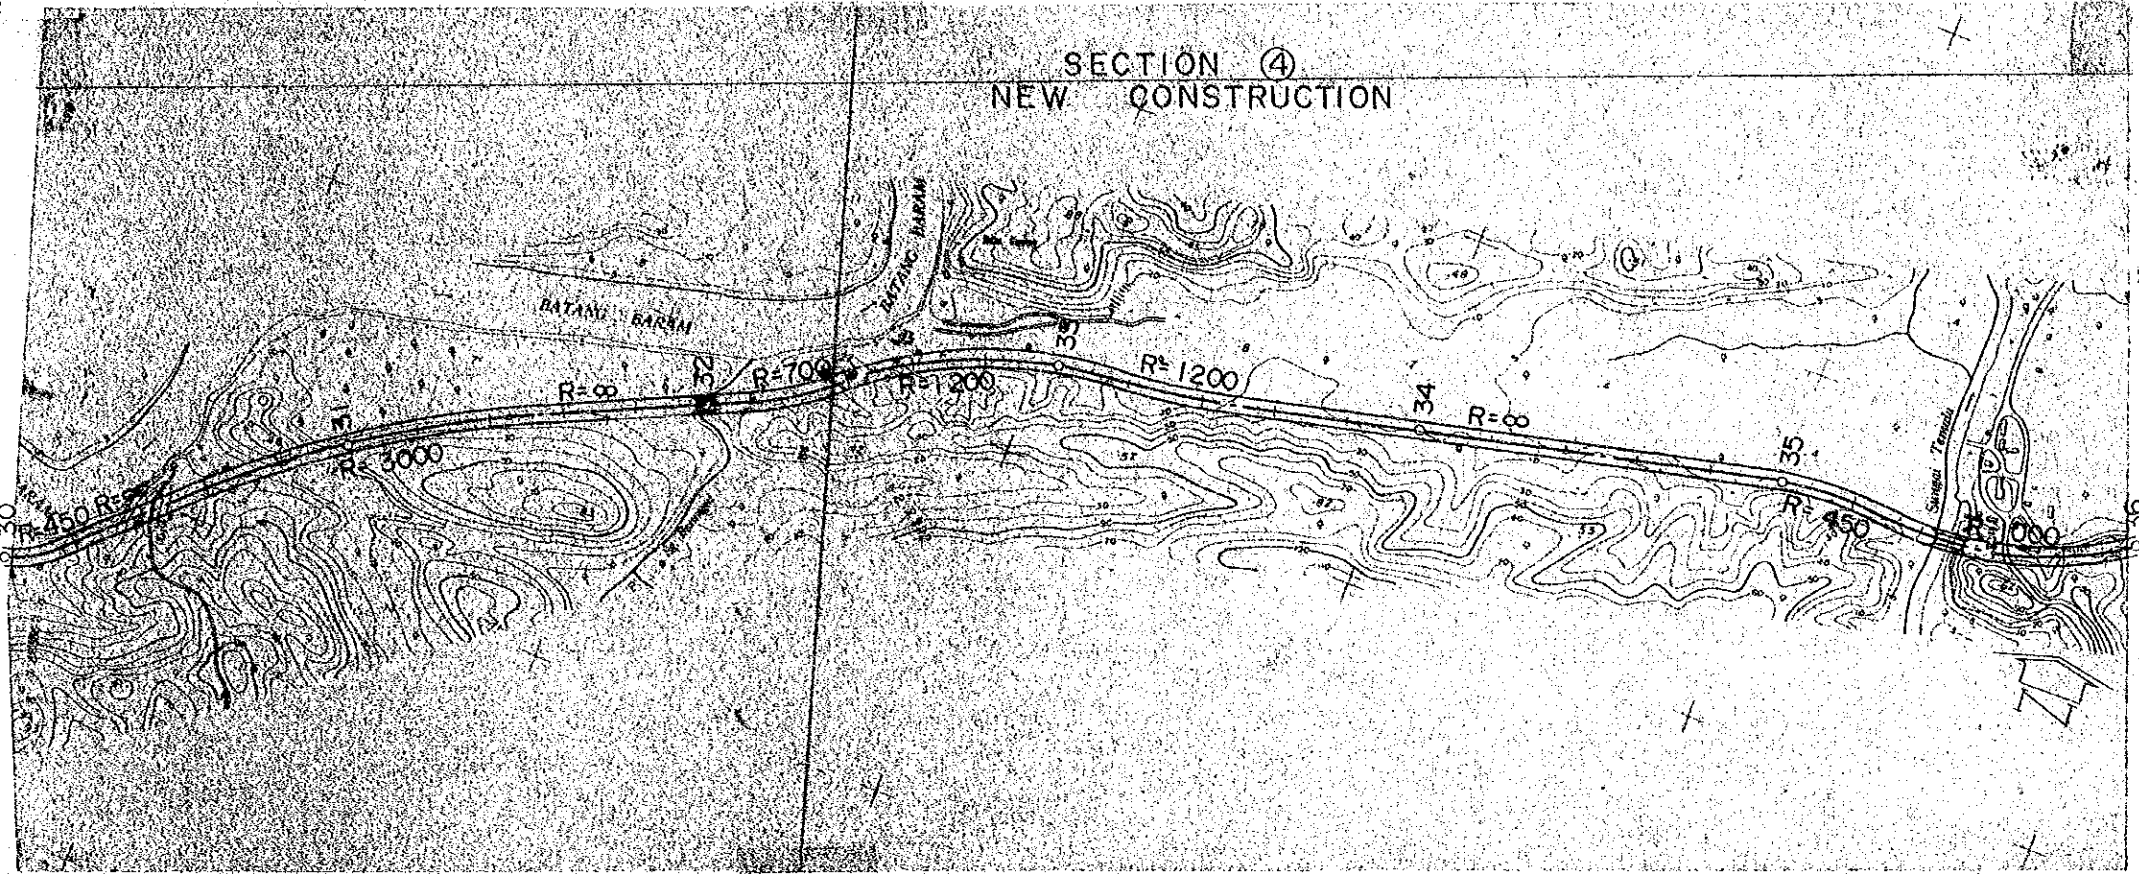

PROFILE



HORIZONTAL ALIGNMENT

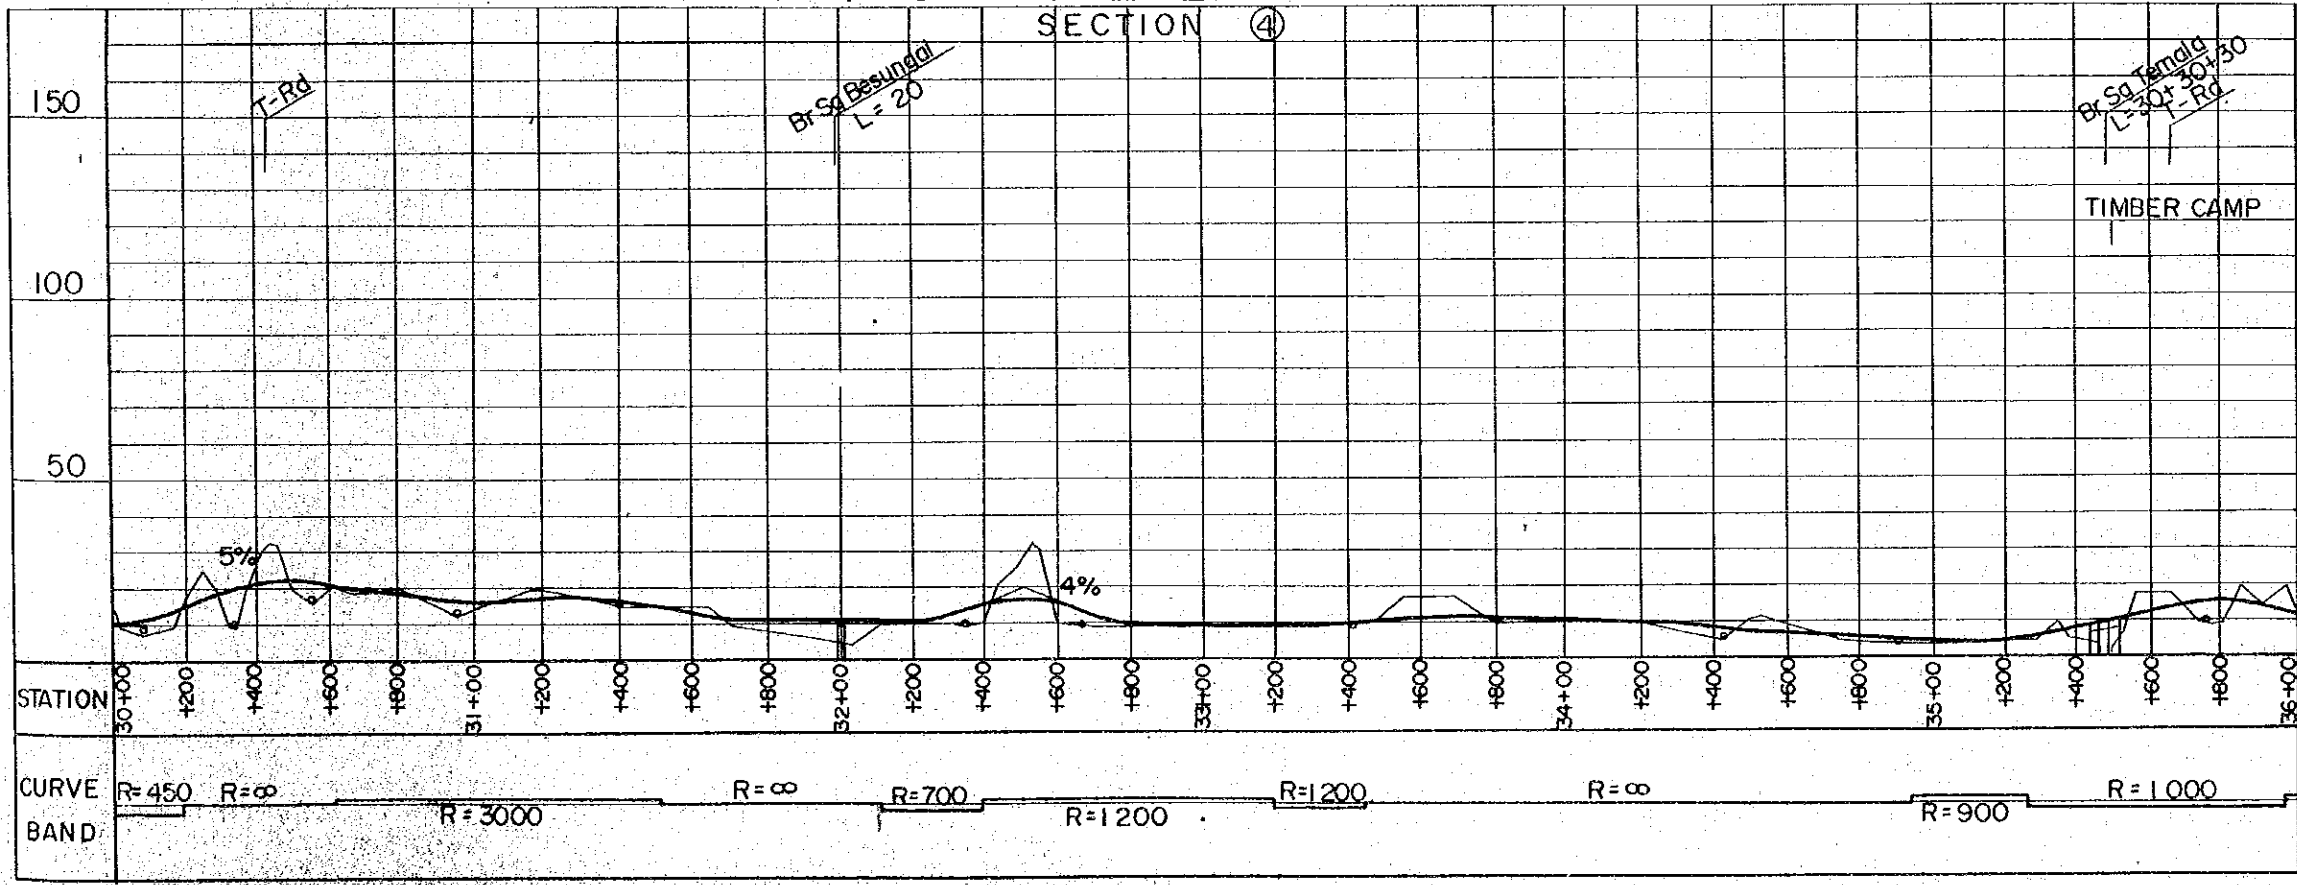


- SCALE 1 : 20,000
- : CENTER LINE
 - : ROAD RESERVE BOUNDARY
 - == : BRIGE
 - R : RADIUS
- VERTICAL ALIGNMENT**
- HORIZONTAL SCALE 1 : 20,000
- VERTICAL SCALE 1 : 2,000
- ▭ : BRIGE
 - 1.0% : GRADIENT OF REC'D PROFILE
 - ⋈ : EXSITING GL
 - : DRAINAGE STRUCTURE

PROJECT	SHEET NO.	TOTAL SHEET
BELURU / LONG LAMA / LIMBANG TRUNK ROAD CONSTRUCTION PROJECT	20	54
PLAN AND PROFILE	SCALE	H = 1: 20,000 V = 1: 2,000

PLAN

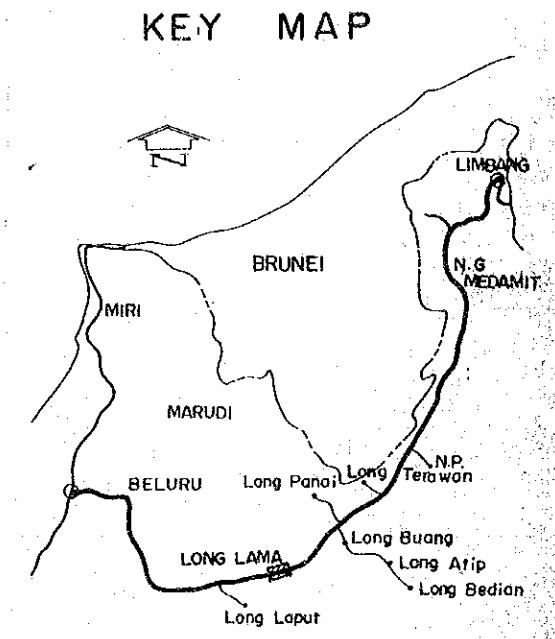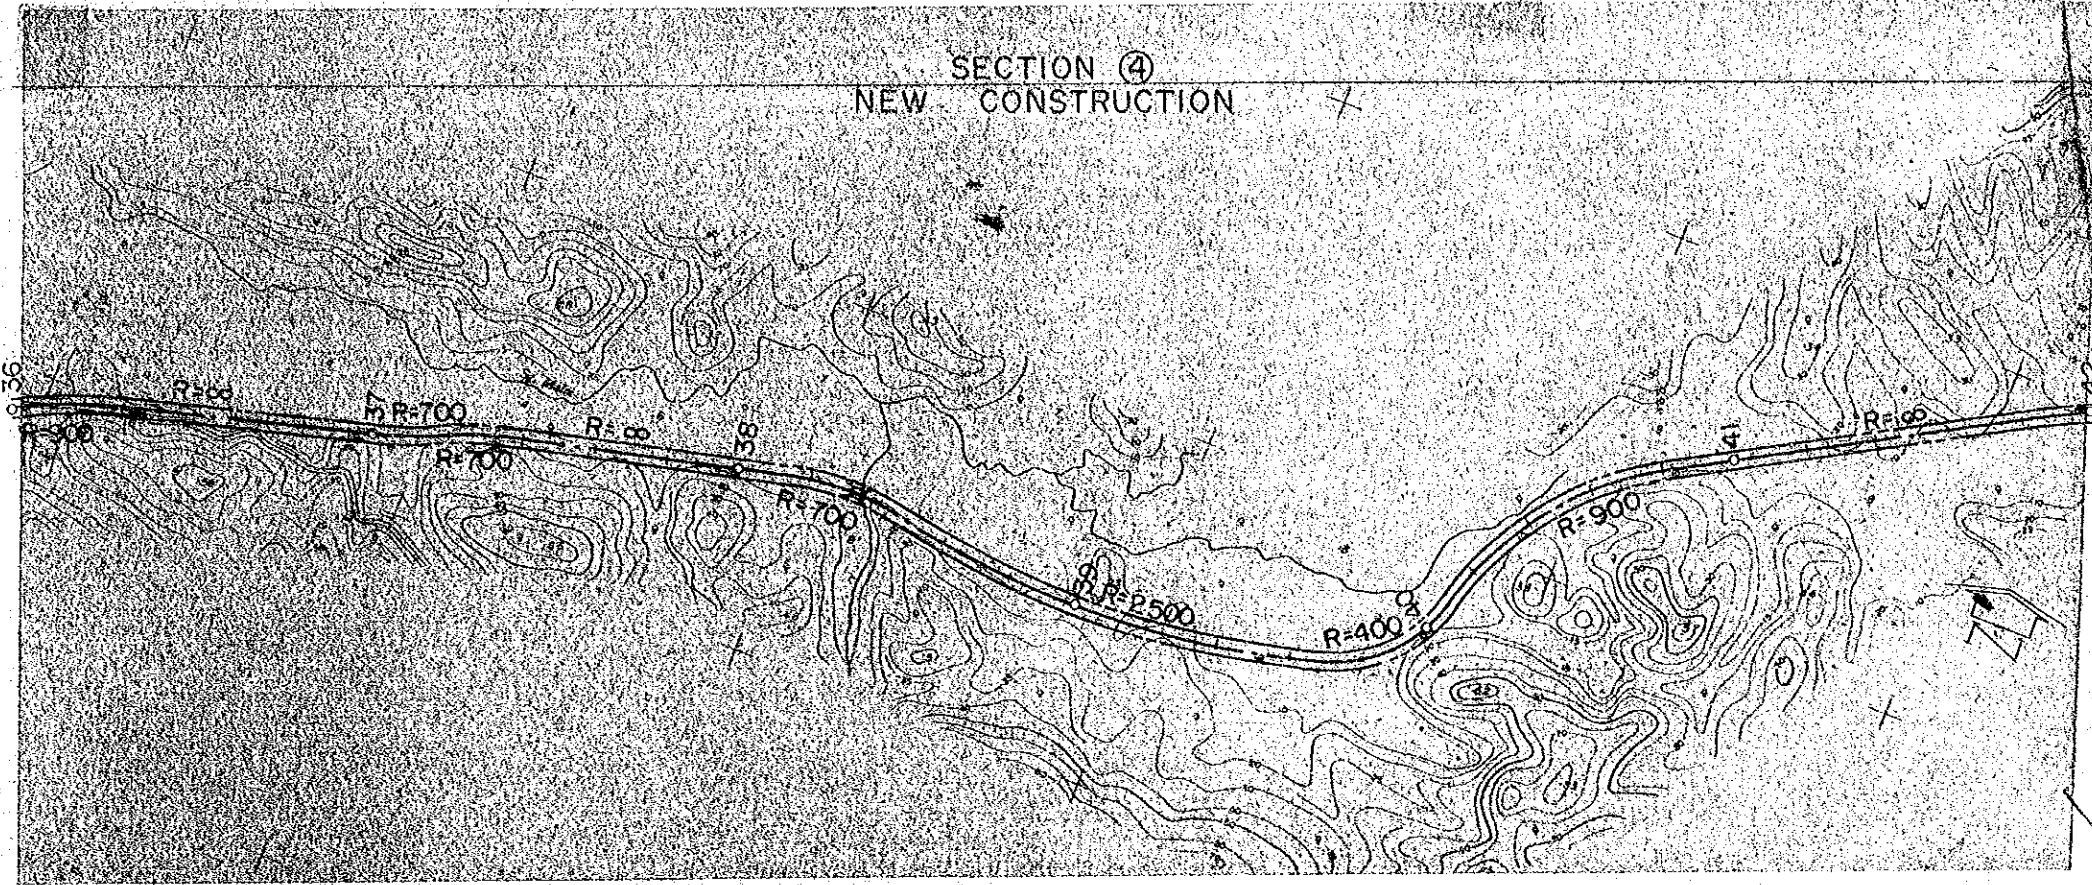



PROFILE

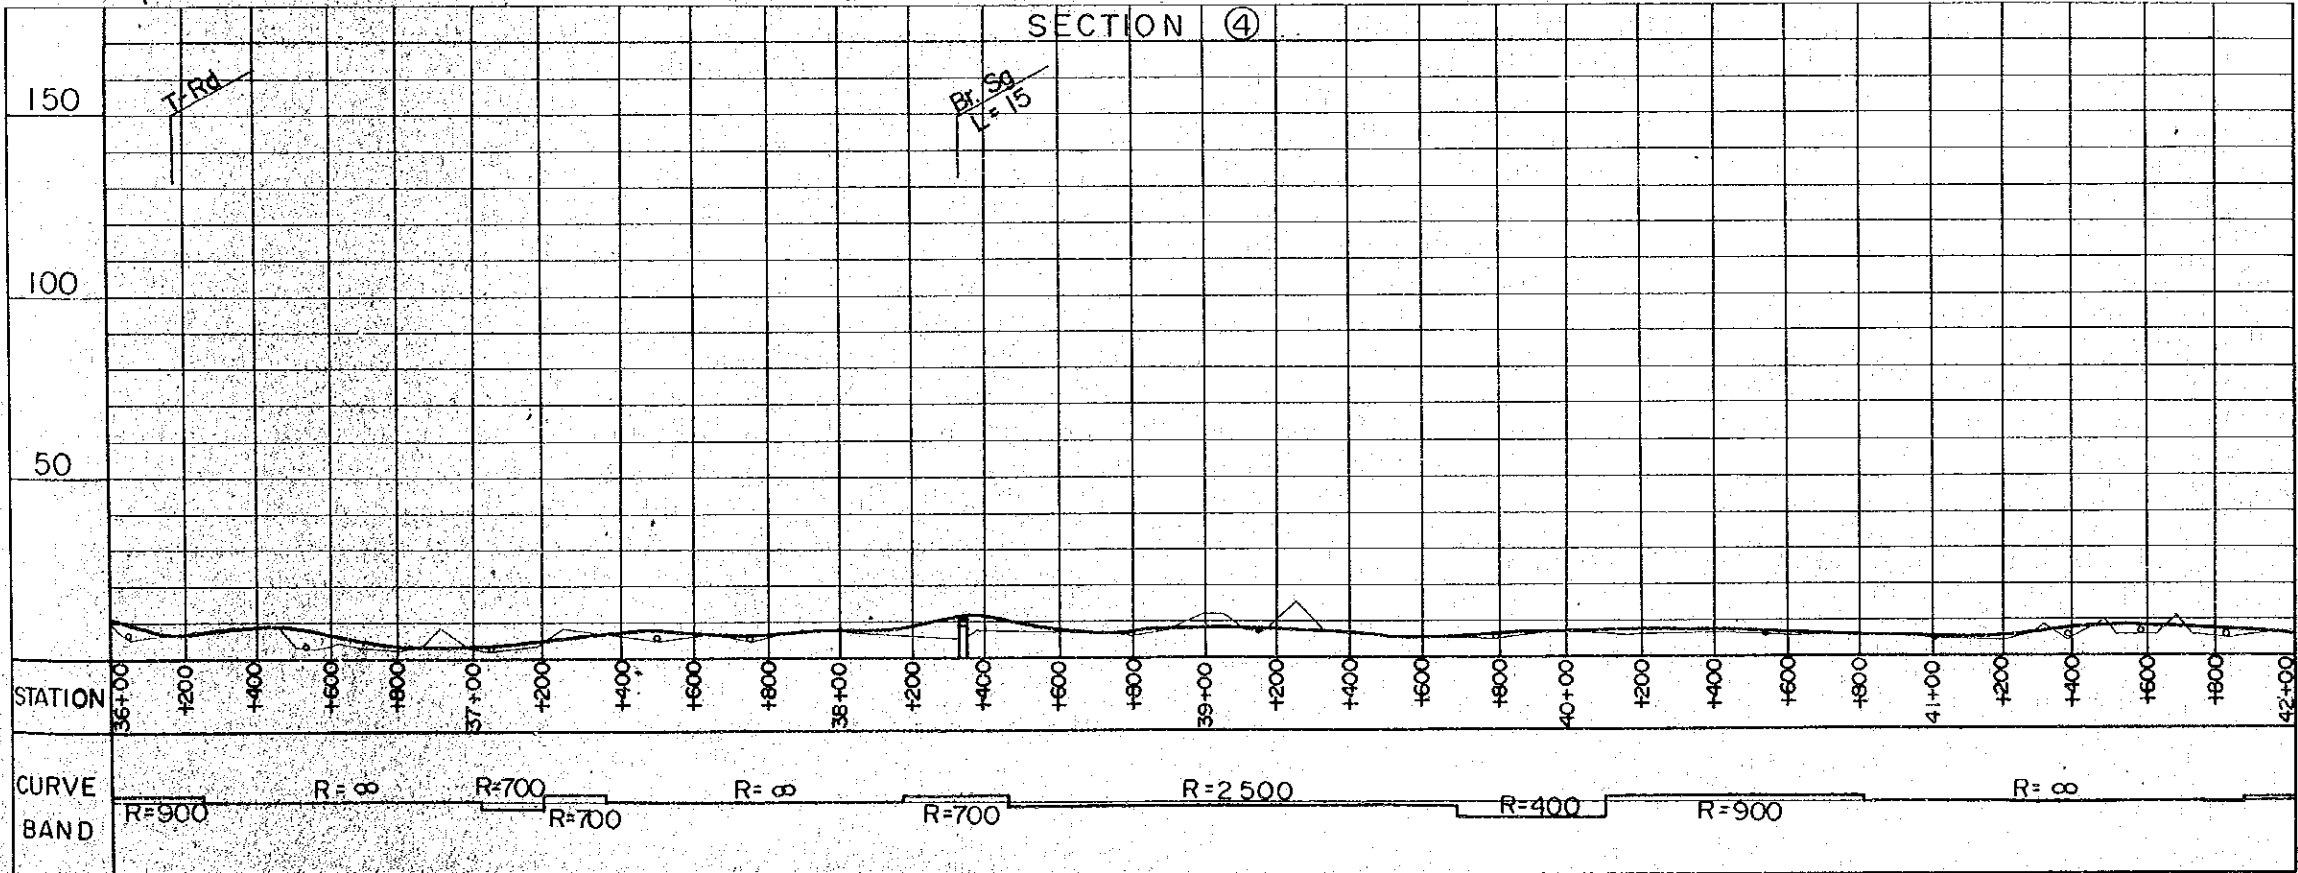


- HORIZONTAL ALIGNMENT**
- SCALE 1: 20,000
- : CENTER LINE
 - : ROAD RESERVE BOUNDARY
 - : BRIGE
 - R : RADIUS
- VERTICAL ALIGNMENT**
- HORIZONTAL SCALE 1: 20,000
- VERTICAL SCALE 1: 2,000
- : BRIGE
 - 1.0% : GRADIENT OF REC'D PROFILE
 - : EXSITING GL
 - o : DRAINAGE STRUCTURE

PROJECT	SHEET NO.	TOTAL SHEET
BELURU / LONG LAMA / LIMBANG TRUNK ROAD CONSTRUCTION PROJECT	21	54
PLAN AND PROFILE	SCALE	H=1:20,000 V=1:2,000

PLAN

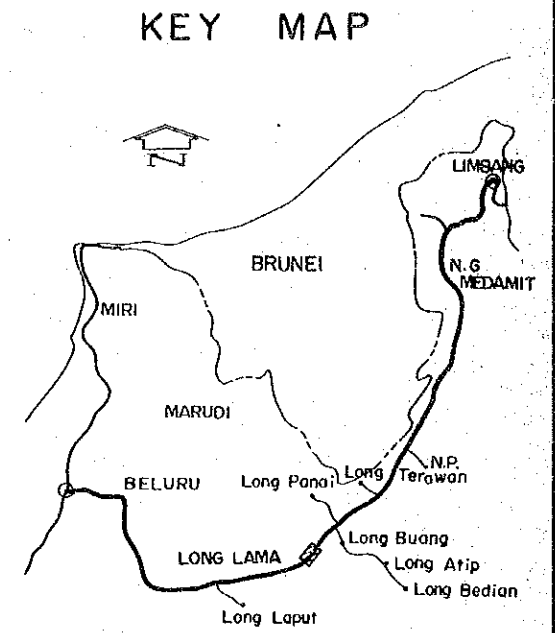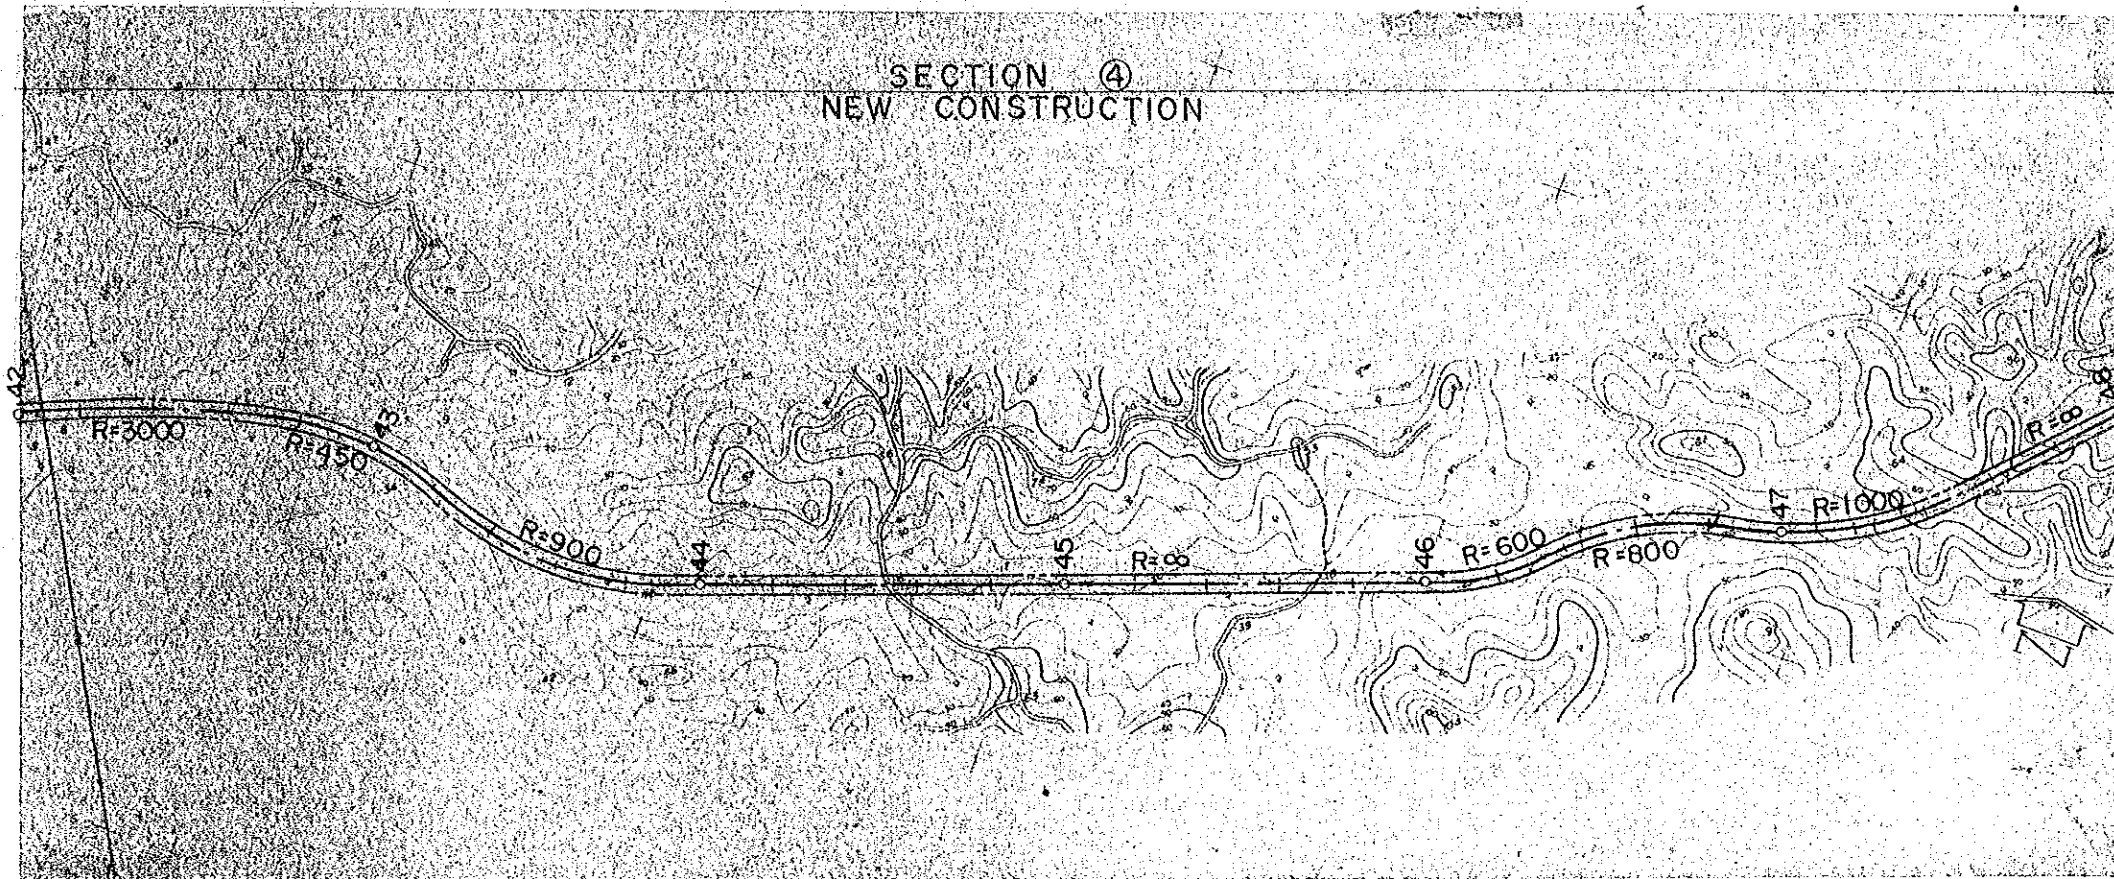



PROFILE

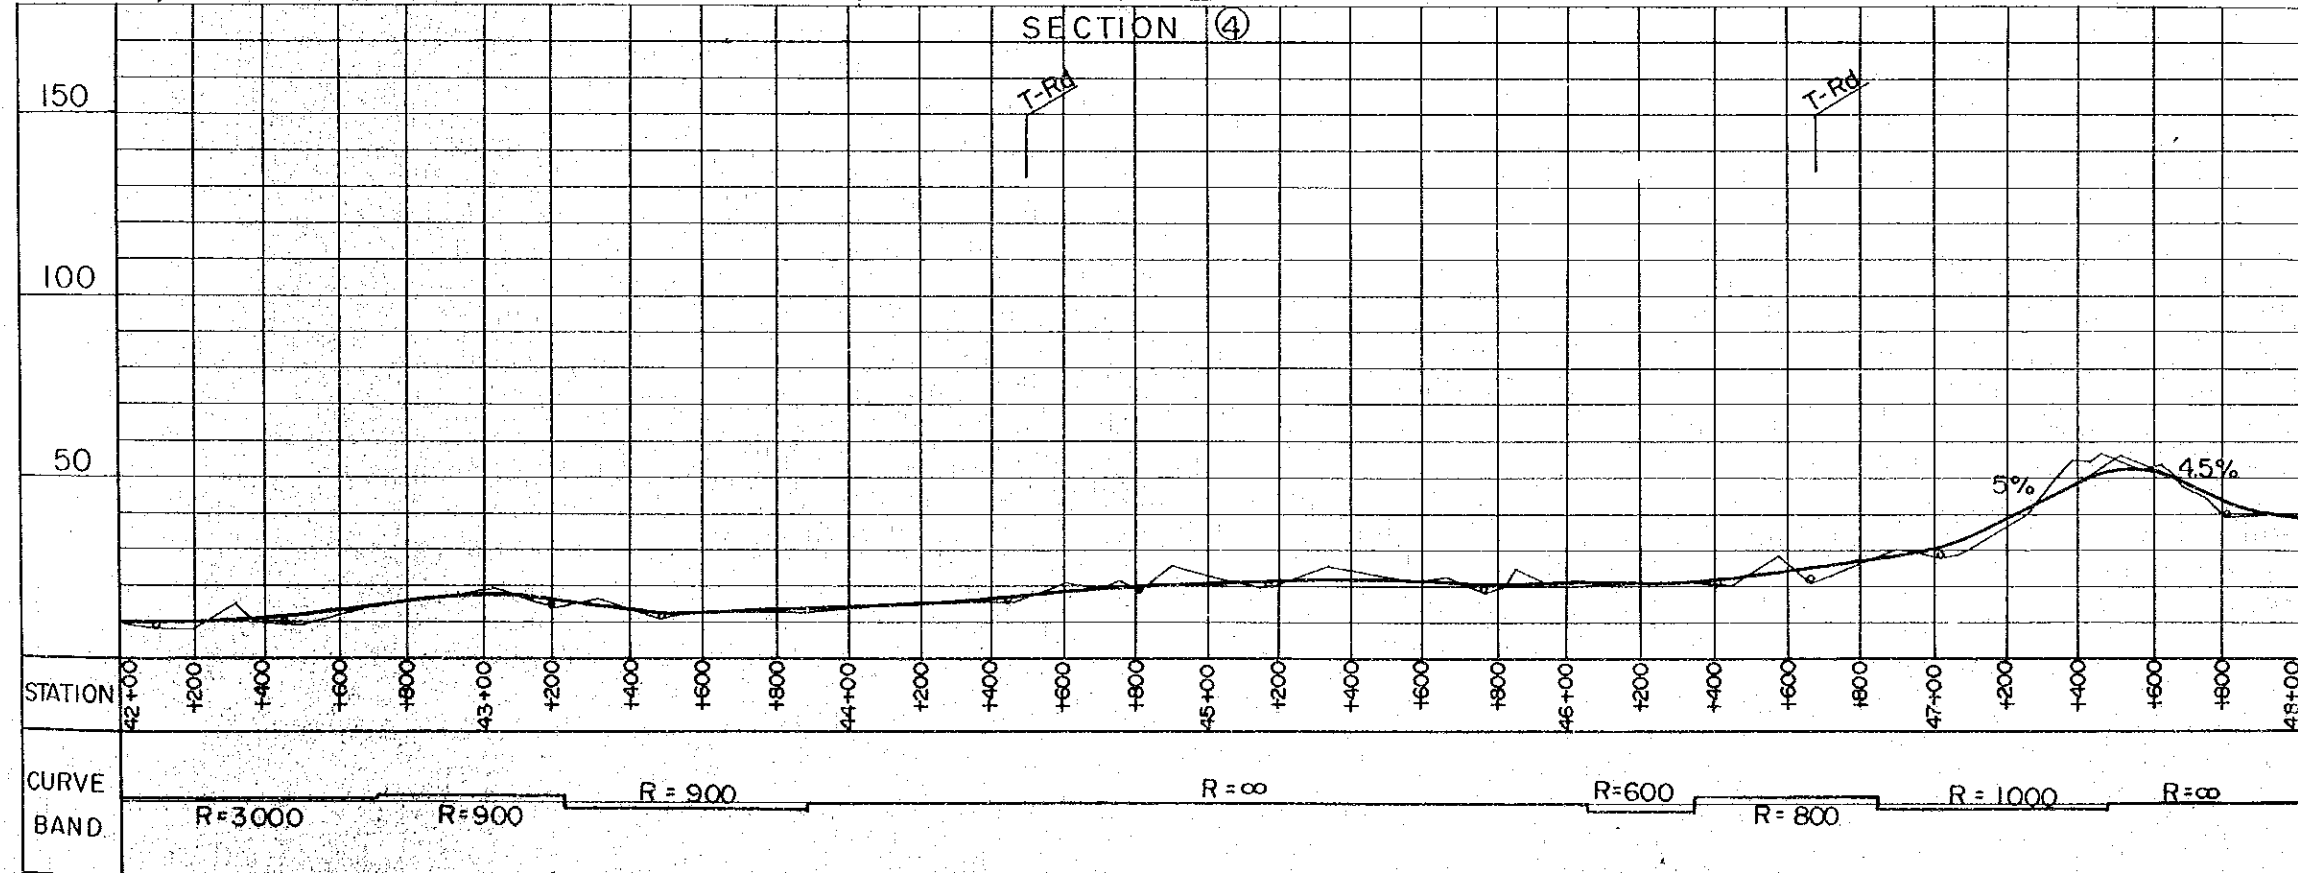


- HORIZONTAL ALIGNMENT**
- SCALE 1 : 20,000
- : CENTER LINE
 - : ROAD RESERVE BOUNDARY
 - : BRIGE
 - R : RADIUS
- VERTICAL ALIGNMENT**
- HORIZONTAL SCALE 1 : 20,000
- VERTICAL SCALE 1 : 2,000
- : BRIGE
 - 1.0% : GRADIENT OF REC'D PROFILE
 - : EXSITING GL
 - o : DRAINAGE STRUCTURE

PROJECT BELURU / LONG LAMA / LIMBANG TRUNK ROAD CONSTRUCTION PROJECT	SHEET NO.	TOTAL SHEET
	22	54
PLAN AND PROFILE		SCALE H = 1: 20,000 V = 1: 2,000

PLAN

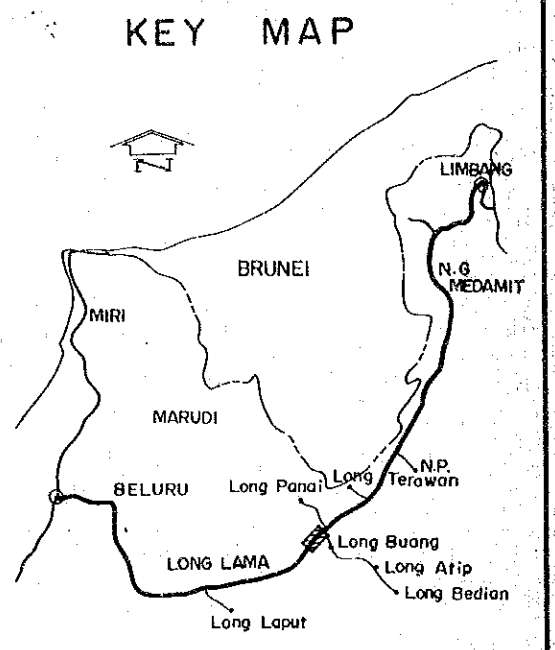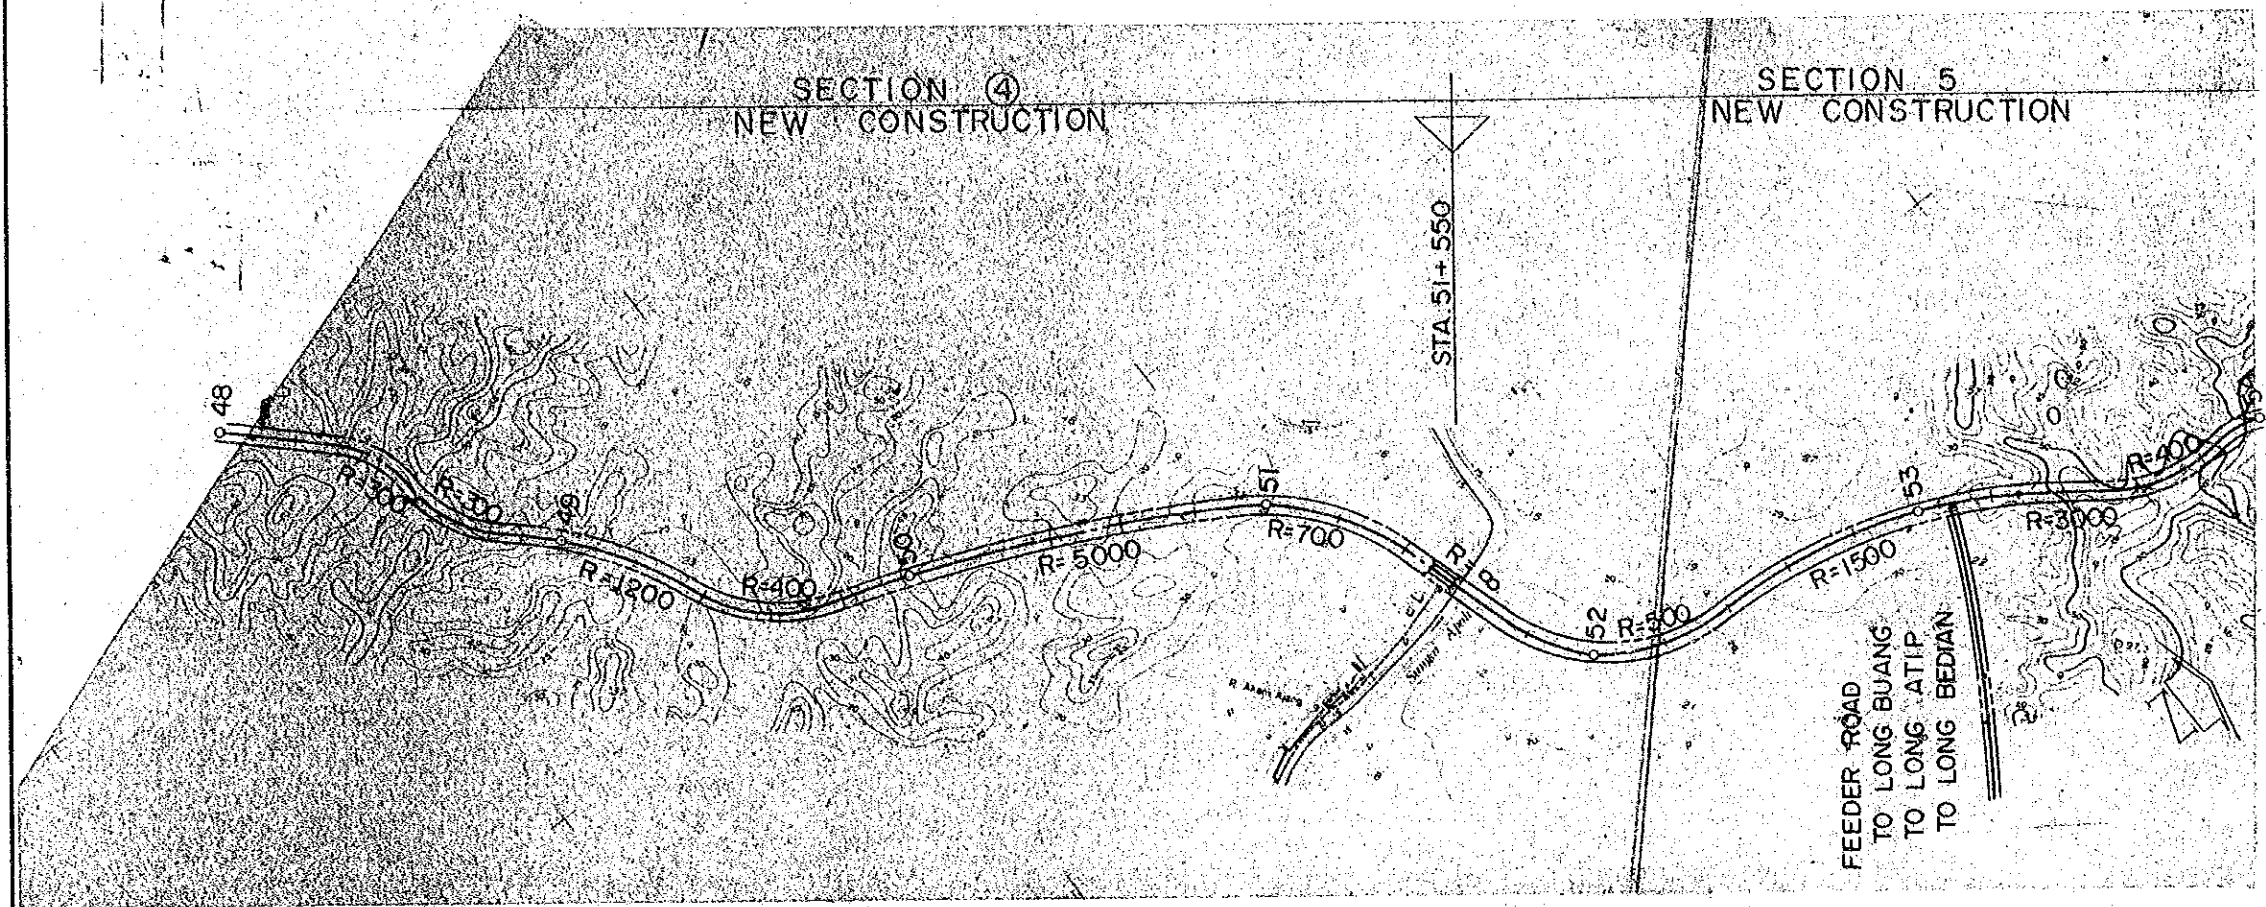



PROFILE

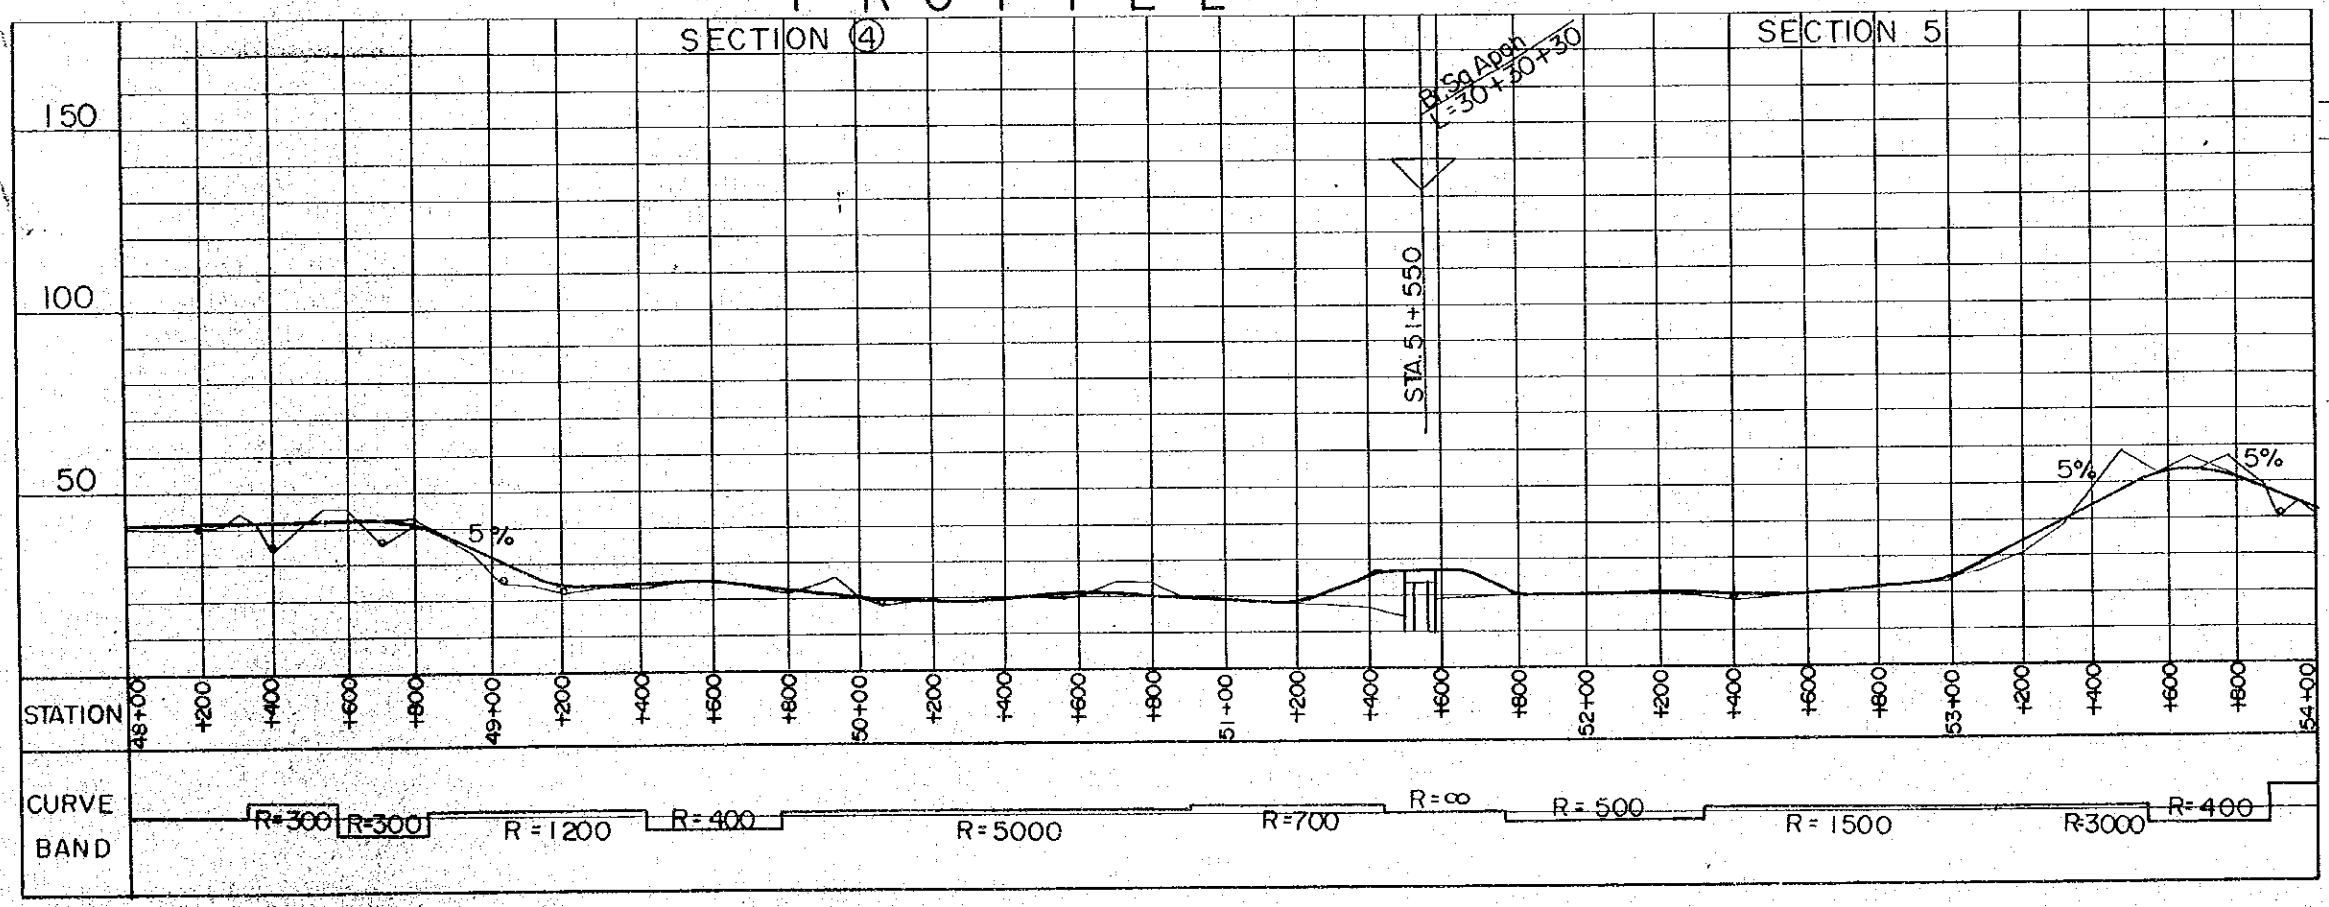


- HORIZONTAL ALIGNMENT**
SCALE 1: 20,000
- : CENTER LINE
 - : ROAD RESERVE BOUNDARY
 - || : BRIGE
 - R : RADIUS
- VERTICAL ALIGNMENT**
HORIZONTAL SCALE 1: 20,000
VERTICAL SCALE 1: 2,000
- : BRIGE
 - 10% : GRADIENT OF REC'D PROFILE
 - : EXSITING GL
 - o : DRAINAGE STRUCTURE

PROJECT	SHEET NO.	TOTAL SHEET
BELURU / LONG LAMA / LIMBANG TRUNK ROAD CONSTRUCTION PROJECT	23	54
PLAN AND PROFILE	SCALE	H = 1: 20,000 V = 1: 2,000

PLAN

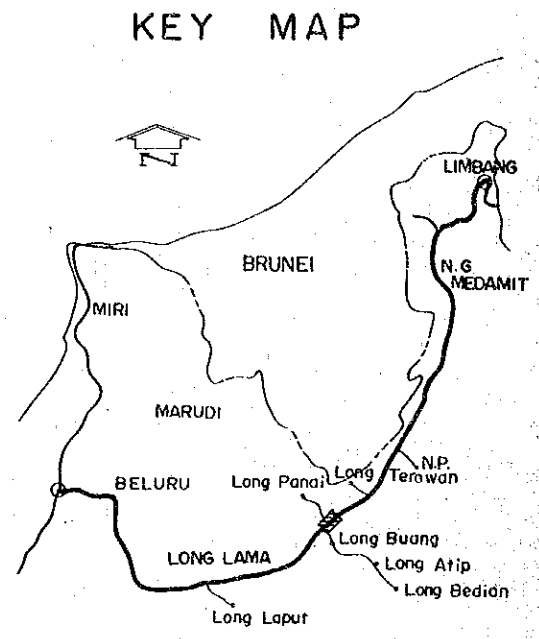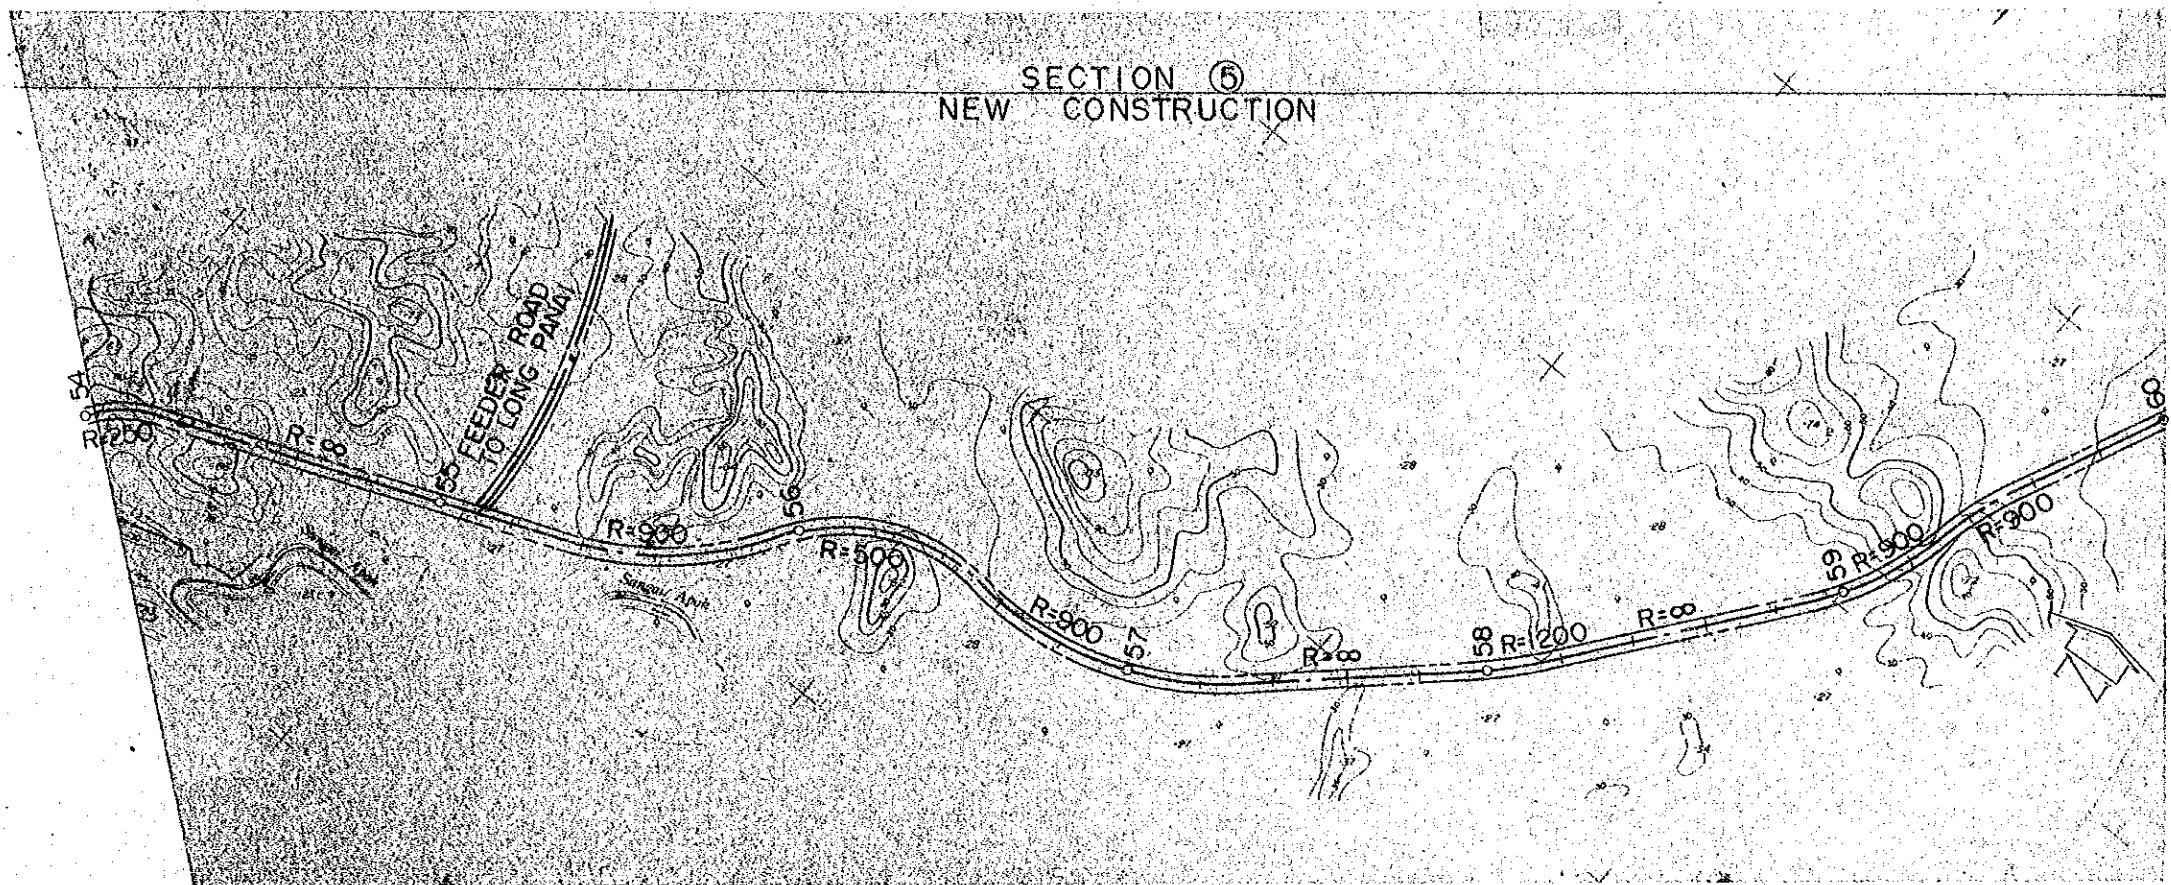

PROFILE

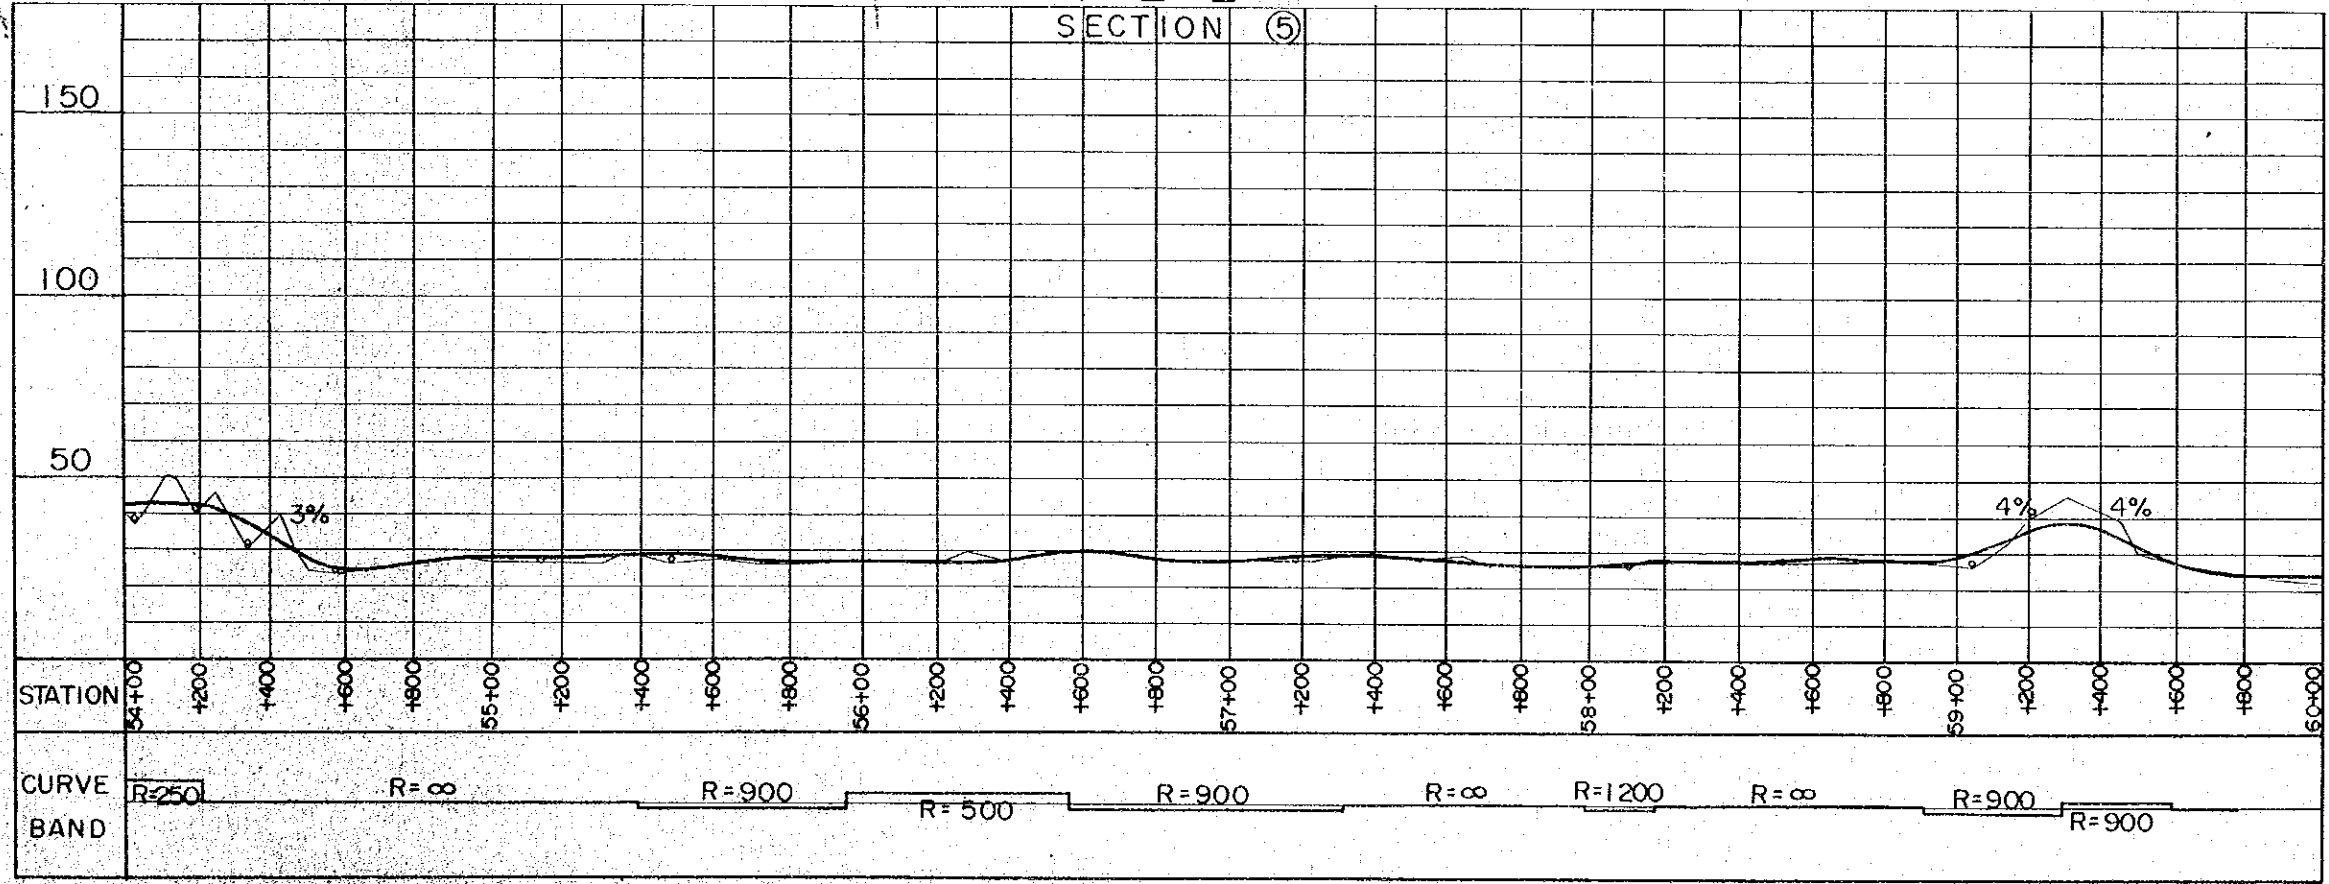

HORIZONTAL ALIGNMENT


- SCALE 1: 20,000
- : CENTER LINE
 - : ROAD RESERVE BOUNDARY
 - || : BRIDGE
 - R : RADIUS

VERTICAL ALIGNMENT


- HORIZONTAL SCALE 1: 20,000
VERTICAL SCALE 1: 2,000
- : BRIDGE
 - 10% : GRADIENT OF REC'D PROFILE
 - : EXSITING GL
 - o : DRAINAGE STRUCTURE

PROJECT	SHEET NO.	TOTAL SHEET
BELURU / LONG LAMA / LIMBANG TRUNK ROAD CONSTRUCTION PROJECT	24	54
PLAN AND PROFILE	SCALE	H=1:20,000 V=1:2,000


PLAN

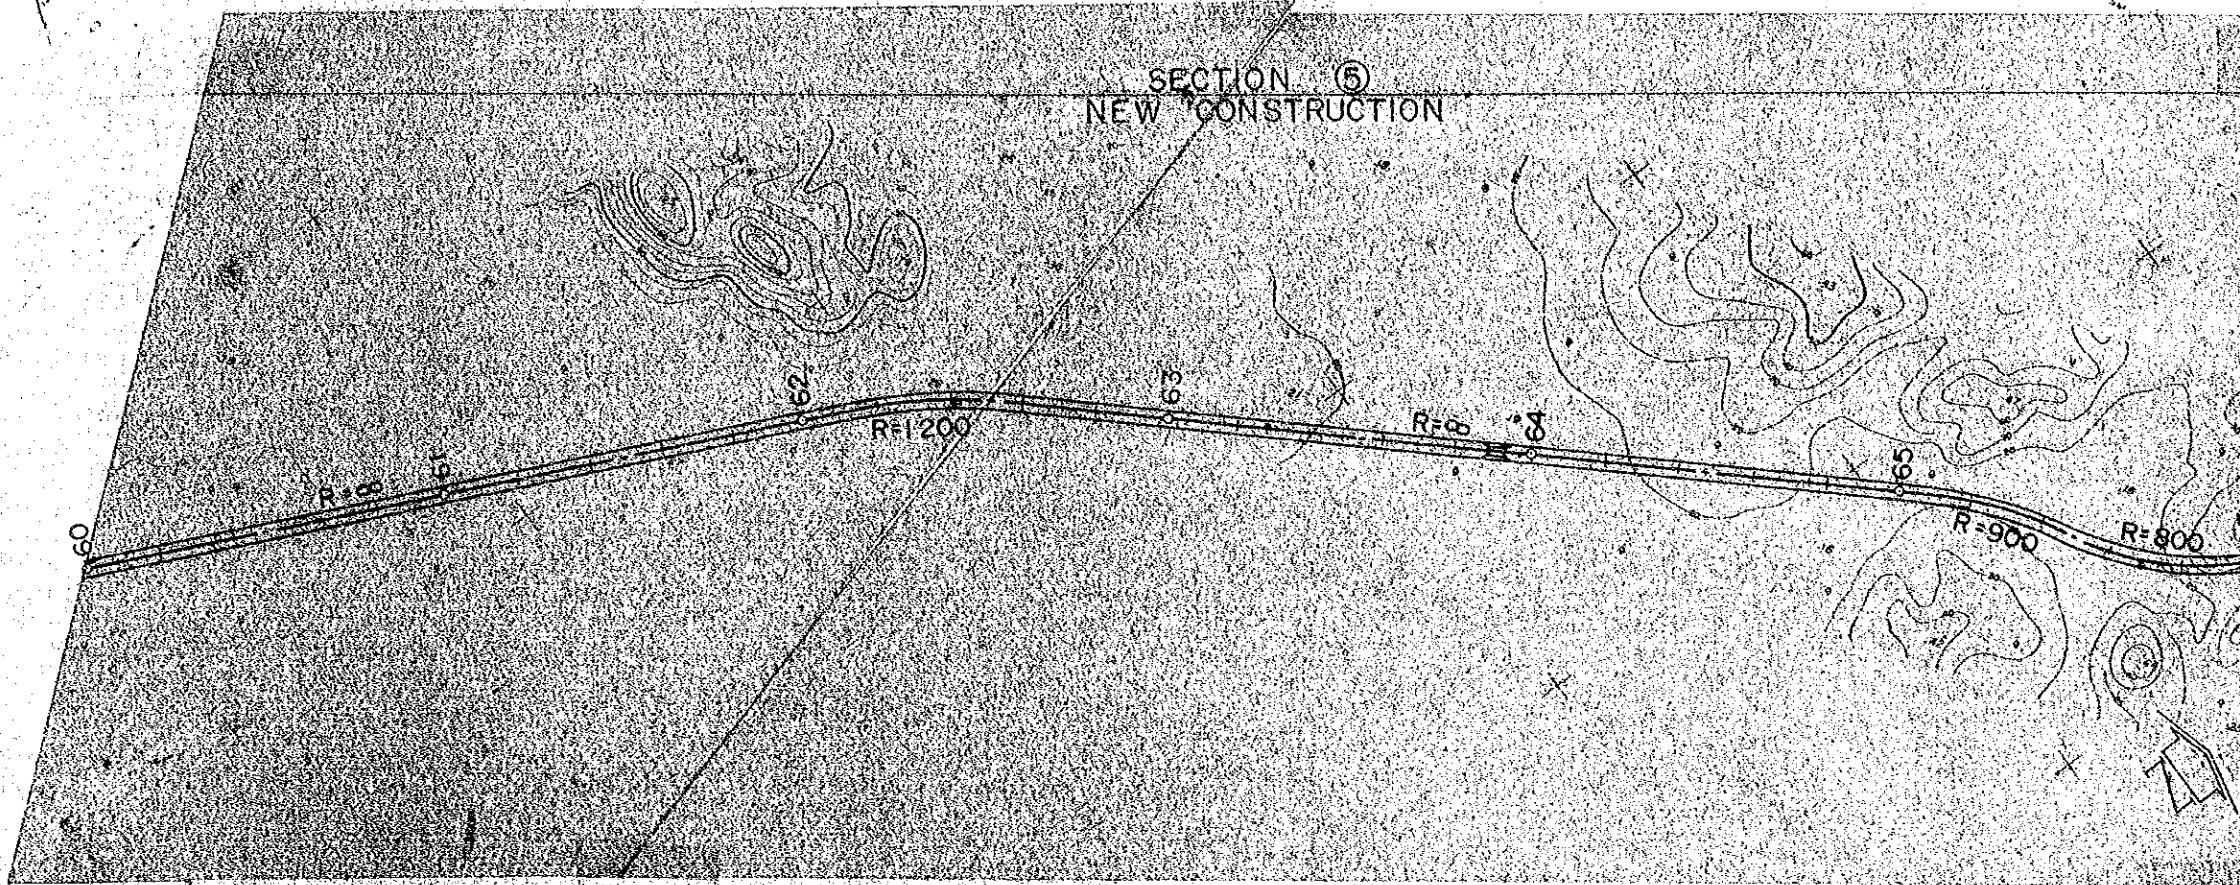

KEY MAP

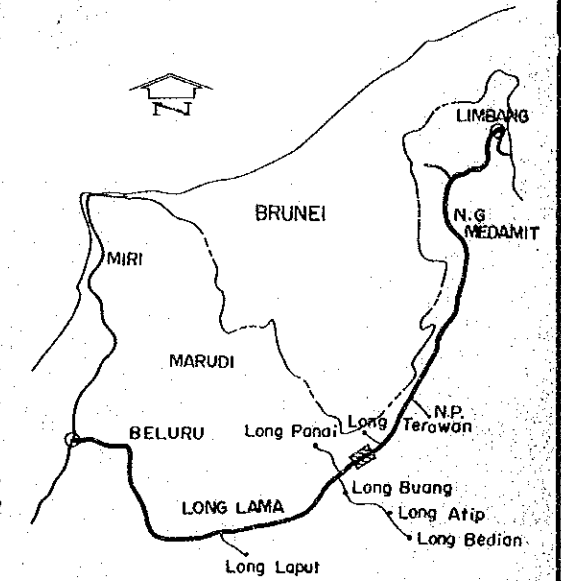

PROFILE

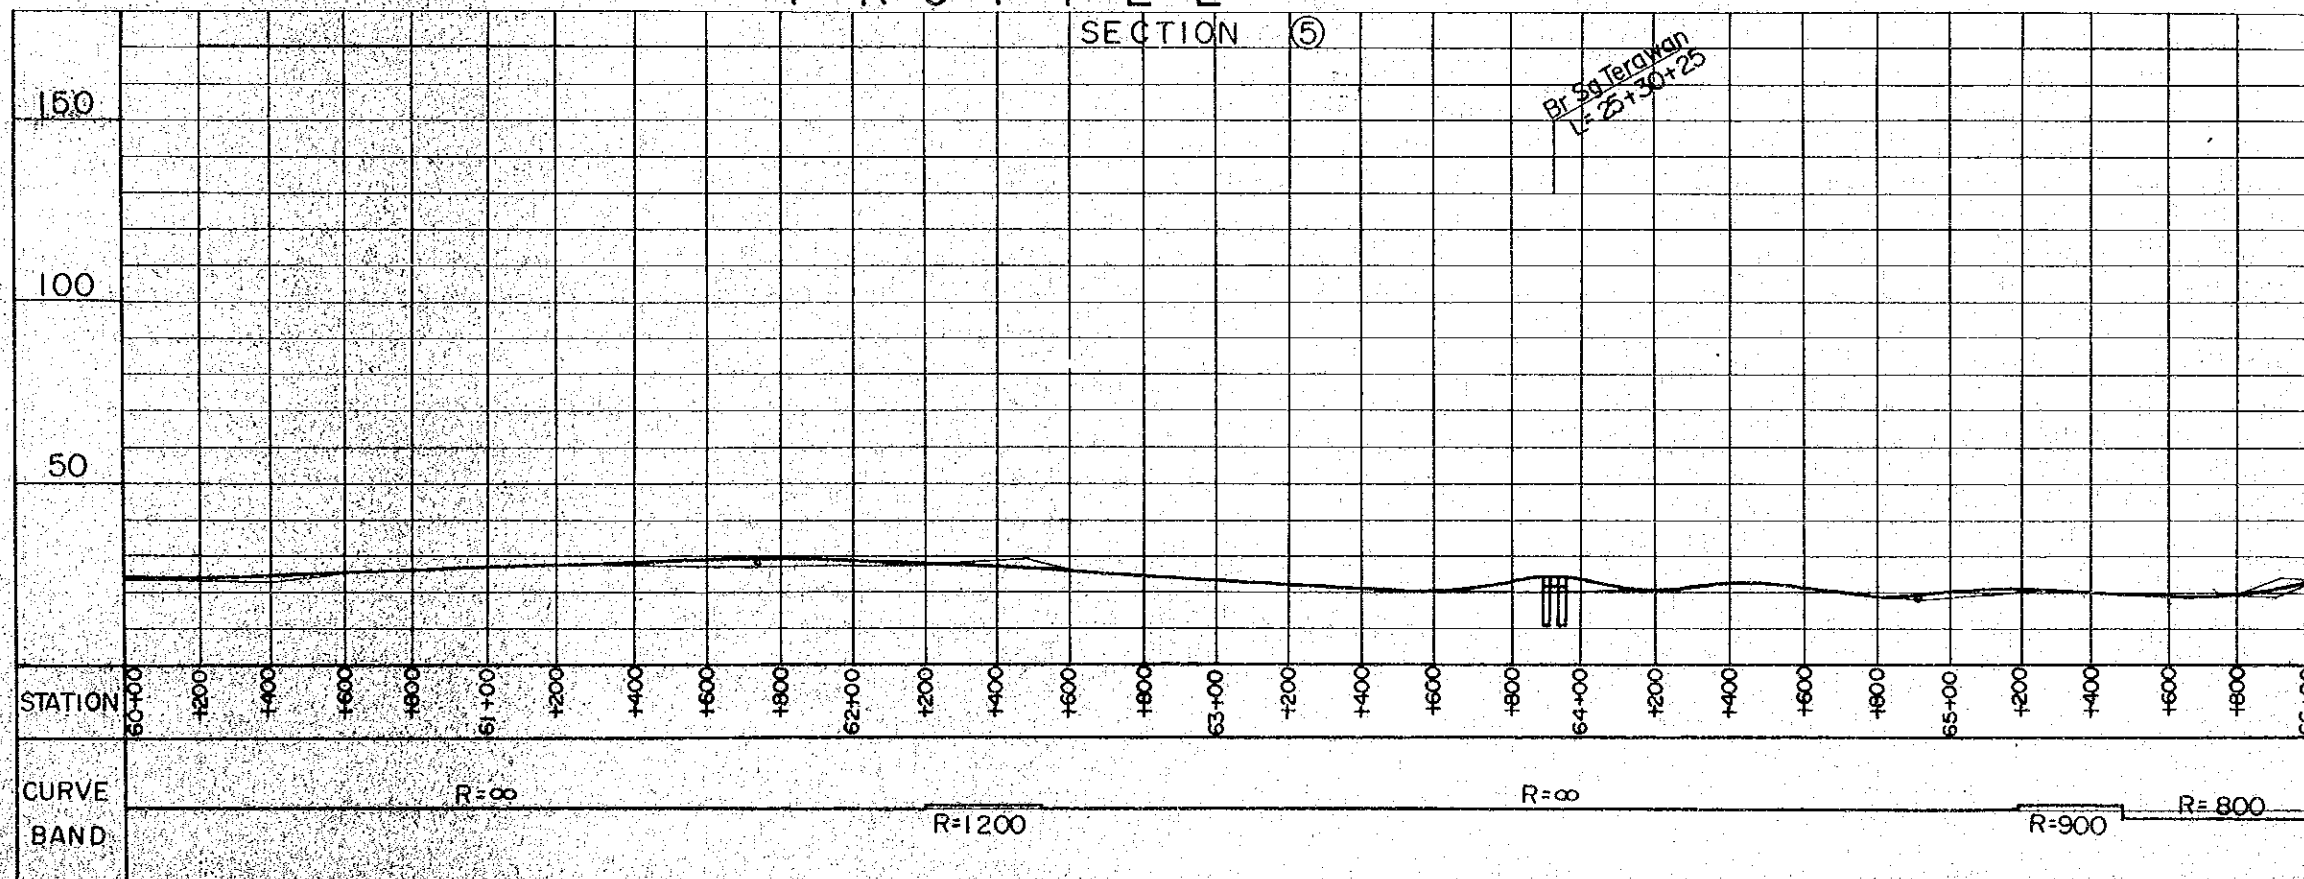

HORIZONTAL ALIGNMENT



- SCALE 1: 20,000
- : CENTER LINE
 - : ROAD RESERVE BOUNDARY
 - : BRIGE
 - R : RADIUS

VERTICAL ALIGNMENT


- HORIZONTAL SCALE 1: 20,000
VERTICAL SCALE 1: 2,000
- : BRIGE
 - 10% : GRADIENT OF REC'D PROFILE
 - : EXSITING GL
 - : DRAINAGE STRUCTURE

PROJECT	SHEET NO.	TOTAL SHEET
BELURU / LONG LAMA / LIMBANG TRUNK ROAD CONSTRUCTION PROJECT	25	54
PLAN AND PROFILE	SCALE	H=1:20,000 V=1:2,000

PLAN

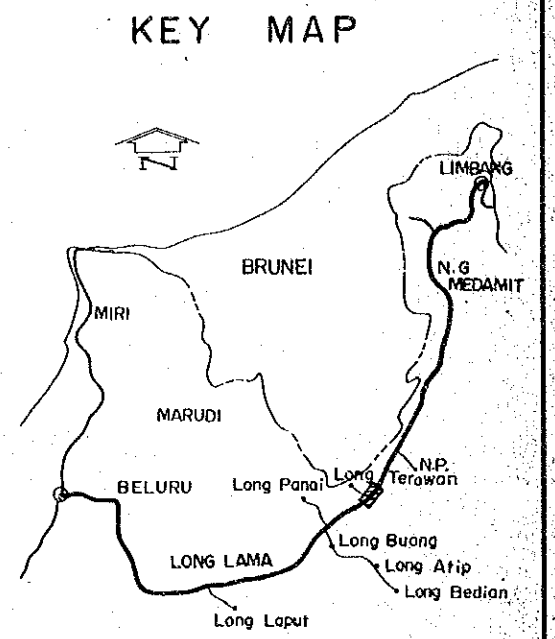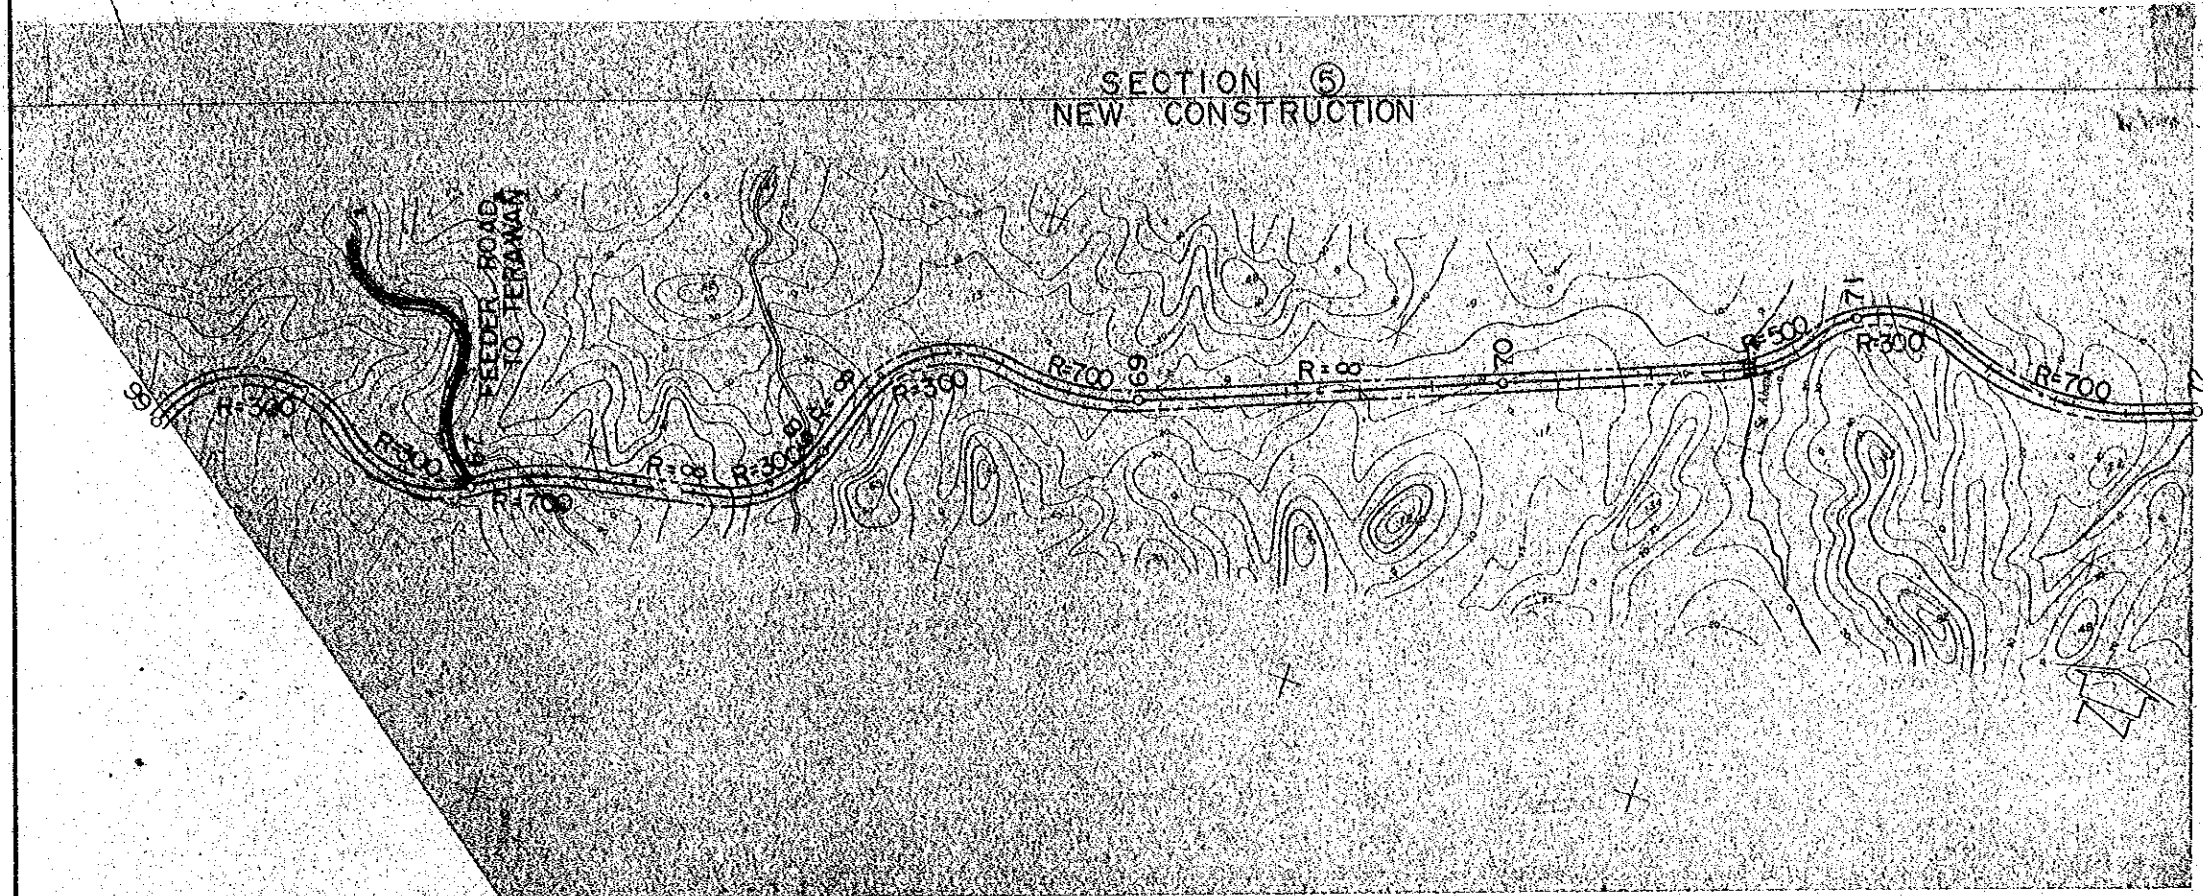



PROFILE

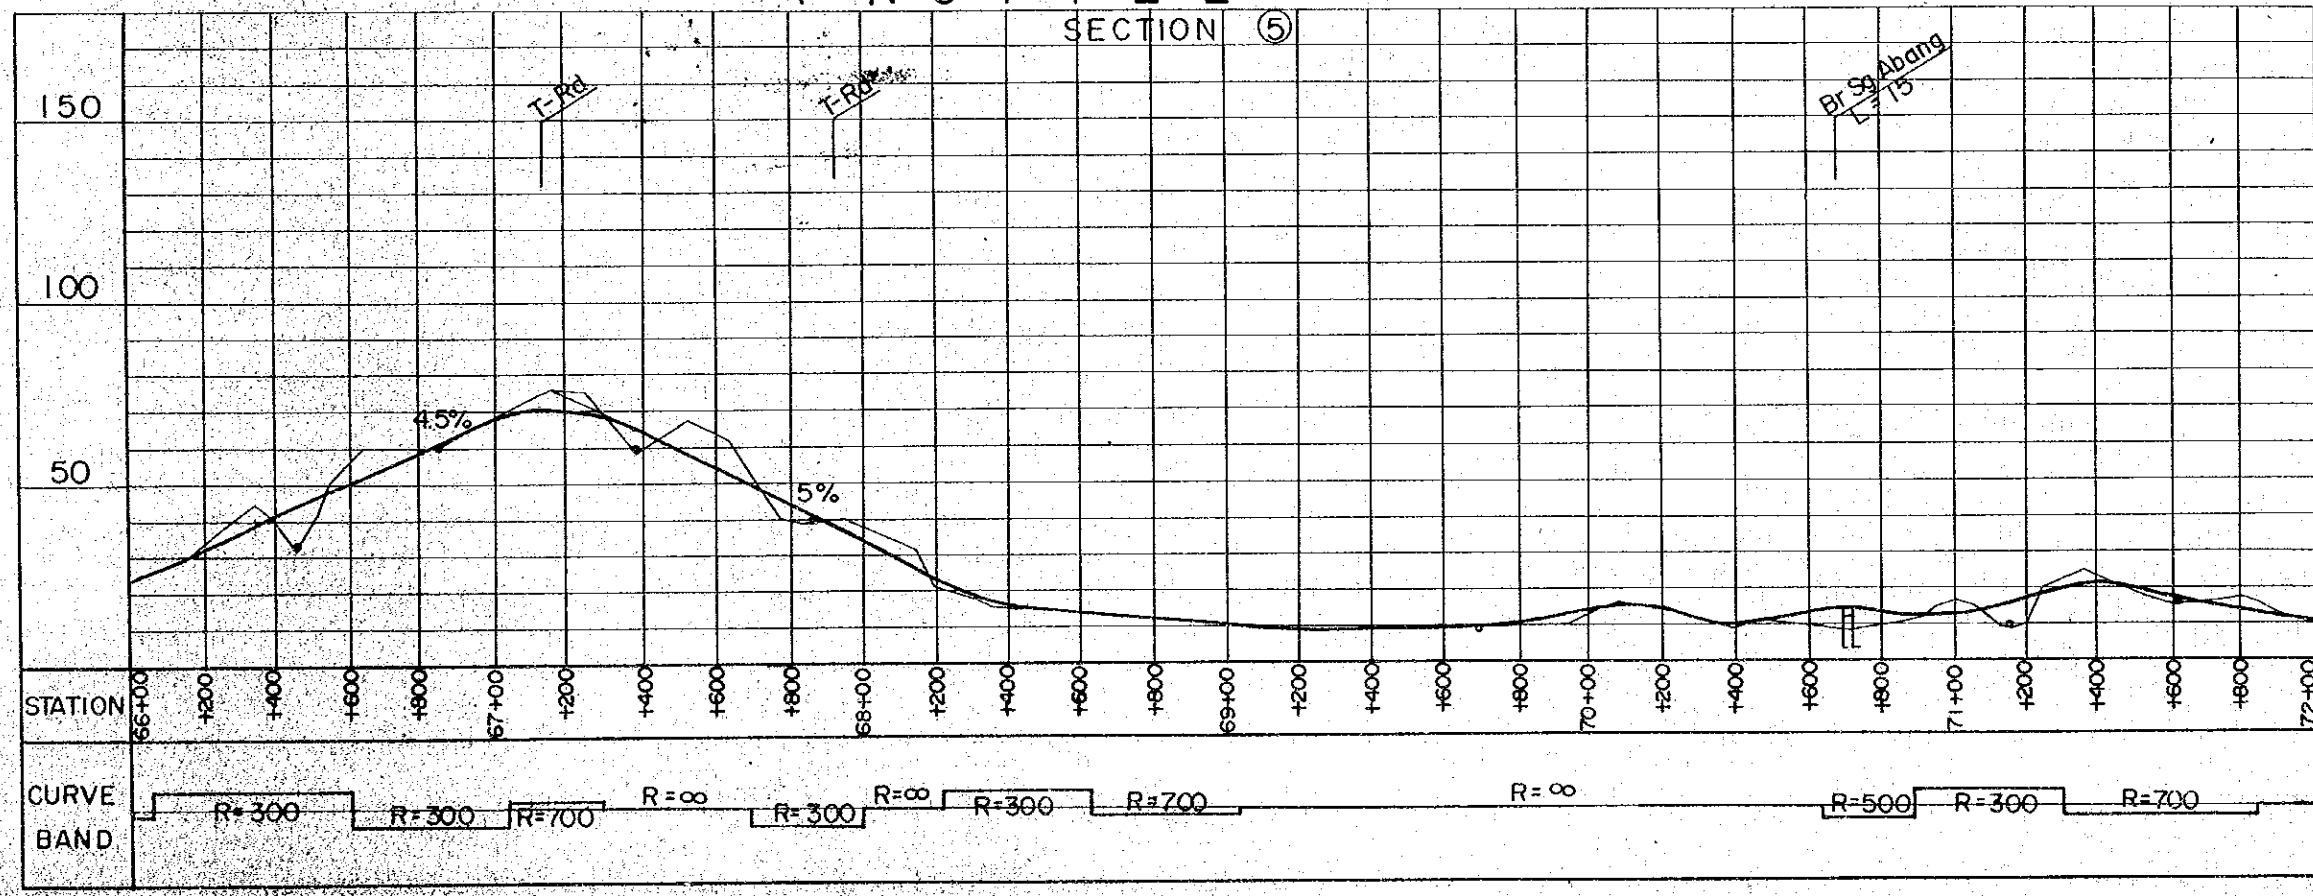


- HORIZONTAL ALIGNMENT
- SCALE 1:20,000
- : CENTER LINE
 - : ROAD RESERVE BOUNDARY
 - : BRIGE
 - R : RADIUS
- VERTICAL ALIGNMENT
- HORIZONTAL SCALE 1:20,000
- VERTICAL SCALE 1:2,000
- : BRIGE
 - 1.0% : GRADIENT OF REC'D PROFILE
 - : EXSITING GL
 - o : DRAINAGE STRUCTURE

PROJECT	SHEET NO.	TOTAL SHEET
BELURU / LONG LAMA / LIMBANG TRUNK ROAD CONSTRUCTION PROJECT	26	54
PLAN AND PROFILE	SCALE	H = 1 : 20,000 V = 1 : 2,000

PLAN

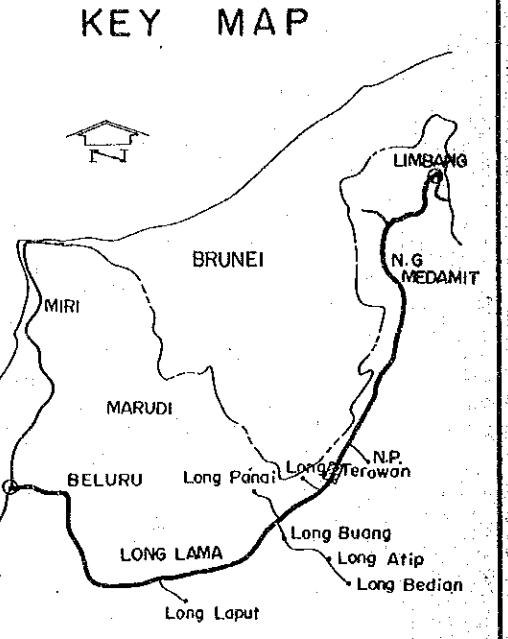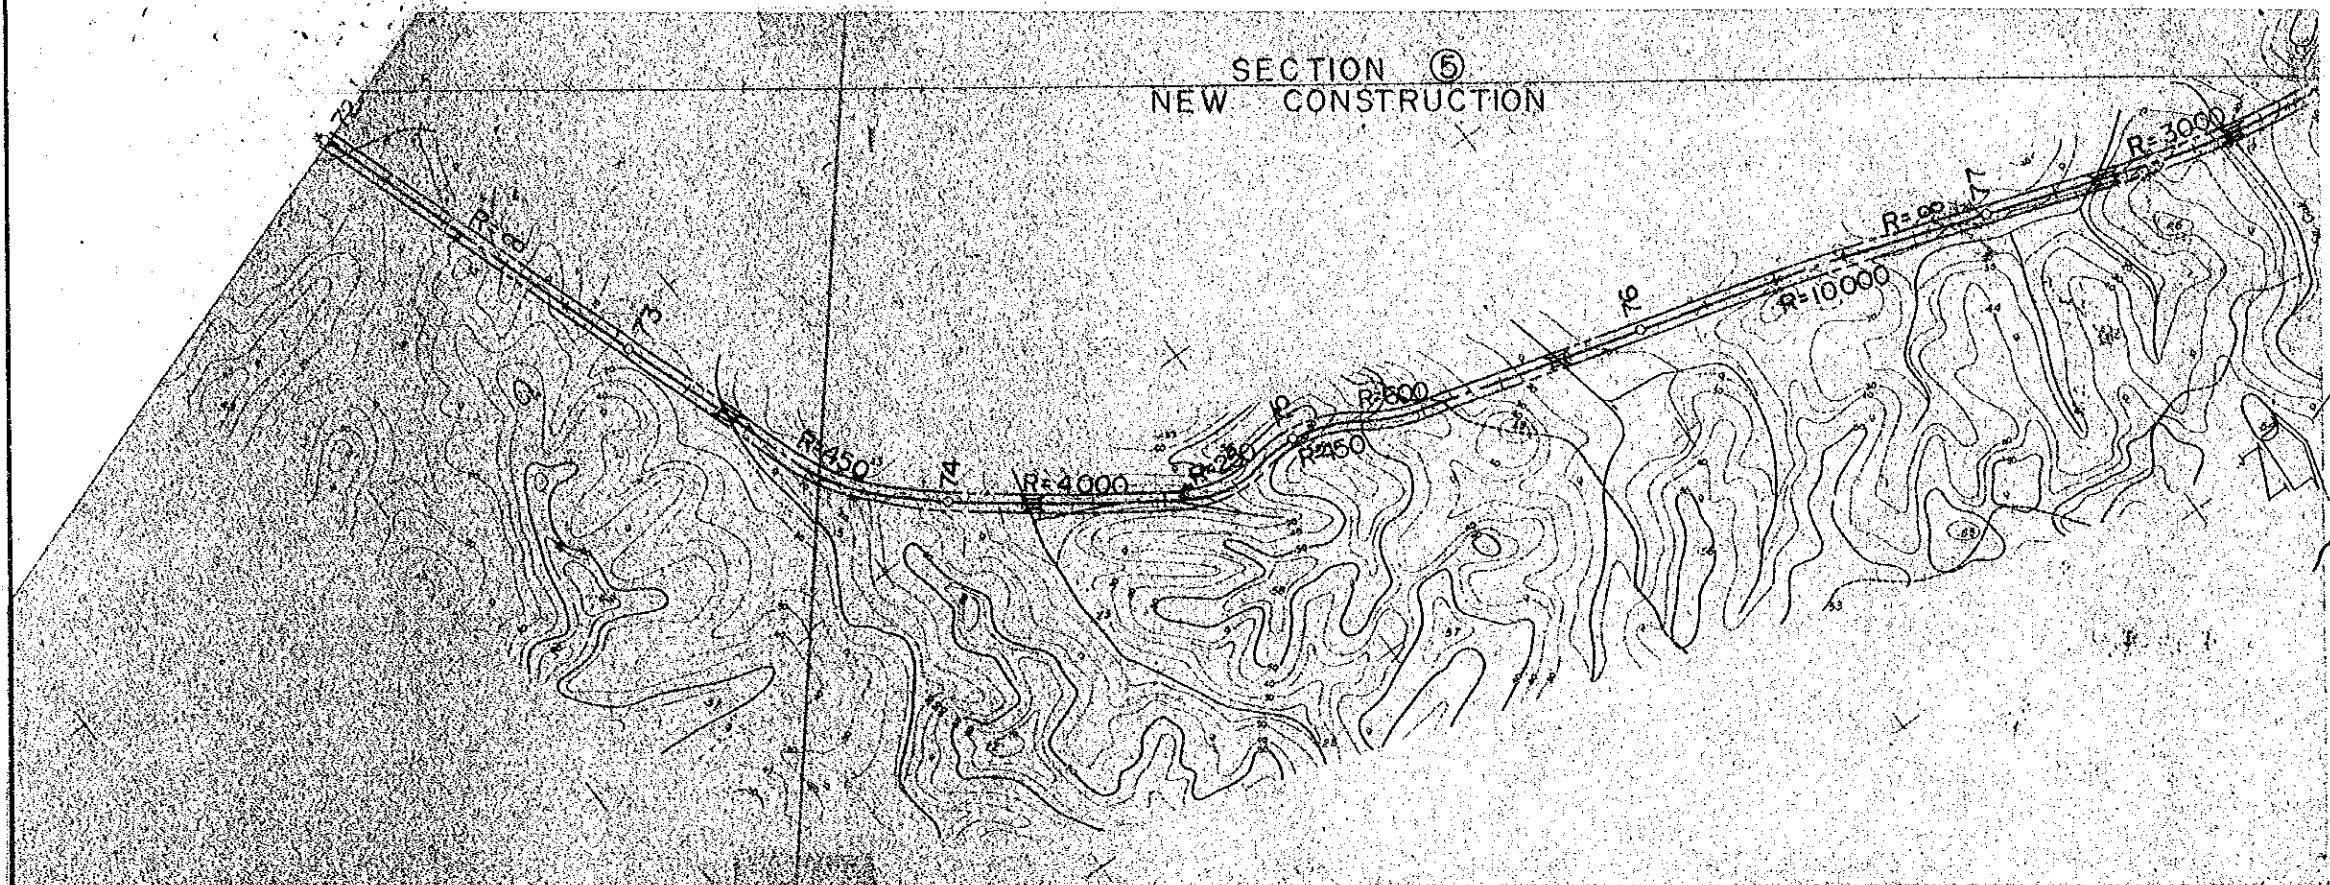

PROFILE

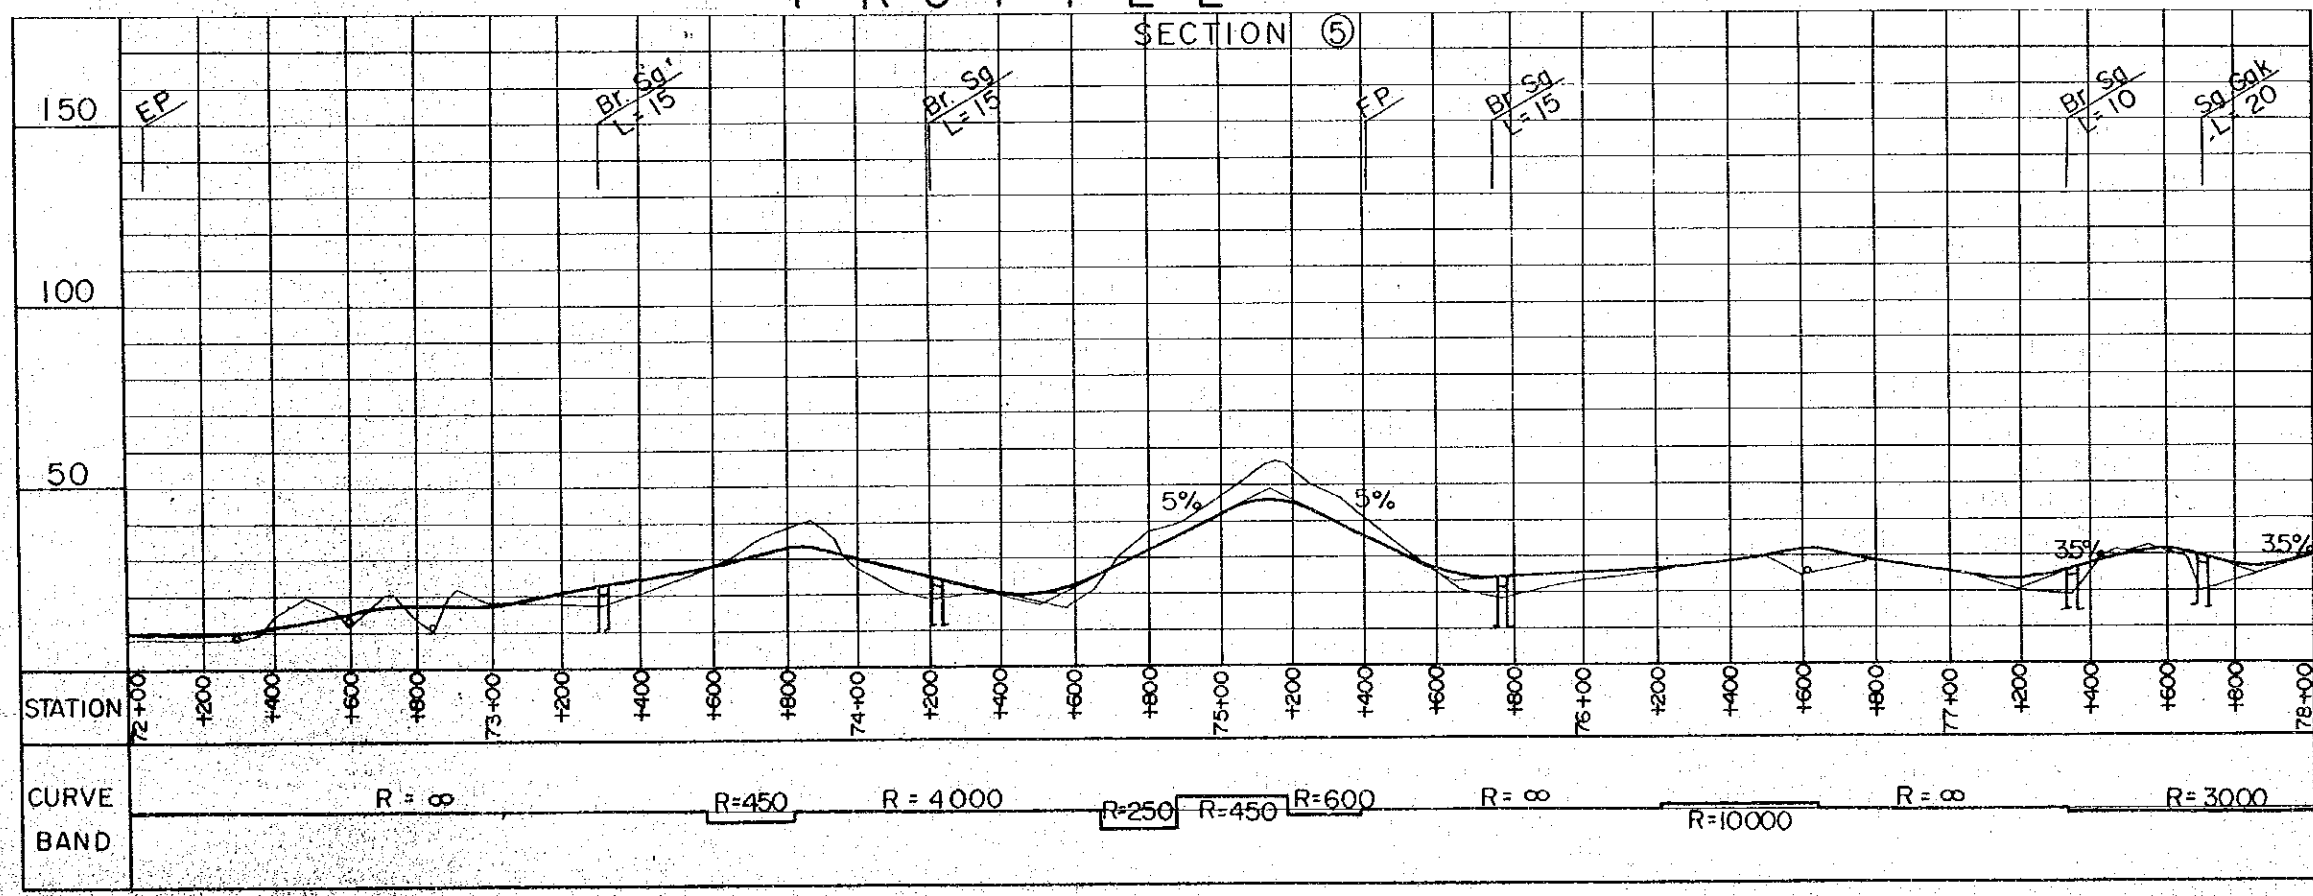

- HORIZONTAL ALIGNMENT**
SCALE 1 : 20,000
- : CENTER LINE
 - : ROAD RESERVE BOUNDARY
 - : BRIGE
 - R : RADIUS
- VERTICAL ALIGNMENT**
HORIZONTAL SCALE 1 : 20,000
VERTICAL SCALE 1 : 2,000
- : BRIGE
 - 1.0% : GRADIENT OF REC'D PROFILE
 - : EXSITING GL
 - o : DRAINAGE STRUCTURE