

TANK: TYPE-A, S-60
H=1.5m

TRANSMISSION LINE: GSP-W, 1 1/2", L=0.6km


PROJECT WELL
TANK: TYPE-D, S-15

MACHINERY HOUSE: TYPE - G/W




TRANSMISSION LINE: GSP-W, 1 1/2", L=0.5km

TANK: TYPE-A, S-60
H=1.5m

AL-KUDHA, AL-HAGL SITE

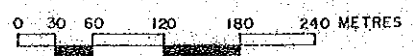


MINISTRY OF PUBLIC WORKS YEMEN ARAB REPUBLIC	
THE RURAL WATER SUPPLY PROJECT PART-II	
T-4B: AL-KUDHA, AL-HAGL	
DESIGNED BY	Pacific Consultants International
DATE	MAY 1980
SCALE	1:1
DRAWING No.	24
JAPAN INTERNATIONAL COOPERATION AGENCY, TOKYO, JAPAN	

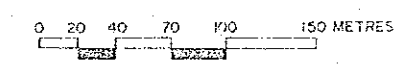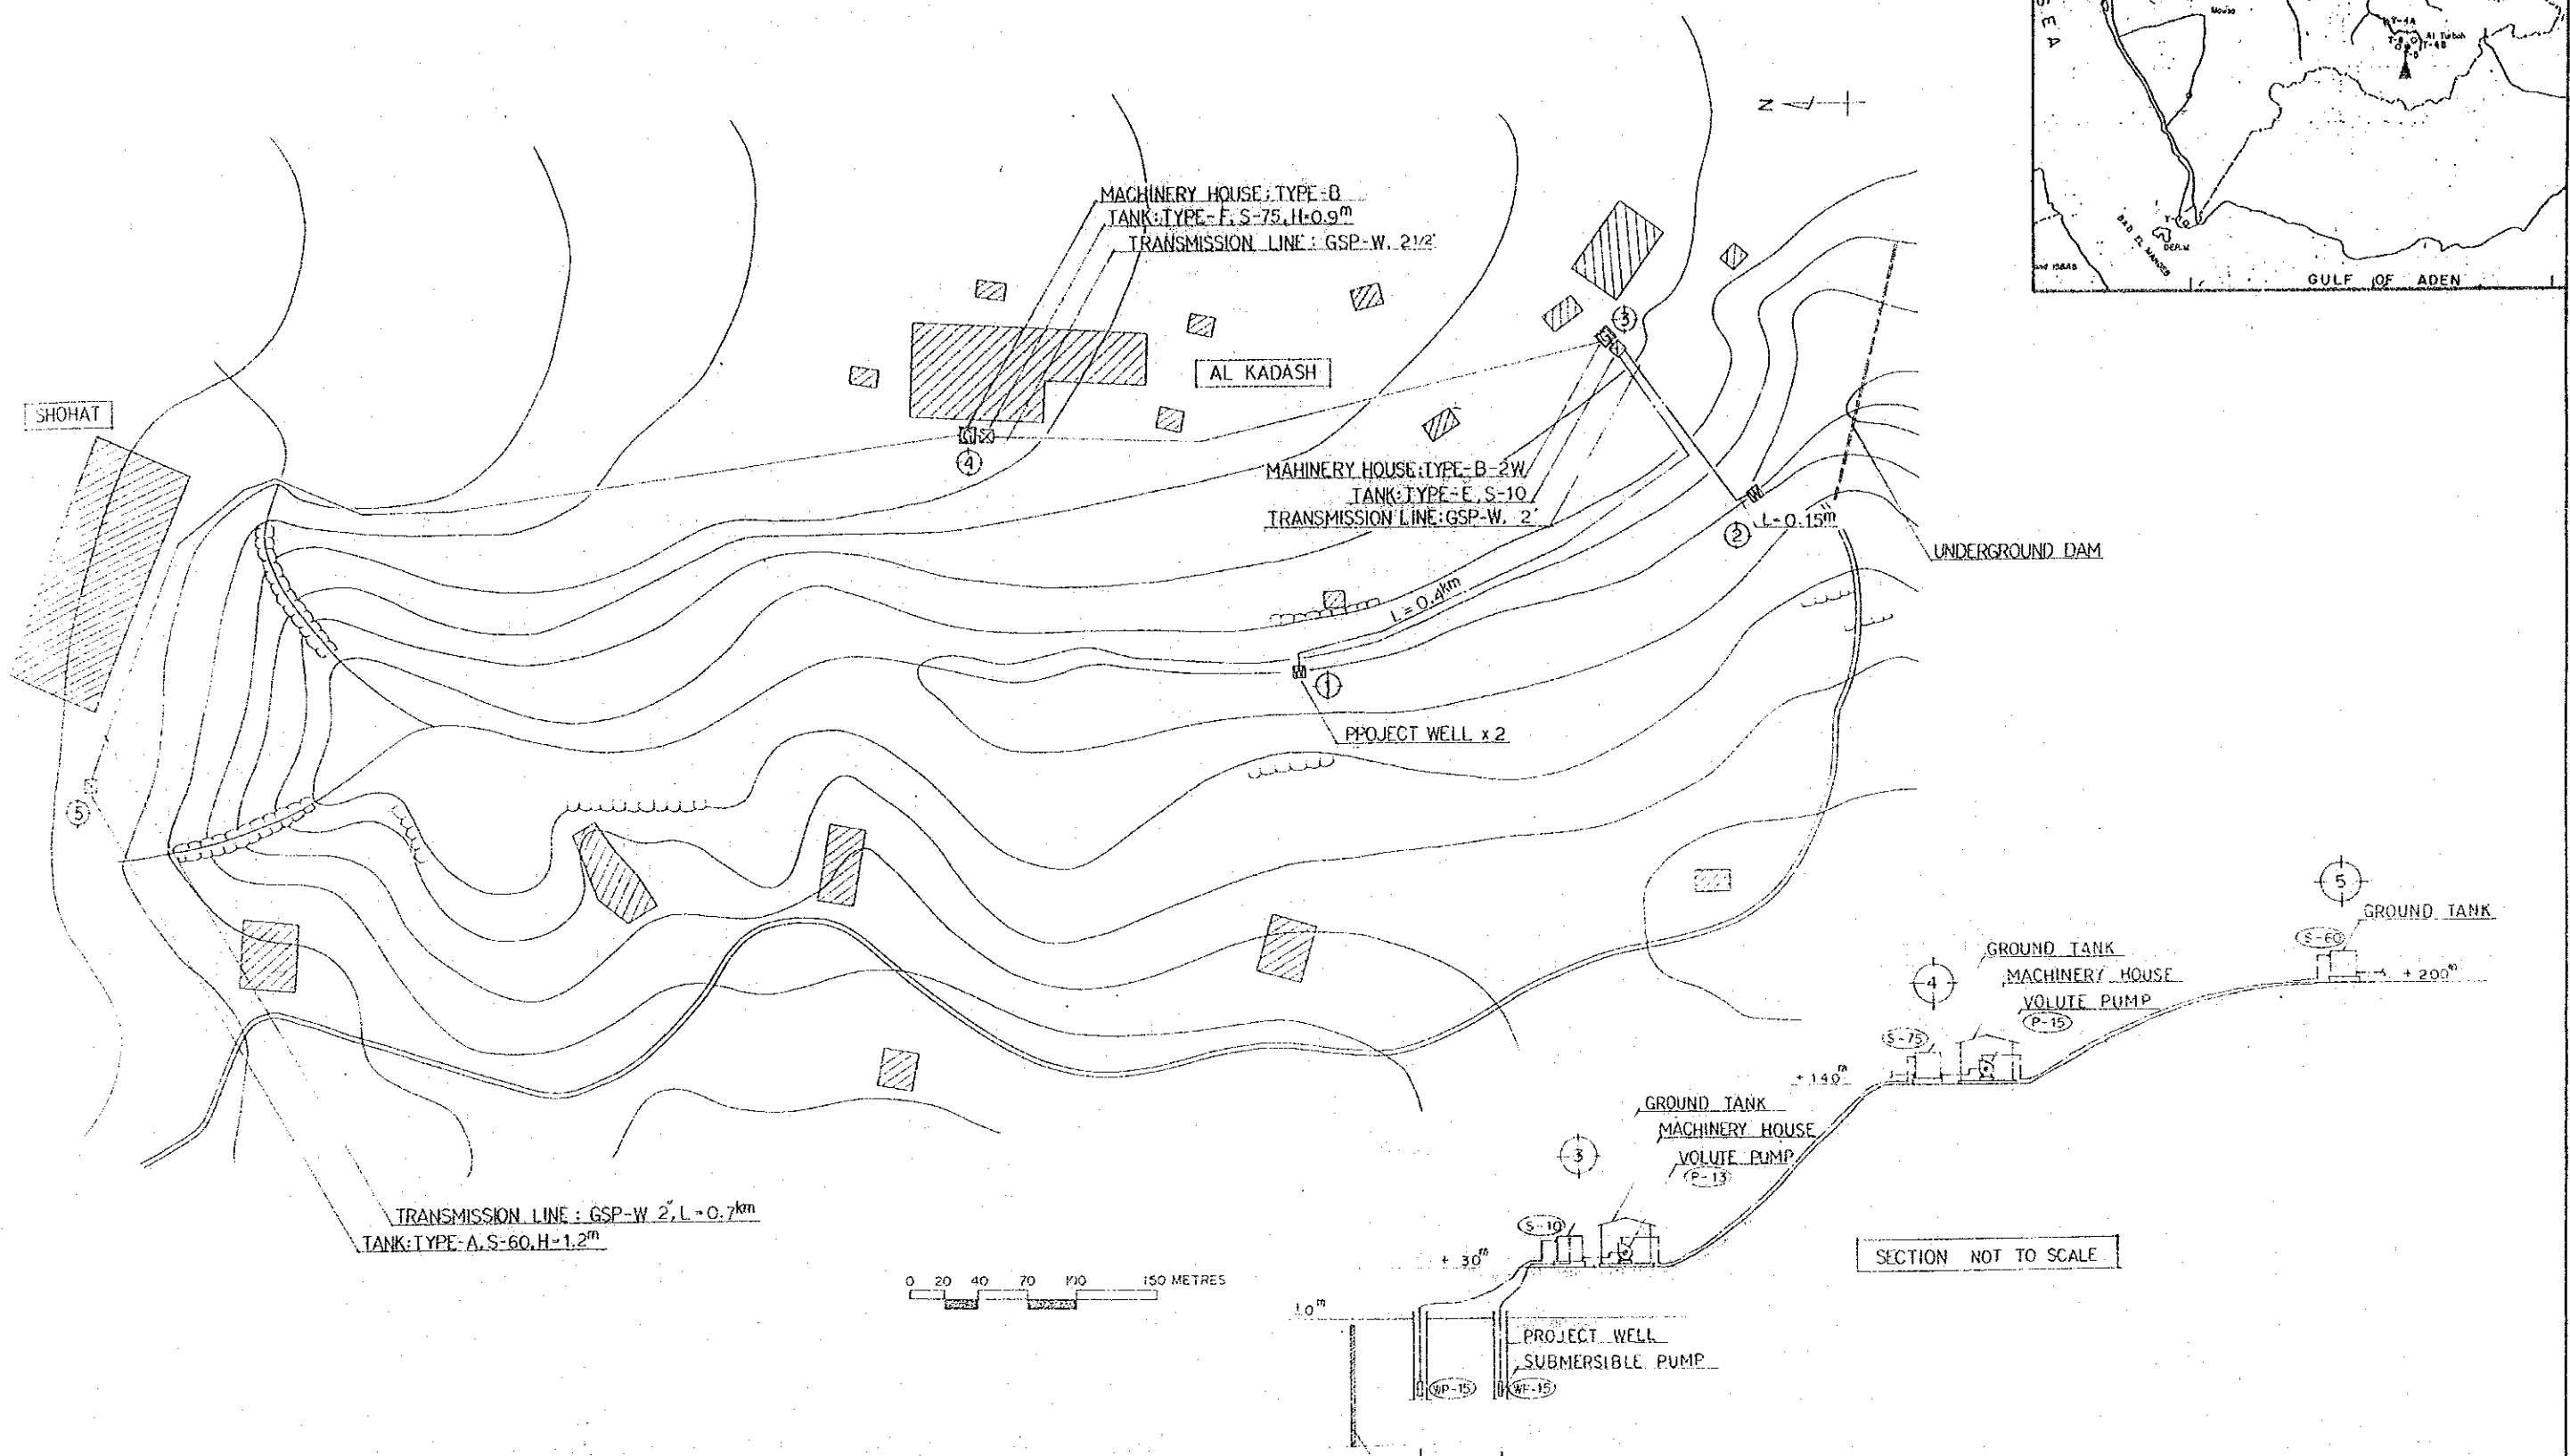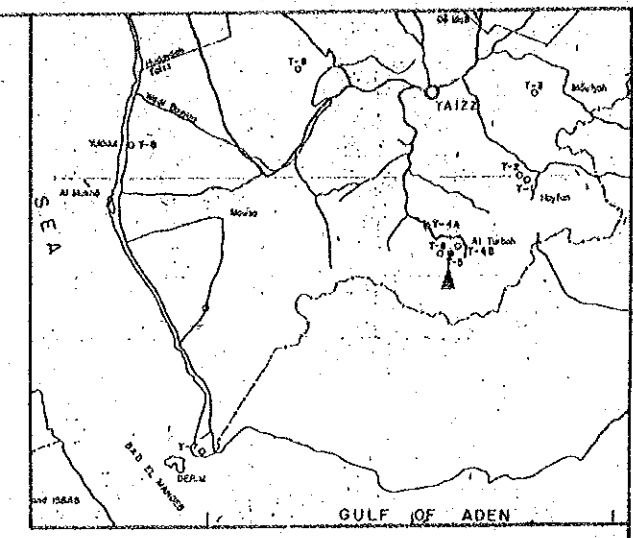


SHOHAT, AL KADASH SITE

MINISTRY OF PUBLIC WORKS YEMEN ARAB REPUBLIC	
THE RURAL WATER SUPPLY PROJECT PART-II	
T-5; SHOHAT, AL KADASH	
DESIGNED BY Pacific Consultants International	
DATE MAY 80	SCALE 1: DRAWING No. 25
JAPAN INTERNATIONAL COOPERATION AGENCY, TOKYO, JAPAN	



LAYOUT PLAN SCALE = 1 / 500
(UNDERGROUND DAM)

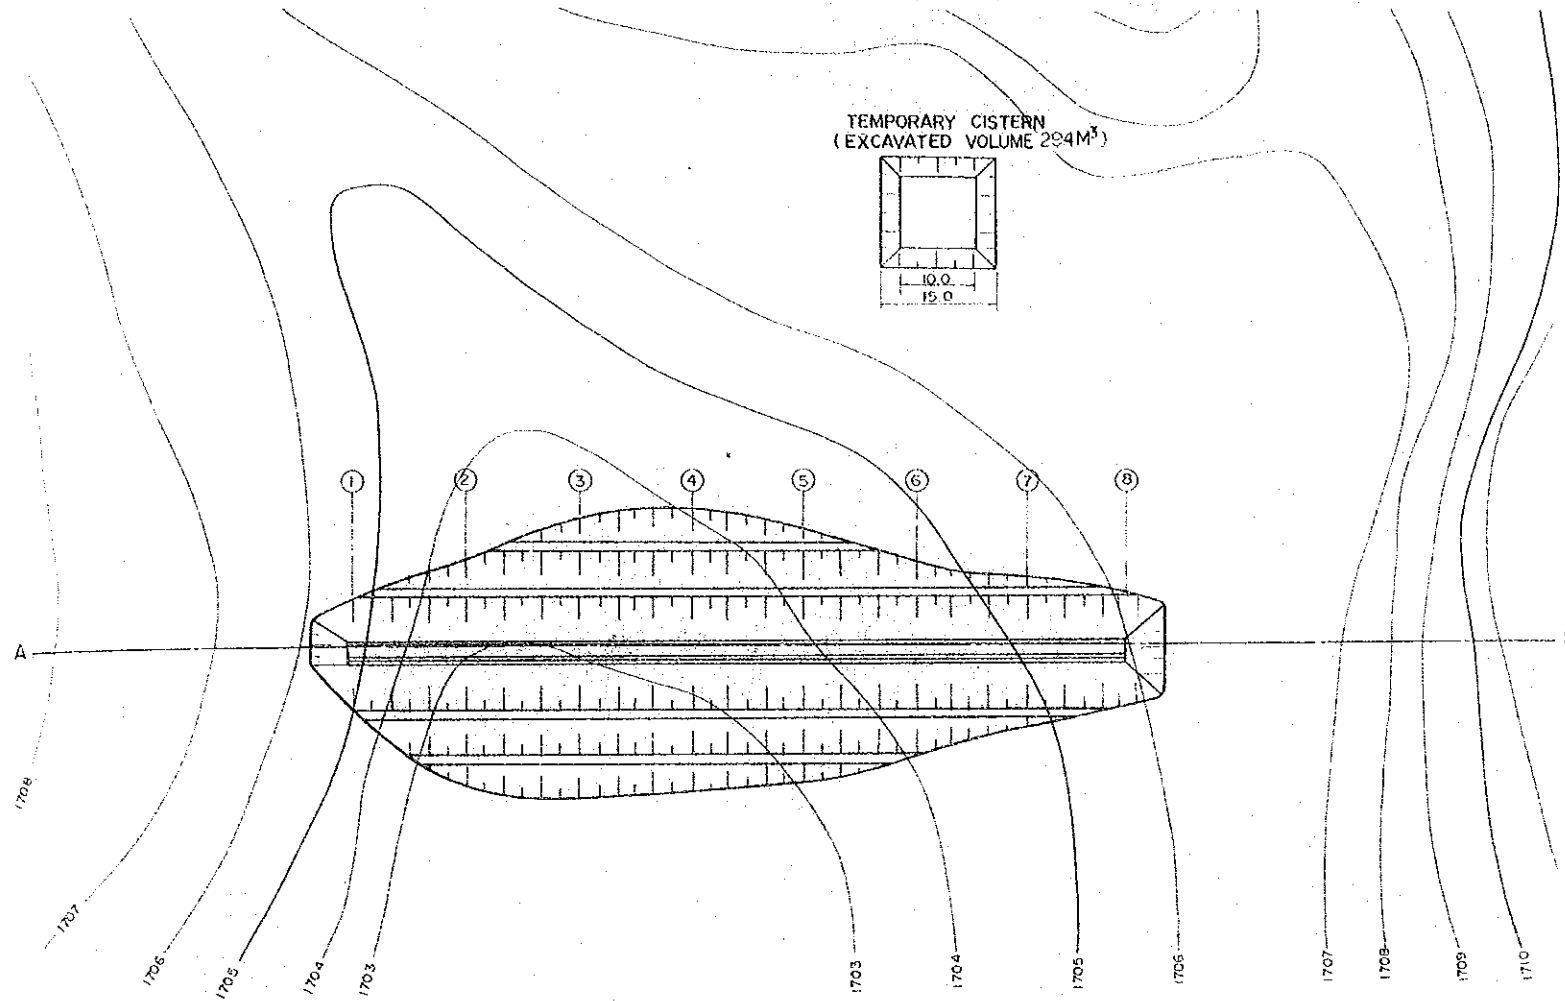


TEMPORARY CISTERN
(EXCAVATED VOLUME 294M³)

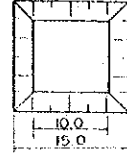

A - B SECTION SCALE = 1 / 500

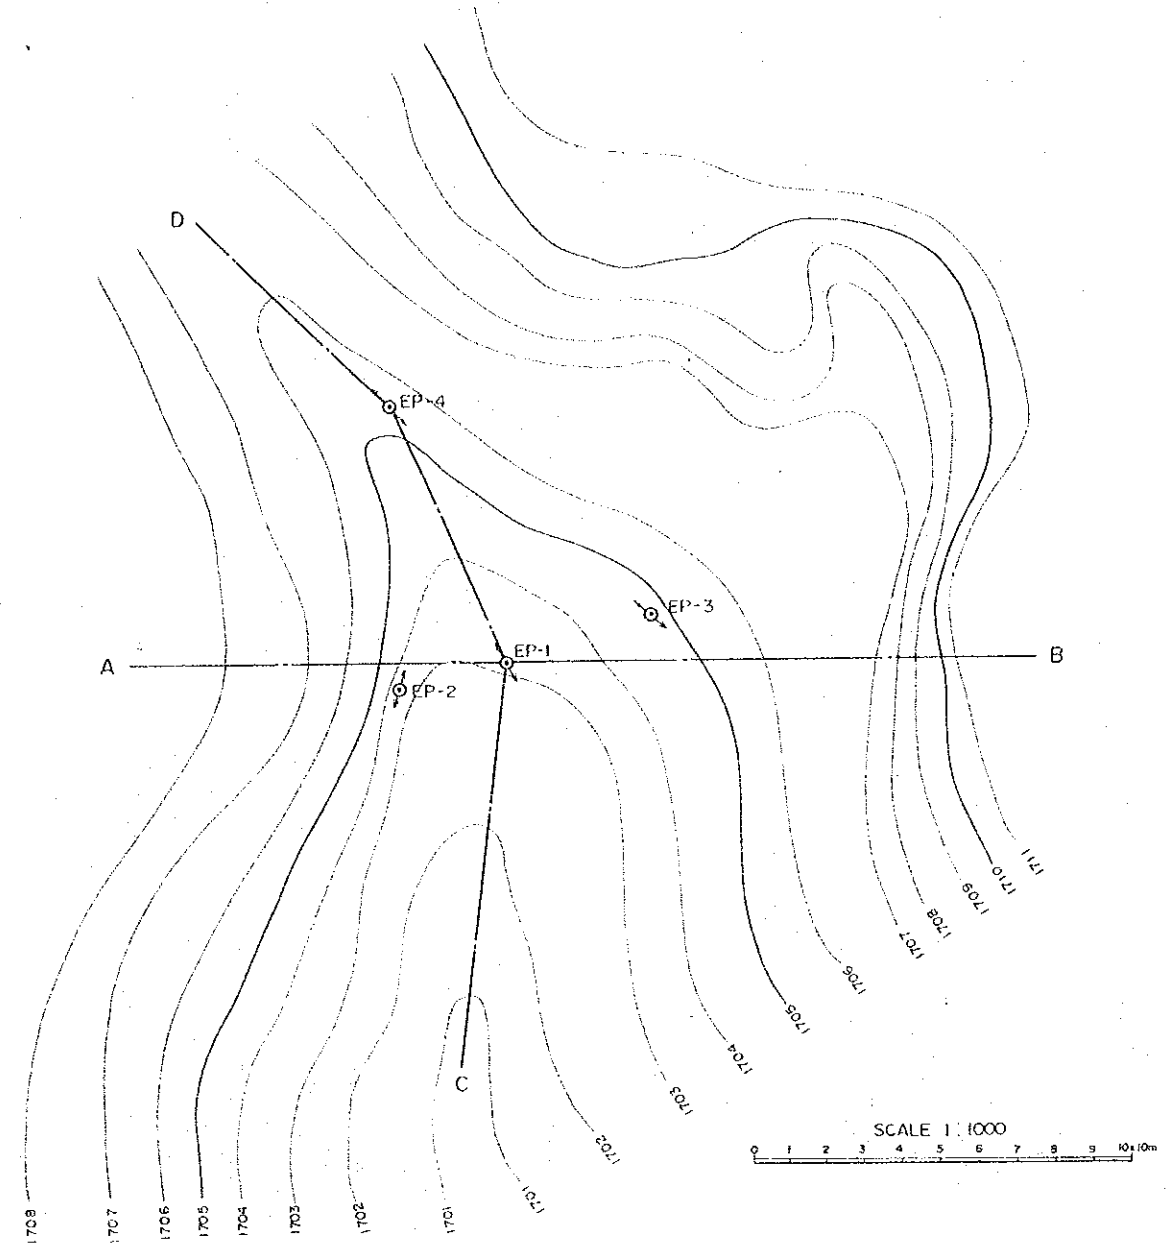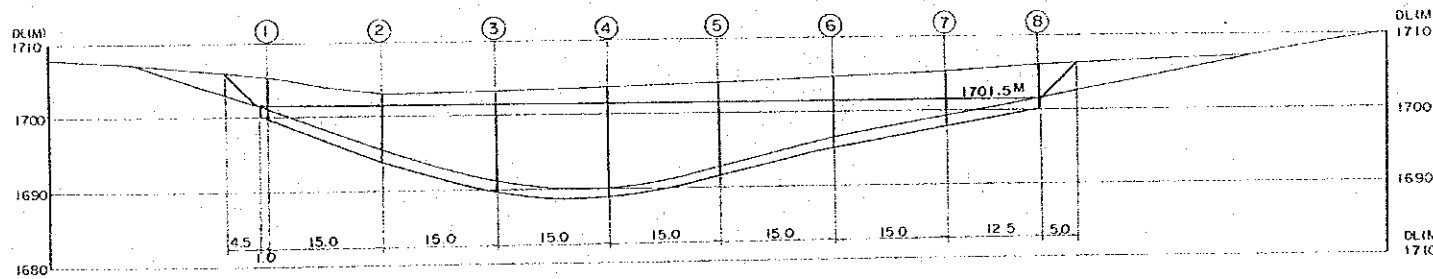

GEOLOGICAL SECTION (A-B) SCALE = 1 / 500

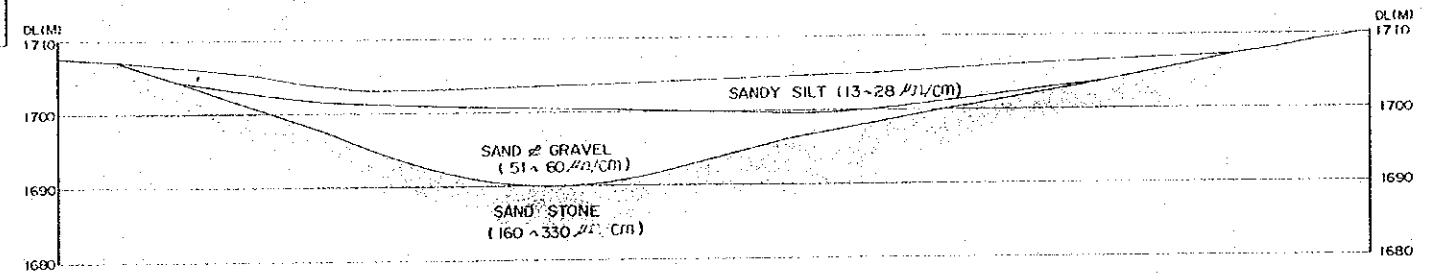

ITEM	NO.	①	②	③	④	⑤	⑥	⑦	⑧	TOTAL	REMARKS	
VOLUME	SOIL (M ³)	148.8	1,222.7	2,729.9	4,112.9	3,809.9	2,416.4	1,398.0	882.8	705.0	17,426.4	EXCAVATED VOLUME
	ROCK (M ³)	5.0	69.0	67.5	66.8	67.5	82.5	66.0	67.5	57.2	549.0	EXCAVATED VOLUME
	CONCRETE (M ³)	4.0	191.3	182.4	168.9	337.7	264.2	119.3	63.8	—	1,331.6	REINFORCED CONCRETE
	GRAVEL (M ³)	—	532.3	1,741.7	2,651.6	2,295.2	1,260.6	460.1	120.8	—	9,052.3	RECLAIMED MATERIAL

MINISTRY OF PUBLIC WORKS
YEMEN ARAB REPUBLIC









THE RURAL WATER SUPPLY
PROJECT PART-II

PLAN ELEVATION: UNDERGROUND DAM (II)



DESIGNED BY Pacific Consultants International

DATE MAY 20 SCALE 1: DRAWING No. 26

JAPAN INTERNATIONAL COOPERATION
AGENCY, TOKYO, JAPAN

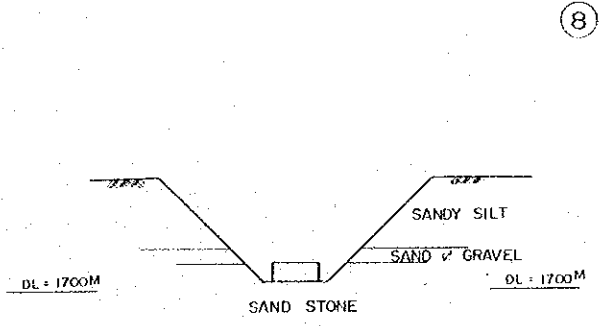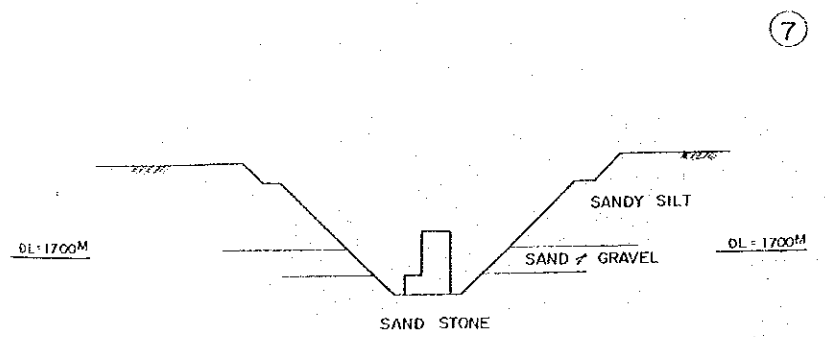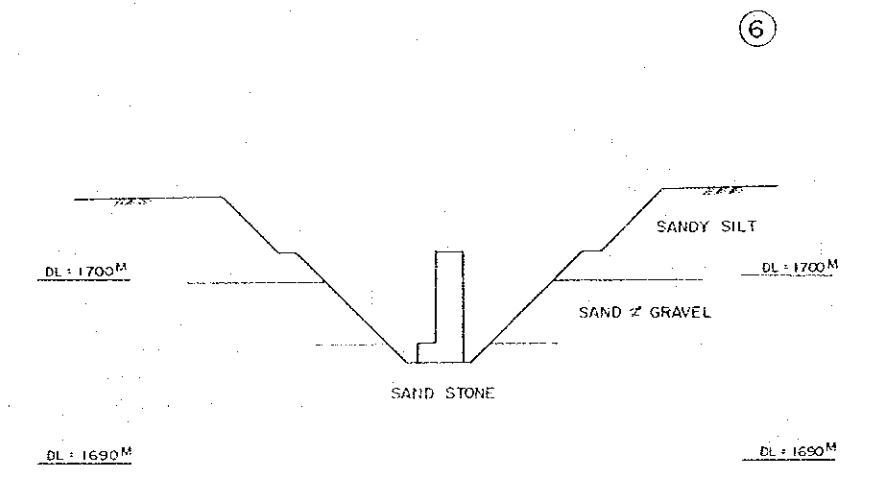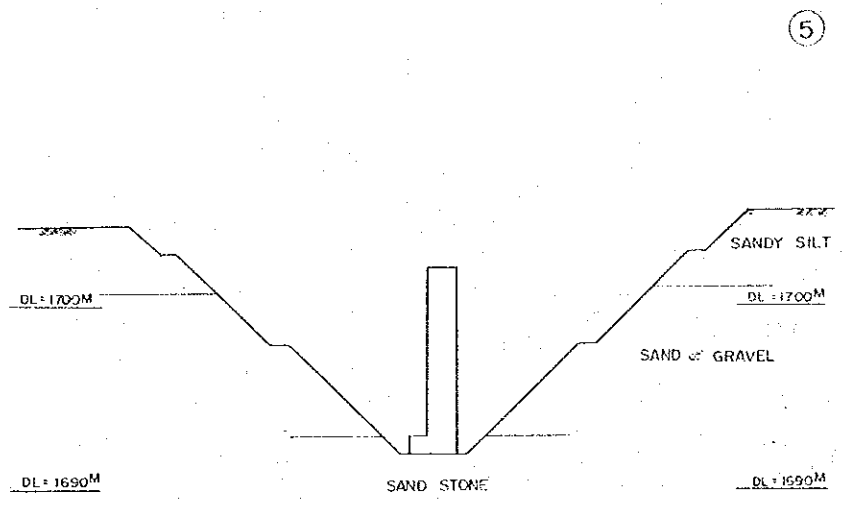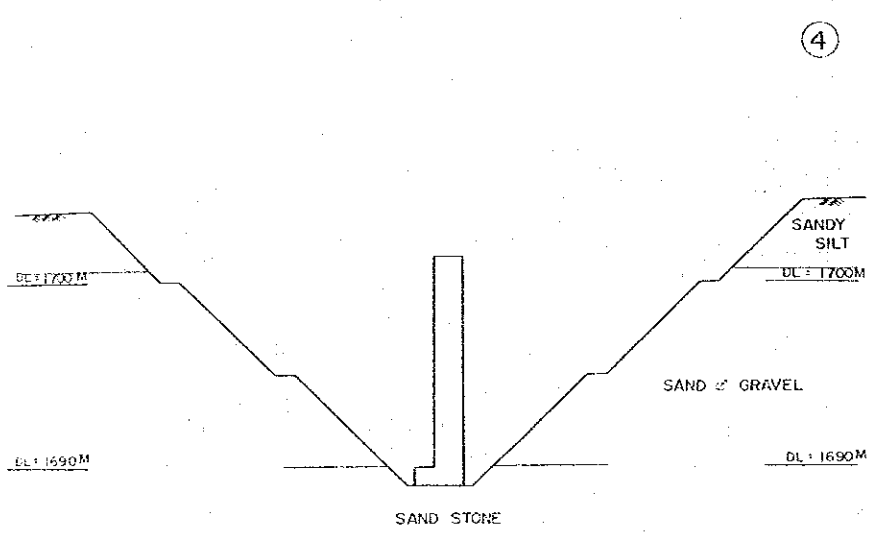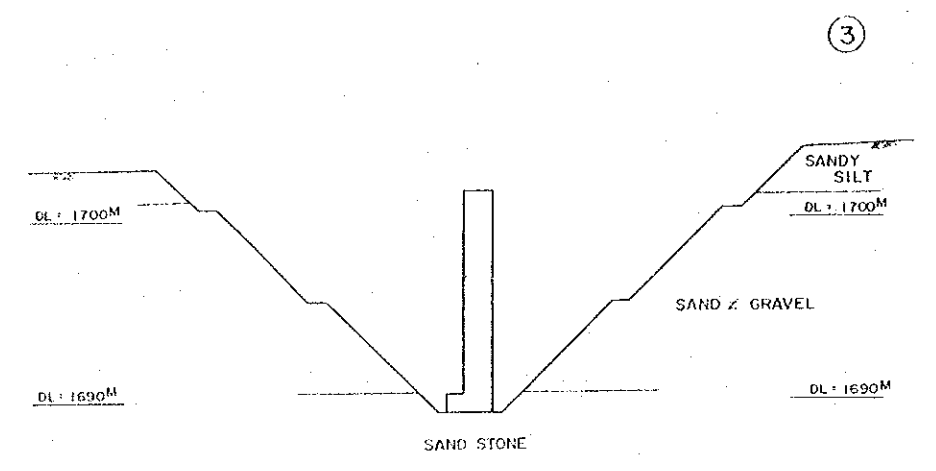
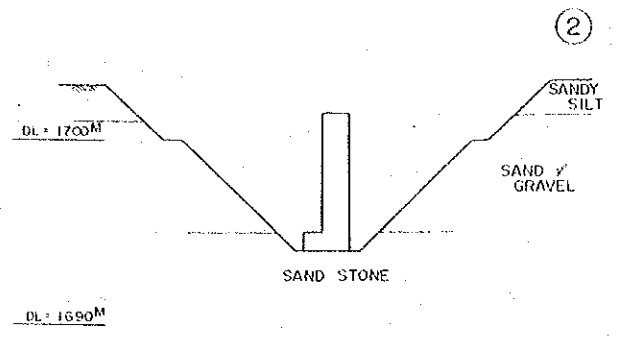
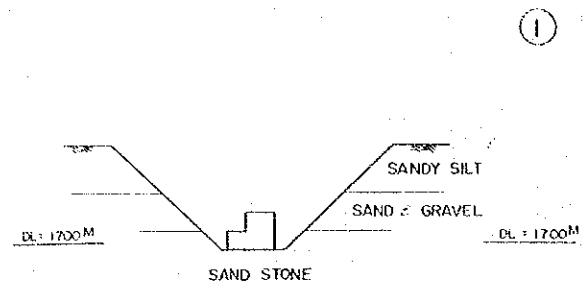


MINISTRY OF PUBLIC WORKS YEMEN ARAB REPUBLIC			
THE RURAL WATER SUPPLY PROJECT PART-II			
SECTION : UNDERGROUND DAM-(2)			
DESIGNED BY	Pacific Consultants International		
DATE	MAY 1980	SCALE	1:200 DRAWING No. 27
JAPAN INTERNATIONAL COOPERATION AGENCY, TOKYO, JAPAN			

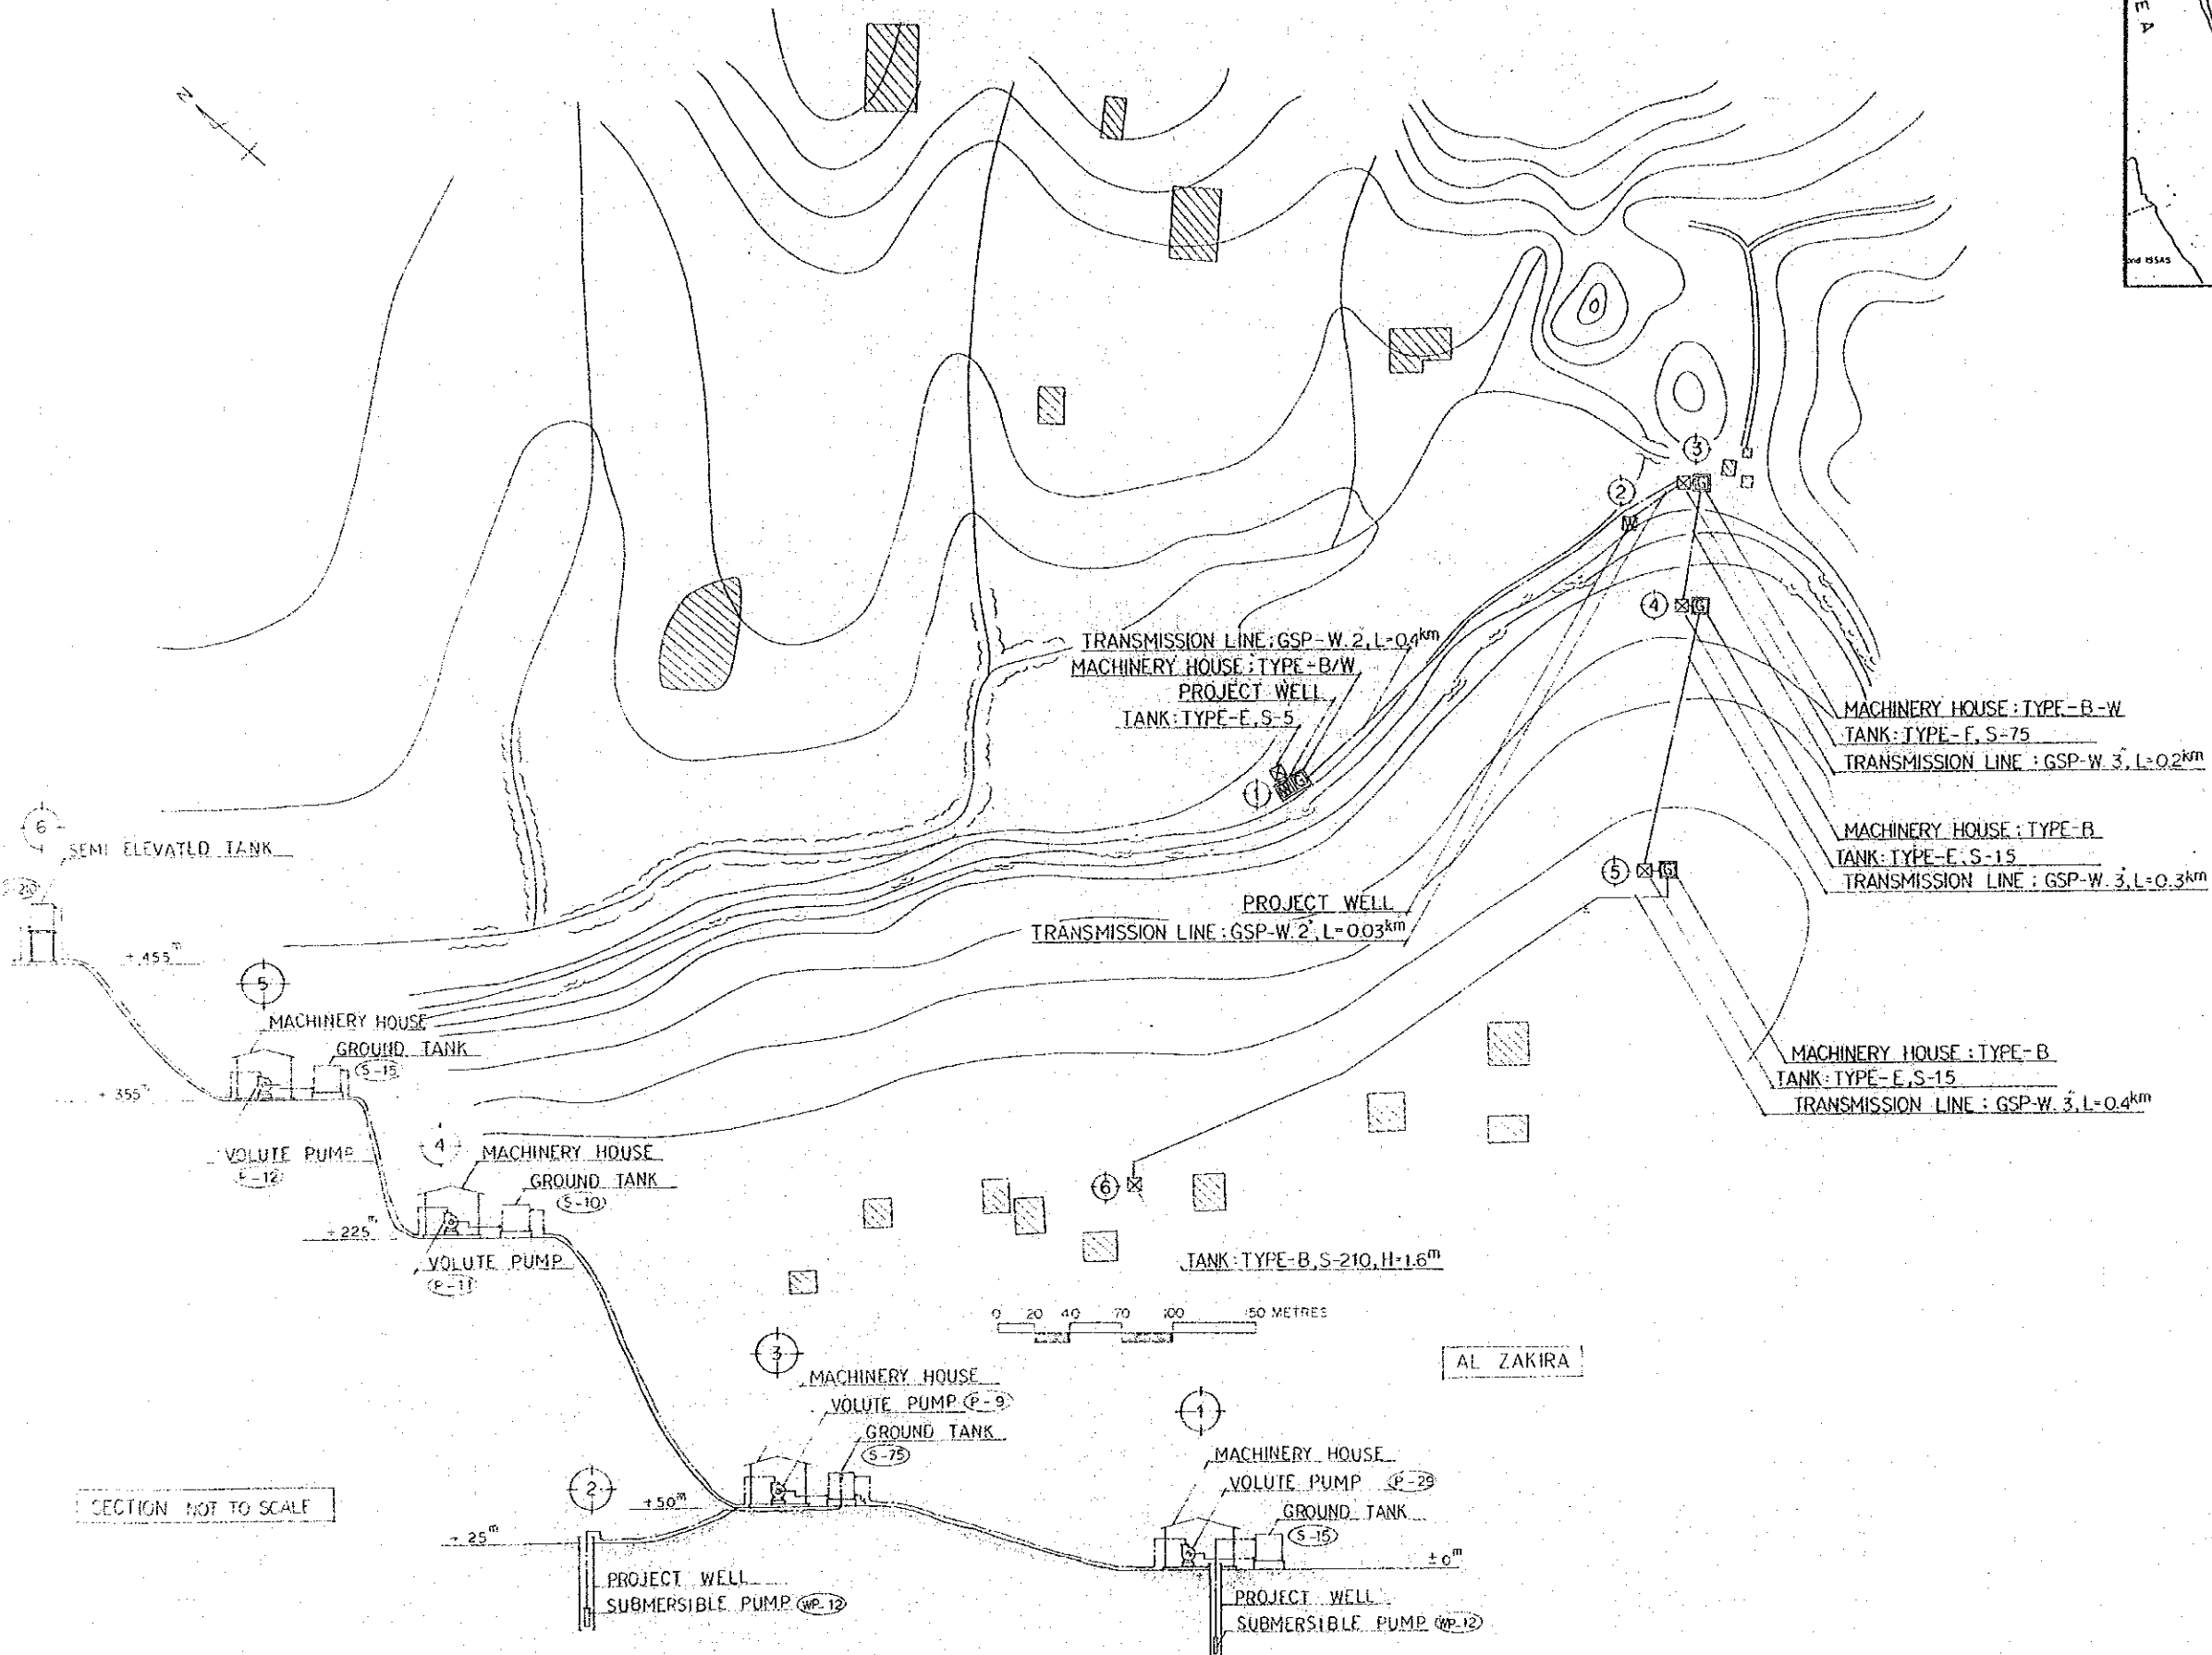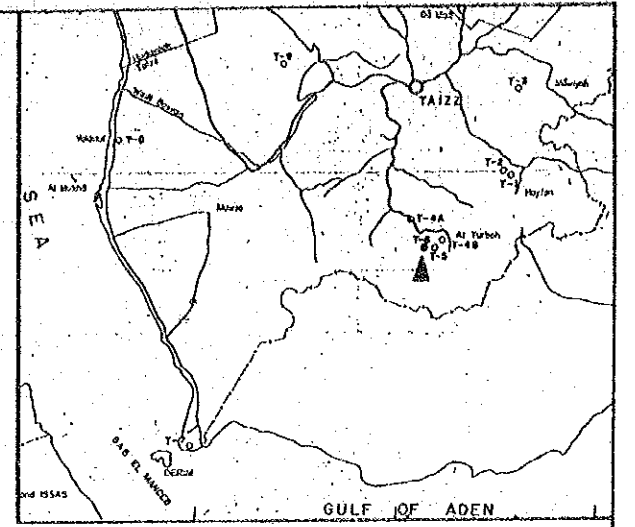

SECTION NOT TO SCALE

MINISTRY OF PUBLIC WORKS YEMEN ARAB REPUBLIC	
THE RURAL WATER SUPPLY PROJECT PART-II	
T-6 : AL-ZAKIRA	
DESIGNED BY: Pacific Consultants International	DATE: MAY 80
SCALE: 1:1	DRAWING No. 28
JAPAN INTERNATIONAL COOPERATION AGENCY, TOKYO, JAPAN	

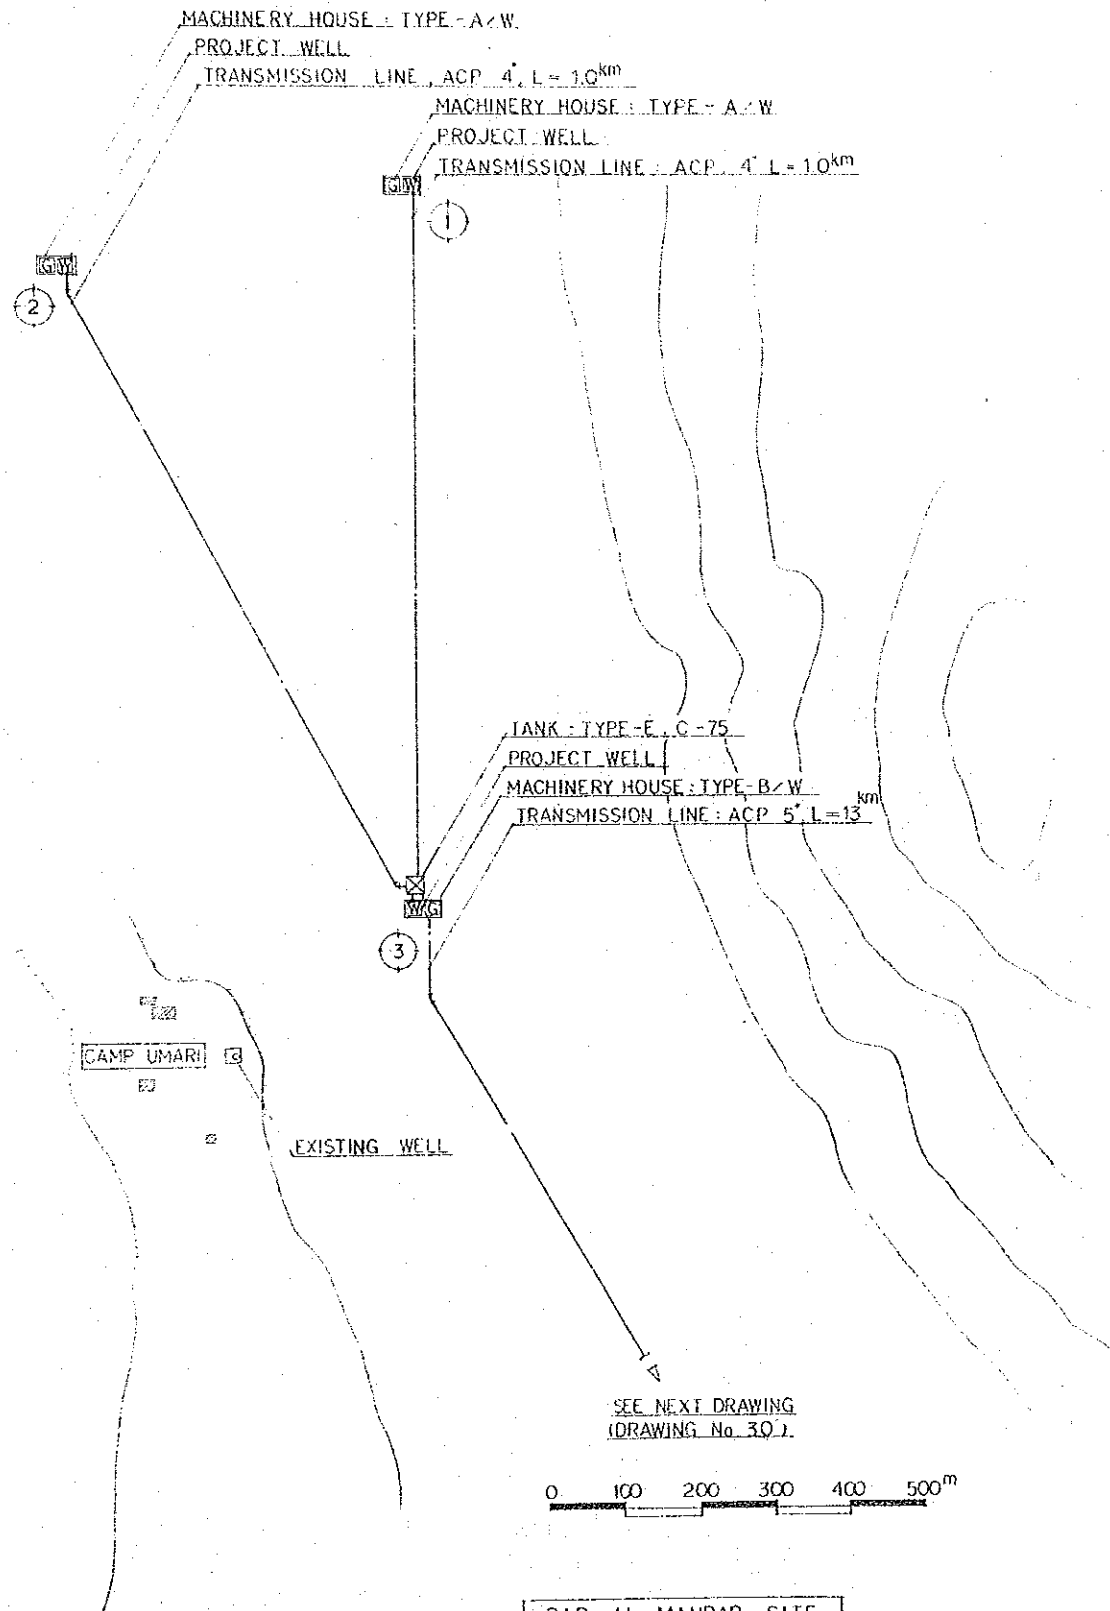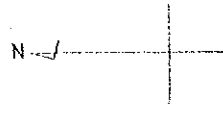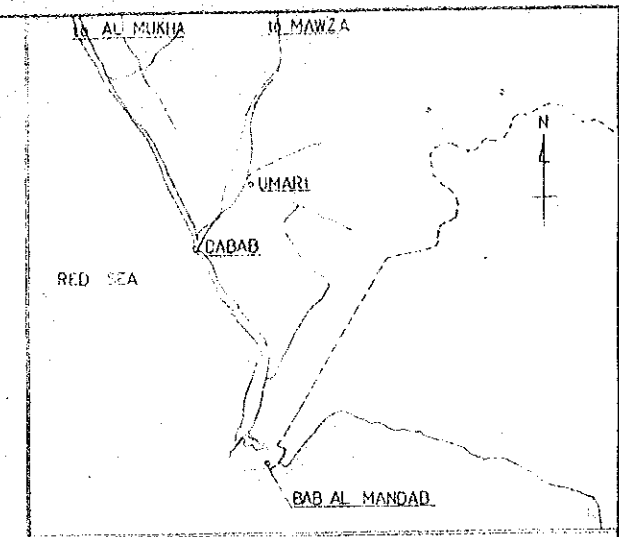

BAB - AL - MANDAB SITE

SEE NEXT DRAWING
(DRAWING No. 30.)

0 100 200 300 400 500^m

No	PROJECT WELL	MACHINERY HOUSE TYPE	TANK		TRANSMISSION LINE ACP		
			TYPE	H	Φ	km	
1	○	A / W			4'	1.0	
2	○	A / W			4'	1.0	
3	○	B / W	E	C-75	5'	13.0	
4	—	C	F	C-210	0.6	3'	2.0
5	—		C	S-40		5'	17.5
6	—	B	E	C-60		5'	17.5
7	—	B	E	C-768	0.5	6'	0.5
			C	S-156			

MINISTRY OF PUBLIC WORKS
YEMEN ARAB REPUBLIC



THE RURAL WATER SUPPLY
PROJECT PART-II

T-7 BAB-AL-MANDAB (1)

DESIGNED BY Pacific Consultants International

DATE MAY 80 SCALE 1: DRAWING No. 29

JAPAN INTERNATIONAL COOPERATION
AGENCY, TOKYO, JAPAN

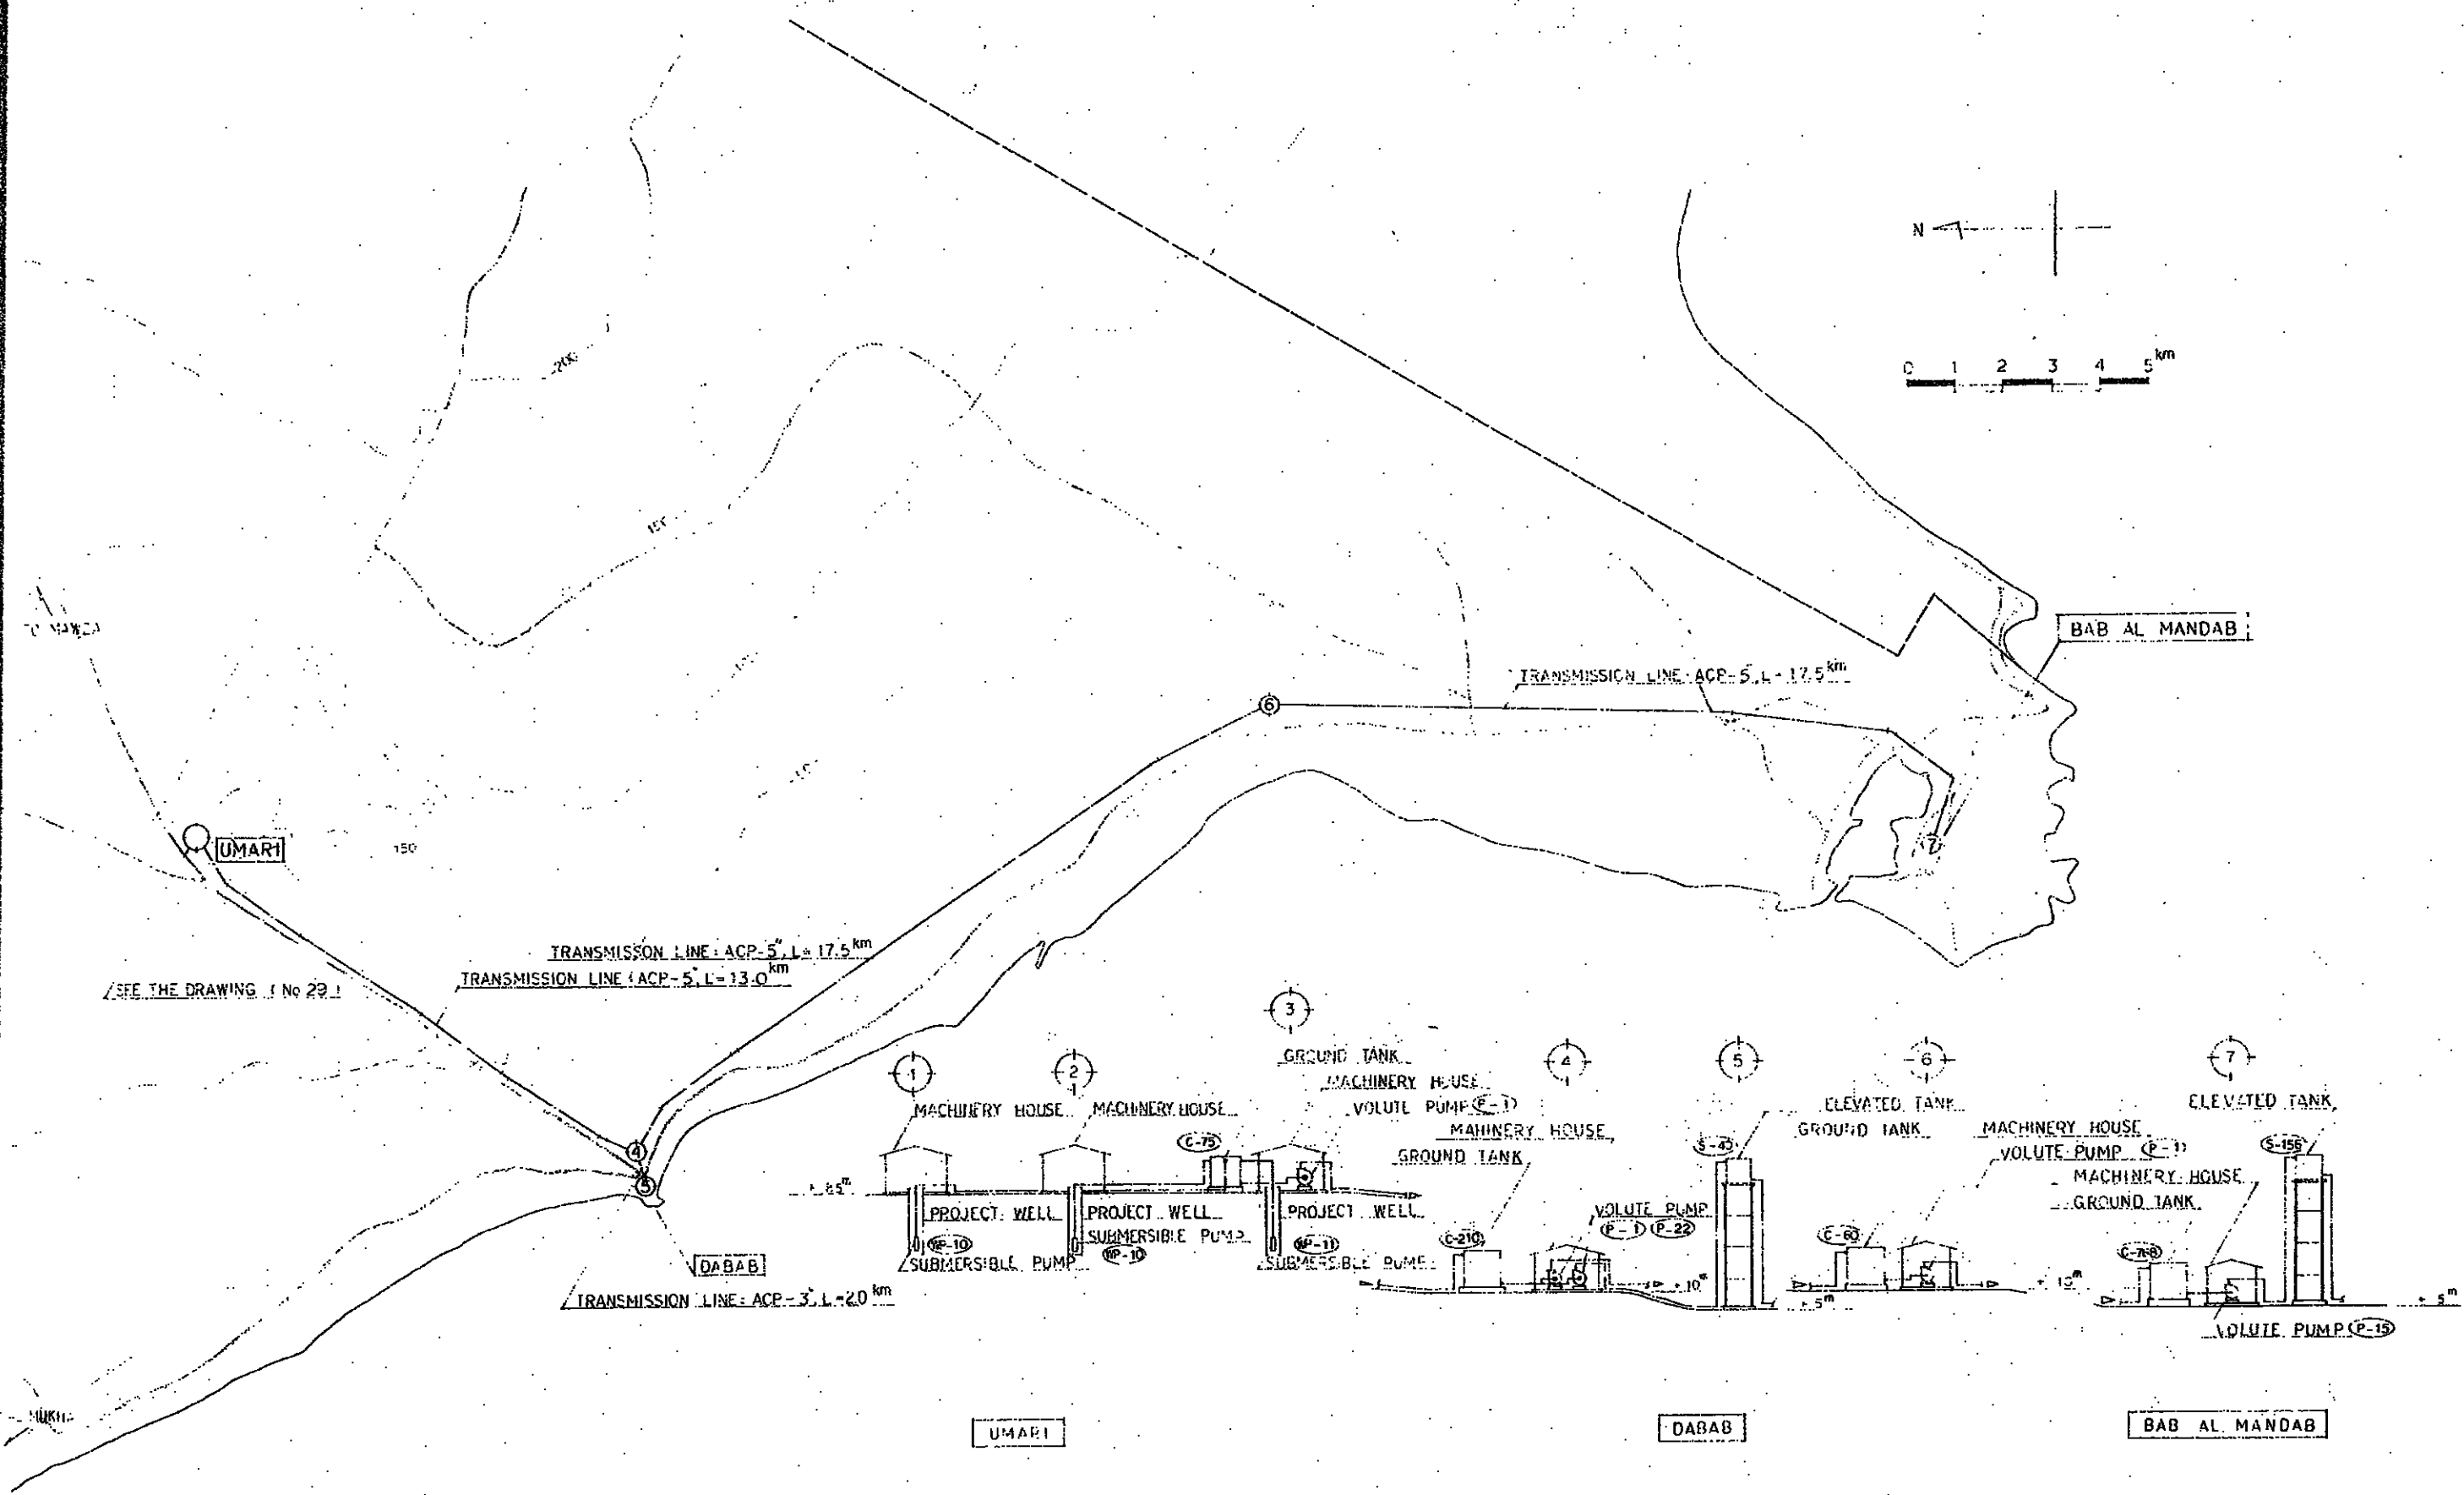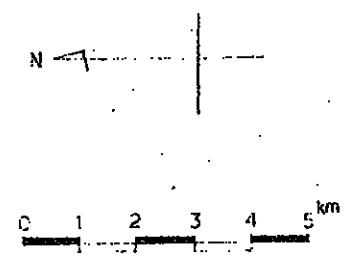


SEE THE DRAWING (No 29)

TRANSMISSION LINE: ACP=5, L=17.5 km
 TRANSMISSION LINE: ACP=5, L=13.0 km

TRANSMISSION LINE: ACP=3, L=2.0 km

TRANSMISSION LINE: ACP=5, L=17.5 km




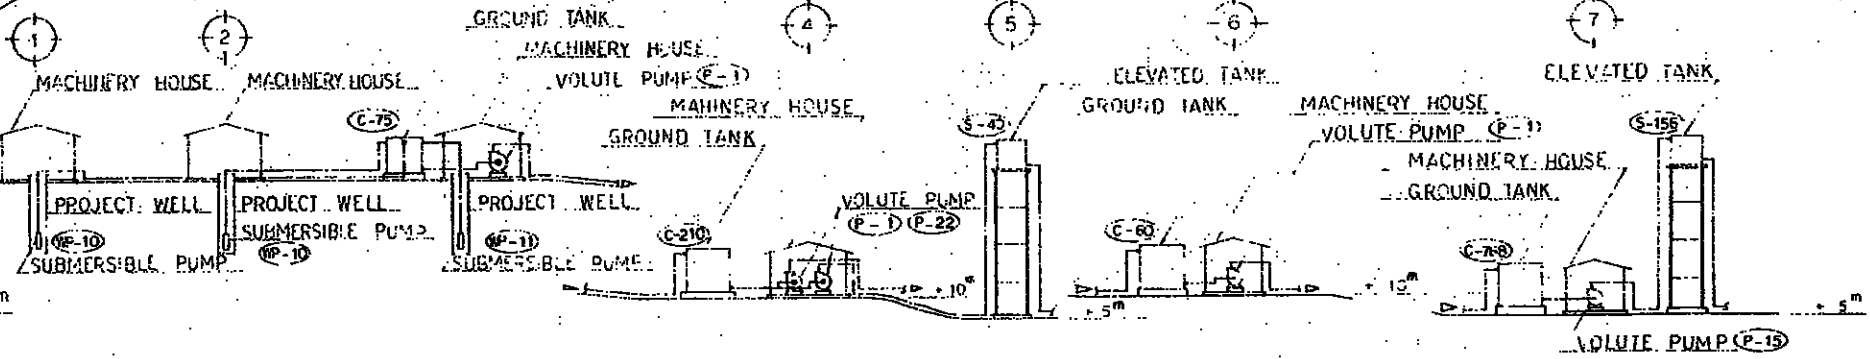


RED SEA




SECTION: NOT TO SCALE

BAB - AL - MANDAB SITE

MINISTRY OF PUBLIC WORKS YEMEN ARAB REPUBLIC		
THE RURAL WATER SUPPLY PROJECT PART-II		
T-7 BAB-AL-MANDAB (2)		
DESIGNED BY	Pacific Consultants International	
DATE	MAY '80	SCALE 1: DRAWING No. 30
JAPAN INTERNATIONAL COOPERATION AGENCY, TOKYO, JAPAN		

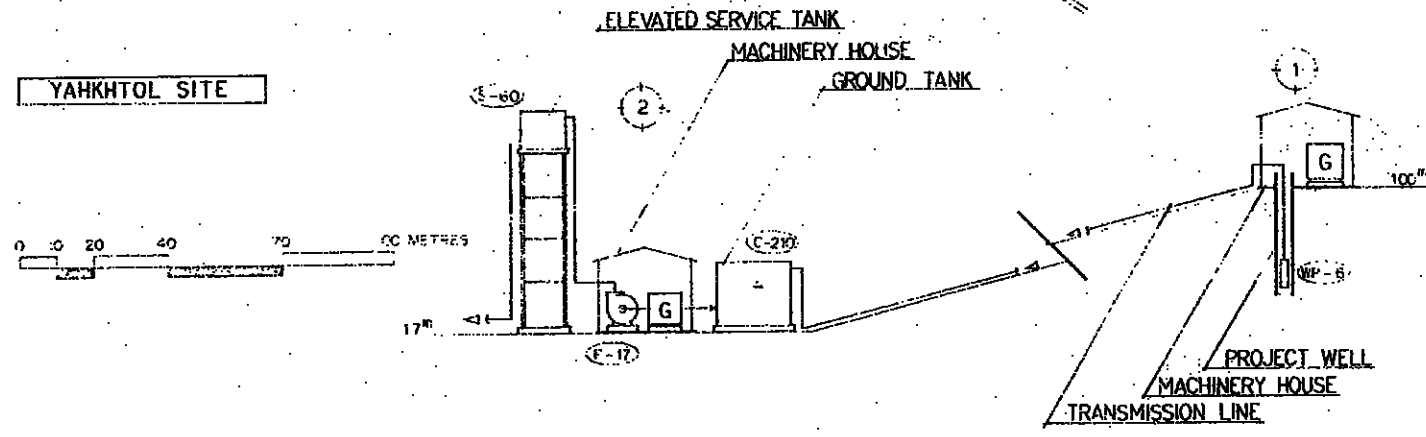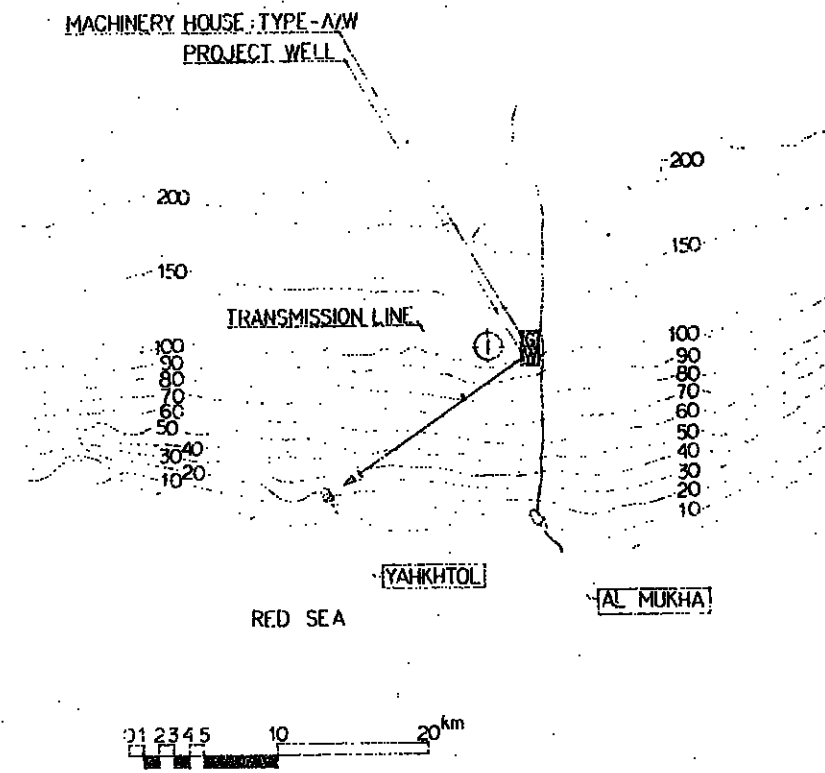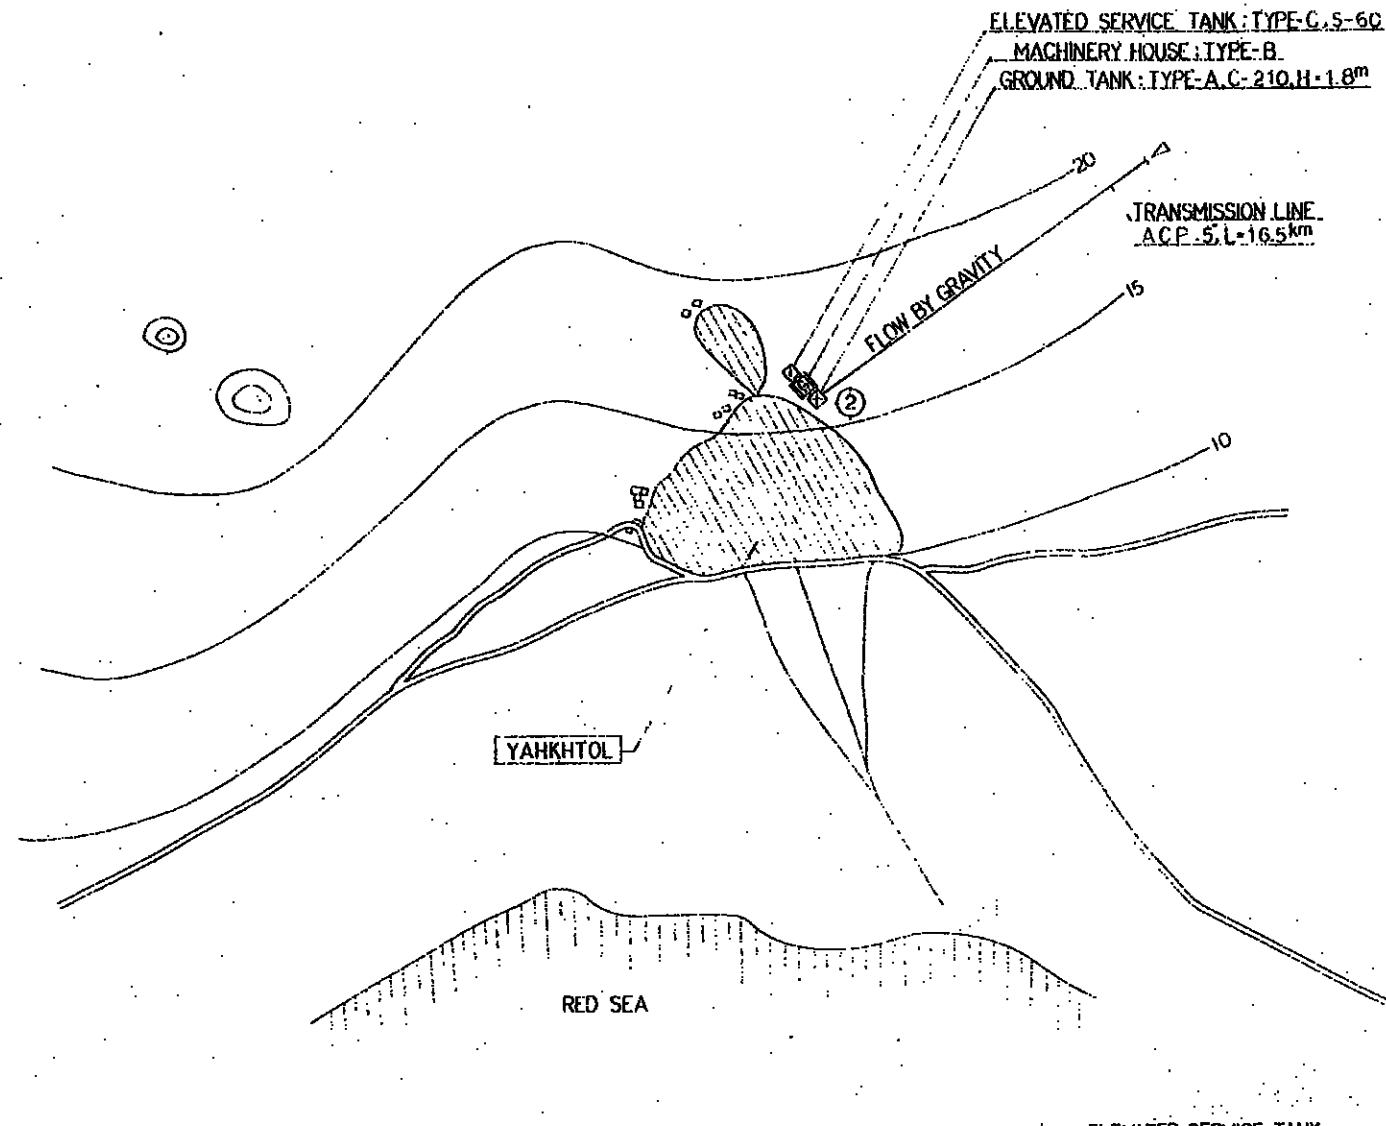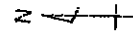

MINISTRY OF PUBLIC WORKS YEMEN ARAB REPUBLIC
THE RURAL WATER SUPPLY PROJECT, PART-II
T-8 : YAHKHTOL
DESIGNED BY: Pacific Consultants International
DATE: MAY 80 SCALE: 1: DRAWING No. 31
JAPAN INTERNATIONAL COOPERATION AGENCY, TOKYO, JAPAN

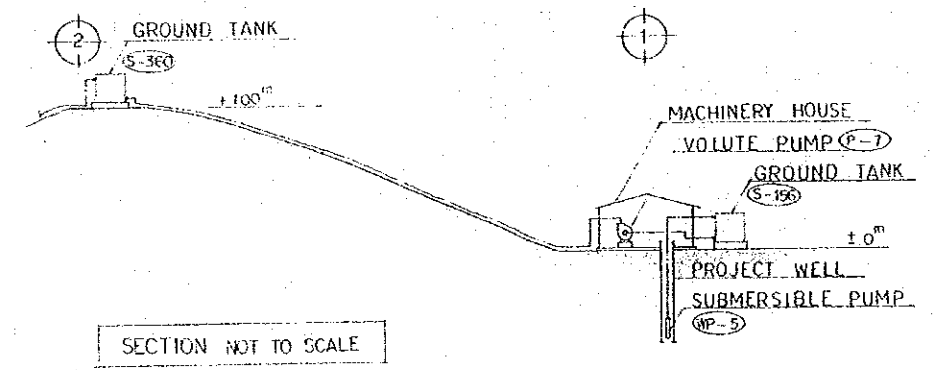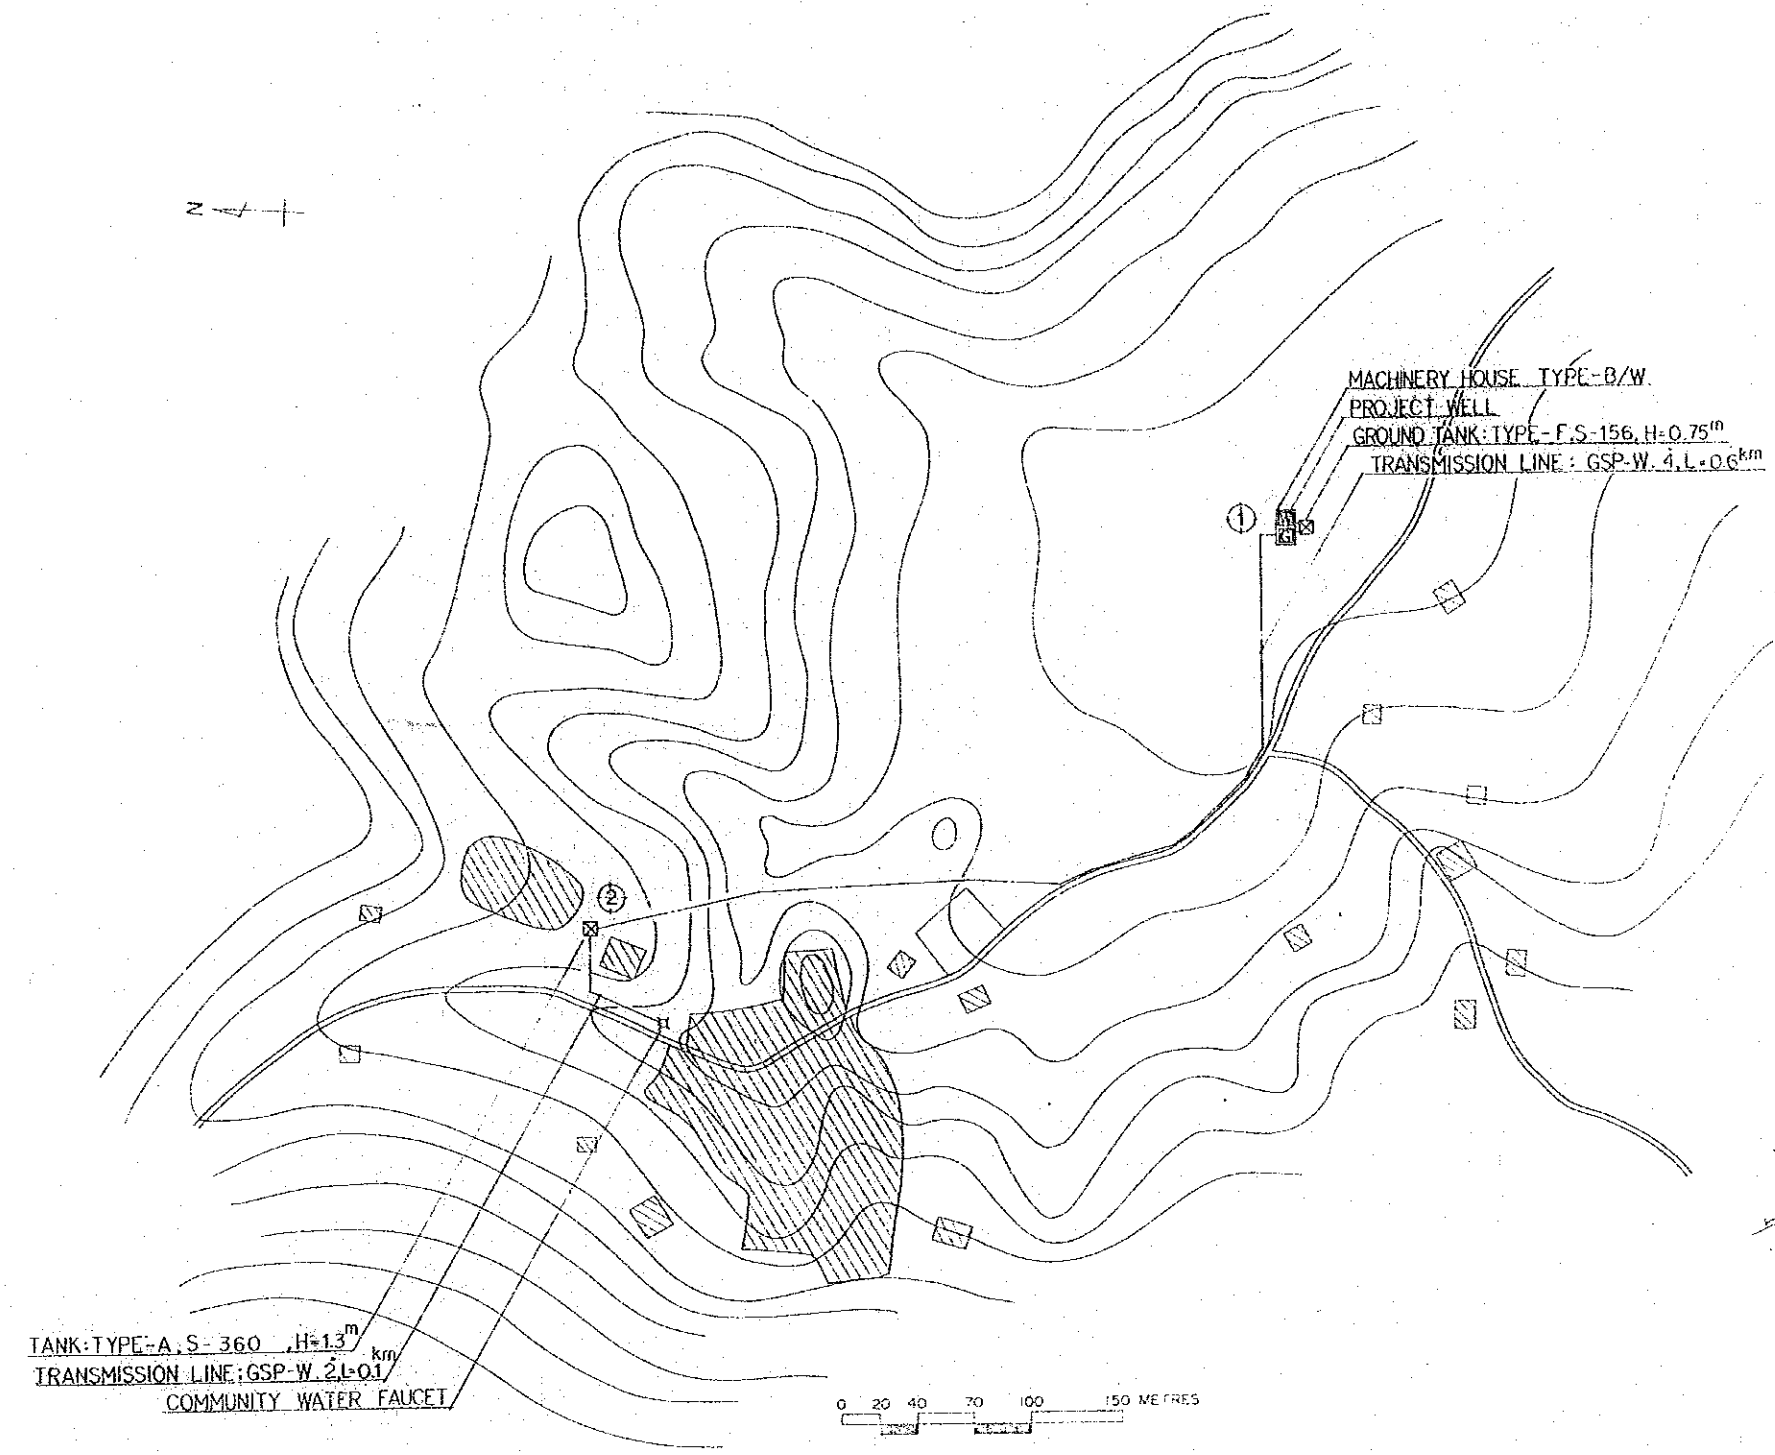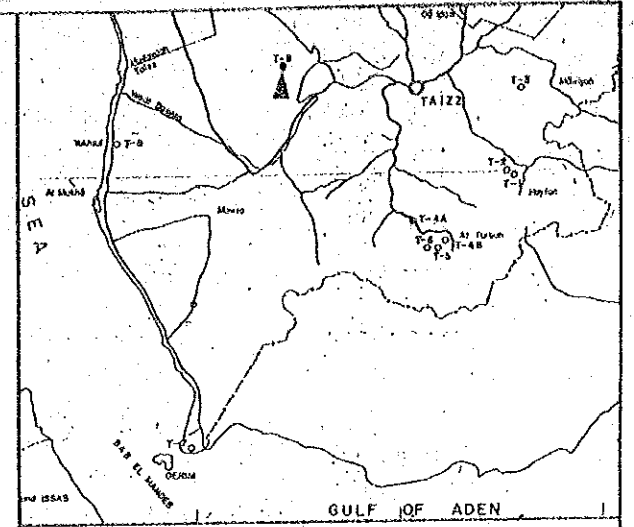

MAKBANA

MINISTRY OF PUBLIC WORKS YEMEN ARAB REPUBLIC	
THE RURAL WATER SUPPLY PROJECT PART-II	
T-9 : MAKBANA	
DESIGNED BY Pacific Consultants International	DATE MAY 1980
SCALE 1:	DRAWING No. 32
JAPAN INTERNATIONAL COOPERATION AGENCY, TOKYO, JAPAN	

GENERAL PLAN OF WATER SUPPLY SYSTEM - 1

PROJECT SITES				ITEMS	WATER SOURCE	FACILITY No	WELL DEPTH m	WELL PUMP TYPE	MACHINERY HOUSE TYPE	VOLUTE PUMP TYPE	GENERATOR RATED OUTPUT KVA	WATER TANK TYPE	SERVICE FACILITIES	REMARKS
GOVERNORATE	DISTRICT	SITE NO	SURVEY SITE											
AL AHNOON	AL AHNOON	HA - 1	AL-MADAN & 9 VILLAGES	2 WELLS	1	300	WP - 12	B - W	P - 2	175	E	S - 15	F - 3 F - 3 F - 3 F - 3 D - 3 D - 3 D - 3 D - 3	MAIN PIPE : 4", 3.0km 3", 2.0km 2 1/2", 2.0km 2", 2.3km WELL PROTECTIONS ARE SET UP.
				2	300	WP - 12	B - W	P - 12	100	E	S - 30			
				3			B	P - 2	100	E	S - 30			
				4			B	P - 2	100	E	S - 30			
				5			B	P - 7	45	G	S - 120			
				6			B	P - 8	30	G	S - 120			
				7			C	P - 9, 27	60	D	S - 60			
				8			B			B	S - 120			
				9			B	P - 14	30	G	S - 120			
				10			B			B	S - 120			
HAJJJA	HAJJJA	HA - 2	ELMAN & 4 OTHER VILLAGES	1 WELL	1	300	WP - 12	B - W	P - 10	100	E	S - 10	F - 2 F - 2 L - 2 L - 2 D - 2 D - 2	MAIN PIPE : 2", 2.1km 2 1/2", 1.0km WELL PROTECTION IS SET UP.
				2			B	P - 10	45	G	S - 60			
				3			B	P - 13	19	E	S - 5			
				4			B			B	S - 60			
HAJJJA	HAJJJA	HA - 3A	SIHARA	2 WELLS	1	300	WP - 12	B - W	P - 2	125	E	S - 15	F - 4x2 F - 4x2 D - 4x2 D - 4x2	MAIN PIPE : 4", 6.5km 3", 1.2km 2 1/2", 1.6km 2", 1.7km
				2	300	WP - 12	B - W	P - 19	100	E	S - 30			
				3			B	P - 2	100	E	S - 30			
				4			B	P - 2	100	E	S - 30			
				5			B	P - 2	100	E	S - 30			
				6			B	P - 2	100	E	S - 30			
				7			C	P - 6, 10	75	D	S - 75			
				8			A			A	S - 210			
				9			A			A	S - 210			
SIHARA	SIHARA	HA - 3B	THARI	2 WELLS	1	200	WP - 13	B - W	P - 2	125	E	S - 15	F - 5x3 F - 5x3 D - 5x3 D - 5x3	MAIN PIPE : 4", 5.2km 2 1/2", 2.8km WELL PROTECTIONS ARE SET UP.
				2	200	WP - 13	B - W	P - 20	60	E	S - 30			
				3			B	P - 2	100	E	S - 30			
				4			B	P - 2	100	E	S - 30			
				5			B	P - 2	100	E	S - 30			
				6			B	P - 3	100	E	S - 30			
				7			B	P - 22	30	F	S - 360			
				8			B			B	S - 324			
HARAD	HARAD	HA - 4	HARAD	3 WELLS	1	120	WP - 2	B / W	P - 16	60	A	C - 396	F - 5x2 F - 4x3 L - 4.5 L - 4x3 D - 5x2 D - 4x3	MAIN PIPE : 4", 0.8km
				2	120	WP - 1	A / W		60					
				3	120	WP - 2	B / W	P - 31	100	A	C - 864			

CLASSIFIED TYPE OF MACHINERY AND FACILITIES ARE SHOWN IN DRAWING No 37

MINISTRY OF PUBLIC WORKS YEMEN ARAB REPUBLIC	
THE RURAL WATER SUPPLY PROJECT PART-II	
GENERAL PLAN OF WATER SUPPLY SYSTEM - 1	
DESIGNED BY	Pacific Consultants International
DATE	MAY 1980
SCALE	1:1
DRAWING No.	33
JAPAN INTERNATIONAL COOPERATION AGENCY, TOKYO, JAPAN	

GENERAL PLAN OF WATER SUPPLY SYSTEM - 2

PROJECT SITES				ITEMS	WATER SOURCE	FACILITY No	WELL DEPTH (m)	WELL PUMP TYPE	MACHINERY HOUSE TYPE	VOLUTE PUMP TYPE	GENERATOR RATED OUTPUT (KVA)	WATER TANK		SERVICE FACILITIES			REMARKS	
GOVERNORATE	DISTRICT	SITE NO	SURVEY SITE									TYPE	CAPACITY (TON)	TYPE	CAPACITY (TON)	COMMUNITY WATER FAUCET		CATTLE TROUGH
AL MAHWEET	AL MAHWEET	A - 1	AL MAHWEET CITY	2 WELLS	1	200	WP - 13	B - W	P - 11	75	E	S - 15	F - 4,5	D - 4,5	MAIN PIPE : 3", 1.5km 4", 6.2km WELL PROTECTIONS ARE SET UP.			
					2	200	WP - 13	B - W	P - 5	100	E	S - 30						
					3			B	P - 4	60	F	S - 156						
					4			B	P - 3	75	F	S - 156						
					5						A	S - 360						
		1	200	WP - 13	B - W	P - 6	100	E	S - 10	F - 3	L - 2	D - 3	MAIN PIPE : 3", 14.1km WELL PROTECTION IS SUT UP.					
	2			B	P - 6	45	E	S - 10										
	3			B	P - 6	45	E	S - 10										
	4			B	P - 6	45	E	S - 10										
	5			B	P - 6	60	E	S - 10										
	6			B	P - 13	19	E	S - 10										
	7			B	P - 23	19	E	S - 10										
8						A	S - 120											
A - 3	AL RAJAM	1 WELL	1	300	WP - 12	B - W	P - 26	100	E	S - 5	F - 2	L - 2	D - 2	MAIN PIPE : 2 1/2", 3.5km				
			2						A	S - 60								
			1	200	WP - 14	B / W	P - 9	60	E	S - 10					F - 3	L - 2	D - 3	MAIN PIPE : 2 1/2", 6.1km
			2			B	P - 9	45	E	S - 10								
3						A	S - 120											
S - 1	AL SUHMAN	BANY SHAKER E. BAIT ABO SABA'A	1 WELL	1	200	WP - 13	B - W	P - 27	75	E	S - 5	F - 1	L - 2	D - 1	MAIN PIPE : 2 1/2", 0.81km			
				2						A	S - 40							
S - 2	BANY FARHAN E. BANY SHRIA'A	1 WELL	1	200	WP - 13	C / W	P - 30,32	60	D	S - 10	F - 1	L - 1	D - 1	MAIN PIPE : 2", 0.8km 1 1/2", 0.4km				
			2						B	S - 10								
			3						B	S - 30								
S - 3	AL SHEAB AL ASWAD	1 WELL	1	100	WP - 13					60					MAIN PIPE : 3", 0.45km 2 1/2", 0.2km 1 1/2", 0.6km			
			2			A - W					D	S - 40	F - 2	L - 4,5		D - 2		
			3								A	S - 120						
			4								A	S - 120						
			5															
1	100	WP - 13	A / W					60							MAIN PIPE : 3", 0.25km			
2								A	S - 40	F - 2	L - 3	D - 2						

MINISTRY OF PUBLIC WORKS
YEMEN ARAB REPUBLIC

THE RURAL WATER SUPPLY
PROJECT PART-II

GENERAL PLAN OF WATER SUPPLY
SYSTEM - 2

DESIGNED BY Pacific Consultants International
DATE MAY 80 SCALE 1: DRAWING No. 34

JAPAN INTERNATIONAL COOPERATION
AGENCY, TOKYO, JAPAN

GENERAL PLAN OF WATER SUPPLY SYSTEM - 3

PROJECT SITES				ITEMS	WATER SOURCE	FACILITY No	WELL DEPTH (m)	WELL PUMP TYPE	MACHINERY HOUSE TYPE	VOLUTE PUMP TYPE	GENERATOR RATED OUTPUT KVA	WATER TANK				SERVICE FACILITIES			REMARKS
GOVERNORATE	DISTRICT	SITE NO	SURVEY SITE									TYPE	CAPACITY TON	TYPE	CAPACITY TON	COMMUNITY WATER FAUCET	CATTLE TROUGH	DRAINAGE BASIN	
HOEIDAHA	DURAIHMI	H - 1	GHULAYFAGAH	1 WELL	1	30	WP - 16	B / W	P - 29	1.9	A	C - 30	C	S - 10	F - 1	L - 1	D - 1	MAIN PIPE: 4', 0.7km	
	HOEIDAHA	H - 2	AL DAHI	2 WELLS	1	80	WP - 4	B / W-W	P - 31	12.5	A	C - 864 120	C	S - 156					
					2	80	WP - 4												
	ZUHRAH	H - 3	AL MOUNIRAH (to supply Ebn Abbas and Al Harunia)	1 WELL	1	60	WP - 8	A / W		3.0	F	C - 60			F - 5	L - 1	D - 5	MAIN PIPE: 4', 18.8km 3', 6.3km	
					2			B	P - 18	1.9	F	C - 120	C	S - 30	F - 2	L - 1	D - 2		
					3			C	P - 25,30	4.5	F	C - 60	C	S - 15	F - 2	L - 1	D - 2		
					4			B	P - 29	12.5	A	C - 60	C	S - 15	F - 2	L - 1	D - 2		
TAIZ	AL SULOU	T - 1	AL MASHJAB	1 WELL	1	110	WP - 8	A / W		4.5	A	S - 75			F - 2	L - 4x2 5	D - 2	MAIN PIPE: 4', 1.1km 2 1/2, 2.5km	
					2														
			T - 2	AL MANARA E AL DUKUM	1 WELL	1	110	WP - 7	A / W		7.5	F	S - 40			F - 2	L - 4x3	D - 2	
						2						A	S - 40			F - 2	L - 4x3	D - 2	
						3													
		KADIER AL BURAIHI	T - 3	AL MAYDAN AL JUBAIL SHEIBD HAMUD	1 WELL	1	200	WP - 6	C / W	P - 23,25	12.5	D	S - 15			F - 1	L - 3	D - 1	MAIN PIPE: 4', 3.0km
						2						A	S - 40			F - 1	L - 3	D - 1	
						3						A	S - 40						
			T - 4A	HADAD, QAHA	1 WELL	1	180	WP - 8	C / W	P - 24,26	7.5	D	S - 30			F - 2	L - 3	D - 2	MAIN PIPE: 3', 0.7km 2 1/2, 0.6km
						2						A	S - 75			F - 2	L - 4	D - 2	
					3						B	S - 60							
		T - 4B	AL KUDHA, AL HAGL	1 WELL	1	250	WP - 13	C / W	P - 32,33	10.0	D	S - 15			F - 3		D - 3	MAIN PIPE: 1 1/2, 1.1km	
					2						A	S - 60			F - 3		D - 3		
					3						A	S - 60							
	AL TURBA	T - 5	SHOHAT, AL KADASH	UNDERGROUND DAM + 2 WELLS	1	30	WP - 15											MAIN PIPE: 2', 1.25km 2 1/2, 0.4km	
					2	30	WP - 15												
					3			B - 2W	P - 13	6.0	E	S - 10							
					4			B	P - 27	1.9	F	S - 75			F - 2	L - 4	D - 2		
					5						A	S - 60			F - 2	L - 4	D - 2		
		T - 6	AL ZAKIRA	2 WELL	1	250	WP - 12	B / W	P - 29	7.5	E	S - 15						MAIN PIPE: 2', 0.42km 3', 0.9km	
					2	250	WP - 12												
					3			B - W	P - 9	12.5	F	S - 75			F - 1		D - 1		
					4			B	P - 11	3.0	E	S - 10							
					5			B	P - 12	3.0	E	S - 15							
					6						B	S - 210			F - 3,4		D - 3,4		

MINISTRY OF PUBLIC WORKS
YEMEN ARAB REPUBLIC

THE RURAL WATER SUPPLY
PROJECT PART-II

GENERAL PLAN OF WATER SUPPLY
SYSTEM- 3

DESIGNED BY Pacific Consultants International

DATE: MAY 80 SCALE 1: DRAWING No. 35

JAPAN INTERNATIONAL COOPERATION
AGENCY, TOKYO, JAPAN

GENERAL PLAN OF WATER SUPPLY SYSTEM -4

PROJECT SITES				ITEMS	WATER SOURCE	FACILITY No	WELL DEPTH (M)	WELL PUMP TYPE	MACHINERY HOUSE TYPE	VOLUME PUMP TYPE	GENERATOR RATED OUTPUT KVA	WATER TANK			SERVICE FACILITIES			REMARKS	
GUBERHORATE	DISTRICT	SITE NO	SURVEY SITE									TYPE	CAPACITY TON	TYPE	CAPACITY TON	COMMUNITY WATER FAUCET	CATTLE TROUGH		DRAINAGE BASIN
TAIZ	BAB AL MANDAB	T - 7	BAB AL MANDAB	3 WELLS	1	8.5	WP - 10	A / W			3.0							MAIN PIPE: 6" 0.5 km 5" 48.0 4" 2.0 3" 2.0	
					2	8.5	WP - 10	A / W											
					3	8.5	WP - 11	B / W	P - 1	1.50	E	C - 75							
					4			C	P - 1.22	1.50	F	C - 210							
					5						C	S - 40				F - 3	L - 1		D - 3
					6			B	F - 1	1.50	E	C - 60							
					7			B	P - 15	3.0	E	C - 768	C	S - 150		F - 4x3	L - 1		D - 4x3
	MOJAH	T - 8	YAKHTOL	1 WELL	1	100	WP - 6	A / W			4.5							MAIN PIPE: 5" 16.5 km	
					2			B	P - 17	1.9	A	C - 210	C	S - 60		F - 4x2	L - 5x4		D - 4x2
	MAKBANA	T - 9	MAKBANA	1 WELL	1	300	WP - 5	B / W			100							MAIN PIPE: 4" 0.6 km	
					2											F - 5x2	L - 5		D - 5x2

X GENERATOR RATED OUTPUT These are the output indications at sea level.
 XX CAPACITY
 C-210 S-210
 CAPACITY 210 ton
 STEEL TANK
 CAPACITY 210 ton
 CONCRETE TANK


MINISTRY OF PUBLIC WORKS
 YEMEN ARAB REPUBLIC
 THE RURAL WATER SUPPLY
 PROJECT PART-II
 GENERAL PLAN OF WATER SUPPLY
 SYSTEM -4
 DESIGNED BY Pacific Consultants International
 DATE MAY 1980 SCALE 1: DRAWING No. 36
 JAPAN INTERNATIONAL COOPERATION
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EQUIPMENT SCHEDULE

TYPE	NO	PUMP SPECIFICATION					Q.T.Y	SITE NO	
		DIAMETER (mm Φ)	QUANTITY OF FLOW (l/min)	HEAD (m)	NO OF STAGE	POWER OUT -PUT (kw)			
SUBMERSIBLE PUMP	WP-1	100	690	137	9	30.0	1	HA-4 (1)	
	-2	100	690	116		26.0	2	HA-4 (2)	
	-3	100	690	81		22.0	1	H-2 (1)	
	-4	100	690	70		19.0	1	H-2 (1)	
	-5	80	480	228		30.0	1	T-9 (1)	
	-6	80	690	116		26.0	2	T-3 (1), T-8 (1)	
	-7	65	270	224		30.0	1	T-2 (1)	
	-8	65	340	172		19.0	2	T-1 (1), T-4A (1)	
	-9	65	340	96		15.0	1	H-3 (1)	
	-10	65	340	67		11.0	2	T-7 (2)	
	-11	65	340	62		7.5	1	T-7 (1)	
	-12	50	200	222		30.0	8	HA-1 (2), HA-2 (1), HA-3A (2), A-3 (1), T-6 (2)	
	-13	50	200	180		19.0	10	HA-3B (2), A-1 (2), A-2 (1), S-1 (1), S-2 (1), S-4 (1), T-4B (1), S-3 (1)	
	-14	50	130	117		11.0	1	A-4 (1)	
	-15	50	65	65		7.5	2	T-5 (2)	
	-16	50	70	34		3.7	1	H-1 (1)	
VOLUTE PUMP	P-1	100-80	810	200	4	55.0	3	T-7 (3)	
	-2	80-65	400	234	5	37.0	12	HA-1 (3), HA-3A (5), HA-3B (4)	
	-3	80-65	400	177	4	30.0	2	HA-3B (1), A-1 (1)	
	-4	80-65	400	138	3	22.0	1	A-1 (1)	
	-5	80-65	400	132	3	18.5	1	A-1 (1)	
	-6	50	200	240	6	18.5	6	HA-3A (1), A-2 (5)	
	-7	50	32	132	4	15.0	2	HA-1 (1), T-9 (1)	
	-8	50	240	122	4	11.0	1	HA-1 (1)	
	-9	40	210	200	11	15.0	4	HA-1 (1), A-4 (2), T-6 (1)	
	-10	40	100	237	10	15.0	2	HA-2 (2)	
	-11	40	210	152	8	11.0	2	T-6 (1), A-1 (1)	
	-12	40	210	120	7	11.0	2	HA-1 (1), T-6 (1)	
	-13	40	200	121	6	7.5	3	HA-2 (1), A-2 (1), T-5 (1)	
	-14	40	80	127	6	5.5	1	HA-1 (1)	
	-15	125	1200	37	2	15.0	1	T-7 (1)	
	-16	100	690	27	2	7.5	1	HA-4 (1)	
	-17	80	450	28	2	5.5	1	T-8 (1)	
	-18	65	340	41	4	5.5	1	H-3 (1)	
	-19	50	200	90	9	7.5	1	HA-3A (1)	
	-20	50	200	70	8	5.5	2	HA-3A (1), HA-3B (1)	
	-21								
	-22	50	200	53	6	5.5	2	HA-3B (1), T-7 (1)	
	-23	50	200	49	5	3.7	2	A-2 (1), T-3 (1)	
	-24	50	200	34	4	3.7	1	T-4A (1)	
	-25	50	200	28	3	2.2	2	H-3 (1), T-3 (1)	
	-26	40	140	73	8	3.7	2	A-3 (1), T-4A (1)	
	-27	40	130	57	7	3.7	3	HA-1 (1), S-1 (1), T-5 (1)	
	-28								
	-29	40	140	28	4	2.2	3	H-1 (1), H-3 (1), T-6 (1)	
	-30	40	140	18	3	1.5	2	S-2 (1), H-3 (1)	
	-31	150	2760	30	1	22.0	2	HA-4 (1), H-2 (1)	
	-32	40	40	36		1.5	2	S-2 (1), T-4B (1)	
	-33	40	35	49		2.2	1	T-4B (1)	


MINISTRY OF PUBLIC WORKS YEMEN ARAB REPUBLIC		
THE RURAL WATER SUPPLY PROJECT PART-II		
EQUIPMENT SCHEDULE		
DESIGNED BY	Pacific Consultants International	
DATE	MAY 80	DRAWING No. 37
JAPAN INTERNATIONAL COOPERATION AGENCY, TOKYO, JAPAN		

D. WATER WELL

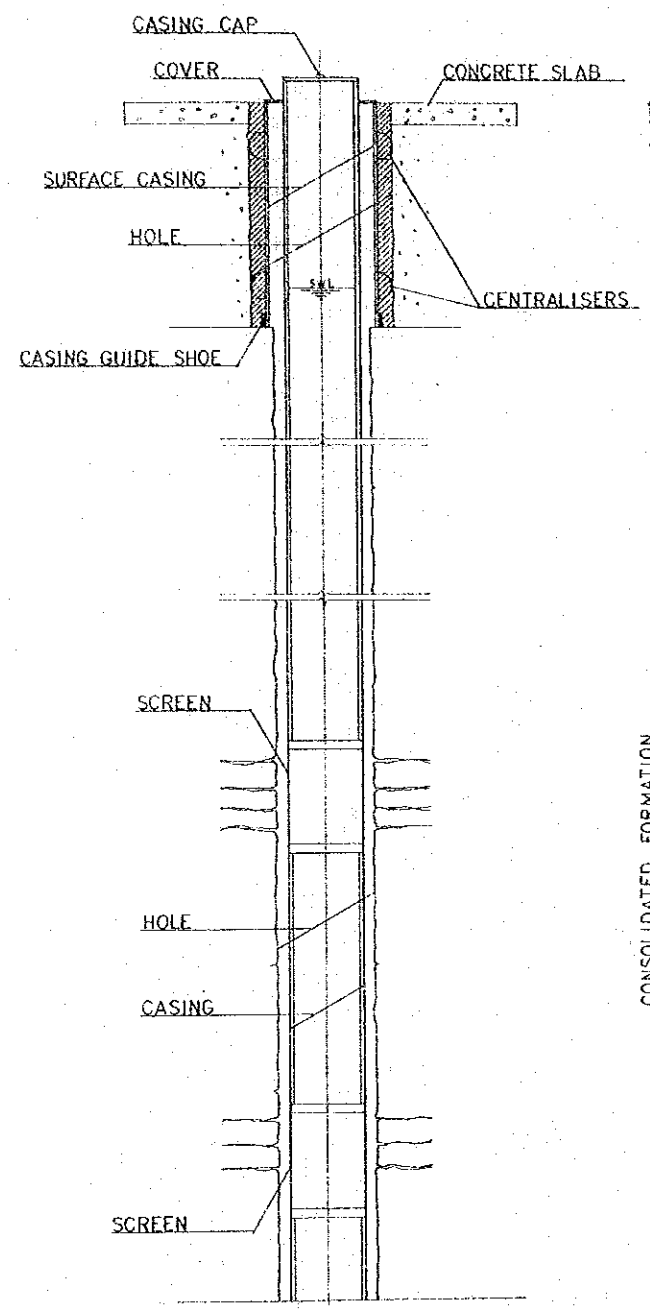


TYPICAL SECTION OF WATER WELL
(FOR CONSOLIDATED FORMATION)


(NOT TO SCALE)

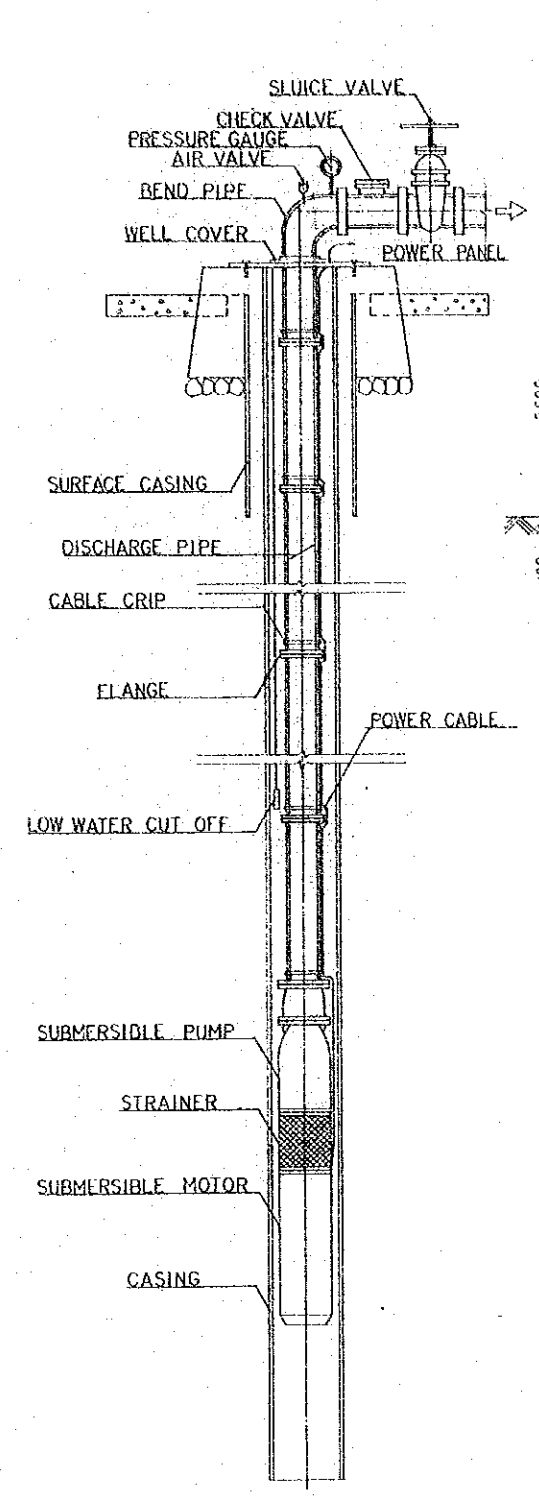

DETAIL OF
SUBMERSIBLE PUMP INSTALLATION

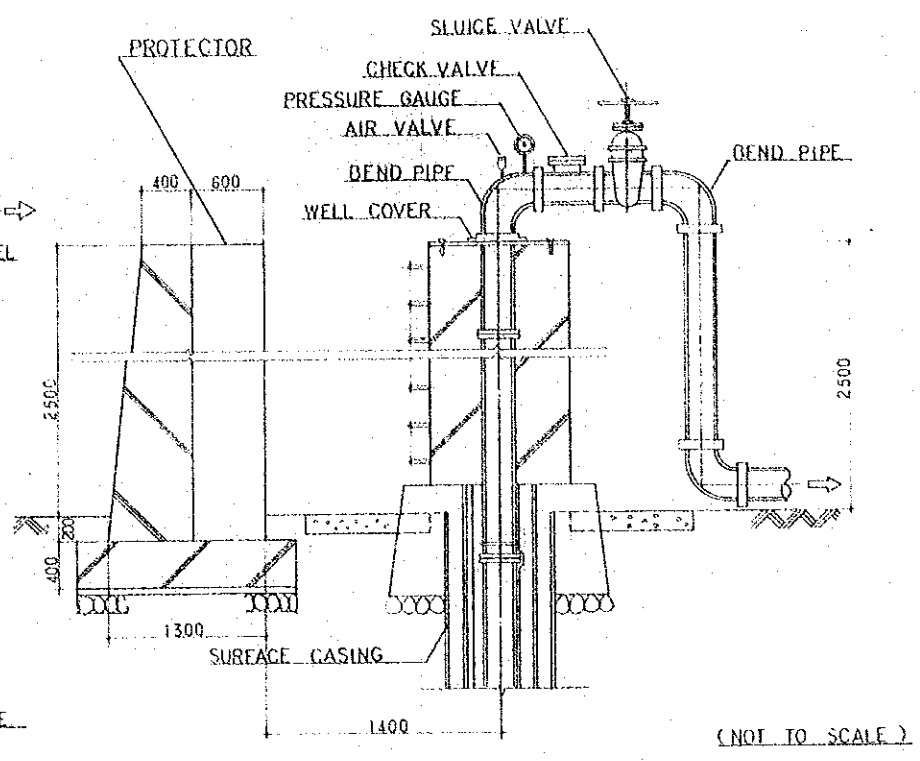

(NOT TO SCALE)


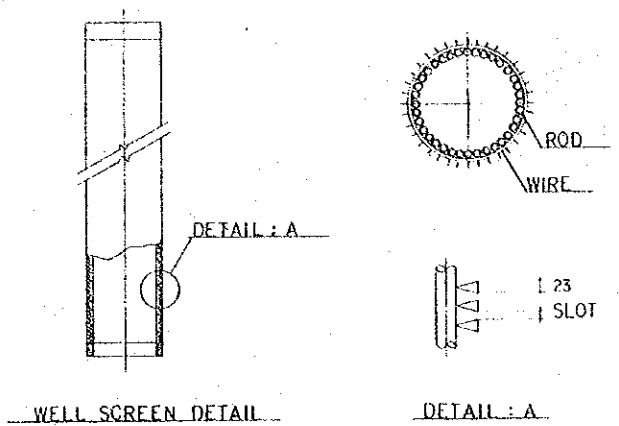


WELL SCREEN DETAIL

DETAIL : A

(NOT TO SCALE)


MINISTRY OF PUBLIC WORKS YEMEN ARAB REPUBLIC			
THE RURAL WATER SUPPLY PROJECT PART-II			
PROJECT WELL OF CONSOLIDATED FORMATION			
DESIGNED BY Pacific Consultants International			
DATE	MAY 90	SCALE 1:	DRAWING No. 38
JAPAN INTERNATIONAL COOPERATION AGENCY, TOKYO, JAPAN			

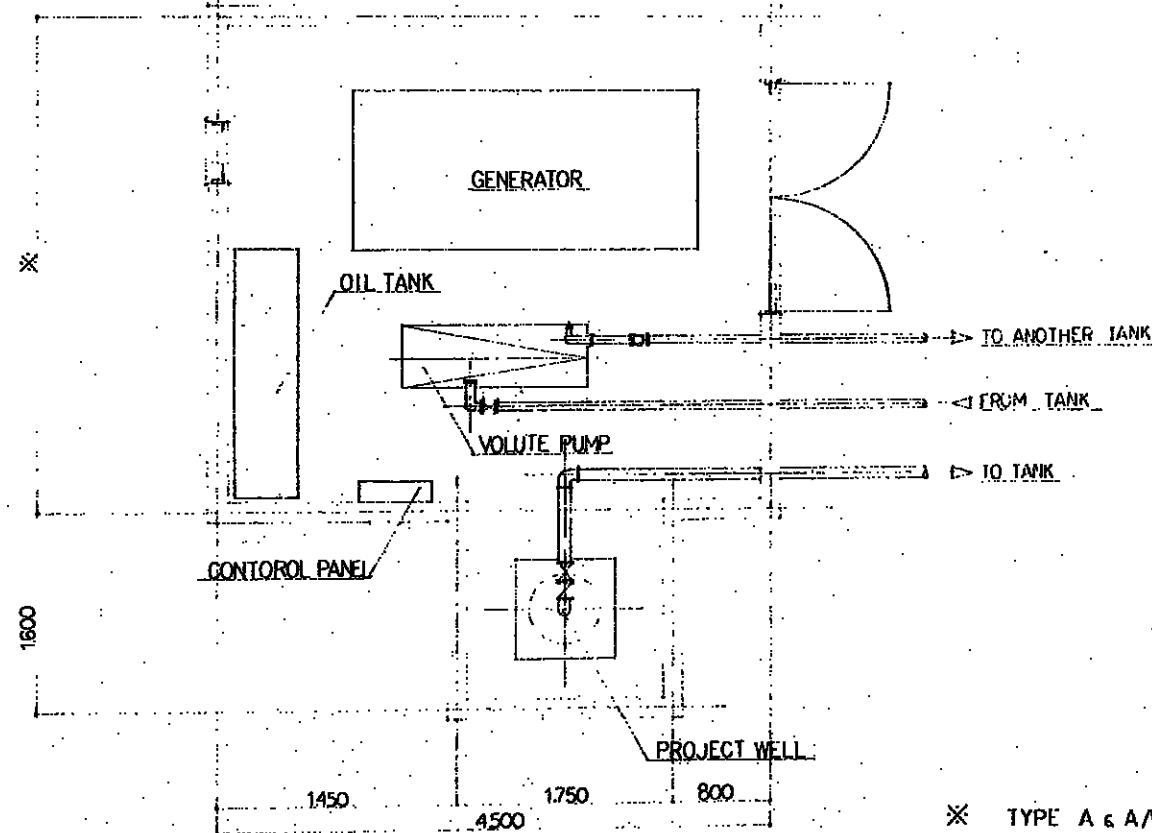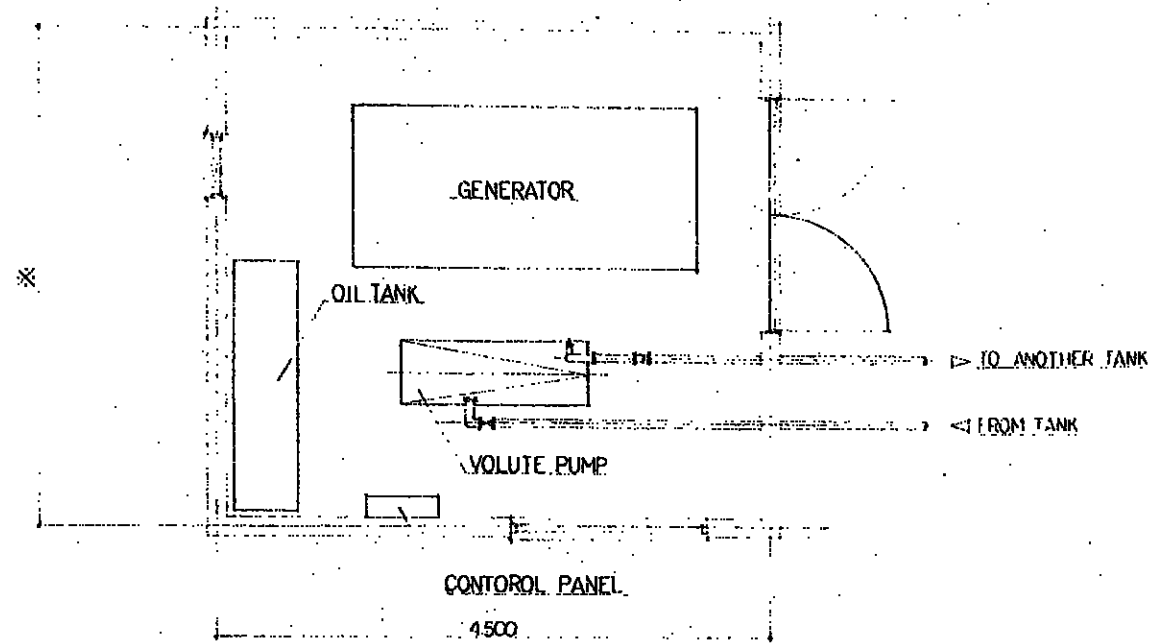


* TYPE A & A/W --- 2900
 TYPE B & B/W --- 4000
 TYPE C & C/W --- 5000

TYPICAL LAYOUT OF WATER WELL & MACHINERY HOUSE


A · B · C

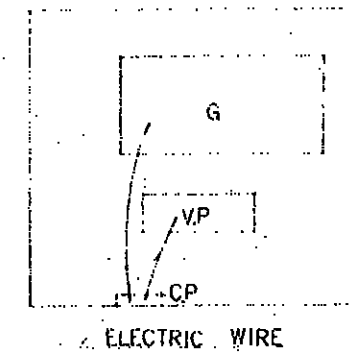

A-W, B-W, C-W

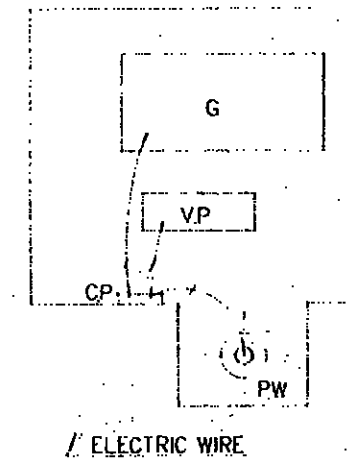

A-W, B-W, C-W

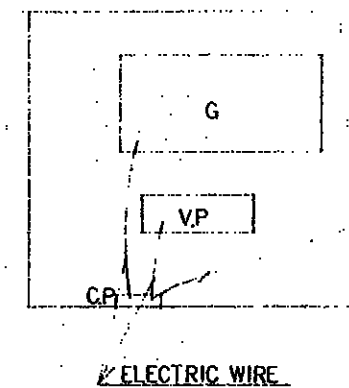


G GENERATOR
 V.P VOLUTE PUMP
 C.P CONTROL PANEL
 P.W PROJECT WELL


EXPLANATION OF MACHINERY HOUSES

MINISTRY OF PUBLIC WORKS YEMEN ARAB REPUBLIC		
THE RURAL WATER SUPPLY PROJECT PART-II		
TYPICAL LAYOUT OF WATER WELL & MACHINERY HOUSE		
DESIGNED BY	Pacific Consultants International	
DATE	MAY 80	SCALE: 1:30 DRAWING No. 39
JAPAN INTERNATIONAL COOPERATION AGENCY, TOKYO, JAPAN		


E. BUILDING WORKS

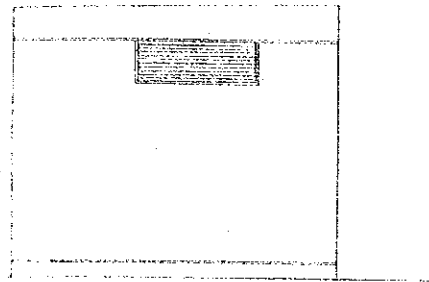


FRONT VIEW

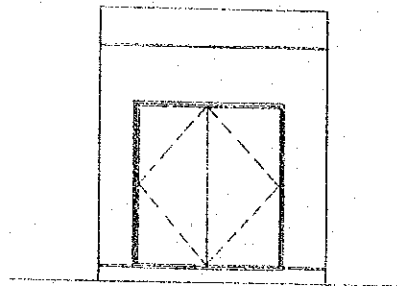


RIGHT SIDE VIEW

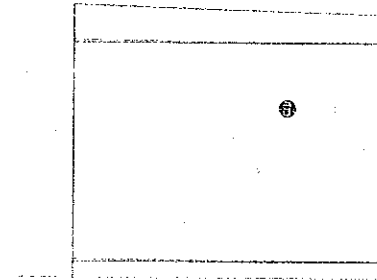


BACK VIEW

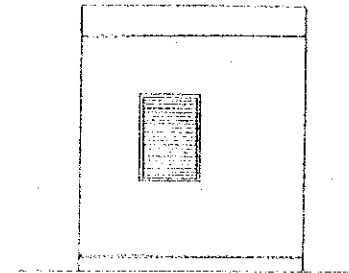


LEFT SIDE VIEW

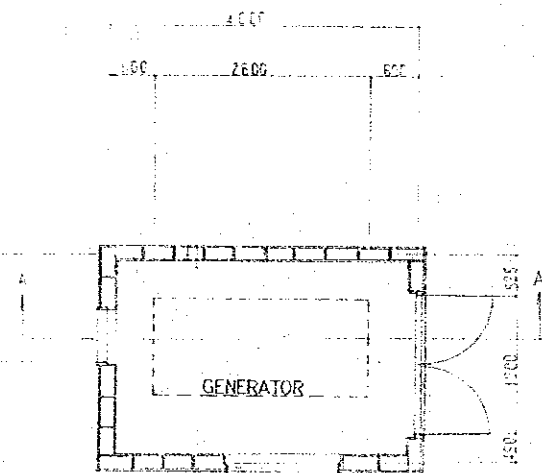


SECTION C-C

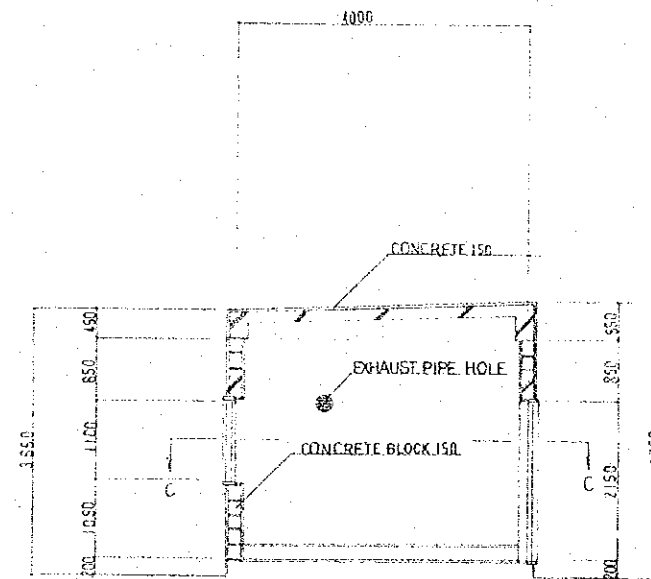


SECTION A-A

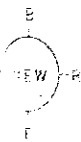


MINISTRY OF PUBLIC WORKS YEMEN ARAB REPUBLIC			
THE RURAL WATER SUPPLY PROJECT PART-II			
MACHINERY HOUSE: TYPE --A			
DESIGNED BY	Pacific Consultants International		
DATE	MAY 80	SCALE 1:50	DRAWING No. 40
JAPAN INTERNATIONAL COOPERATION AGENCY, TOKYO, JAPAN			

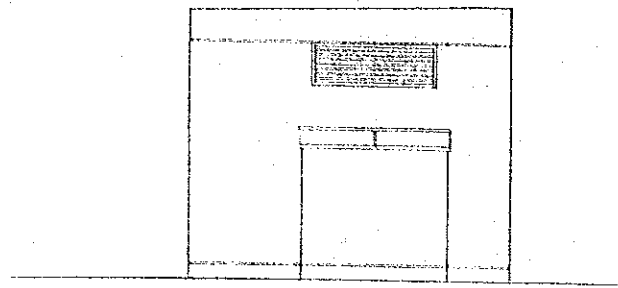


FRONT VIEW

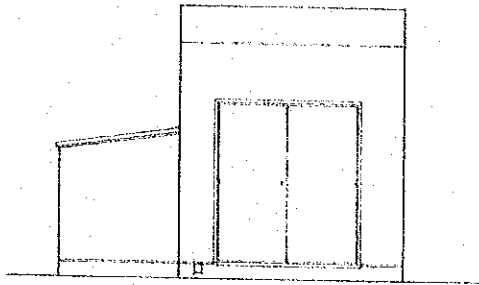


RIGHT SIDE VIEW

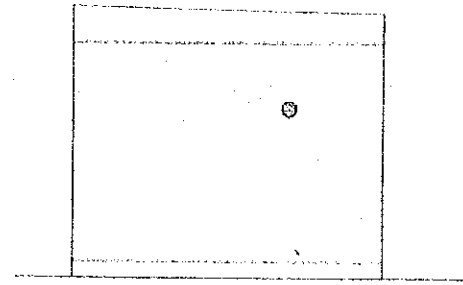


BACK VIEW

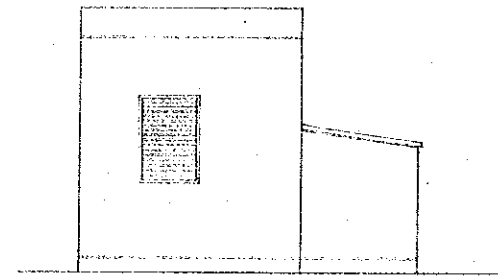


LEFT SIDE VIEW

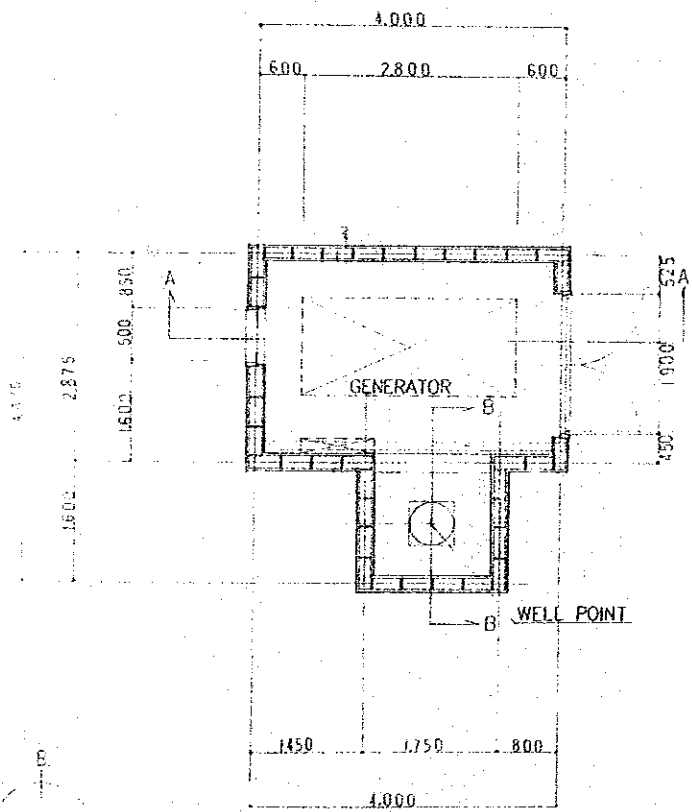


SECTION C-C

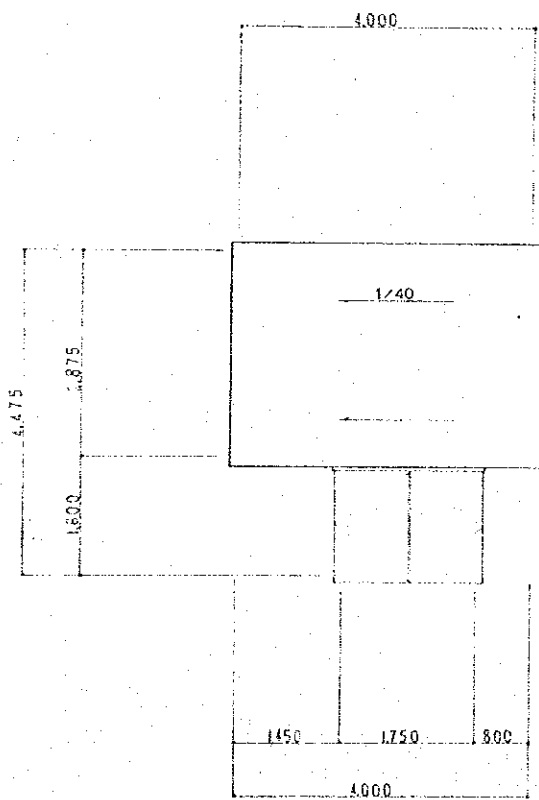


ROOF PLAN

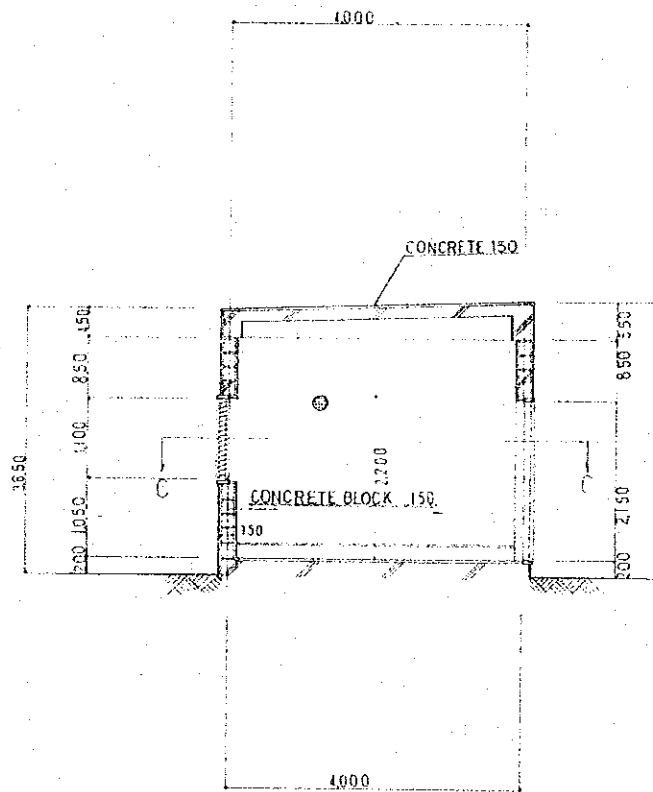


SECTION A-A

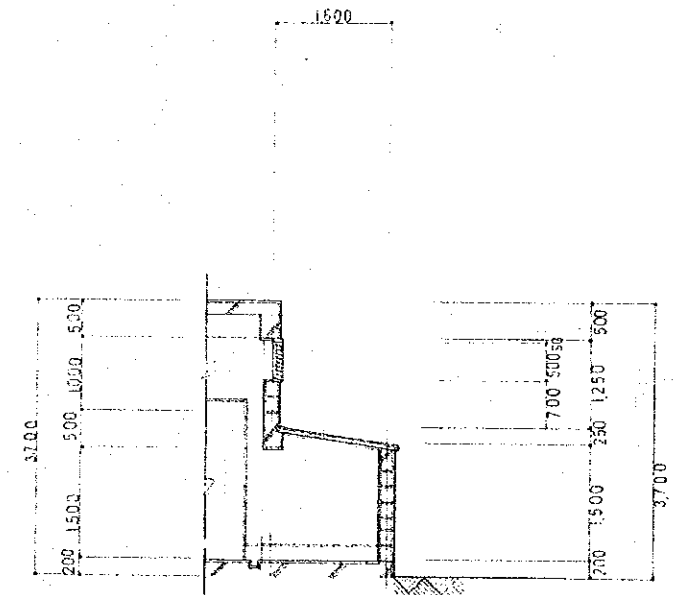


SECTION B-B

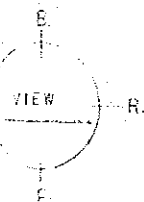


MINISTRY OF PUBLIC WORKS YEMEN ARAB REPUBLIC			
THE RURAL WATER SUPPLY PROJECT - PART - II			
MACHINERY HOUSE : TYPE - A/W			
DESIGNED BY	Pacific Consultants International		
DATE	MAY 80	SCALE 1:50	DRAWING No. 41
JAPAN INTERNATIONAL COOPERATION AGENCY, TOKYO, JAPAN			

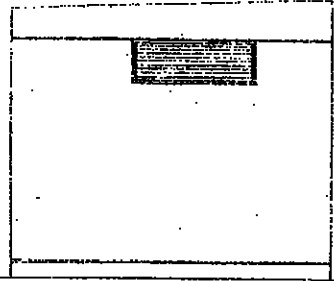


FRONT VIEW

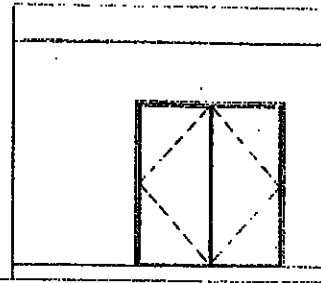


RIGHT SIDE VIEW

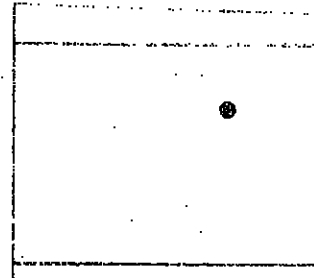


BACK VIEW

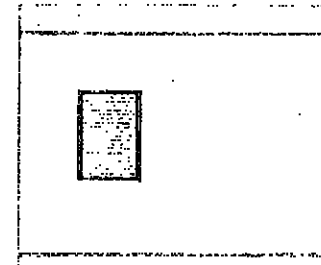


LEFT SIDE VIEW

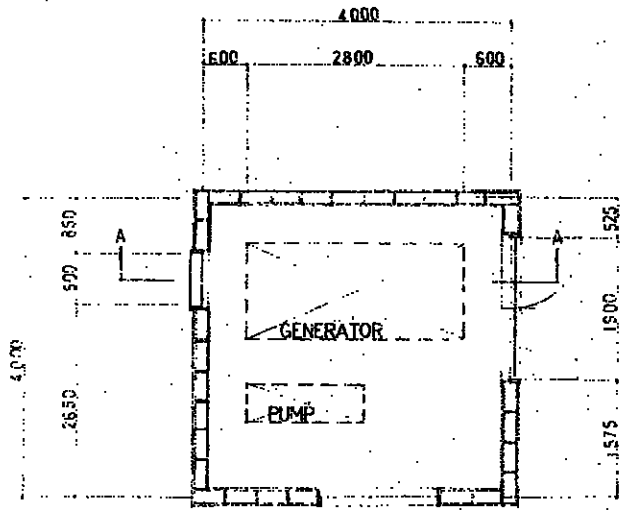


SECTION C-C

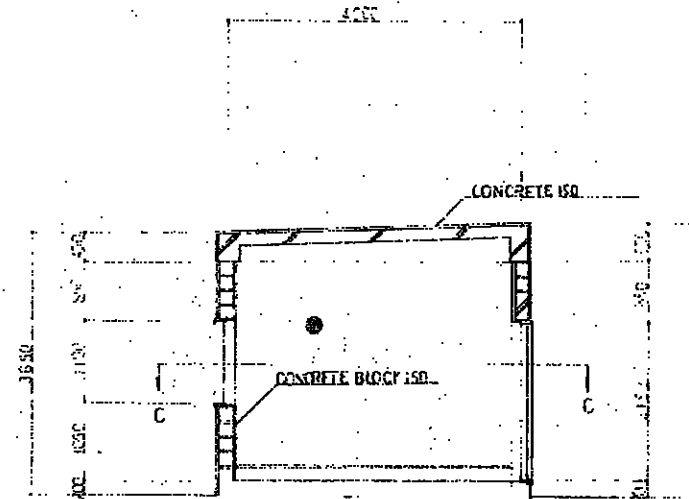


SECTION A-A

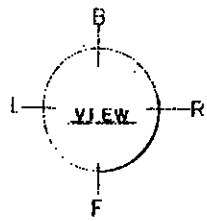


MINISTRY OF PUBLIC WORKS, YEMEN ARAB REPUBLIC			
THE RURAL WATER SUPPLY PROJECT PART - II			
MACHINERY HOUSE : TYPE - B			
DESIGNED BY	Pacific Consultants International		
DATE	MAY 80	SCALE	1:50
		DRAWING No.	42
JAPAN INTERNATIONAL COOPERATION AGENCY, TOKYO, JAPAN			

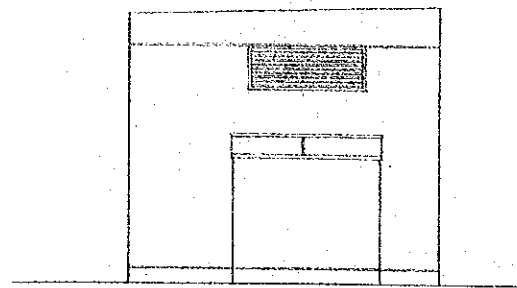


FRONT VIEW

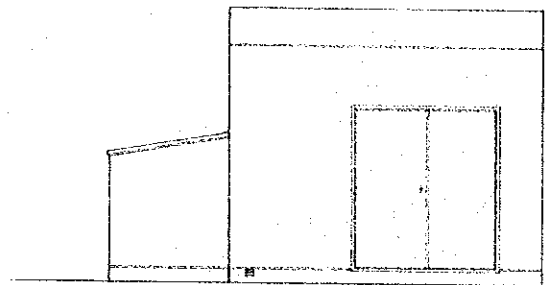


RIGHT SIDE VIEW

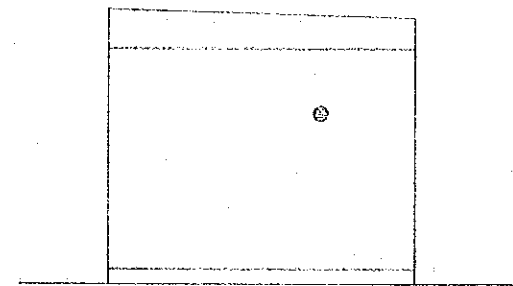


BACK VIEW

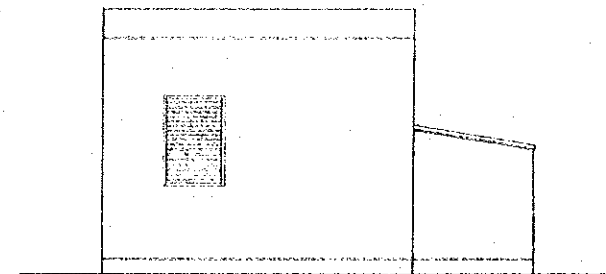


LEFT SIDE VIEW

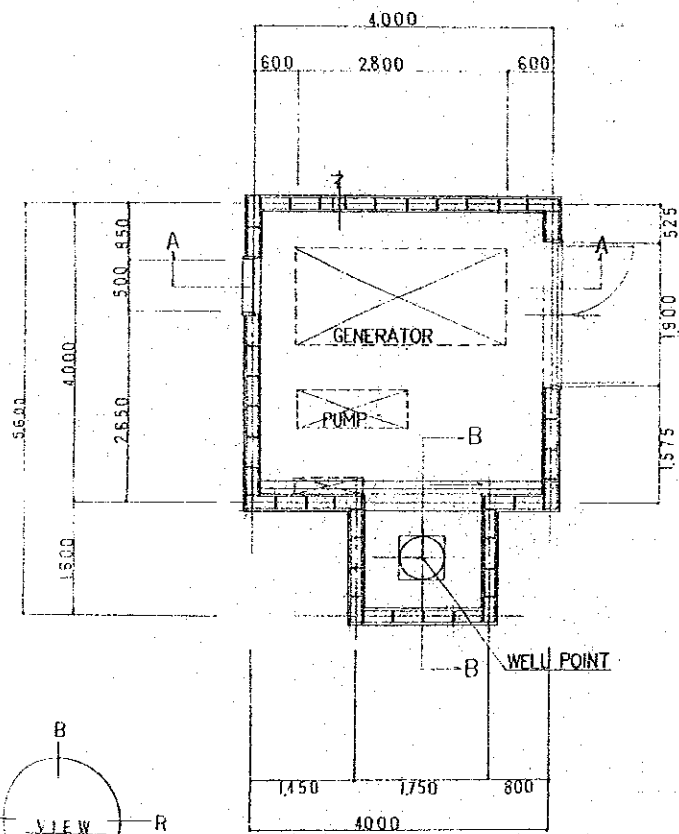


SECTION C-C

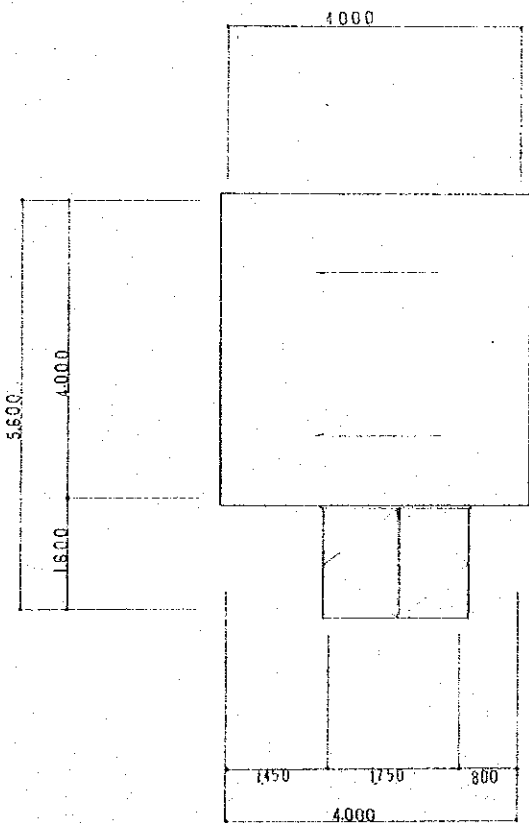

ROOF PLAN

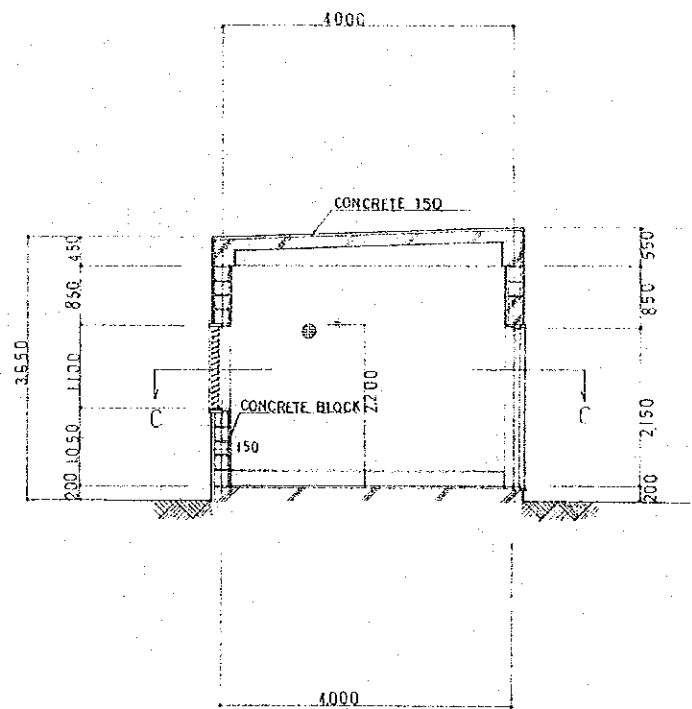


SECTION A-A

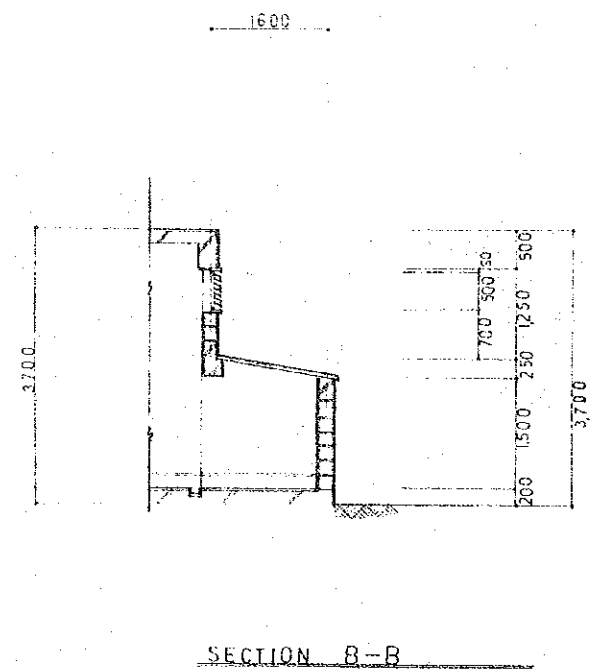


SECTION B-B


MINISTRY OF PUBLIC WORKS YEMEN ARAB REPUBLIC			
THE RURAL WATER SUPPLY PROJECT PART-II			
MACHINERY HOUSE : TYPE-B/W			
DESIGNED BY	Pacific Consultants International		
DATE	MAY 80	SCALE	1:50 DRAWING No. 43
JAPAN INTERNATIONAL COOPERATION AGENCY, TOKYO, JAPAN			

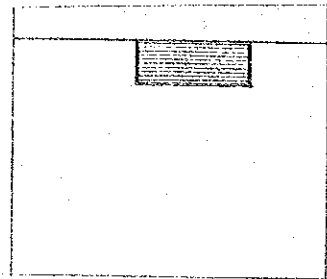


FRONT VIEW

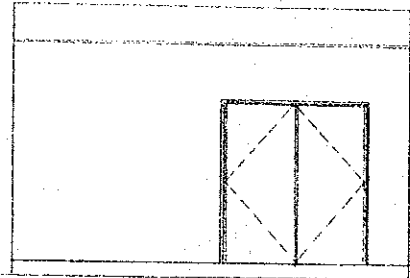


RIGHT SIDE VIEW

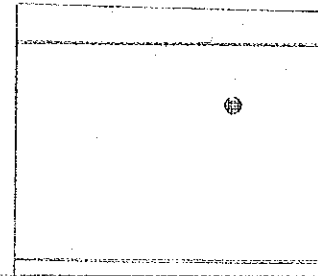


BACK VIEW

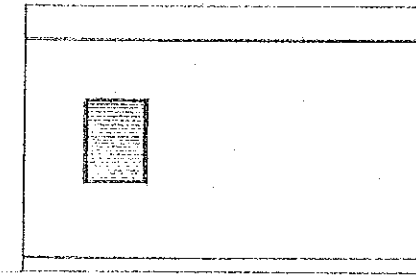


LEFT SIDE VIEW

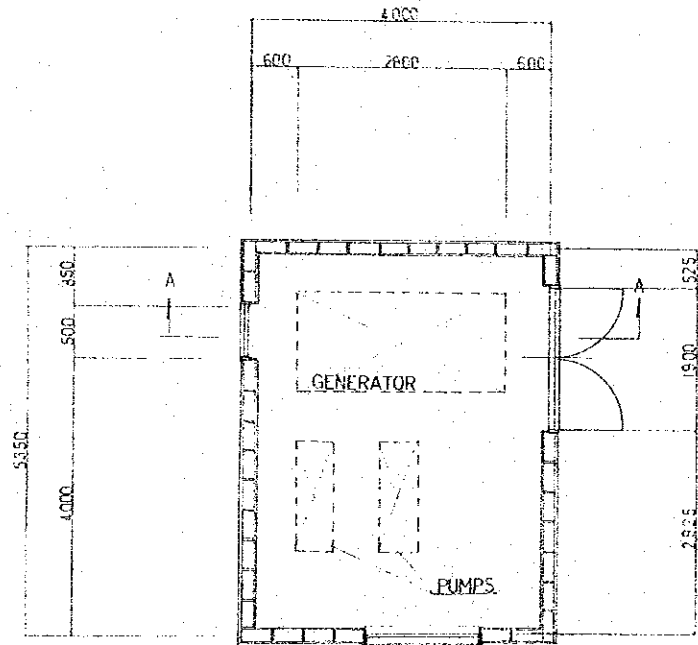


SECTION C-C

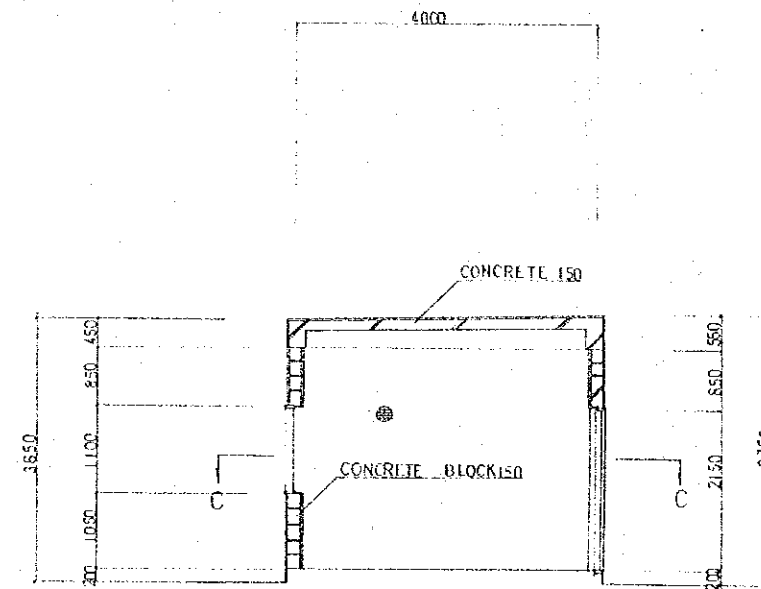


SECTION A-A

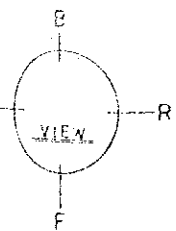


MINISTRY OF PUBLIC WORKS YEMEN ARAB REPUBLIC		
THE RURAL WATER SUPPLY PROJECT PART-II		
MACHINERY HOUSE: TYPE-C		
DESIGNED BY	Pacific Consultants International	
DATE	MAY 80	SCALE 1: 50 DRAWING No. 44
JAPAN INTERNATIONAL COOPERATION AGENCY, TOKYO, JAPAN		

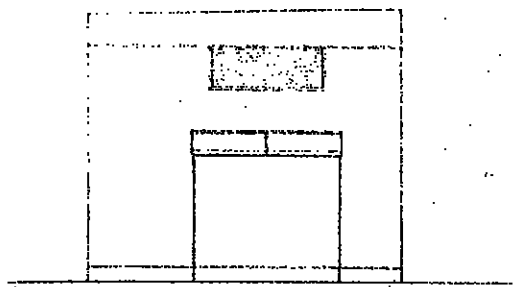


FRONT VIEW

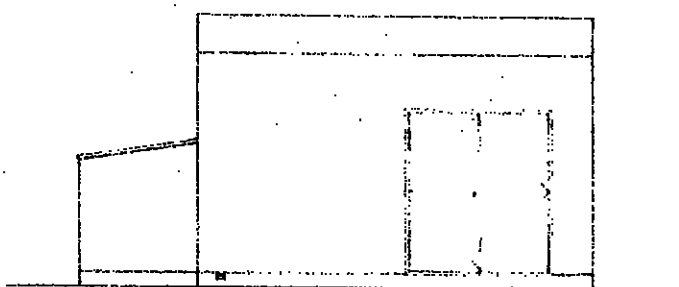


RIGHT SIDE VIEW

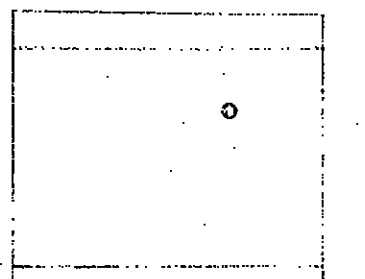


BACK VIEW

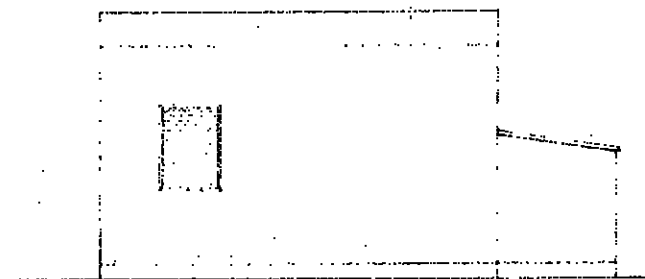


LEFT SIDE VIEW

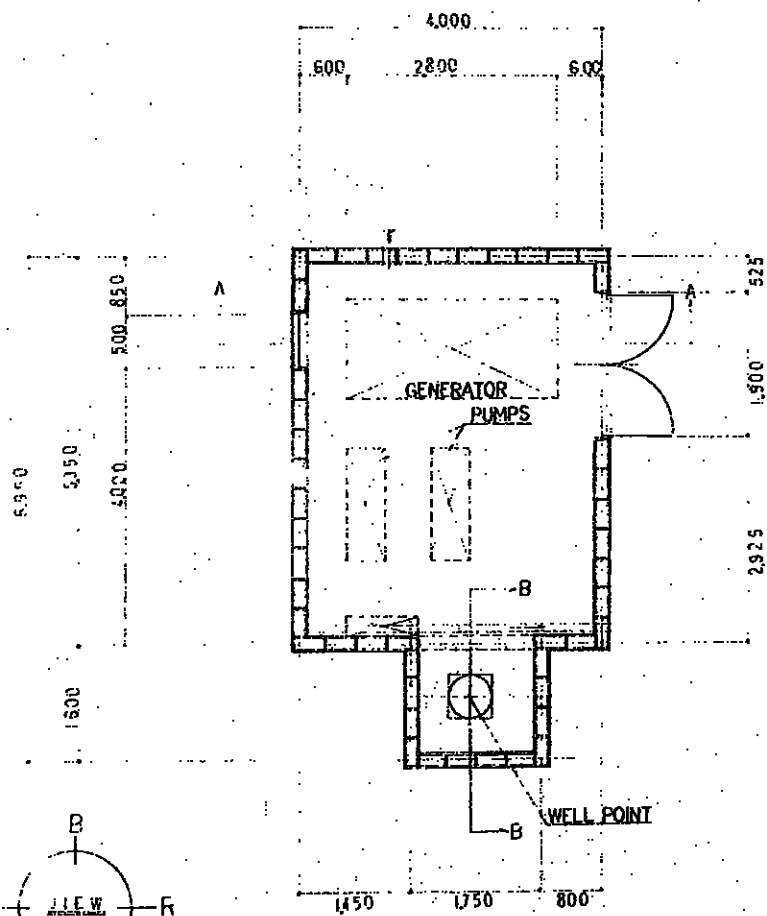

SECTION C-C

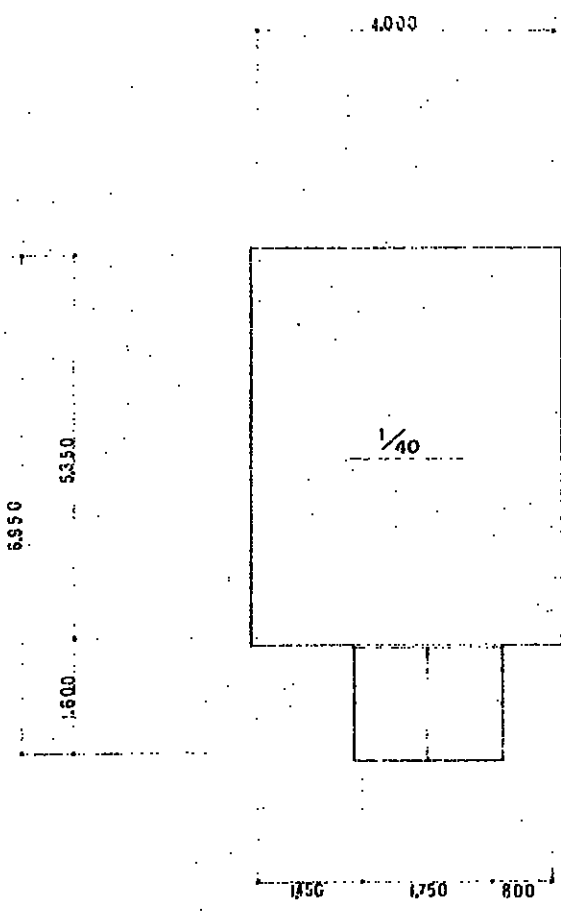


ROOF PLAN

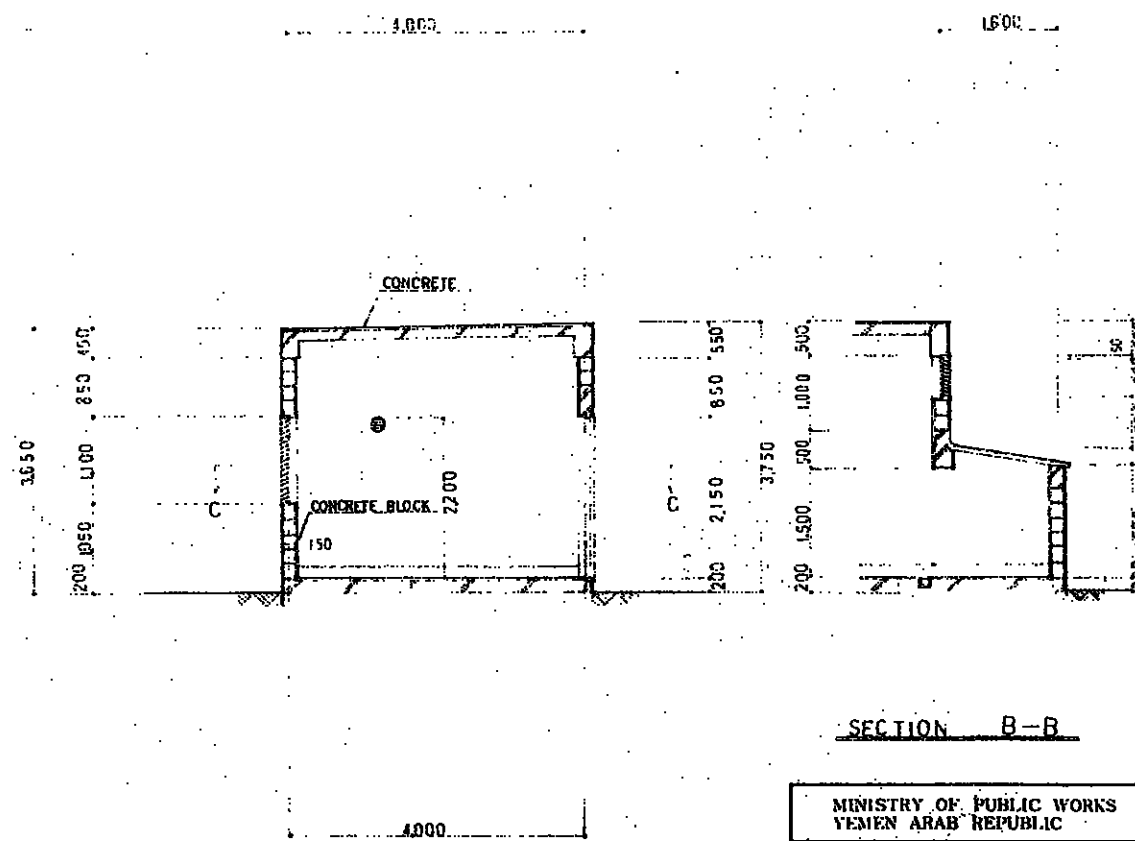

SECTION A-A



SECTION B-B

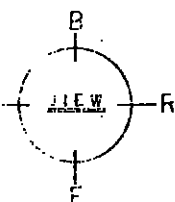

MINISTRY OF PUBLIC WORKS YEMEN ARAB REPUBLIC			
THE RURAL WATER SUPPLY PROJECT PART-II			
MACHINERY HOUSE: TYPE-C/W			
DESIGNED BY	Pacific Consultants International		
DATE	MAY 1980	SCALE	1:50
		DRAWING No.	45
JAPAN INTERNATIONAL COOPERATION AGENCY, TOKYO, JAPAN			


F. WATER SUPPLY WORKS

TYPICAL LAYOUT PLAN

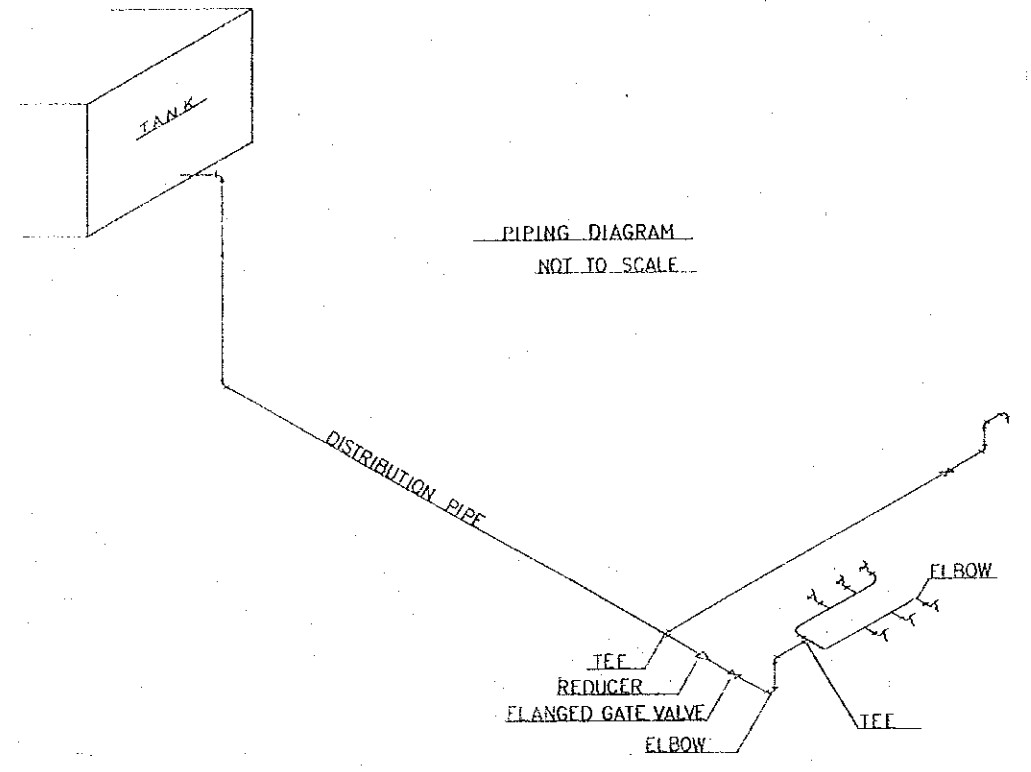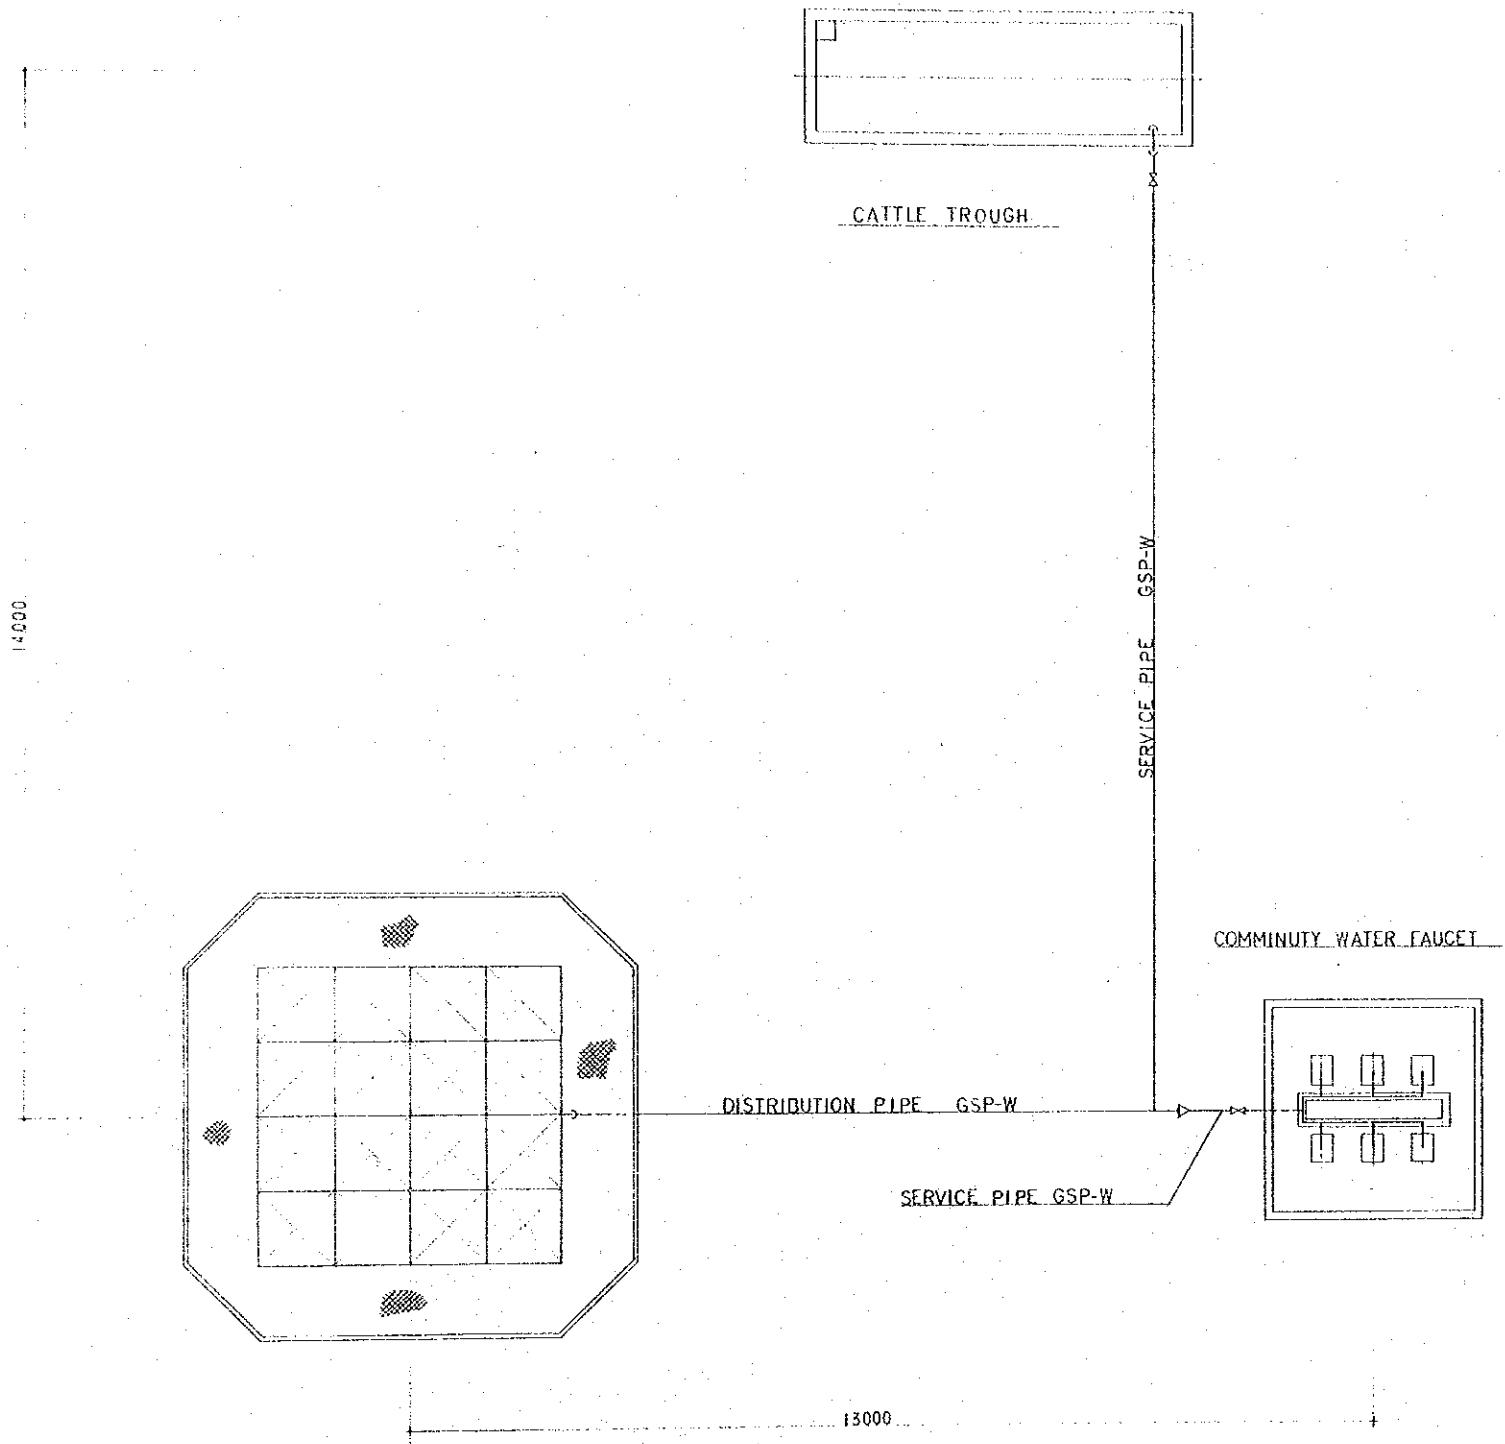


MINISTRY OF PUBLIC WORKS YEMEN ARAB REPUBLIC		
THE RURAL WATER SUPPLY PROJECT PART-II		
TYPICAL LAYOUT PLAN		
DESIGNED BY	Pacific Consultants International	
DATE	MAY 80	DRAWING No. 46
JAPAN INTERNATIONAL COOPERATION AGENCY, TOKYO, JAPAN		


ROAD CROSSING
TRENCHING SECTION SCALE = 1/5

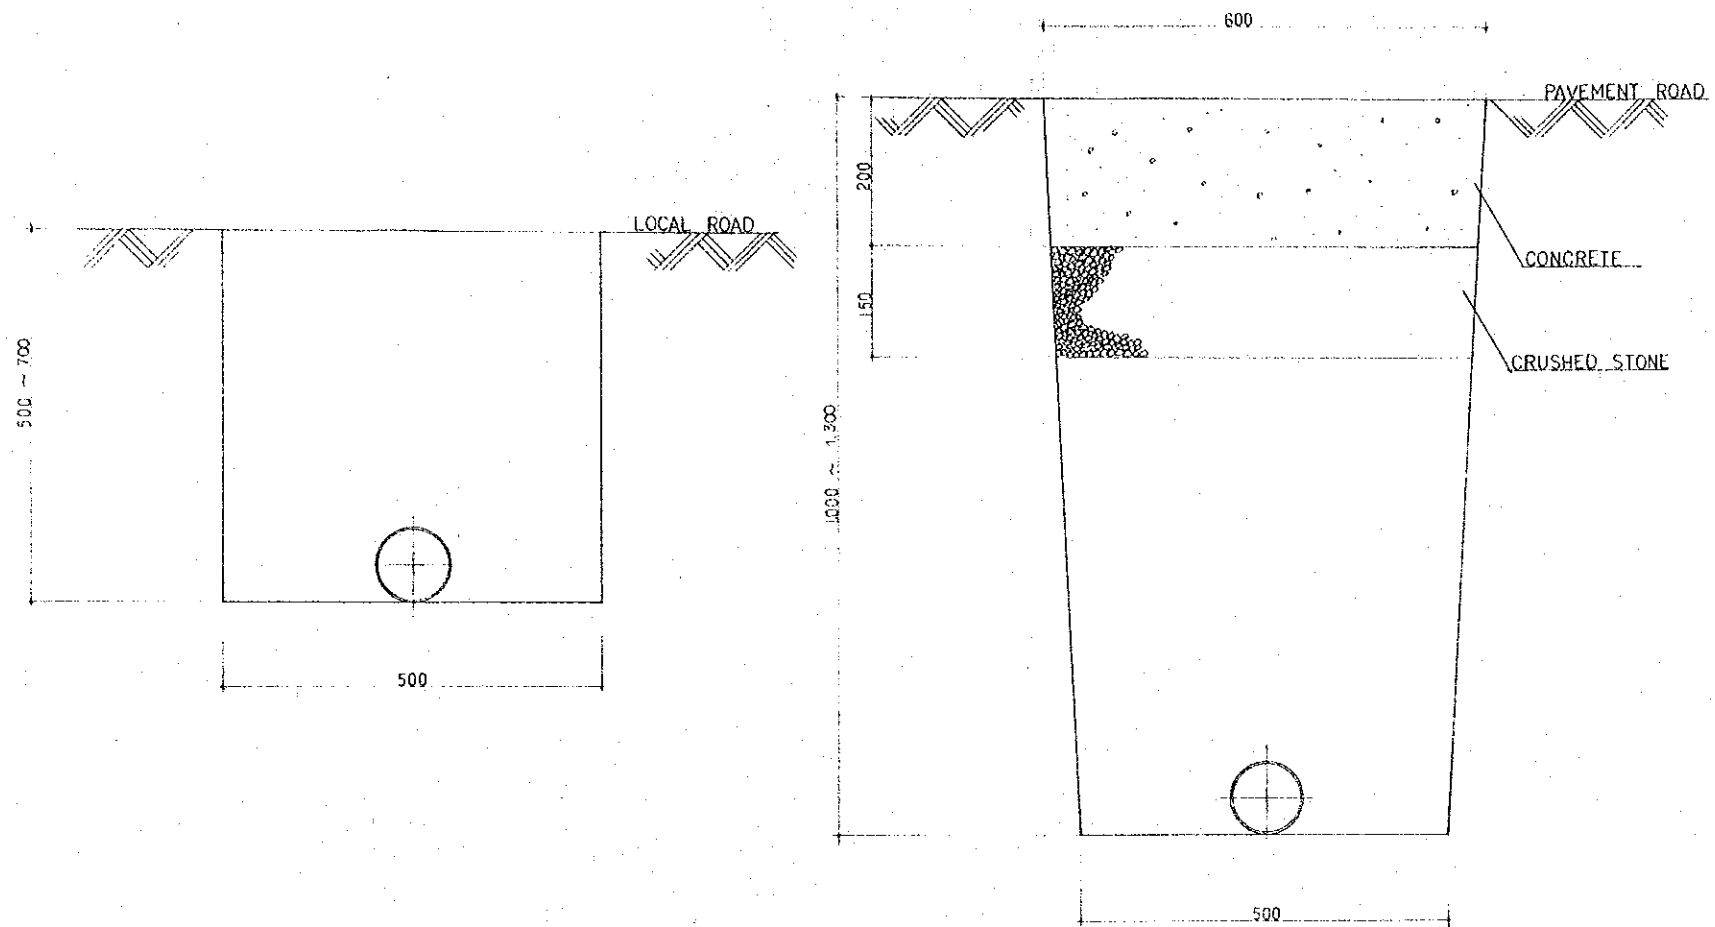


OPEN PIPING

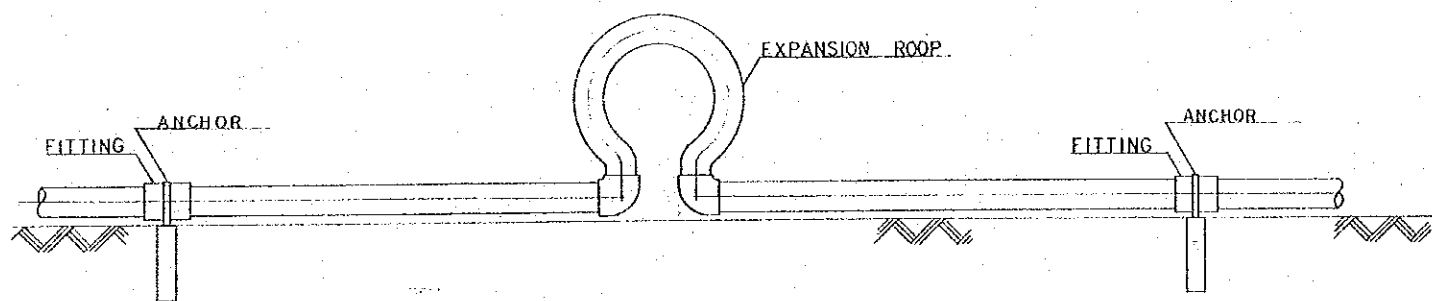

PLAN

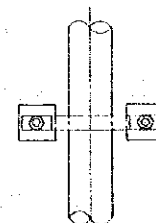


SECTION

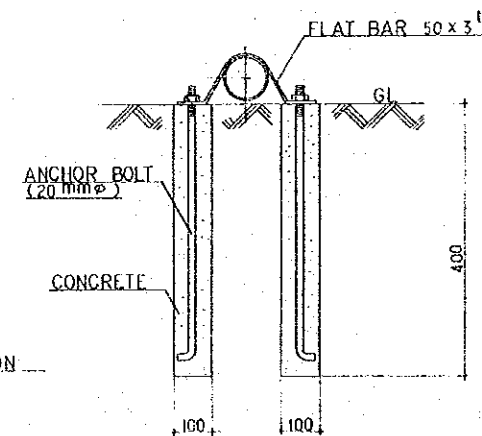

DETAIL OF ANCHORING
NOT TO SCALE

MINISTRY OF PUBLIC WORKS YEMEN ARAB REPUBLIC		
THE RURAL WATER SUPPLY PROJECT PART-II		
PLUMBING WORK - 1		
DESIGNED BY	Pacific Consultants International	
DATE	MAY 80	SCALE 1: DRAWING No. 47
JAPAN INTERNATIONAL COOPERATION AGENCY, TOKYO, JAPAN		

PIPING FOR TANK

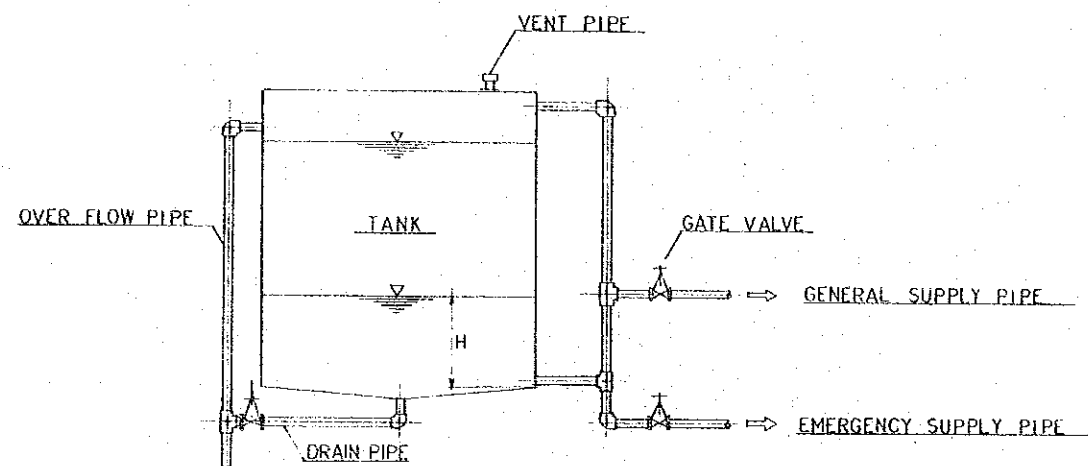


H: HEIGHT OF GENERAL SUPPLY PIPE
EACH HEIGHT IS SHOWN IN GENERAL LAYOUT
PLAN OF PROJECT SITES

WATER LEVEL CONTROL

1 ELECTRICAL CONTROL SEE ELECTRICAL WORKS.

2 MECHANICAL CONTROL

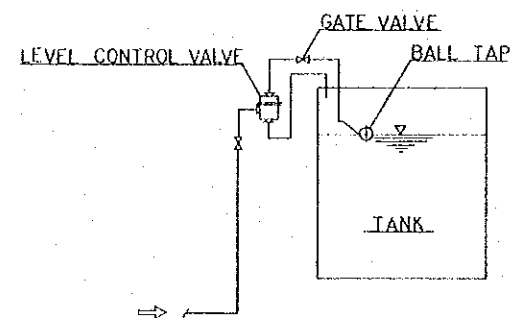


MINISTRY OF PUBLIC WORKS YEMEN ARAB REPUBLIC		
THE RURAL WATER SUPPLY PROJECT PART- II		
PLUMBING WORK - 2		
DESIGNED BY	Pacific Consultants International	
DATE	MAY 80	SCALE 1: DRAWING No. 48
JAPAN INTERNATIONAL COOPERATION AGENCY, TOKYO, JAPAN		


TANK

TYPES OF TANKS


CATEGORY	KIND	GROUND TANK	SEMI ELEVATED TANK	ELEVATED TANK
		SERVICE TANK	TYPE A	TYPE B
DISTRIBUTION TANK	TYPE D	---	---	---
BOOSTER STATION TANK	TYPE E	---	---	---
SERVICE AND BOOSTER STATION TANK	TYPE F	---	TYPE G	---

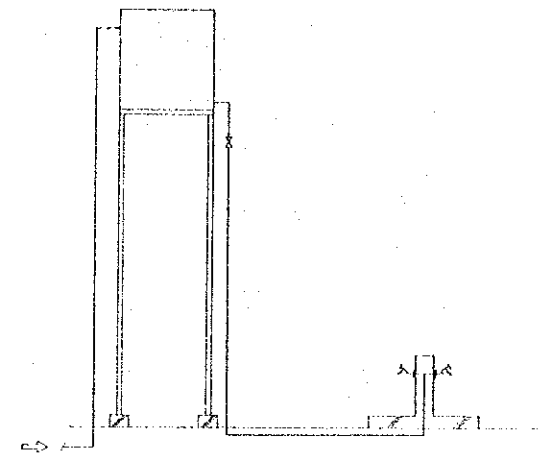


TYPE - C

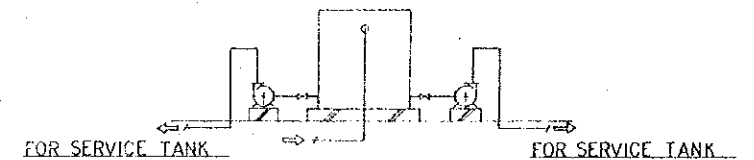


TYPE - D

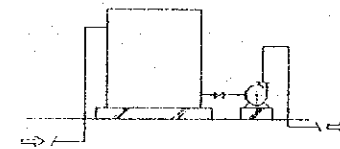


TYPE - A

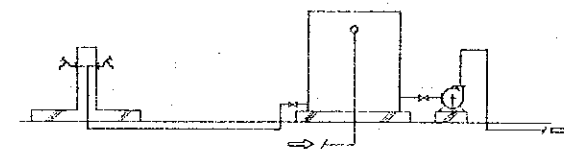


TYPE - E

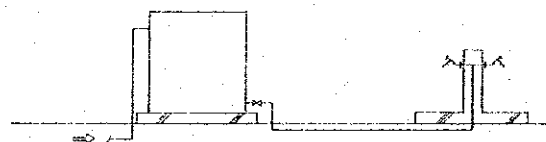

TYPE - A


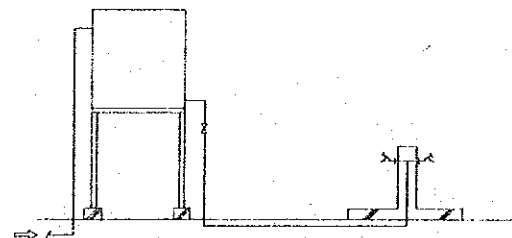


TYPE - B

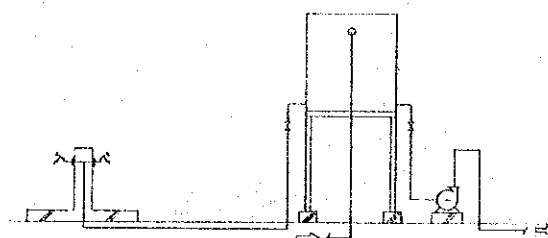

TYPE - G

MINISTRY OF PUBLIC WORKS YEMEN ARAB REPUBLIC		
THE RURAL WATER SUPPLY PROJECT PART-II		
TYPES OF TANKS		
DESIGNED BY	Pacific Consultants International	
DATE	MAY 80	SCALE 1: DRAWING No. 49
JAPAN INTERNATIONAL COOPERATION AGENCY, TOKYO, JAPAN		

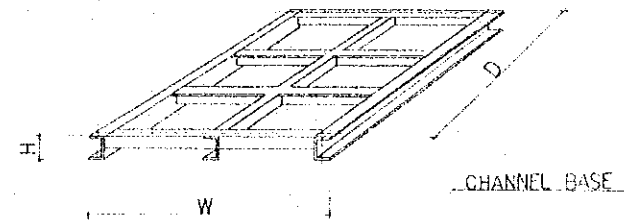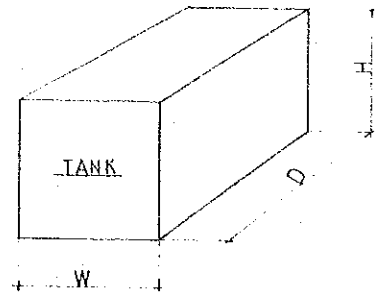

SIZE OF STEEL AND CONCRETE TANK


CAPACITY (ton)	W (m)	D (m)	H (m)	ACTUAL CAPACITY (ton)	NOTE
5.0	2.0	2.5	1.0	4.20	
10.0	2.0	2.5	2.0	9.10	
15.0	2.5	3.0	2.0	13.65	
30.0	3.0	4.0	2.5	27.84	
40.0	4.0	4.0	2.5	37.12	
60.0	4.0	5.0	3.0	56.20	
75.0	5.0	5.0	3.0	70.25	
120.0	5.0	6.0	4.0	113.14	
156.0	6.0	6.5	4.0	147.08	
210.0	7.0	7.5	4.0	198.00	
324.0	9.0	9.0	4.0	306.00	
360.0	9.0	10.0	4.0	340.00	
396.0	11.0	12.0	3.0	374.00	
714.0	14.0	17.0	3.0	674.00	
768.0	16.0	16.0	3.0	725.00	
867.0	17.0	17.0	3.0	818.00	

SIZE OF CHANNEL BASE FOR STEEL TANK


CAPACITY (ton)	W (mm)	D (mm)	H (mm)	NOTE
5.0	2100	2600	125	
10.0	2100	2600	125	
15.0	2600	3100	125	
30.0	3100	4100	125	
40.0	4100	4100	125	
60.0	4100	5100	150	
75.0	5100	5100	150	
120.0	5100	6100	150	
156.0	6100	6600	150	
210.0	7100	7600	150	
324.0	9100	9100	150	
360.0	9100	10100	150	
396.0	11100	12100	150	
714.0	14100	17100	200	
768.0	16100	16100	200	
867.0	17100	17100	200	

MINISTRY OF PUBLIC WORKS YEMEN ARAB REPUBLIC		
THE RURAL WATER SUPPLY PROJECT PART-II		
LIST OF TANKS		
DESIGNED BY	Pacific Consultants International	
DATE	MAY 80	SCALE 1: DRAWING No. 50
JAPAN INTERNATIONAL COOPERATION AGENCY, TOKYO, JAPAN		

COMMUNITY WATER FAUCET
(SCALE = 1/30)

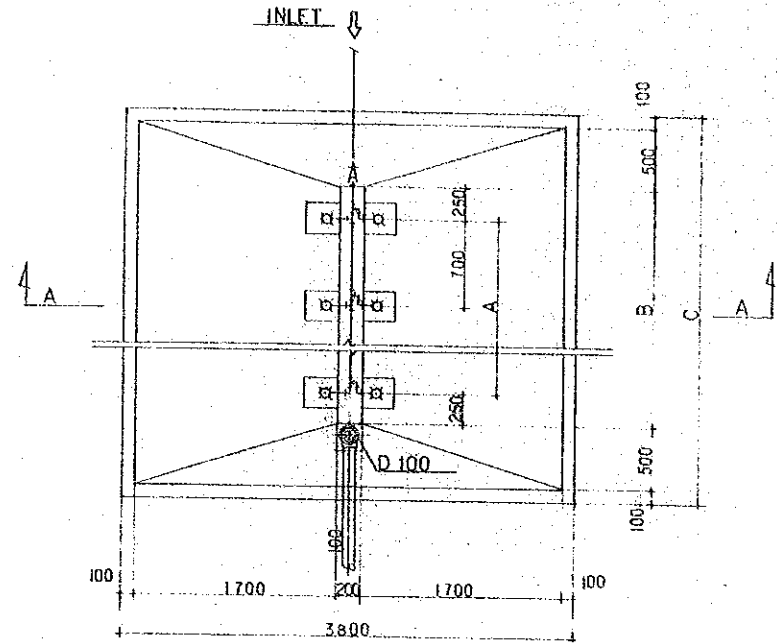


PLAN

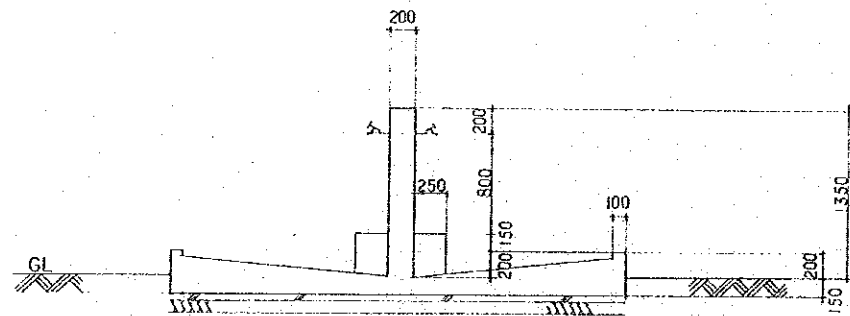


A-A : SECTION

TYPE	A	B	C	FAUCET	INLET	NOTE
F-1	700	1200	2400	4	Φ _{min} 25	
F-2	2100	2600	3800	8	32	
F-3	3500	4000	5200	12	40	
F-4	4900	5400	6800	16	50	
F-5	6300	6800	8000	20	50	

CATTLE TROUGH
(SCALE = 1/30)

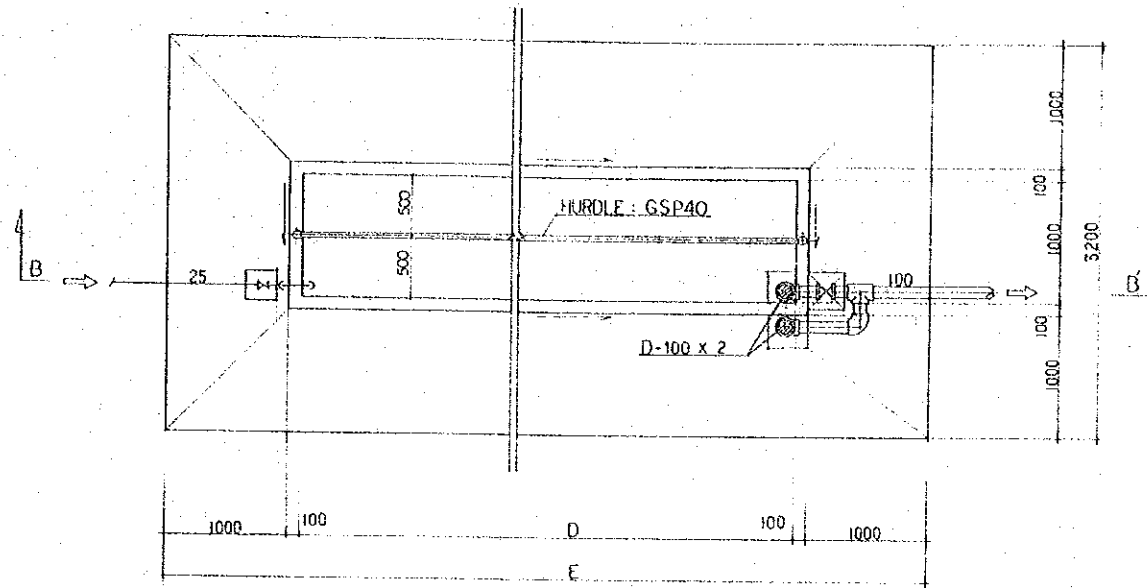


PLAN

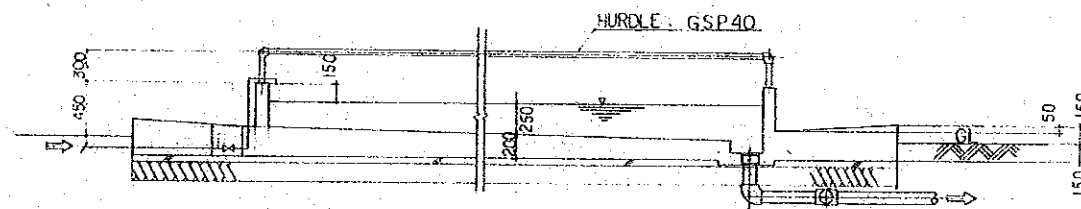


B-B : SECTION

TYPE	D	E	NOTE
L-1	4000	6200	
L-2	7000	9200	
L-3	10000	12200	
L-4	15000	17200	
L-5	20000	22200	

DRAINAGE BASIN
(SCALE = 1/50)

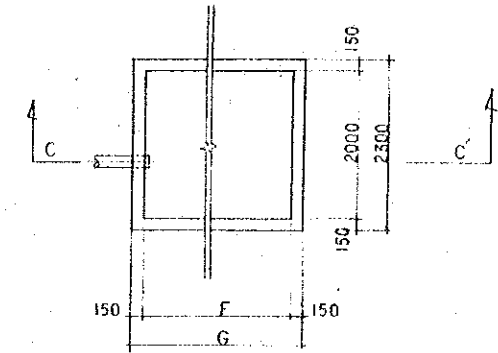

PLAN

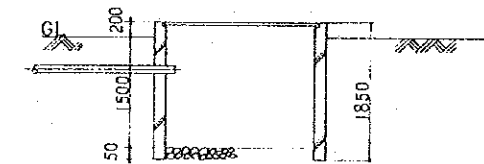

C-C : SECTION

TYPE	F	G	SQ(m ²)	NOTE
D-1	2000	2300	4	
D-2	4000	4300	8	
D-3	6000	6300	12	
D-4	8000	8300	16	
D-5	10000	10300	20	

WATER SERVICE FACILITIES


MINISTRY OF PUBLIC WORKS
YEMEN ARAB REPUBLIC

THE RURAL WATER SUPPLY
PROJECT PART-II


WATER SERVICE FACILITIES

DESIGNED BY Pacific Consultants International
DATE MAY 80 SCALE 1:30 DRAWING No. 51
JAPAN INTERNATIONAL COOPERATION
AGENCY, TOKYO, JAPAN


G. STEEL TRESTLES

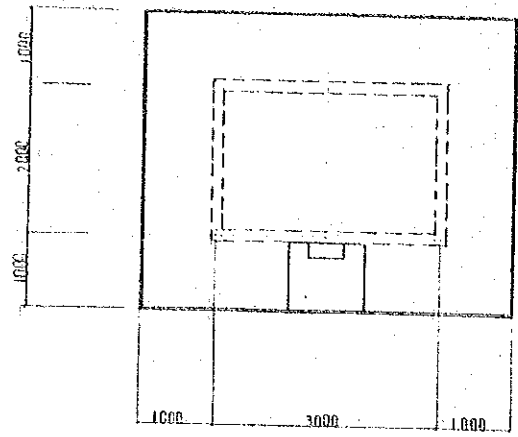


PLAN 10 TON

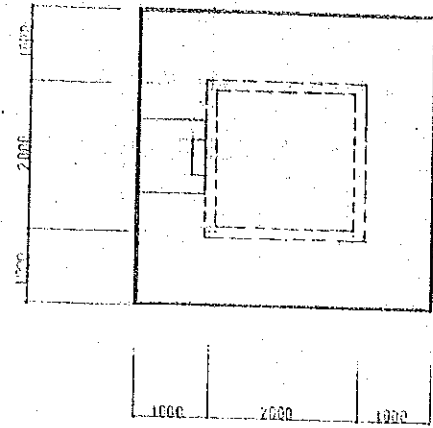


PLAN 5 TON

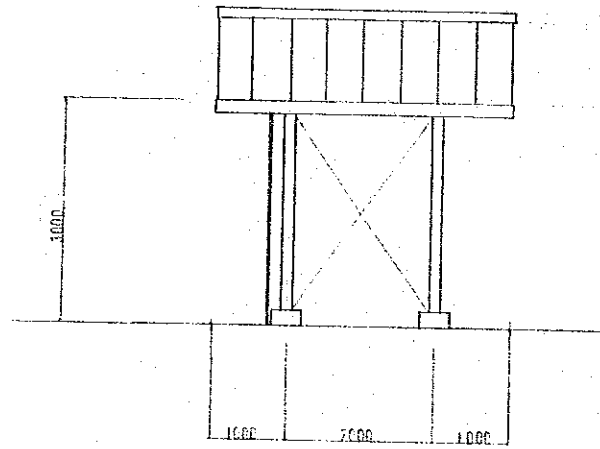


ELEVATED TANK 10 TON

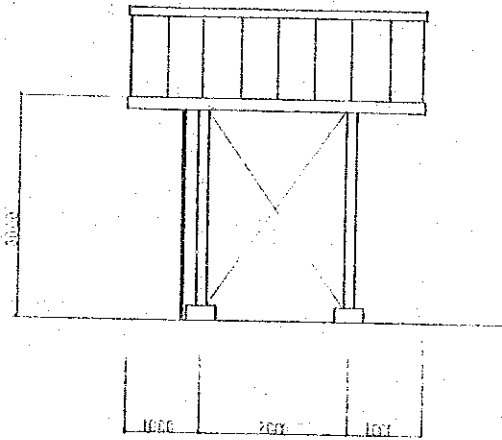

ELEVATED TANK 5 TON

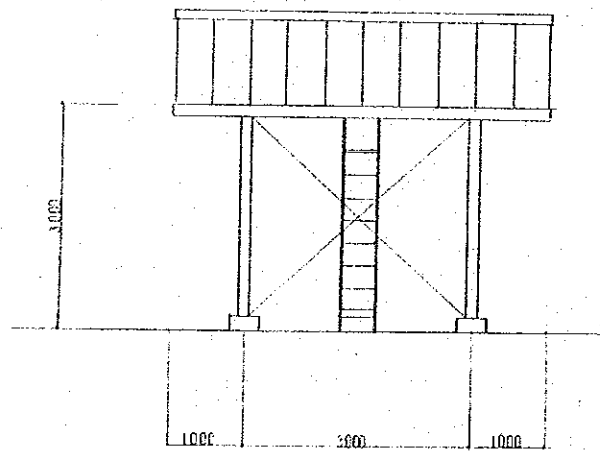


ELEVATED TANK 10 TON

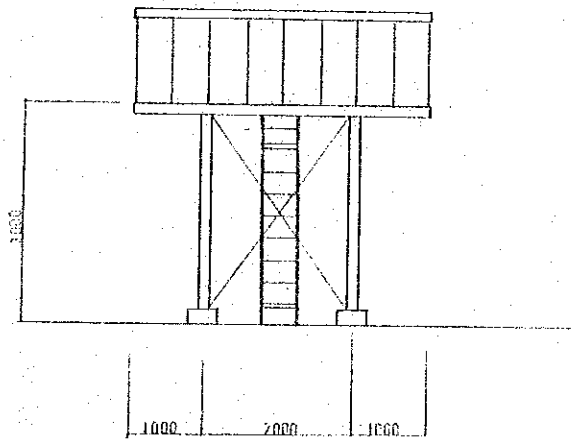


ELEVATED TANK 5 TON


MINISTRY OF PUBLIC WORKS YEMEN ARAB REPUBLIC		
THE RURAL WATER SUPPLY PROJECT PART-II		
STEEL TRESTLE 3 ^m TALL FOR 5 TON & 10 TON TANKS		
DESIGNED BY Pacific Consultants International		
DATE	SCALE	DRAWING No.
MAY 80	1:50	52
JAPAN INTERNATIONAL COOPERATION AGENCY, TOKYO, JAPAN		

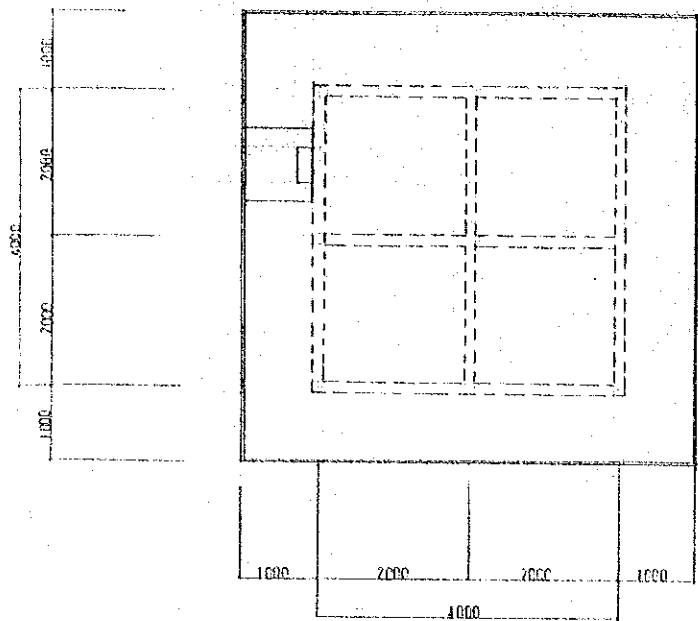


PLAN 40TON

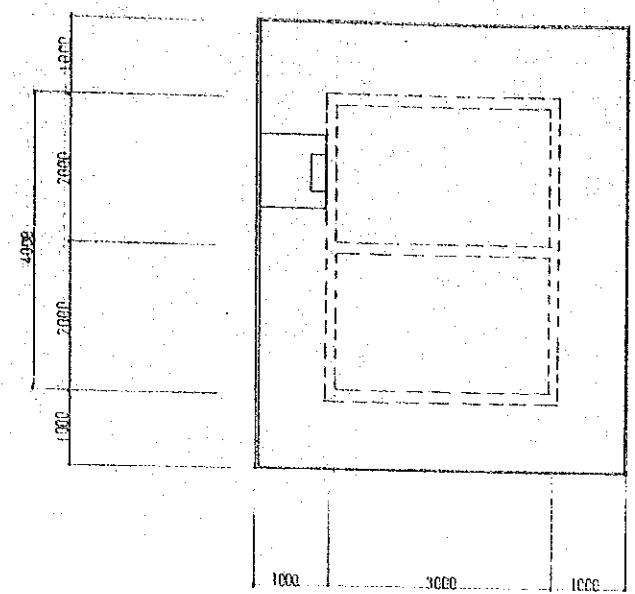


PLAN 30TON

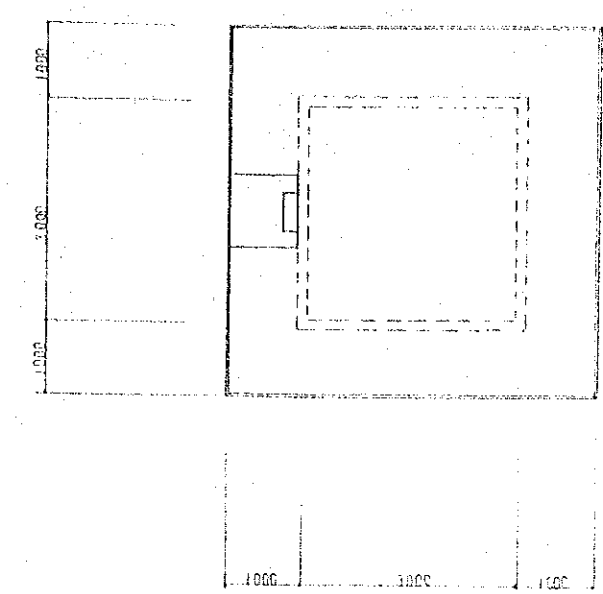


PLAN 15TON

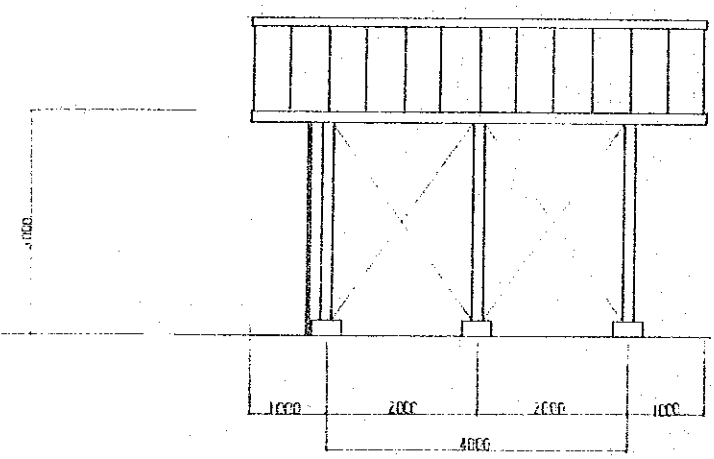


ELEVATED TANK 40TON

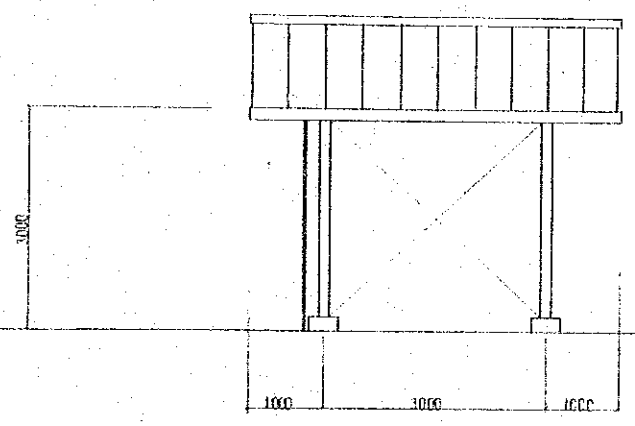


ELEVATED TANK 30TON

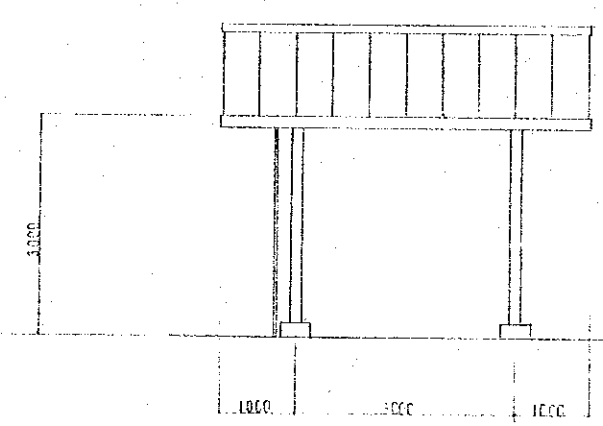


ELEVATED TANK 15TON

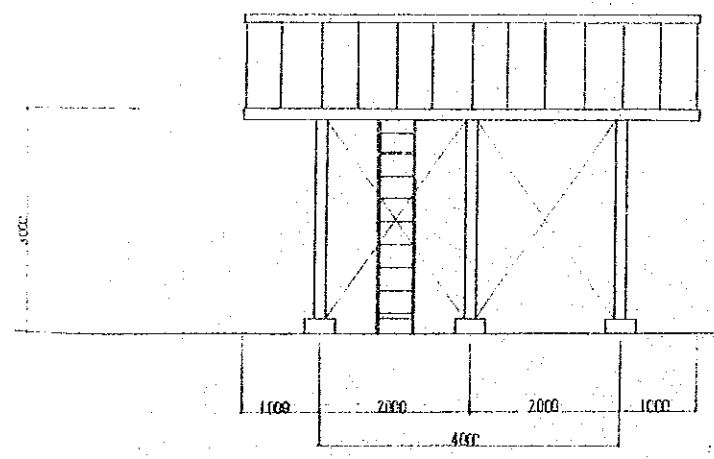

ELEVATED TANK 40TON

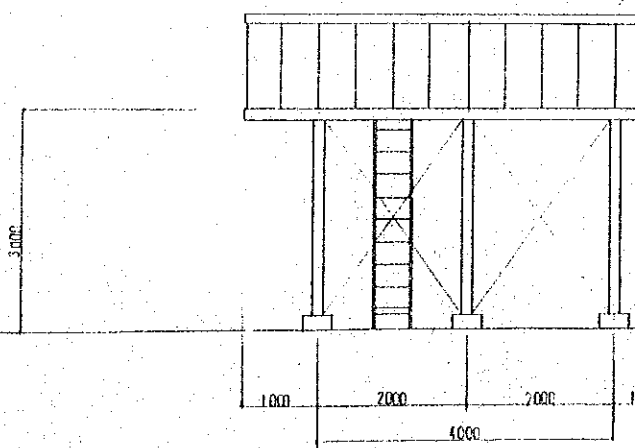


ELEVATED TANK 30TON

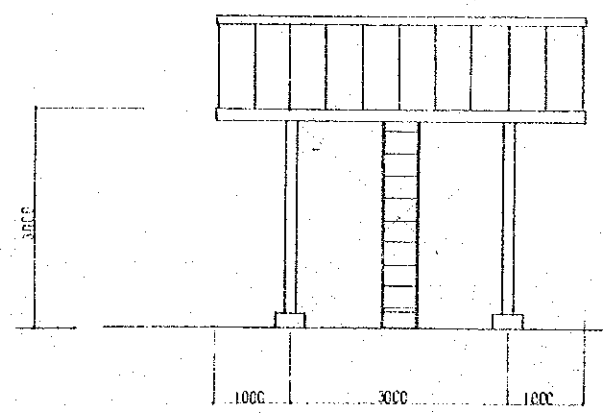


ELEVATED TANK 15TON


MINISTRY OF PUBLIC WORKS YEMEN ARAB REPUBLIC		
THE RURAL WATER SUPPLY PROJECT PART-II		
STEEL TRESTLE 3 ^m TALL FOR 15TON & 30TON TANKS		
DESIGNED BY	Pacific Consultants International	
DATE	MAY 1980	SCALE 1:50 DRAWING No. 53
JAPAN INTERNATIONAL COOPERATION AGENCY, TOKYO, JAPAN		

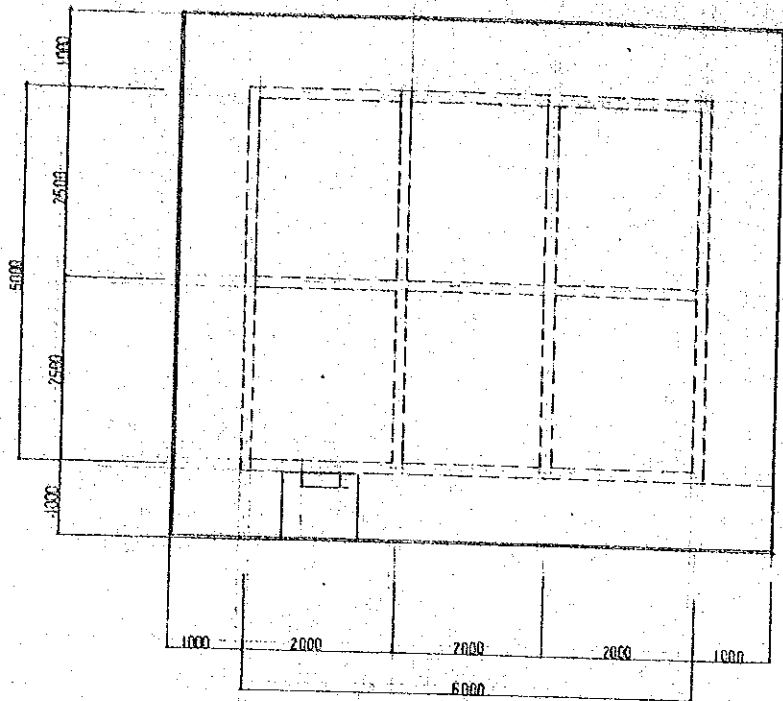


PLAN 120TON

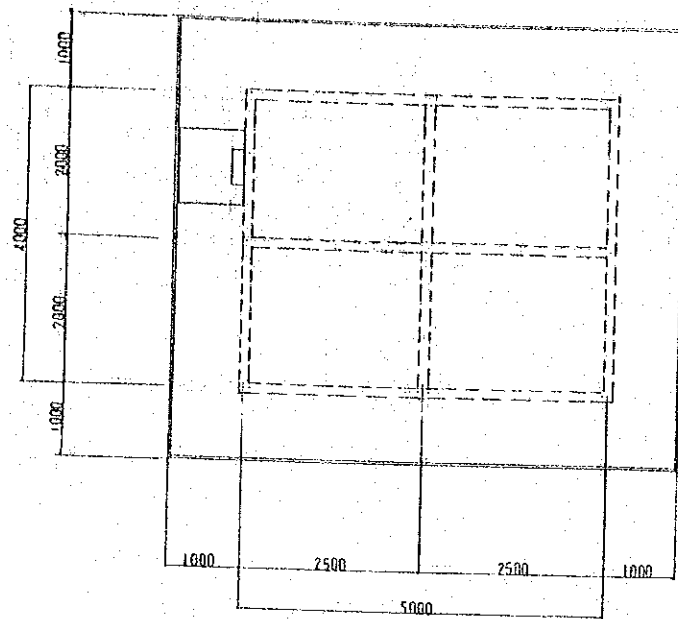


PLAN 60TON

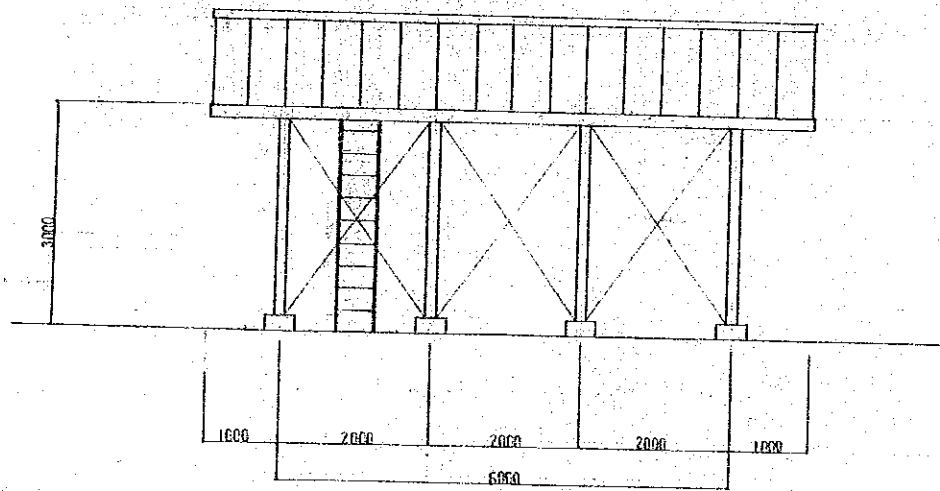


ELEVATED TANK 120TON

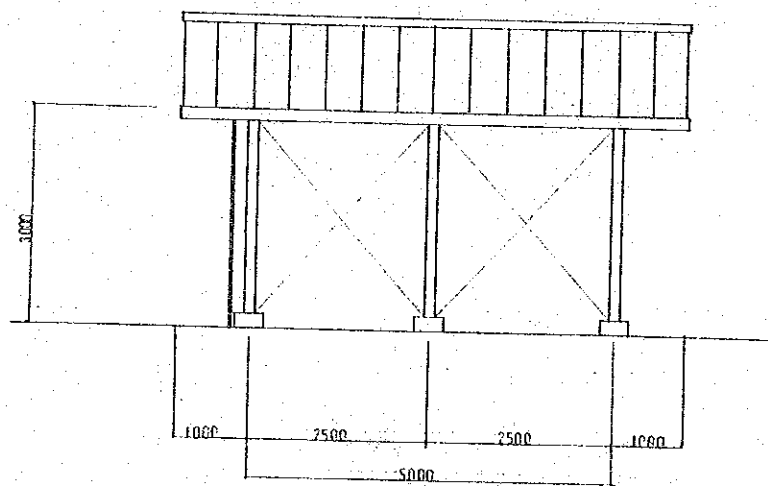

ELEVATED TANK 60TON

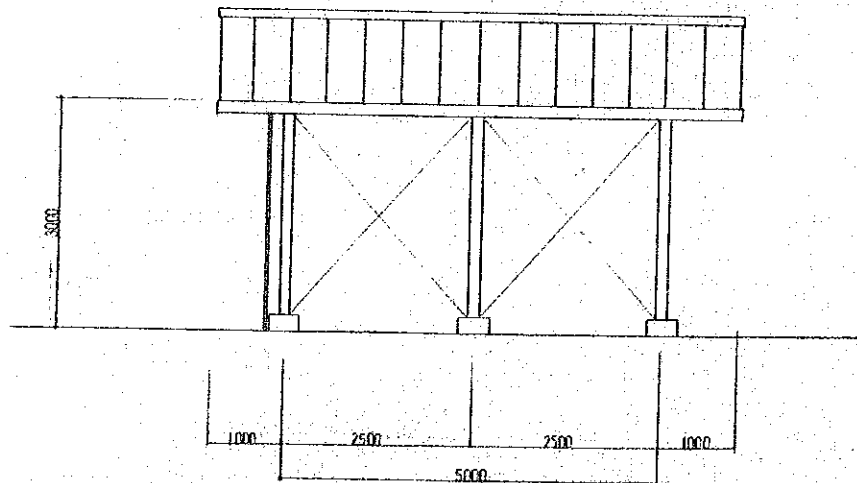


ELEVATED TANK 120TON

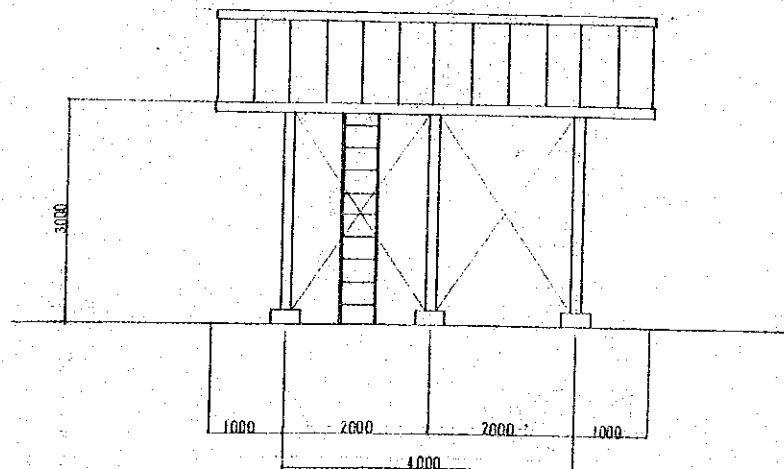


ELEVATED TANK 60TON


MINISTRY OF PUBLIC WORKS YEMEN ARAB REPUBLIC		
THE RURAL WATER SUPPLY PROJECT PART-II		
STEEL TRESTLE 3 RD TALL FOR 60TON & 120TON TANKS		
DESIGNED BY Pacific Consultants International		
DATE MAY 80	SCALE 1:50	DRAWING No. 154
JAPAN INTERNATIONAL COOPERATION AGENCY, TOKYO, JAPAN		

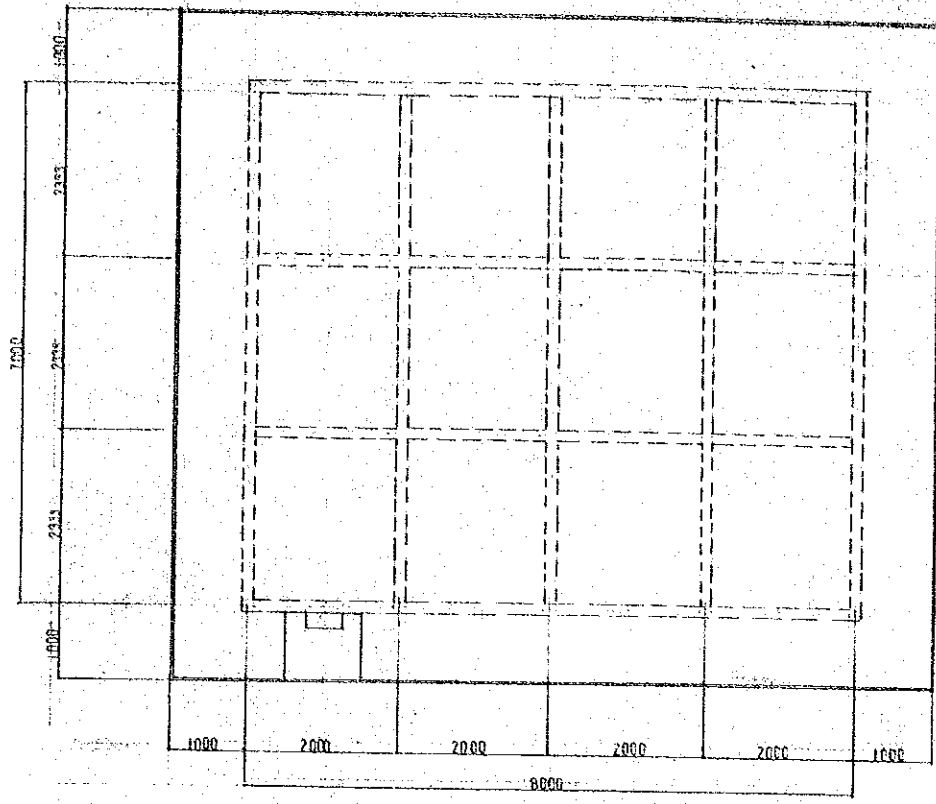


PLAN 210 TON

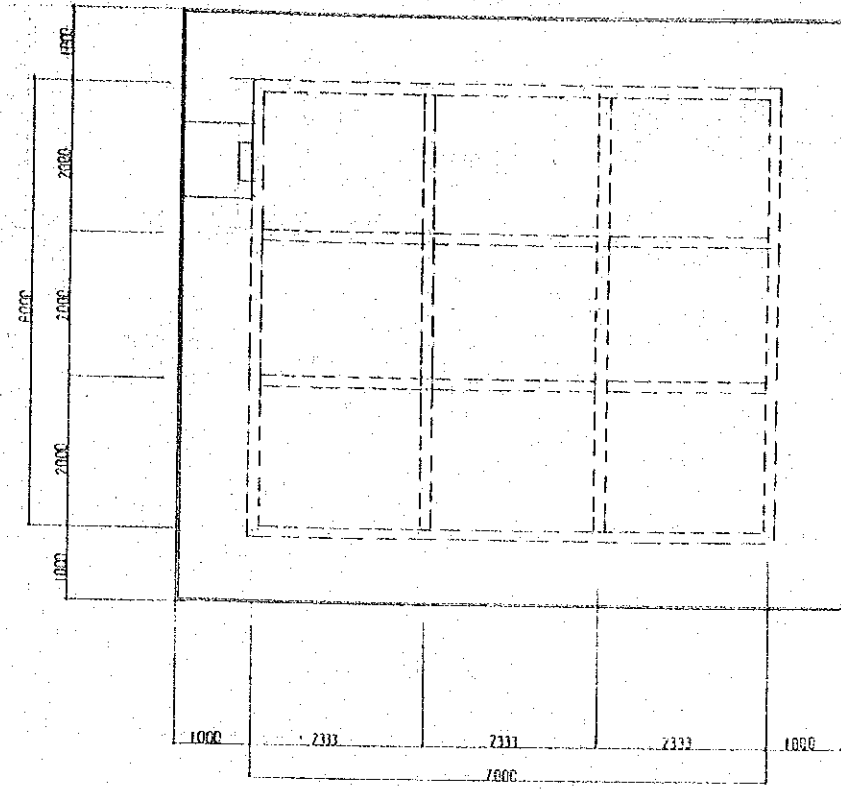


PLAN 156 TON

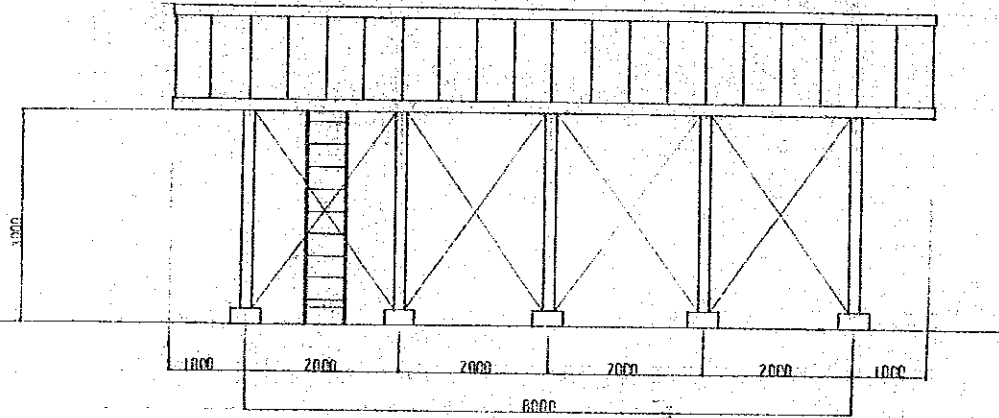


ELEVATED TANK 210 TON

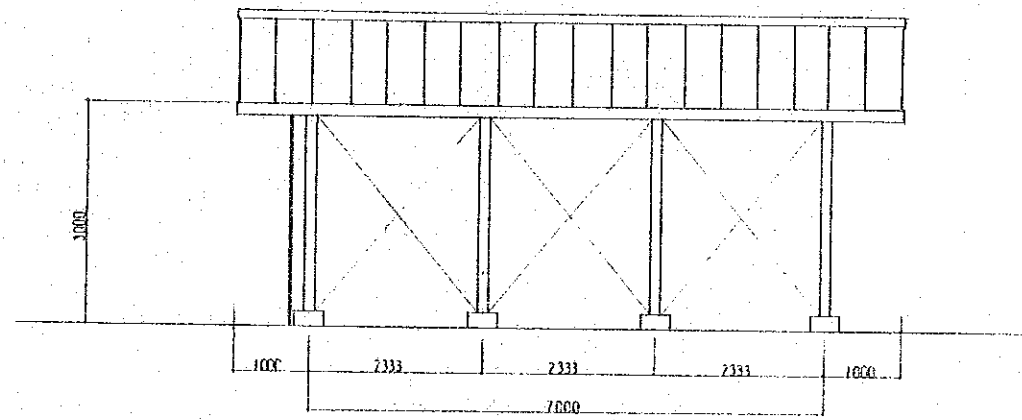

ELEVATED TANK 156 TON

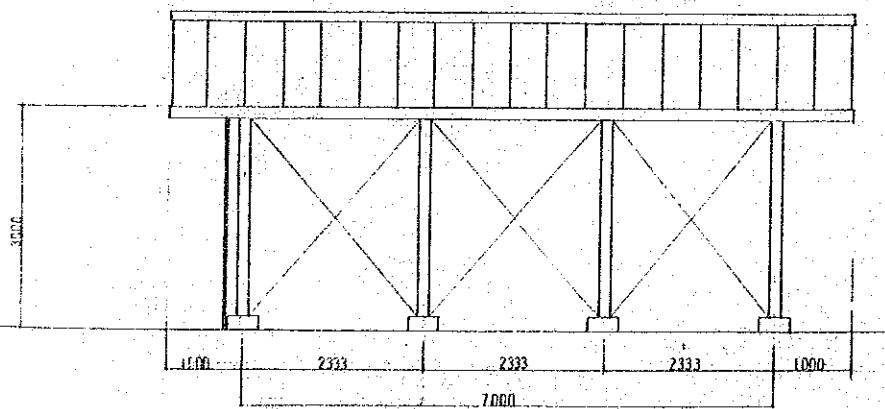


ELEVATED TANK 210 TON

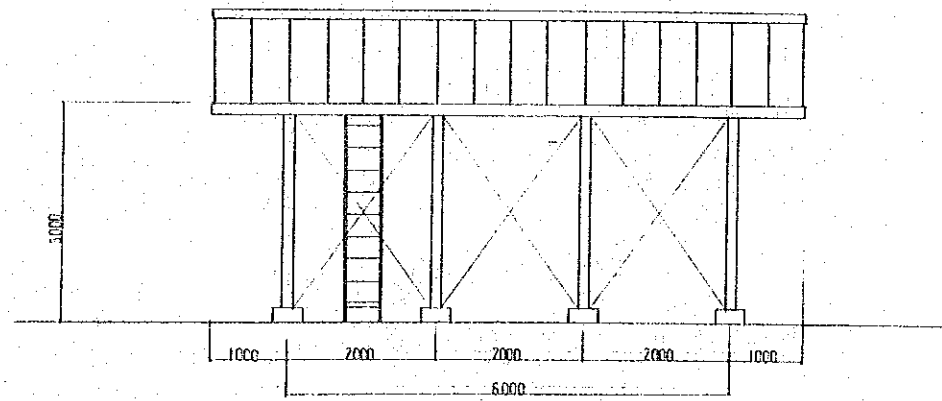


ELEVATED TANK 156 TON


MINISTRY OF PUBLIC WORKS YEMEN ARAB REPUBLIC		
THE RURAL WATER SUPPLY PROJECT PART-II		
STEEL TRUSSE 3 ^m TALL FOR 156 TON & 210 TON TANKS		
DESIGNED BY	Pacific Consultants International	
DATE	MAY 1960	SCALE 1:50
DRAWING No. 55		
JAPAN INTERNATIONAL COOPERATION AGENCY, TOKYO, JAPAN		

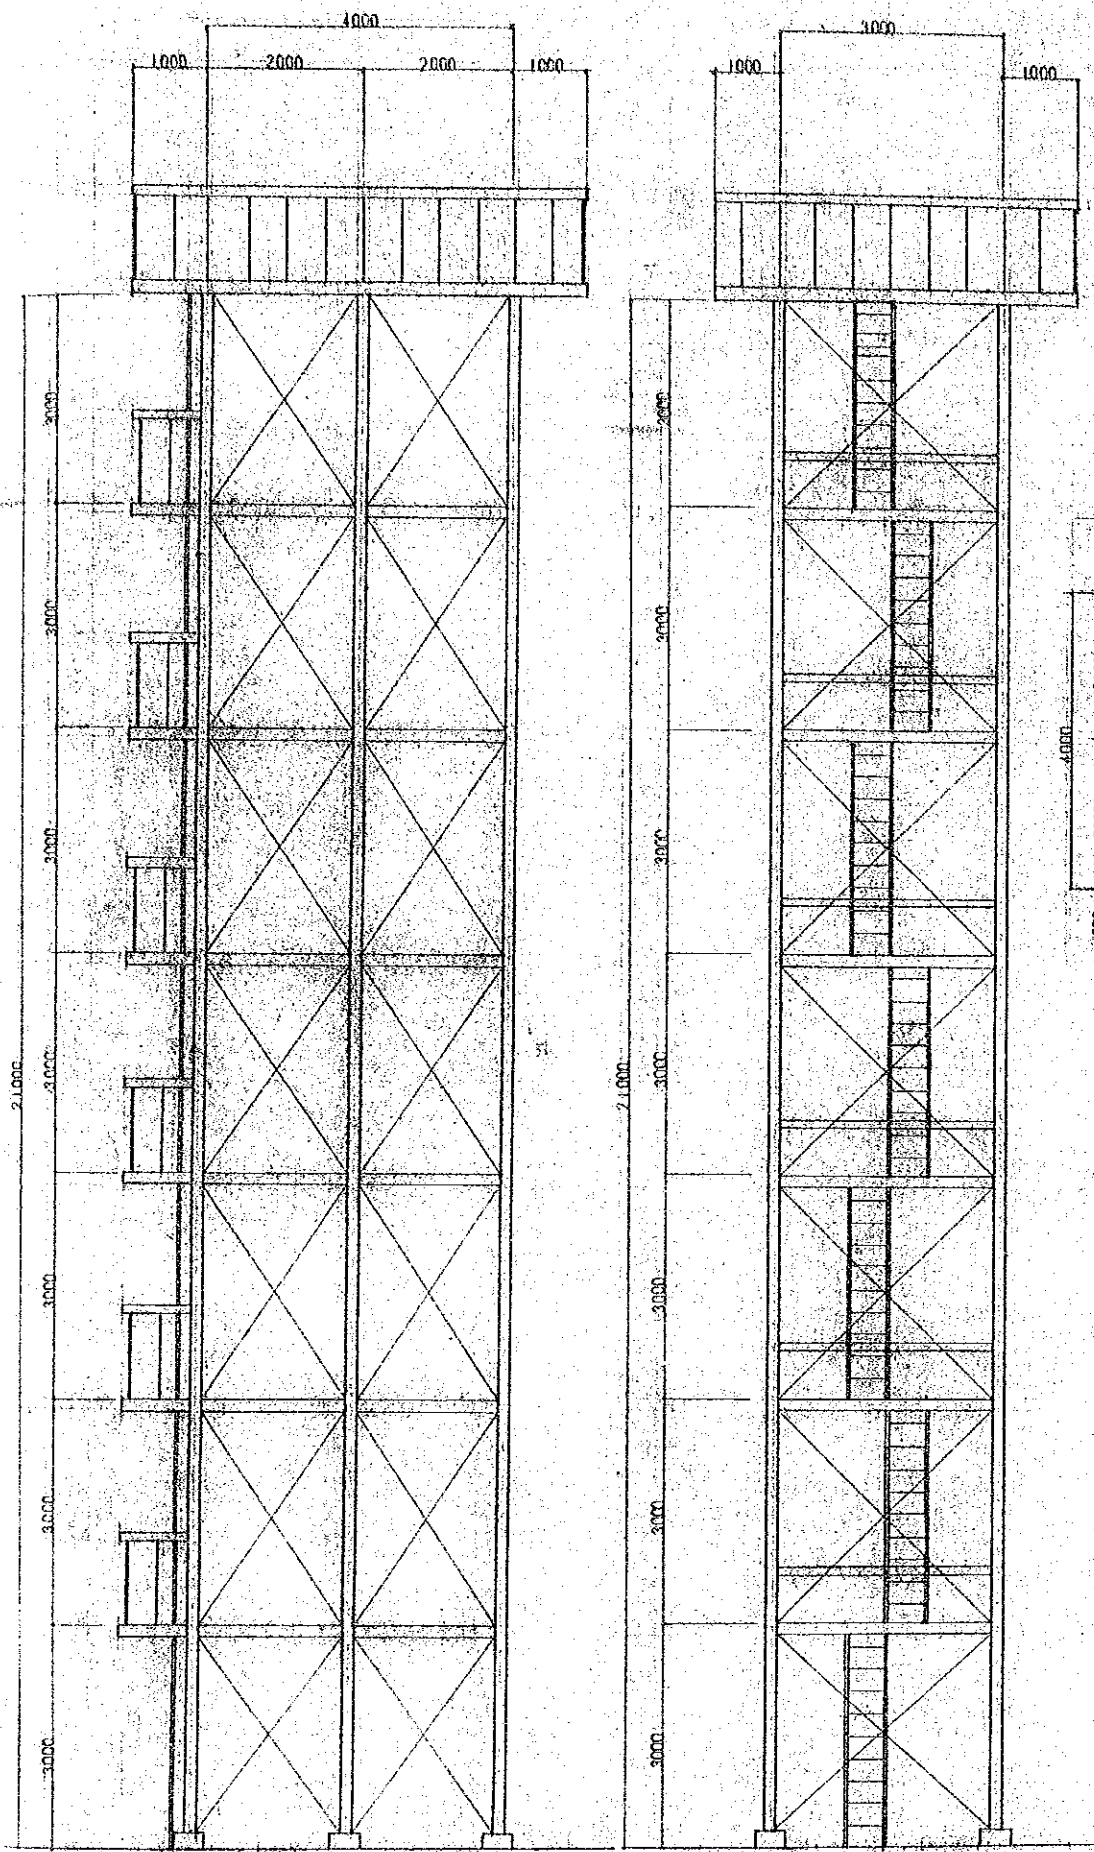


ELEVATED TANK 30TON

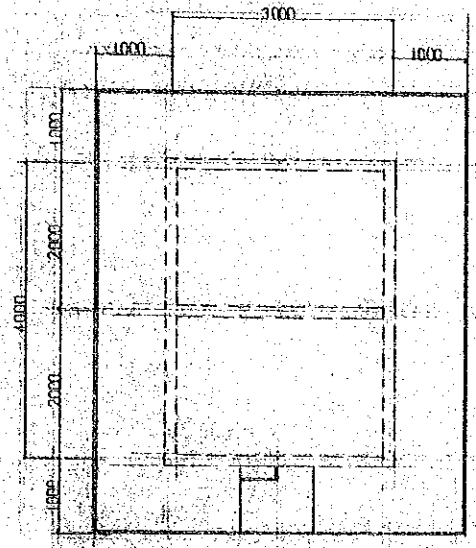

PLAN



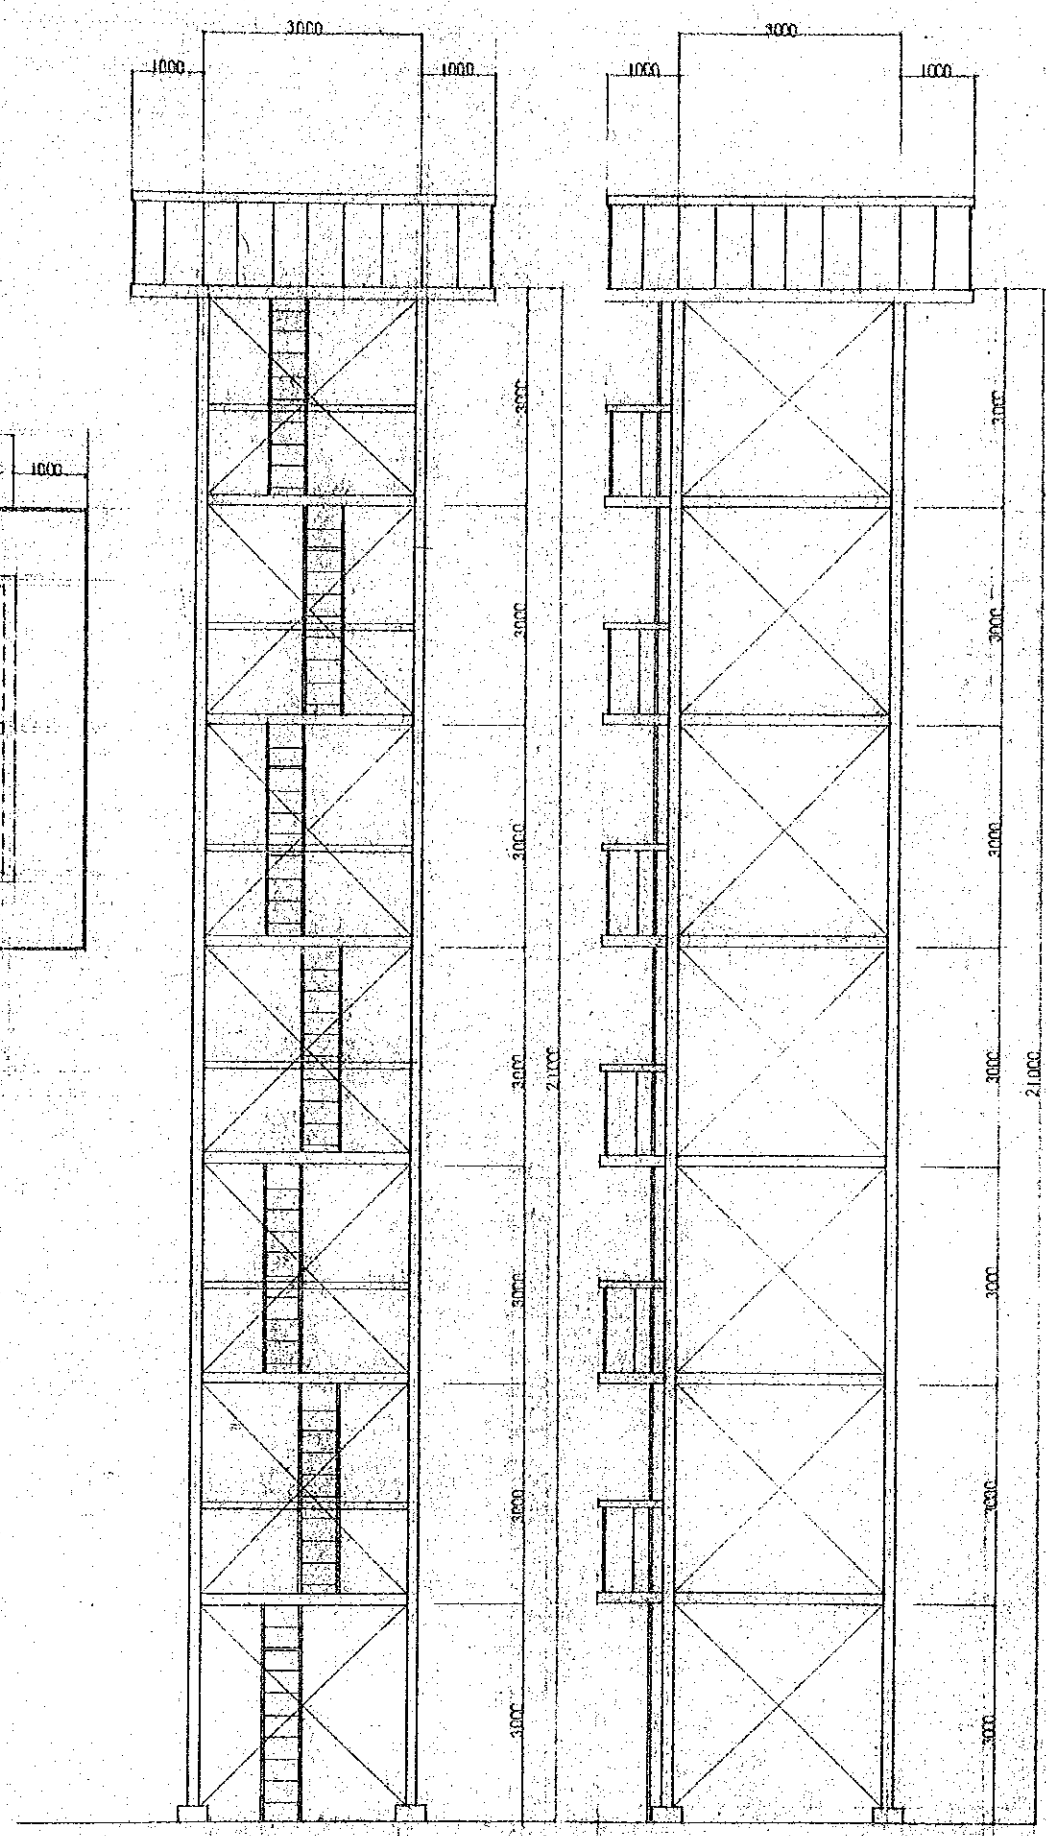


ELEVATED TANK 15TON

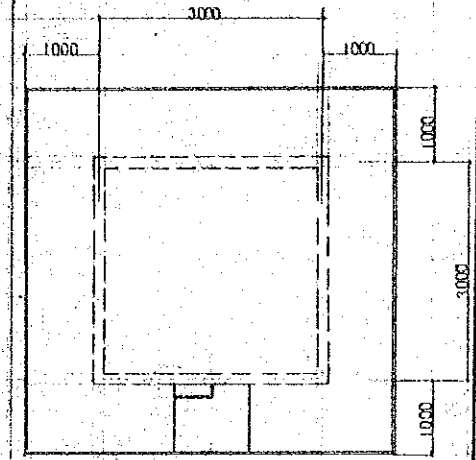

PLAN

MINISTRY OF PUBLIC WORKS
 YEMEN ARAB REPUBLIC
 THE RURAL WATER SUPPLY
 PROJECT PART II
 STEEL TRESTLE 21^m TALL
 FOR TOTAL 15TON & 30TON TANKS
 DESIGNED BY Pacific Consultants International
 DATE 1980 SCALE 1:50 DRAWING No. 56
 JAPAN INTERNATIONAL COOPERATION
 AGENCY, TOKYO, JAPAN

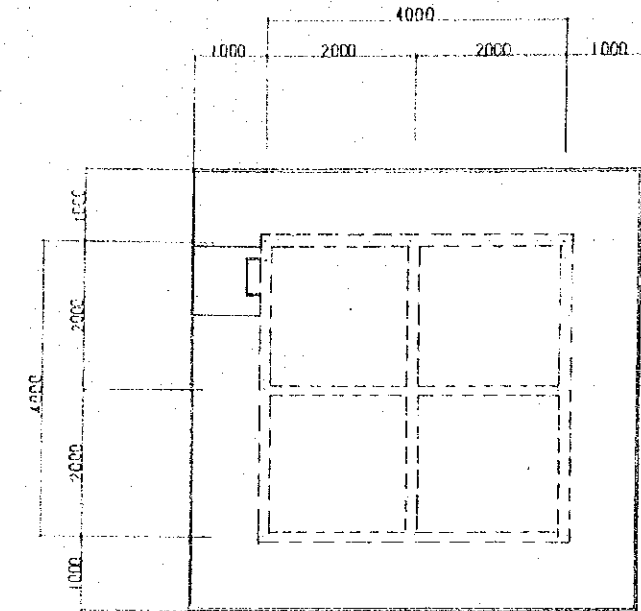
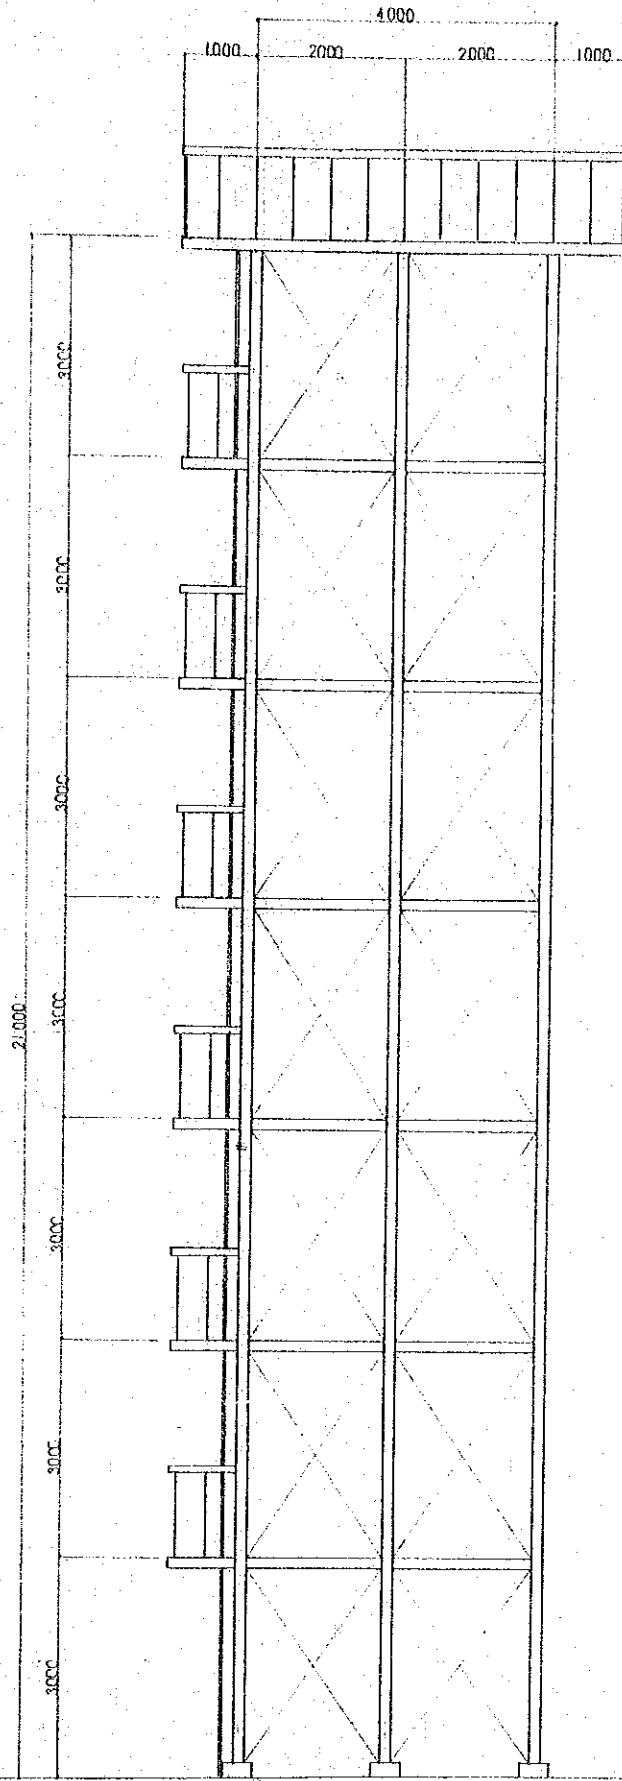
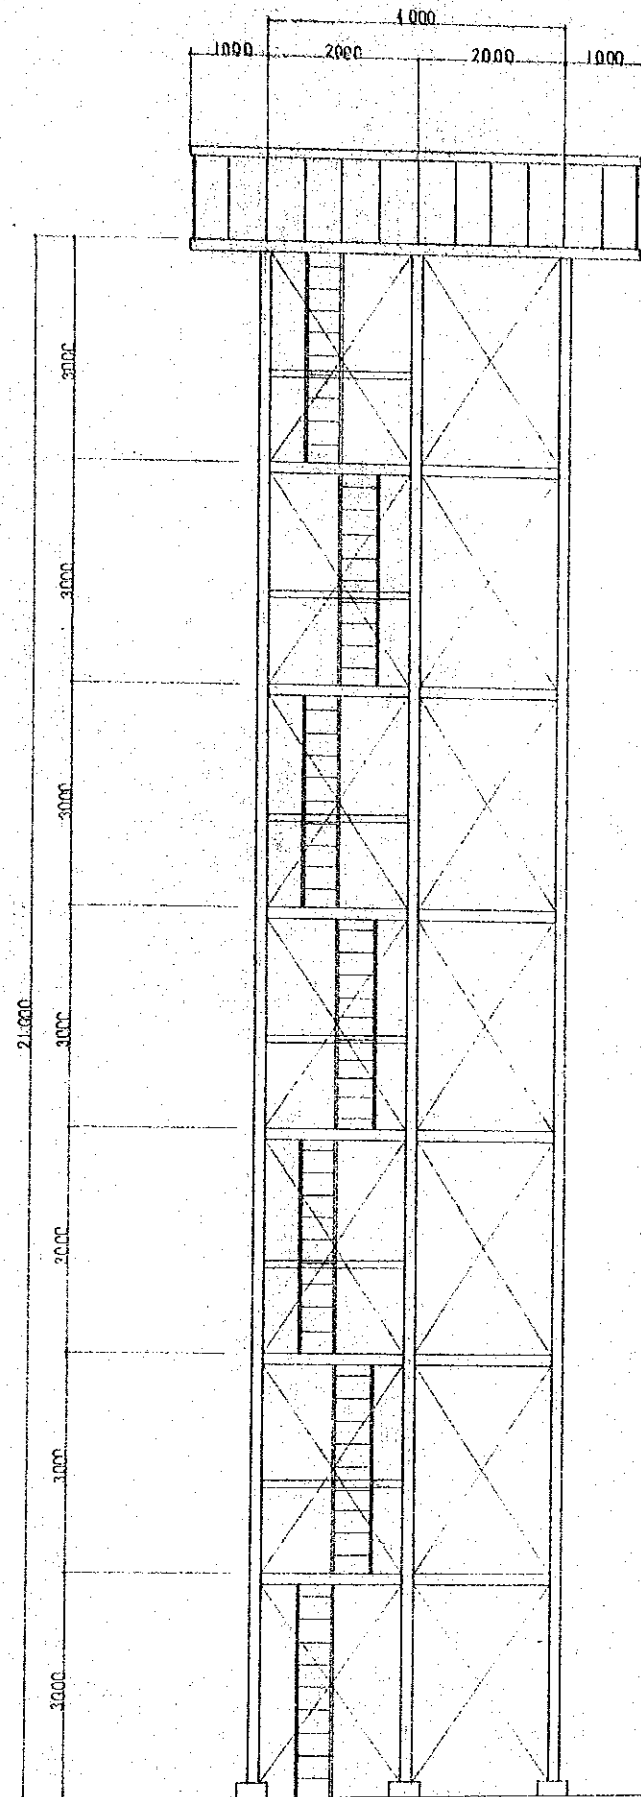


PLAN

ELEVATED TANK

40TON

MINISTRY OF PUBLIC WORKS YEMEN ARAB REPUBLIC		
THE RURAL WATER SUPPLY PROJECT PART-II		
STEEL TRESTLE 21 ^m TALL FOR 40 TON TANK		
DESIGNED BY	Pacific Consultants International	
DATE	MAY 80	SCALE 1: 50
DRAWING No.		57
JAPAN INTERNATIONAL COOPERATION AGENCY, TOKYO, JAPAN		

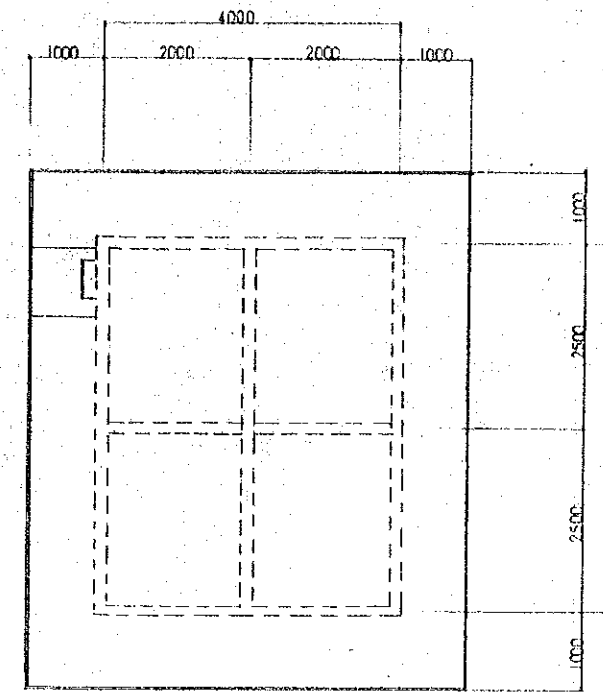
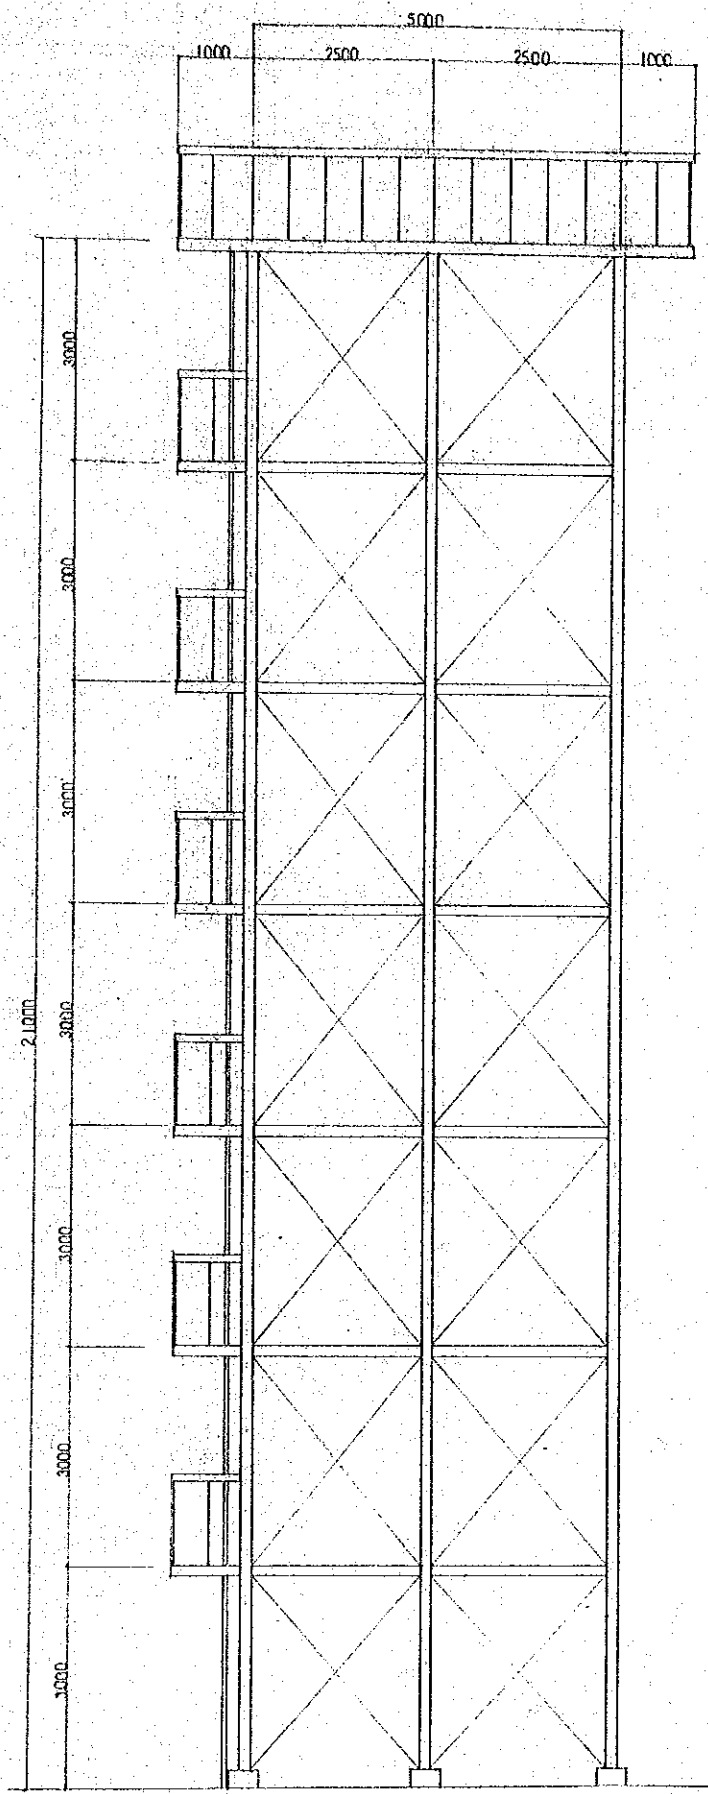
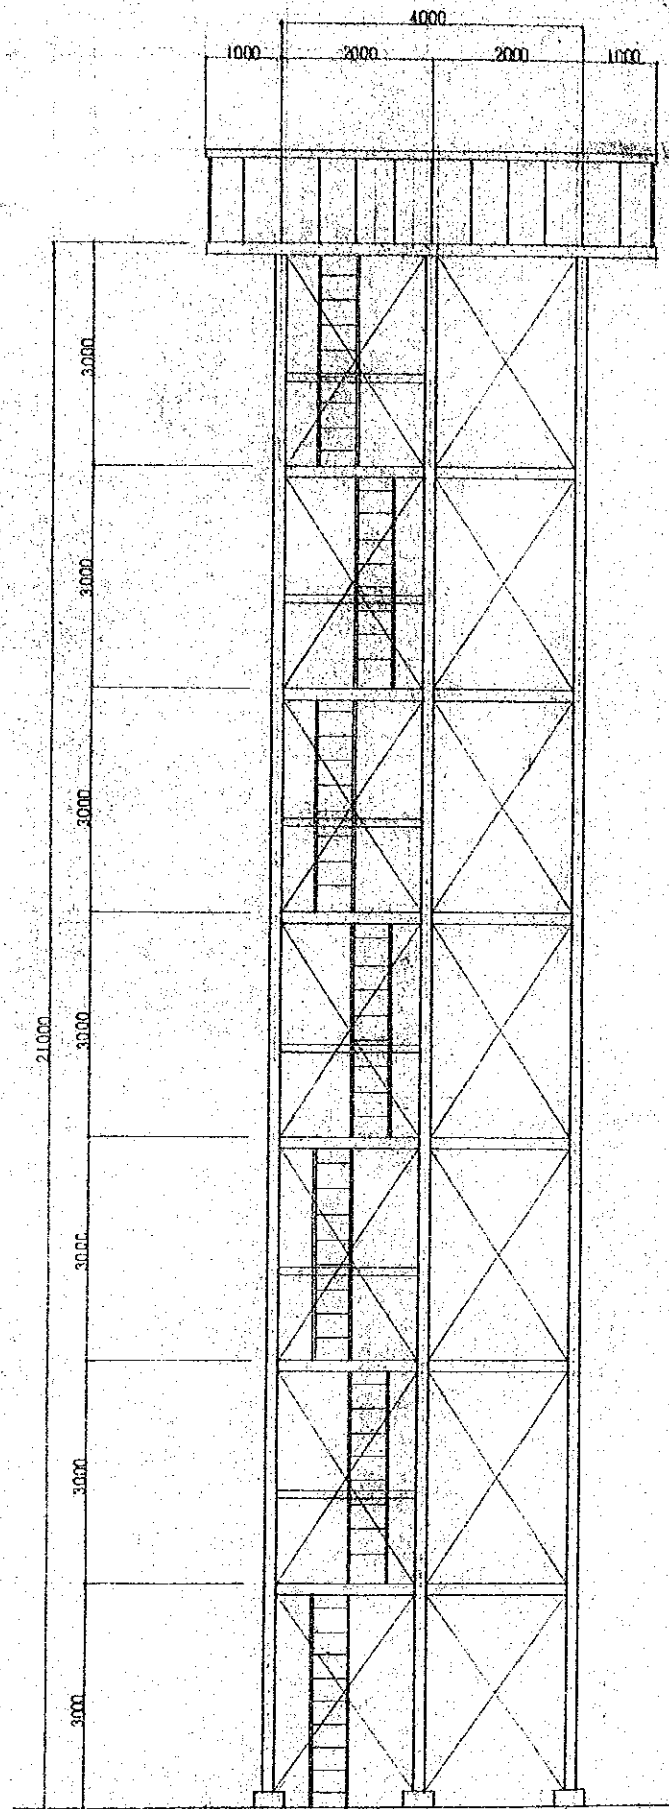


PLAN

ELEVATED TANK

60TON

MINISTRY OF PUBLIC WORKS YEMEN ARAB REPUBLIC			
THE RURAL WATER SUPPLY PROJECT PART-II			
STEEL TRESTLE 21 ^m TALL FOR 60TON TANK			
DESIGNED BY	Pacific Consultants International		
DATE	MAY 1980	SCALE	1:50
DRAWING No.		58	
JAPAN INTERNATIONAL COOPERATION AGENCY, TOKYO, JAPAN			

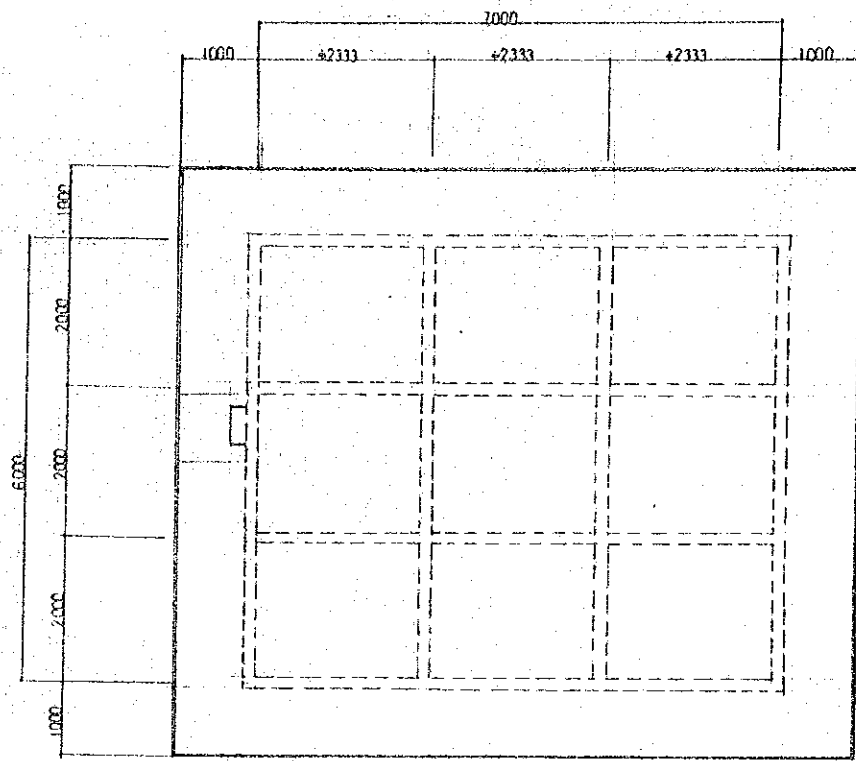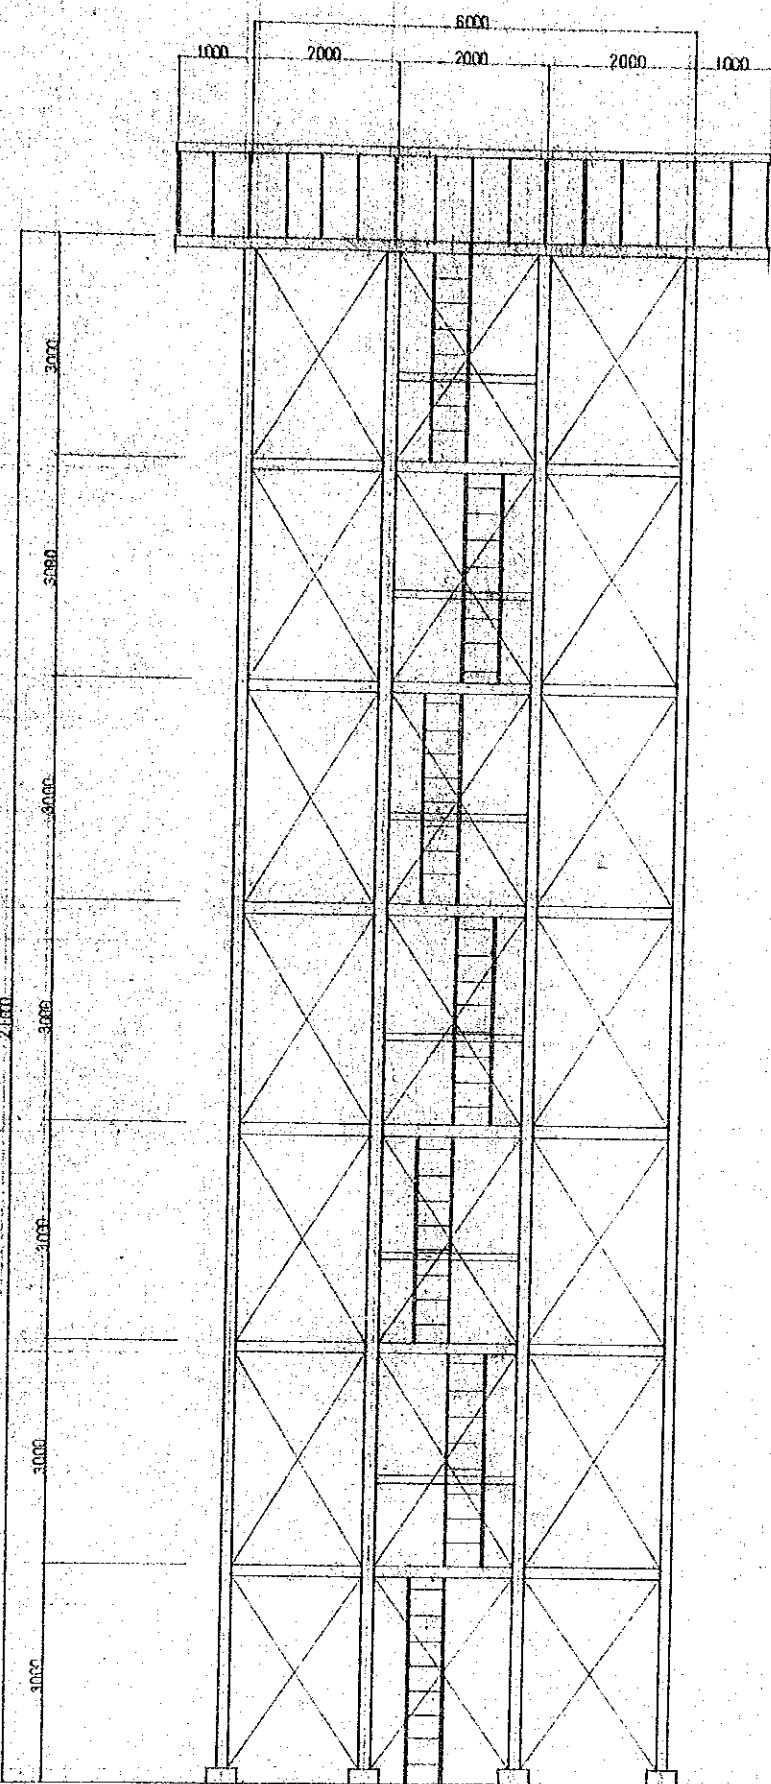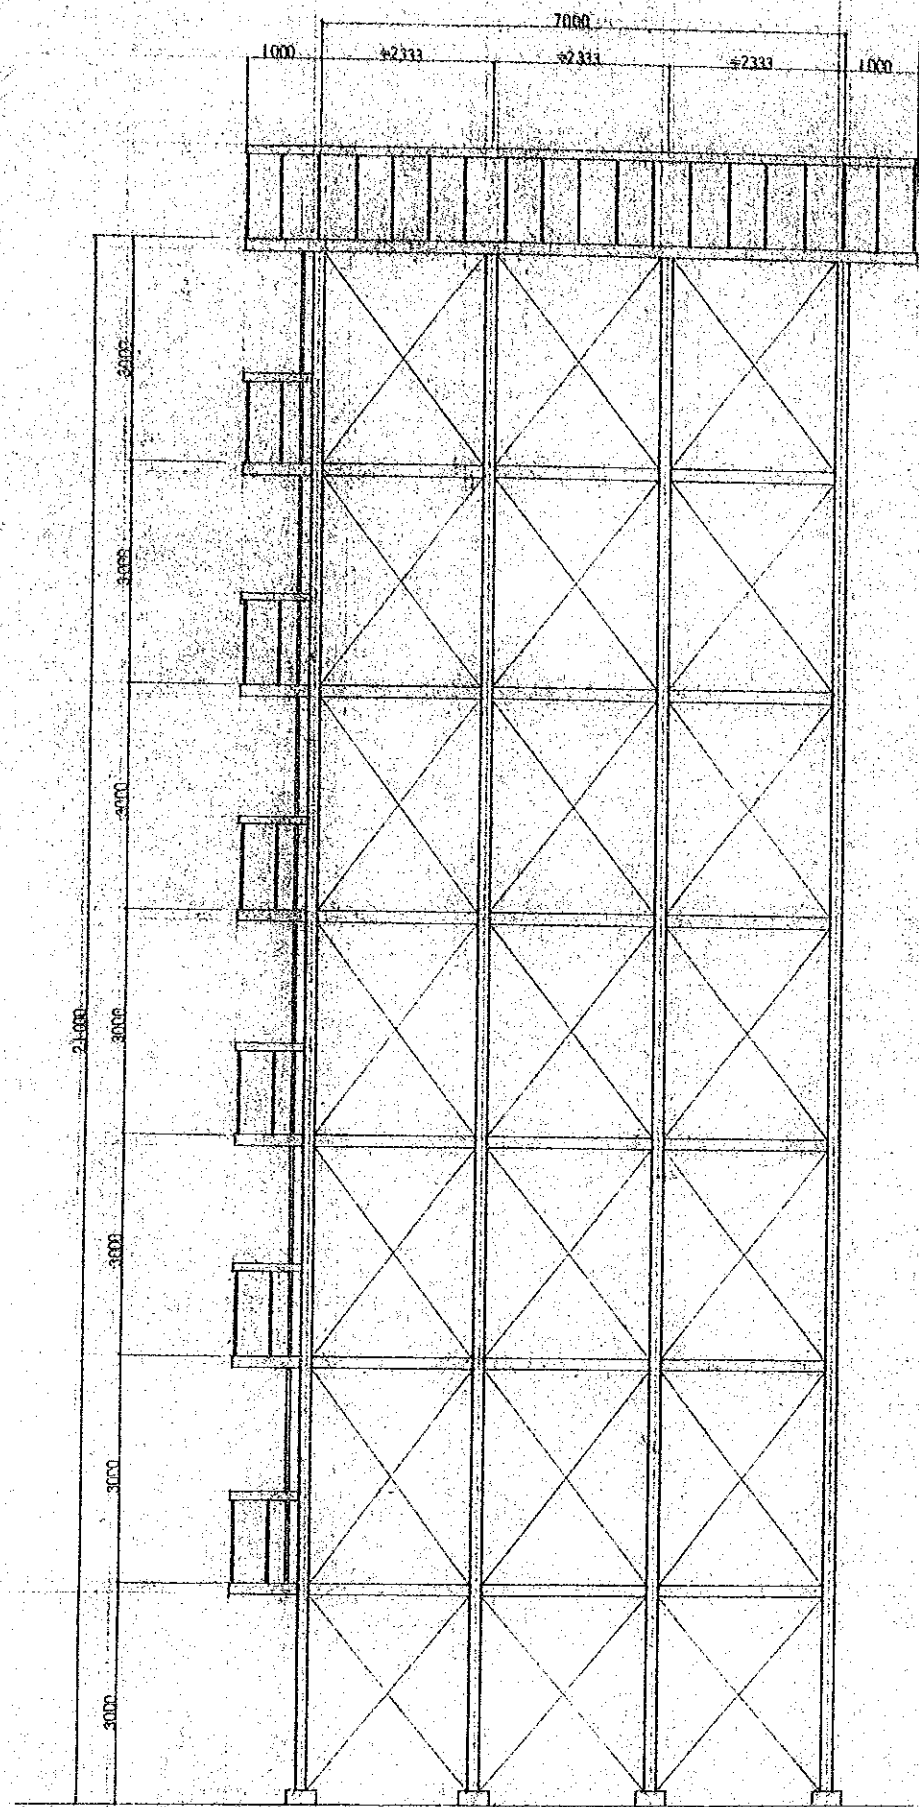

PLAN

ELEVATED TANK

156 TON

MINISTRY OF PUBLIC WORKS YEMEN ARAB REPUBLIC		
THE RURAL WATER SUPPLY PROJECT PART-II		
STEEL TRESTLE 21 ^m TALL FOR 156 TON TANK		
DESIGNED BY	Pacific Consultants International	
DATE	SCALE	DRAWING No.
MAY 80	1:50	59
JAPAN INTERNATIONAL COOPERATION AGENCY, TOKYO, JAPAN		