



FOUNDATION SCHEDULE
SCALE 1:30

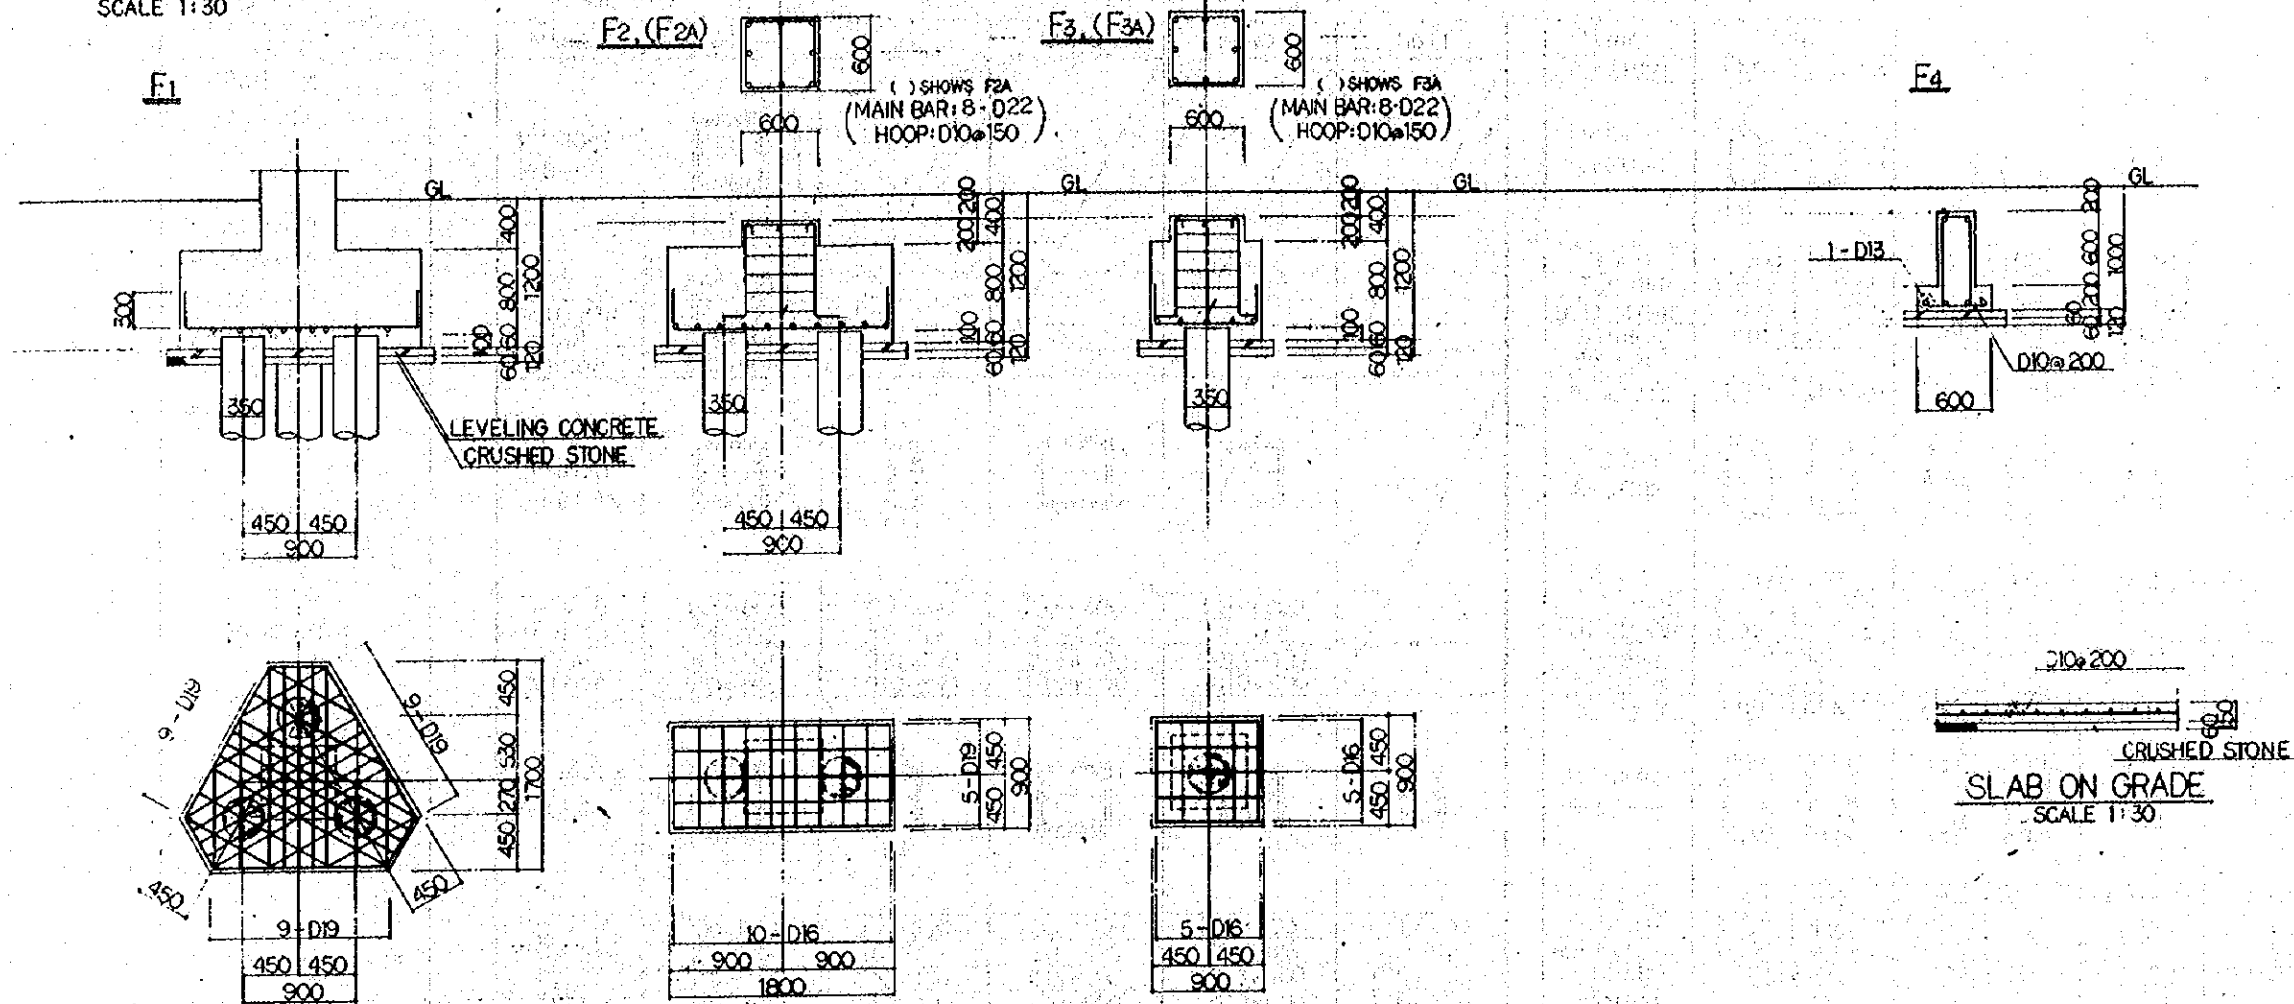

GIRDER SCHEDULE
SCALE 1:30

SHOWS TIE BAR : D10 @ 600

MARK	FG1	FG2	FG3	FG4	FG5
POSITION	ALL	ALL	END CENTER	END CENTER	ALL
SECTION					
B x D	300 x 800	400 x 800	400 x 800	400 x 900	400 x 900
TOP BAR	3 - D25	4 - D25	6 - D25 4 - D25	6 - D25 3 - D25	4 - D25
BOTTOM BAR	3 - D25	4 - D25	6 - D25 6 - D25	6 - D25 6 - D25	4 - D25
STIRRUP	D13 @ 200	D13 @ 200	D13 @ 200	D13 @ 200	D13 @ 200
WEB BAR	2 - D13	2 - D13	2 - D13	2 - D13	2 - D13

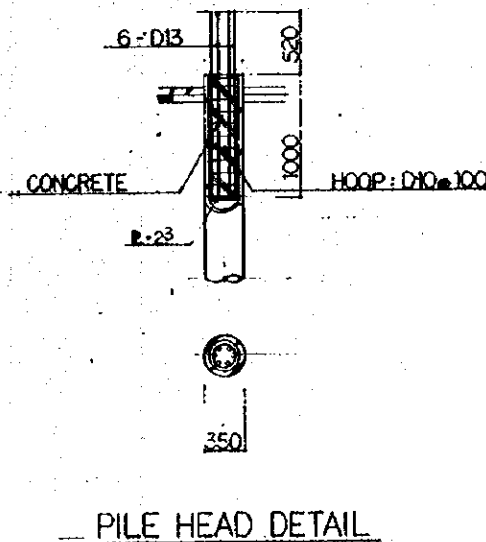

REPUBLIC OF INDONESIA
MINISTRY OF COMMUNICATIONS
DIRECTORATE GENERAL OF LAND TRANSPORT
AND INLAND WATERWAYS

NEW RAILWAY LINE FOR CENKARENG AIRPORT
CONSTRUCTION PROJECT

JAPAN INTERNATIONAL COOPERATION AGENCY
(JICA)

REVISION	DATE	BY	CHECKED	DATE	BY
B	1.10.2014
A	11.08.2014

FOUNDATION SCHEDULE

PACKAGE: I CIVIL AND ARCHITECTURAL WORK

SCALE: 1:30 DRAWING NO: AS - 001

STEEL MEMBER SCHEDULE

COLUMN SCHEDULE
SCALE 1:30

GIRDER SCHEDULE
SCALE 1:30
--- SHOWS TIE BAR D10@600

MARK	SIZE
C1	∅-355.6 x 7.9
C2	∅-457.2 x 9.5
G1	∅-355.6 x 7.9
G2	∅-355.6 x 9.5
G3	∅-355.6 x 6.4
G4	∅-457.2 x 9.5
G5	∅-267.4 x 6
G6	∅-165.2 x 4
B1	∅-267.4 x 6
B2	∅-165.2 x 4
B3	L-75 x 75 x 6
V1	H-250 x 250 x 9 x 14
P1	∅-355.6 x 6.4
P2	∅-267.4 x 6
P3	∅-165.2 x 4

MARK	C10	C11	KC10	SC10	SC11
3 rd STORY SECTION					
B x D	600 x 600				
MAIN BAR	24-D22				
HOOP	D13@100				
D.HOOP	D10@600				
2 nd STORY SECTION					
B x D	600 x 600	300 x 600	600 x 600	500 x 500	
MAIN BAR	24-D22	10-D19	20-D25	8-D25	
HOOP	D13@100	D10@100	D13@100	D13@100	
D.HOOP	D10@600	D10@600	D10@600	D10@600	
1 st STORY SECTION					
B x D	600 x 600	300 x 600	600 x 600	500 x 500	400 x 400
MAIN BAR	24-D22	10-D19	20-D25	8-D25	8-D16
HOOP	D13@100	D10@100	D13@100	D13@100	D10@100
D.HOOP	D10@600	D10@600	D10@600	D10@600	D10@600

MARK	G10	G11	G12	CG10
POSITION	END CENTER	ALL	ALL	
ROOF SECTION				
B x D	300 x 500	250 x 500	250 x 650	
TOP BAR	3-D22 3-D22	2-D22	2-D22	
BOTTOM BAR	3-D22 5-D22	2-D22	2-D22	
STIRRUP	D10@200	D10@200	D10@200	
WEB BAR			2-D10	
POSITION	END CENTER	END CENTER	ALL	ALL
3 rd STORY SECTION				
B x D	400 x 700	350 x 700	300 x 600	350 x 700
TOP BAR	8-D25 4-D25	5-D25 3-D25	3-D25	5-D25
BOTTOM BAR	4-D25 10-D25	3-D25 3-D25	3-D25	3-D25
STIRRUP	D13@100	D13@200	D10@200	D10@200
WEB BAR	2-D13	2-D13	2-D10	2-D10
POSITION	END CENTER	END CENTER	ALL	ALL
2 nd STORY SECTION				
B x D	400 x 700	350 x 700	300 x 600	350 x 700
TOP BAR	8-D25 4-D25	6-D25 3-D25	3-D25	5-D25
BOTTOM BAR	4-D25 6-D25	5-D25 3-D25	3-D25	3-D25
STIRRUP	D13@100	D13@200	D10@200	D10@200
WEB BAR	2-D13	2-D13	2-D10	2-D10

MARK	SIZE
KC1	H-250 x 250 x 9 x 14
KG1	H-300 x 150 x 6.5 x 9
KG2	H-300 x 150 x 6.5 x 9
KB1	H-248 x 124 x 5 x 8
KB2	H-175 x 90 x 5 x 8
KB3	C-100 x 50 x 20 x 2.3
KB4	H-300 x 150 x 6.5 x 9
KP1	H-244 x 175 x 7 x 11

GIRDER SCHEDULE
SCALE 1:30
--- SHOWS TIE BAR D10@600

MARK	WG1	KG10	KG11	KG12	SG10	SG11	SG12
POSITION		END CENTER	END CENTER	ALL	END CENTER	ALL	
ROOF SECTION							
B x D		400 x 800	350 x 800	350 x 800	300 x 600	300 x 600	
TOP BAR		6-D25 4-D25	5-D25 3-D25	4-D25	3-D22 3-D22	3-D19	
BOTTOM BAR		3-D25 7-D25	3-D25 6-D25	4-D25	3-D22 5-D22	3-D19	
STIRRUP		D13@100	D13@100	D10@200	D10@200	D10@200	
WEB BAR		2-D13	2-D13	2-D10	2-D10	2-D10	
POSITION	ALL	END CENTER	END CENTER	ALL	END CENTER	ALL	ALL
2 nd STORY SECTION							
B x D	150 x 600	400 x 800	350 x 800	350 x 800	300 x 600	300 x 600	250 x 500
TOP BAR	1-D13	5-D25 3-D25	5-D25 3-D25	4-D25	5-D22 3-D22	3-D22	2-D19
BOTTOM BAR	1-D13	3-D25 6-D25	3-D25 6-D25	4-D25	3-D22 5-D22	3-D22	2-D19
STIRRUP	D10@200	D13@100	D13@100	D10@200	D10@200	D10@200	D10@200
WEB BAR	2-D10	2-D13	2-D13	2-D10	2-D10	2-D10	

MARK	SIZE
SG1	H-250 x 125 x 6 x 9
SB1	2C-100 x 50 x 20 x 2.3

REPUBLIC OF INDONESIA
MINISTRY OF COMMUNICATIONS
DIRECTORATE GENERAL OF LAND TRANSPORT AND INLAND WATERWAYS

NEW RAILWAY LINE FOR CENGKARENG AIRPORT CONSTRUCTION PROJECT

JAPAN INTERNATIONAL COOPERATION AGENCY (JICA)

REVISIONS	DATE	DESIGNED	CHECKED	REVIEWED	SUBMITTED
B	1 AUG 2014	DN	PN	K.M.	AK
A	1 FEB 2014	DN	PN	K.M.	AK

COLUMN AND GIRDER SCHEDULE.

PACKAGE: I CIVIL AND ARCHITECTURAL WORK
SCALE: 1:30
DRAWING NO: AS-002

BEAM SCHEDULE





SCALE 1:30

SHOWS TIE BAR D10@600

MARK	B10		B11	B12		B13	B14		B15		B16
	END	CENTER	ALL	END	CENTER	ALL	END	CENTER	END	CENTER	ALL
SECTION											
B x D	350 x 650		300 x 500	300 x 600		200 x 500	400 x 800		400 x 700		400 x 600
TOP BAR	3 - D22	3 - D22	3 - D22	3 - D22	3 - D22	2 - D19	5 - D25	3 - D25	5 - D25	3 - D25	3 - D25
BOTTOM BAR	3 - D22	5 - D22	3 - D22	3 - D22	5 - D22	2 - D19	3 - D25	6 - D25	5 - D25	3 - D25	3 - D25
STIRRUP	D10 @ 200		D10 @ 200	D10 @ 200		D10 @ 200	D13 @ 200		D13 @ 200		D13 @ 200
WEB BAR	2 - D10		—	2 - D10		2 - D10	2 - D13		2 - D13		2 - D13

SLAB SCHEDULE

MARK	THICKNESS	POSITION	SHORT SPAN		LONG SPAN		NOTE
			END	CENTER	END	CENTER	
			S1	130	TOP	D10 D13 @ 200	
		BOTTOM	D10 D13 @ 200	D10 D13 @ 200	D10 D13 @ 200	D10 D13 @ 200	
S2	130	TOP	D10 D13 @ 200	D10 D13 @ 200	D10 @ 200	D10 @ 200	
		BOTTOM	D10 D13 @ 200	D10 D13 @ 200	D10 @ 200	D10 @ 200	
S3	150	TOP	D13 @ 200		D13 @ 200		
		BOTTOM	D13 @ 200		D13 @ 200		
CS1	150	TOP	D13 @ 200		D10 @ 200		
	130	BOTTOM	D10 @ 200		D10 @ 200		
CS2	200	TOP	D13 @ 200		D10 @ 200		
	130	BOTTOM	D10 @ 200		D10 @ 200		

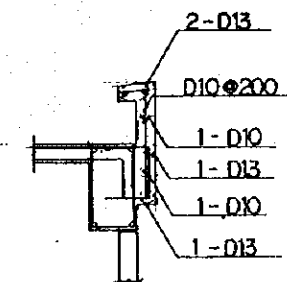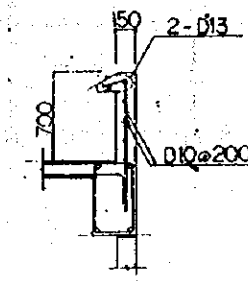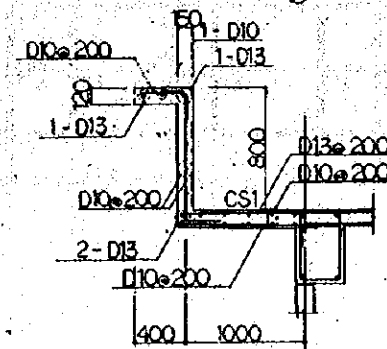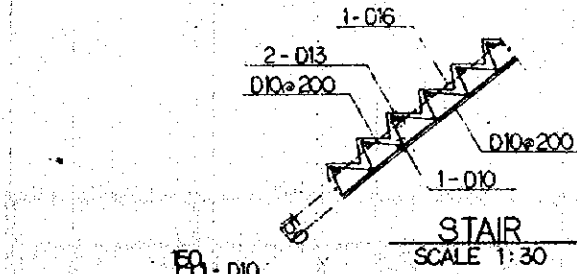

WALL SCHEDULE

SCALE 1:30

MARK	W15	W18
SECTION		
THICKNESS	150	180
VERT. BAR	D10 @ 200	D10 D13 @ 200
HORI. BAR	D10 @ 200	D10 @ 200
TIE BAR	—	D10 @ 1000

REPUBLIC OF INDONESIA
MINISTRY OF COMMUNICATIONS
DIRECTORATE GENERAL OF LAND TRANSPORT AND INLAND WATERWAYS


NEW RAILWAY LINE FOR CENKARENG AIRPORT
CONSTRUCTION PROJECT

JAPAN INTERNATIONAL COOPERATION AGENCY (JICA)

REVISIONS	DATE	DESIGNED	DRAWN	CHECKED	REVIEWED	SUBMITTED
B	1 MAR 2014	HN	ES	KM	AK	
A	15 FEB 2014	HN	ES	KM	AK	

BEAM, SLAB AND WALL SCHEDULE

PACKAGE: I CIVIL AND ARCHITECTURAL WORK
SCALE: 1:30 DRAWING NO: AS - 003

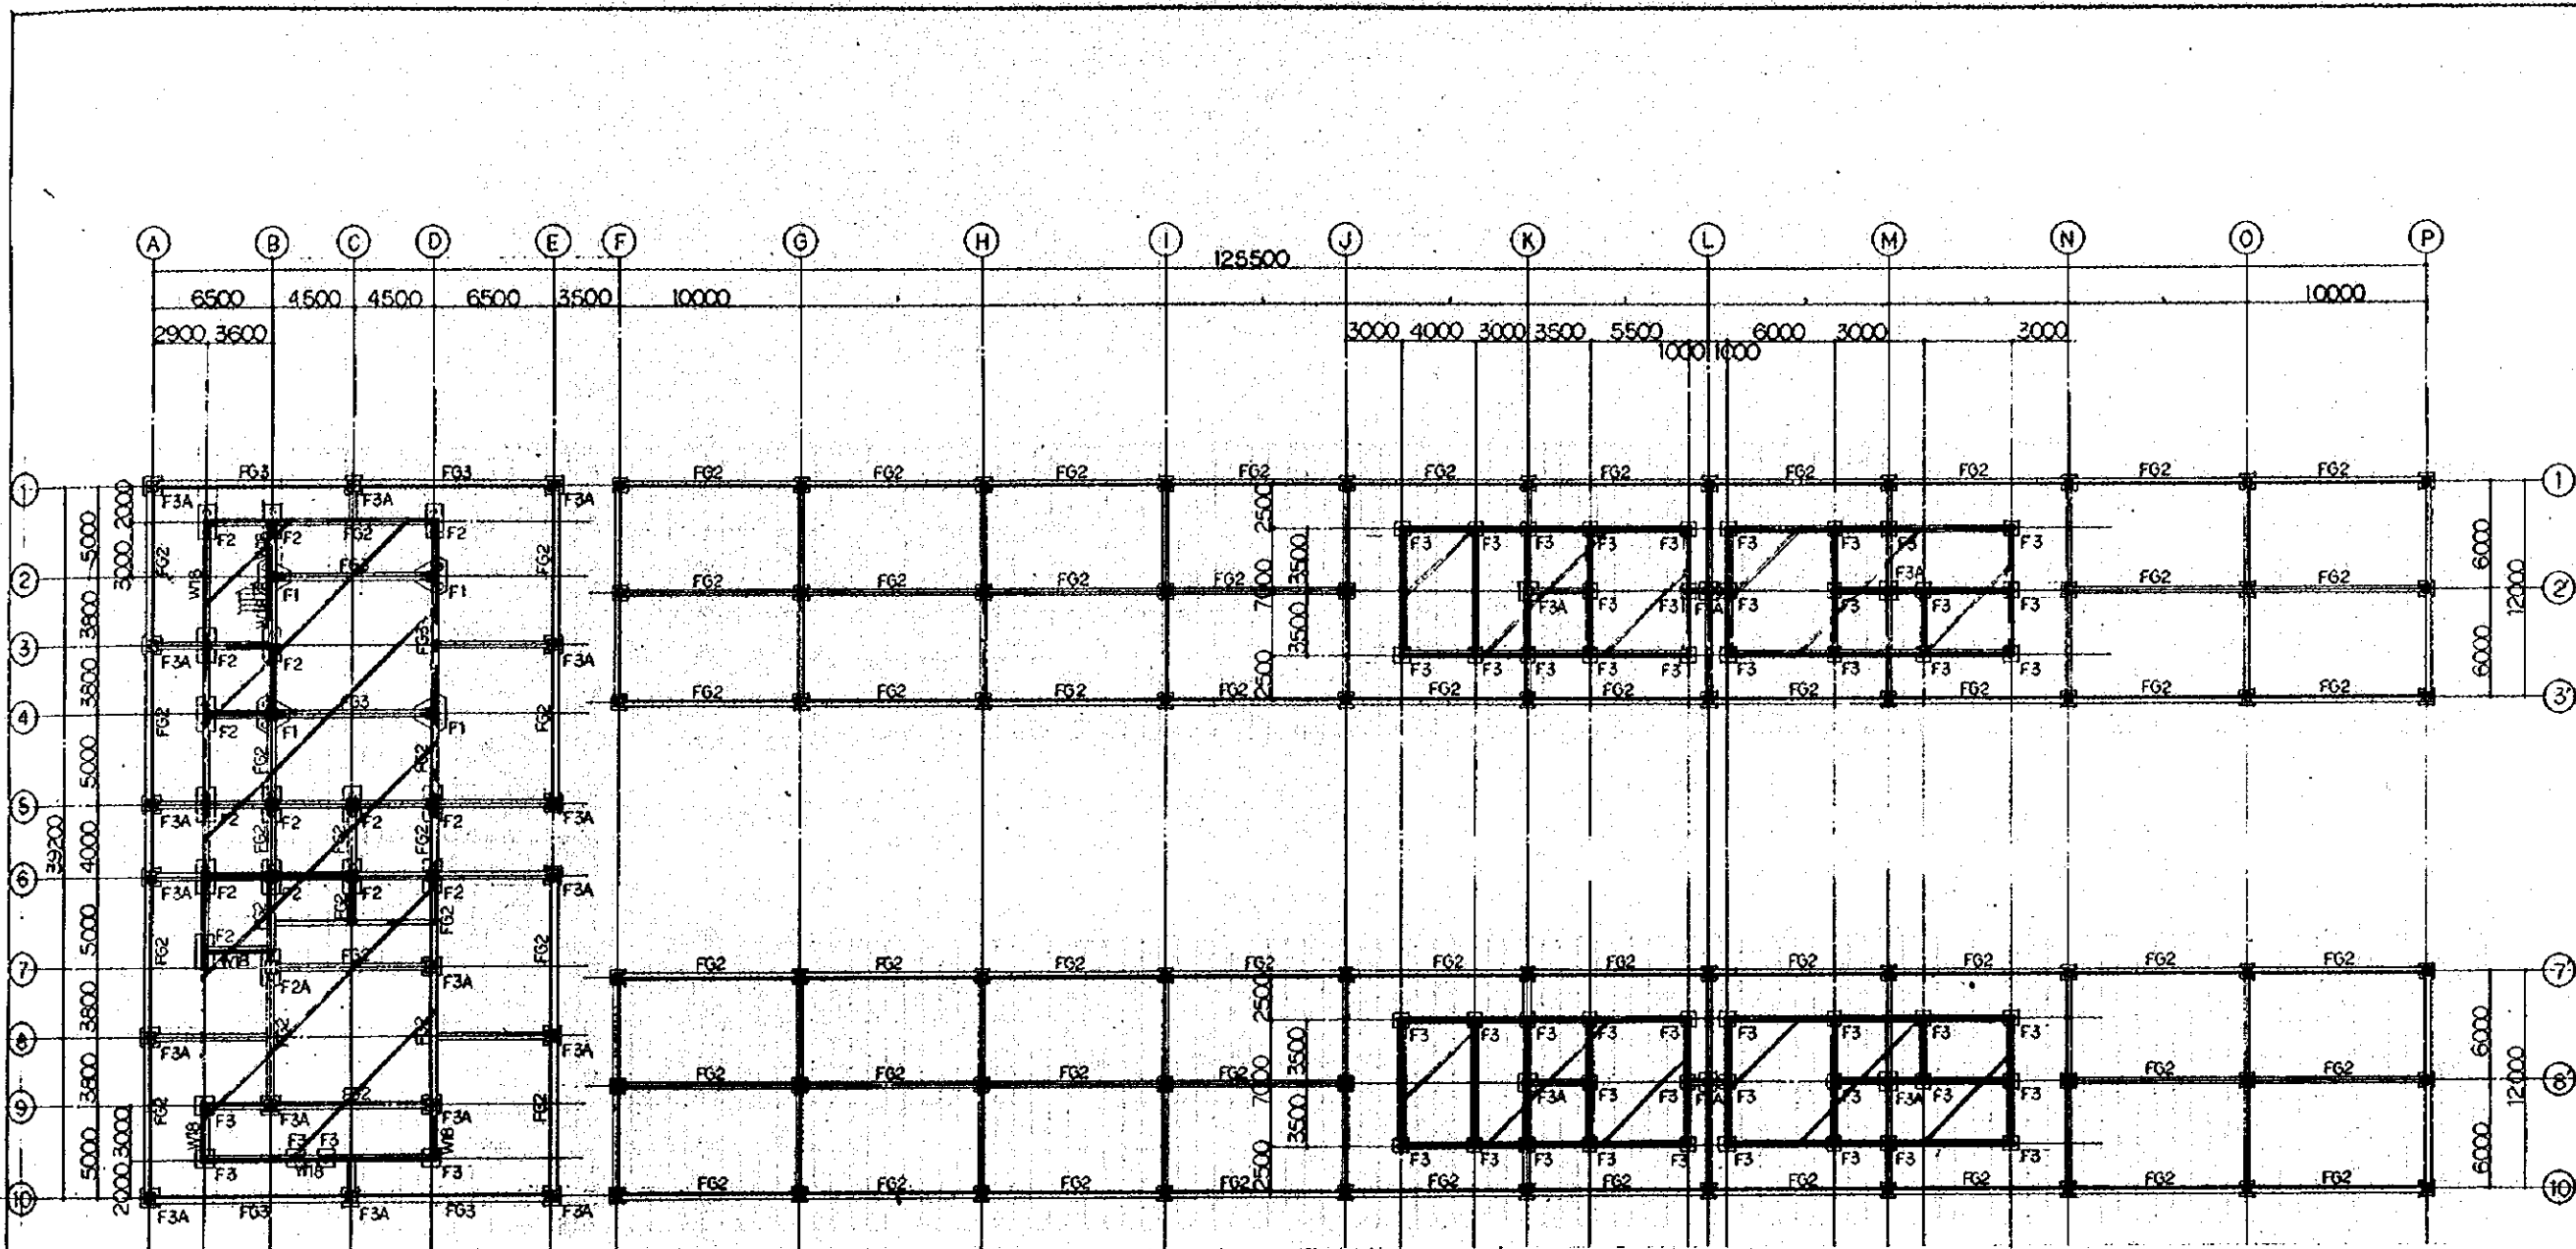


FOUNDATION PLAN

SCALE 1:200

- UNLESS OTHERWISE NOTED
1. GIRDER MARK : FG1
 2. WALL MARK : W15
 3. FOOTING MARK : F3A
 4. : SHOWS SLAB ON GRADE

REPUBLIC OF INDONESIA MINISTRY OF COMMUNICATIONS DIRECTORATE GENERAL OF LAND TRANSPORT AND INLAND WATERWAYS						
NEW RAILWAY LINE FOR CENKARENG AIRPORT CONSTRUCTION PROJECT						
JAPAN INTERNATIONAL COOPERATION AGENCY (JICA)						
B	1 AUG 78	S.M.	H.Z.	S.M.	K.M.	M.K.
A	15 FEB 78	S.M.	H.Z.	S.M.	K.M.	M.K.
REVISIONS	DATE	DRAWN	CHECKED	REVIEWED	SUBMITTED	
AIRPORT TERMINAL STATION FOUNDATION PLAN						
PACKAGE: I CIVIL AND ARCHITECTURAL WORK						
SCALE: 1:200		DRAWING NO: AS - 004				

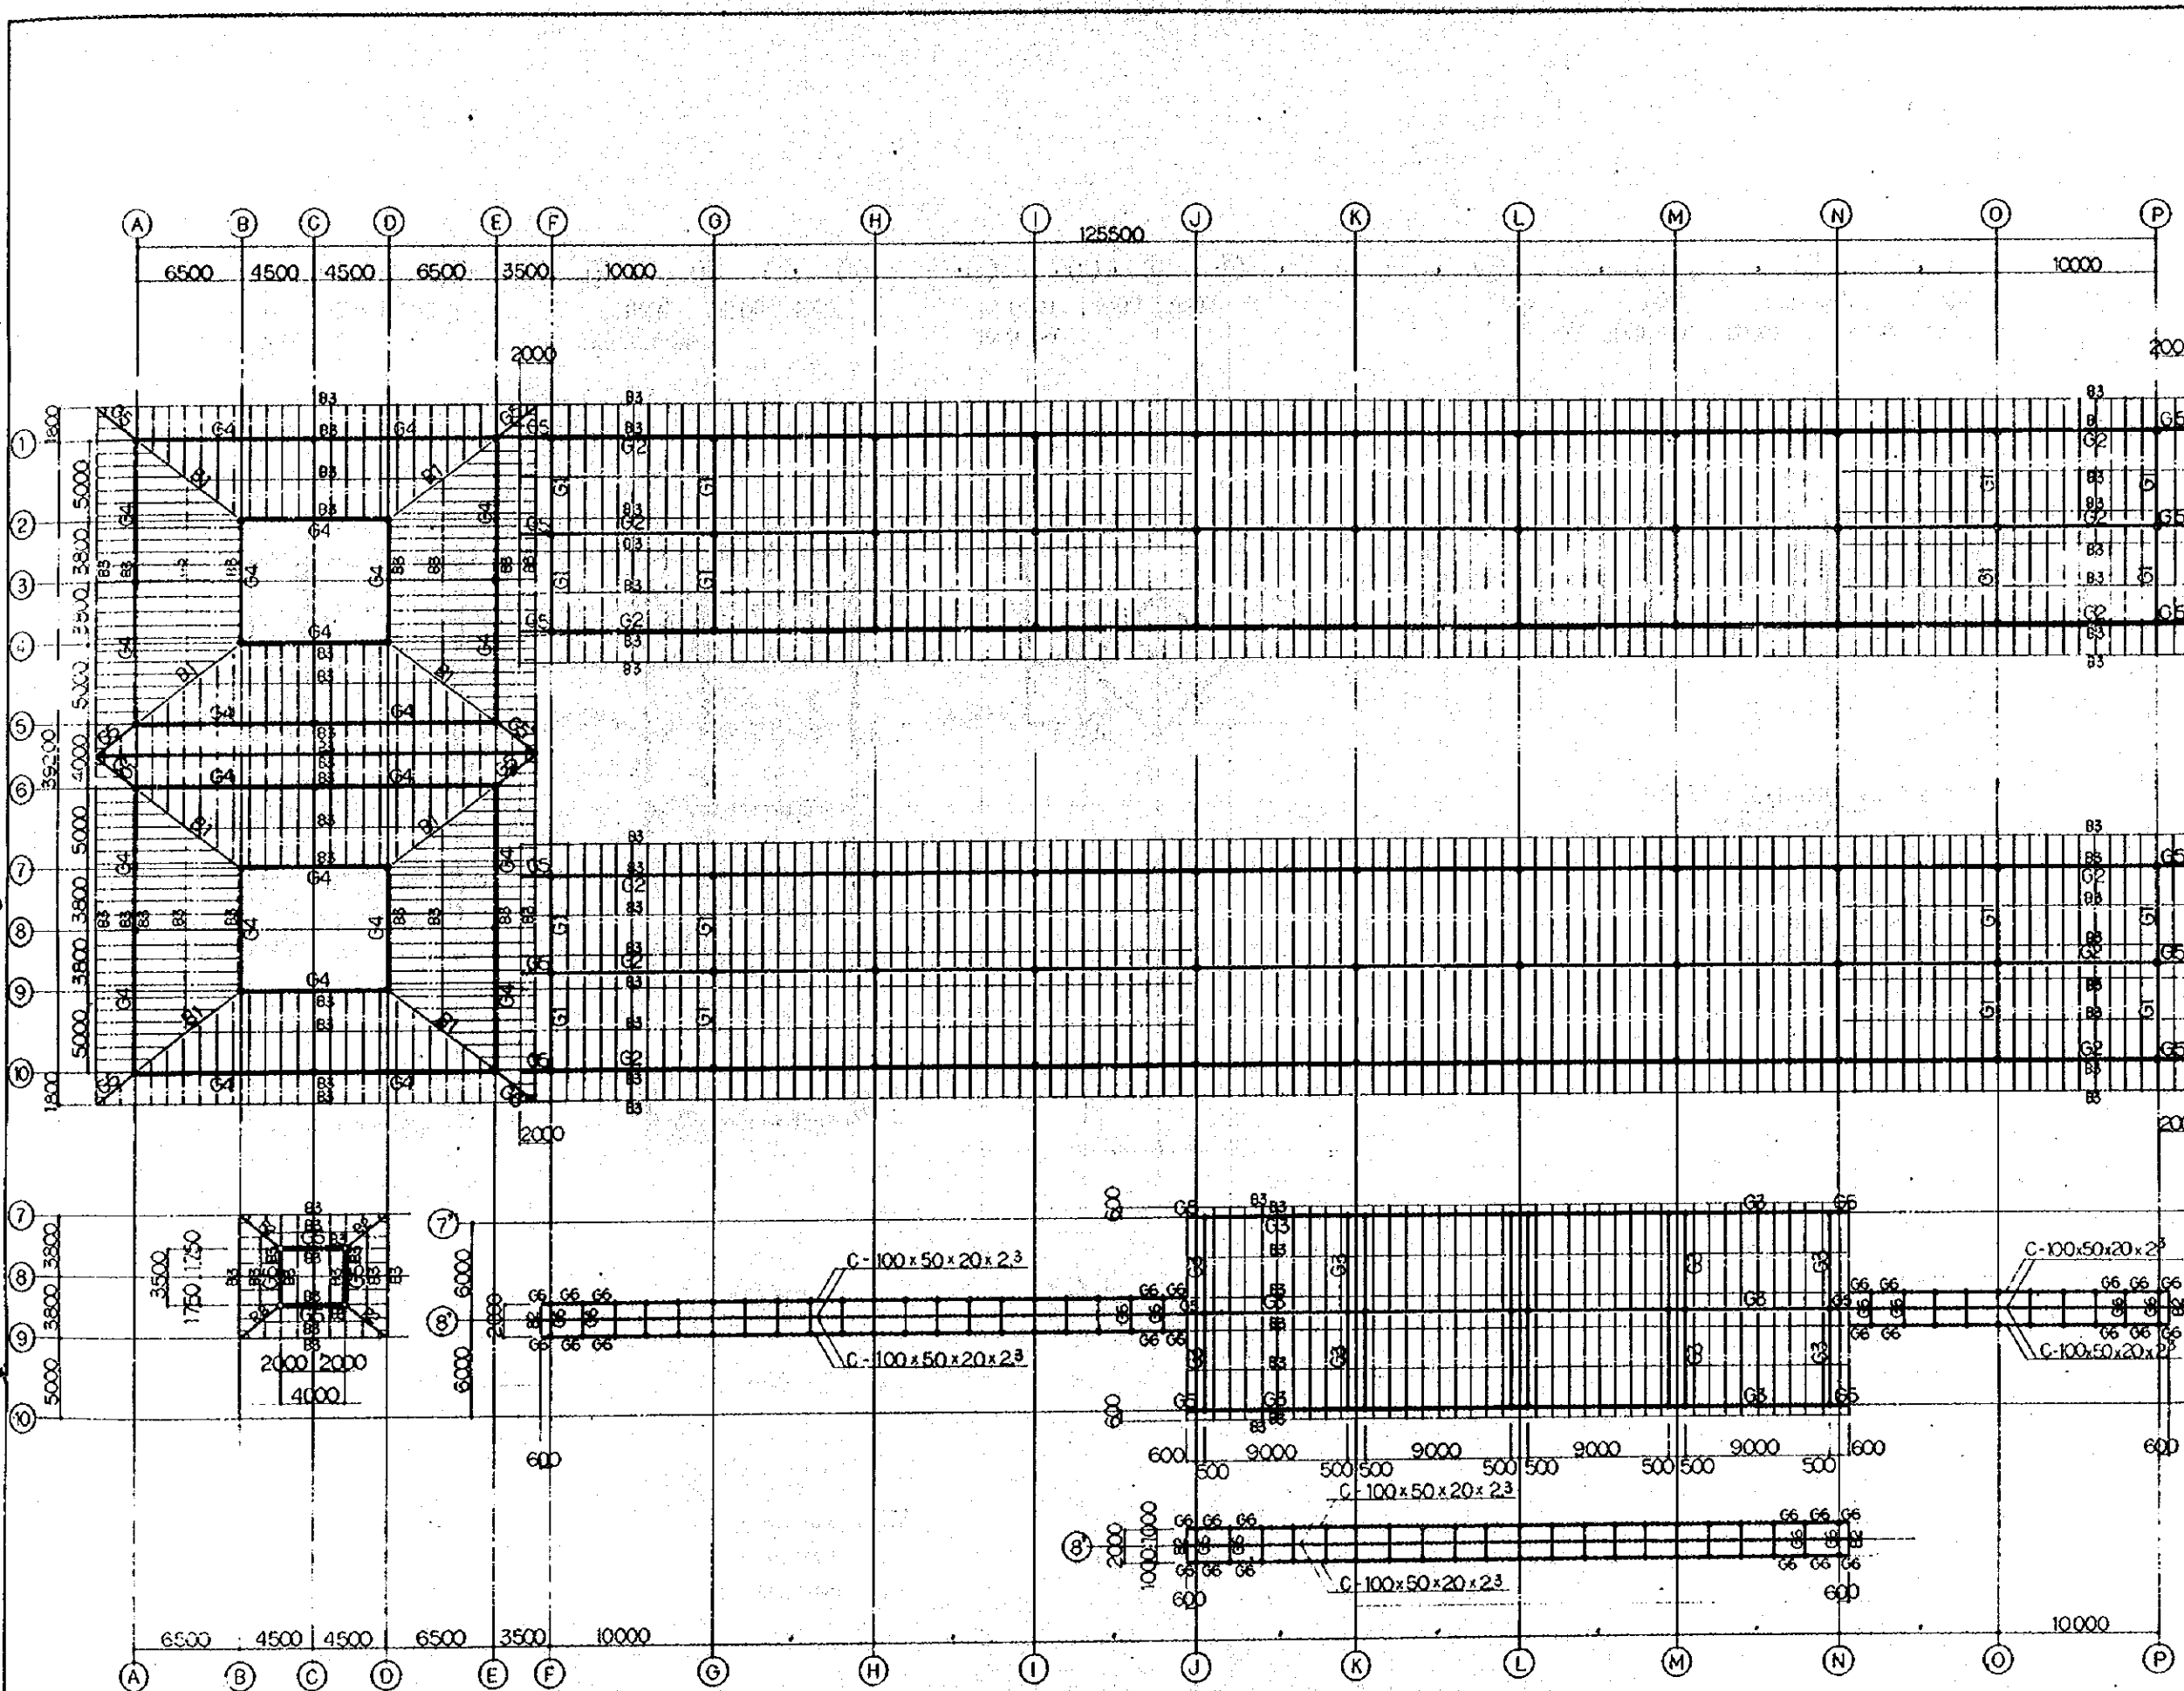

REPUBLIC OF INDONESIA
 MINISTRY OF COMMUNICATIONS
 DIRECTORATE GENERAL OF LAND TRANSPORT
 AND INLAND WATERWAYS

NEW RAILWAY LINE FOR CENKARENG AIRPORT
 CONSTRUCTION PROJECT

JAPAN INTERNATIONAL COOPERATION AGENCY
 (JICA)

REVISIONS	DATE	DESIGNED	CHECKED	APPROVED	REVIEWED	SUBMITTED
B	1/20/2014	H.A.	F.K.	K.M.	K.K.	
A	11/27/2013	N.A.	S.Y.	K.M.	K.K.	


AIRPORT TERMINAL STATION
 ROOF FRAMING PLAN

PACKAGE: I CIVIL AND ARCHITECTURAL WORK

SCALE: 1:200 DRAWING NO: AS - 005

ROOF FRAMING PLAN
 SCALE 1:200

UNLESS OTHERWISE NOTED
 1. PURLIN : # -1652 x 4 (B2)
 2. ROOF DECKING : V50 TYPE 1.16

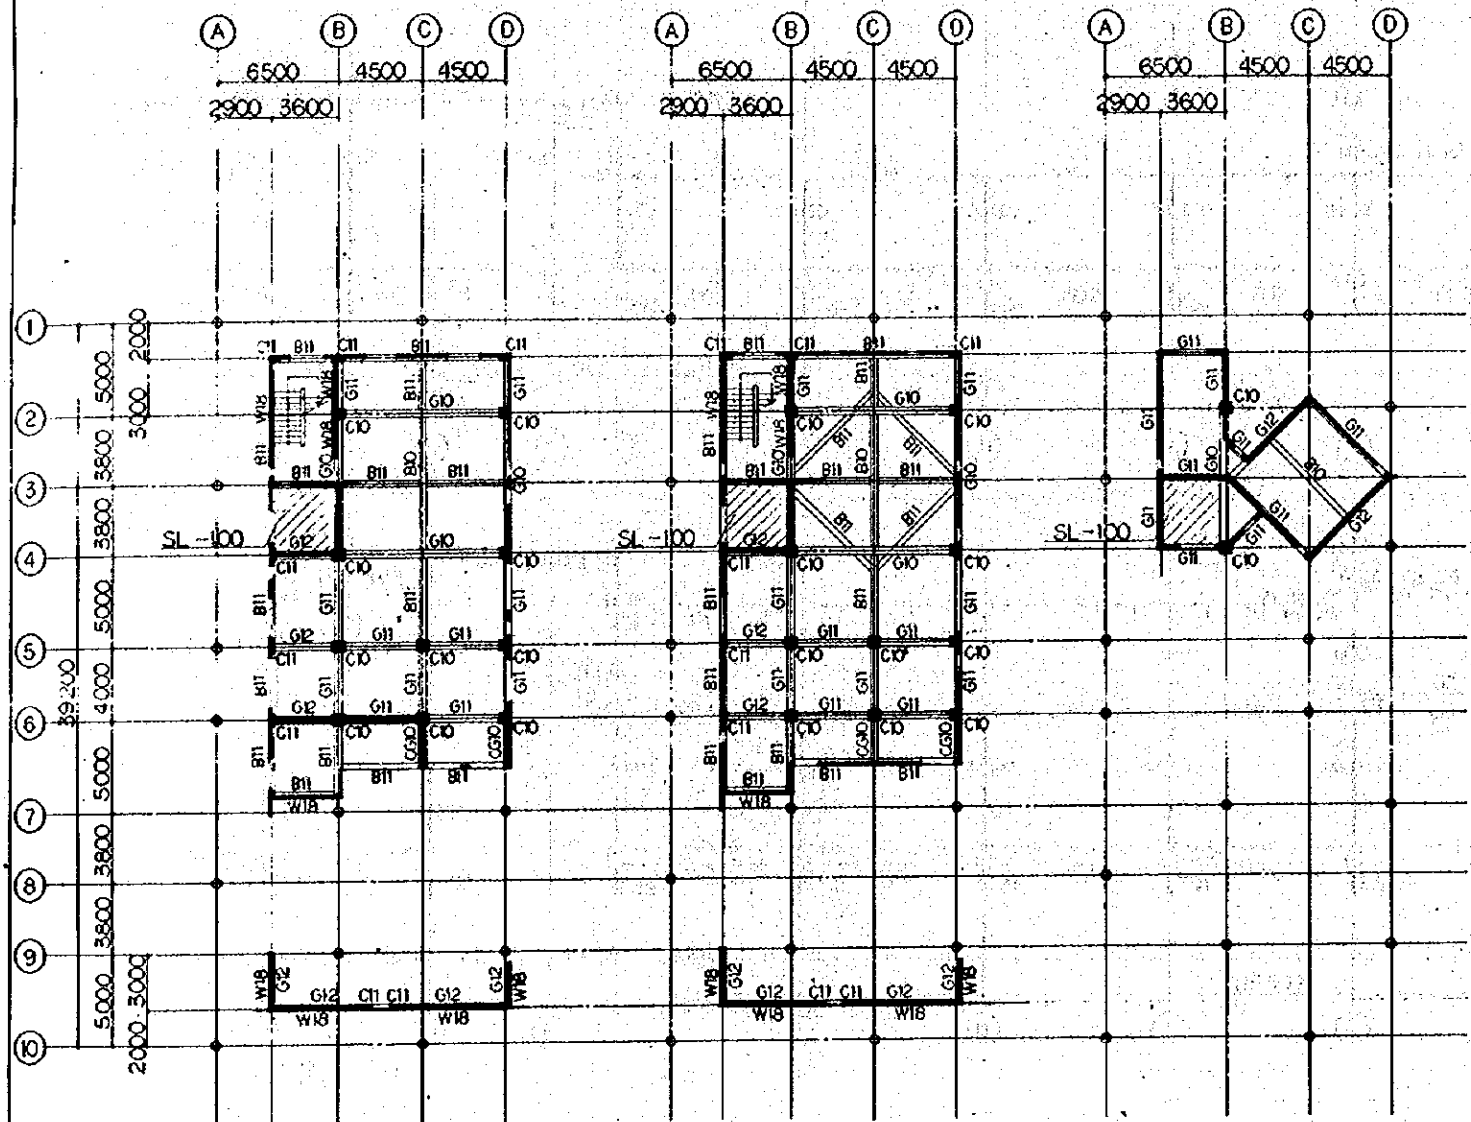

2nd FLOOR


3rd FLOOR

ROOF

FRAMING PLAN
SCALE 1:200

UNLESS OTHERWISE NOTED

1. SLAB MARK : S1
2. WALL MARK : W1S

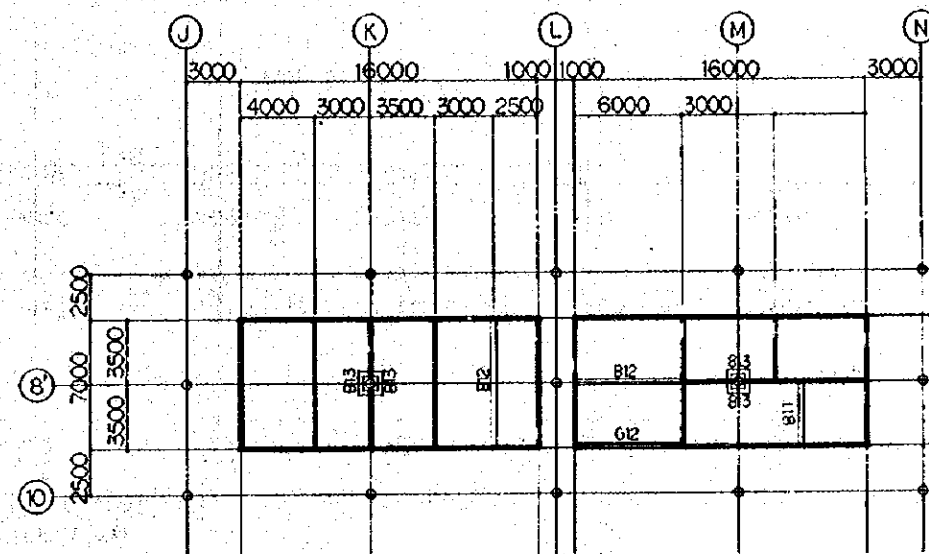





ROOF FRAMING PLAN

SCALE 1:200




UNLESS OTHERWISE NOTED

1. SLAB MARK : S1
2. GIRDER MARK : W1
3. WALL MARK : W1S



REPUBLIC OF INDONESIA MINISTRY OF COMMUNICATIONS DIRECTORATE GENERAL OF LAND TRANSPORT AND INLAND WATERWAYS					
NEW RAILWAY LINE FOR GENGKARENG AIRPORT CONSTRUCTION PROJECT					
JAPAN INTERNATIONAL COOPERATION AGENCY (JICA)					
B	1 AUG 2011	K.M.A.K.	K.M.A.K.	K.M.A.K.	K.M.A.K.
A	15 FEB 2011	K.M.A.K.	K.M.A.K.	K.M.A.K.	K.M.A.K.
REVISIONS	DATE	DESIGNED	DRAWN	CHECKED	EXTENDED
AIRPORT TERMINAL STATION FRAMING PLAN					
PACKAGE: I CIVIL AND ARCHITECTURAL WORK					
SCALE		DRAWING NO.			
1:200		AS - 006			

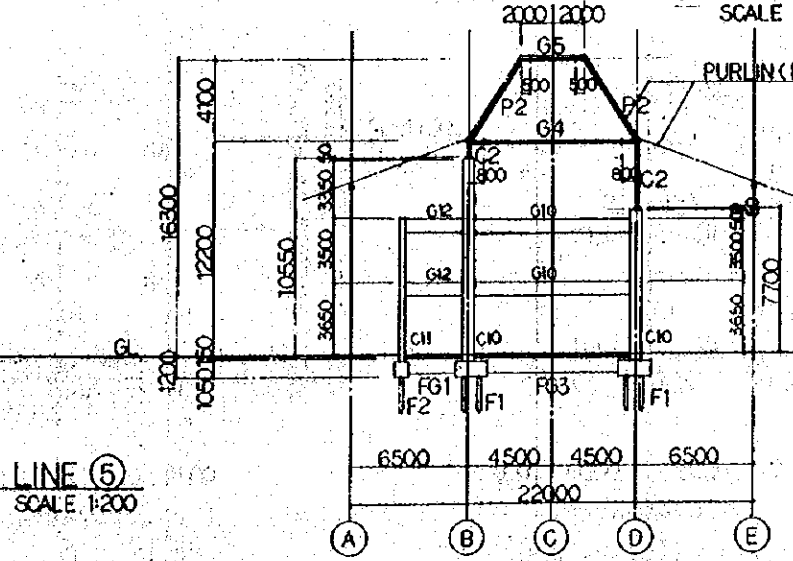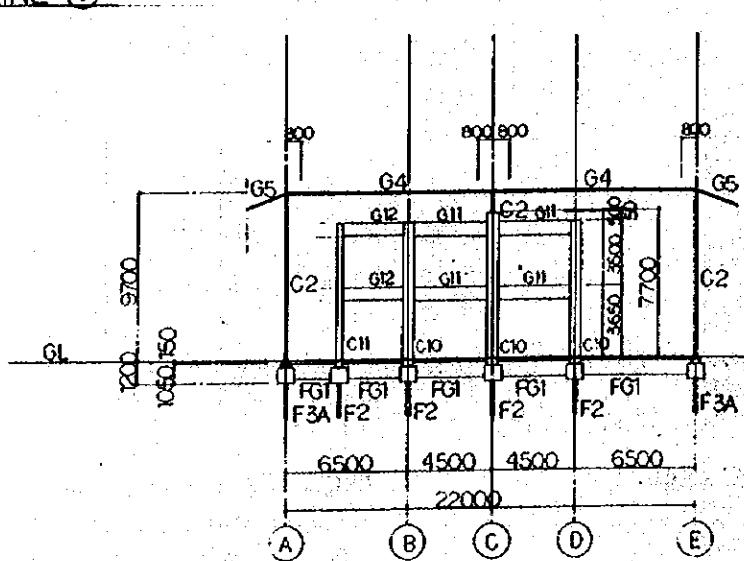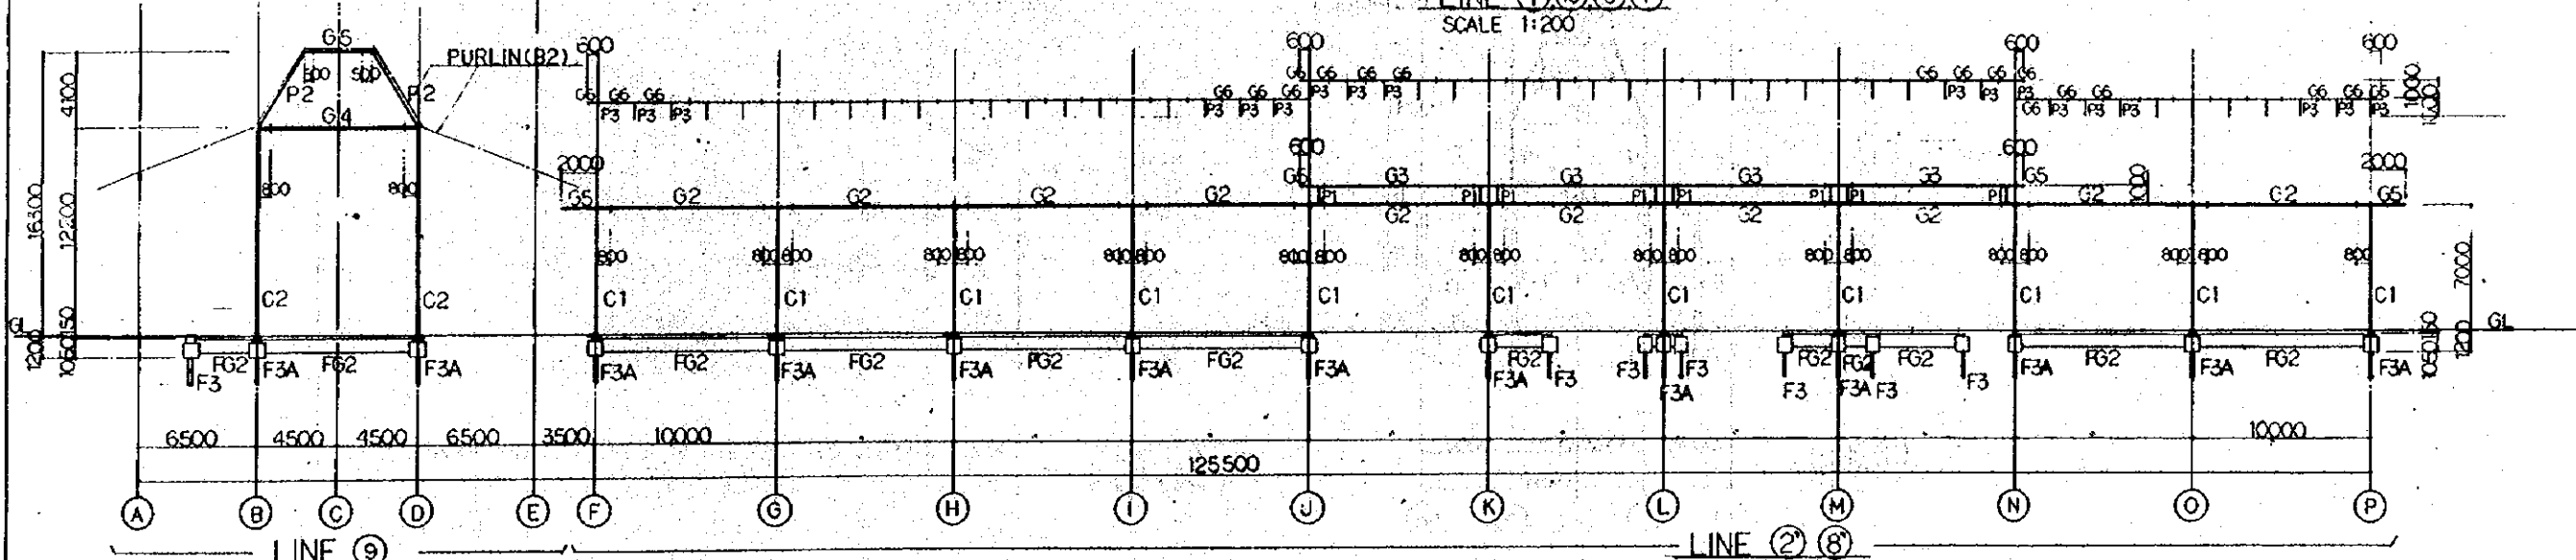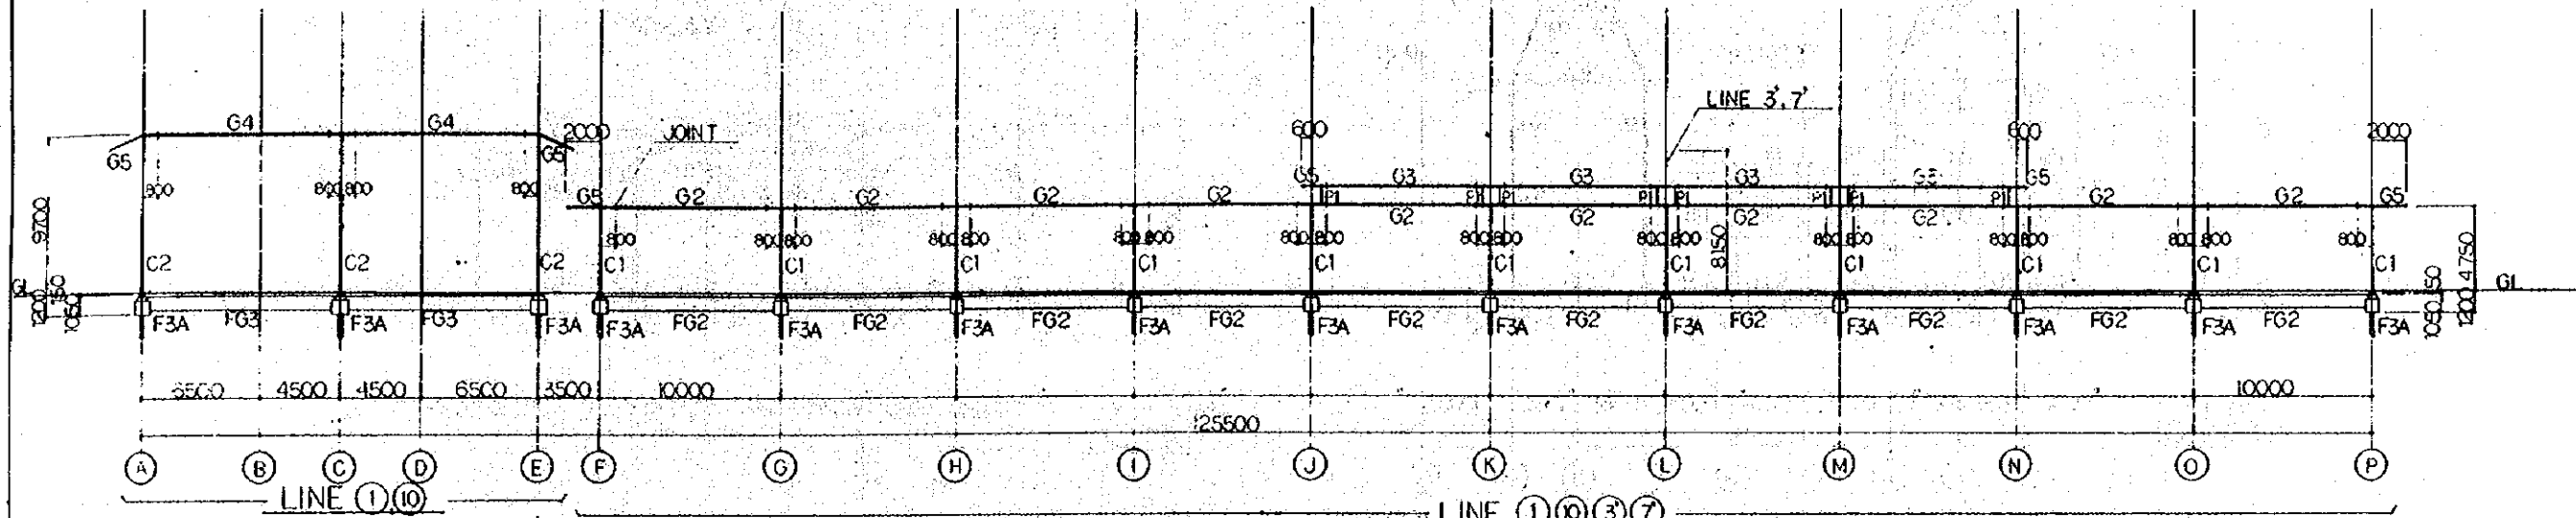


REPUBLIC OF INDONESIA MINISTRY OF COMMUNICATIONS DIRECTORATE GENERAL OF LAND TRANSPORT AND INLAND WATERWAYS					
NEW RAILWAY LINE FOR CENKARENG AIRPORT CONSTRUCTION PROJECT					
JAPAN INTERNATIONAL COOPERATION AGENCY (JICA)					
REVISIONS	DATE	DESIGNED	CHECKED	APPROVED	SUBMITTED
B	1 AUG 88	Y. H. S.	Y. H. S.	K. M. M.	M. K.
A	15 FEB 88	Y. H. S.	Y. H. S.	K. M. M.	M. K.
AIRPORT TERMINAL STATION FRAMING ELEVATION (SHEET 1 OF 2)					
PACKAGE: I CIVIL AND ARCHITECTURAL WORK					
SCALE: 1:200		DRAWING NO: AS - 007			

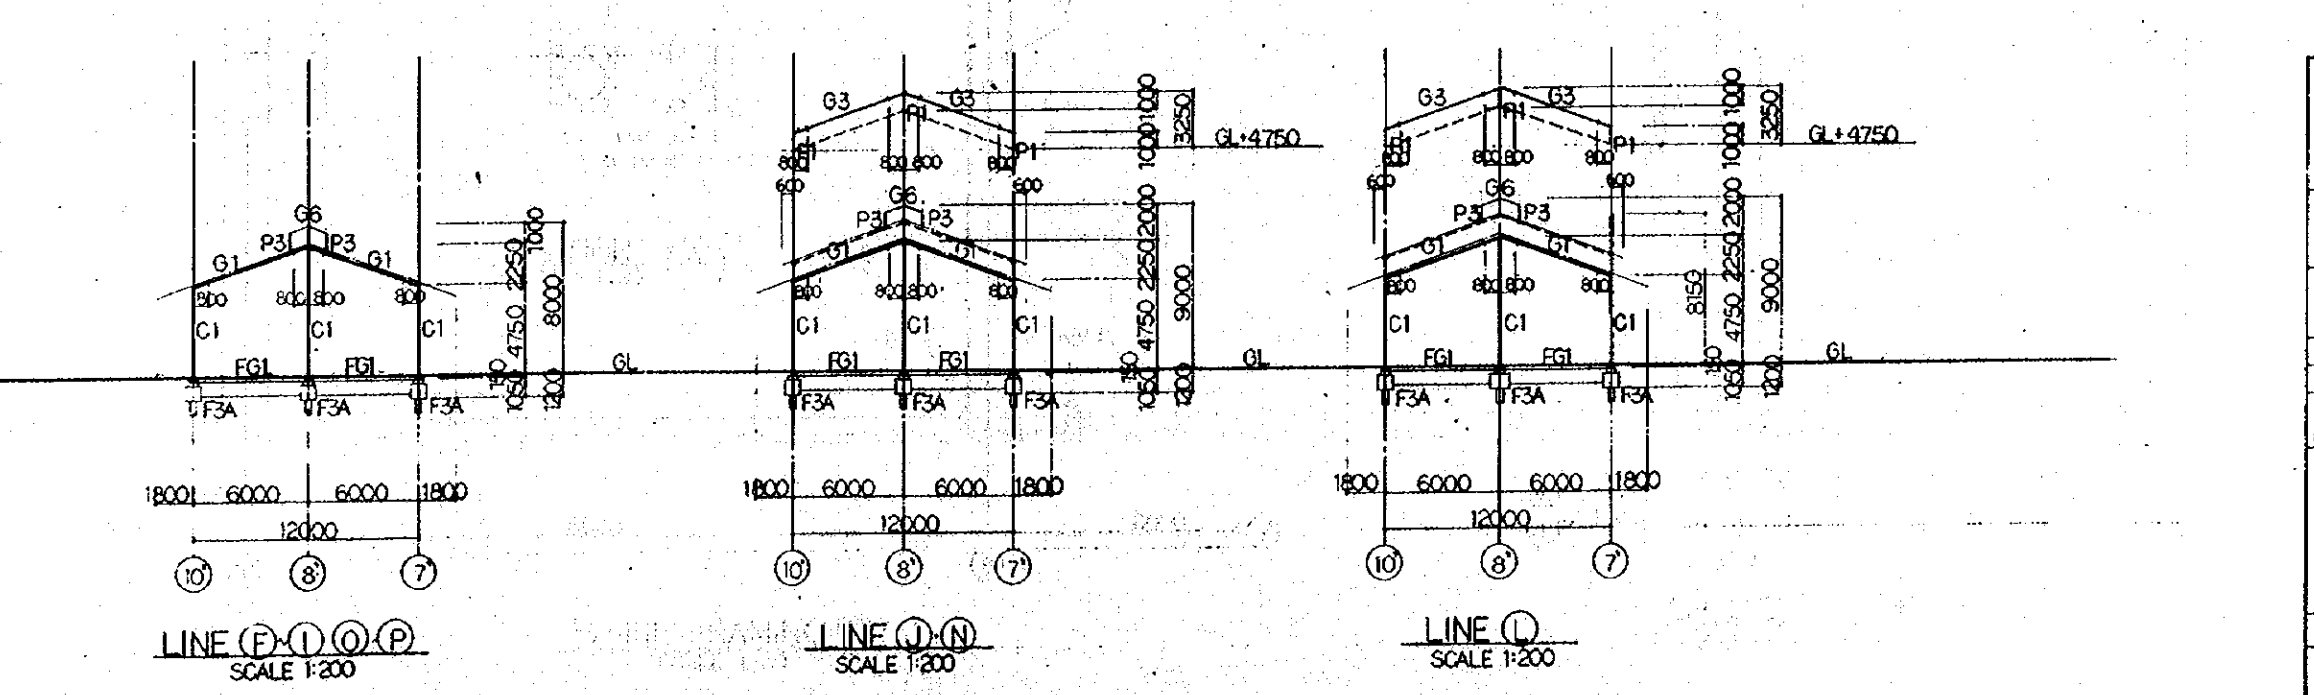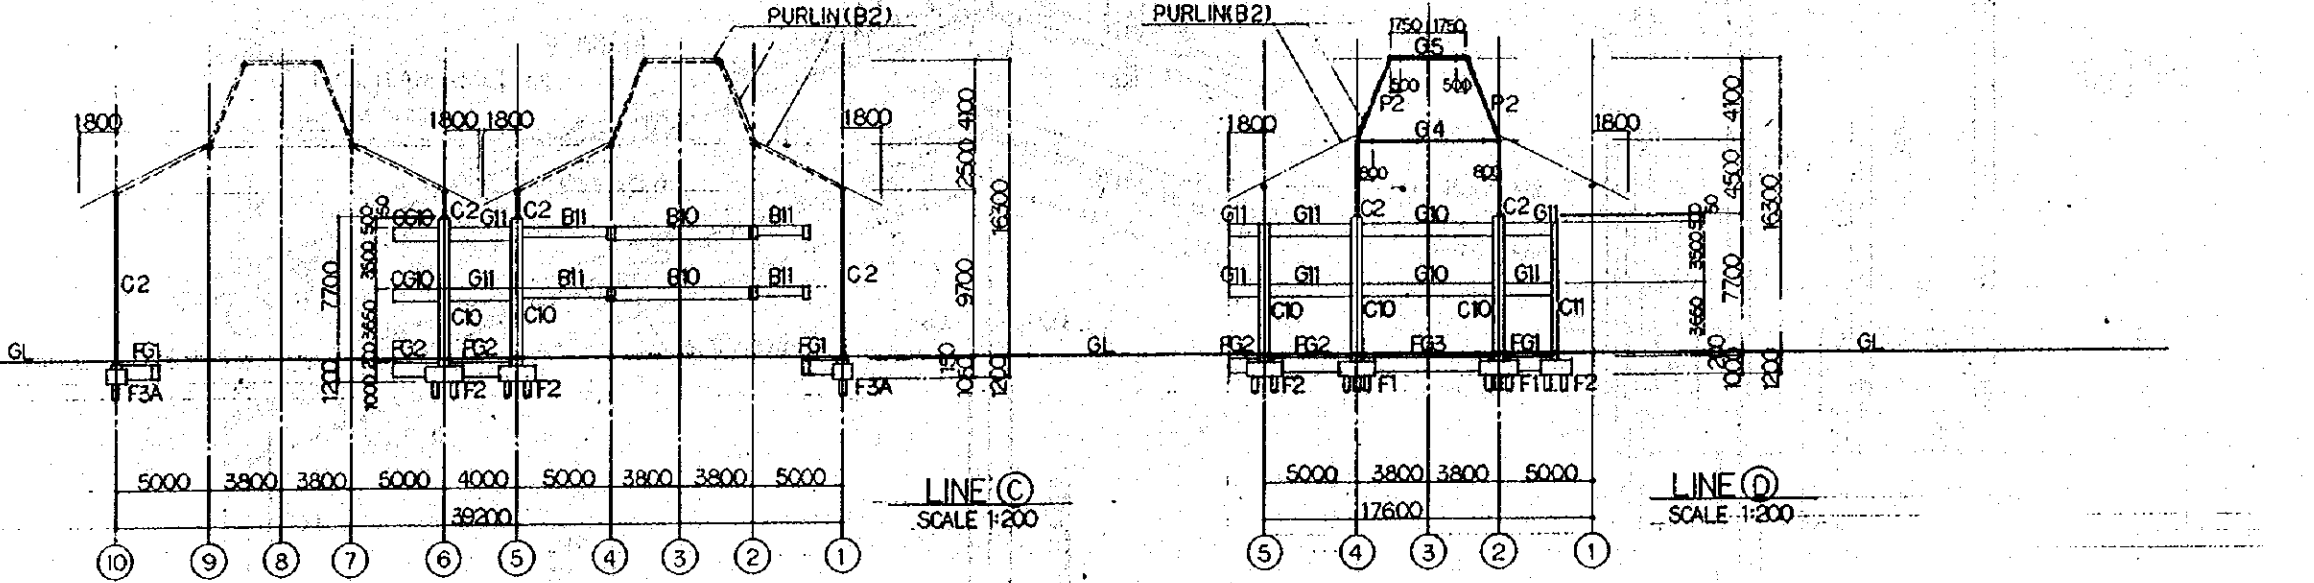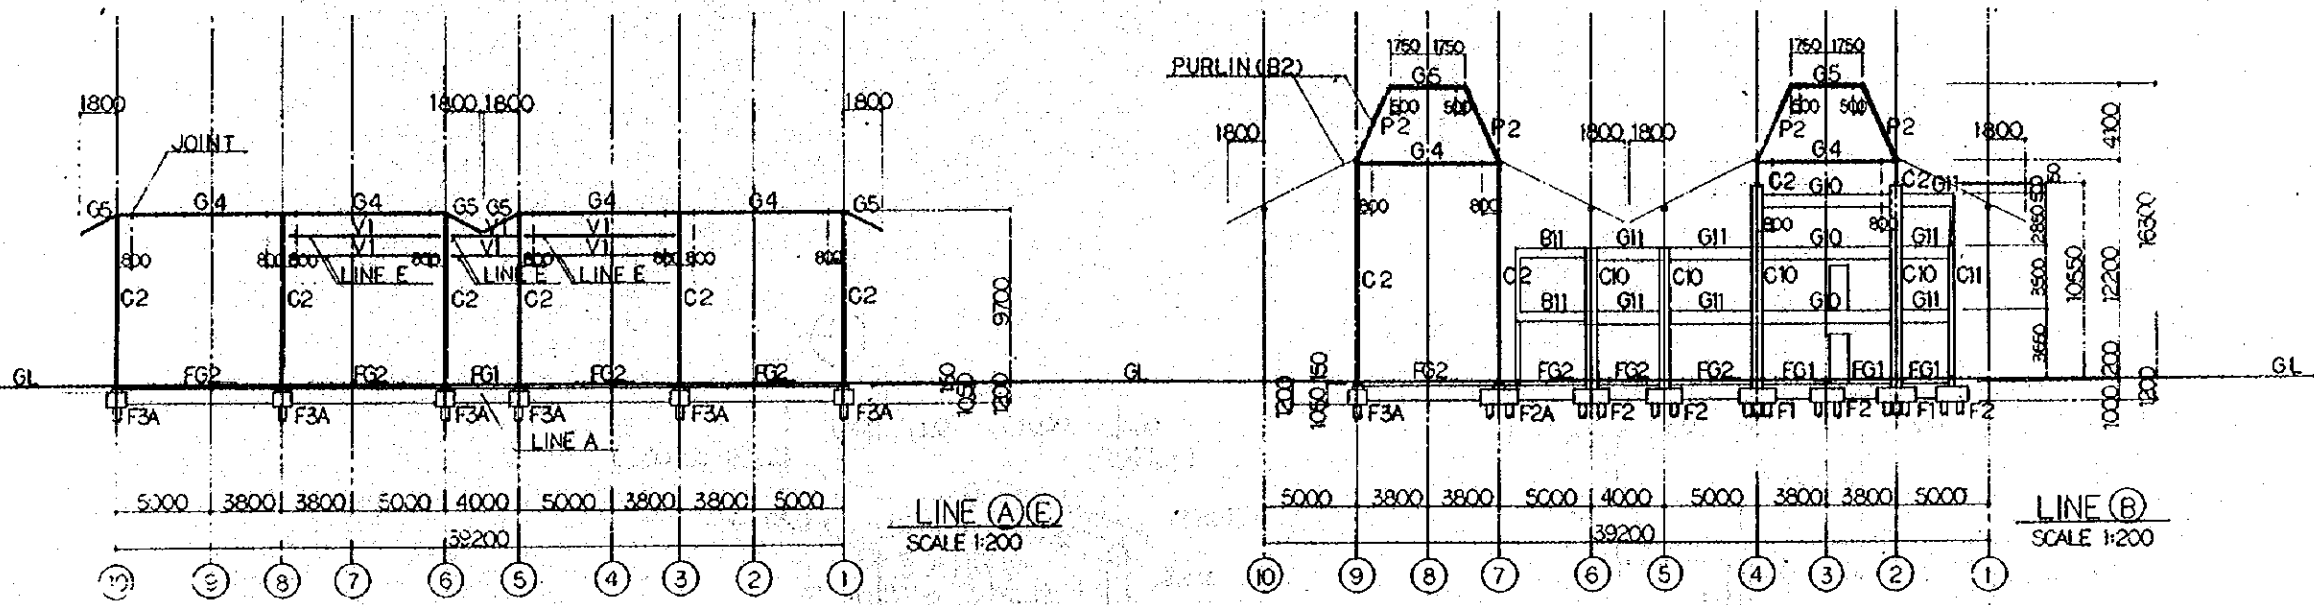

REPUBLIC OF INDONESIA MINISTRY OF COMMUNICATIONS DIRECTORATE GENERAL OF LAND TRANSPORT AND INLAND WATERWAYS					
NEW RAILWAY LINE FOR CENGKARENG AIRPORT CONSTRUCTION PROJECT					
JAPAN INTERNATIONAL COOPERATION AGENCY (JICA)					
REVISIONS	DATE	DESIGNED	DRAWN	CHECKED	APPROVED
B	1.10.89	[Signature]	[Signature]	[Signature]	[Signature]
A	12.12.88	[Signature]	[Signature]	[Signature]	[Signature]
AIRPORT TERMINAL STATION FRAMING ELEVATION (SHEET 2 OF 2)					
PACKAGE: I CIVIL AND ARCHITECTURAL WORK					
SCALE: 1:200		DRAWING NO: AS - 008			

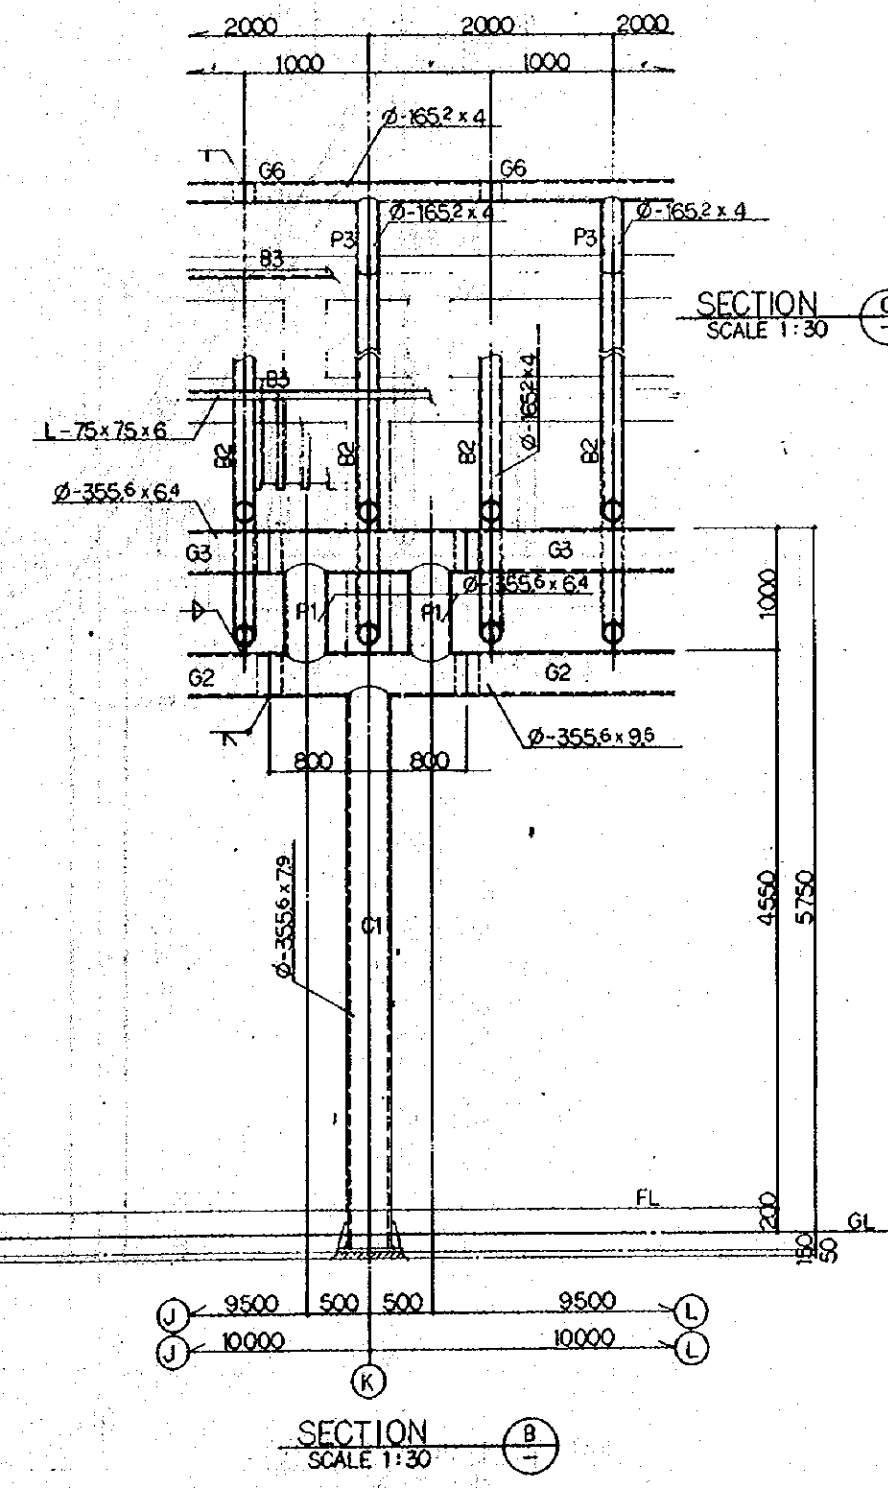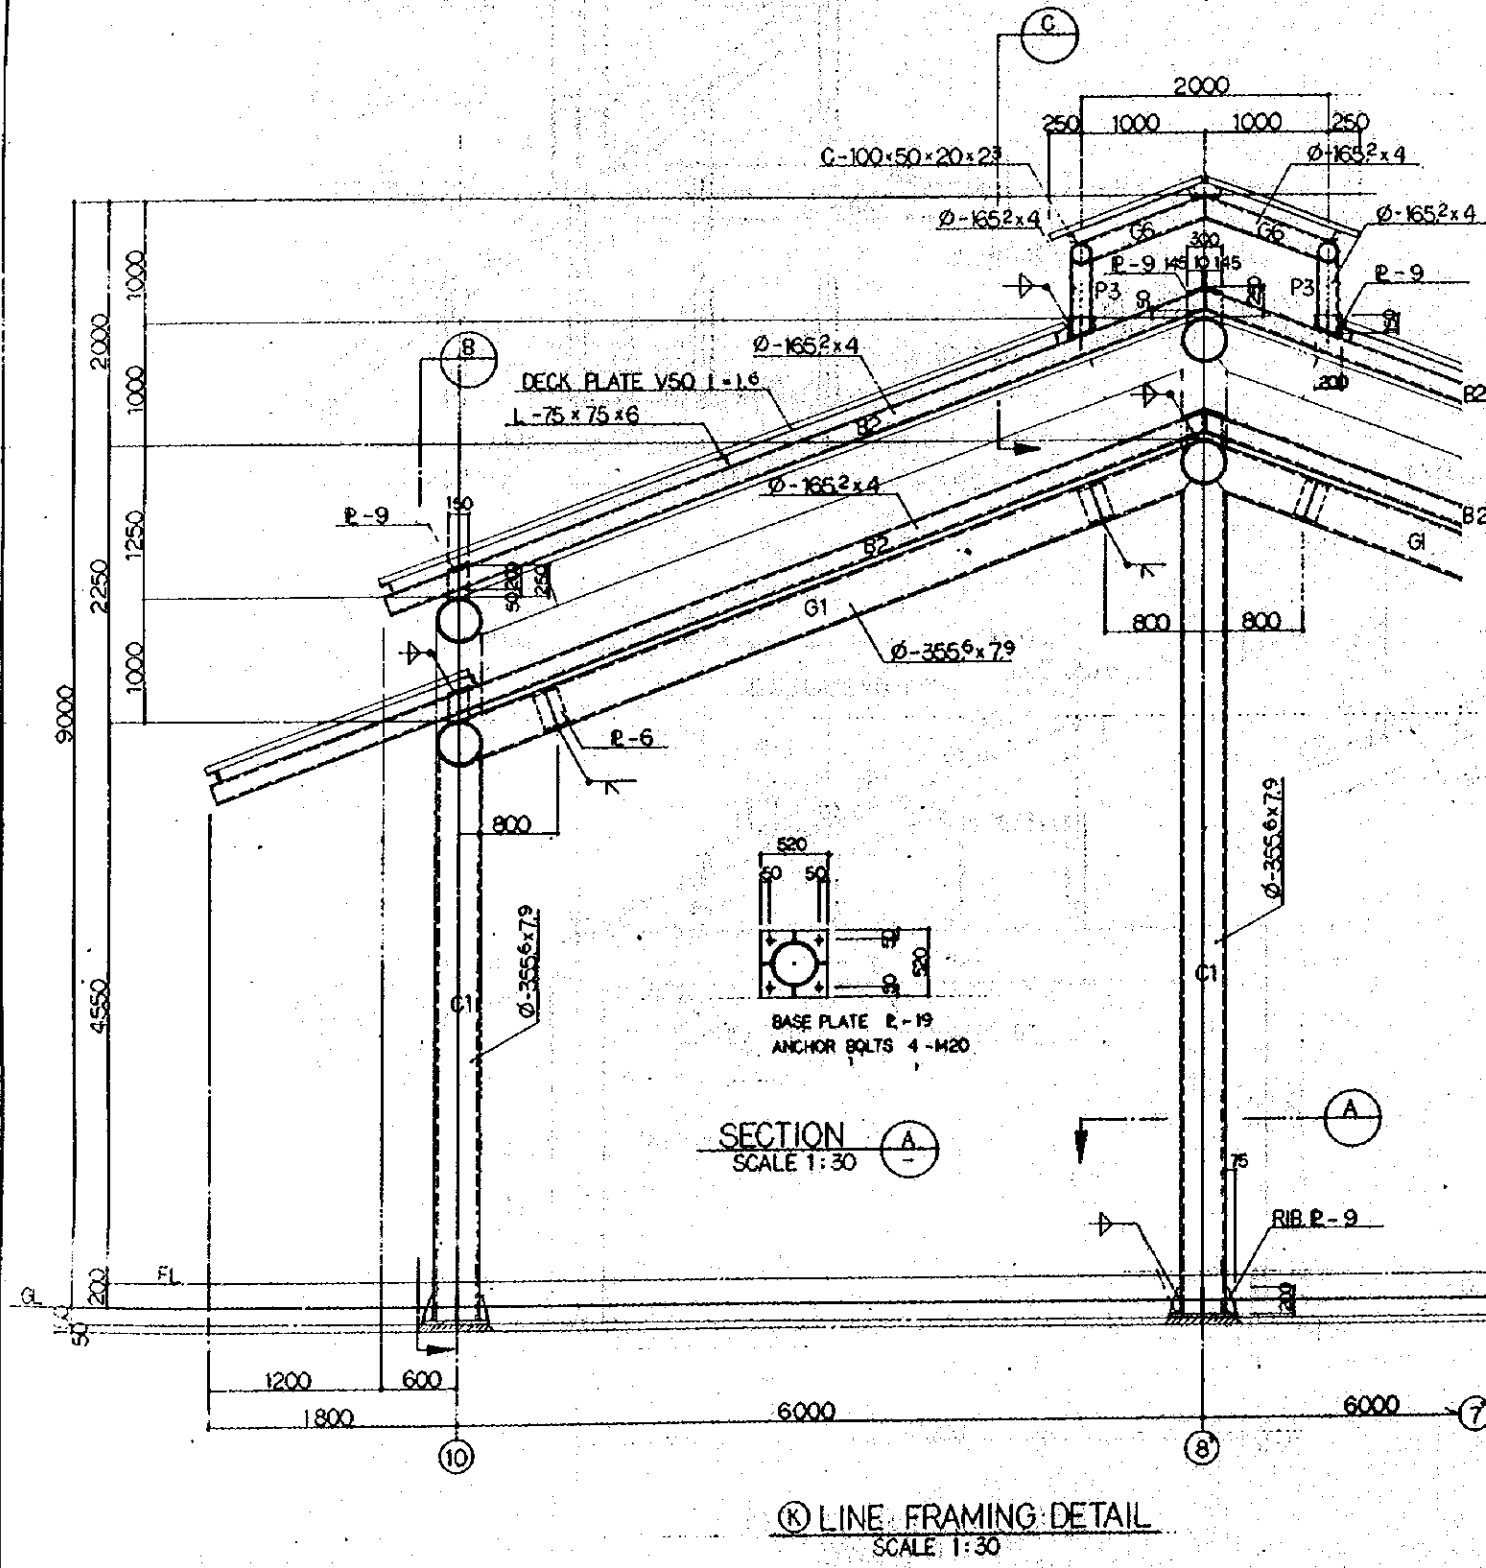


REPUBLIC OF INDONESIA MINISTRY OF COMMUNICATIONS DIRECTORATE GENERAL OF LAND TRANSPORT AND INLAND WATERWAYS					
NEW RAILWAY LINE FOR CENKARENG AIRPORT CONSTRUCTION PROJECT					
JAPAN INTERNATIONAL COOPERATION AGENCY (JICA)					
REVISIONS	DATE	DESIGNED	CHECKED	REVISED	SUBMITTED
B	1/24/98	AK	AK	AK	AK
A	1/24/98	AK	AK	AK	AK
AIRPORT TERMINAL STATION FRAMING DETAIL (SHEET 1 OF 4)					
PACKAGE: I CIVIL AND ARCHITECTURAL WORK					
SCALE	DRAWING NO.				
1:30	AS - 009				

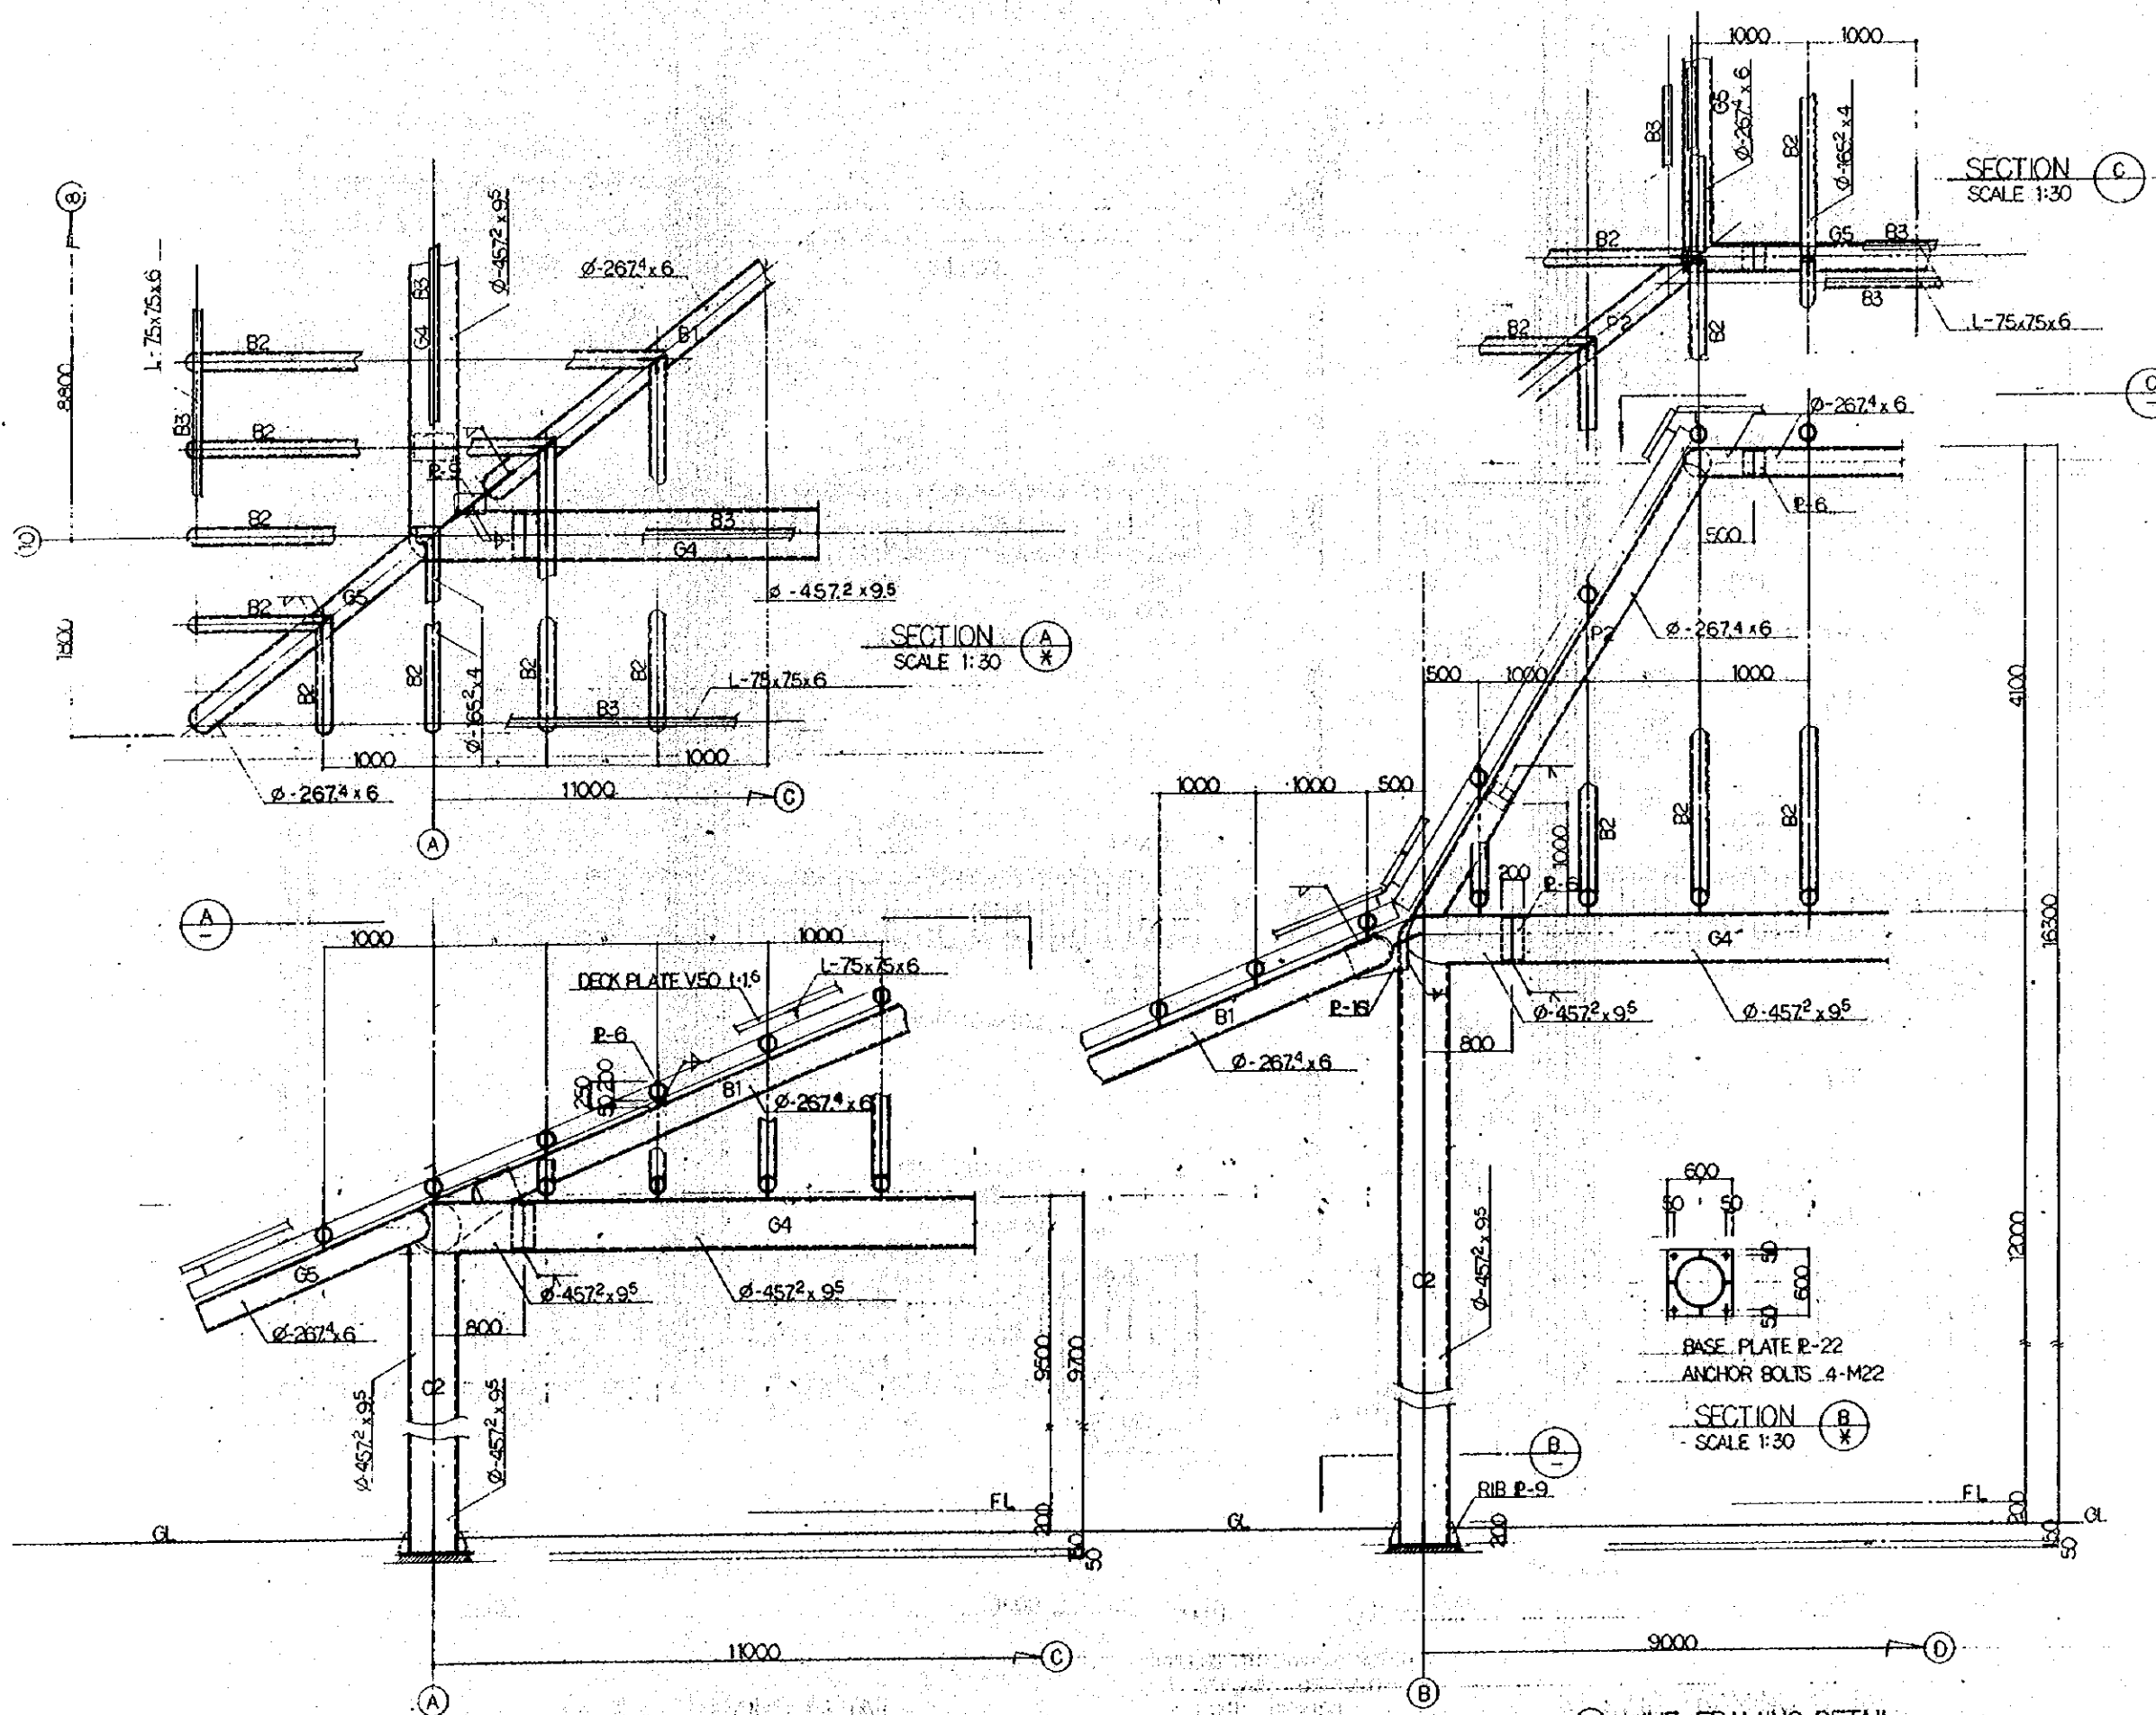

⑩ LINE FRAMING DETAIL
SCALE 1:30

⑨ LINE FRAMING DETAIL
SCALE 1:30

REPUBLIC OF INDONESIA MINISTRY OF COMMUNICATIONS DIRECTORATE GENERAL OF LAND TRANSPORT AND INLAND WATERWAYS						
NEW RAILWAY LINE FOR GENGKARENG AIRPORT CONSTRUCTION PROJECT						
JAPAN INTERNATIONAL COOPERATION AGENCY (JICA)						
REVISION	DATE	DESIGNED	DRAWN	CHECKED	REVIEWED	SUBMITTED
B	10/09/09	[Signature]	[Signature]	[Signature]	[Signature]	[Signature]
A	10/08/09	[Signature]	[Signature]	[Signature]	[Signature]	[Signature]
AIRPORT TERMINAL STATION FRAMING DETAIL (SHEET 2 OF 4)						
PACKAGE: I CIVIL AND ARCHITECTURAL WORK						
SCALE	DRAWING NO.					
1:30	AS - 010					

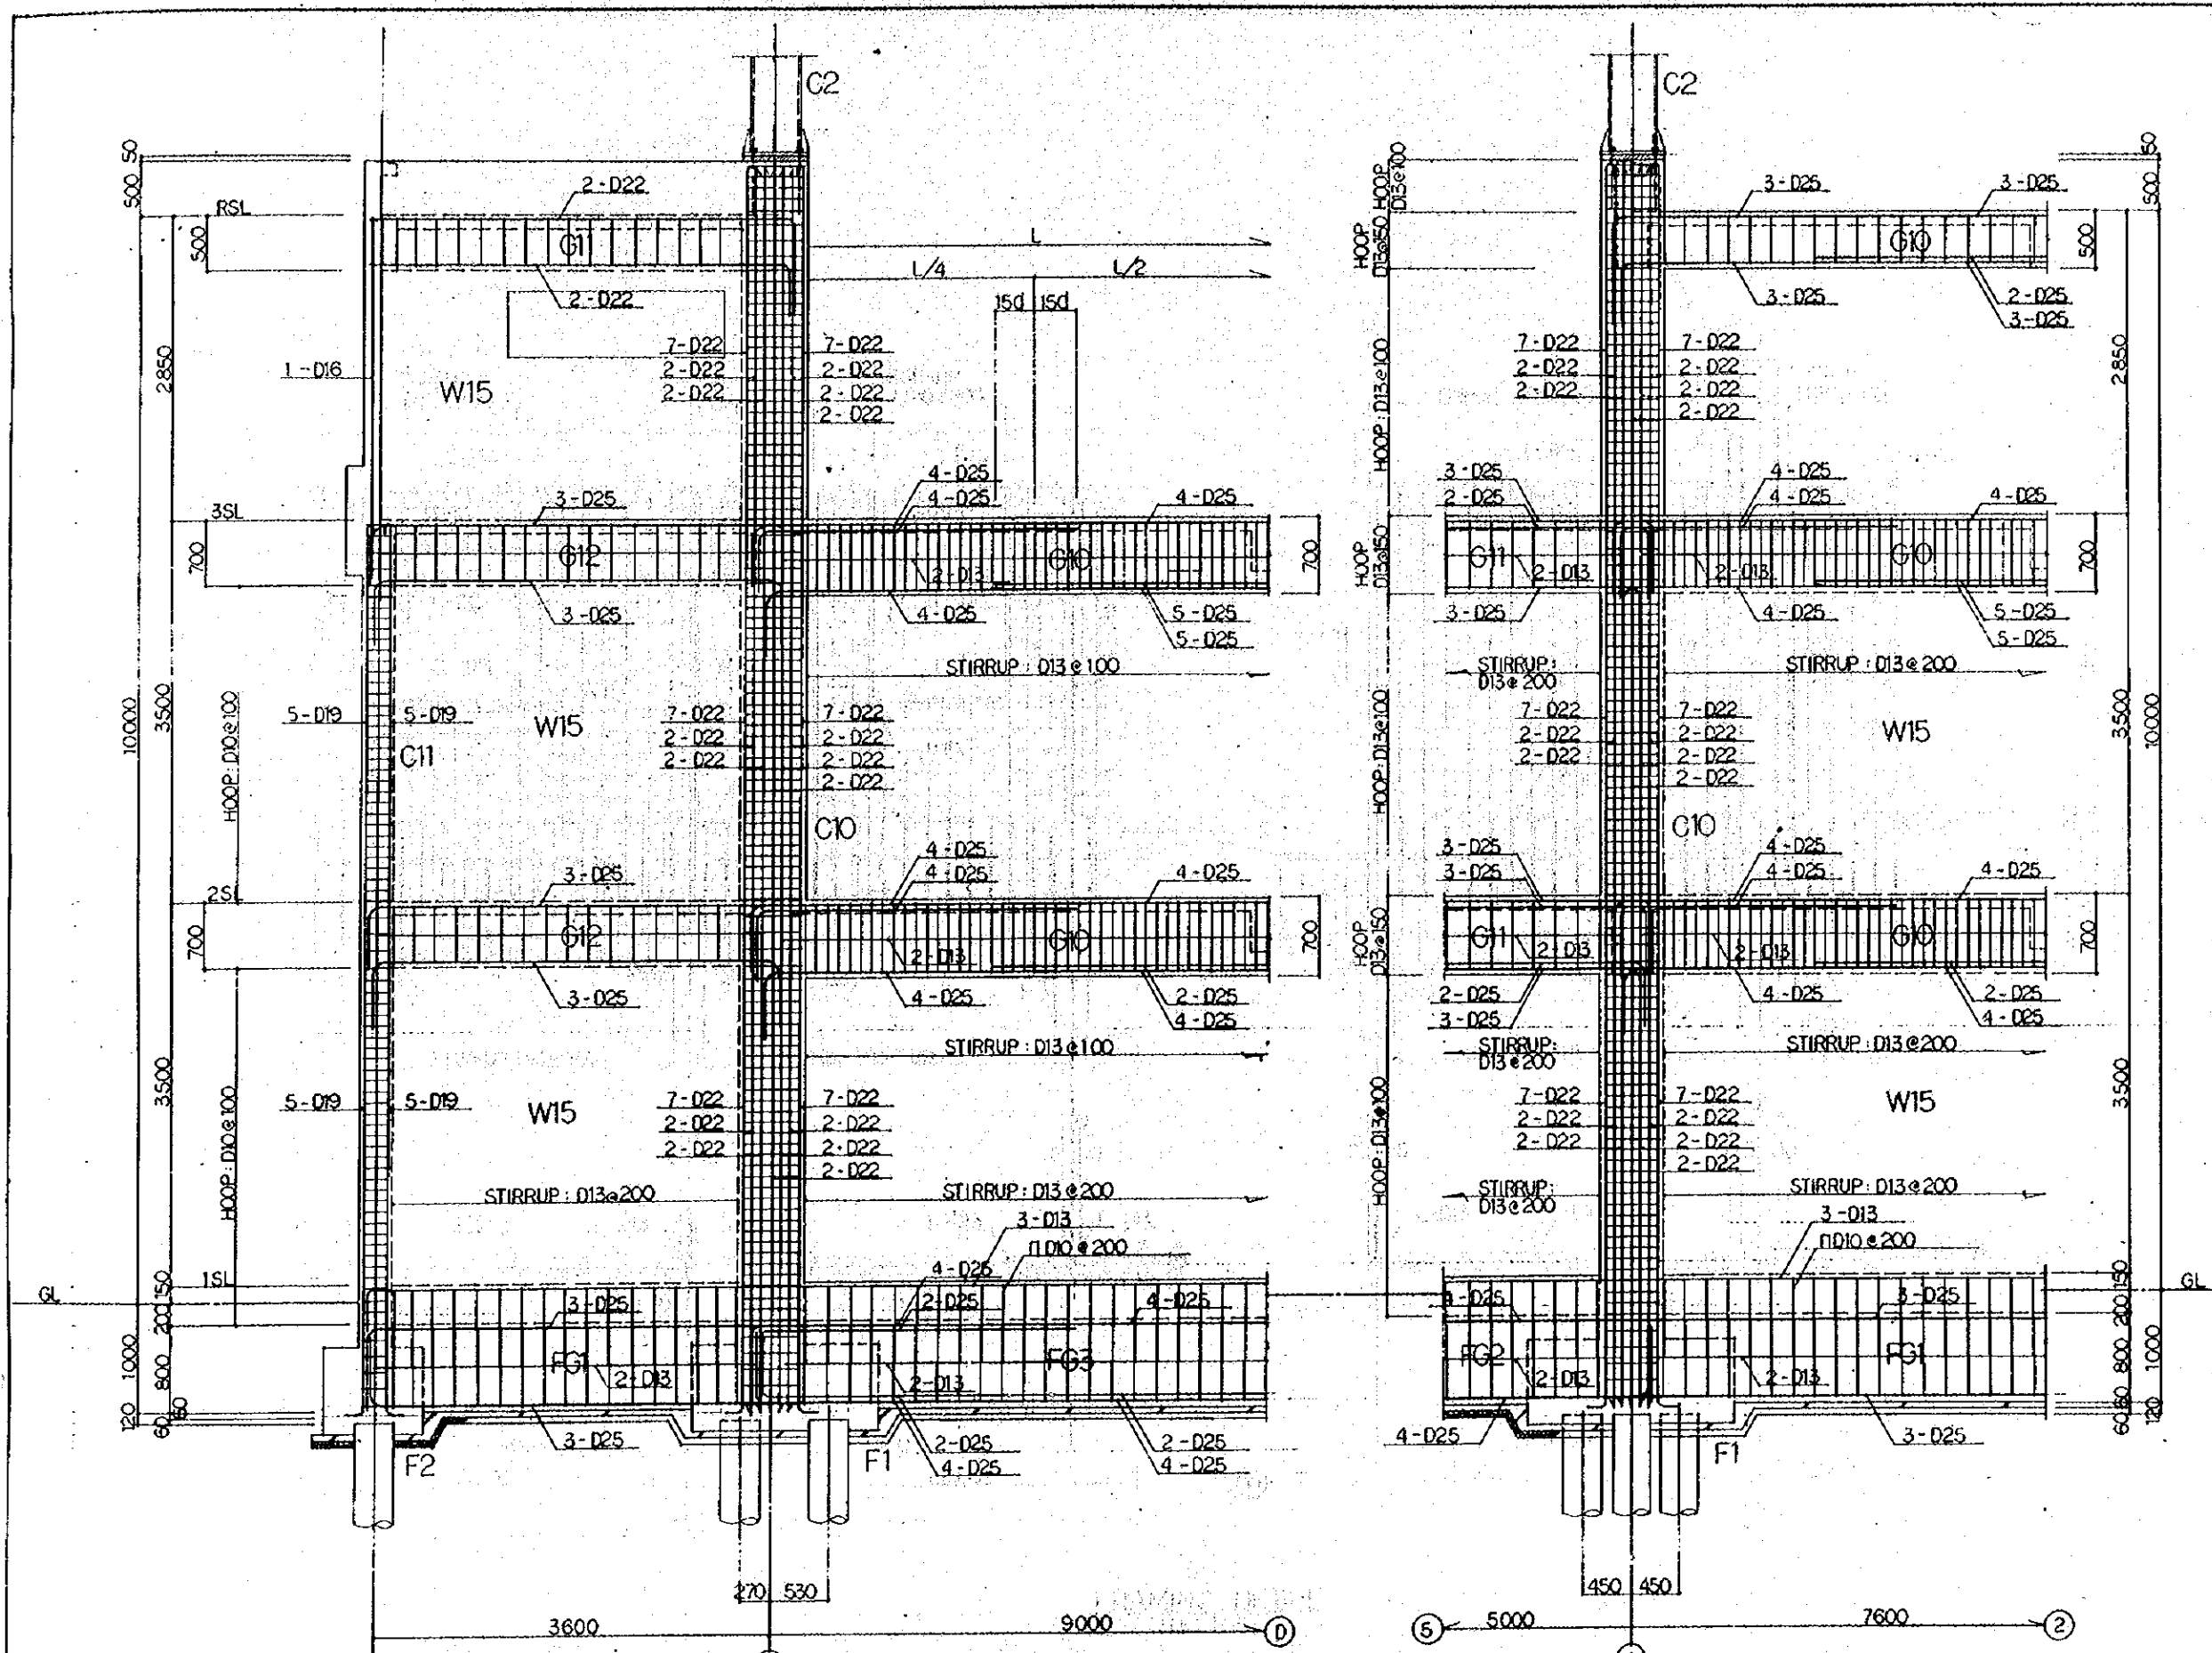

(A) LINE FRAMING DETAIL
SCALE: 1:30

UNLESS OTHERWISE NOTED
 1. STIRRUP: D10@200
 2. HOOP: D10@150
 3. WEB BAR: 2-D10

(B) LINE FRAMING DETAIL
SCALE: 1:30

REPUBLIC OF INDONESIA
 MINISTRY OF COMMUNICATIONS
 DIRECTORATE GENERAL OF LAND TRANSPORT
 AND INLAND WATERWAYS


NEW RAILWAY LINE FOR CENGKARENG AIRPORT
 CONSTRUCTION PROJECT

JAPAN INTERNATIONAL COOPERATION AGENCY
 (JICA)

REVISIONS	DATE	REASON	DESIGN	CHECKED	REVIEWED	SUBMITTED
B	1 AUG 99	AM	HM	SM	KM	IK
A	15 FEB 99	AM	HM	SM	KM	IK


AIRPORT TERMINAL STATION
 FRAMING DETAIL
 (SHEET 3 OF 4)

PACKAGE: 1 CIVIL AND ARCHITECTURAL WORK
 SCALE: 1:30 DRAWING NO: AS - 011

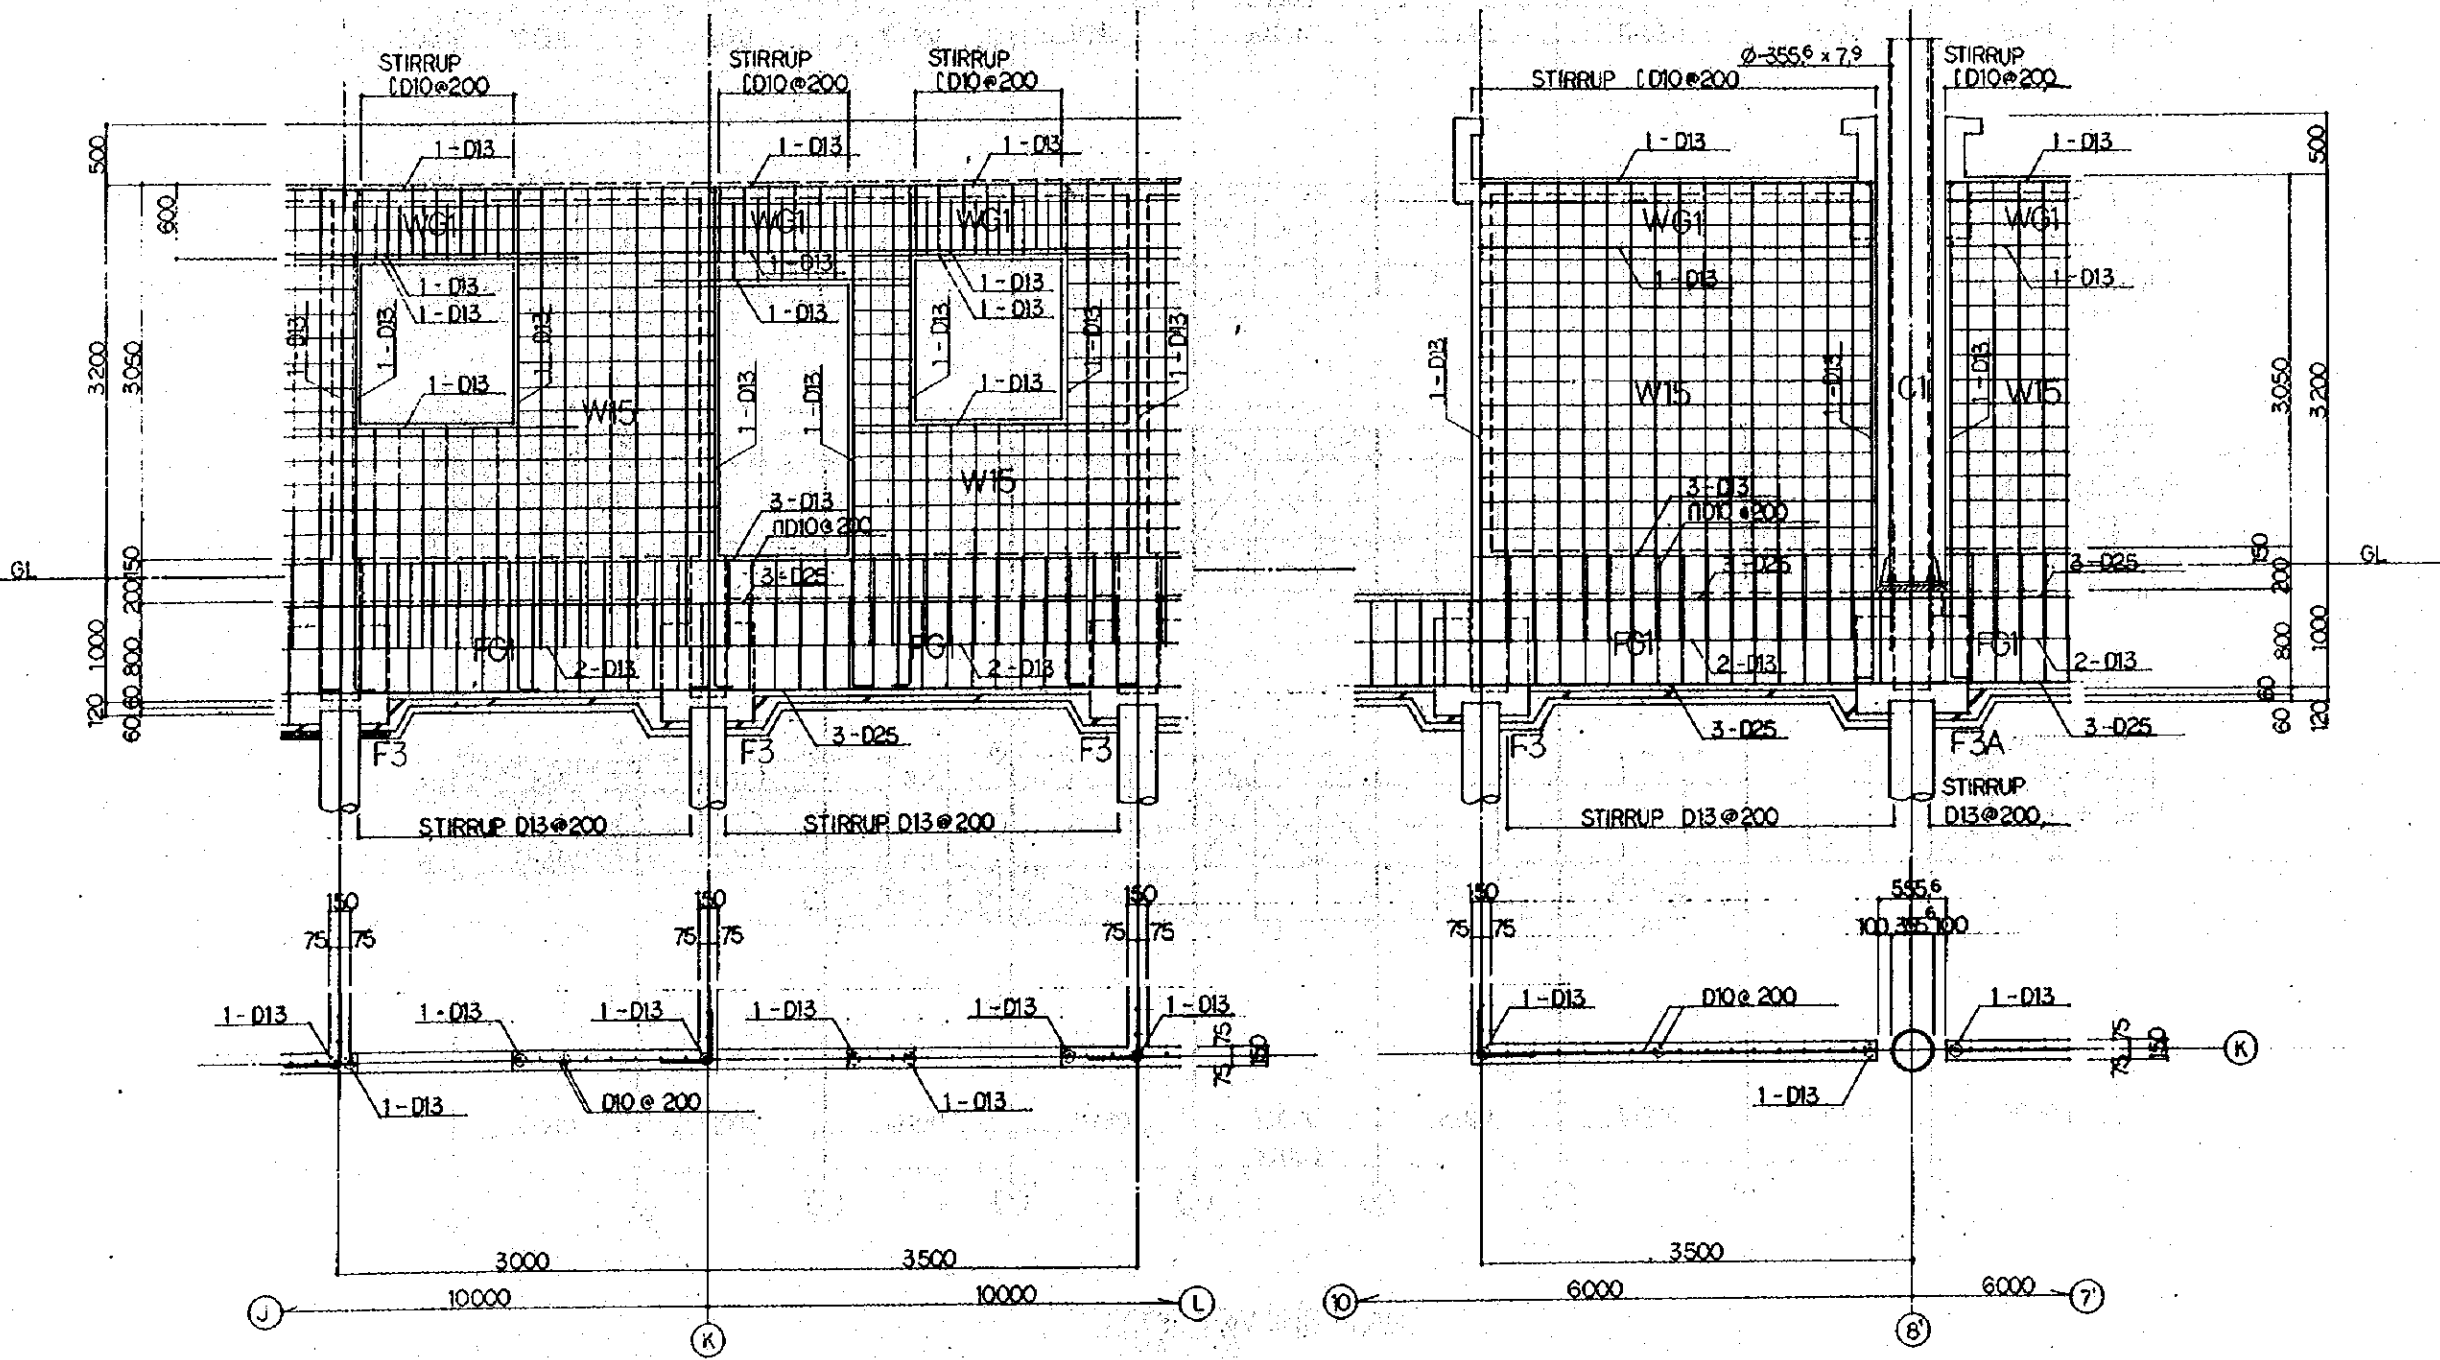

FRAMING DETAIL
SCALE 1:30


REPUBLIC OF INDONESIA MINISTRY OF COMMUNICATIONS DIRECTORATE GENERAL OF LAND TRANSPORT AND INLAND WATERWAYS					
NEW RAILWAY LINE FOR CENKARENG AIRPORT CONSTRUCTION PROJECT					
JAPAN INTERNATIONAL COOPERATION AGENCY (JICA)					
REVISIONS	DATE	DESIGNED	DRAWN	CHECKED	SUBMITTED
B	1 AUG 2012	H.M.	S.P.	K.M.	M.K.
A	15 FEB 2012	H.M.	S.P.	K.M.	M.K.
AIRPORT TERMINAL STATION FRAMING DETAIL (SHEET 4 OF 4)					
PROGRAM: I CIVIL AND ARCHITECTURAL WORK					
SCALE	DRAWING NO.				
1:30	AS - 012				

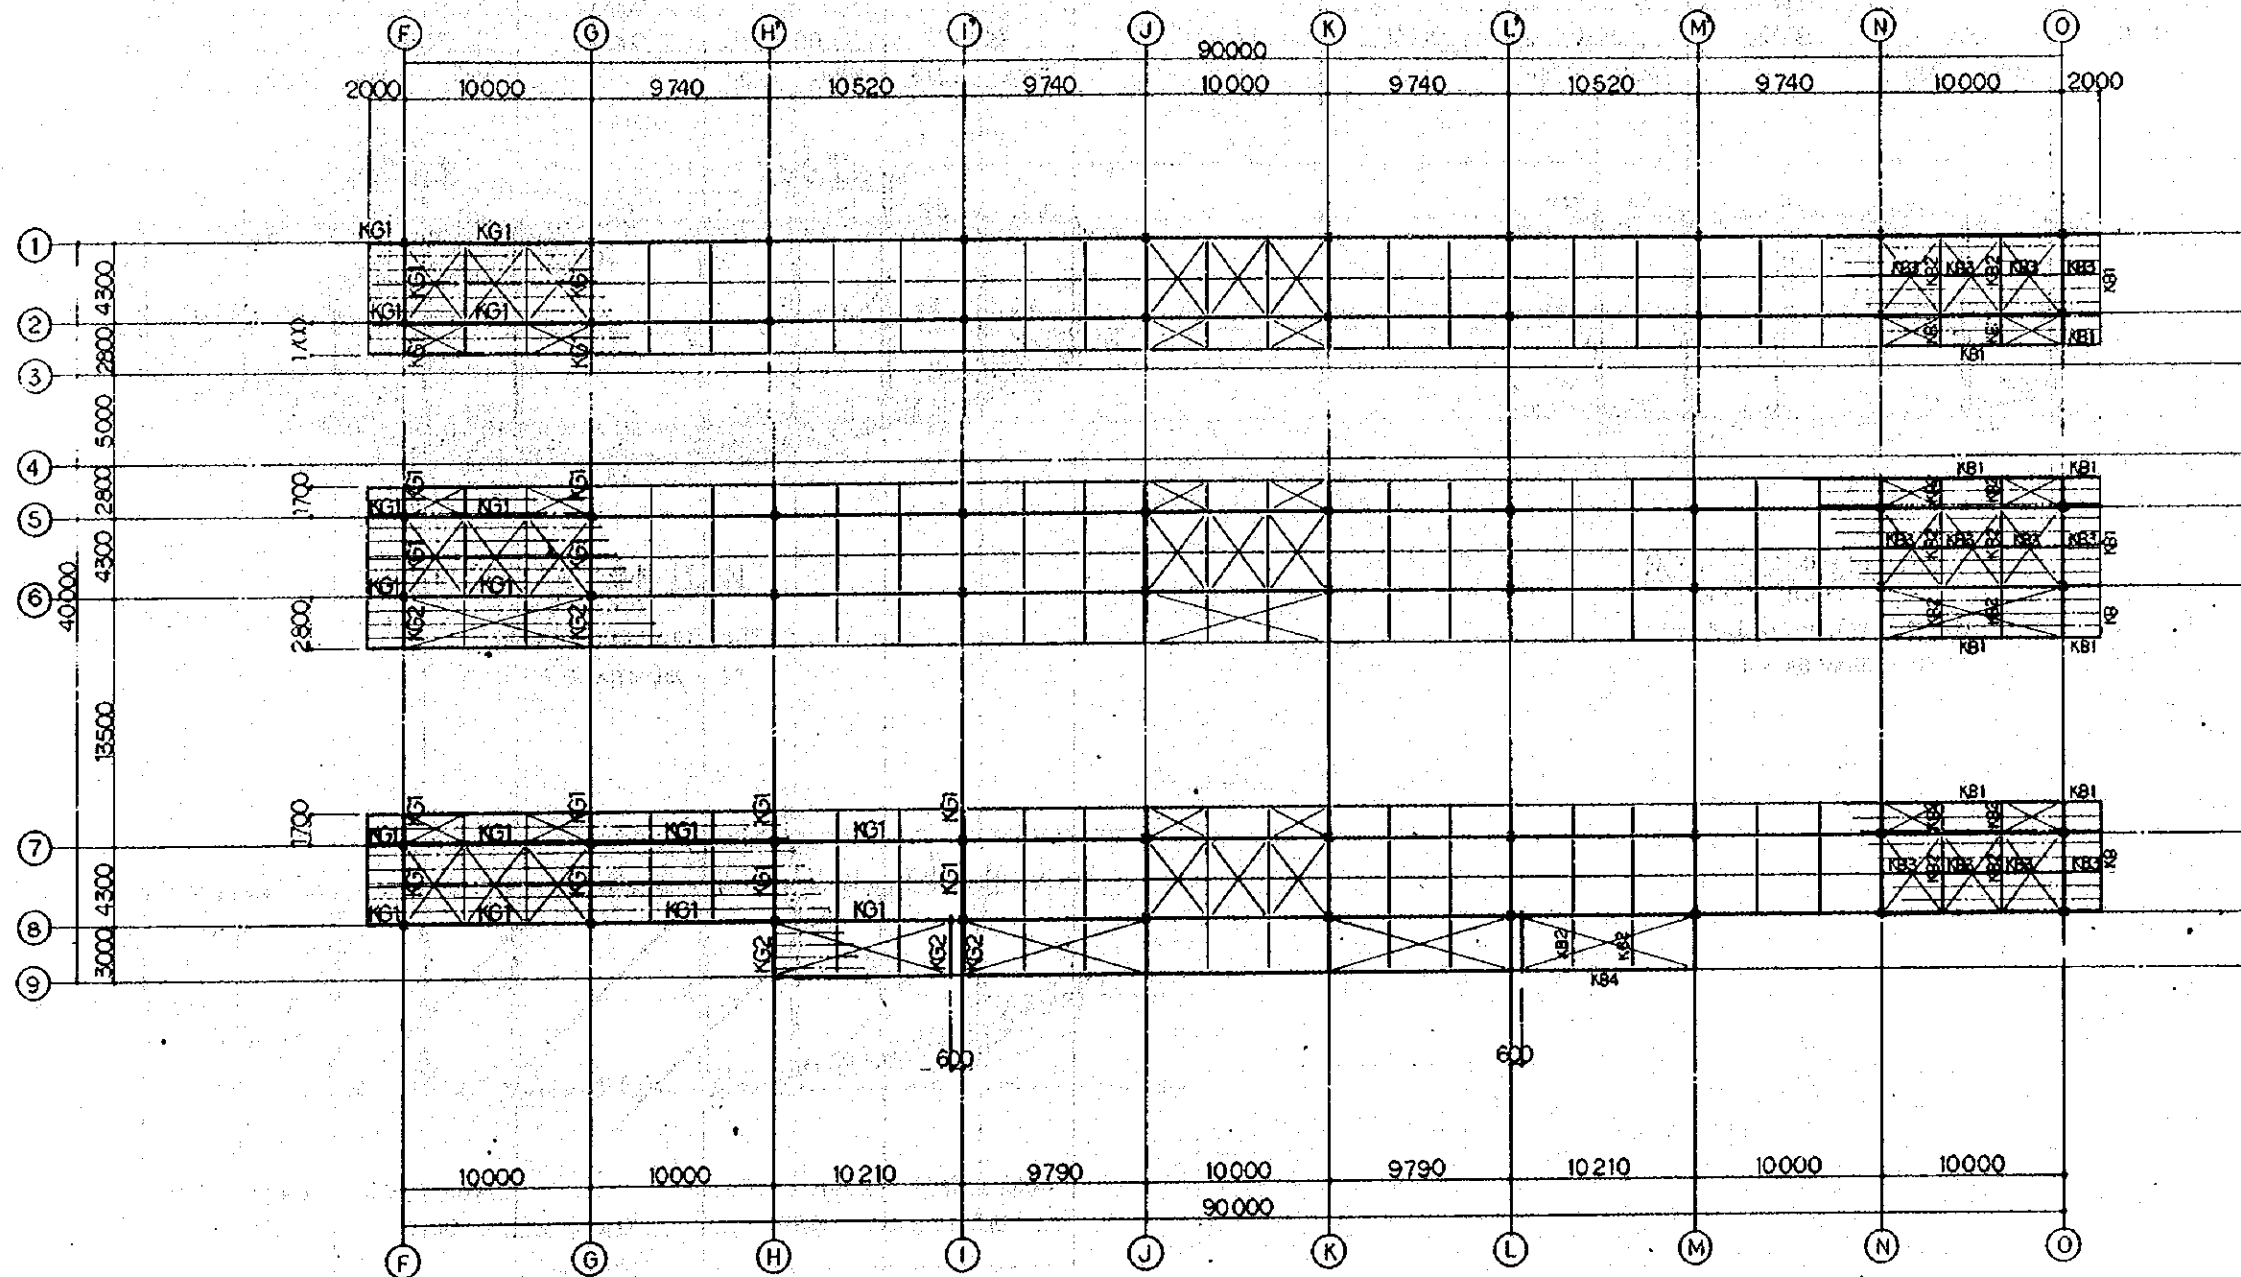


ROOF FRAMING PLAN
SCALE 1:200

UNLESS OTHERWISE NOTED
 1. BRACE : 1-16 Ø
 2. PURLIN : C-100x50x20x2.5 @ 750


REPUBLIC OF INDONESIA MINISTRY OF COMMUNICATIONS DIRECTORATE GENERAL OF LAND TRANSPORT AND INLAND WATERWAYS						
NEW RAILWAY LINE FOR CENGKARENG AIRPORT CONSTRUCTION PROJECT						
JAPAN INTERNATIONAL COOPERATION AGENCY (JICA)						
REVISED	DATE	DESIGNED	DRAWN	CHECKED	REVIEWED	SUBMITTED
B	12.19.89	SK	SK	SK	SK	SK
A	12.22.89	SK	SK	SK	SK	SK
KOTA INTAN STATION ROOF FRAMING PLAN						
PACKAGE: I CIVIL AND ARCHITECTURAL WORK						
SCALE: 1:200		DRAWING NO: AS - 013				

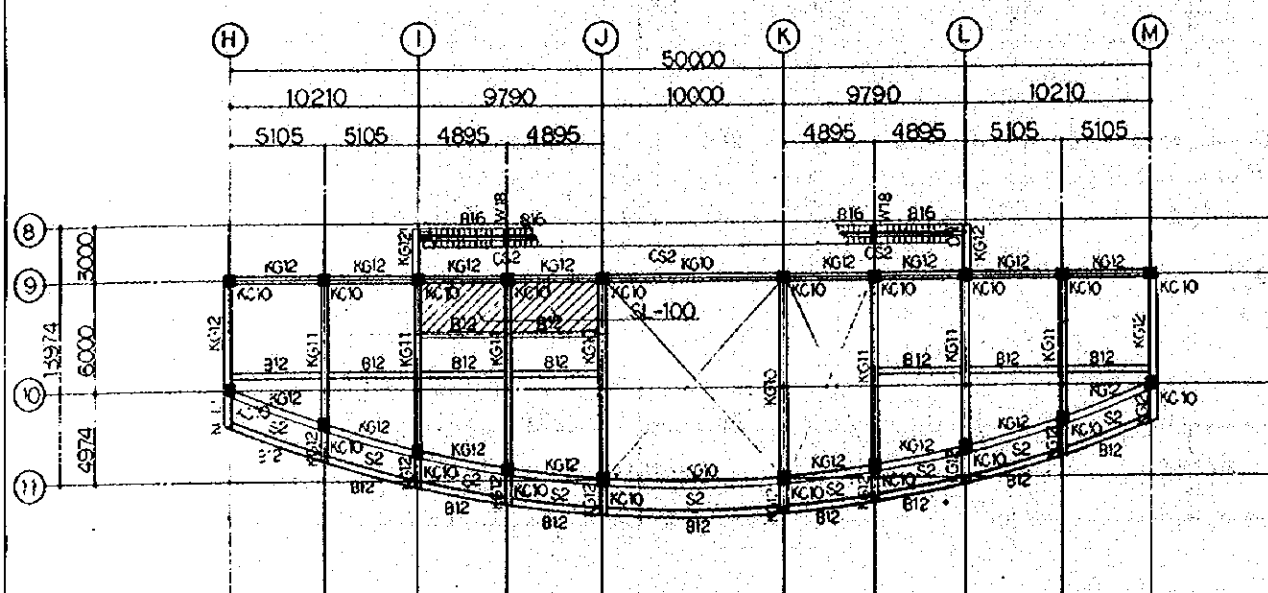

2nd FLOOR FRAMING PLAN
 SCALE 1:200
 UNLESS OTHERWISE NOTED
 1. SLAB MARK : S3

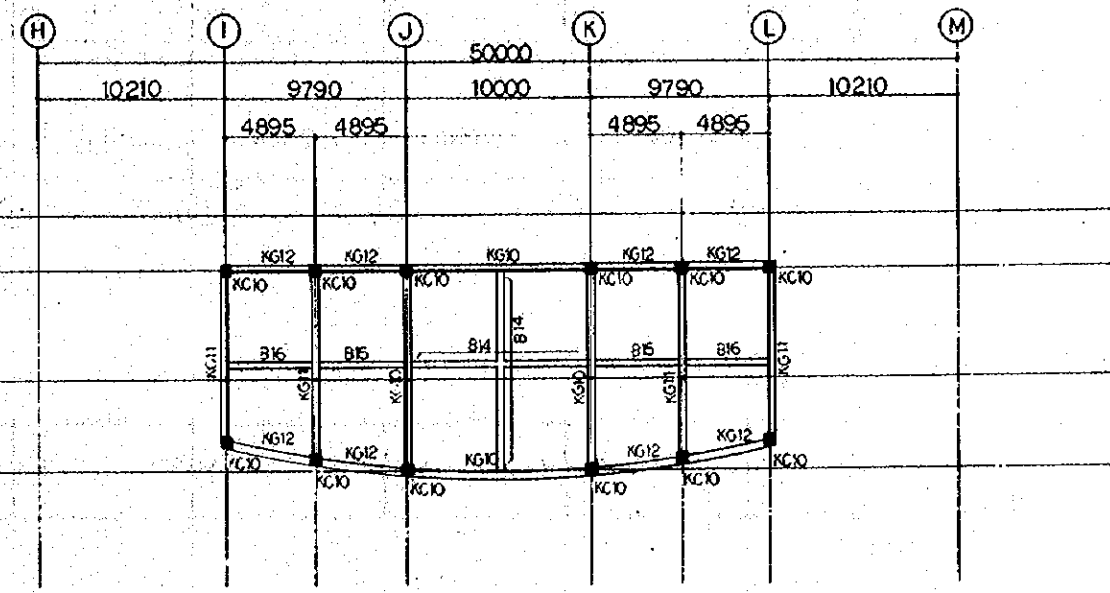


ROOF FRAMING PLAN
 SCALE 1:200
 UNLESS OTHERWISE NOTED
 1. SLAB MARK : S3

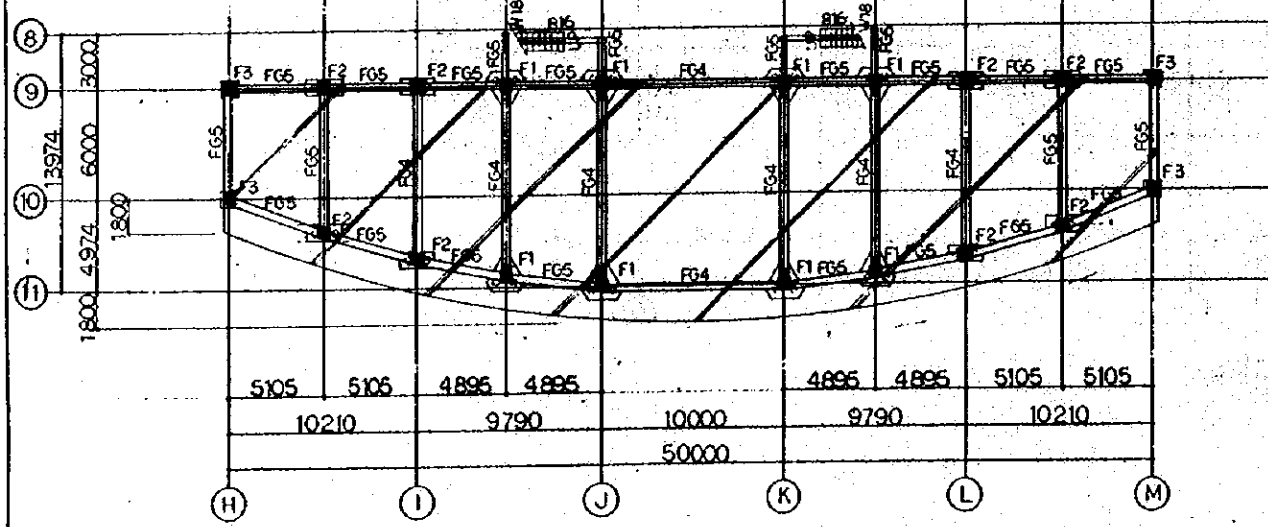


FOUNDATION PLAN
 SCALE 1:200
 NOTE Z1 SHOWS SLAB ON GRADE


REPUBLIC OF INDONESIA MINISTRY OF COMMUNICATIONS DIRECTORATE GENERAL OF LAND TRANSPORT AND INLAND WATERWAYS					
NEW RAILWAY LINE FOR CENGKARENG AIRPORT CONSTRUCTION PROJECT					
JAPAN INTERNATIONAL COOPERATION AGENCY (JICA)					
REVISORS	DATE	REASON	BY	CHECKED	APPROVED
B	1. NOV. 2014	REVISION	PRM	SKM	SKM
A	15. FEB. 2014	REVISION	PRM	SKM	SKM
KOTA INTAN STATION FRAMING PLAN					
PACKAGE: I CIVIL AND ARCHITECTURAL WORK					
SCALE: 1:200		DRAWING NO: AS - 014			

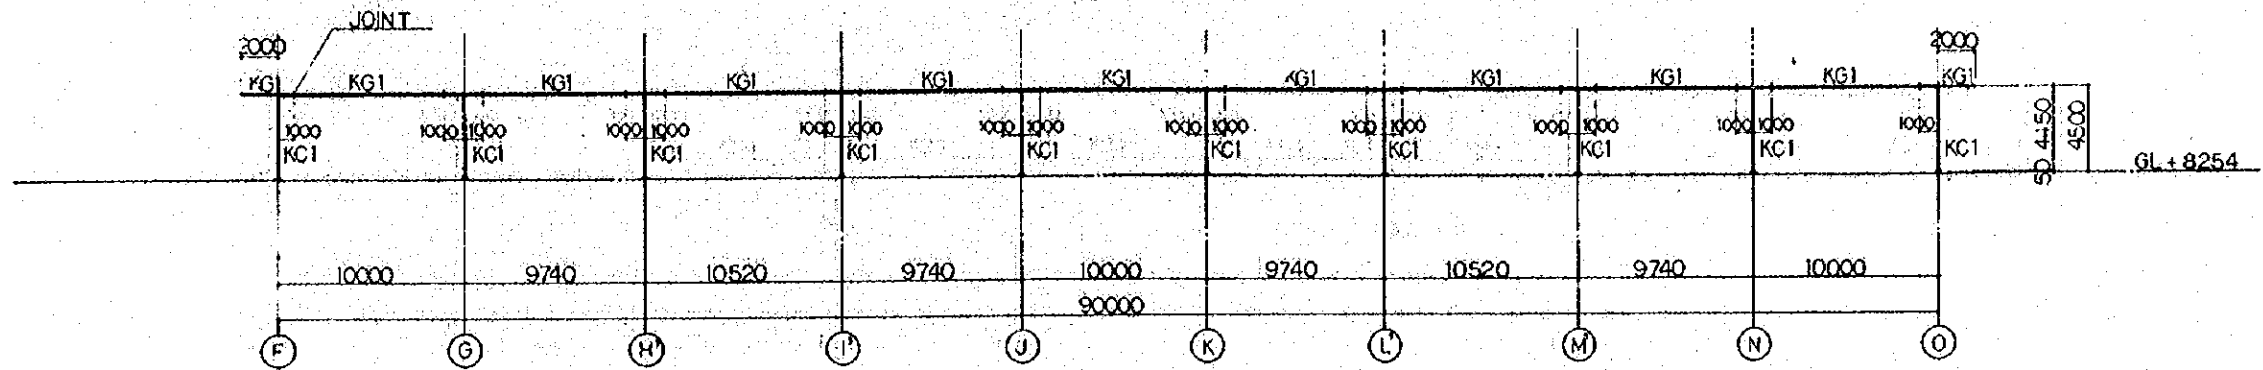


LINE ①
SCALE 1:200

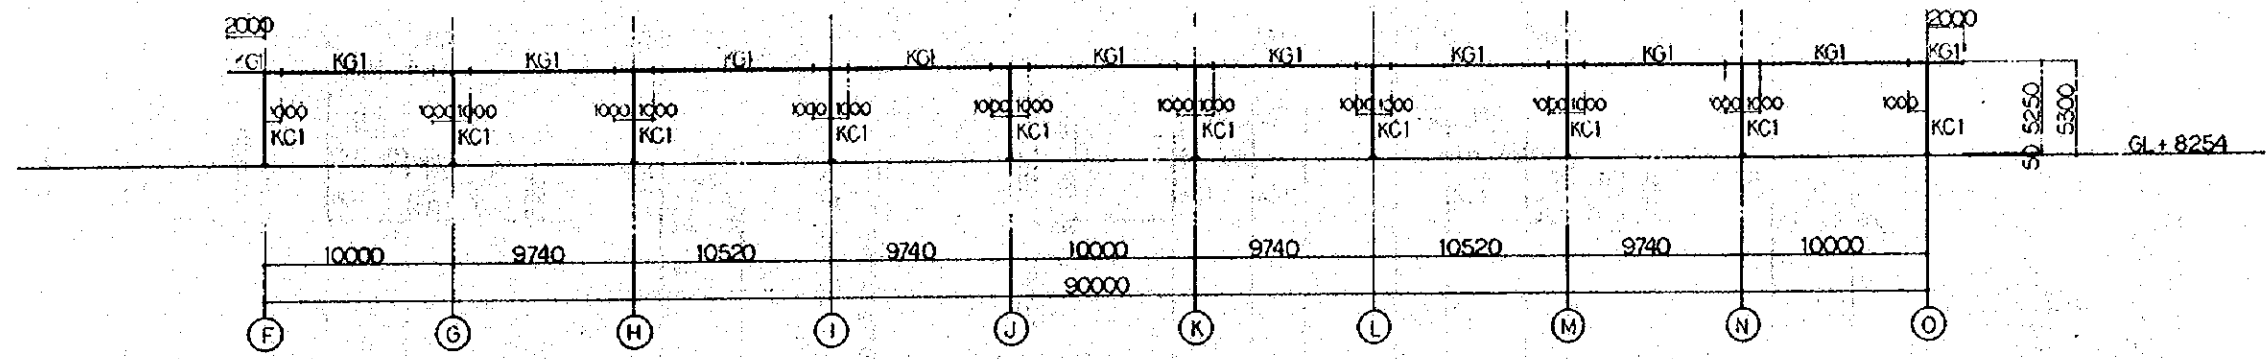

LINE ②
SCALE 1:200

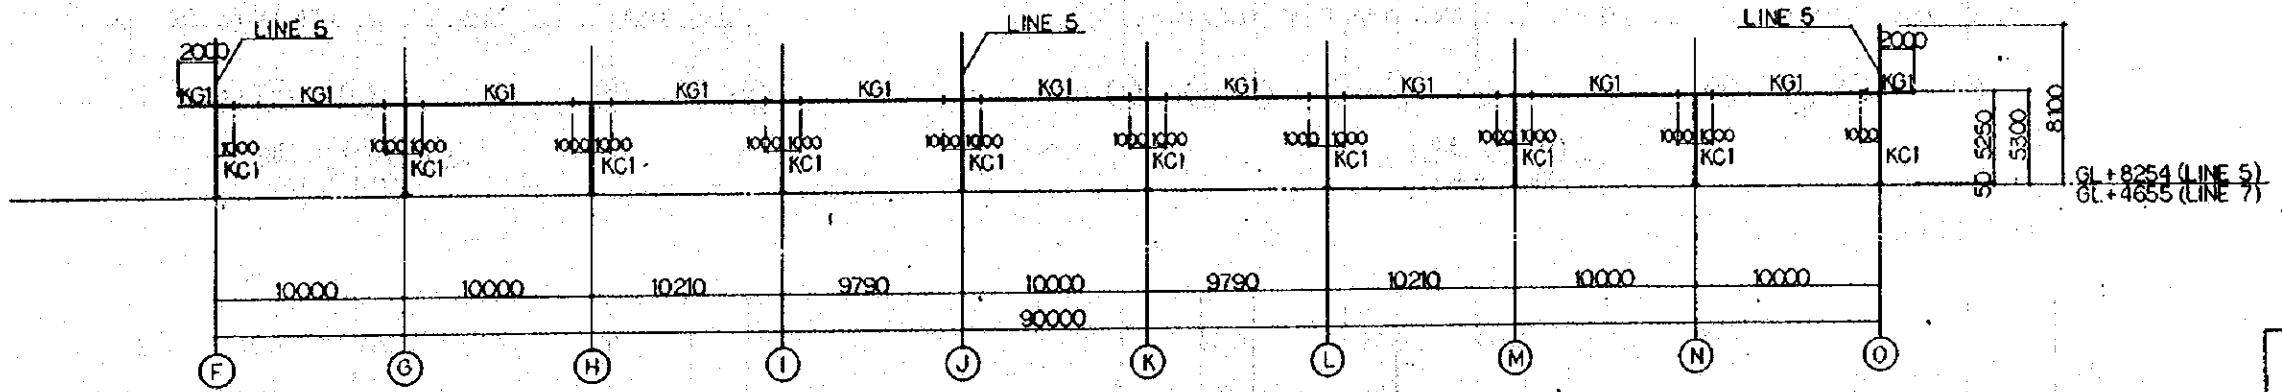


LINE ⑤⑦
SCALE 1:200

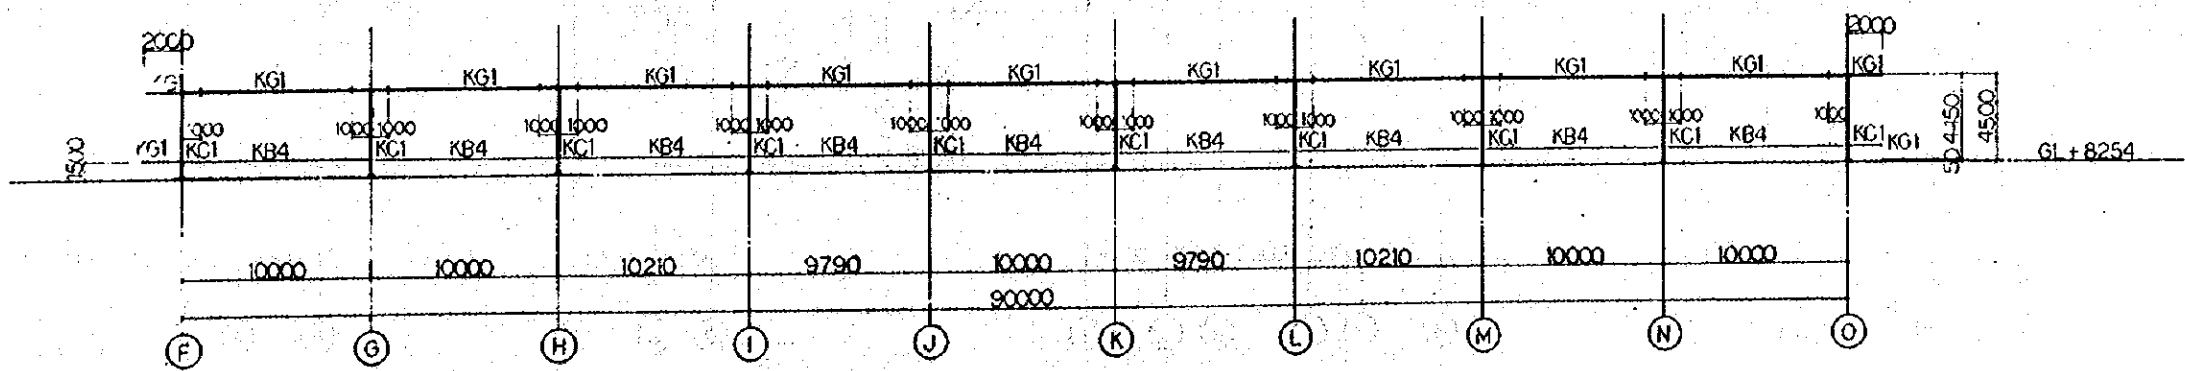


LINE ⑥
SCALE 1:200

REPUBLIC OF INDONESIA MINISTRY OF COMMUNICATIONS DIRECTORATE GENERAL OF LAND TRANSPORT AND INLAND WATERWAYS					
NEW RAILWAY LINE FOR CENGKARENG AIRPORT CONSTRUCTION PROJECT					
JAPAN INTERNATIONAL COOPERATION AGENCY (JICA)					
REVISIONS	DATE	DESIGNED	CHECKED	REVIEWED	SUBMITTED
B	1.08.2014	N.A.	S.M.	K.M.	M.K.
A	10.08.2014	O.A.	S.M.	K.M.	M.K.
KOTA INTAN STATION FRAMING ELEVATION (SHEET 1 OF 2)					
PACKAGE: I CIVIL AND ARCHITECTURAL WORK					
SCALE: 1:200		DRAWING NO: AS - 015.			

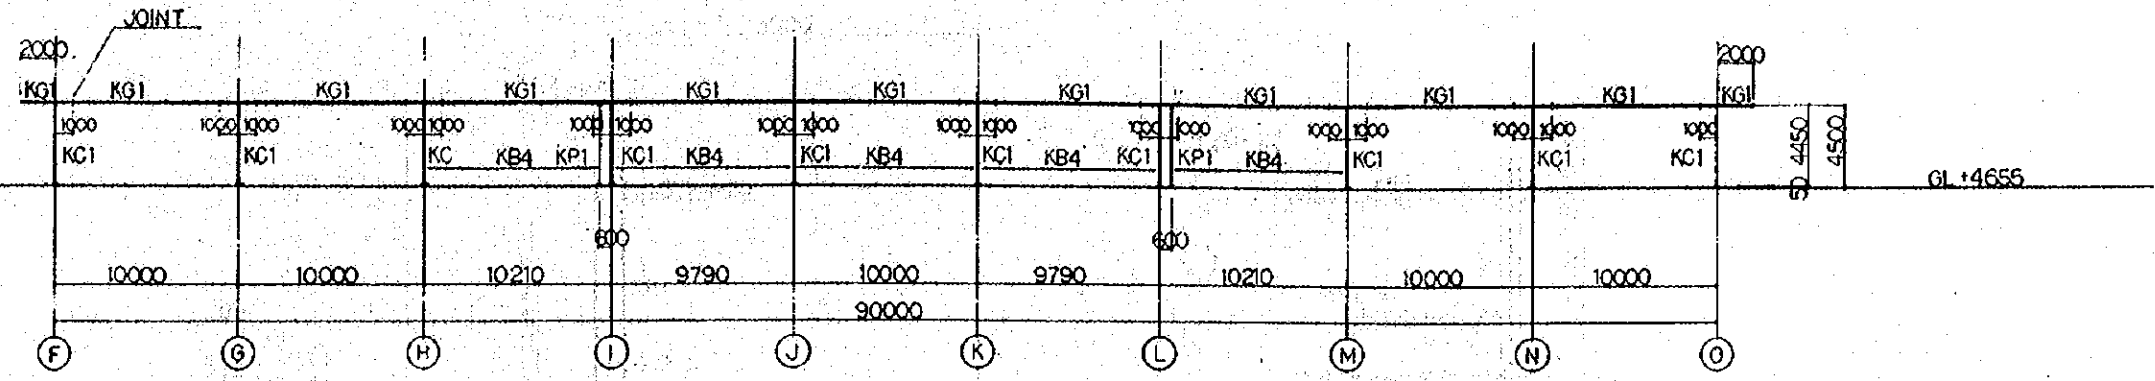


LINE 8
SCALE 1:200

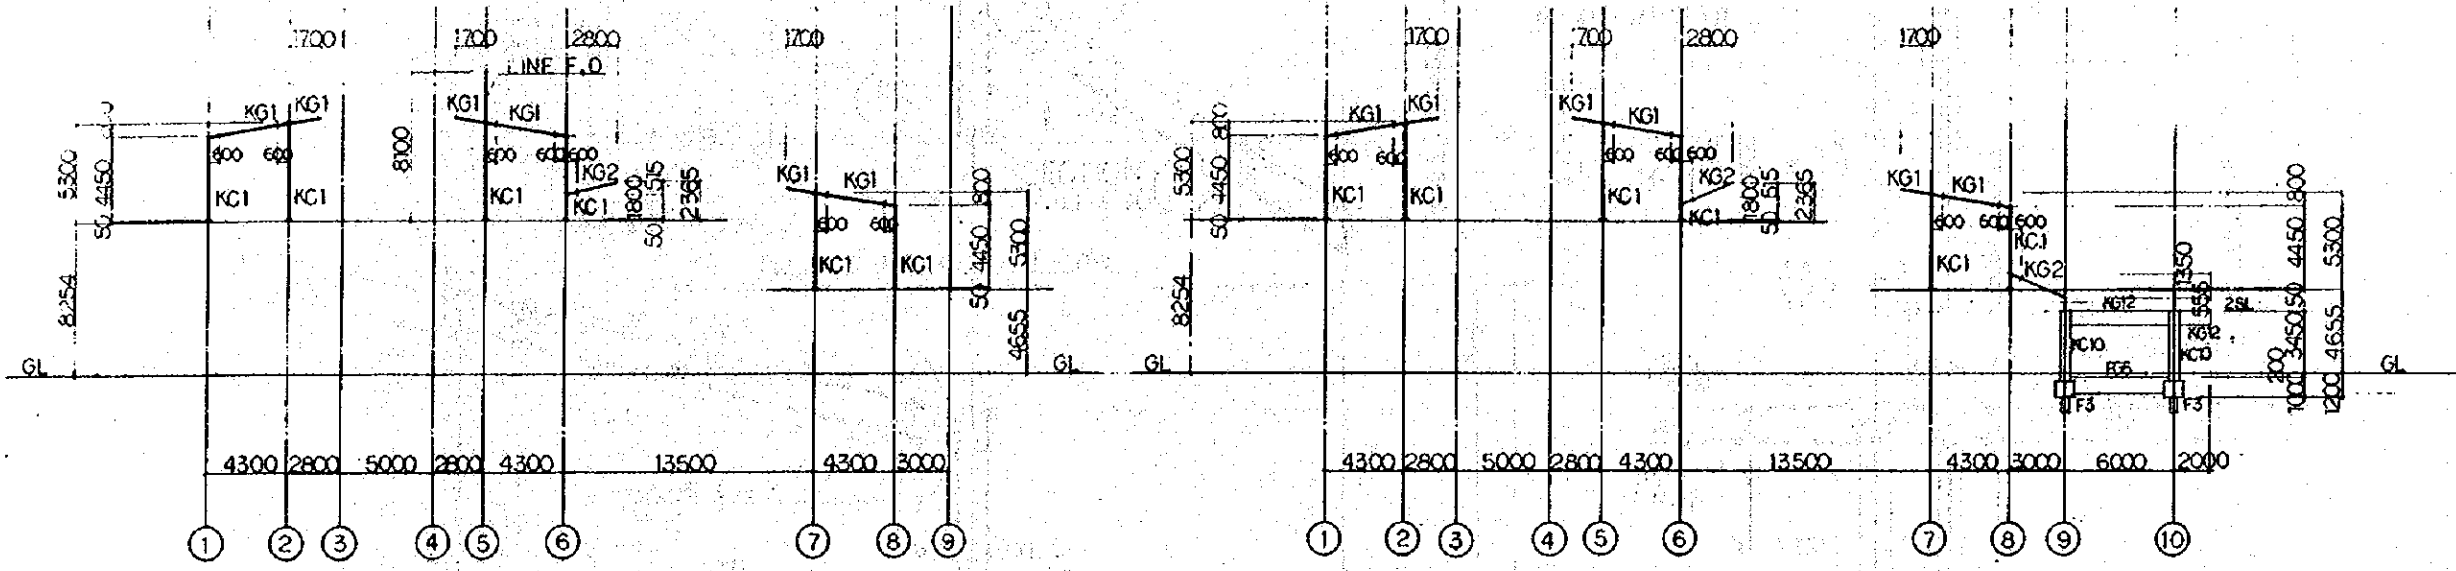

LINE F, G, N, O
SCALE 1:200


LINE H, M
SCALE 1:200

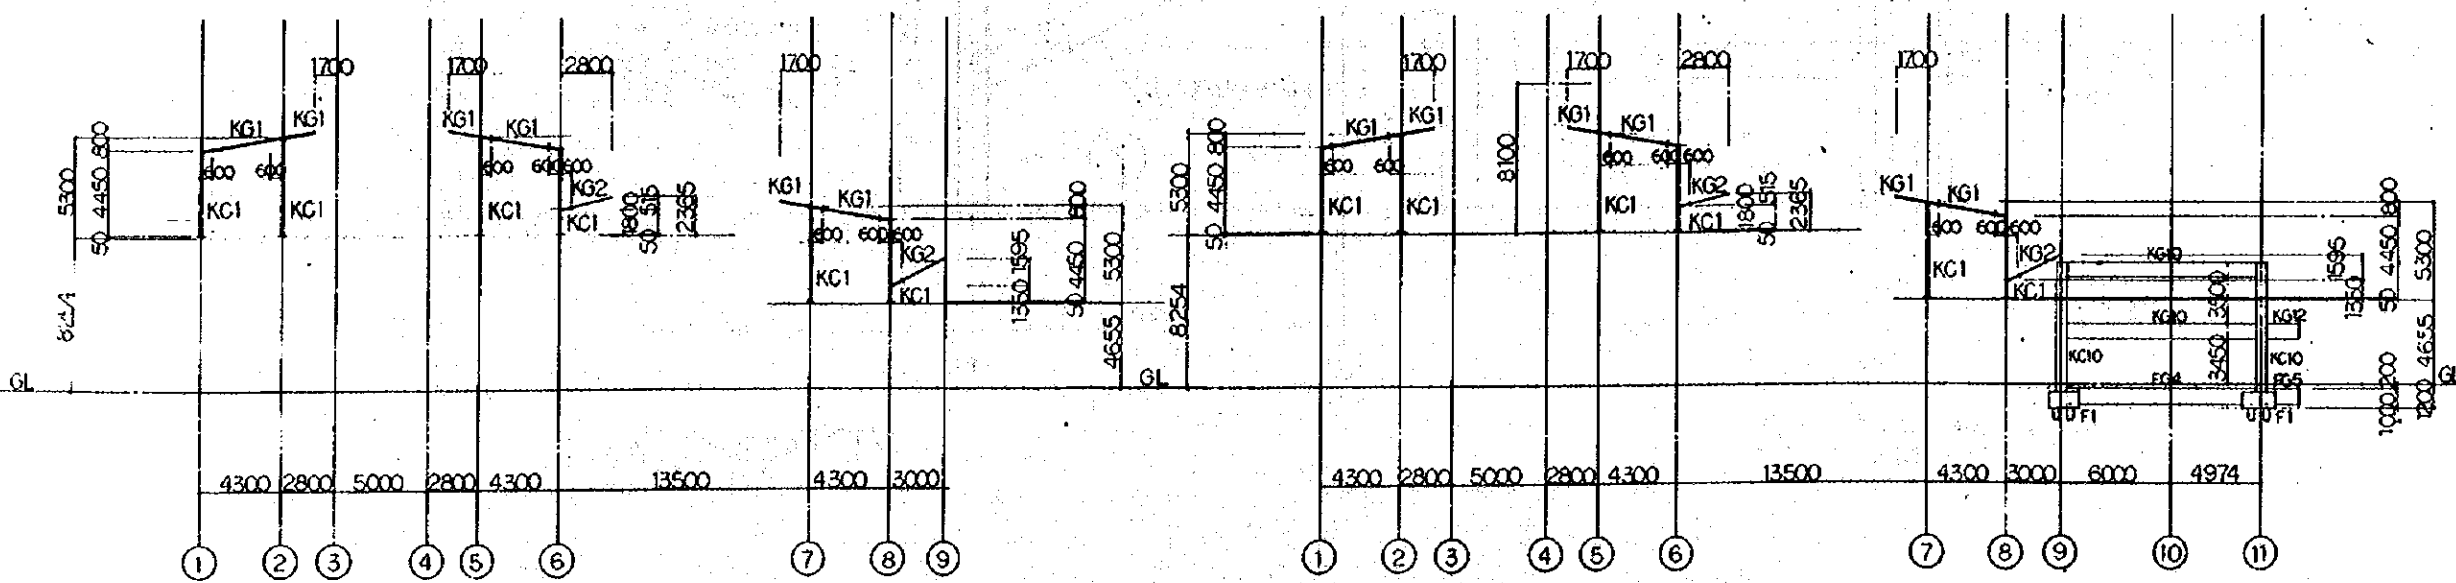

LINE I, K, L
SCALE 1:200

LINE J
SCALE 1:200

REPUBLIC OF INDONESIA MINISTRY OF COMMUNICATIONS DIRECTORATE GENERAL OF LAND TRANSPORT AND INLAND WATERWAYS					
NEW RAILWAY LINE FOR CENGKARENG AIRPORT CONSTRUCTION PROJECT					
JAPAN INTERNATIONAL COOPERATION AGENCY (JICA)					
REVISION	DATE	REASON	BY	CHECKED	APPROVED
B	1 AUG 89	1st	H.M.	K.M.	M.K.
A	11 FEB 89	2nd	H.M.	K.M.	M.K.
KOTA INTAN STATION FRAMING ELEVATION (1 SHEET 2 OF 2)					
PACKAGE: I CIVIL AND ARCHITECTURAL WORK					
SCALE: 1:200		DRAWING NO: AS - 016			

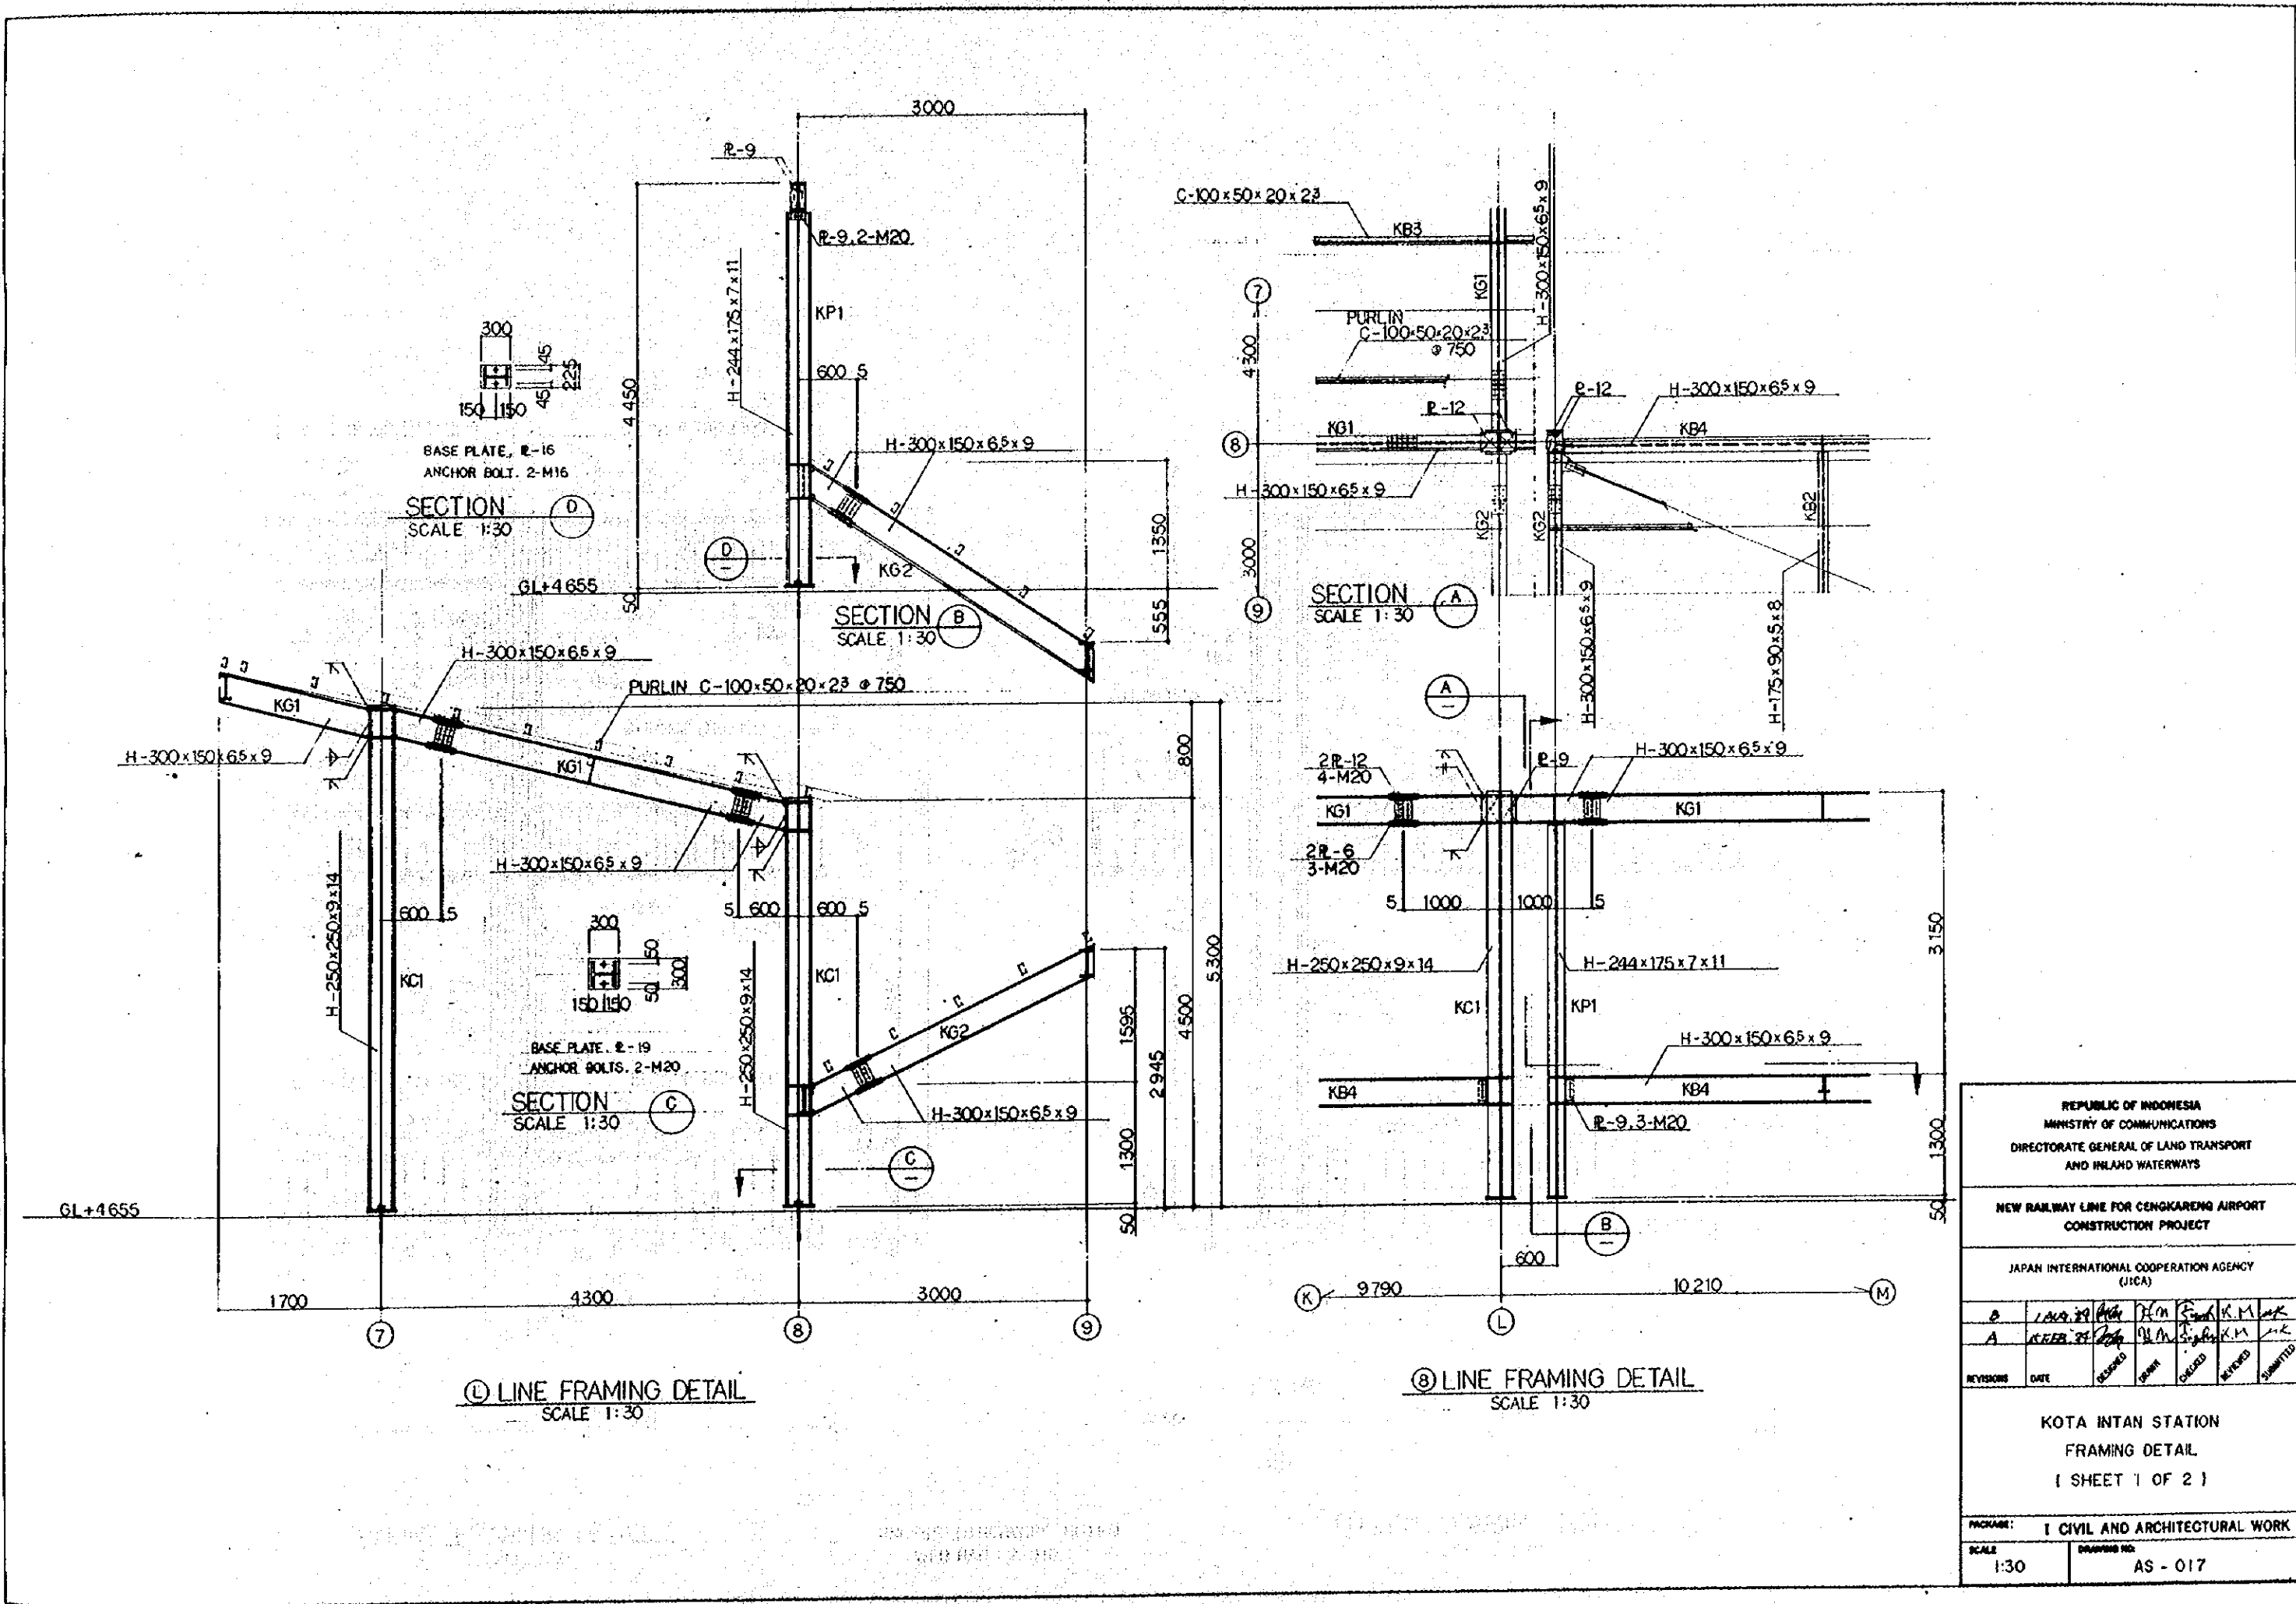

BASE PLATE, P-16
ANCHOR BOLT, 2-M16
SECTION (D)
SCALE 1:30

SECTION (B)
SCALE 1:30


SECTION (A)
SCALE 1:30

BASE PLATE, P-19
ANCHOR BOLTS, 2-M20
SECTION (C)
SCALE 1:30

(L) LINE FRAMING DETAIL
SCALE 1:30


(B) LINE FRAMING DETAIL
SCALE 1:30

REPUBLIC OF INDONESIA MINISTRY OF COMMUNICATIONS DIRECTORATE GENERAL OF LAND TRANSPORT AND INLAND WATERWAYS					
NEW RAILWAY LINE FOR CENGKARENG AIRPORT CONSTRUCTION PROJECT					
JAPAN INTERNATIONAL COOPERATION AGENCY (JICA)					
REVISIONS	DATE	DESIGNED	DRAWN	CHECKED	SUBMITTED
B	12.09.2010	[Signature]	[Signature]	[Signature]	[Signature]
A	08.08.2010	[Signature]	[Signature]	[Signature]	[Signature]
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PACKAGE: I CIVIL AND ARCHITECTURAL WORK					
SCALE: 1:30		DRAWING NO: AS - 017			

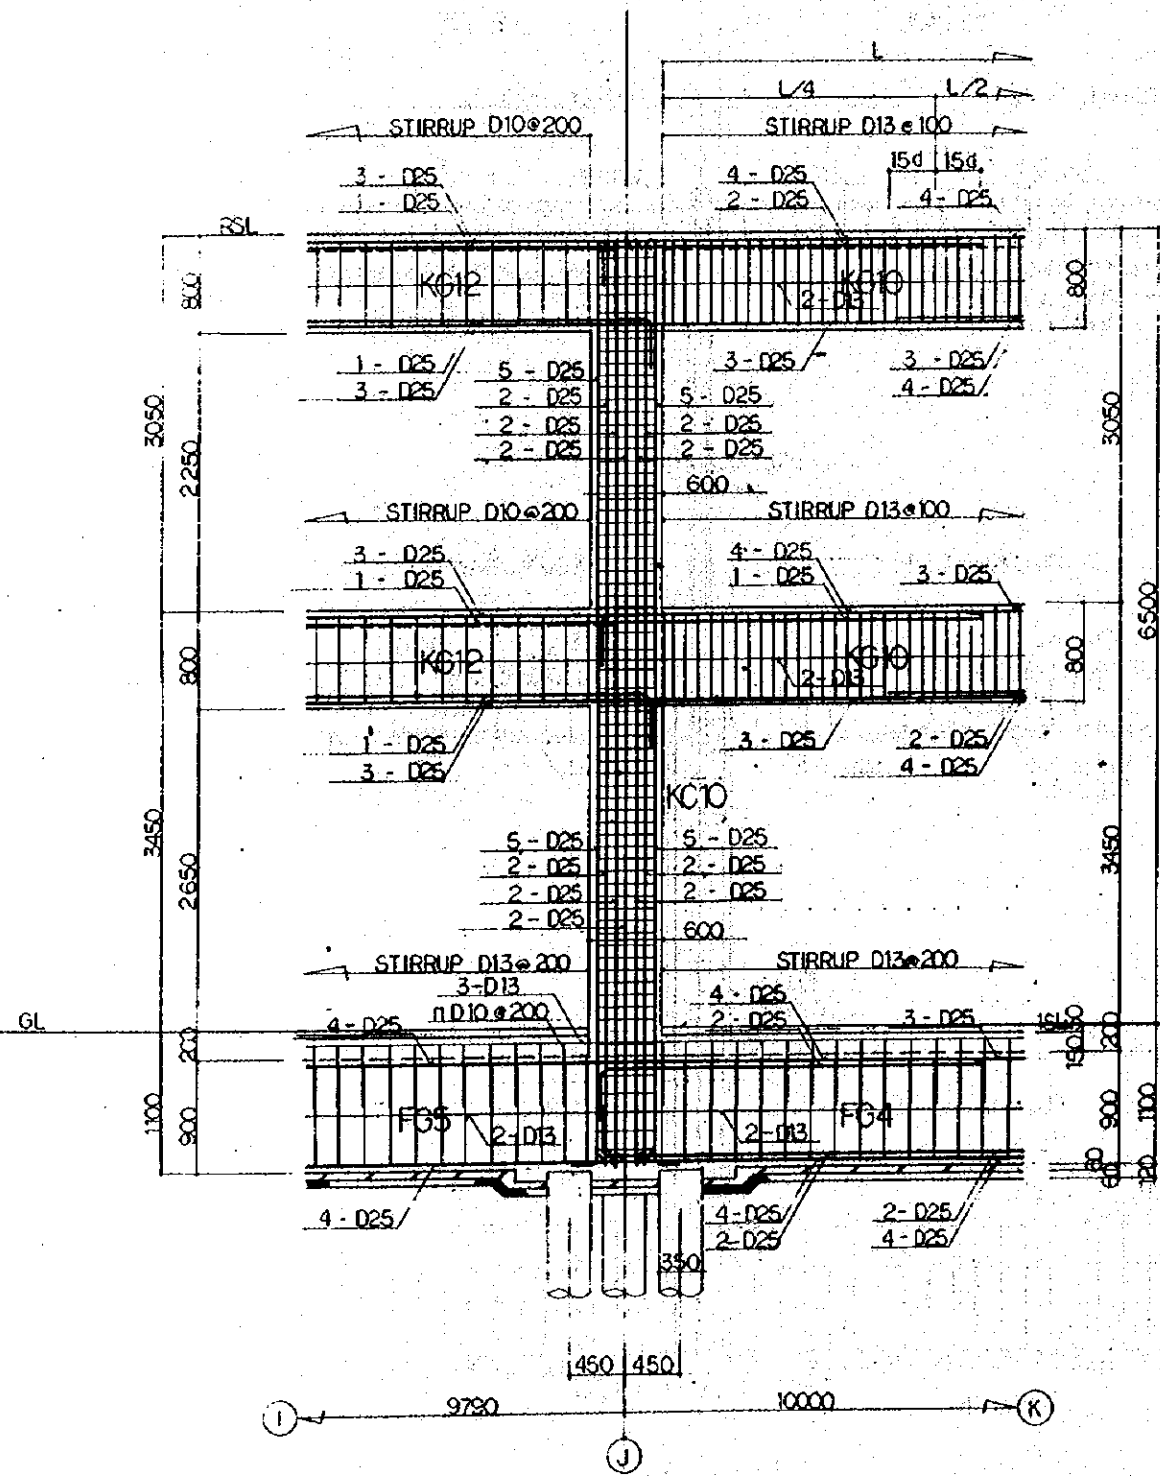


(I) LINE FRAMING DETAIL
SCALE 1:30

UNLESS OTHERWISE NOTED
WEB BAR : 2-D10

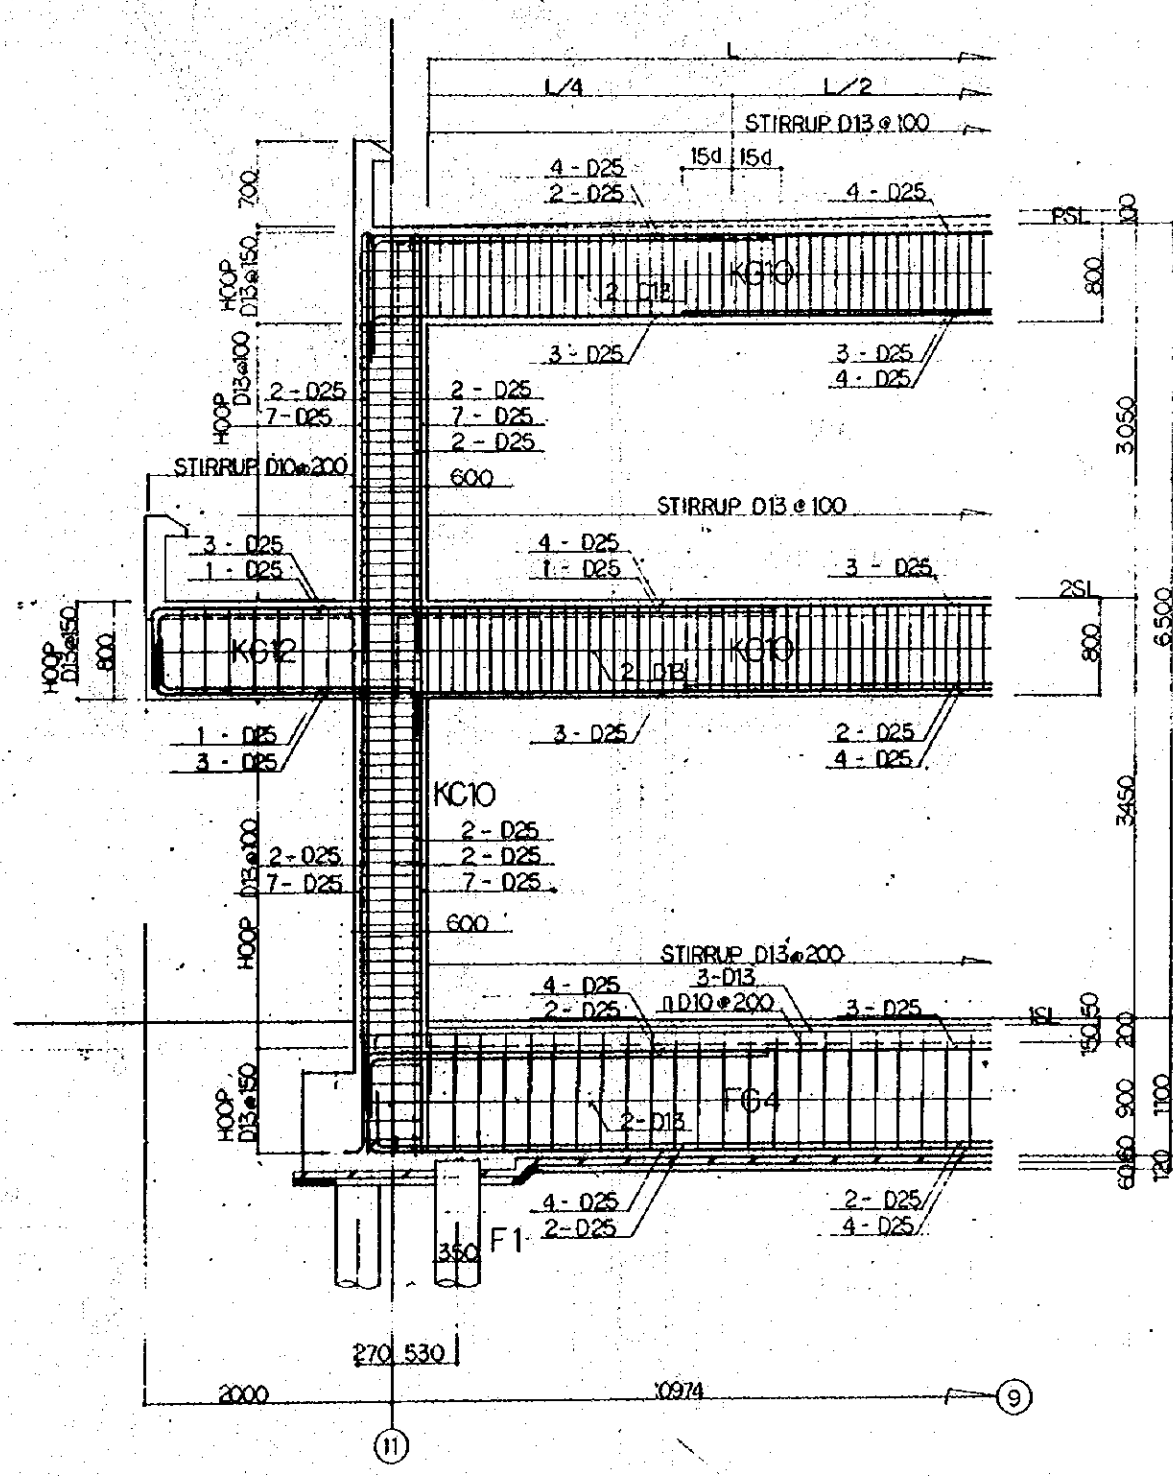


(J) LINE FRAMING DETAIL
SCALE 1:30

REPUBLIC OF INDONESIA MINISTRY OF COMMUNICATIONS DIRECTORATE GENERAL OF LAND TRANSPORT AND INLAND WATERWAYS					
NEW RAILWAY LINE FOR CENGKARENG AIRPORT CONSTRUCTION PROJECT					
JAPAN INTERNATIONAL COOPERATION AGENCY (JICA)					
REVISION	DATE	DESIGNED	CHECKED	APPROVED	SUBMITTED
B	1/19/99	AKH	AKH	S. K. M. K.	
A	11/28/98	AKH	AKH	S. K. M. K.	
KOTA INTAN STATION FRAMING DETAIL (SHEET 2 OF 2)					
PACKAGE: I CIVIL AND ARCHITECTURAL WORK					
SCALE	DRAWING NO.				
1:30	AS - 018				

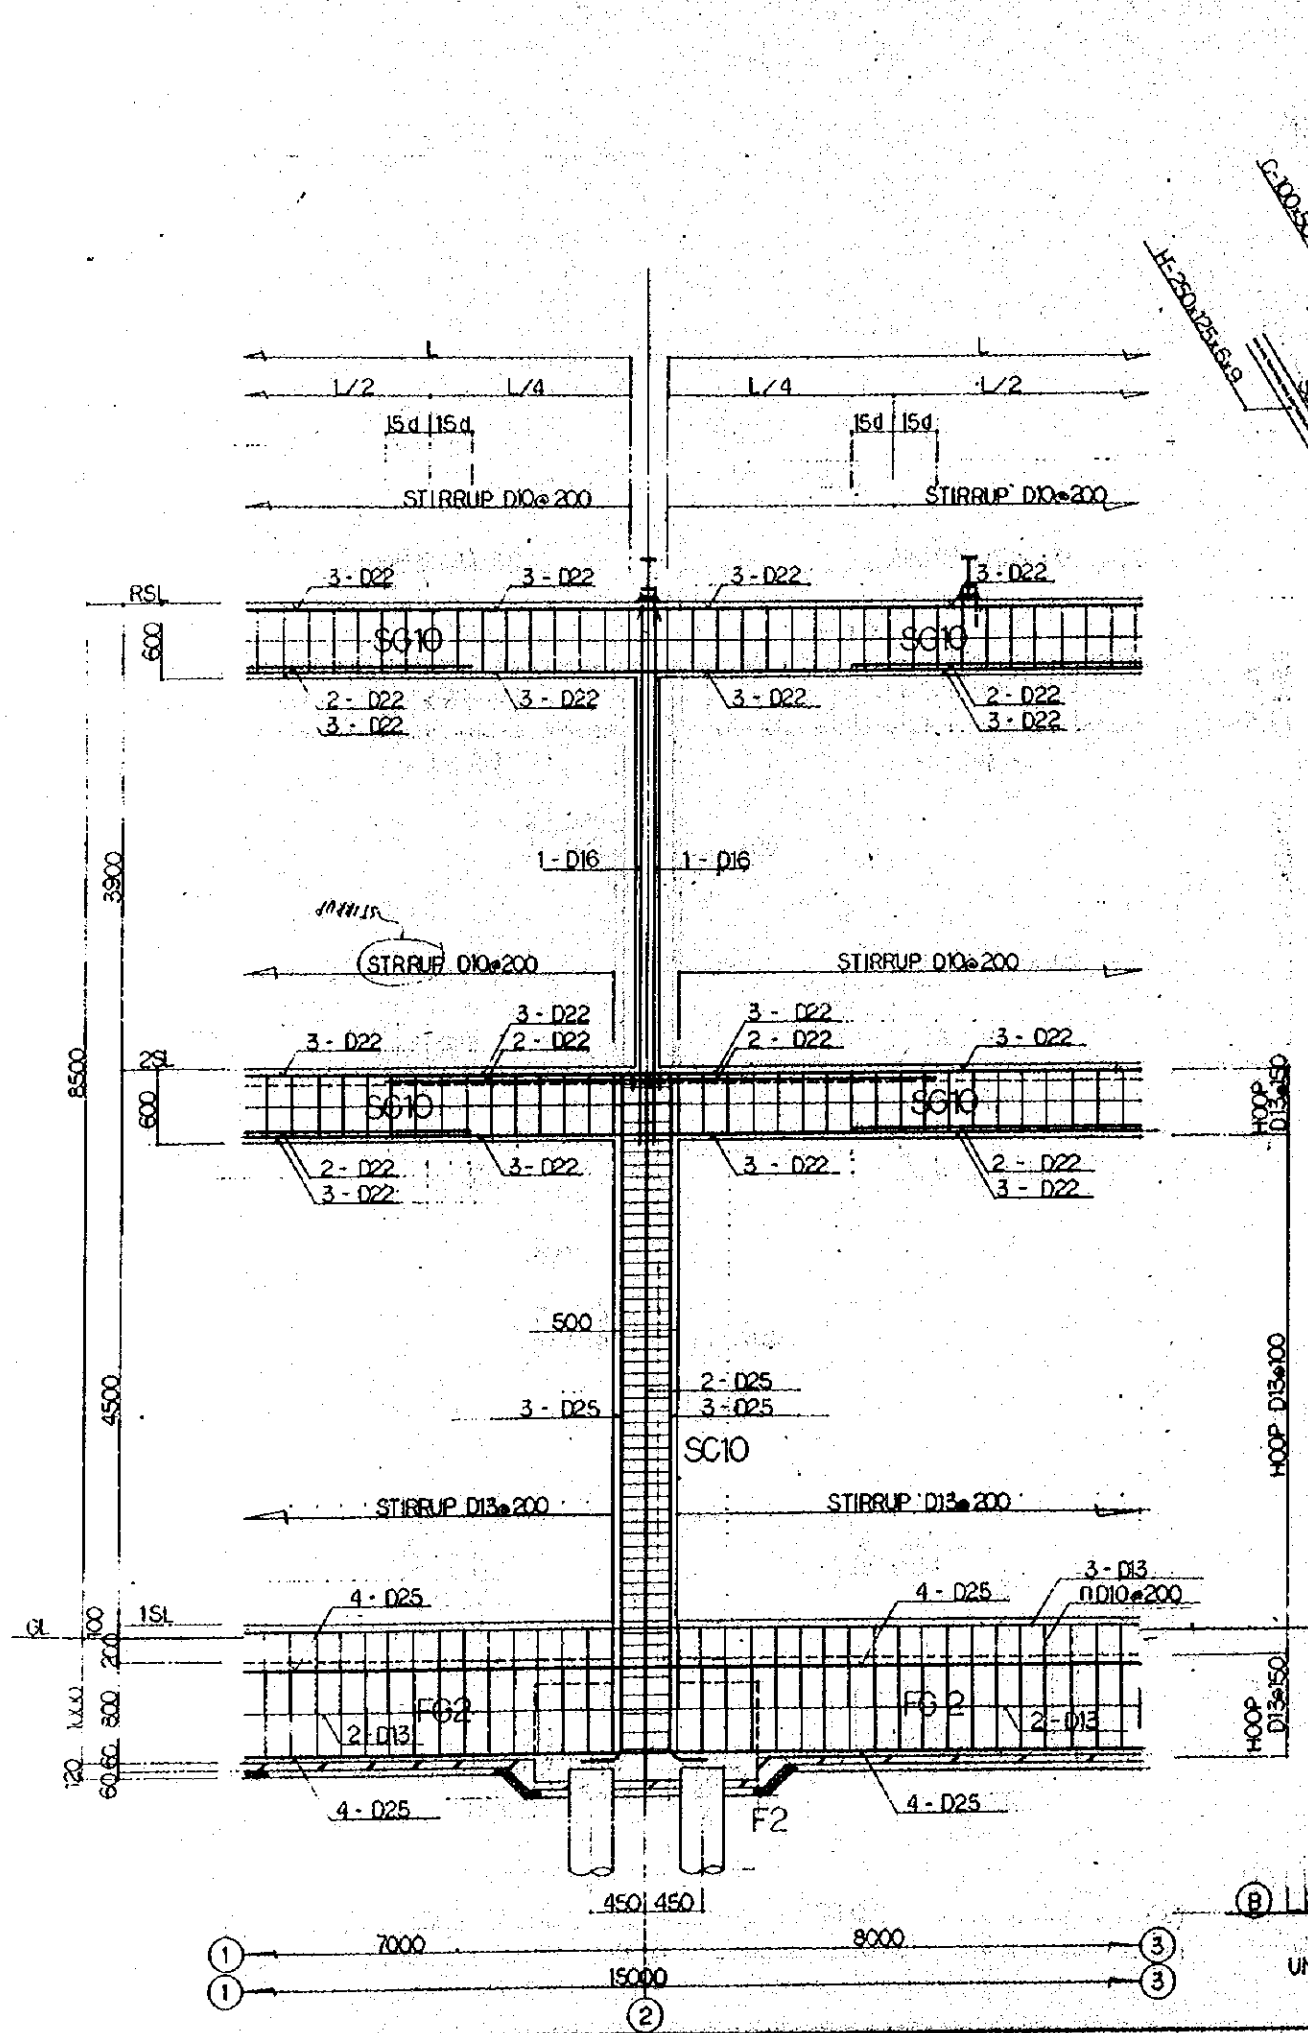


(B) LINE FRAMING DETAIL
SCALE 1:30
UNLESS OTHERWISE NOTED
WEB BAR: 2-D10

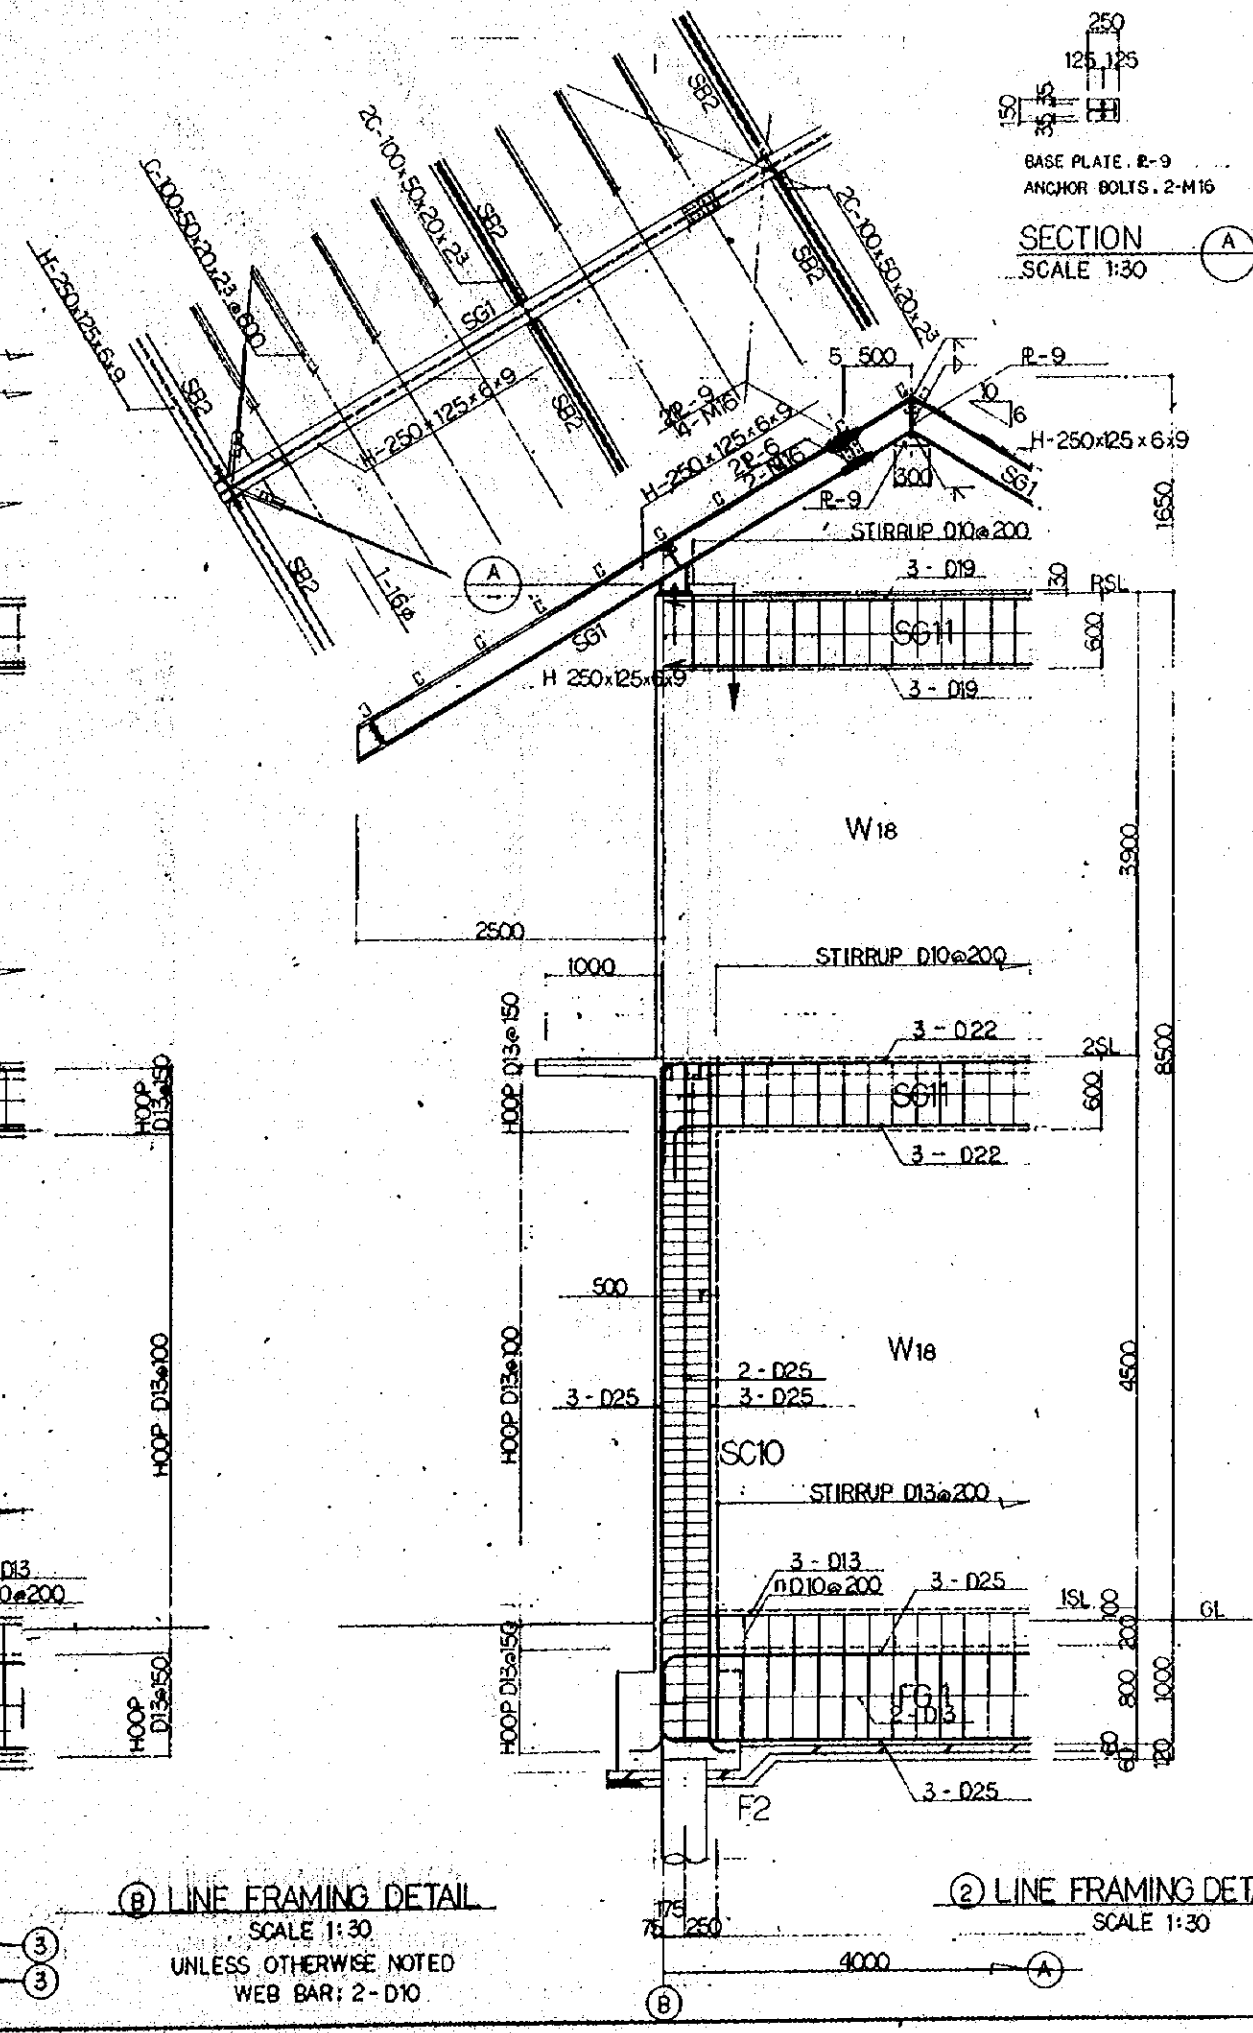


(A) LINE FRAMING DETAIL
SCALE 1:30

REPUBLIC OF INDONESIA MINISTRY OF COMMUNICATIONS DIRECTORATE GENERAL OF LAND TRANSPORT AND INLAND WATERWAYS					
NEW RAILWAY LINE FOR CENKARENG AIRPORT CONSTRUCTION PROJECT					
JAPAN INTERNATIONAL COOPERATION AGENCY (JICA)					
REVISIONS	DATE	DESIGNED	DRAWN	CHECKED	SUBMITTED
B	1/14/99	M. H. H. H.	S. K. M.	M. K.	
A	1/14/99	M. H. H. H.	S. K. M.	M. K.	
SIGNAL CABIN A FRAMING DETAIL					
PACKAGE: I CIVIL AND ARCHITECTURAL WORK					
SCALE: 1:30	DRAWING NO: AS - 020				

250
125 125
150
35
BASE PLATE. R-9
ANCHOR BOLTS. 2-M16
SECTION (A)
SCALE 1:30

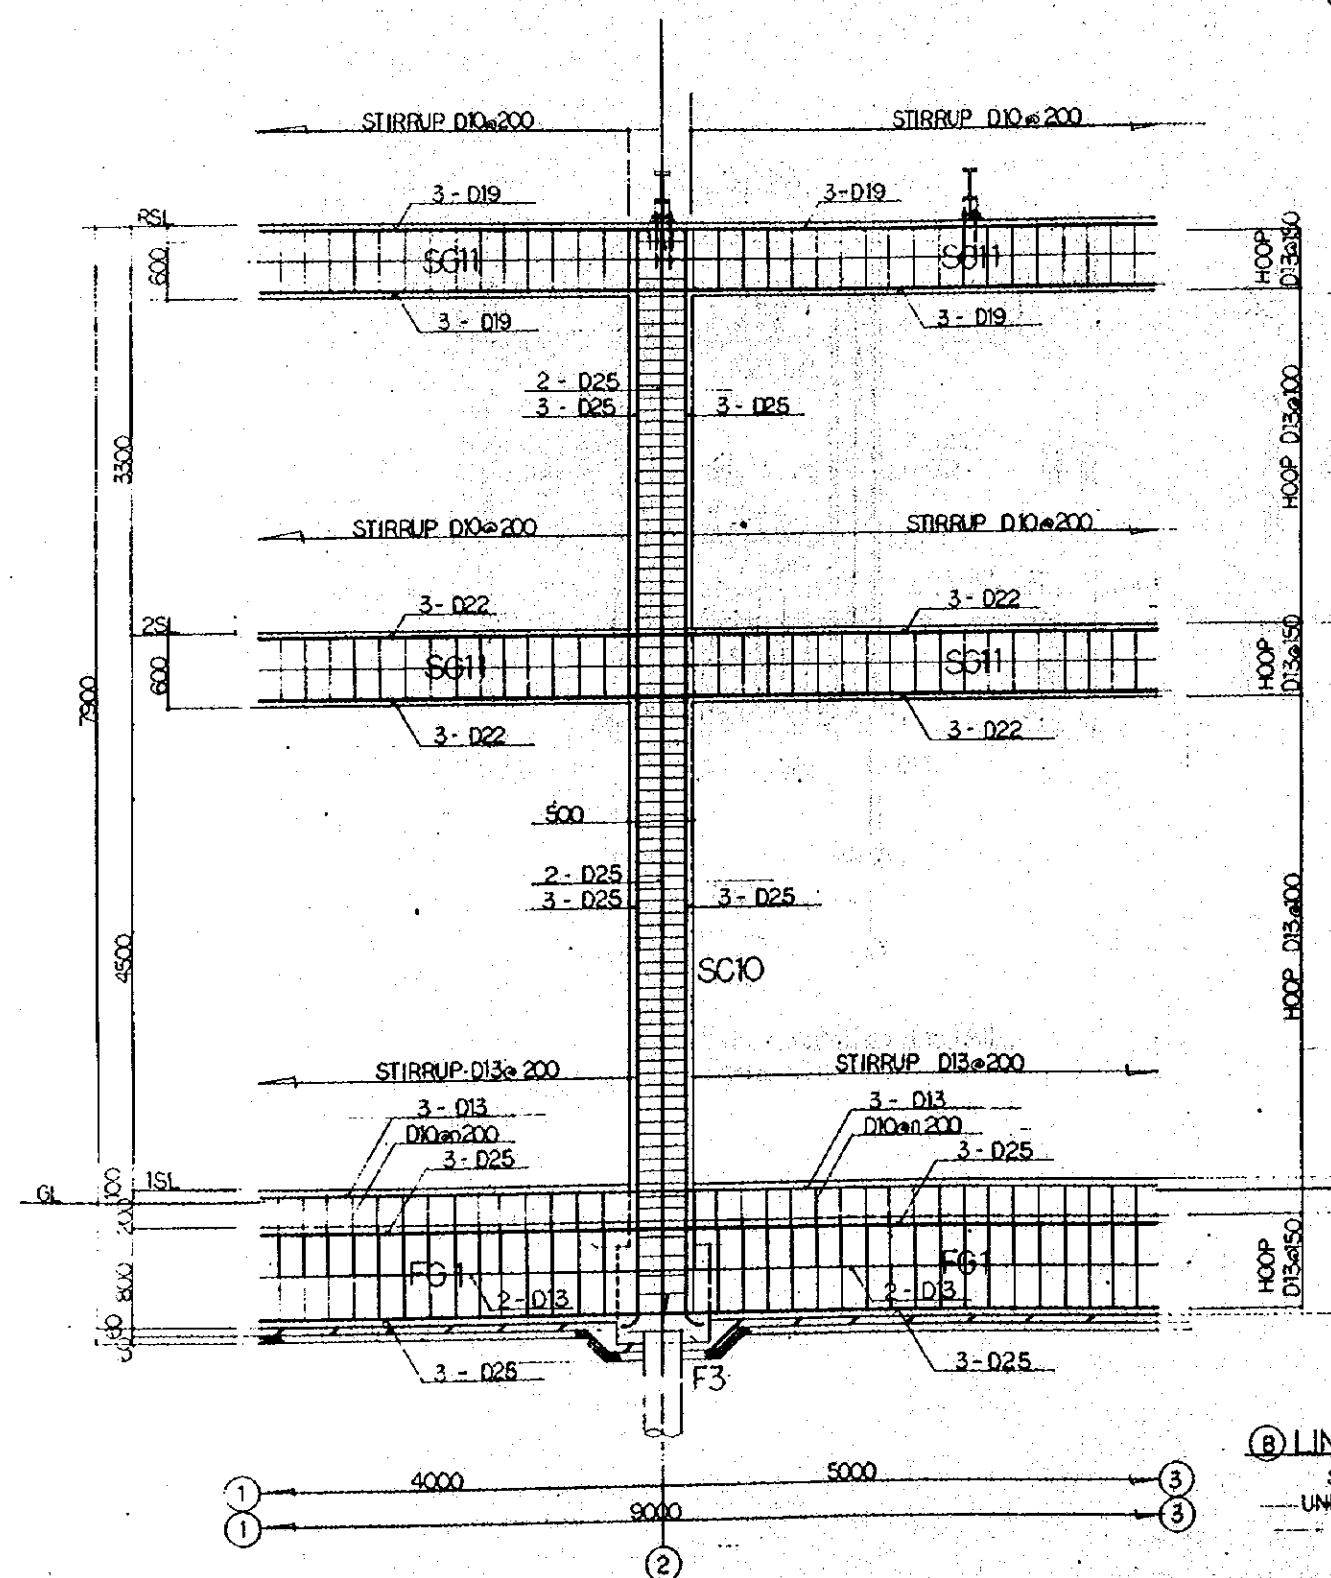


(B) LINE FRAMING DETAIL
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UNLESS OTHERWISE NOTED
WEB BAR: 2-D10

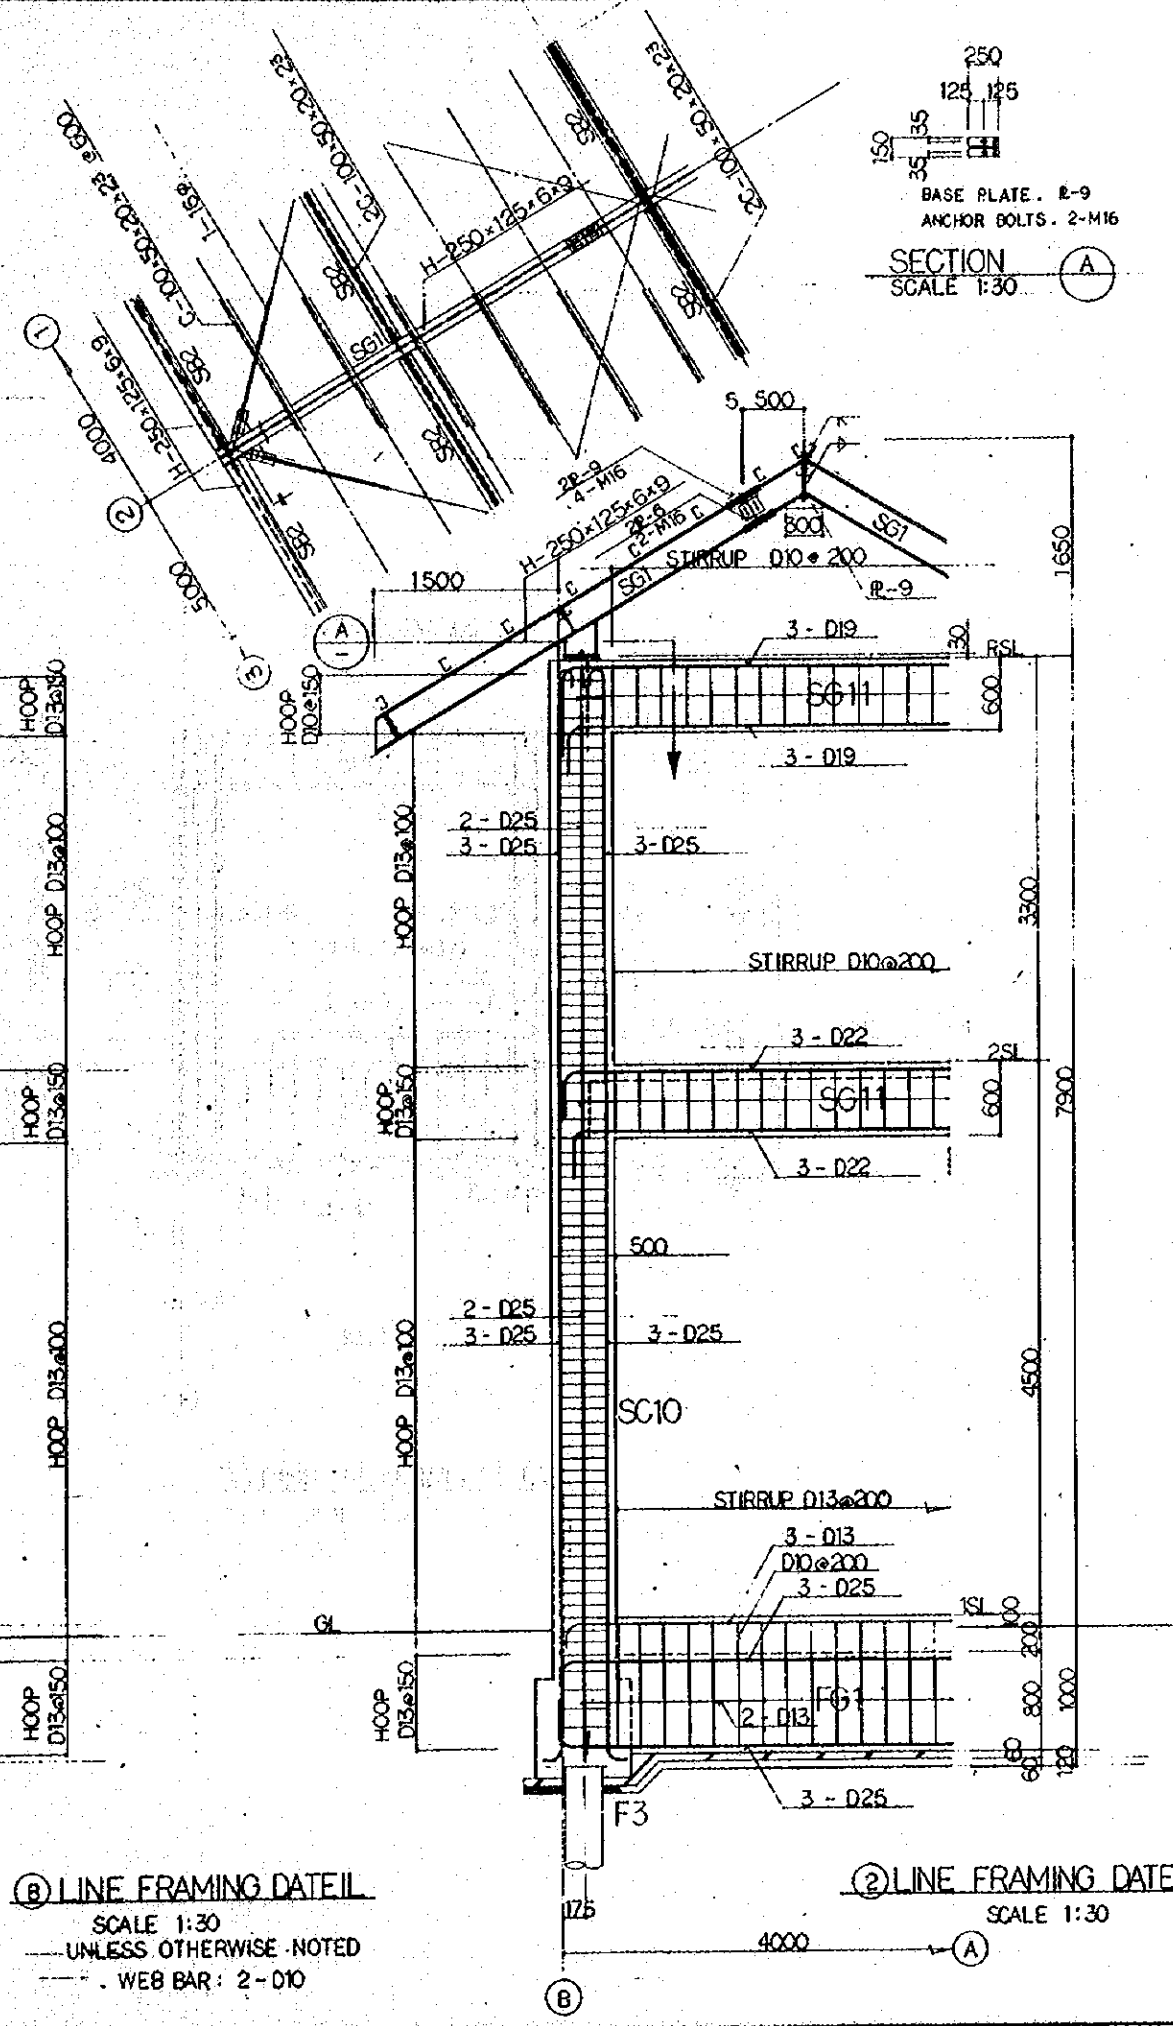


(2) LINE FRAMING DETAIL
SCALE 1:30

REPUBLIC OF INDONESIA MINISTRY OF COMMUNICATIONS DIRECTORATE GENERAL OF LAND TRANSPORT AND INLAND WATERWAYS					
NEW RAILWAY LINE FOR CENKARENG AIRPORT CONSTRUCTION PROJECT					
JAPAN INTERNATIONAL COOPERATION AGENCY (JICA)					
REVISIONS	DATE	DESIGNED	CHECKED	REVIEWED	SUBMITTED
B	1 AUG 99	[Signature]	[Signature]	[Signature]	[Signature]
A	25 FEB 99	[Signature]	[Signature]	[Signature]	[Signature]
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PACKAGE: I CIVIL AND ARCHITECTURAL WORK					
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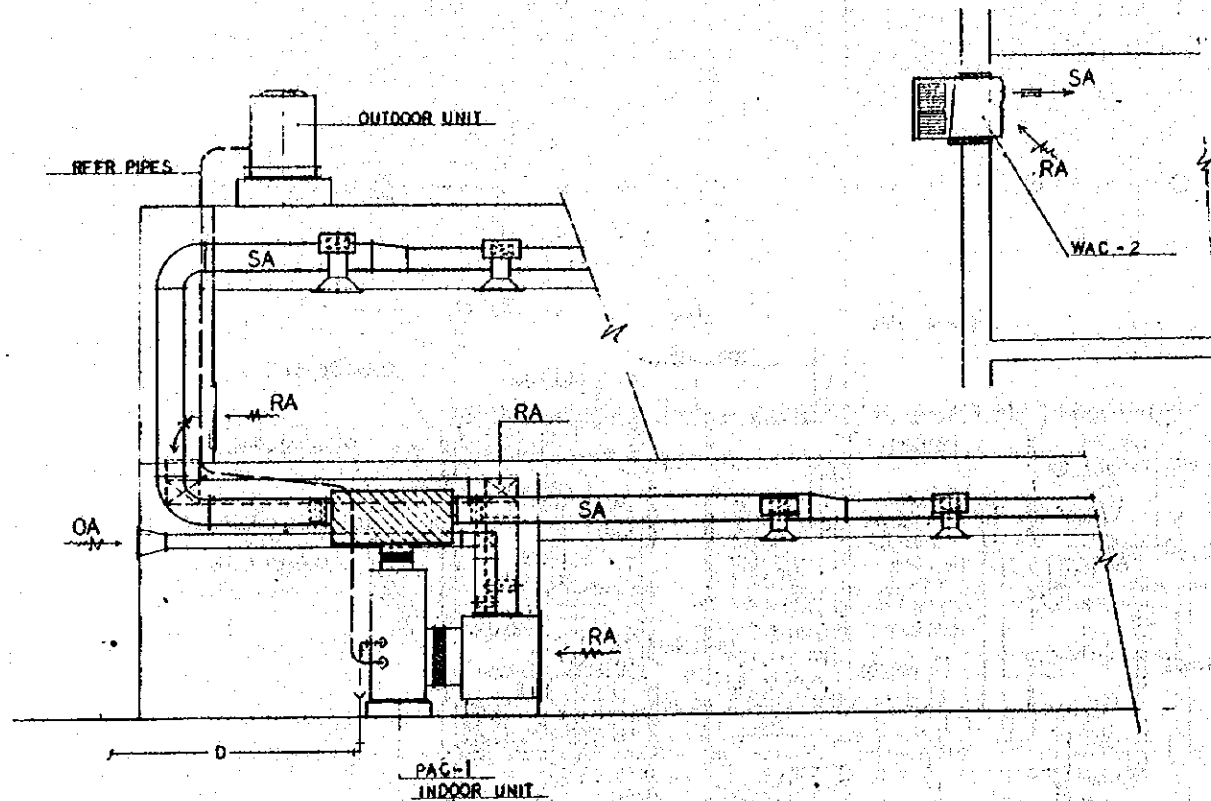
① LINE FRAMING DETAIL
SCALE 1:30

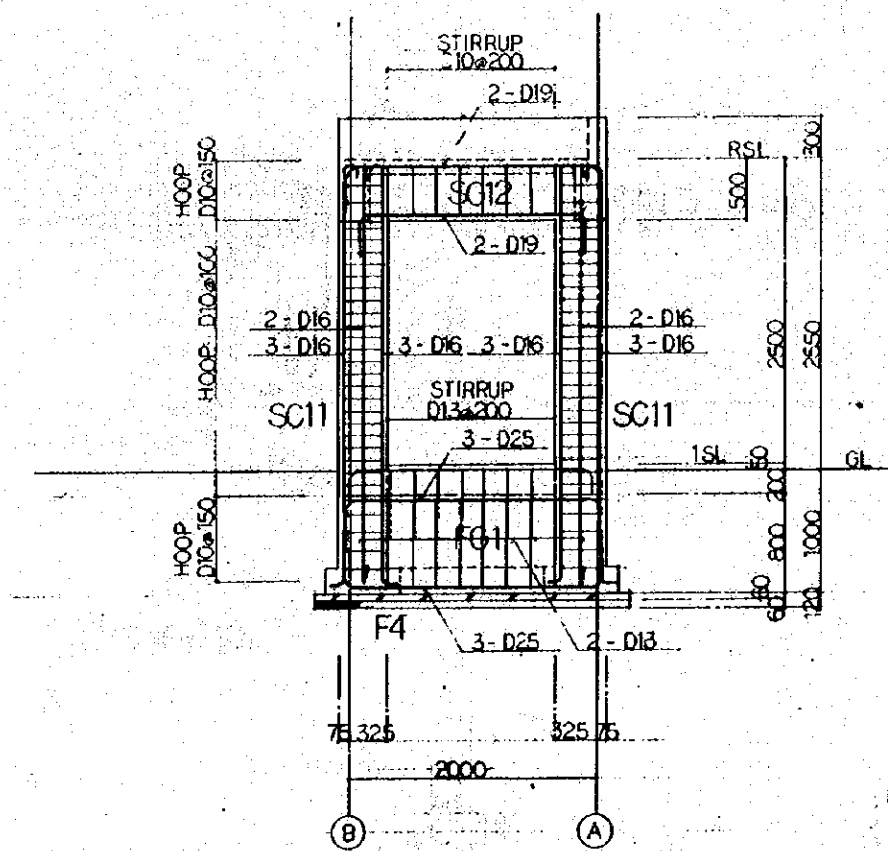

② LINE FRAMING DETAIL
SCALE 1:30

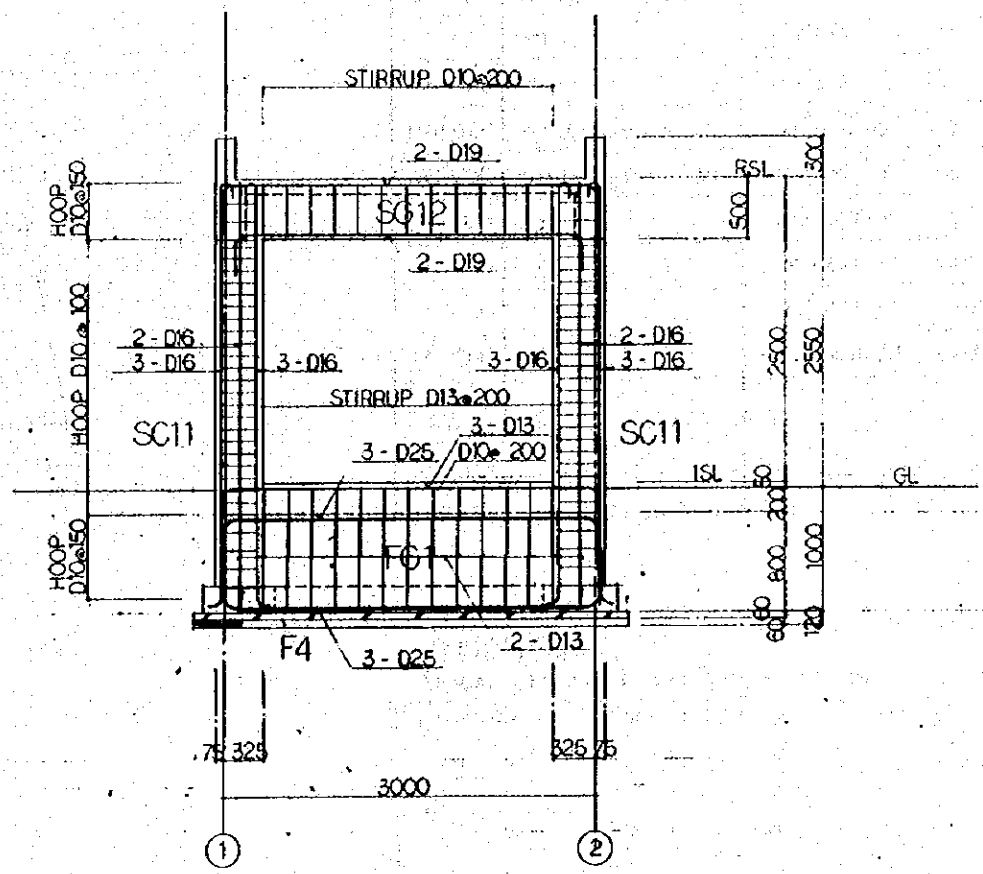REPUBLIC OF INDONESIA MINISTRY OF COMMUNICATIONS DIRECTORATE GENERAL OF LAND TRANSPORT AND INLAND WATERWAYS					
NEW RAILWAY LINE FOR CENKARENG AIRPORT CONSTRUCTION PROJECT					
JAPAN INTERNATIONAL COOPERATION AGENCY (JICA)					
B	1 AUG. 89	HM	JK	K.M.	JK
A	15 FEB. 89	JK	JK	K.M.	JK
REVISIONS	DATE	DESIGNED	CHECKED	APPROVED	SUBMITTED
CROSSING WATCHMAN'S BOX FRAMING DETAIL					
PACKAGE: I CIVIL AND ARCHITECTURAL WORK					
SCALE: 1:30		DRAWING NO: AS - 022			


AIR CONDITIONING DIAGRAM



SCHEDULE OF VAC EQUIPMENT

SYMBOL	NAME OF EQUIPMENT	SPECIFICATION	ELEC DATA			ACCESSORIES	QTY
			V	PHASE	HZ		
PAC-1	AIR-COOLED TYPE PACKAGED AIR CONDITIONER	CAP: 16 RT, INDOOR-UNIT COMP. FAN 15 KW 3.7 KW, OUTDOOR-UNIT FAN 0.4 KW x 2	380	3	50	REFR-PIPES	1
# -2	DITTO	CAP: 6 RT, INDOOR-UNIT COMP. FAN 5.5 KW 0.55 KW, OUTDOOR-UNIT FAN 0.3 KW	#	#	#	DITTO	
WAC-1	WINDOW MOUNTED ROOM AIR CONDITIONER	CAP: 1.9 RT, APPROX. 650 x 420 x 760 ^D , 3.4 KW	220	1	#	COOLER FRAME	
# -2	DITTO	CAP: 1.4 RT, DITTO. 650 x 420 x 650 ^D , 2.3 ^D	#	#	#	DITTO	2
CEF-1/2	CENTRIFUGAL FAN	1400 x 40 ^{mm} x 40 ^{mm} x 0.75 ^W	380	3	#	ANTIVIBRATION FRAME	1
# -2	DITTO	3600 x 35 ^{mm} x 15 ^{mm}	#	#	#	DITTO	1
# -2 1/2	DITTO	5600 x 45 ^{mm} x 22 ^{mm}	#	#	#	DITTO	
PEF-200	PIPE EXHAUST FAN	200 ^{mm} x 200 ^{mm} x 10 ^W	220	1	#	HS	
WEF-250	WALL-TYPE EXHAUST FAN	250 ^{mm} x 300 ^{mm} x 6 ^W	#	#	#	EAG	
# -300	DITTO	300 ^{mm} x 600 ^{mm} x 8 ^{mm} x 50 ^{mm}	#	#	#	DITTO	1
# -350	DITTO	350 ^{mm} x 850 ^{mm} x 8 ^{mm} x 100 ^{mm}	#	#	#	DITTO	2
# -400	DITTO	400 ^{mm} x 1300 ^{mm} x 8 ^{mm} x 200 ^{mm}	#	#	#	DITTO	
# -500	DITTO	500 ^{mm} x 1600 ^{mm} x 15 ^{mm} x 300 ^{mm}	#	#	#	DITTO	1

VENTILATION SYSTEM DIAGRAM

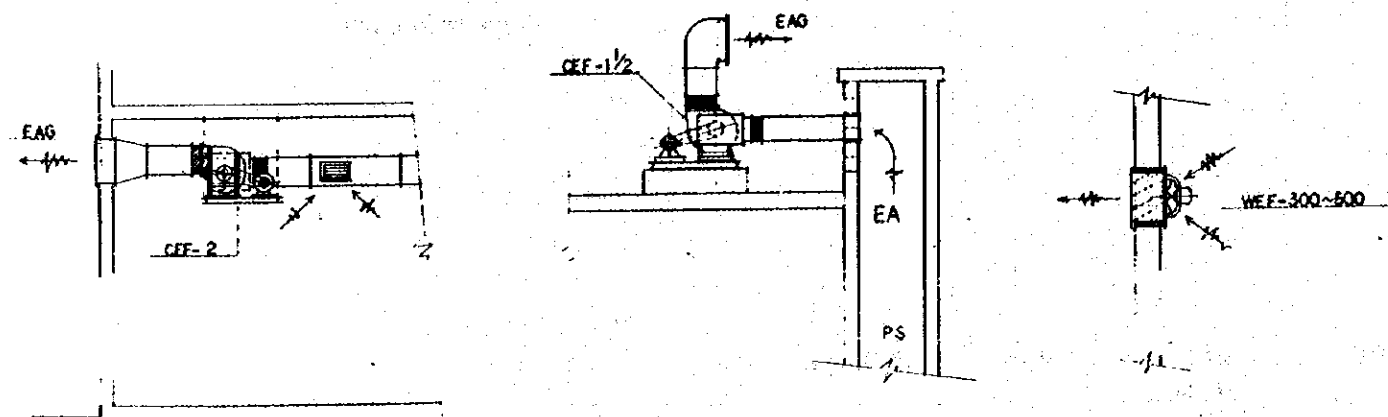

DUCT MATERIAL

MINIMUM DUCT GALVANIZED SHEET STEEL METAL GAGES

GAGE / THK (mm)	RECTANGULAR (mm)	ROUND (φ mm)
26 0.5 APPROX	UP THROUGH 300 TH	UP THROUGH 200
24 0.6	325	255
22 0.8	778	583
20 1.0	1325	925
18 1.2	2155	3050

(U) DIMENSION OF LONGEST SIDE

REPUBLIC OF INDONESIA
 MINISTRY OF COMMUNICATIONS
 DIRECTORATE GENERAL OF LAND TRANSPORT
 AND INLAND WATERWAYS

NEW RAILWAY LINE FOR CENGKARENG AIRPORT
 CONSTRUCTION PROJECT

JAPAN INTERNATIONAL COOPERATION AGENCY
 (JICA)



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A	15 FEB. 89	REVISED	BY	CHKD	BY	CHKD

REVISIONS DATE REVISIONS BY CHECKED BY REVISIONS BY CHECKED BY



AIRPORT TERMINAL BUILDING
 VAC
 GENERAL NOTES AND
 APPARATUS SCHEDULE

PACKAGE: I CIVIL AND ARCHITECTURAL WORK



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REPUBLIC OF INDONESIA MINISTRY OF COMMUNICATIONS DIRECTORATE GENERAL OF LAND TRANSPORT AND INLAND WATERWAYS					
NEW RAILWAY LINE FOR CENGKARENG AIRPORT CONSTRUCTION PROJECT					
JAPAN INTERNATIONAL COOPERATION AGENCY (JICA)					
REVISONS	DATE	DESIGNED	DRAWN	CHECKED	SUBMITTED
B	1 AUG. 99	[Signature]	[Signature]	[Signature]	[Signature]
A	2 FEB. 89	[Signature]	[Signature]	[Signature]	[Signature]
AIRPORT TERMINAL BUILDING VAC IF PLAN					
PACKAGE: I CIVIL AND ARCHITECTURAL WORK					
SCALE	DRAWING NO.				
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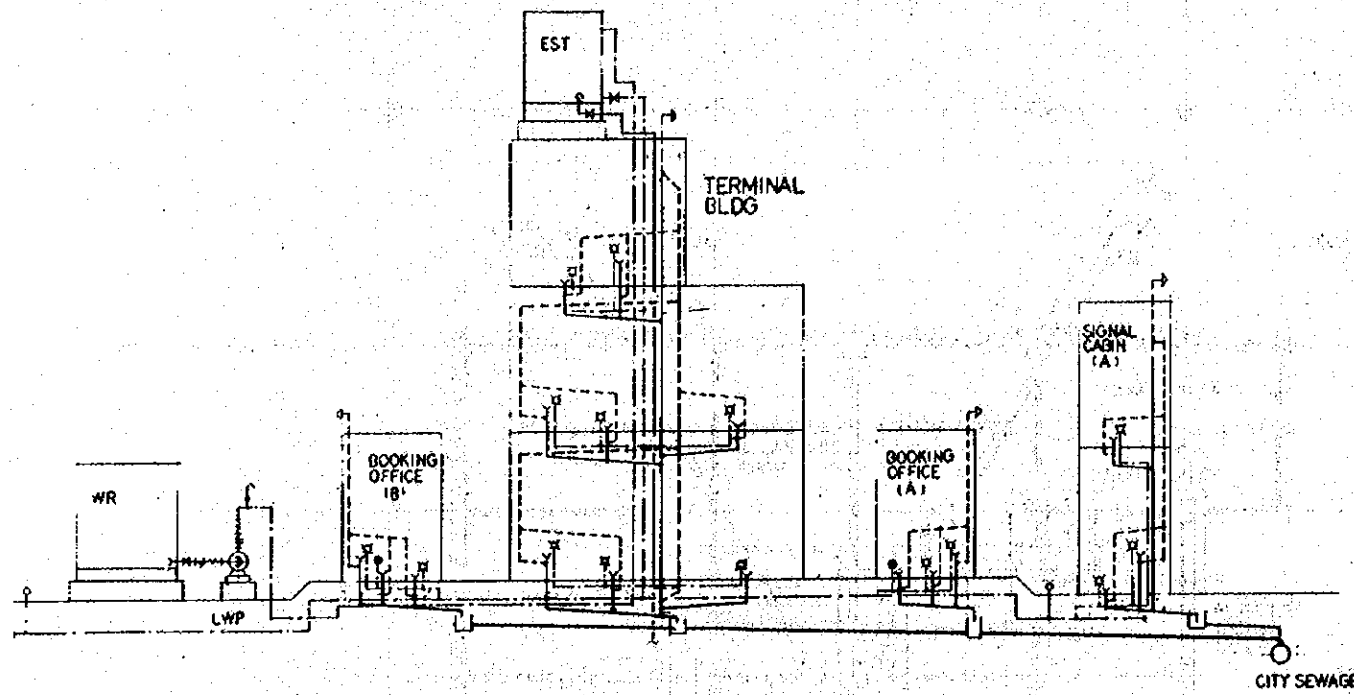


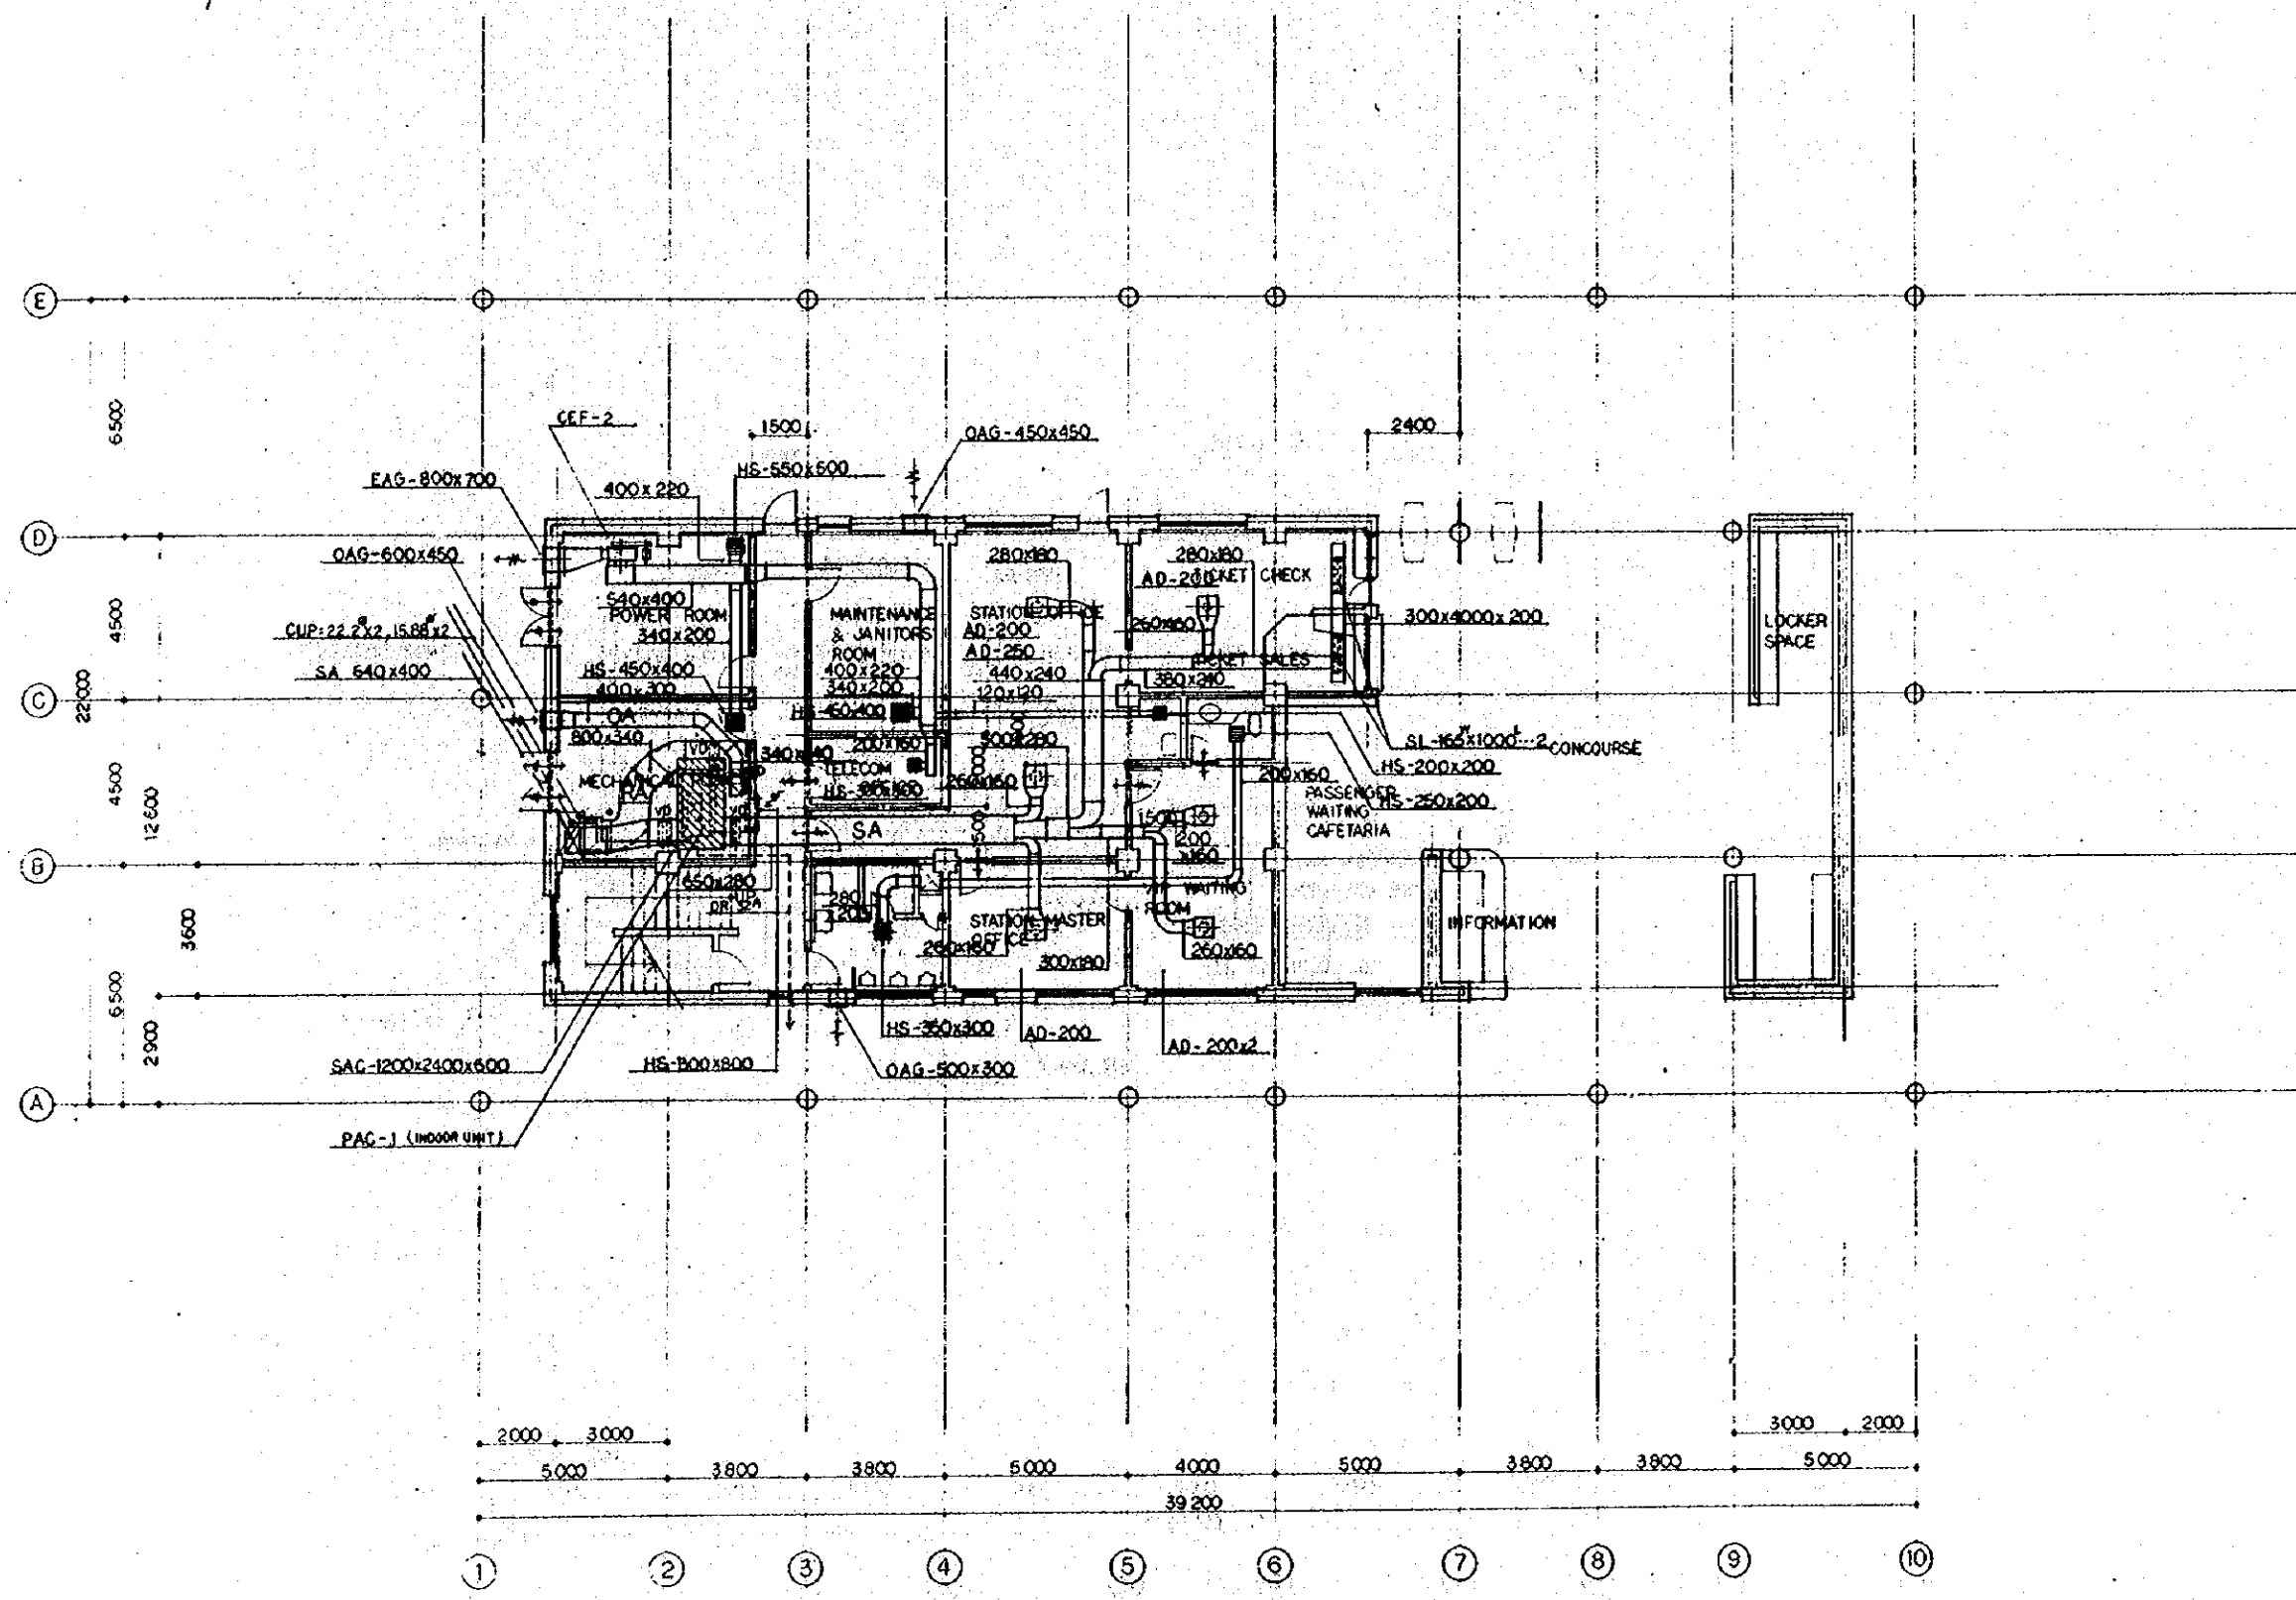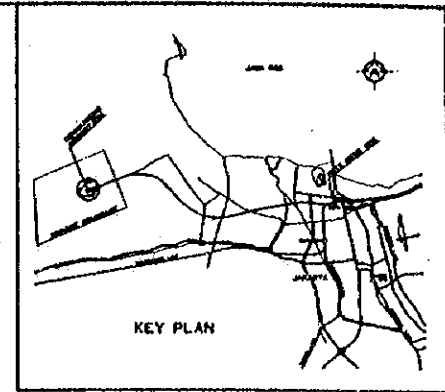REPUBLIC OF INDONESIA MINISTRY OF COMMUNICATIONS DIRECTORATE GENERAL OF LAND TRANSPORT AND INLAND WATERWAYS						
NEW RAILWAY LINE FOR CENKARENG AIRPORT CONSTRUCTION PROJECT						
JAPAN INTERNATIONAL COOPERATION AGENCY (JICA)						
B	1 AUG 84	CHK	DRG	DESIGN	K.M.	M.K.
A	15 FEB 84	CHK	DRG	DESIGN	K.M.	M.K.
REVISIONS	DATE	DESIGNED	DRAWN	CHECKED	REVIEWED	SUBMITTED
AIRPORT TERMINAL BUILDING VAC 2F PLAN						
PROGRAM: I CIVIL AND ARCHITECTURAL WORK						
SCALE	DRAWING NO.					
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REPUBLIC OF INDONESIA MINISTRY OF COMMUNICATIONS DIRECTORATE GENERAL OF LAND TRANSPORT AND INLAND WATERWAYS						
NEW RAILWAY LINE FOR CENGKARENG AIRPORT CONSTRUCTION PROJECT						
JAPAN INTERNATIONAL COOPERATION AGENCY (JICA)						
B	1 AUG 88	OK	OK	OK	OK	OK
A	15 FEB 88	OK	OK	OK	OK	OK
REVISIONS	DATE	DESIGNED	DRAWN	CHECKED	REVIEWED	SUBMITTED
AIRPORT TERMINAL BUILDING VAC 3F PLAN						
PACKAGE: I CIVIL AND ARCHITECTURAL WORK						
SCALE: 1:100		DRAWING NO: AM - 004				

PLUMBING SYSTEM DIAGRAM

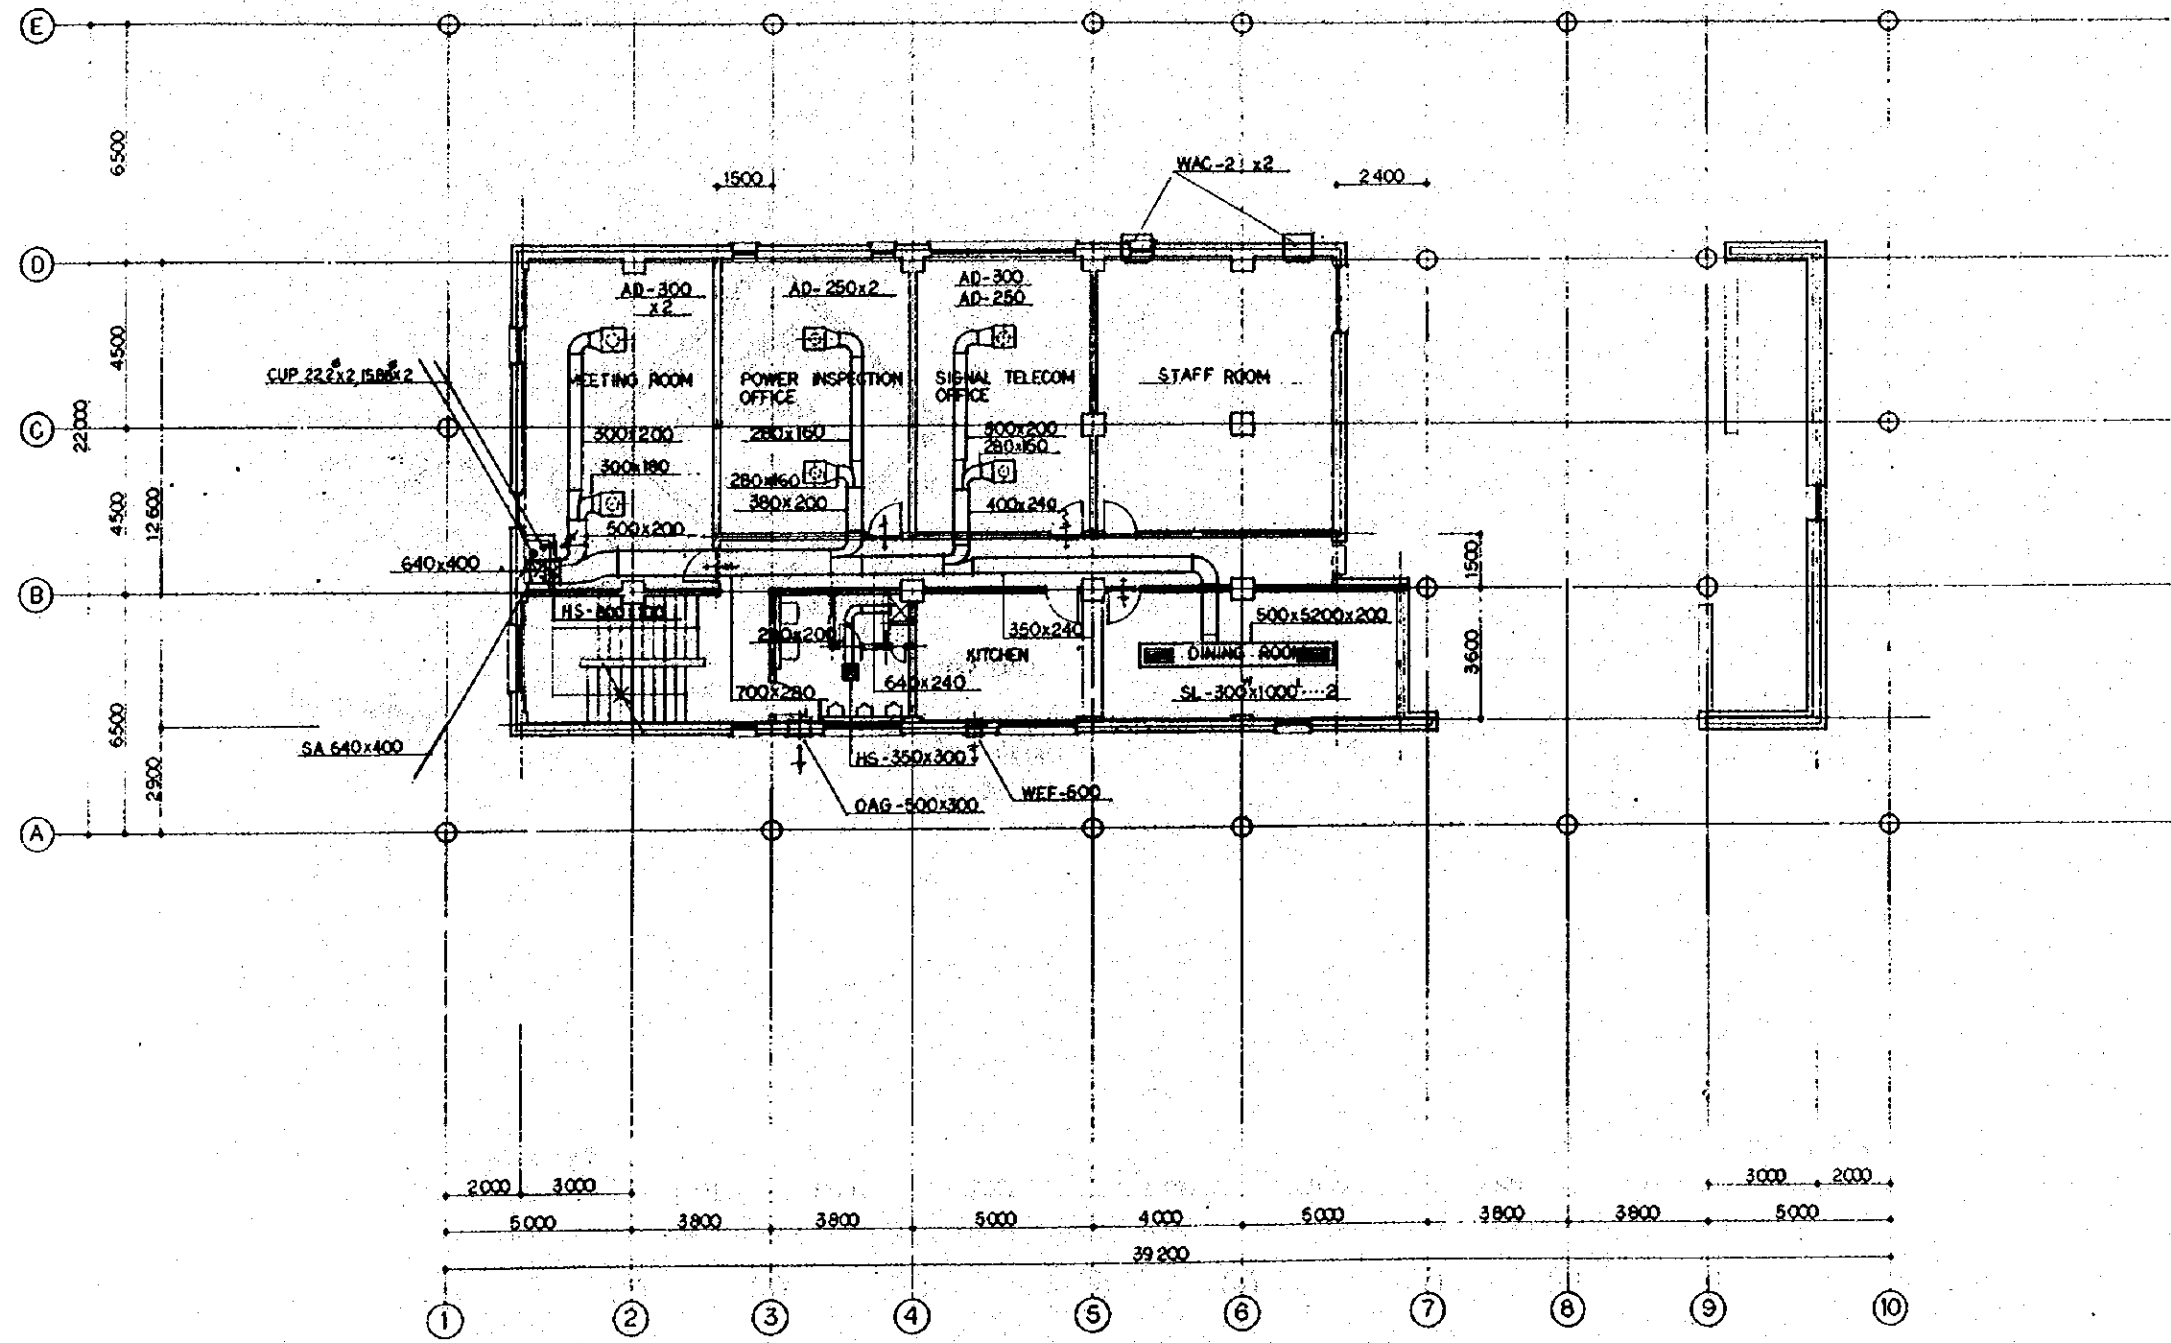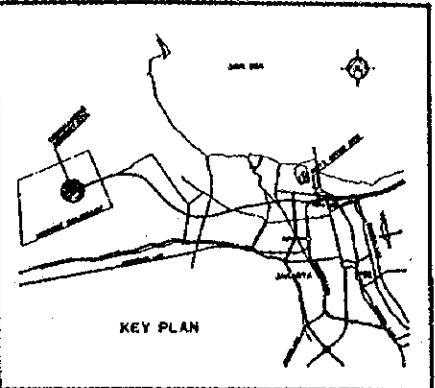

PLUMBING FIXTURES SCHEDULE

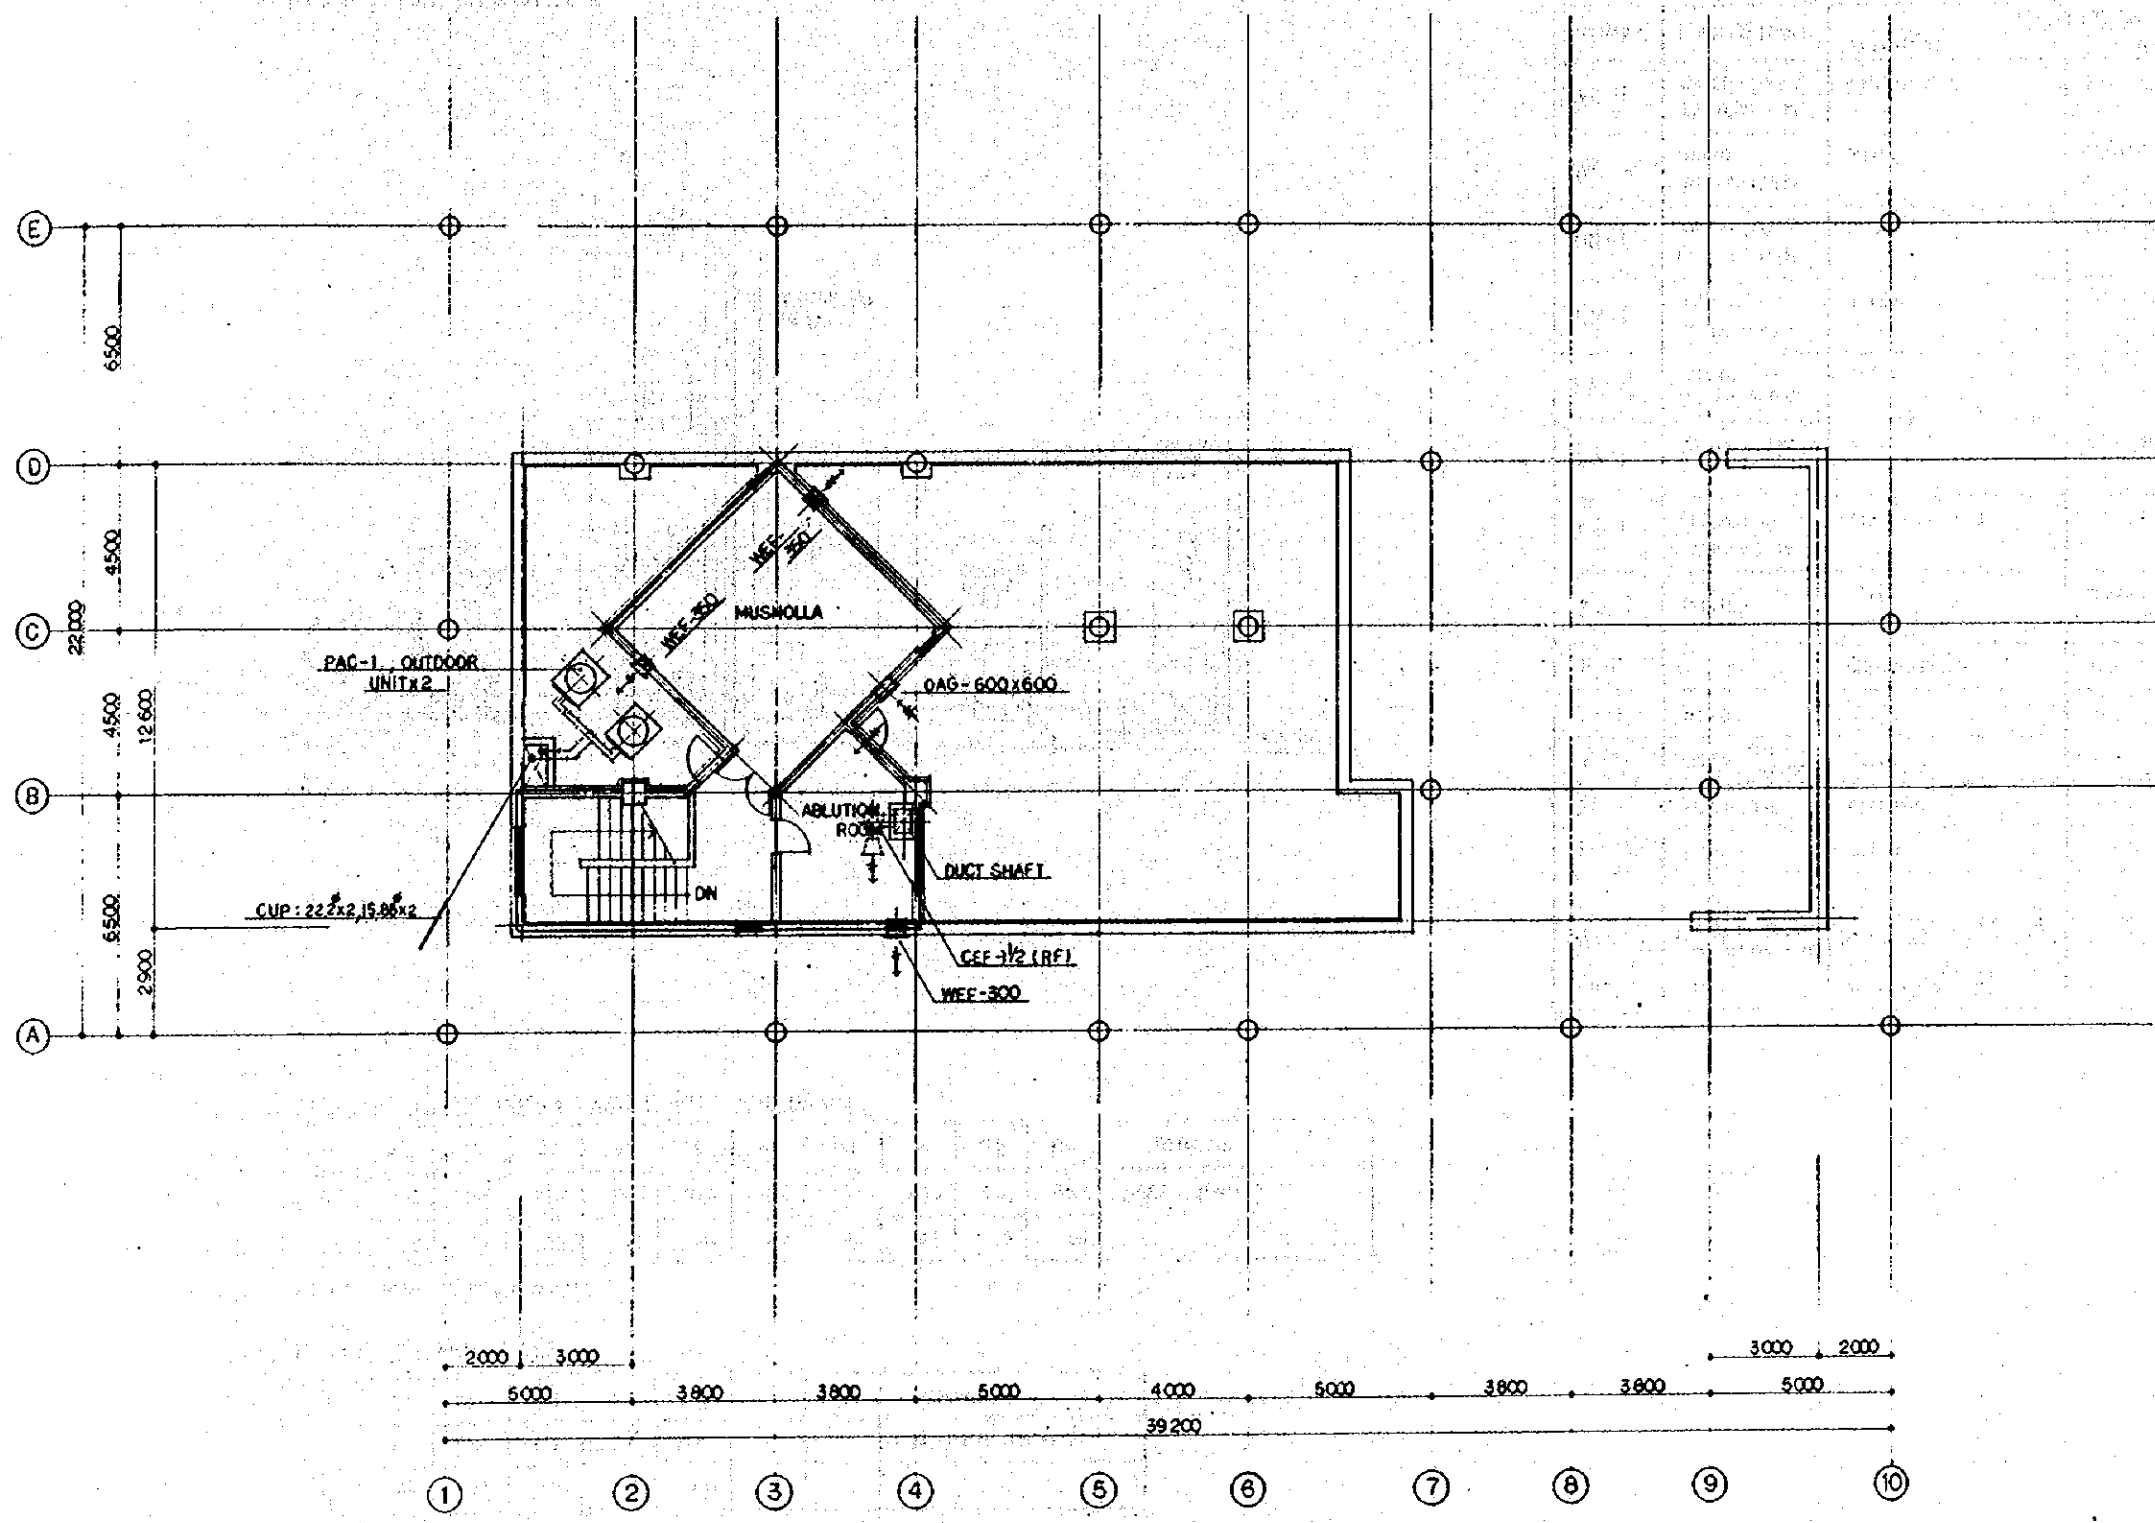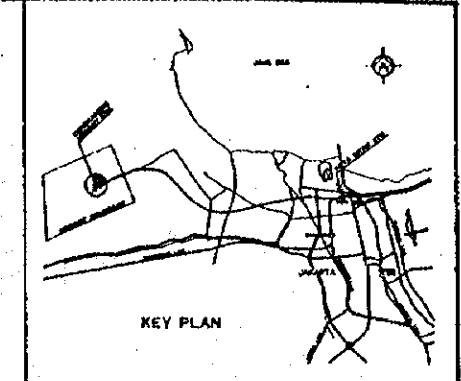SYMBOL	FIXTURE NAME	DESCRIPTION			QTY	CONNECTION PIPE		
		MATERIAL	SIZE APPROX.	ACCESSORIES		WATER	WASTE	VENT
WC-1	WATER CLOSET EASTERN TYPE	VITREOUS CHINA	280x570x300 ^H	P-TRAP, F-2	2	25	100	80
WC-2	DITTO WESTERN TYPE	DITTO	360x600x360 ^H	DITTO, FLUSH-VALVE, TOILET PAPER HOLDER	1	25	100	80
UR-1	URINAL, FLOOR MOUNTED TYPE	DITTO	380x380x920 ^H	FLUSH-VALVE, INLET SPUD	6	20	75	50
LV-1	LAVATORY WALL HUNG	DITTO	530x430	F-1, P-TRAP, SHUT OFF VALVE, CONNECTING PIPE	4	20	50	40
LV-2	DITTO COUNTER-TOP	DITTO	480 ^H	DITTO	1	20	50	40
SK-1	SERVICE SINK	DITTO	560x450x630 ^H	F-2, SINK-TRAP		20	75	40
KS-1	KITCHEN SINK CABINET TYPE	STAINLESS STEEL	1000x560x800 ^H	F-1, SINK-TRAP	1	20	50	40
KS-2	DITTO	DITTO	1500x560x800 ^H	DITTO	1	20 _{x2}	50	40
F-1	FAUCET	CHROME PLATED	1/2			20		
F-2	DITTO	DITTO	3/4		4	25		
F-3	DITTO FOR IRRIGATION	DITTO	3/4	VALVE-BOX, W/KEY	48	25		
FD-1	FLOOR DRAIN	CAST IRON		WASTE FITTING	7		50	
FD-2	DITTO	DITTO		DITTO	1		75	
LWP-1	LIFT WATER PUMP CENTRIFUGAL-TYPE	65-50x550 ^H	1/2" x 24 x 3.7		1			
LWP-2	DITTO	50-40x250 ^H	1/2" x 24 x 2.2					

NOTES: PIPING

1. GALVANIZED STEEL PIPES FOR POTABLE WATER, VENT AND DRAIN

SIZE NOMINAL	15	20	25	32	40	50	65	80	100	125	150	REMARKS
OUTSIDE DIAMETER	21.7	27.2	34.0	42.7	48.6	60.5	76.3	89.1	114.3	139.8	165.2	SCREW-JOINTED
WALL THICKNESS	2.8	2.8	3.2	3.5	3.5	3.8	4.2	4.2	4.5	4.5	4.6	

FITTINGS SHALL COMPLY WITH THE PIPE MATERIAL.

2. CAST IRON PIPE FOR SOIL AND SEWER

SIZE NOMINAL	50	75	100	125	150	200	REMARKS
OUTSIDE DIAMETER	59	84	109	134	159	212	ONE TOUCH JOINT-TYPE
WALL THICKNESS	4.5	4.5	4.5	4.5	4.5	6.0	

FITTINGS SHALL COMPLY WITH THE PIPE MATERIAL.

REPUBLIC OF INDONESIA
 MINISTRY OF COMMUNICATIONS
 DIRECTORATE GENERAL OF LAND TRANSPORT AND INLAND WATERWAYS



NEW RAILWAY LINE FOR CENKARENG AIRPORT CONSTRUCTION PROJECT

JAPAN INTERNATIONAL COOPERATION AGENCY (JICA)



REVISIONS	DATE	DESIGNED	DRAWN	CHECKED	REVIEWED	SUBMITTED
B	1 AUG. 79	[Signature]	[Signature]	[Signature]	[Signature]	[Signature]
A	15 FEB. 79	[Signature]	[Signature]	[Signature]	[Signature]	[Signature]

AIRPORT TERMINAL BUILDING PLUMBING GENERAL NOTES AND FIXTURES SCHEDULE



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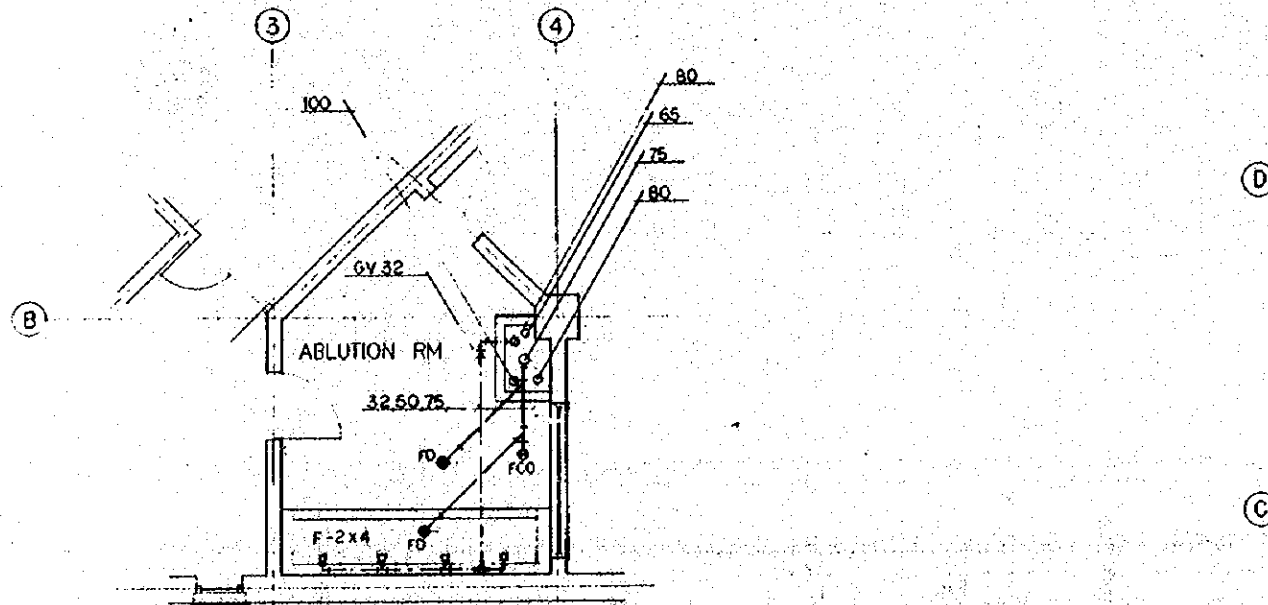
REPUBLIC OF INDONESIA MINISTRY OF COMMUNICATIONS DIRECTORATE GENERAL OF LAND TRANSPORT AND INLAND WATERWAYS					
NEW RAILWAY LINE FOR CENGKARENG AIRPORT CONSTRUCTION PROJECT					
JAPAN INTERNATIONAL COOPERATION AGENCY (JICA)					
REVISIONS	DATE	DESIGNED	DRAWN	CHECKED	SUBMITTED
B	1 AUG 79	[Signature]	[Signature]	[Signature]	[Signature]
A	15 FEB 79	[Signature]	[Signature]	[Signature]	[Signature]
AIRPORT TERMINAL BUILDING PLUMBING IF PLAN					
PACKAGE: I CIVIL AND ARCHITECTURAL WORK					
SCALE: 1:100		DRAWING NO: AM - 006			

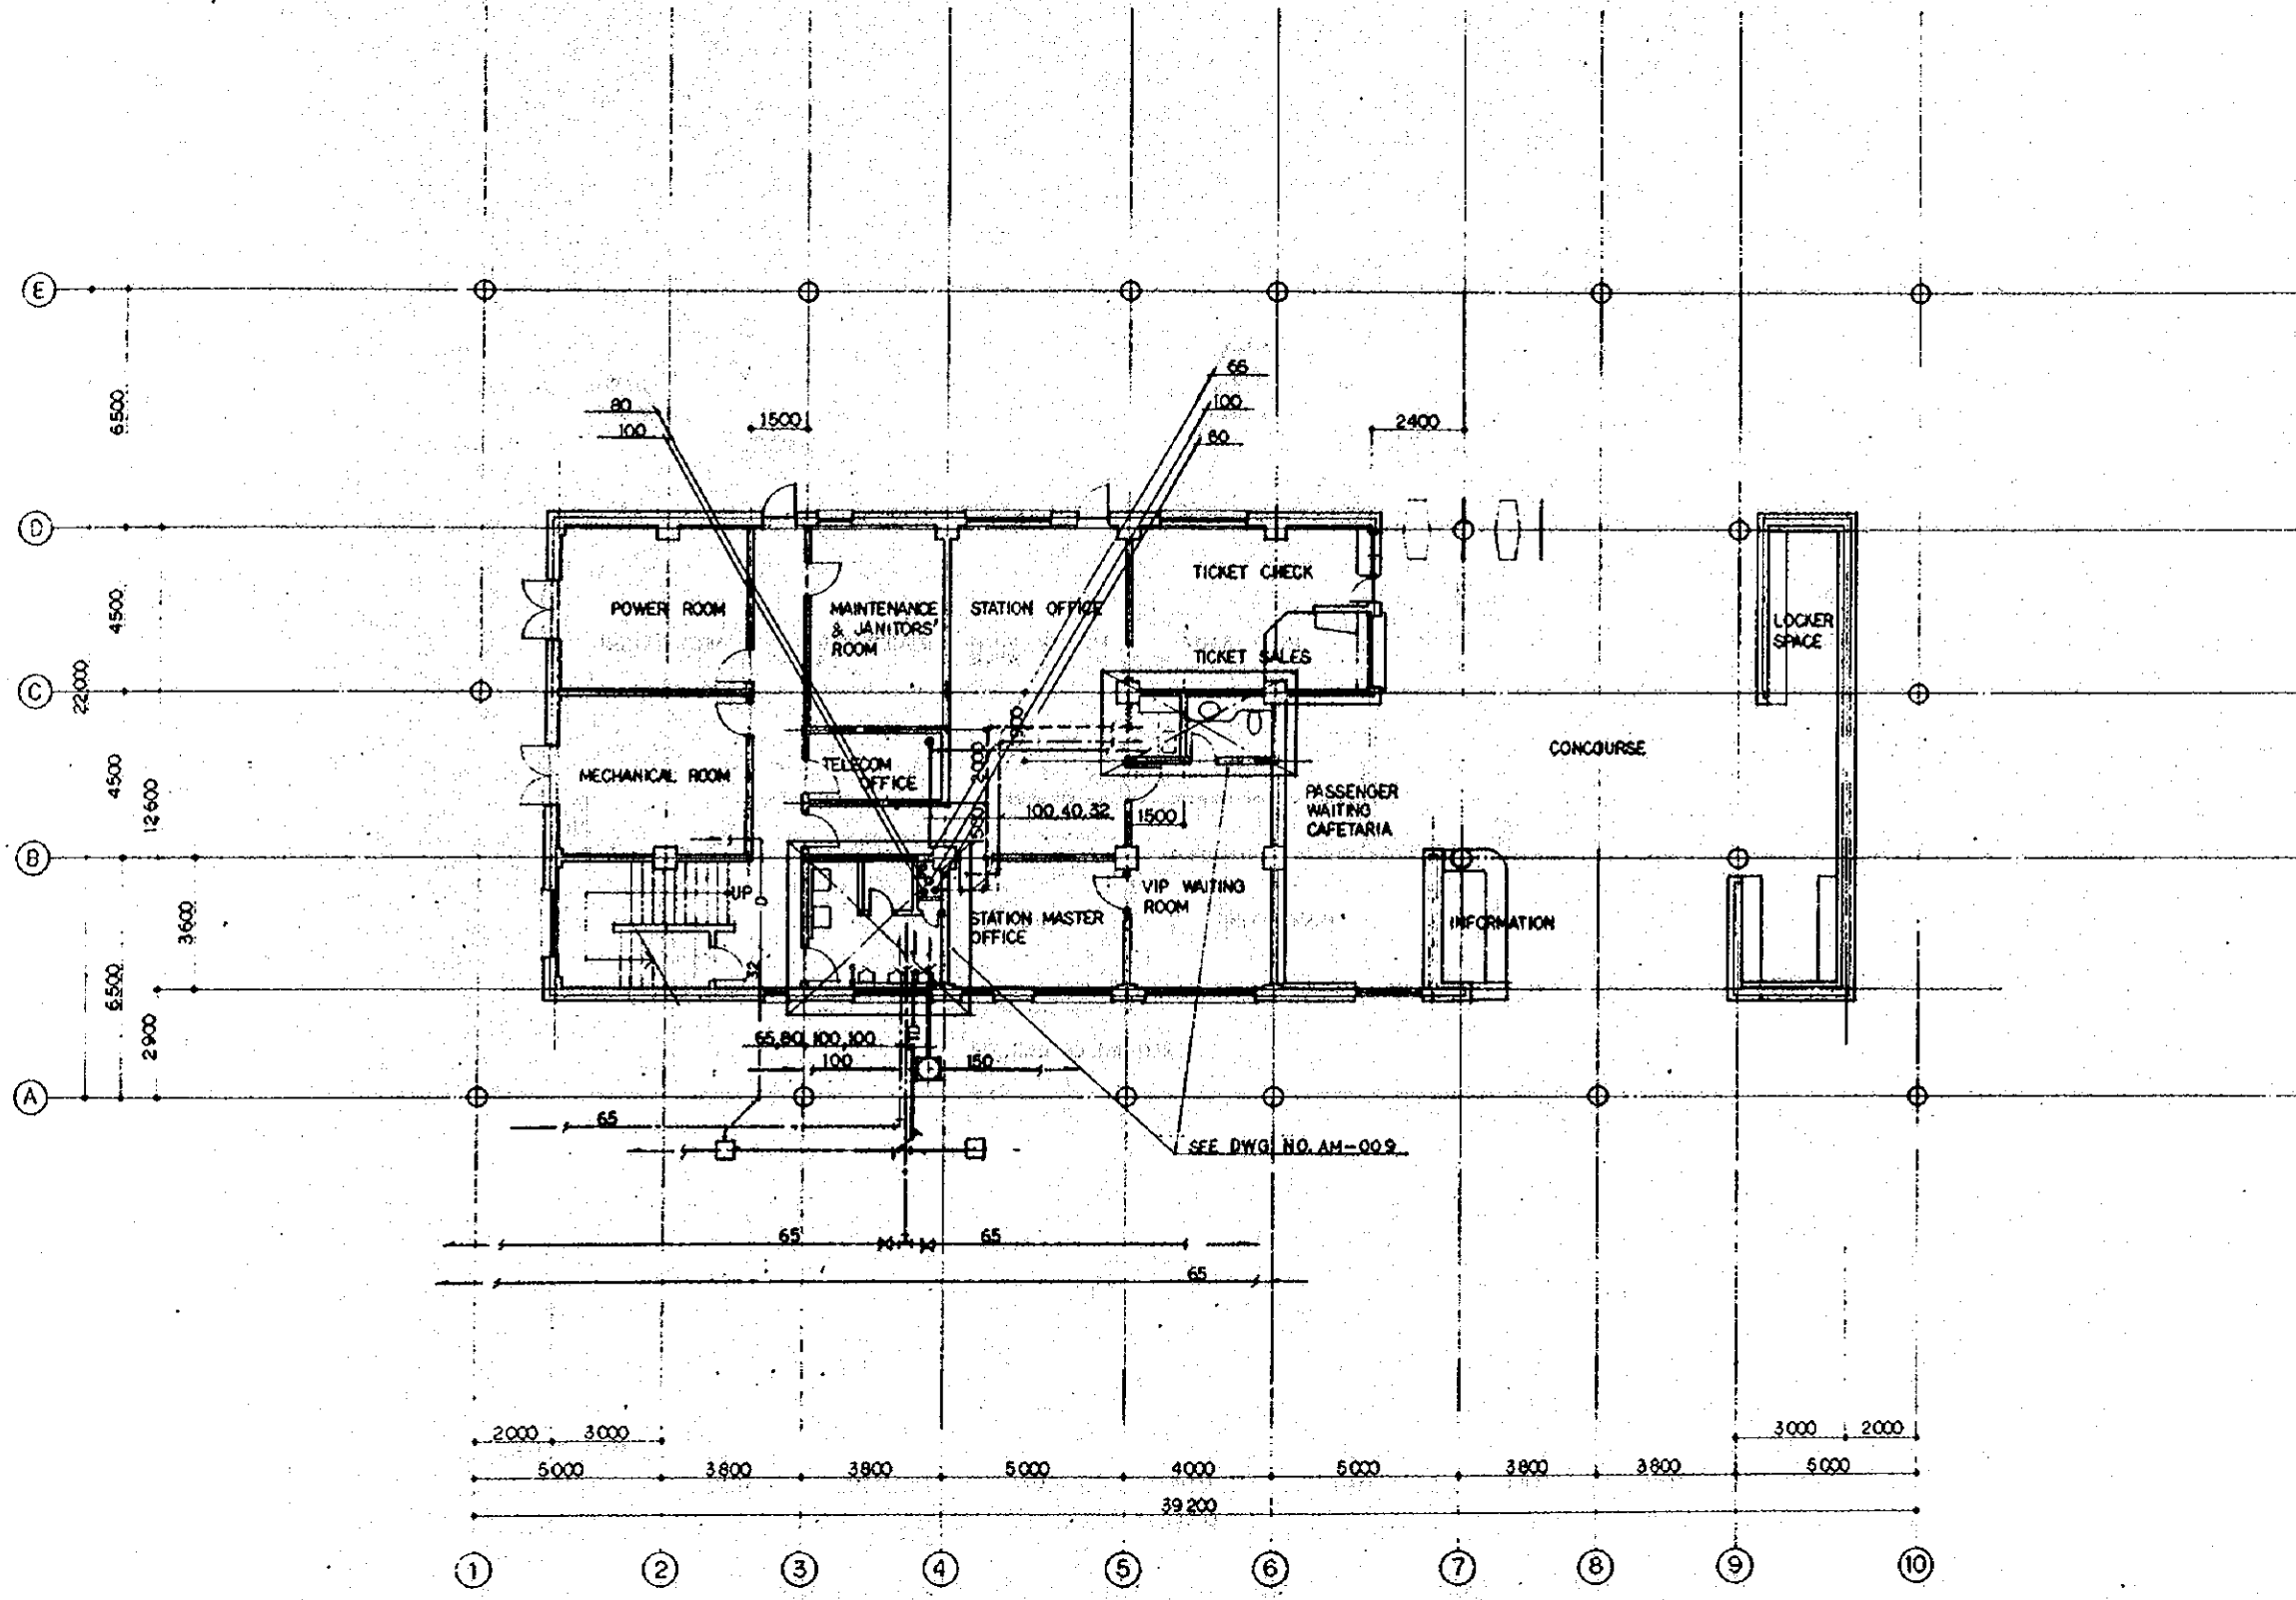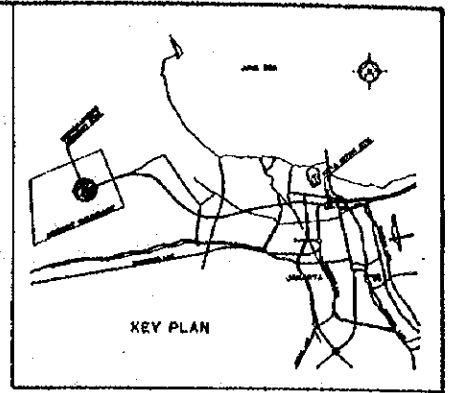


REPUBLIC OF INDONESIA MINISTRY OF COMMUNICATIONS DIRECTORATE GENERAL OF LAND TRANSPORT AND INLAND WATERWAYS						
NEW RAILWAY LINE FOR CENGKARENG AIRPORT CONSTRUCTION PROJECT						
JAPAN INTERNATIONAL COOPERATION AGENCY (JICA)						
REVISIONS	DATE	DESIGNED	DRAWN	CHECKED	REVIEWED	SUBMITTED
B	1 AUG 79	WT	WT	S. Sub. U.M.	AK	
A	15 FEB 79	WT	WT	S. Sub. U.M.	AK	
AIRPORT TERMINAL BUILDING PLUMBING 2F PLAN						
PACKAGE: I CIVIL AND ARCHITECTURAL WORK						
SCALE: 1:100		DRAWING NO.: AM - 007				

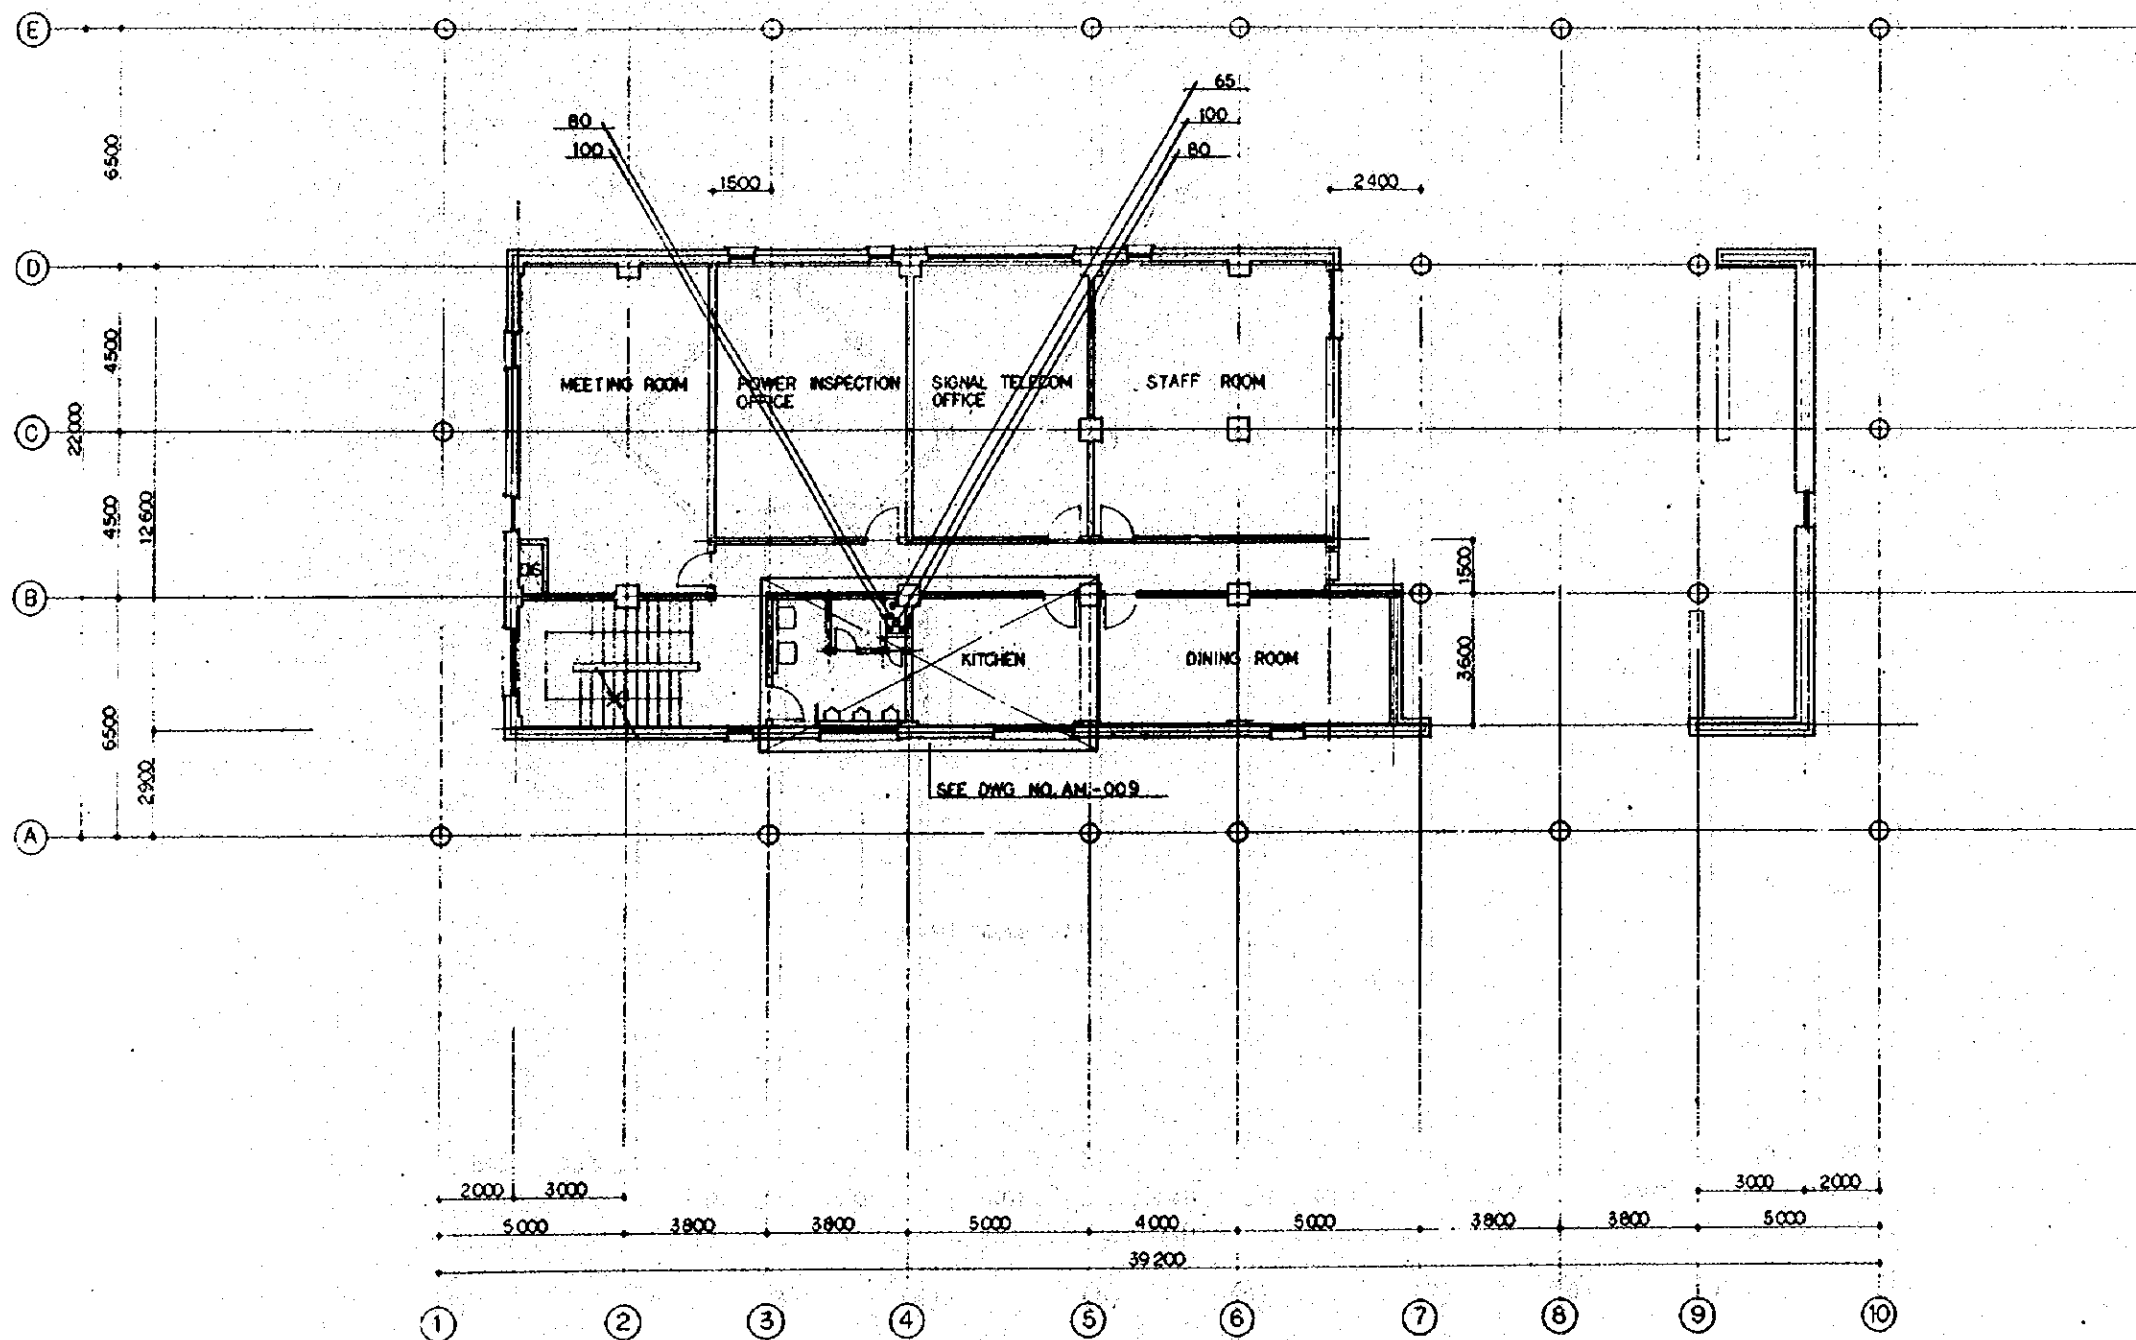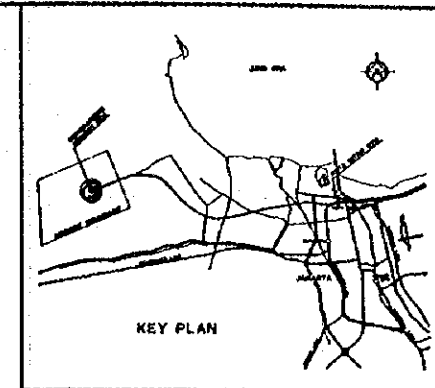


REPUBLIC OF INDONESIA MINISTRY OF COMMUNICATIONS DIRECTORATE GENERAL OF LAND TRANSPORT AND INLAND WATERWAYS					
NEW RAILWAY LINE FOR CENGKARENG AIRPORT CONSTRUCTION PROJECT					
JAPAN INTERNATIONAL COOPERATION AGENCY (JICA)					
REVISIONS	DATE	DESIGNED	DRAWN	CHECKED	REVIEWED
B	1/10/89	[Signature]	[Signature]	[Signature]	[Signature]
A	15/12/87	[Signature]	[Signature]	[Signature]	[Signature]
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INCLUDE: I CIVIL AND ARCHITECTURAL WORK					
SCALE: 1:100		DRAWING NO: AM - 008			

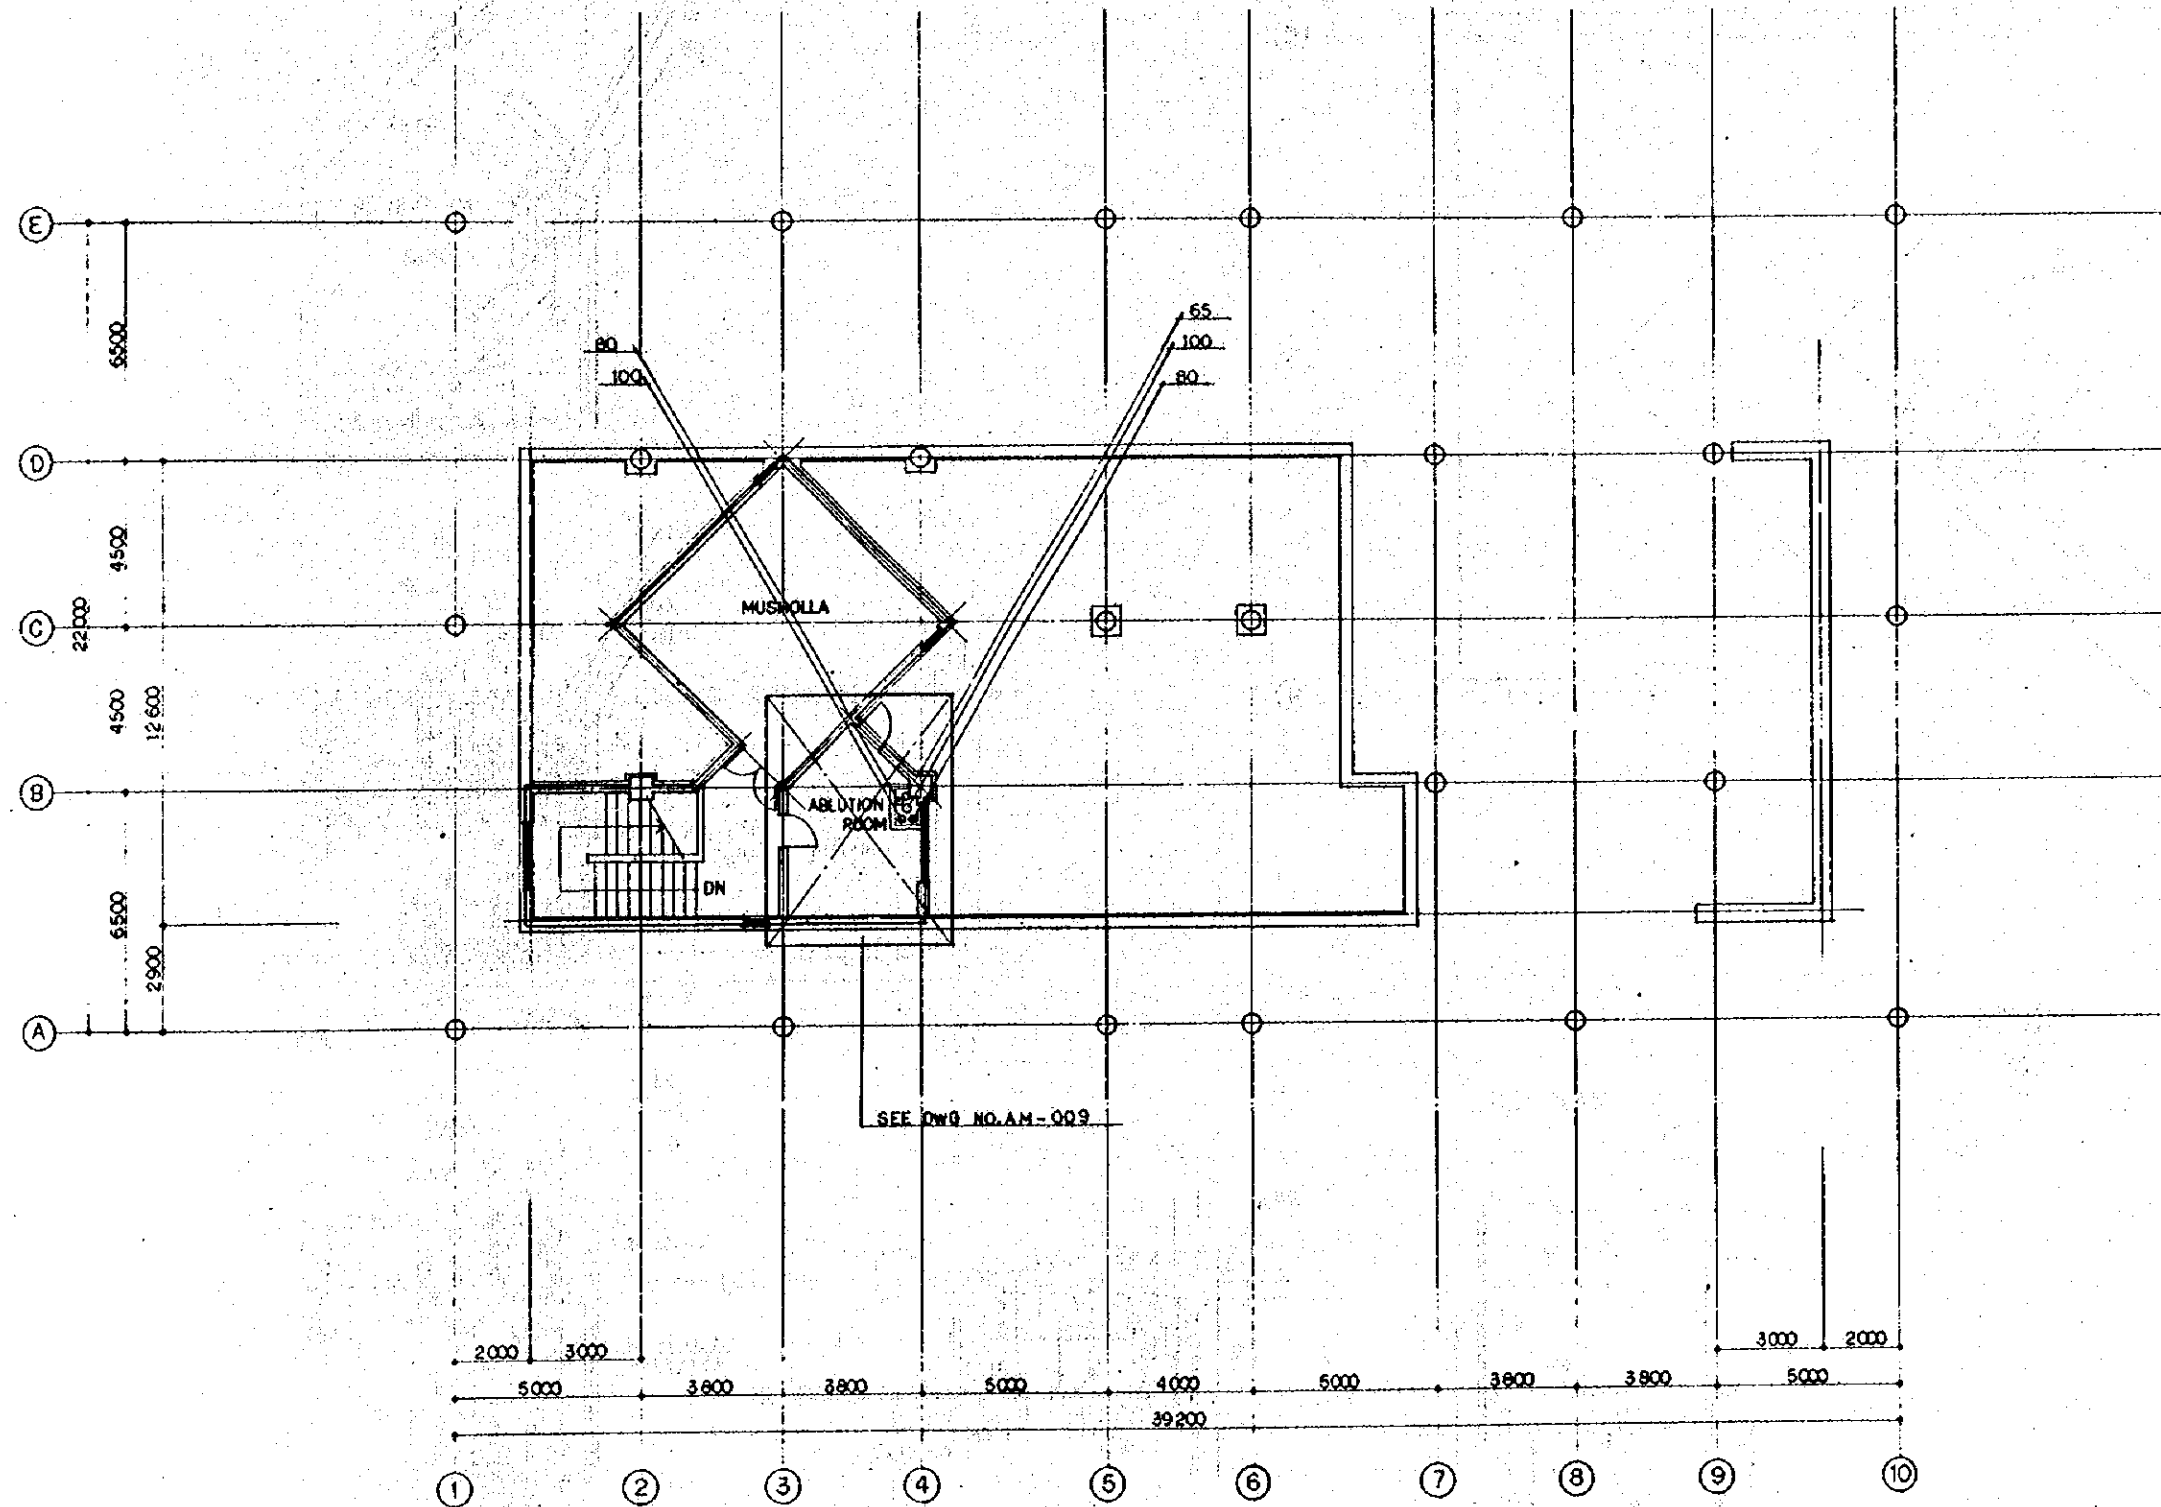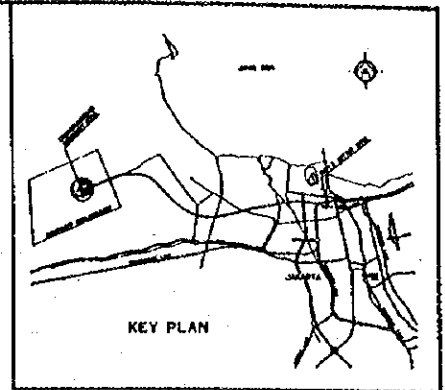


3FL PLAN

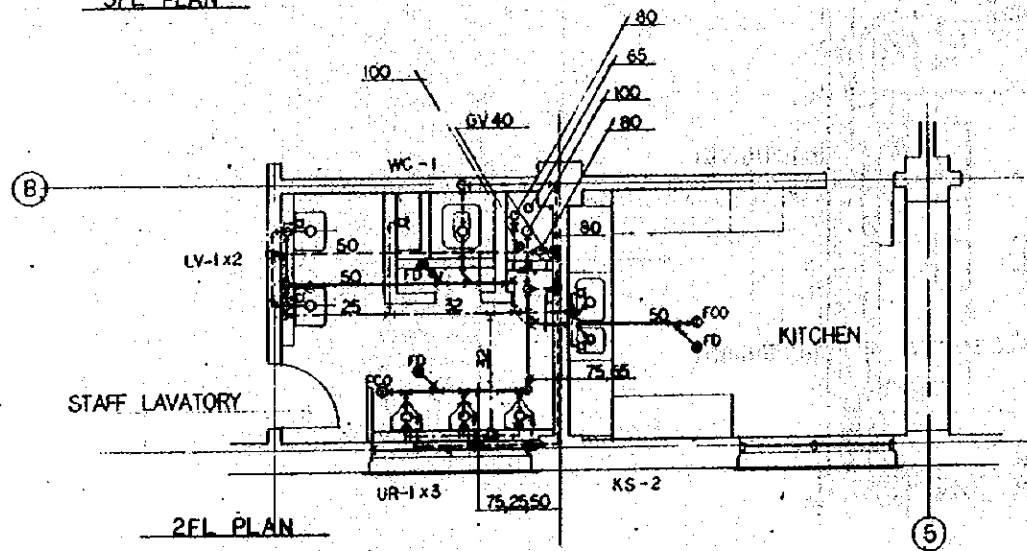


2FL PLAN

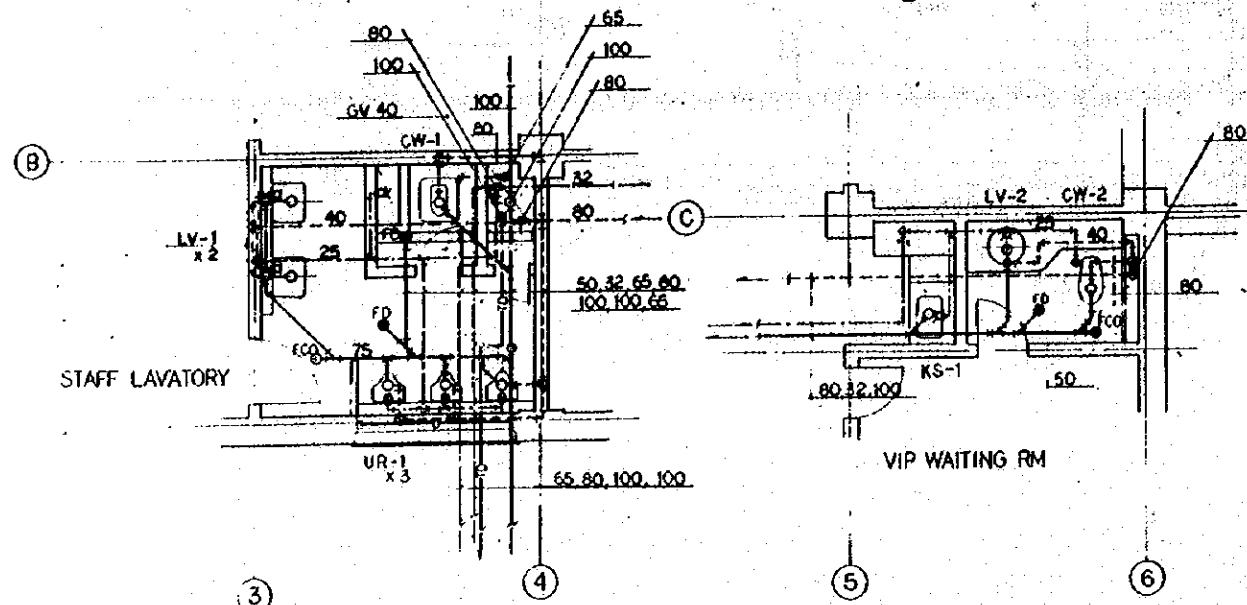

1FL PLAN


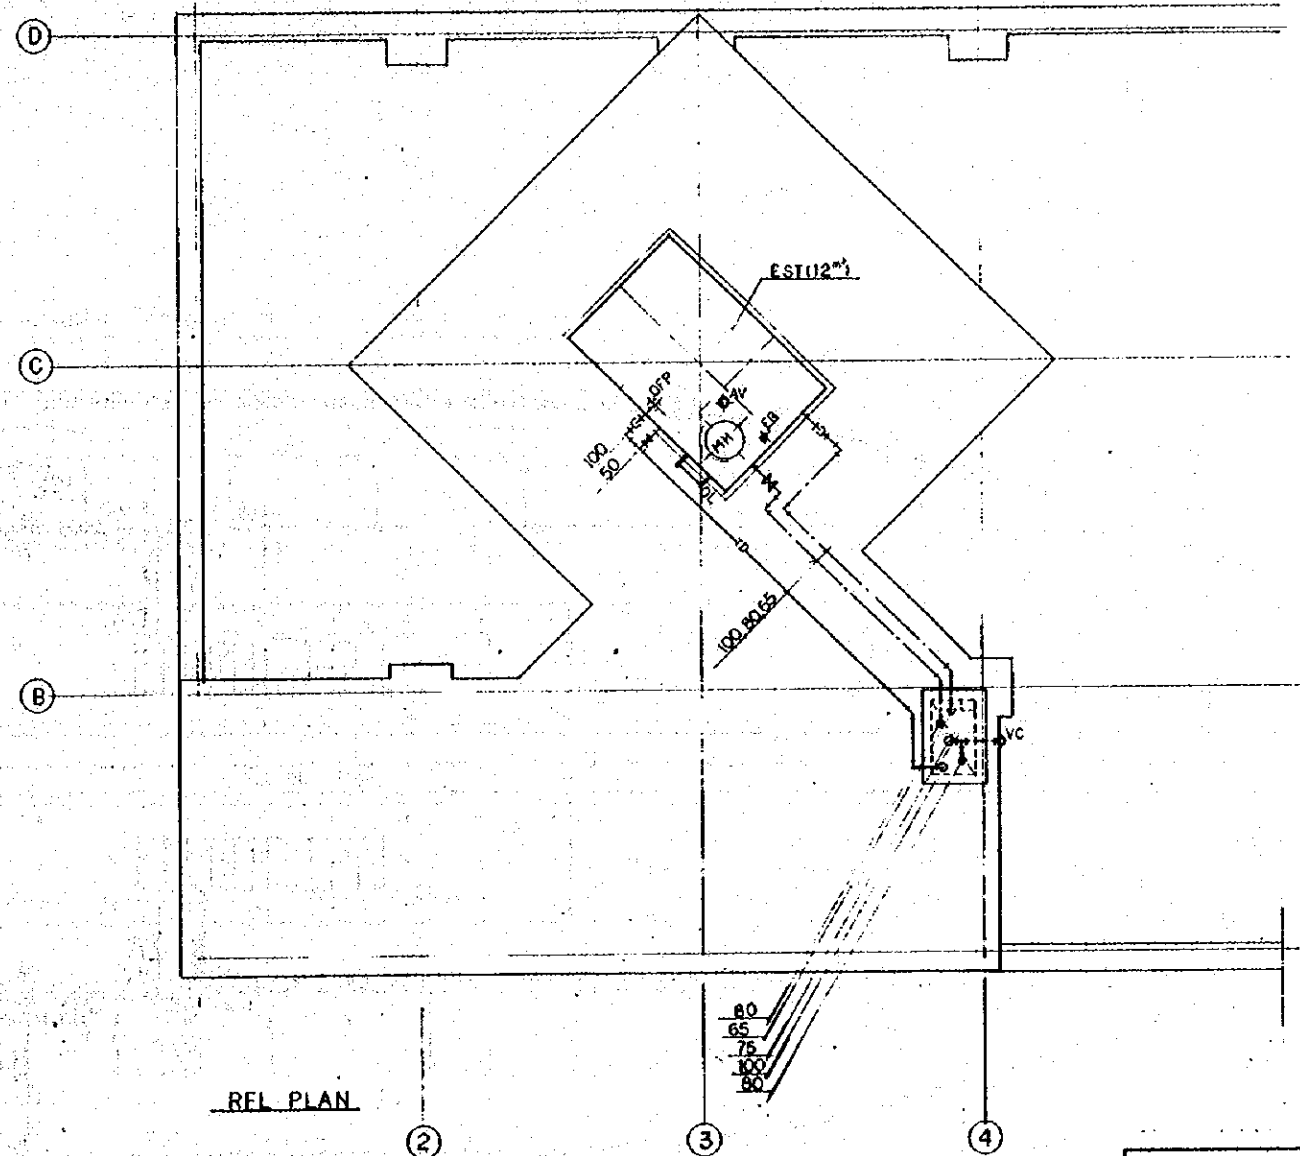


REL PLAN

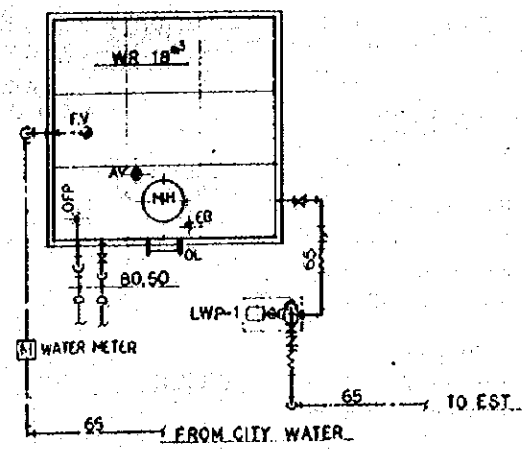

GF PLAN

REPUBLIC OF INDONESIA MINISTRY OF COMMUNICATIONS DIRECTORATE GENERAL OF LAND TRANSPORT AND INLAND WATERWAYS					
NEW RAILWAY LINE FOR CENKARENG AIRPORT CONSTRUCTION PROJECT					
JAPAN INTERNATIONAL COOPERATION AGENCY (JICA)					
REVISORS	DATE	REASON	BY	CHECKED	APPROVED
B	1 AUG 79				
A	15 FEB 79				
AIRPORT TERMINAL BUILDING PLUMBING DETAIL PLAN					
PACKAGE: 1 CIVIL AND ARCHITECTURAL WORK					
SCALE: 1:100		DRAWING NO: AM - 009			

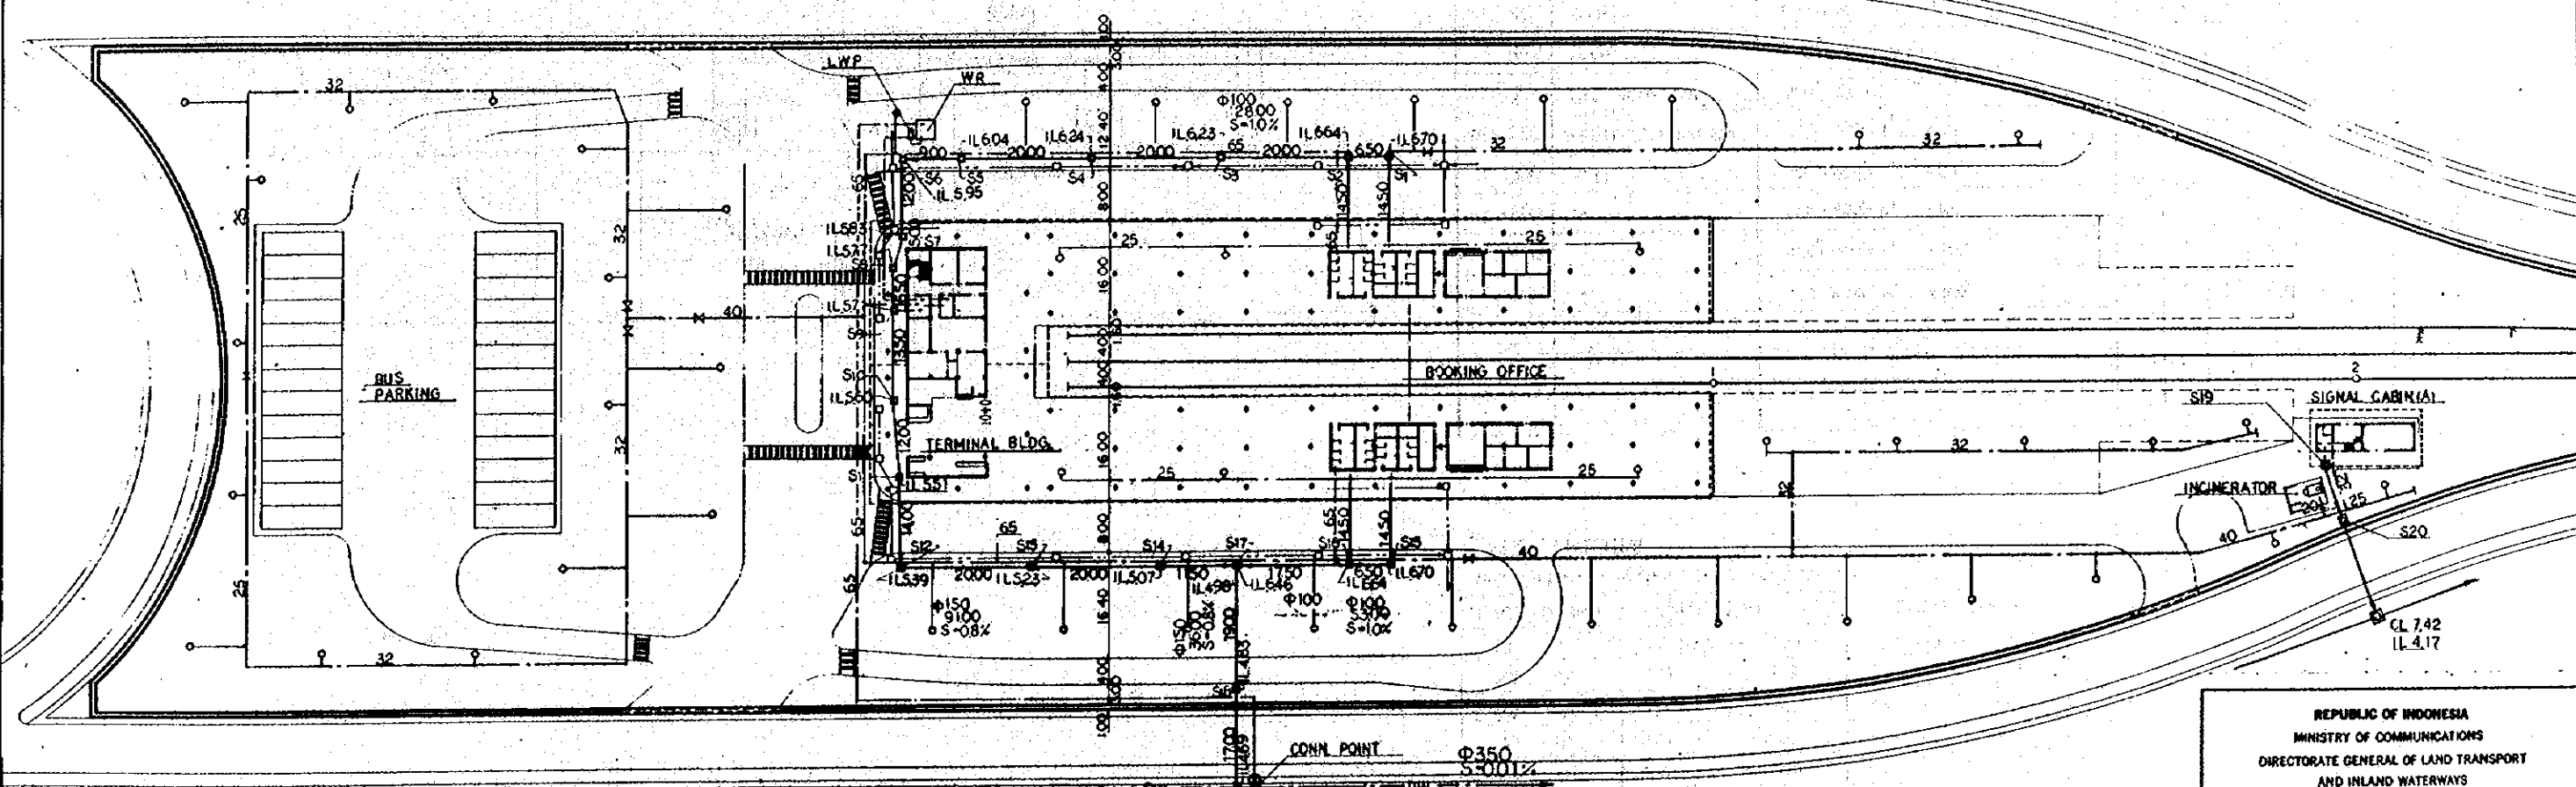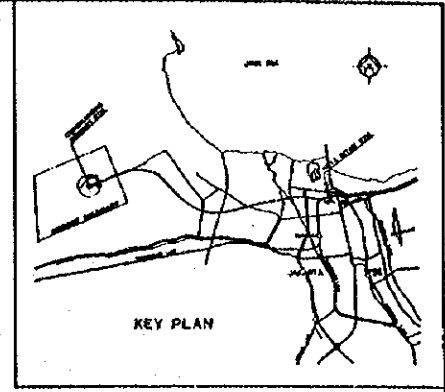

LEGEND


- DRINKING WATER
- WASTE WATER GRAVITY FLOW
- RAIN WATER
- SANITARY SEWER
- IRRIGATION VALVE 20"(F-3)

NOTES



- S1~S16, S19, S20 600x600
- S17, S18 900x900

REPUBLIC OF INDONESIA MINISTRY OF COMMUNICATIONS DIRECTORATE GENERAL OF LAND TRANSPORT AND INLAND WATERWAYS					
NEW RAILWAY LINE FOR CENGKARENG AIRPORT CONSTRUCTION PROJECT					
JAPAN INTERNATIONAL COOPERATION AGENCY (JICA)					
REVISIONS	DATE	DRAWN	CHECKED	REVIEWED	SUBMITTED
B	1 APR 79	K.P.	S.P.	K.M.	K.K.
A	15 FEB 79	S.P.	S.P.	K.M.	K.K.
AIRPORT TERMINAL STATION GENERAL SITE PLAN OF PLUMBING AND IRRIGATION SYSTEM					
PACKAGE: I CIVIL AND ARCHITECTURAL WORK					
SCALE 1:500		DRAWING NO. AM - 010			

VENTILATION SYSTEM DIAGRAM

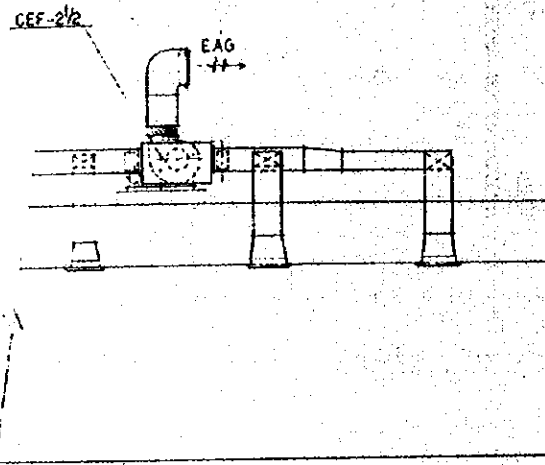

AIR CONDITIONING SYSTEM DIAGRAM

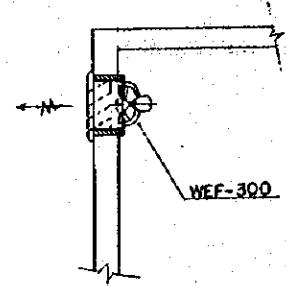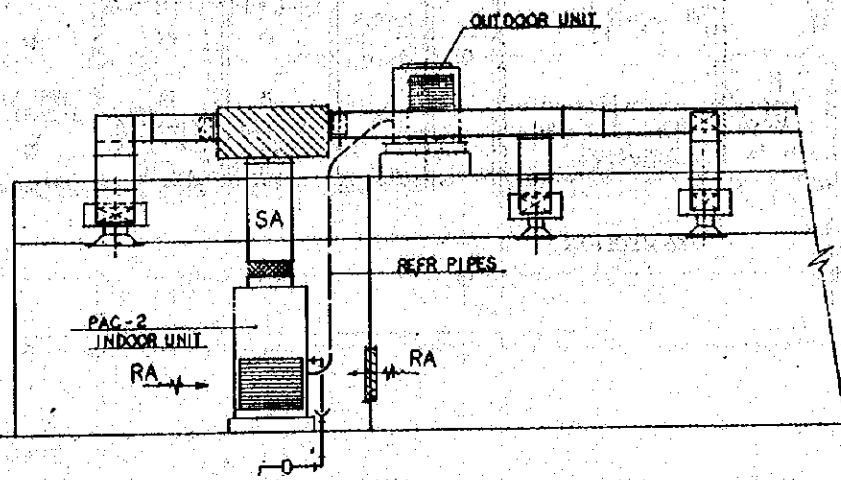

SCHEDULE OF VAC EQUIPMENT

SYMBOL	NAME OF EQUIPMENT	SPECIFICATION	ELEC DATA			ACCESSORIES	QTY
			V	PHASE	HZ		
PAC-1	AIR-COOLED TYPE PACKAGED AIR CONDITIONER	CAP: 16 RT, INDOOR-UNIT COMP. FAN 15 KW 3.7 KW OUTDOOR-UNIT FAN 0.4 KW x 2	380	3	50	REFR-PIPES	
1-2	DITTO	CAP: 6 RT, INDOOR-UNIT COMP. FAN 3.5 KW 0.55 KW OUTDOOR-UNIT FAN 0.3 KW				DITTO	1
WAC-1	WINDOW MOUNTED ROOM AIR CONDITIONER	CAP: 1.9 RT, APPROX. 650x420x760, 3.4 KW	220	1		COOLER FRAME	
1-2	DITTO	CAP: 1.4 RT, DITTO 650x420x650, 2.3 KW				DITTO	
CEF-1/2	CENTRIFUGAL FAN	1400 x 40 x 0.78 KW	380	3		ANTIVIBRATION FRAME	
1-2	DITTO	3600 x 35 x 1.5 KW				DITTO	
1-2 1/2	DITTO	8600 x 45 x 2.2 KW				DITTO	1
PEF-200	PIPE EXHAUST FAN	200 x 300 x 10 m ³ /hr mmHg x 75 W	220	1		HS	
WEF-250	WALL-TYPE EXHAUST FAN	250 x 300 x 6 m ³ /hr mmHg x 25 W				EAG	
1-300	DITTO	300 x 600 x 8 x 50				DITTO	1
1-350	DITTO	350 x 850 x 8 x 100				DITTO	
1-400	DITTO	400 x 1300 x 8 x 200				DITTO	
1-500	DITTO	500 x 1800 x 15 x 300				DITTO	

DUCT MATERIAL

MINIMUM DUCT GALVANIZED SHEET STEEL METAL GAGES

GAGE / THICKNESS	RECTANGULAR (mm)	ROUND (mm)
26 0.5 APPROX	UP THROUGH 300	UP THROUGH 200
24 0.6	325 x 762	256 x 558
22 0.8	778 x 1300	583 x 900
20 1.0	1325 x 2130	925 x 1270
18 1.2	2155 x 3050	

1) DIMENSION OF LONGEST SIDE

REPUBLIC OF INDONESIA
 MINISTRY OF COMMUNICATIONS
 DIRECTORATE GENERAL OF LAND TRANSPORT AND INLAND WATERWAYS

NEW RAILWAY LINE FOR CENKARENG AIRPORT CONSTRUCTION PROJECT




JAPAN INTERNATIONAL COOPERATION AGENCY (JICA)

B	1/20/89	OK	OK	OK	K.M.	K.K.
A	15/FEB/89	OK	OK	OK	K.M.	K.K.

REVISIONS DATE DESIGNED DRAWN CHECKED REFERED SUBMITTED


BOOKING OFFICE
 VAC
 GENERAL NOTES AND APPARATUS SCHEDULE

PACKAGE: I CIVIL AND ARCHITECTURAL WORK
 SCALE: NONE DRAWING NO: AM - 011

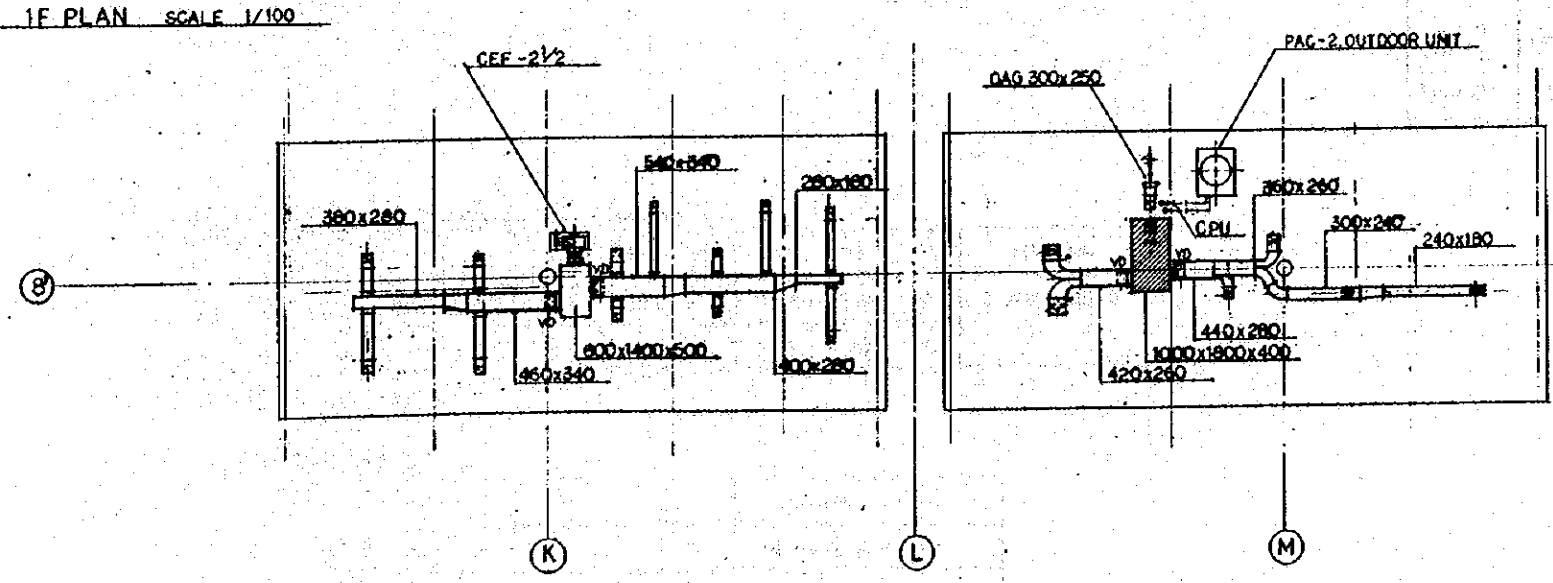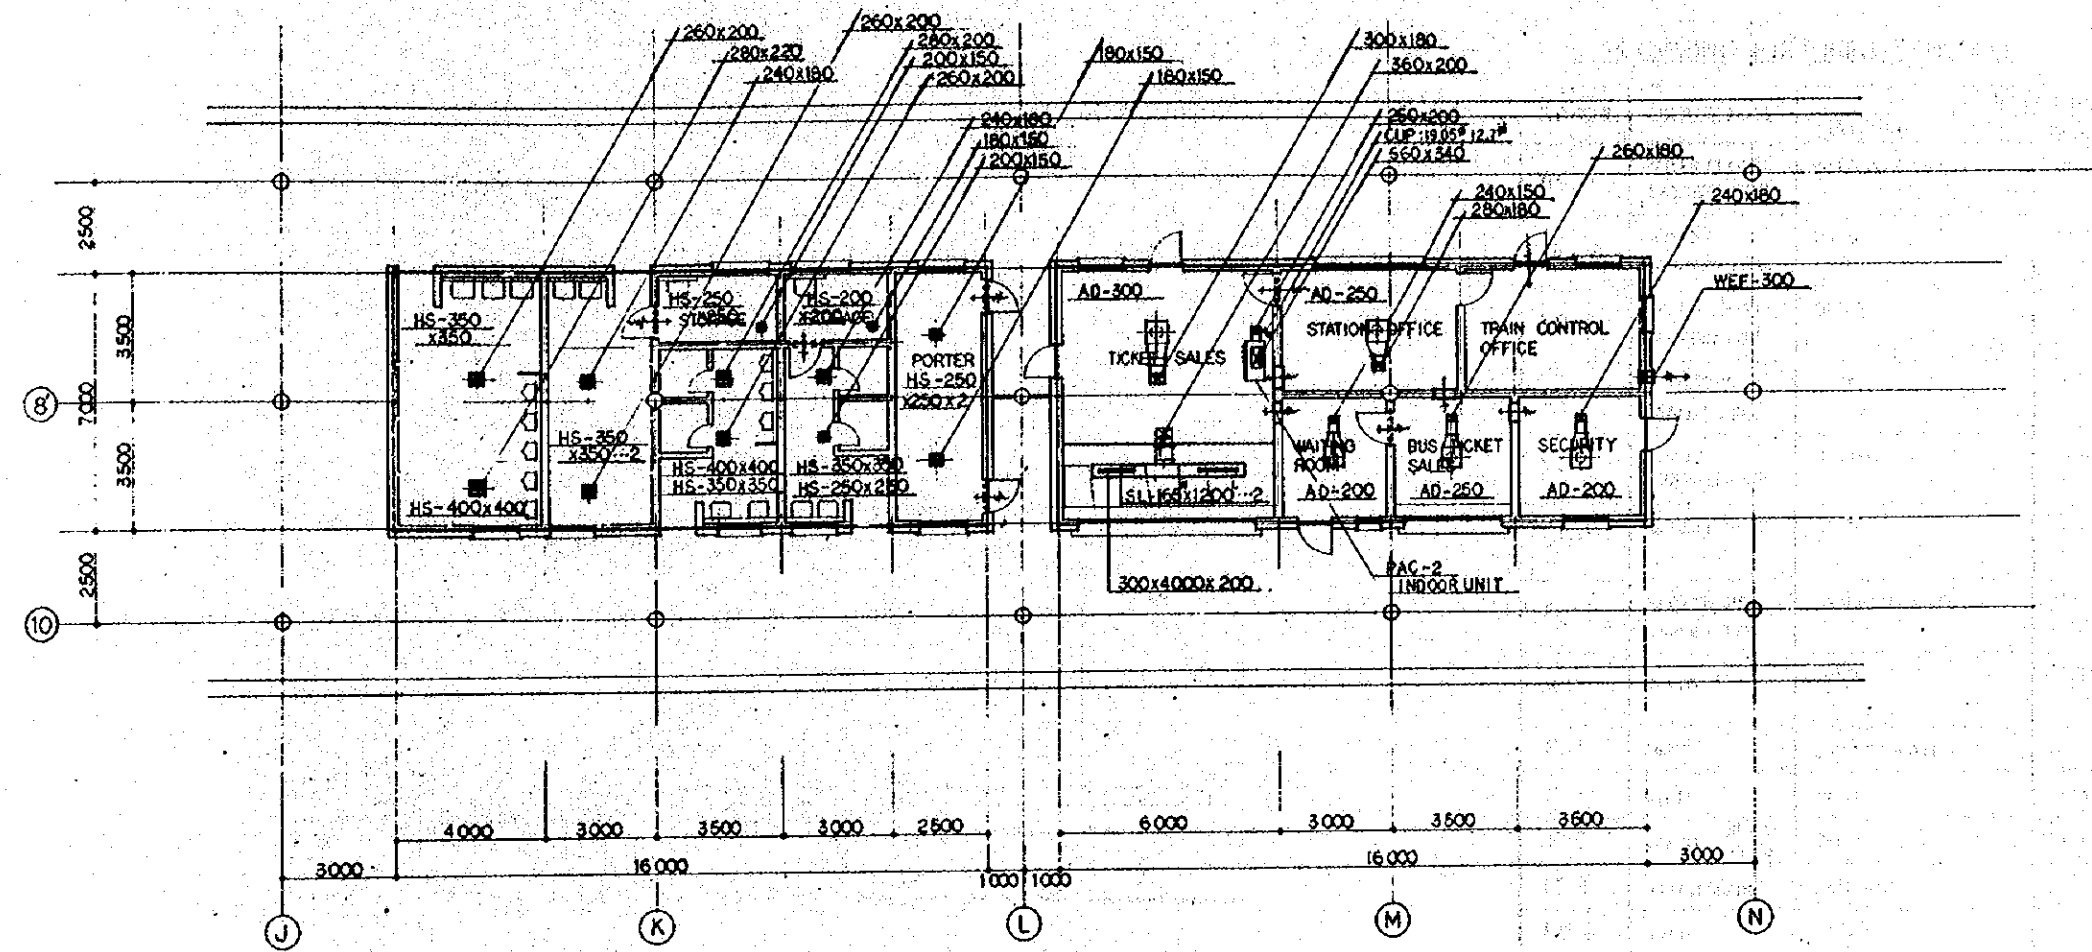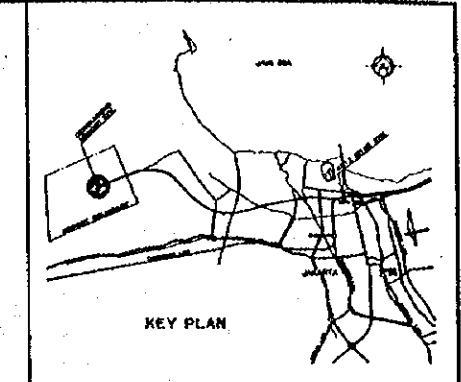

REPUBLIC OF INDONESIA MINISTRY OF COMMUNICATIONS DIRECTORATE GENERAL OF LAND TRANSPORT AND INLAND WATERWAYS					
NEW RAILWAY LINE FOR CENGKARENG AIRPORT CONSTRUCTION PROJECT					
JAPAN INTERNATIONAL COOPERATION AGENCY (JICA)					
REVISIONS	DATE	DESIGNED	DRAWN	CHECKED	SUBMITTED
B	1 AUG 89	MT	MT	Y. K.M.	M.K.
A	15 FEB 89	MT	MT	Y. K.M.	M.K.
BOOKING OFFICE VAC 1F AND RF PLAN					
PACKAGE: I CIVIL AND ARCHITECTURAL WORK					
SCALE: 1:100		DRAWING NO: AM - 012			

PLUMBING SYSTEM DIAGRAM

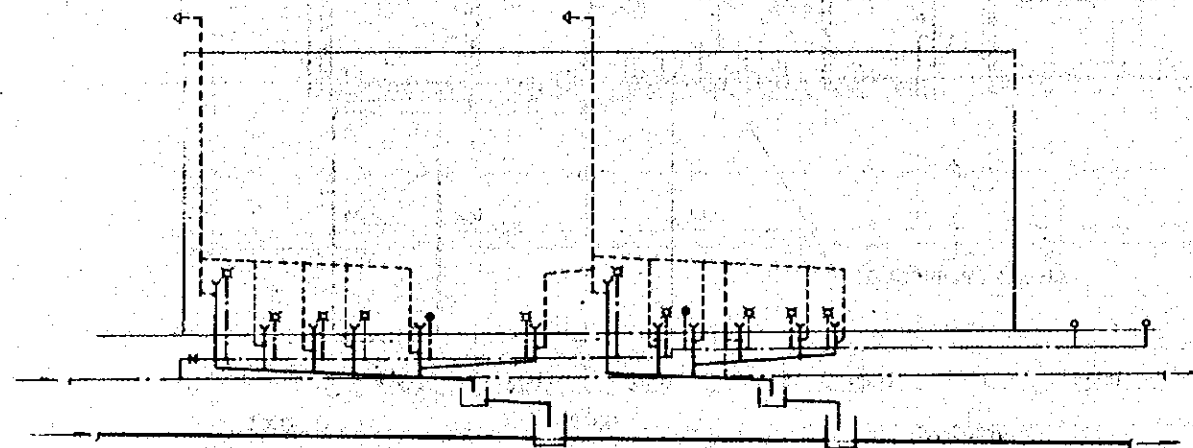

PLUMBING FIXTURES SCHEDULE

SYMBOL	FIXTURE NAME	DESCRIPTION			QTY	CONNECTION PIPE		
		MATERIAL	SIZE APPROX.	ACCESSORIES		WATER	WASTE	VENT
WC-1	WATER CLOSET EASTERN TYPE	VITREOUS CHINA	280x570x300 ^H	P-TRAP, F-2	6	25	100	80
WC-2	DITTO WESTERN TYPE	DITTO	360x600x360 ^H	DITTO, FLUSH-VALVE, TOILET PAPER HOLDER	4	25	100	80
UR-1	URINAL, FLOOR MOUNTED TYPE	DITTO	380x380x920 ^H	FLUSH-VALVE, INLET SPUD	8	20	75	50
LV-1	LAVATORY WALL HUNG	DITTO	530x430	F-1, P-TRAP, SHUT OFF VALVE, CONNECTING PIPE	9	20	50	40
LV-2	DITTO COUNTER-TOP	DITTO	480 ^H	DITTO		20	50	40
SK-1	SERVICE SINK	DITTO	560x450x630 ^H	F-2, SINK-TRAP	2	20	75	40
KS-1	KITCHEN SINK CABINET TYPE	STAINLESS STEEL	1000x560x800 ^H	F-1, SINK-TRAP		20	50	40
KS-2	DITTO	DITTO	1500x560x800 ^H	DITTO		20	50	40
F-1	FAUCET	CHROME PLATED	1/2			20		
F-2	DITTO	DITTO	3/4			25		
F-3	DITTO FOR IRRIGATION	DITTO	3/4	VALVE-BOX, W/KEY		25		
FD-1	FLOOR DRAIN	CAST IRON		WASTE FITTING	8		50	
FD-2	DITTO	DITTO		DITTO			75	
LWP-1	LIFT WATER PUMP CENTRIFUGAL-TYPE	65-50x550 x 24 x 3.7 ^{HP}						
LWP-2	DITTO	50-40x250 x 24 x 2.2 ^{HP}						

NOTES: PIPING

1. GALVANIZED STEEL PIPES FOR POTABLE WATER, VENT AND DRAIN

SIZE NOMINAL	15	20	25	32	40	50	65	80	100	125	150	REMARKS
OUTSIDE DIAMETER	21.7	27.2	34.0	42.7	48.6	60.5	76.3	89.1	114.3	139.8	165.2	SCREW-JOINTED
WALL THICKNESS	2.8	2.8	3.2	3.5	3.5	3.8	4.2	4.2	4.5	4.5	4.6	

FITTINGS SHALL COMPLY WITH THE PIPE MATERIAL.

2. CAST IRON PIPE FOR SOIL AND SEWER

SIZE NOMINAL	50	75	100	125	150	200	REMARKS
OUTSIDE DIAMETER	59	84	109	134	159	212	ONE TOUCH JOINT-TYPE
WALL THICKNESS	4.5	4.5	4.5	4.5	4.5	6.0	

FITTINGS SHALL COMPLY WITH THE PIPE MATERIAL.

REPUBLIC OF INDONESIA
 MINISTRY OF COMMUNICATIONS
 DIRECTORATE GENERAL OF LAND TRANSPORT AND INLAND WATERWAYS

NEW RAILWAY LINE FOR GENGKARENG AIRPORT CONSTRUCTION PROJECT

JAPAN INTERNATIONAL COOPERATION AGENCY (JICA)



B	1 AUG 89	DESIGNED	CHKD	BY	K.M	AK
A	15 FEB 89	DESIGNED	CHKD	BY	K.M	AK

REVISIONS: DATE, DESIGNED, CHECKED, REVISION, SUBMITTED


BOOKING OFFICE
 PLUMBING
 GENERAL NOTES AND
 FIXTURES SCHEDULE

PACKAGE: 1 CIVIL AND ARCHITECTURAL WORK

SCALE: NONE DRAWING NO: AM - 013

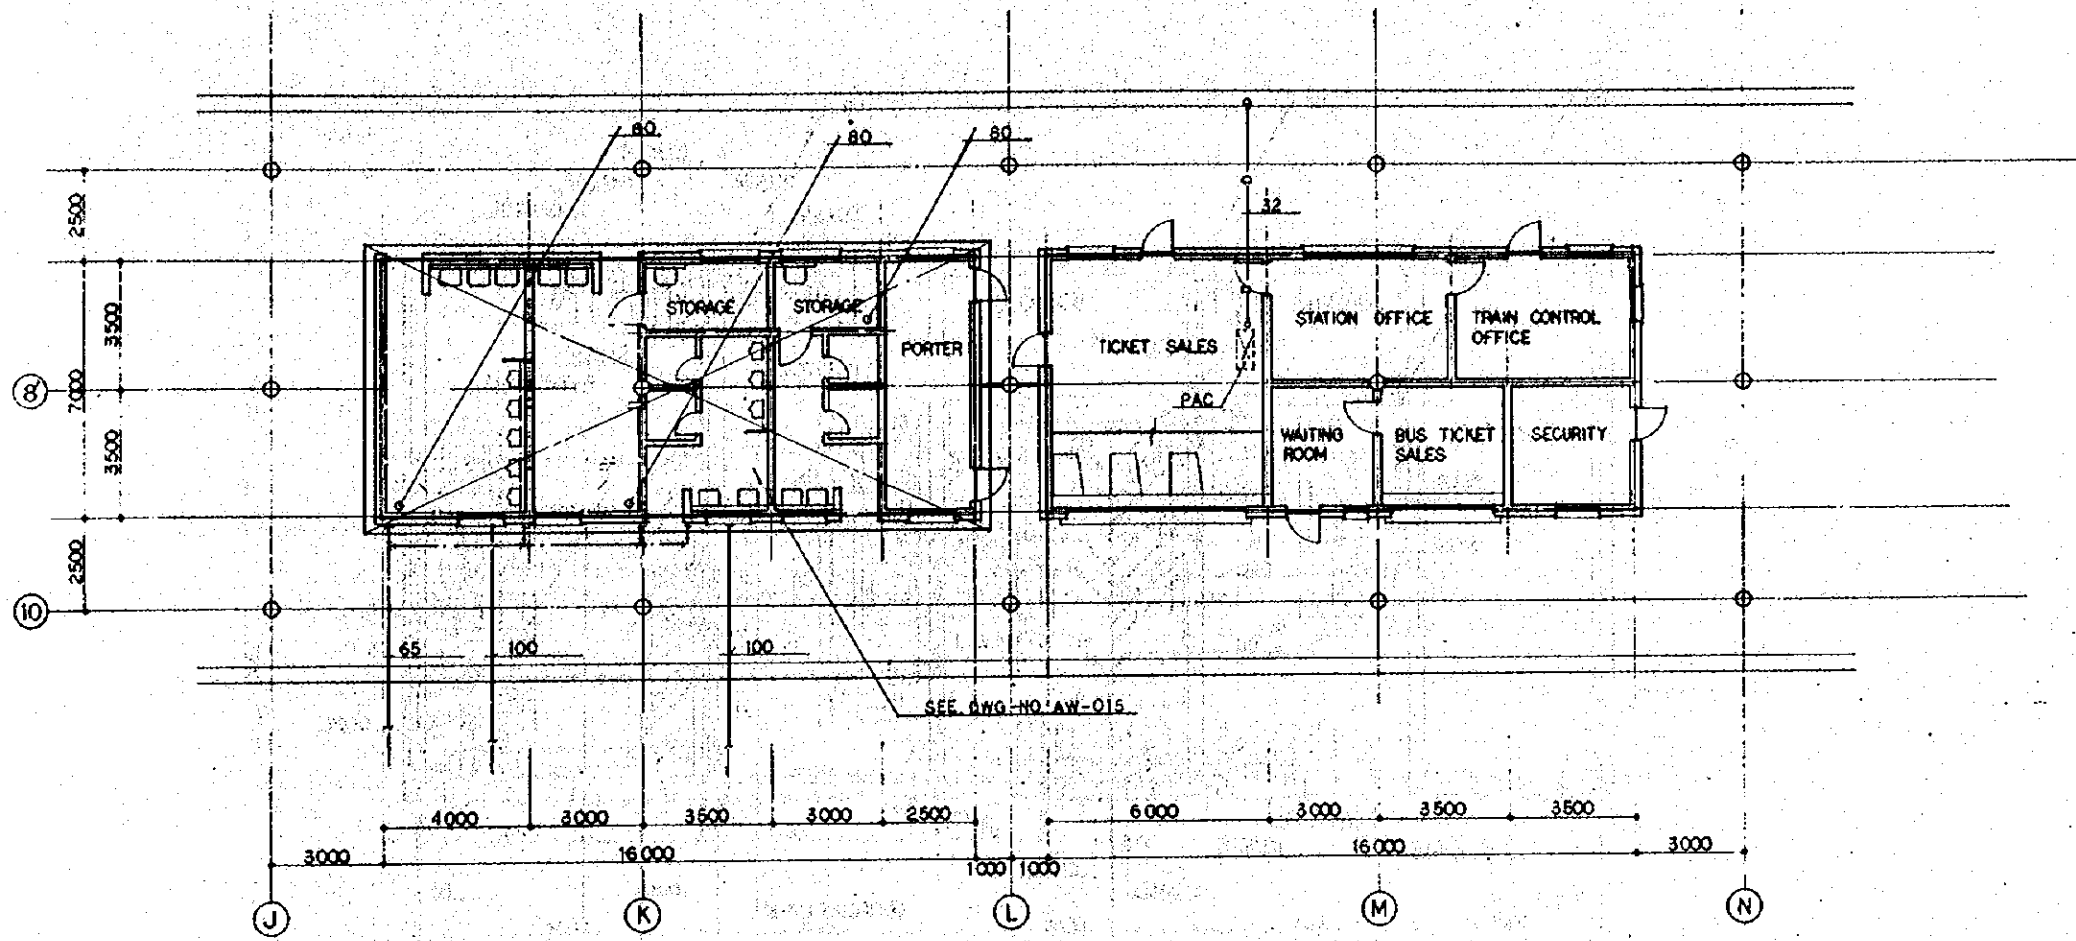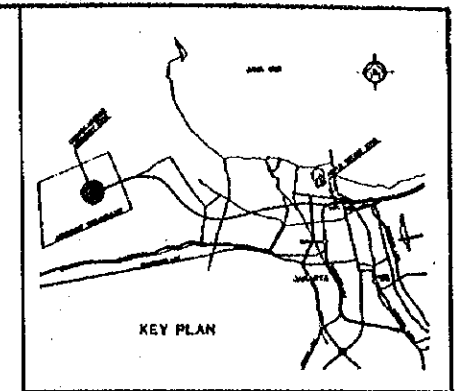


REPUBLIC OF INDONESIA MINISTRY OF COMMUNICATIONS DIRECTORATE GENERAL OF LAND TRANSPORT AND INLAND WATERWAYS					
NEW RAILWAY LINE FOR CENGKARENG AIRPORT CONSTRUCTION PROJECT					
JAPAN INTERNATIONAL COOPERATION AGENCY (JICA)					
REVISIONS	DATE	DESIGNED	DRAWN	CHECKED	APPROVED
B	1/29/84	[Signature]	[Signature]	[Signature]	[Signature]
A	1/28/84	[Signature]	[Signature]	[Signature]	[Signature]
BOOKING OFFICE PLUMBING IF PLAN					
PACKAGE: I CIVIL AND ARCHITECTURAL WORK					
SCALE: 1:100		DRAWING NO.: AM - 014			

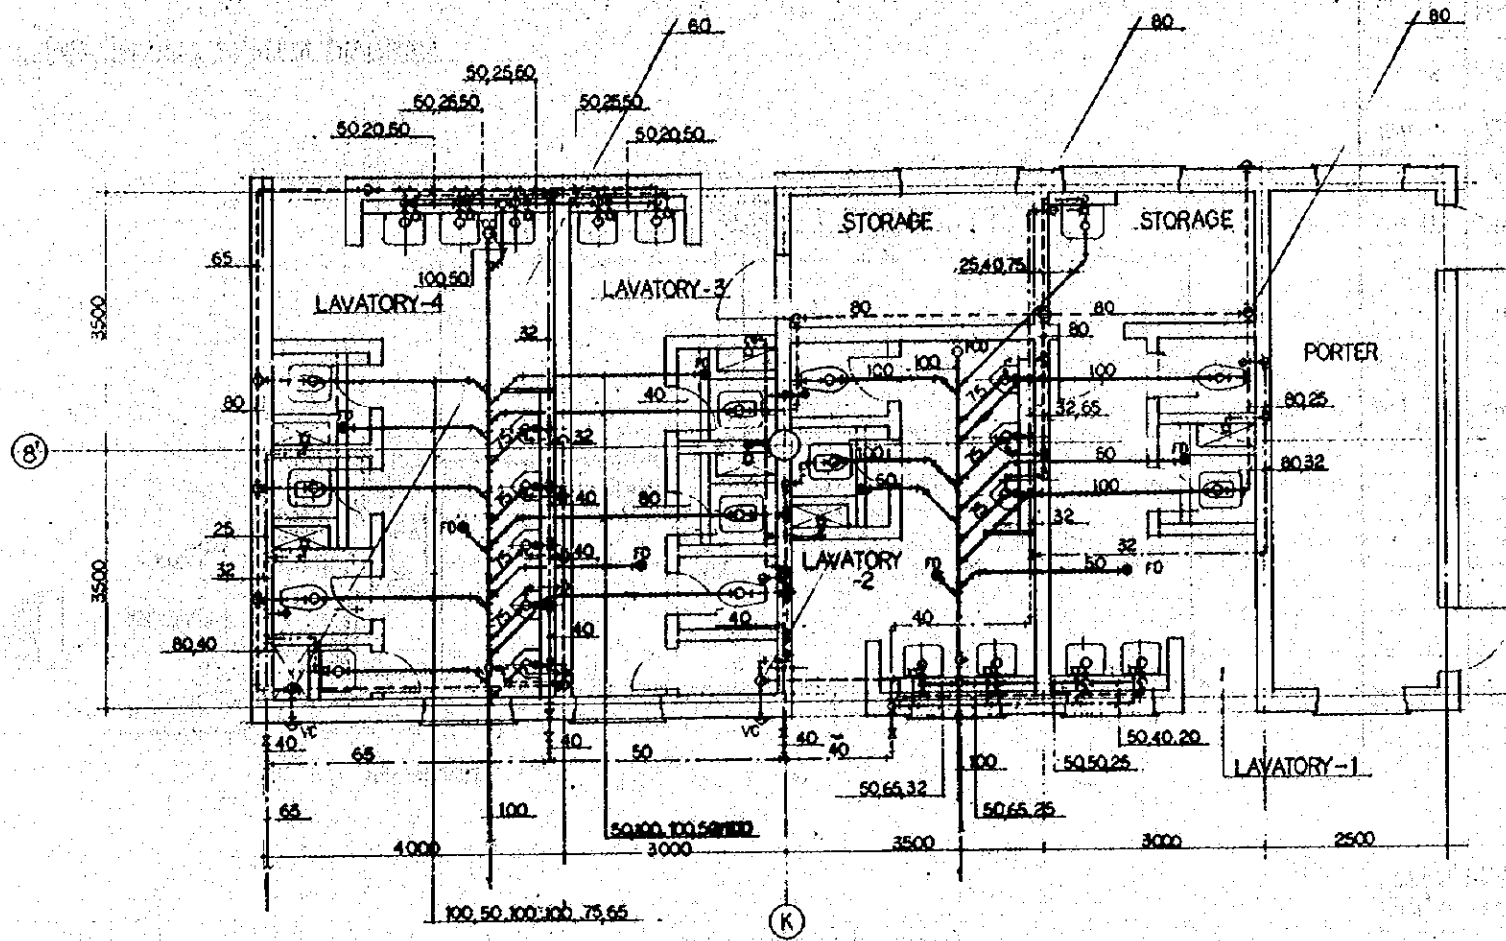

REPUBLIC OF INDONESIA MINISTRY OF COMMUNICATIONS DIRECTORATE GENERAL OF LAND TRANSPORT AND INLAND WATERWAYS					
NEW RAILWAY LINE FOR CENGKARENG AIRPORT CONSTRUCTION PROJECT					
JAPAN INTERNATIONAL COOPERATION AGENCY (JICA)					
B	1 AUG 89	HT	HT	Supdy	K.M. m.k
A	15 FEB 89	HT	HT	Supdy	K.M. m.k
REVISIONS	DATE	DESIGNED	DRAWN	CHECKED	REVIEWED
BOOKING OFFICE PLUMBING DETAIL PLAN					
PACKAGE: I CIVIL AND ARCHITECTURAL WORK					
SCALE	DRAWING NO.				
1:100	AM - 015				


AIR CONDITIONING SYSTEM DIAGRAM

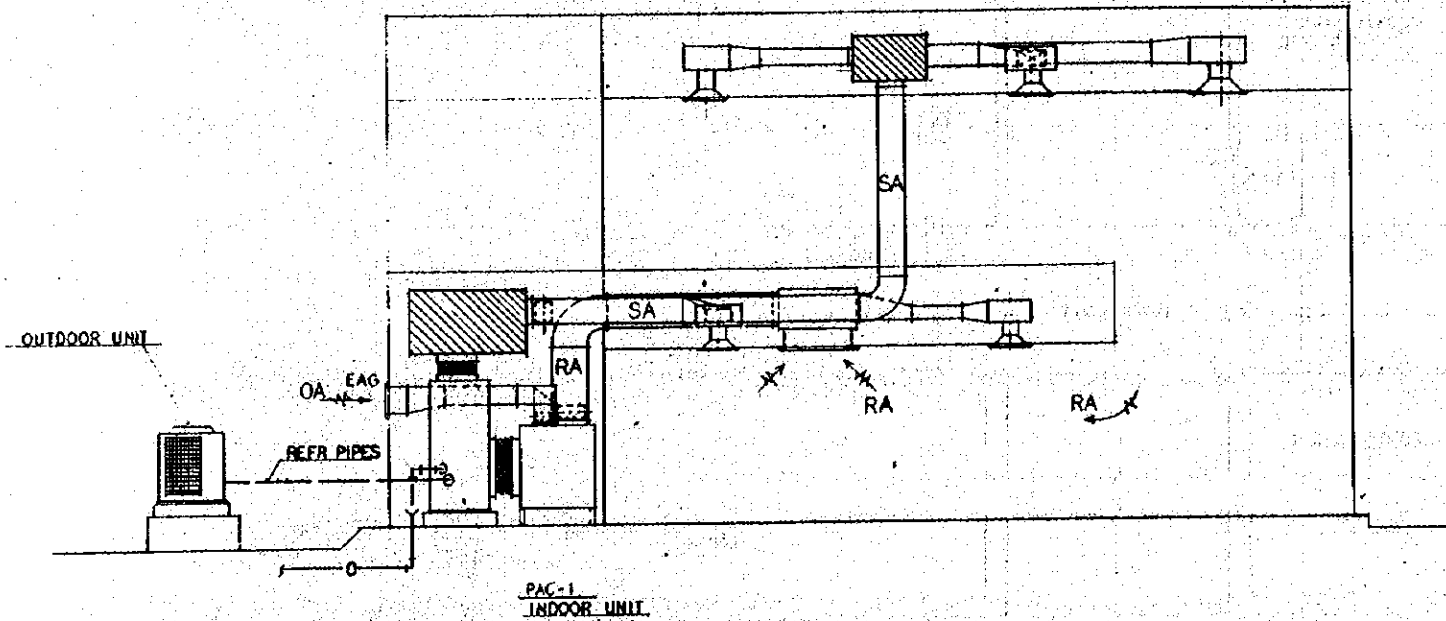

SCHEDULE OF VAC EQUIPMENT

SYMBOL	NAME OF EQUIPMENT	SPECIFICATION	ELEC DATA			ACCESSORIES	QTY
			V	PHASE	HZ		
PAC-1	AIR-COOLED TYPE PACKAGED AIR CONDITIONER	CAP: 16 RT, INDOOR-UNIT ^{COMP. FAN} 15 KW 3.7 KW OUTDOOR-UNIT ^{FAN} 0.9 KW x 2	380	3	60	REFR-PIPES	1
PAC-2	DITTO	CAP: 6 RT, INDOOR-UNIT ^{COMP. FAN} 5.5 KW 0.55 KW OUTDOOR-UNIT ^{FAN} 0.3 KW				DITTO	
WAC-1	WINDOW MOUNTED ROOM AIR CONDITIONER	CAP: 1.9 RT, APPROX. 650x420x760 ^D 3.4 KW	220	1		COOLER FRAME	
WAC-2	DITTO	CAP: 1.4 RT, DITTO 650x420x650 ^D 2.3 KW				DITTO	4
CEF-1/2	CENTRIFUGAL FAN	1400 ^{mm} x 40 ^{mm} x 0.75 KW	380	3		ANTIVIBRATION FRAME	
CEF-2	DITTO	3600 x 35" x 1.5'				DITTO	1
CEF-2/2	DITTO	5600 x 45" x 2.2'				DITTO	
PEF-200	PIPE EXHAUST FAN	200 ^{mm} x 300 x 10 ^{mm} x 75 W	220	1		HS	
WEF-250	WALL-TYPE EXHAUST FAN	250 ^{mm} x 300 x 6 ^{mm} x 25 W				EAG	
WAC-300	DITTO	300 x 600 x 8' x 50'				DITTO	2
WAC-350	DITTO	350 x 650 x 8' x 100'				DITTO	4
WAC-400	DITTO	400 x 1500 x 8' x 200'				DITTO	5
WAC-500	DITTO	500 x 1600 x 15' x 300'				DITTO	1

VENTILATION SYSTEM DIAGRAM

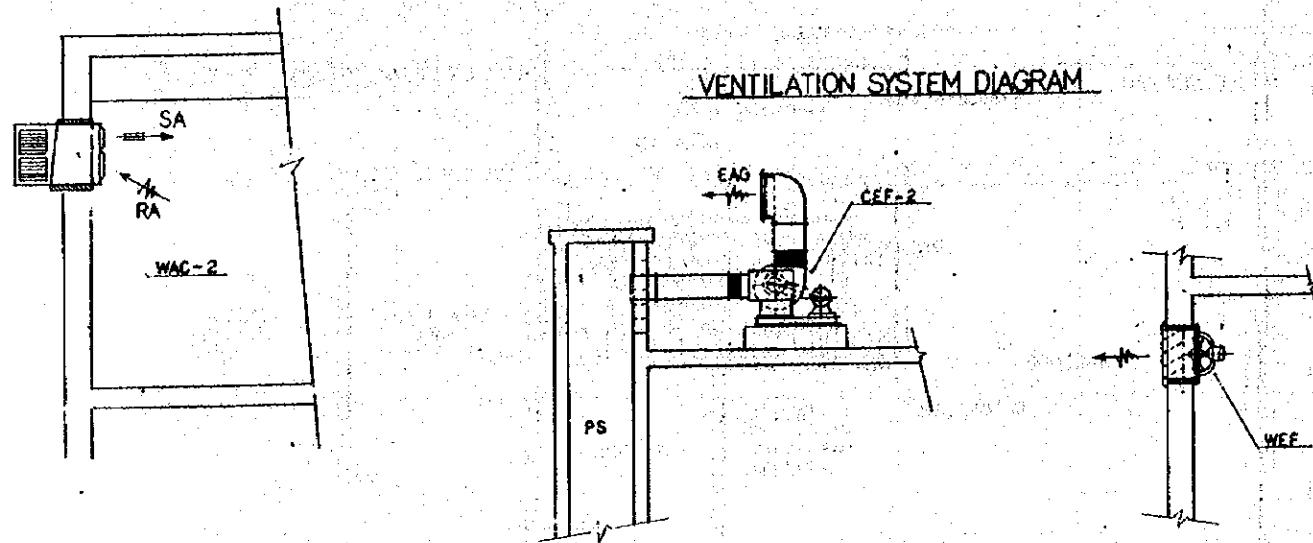

DUCT MATERIAL

MINIMUM DUCT GALVANIZED SHEET STEEL METAL GAGES

GAGE / THK (mm)	RECTANGULAR (mm)	ROUND (φ mm)
26 0.5 APPROX	UP THROUGH 300 ^{mm}	UP THROUGH 200
24 0.6	325 5 752	255 5 558
22 0.8	778 5 1300	583 5 900
20 1.0	1325 5 2130	925 5 1270
18 1.2	2155 5 3050	

(1) DIMENSION OF LONGEST SIDE

REPUBLIC OF INDONESIA
 MINISTRY OF COMMUNICATIONS
 DIRECTORATE GENERAL OF LAND TRANSPORT AND INLAND WATERWAYS

NEW RAILWAY LINE FOR CENGKARENG AIRPORT
 CONSTRUCTION PROJECT



JAPAN INTERNATIONAL COOPERATION AGENCY
 (JICA)

REVISIONS	DATE	DESIGNED	DRAWN	CHECKED	REVIEWED	SUBMITTED
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A	1989.08	[Signature]	[Signature]	[Signature]	[Signature]	[Signature]



KOTA INTAN STATION
 VAC
 GENERAL NOTES AND
 APPARATUS SCHEDULE

PACKAGE: I CIVIL AND ARCHITECTURAL WORK




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REPUBLIC OF INDONESIA MINISTRY OF COMMUNICATIONS DIRECTORATE GENERAL OF LAND TRANSPORT AND INLAND WATERWAYS					
NEW RAILWAY LINE FOR CENGKARENG AIRPORT CONSTRUCTION PROJECT					
JAPAN INTERNATIONAL COOPERATION AGENCY (JICA)					
REVISED	DATE	DESIGNED	DRAWN	CHECKED	APPROVED
B	1 AUG 89	W.P.	W.P.	S.M.	K.M.
A	5 FEB 89	W.P.	W.P.	S.M.	K.M.
KOTA INTAN STATION VAC IF PLAN					
PROGRAM: I CIVIL AND ARCHITECTURAL WORK					
SCALE: 1:100		DRAWING NO: AM - 017			

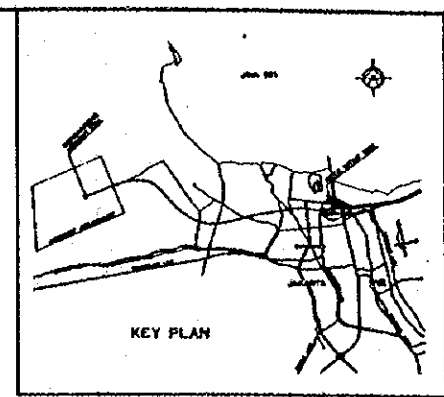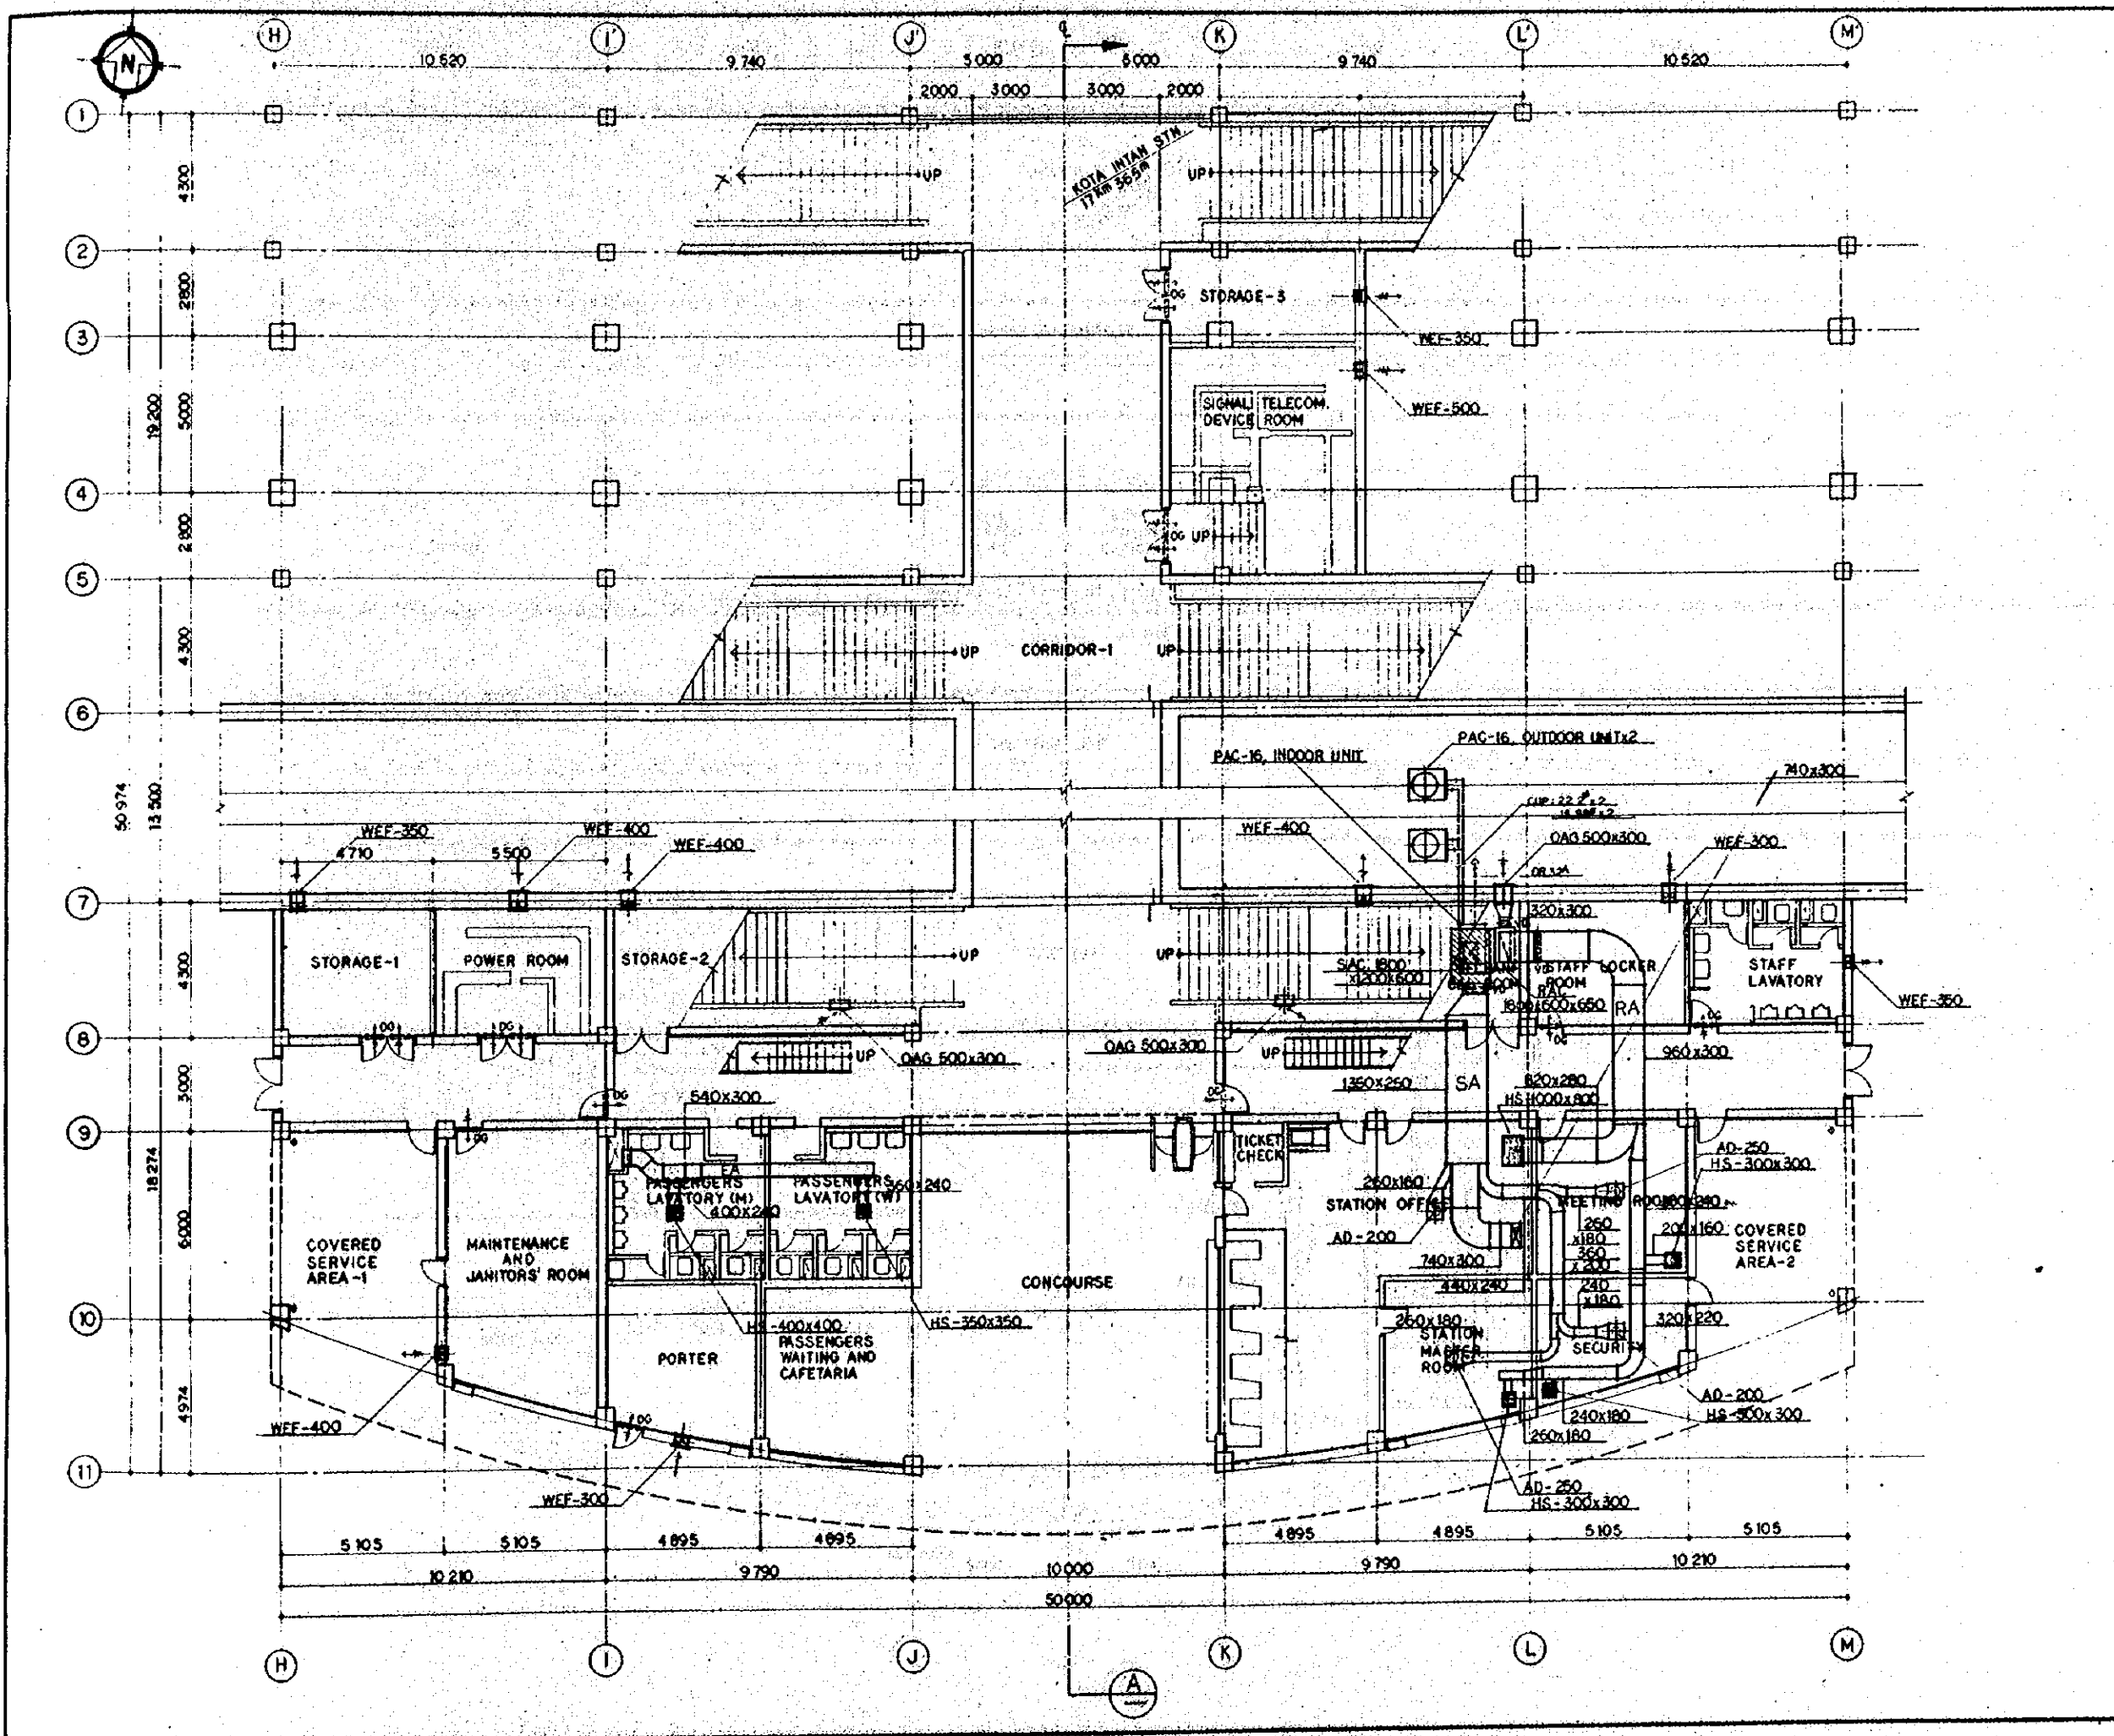

REPUBLIC OF INDONESIA MINISTRY OF COMMUNICATIONS DIRECTORATE GENERAL OF LAND TRANSPORT AND INLAND WATERWAYS					
NEW RAILWAY LINE FOR CENKARENG AIRPORT CONSTRUCTION PROJECT					
JAPAN INTERNATIONAL COOPERATION AGENCY (JICA)					
REVISIONS	DATE	DESIGNED	DRAWN	CHECKED	REVIEWED
B	1 AUG 88	MT	10	Sya	KM
A	1 FEB 88	MT	10	Sya	KM
KOTA INTAN STATION VAC 2F PLAN					
PACKAGE: I CIVIL AND ARCHITECTURAL WORK					
SCALE: 1:100		DRAWING NO: AM - 018			

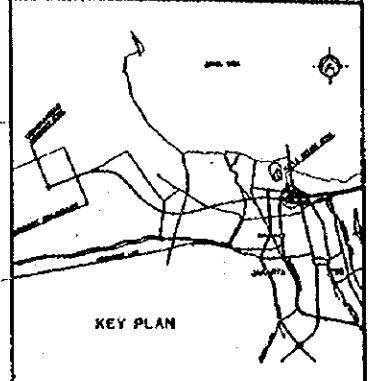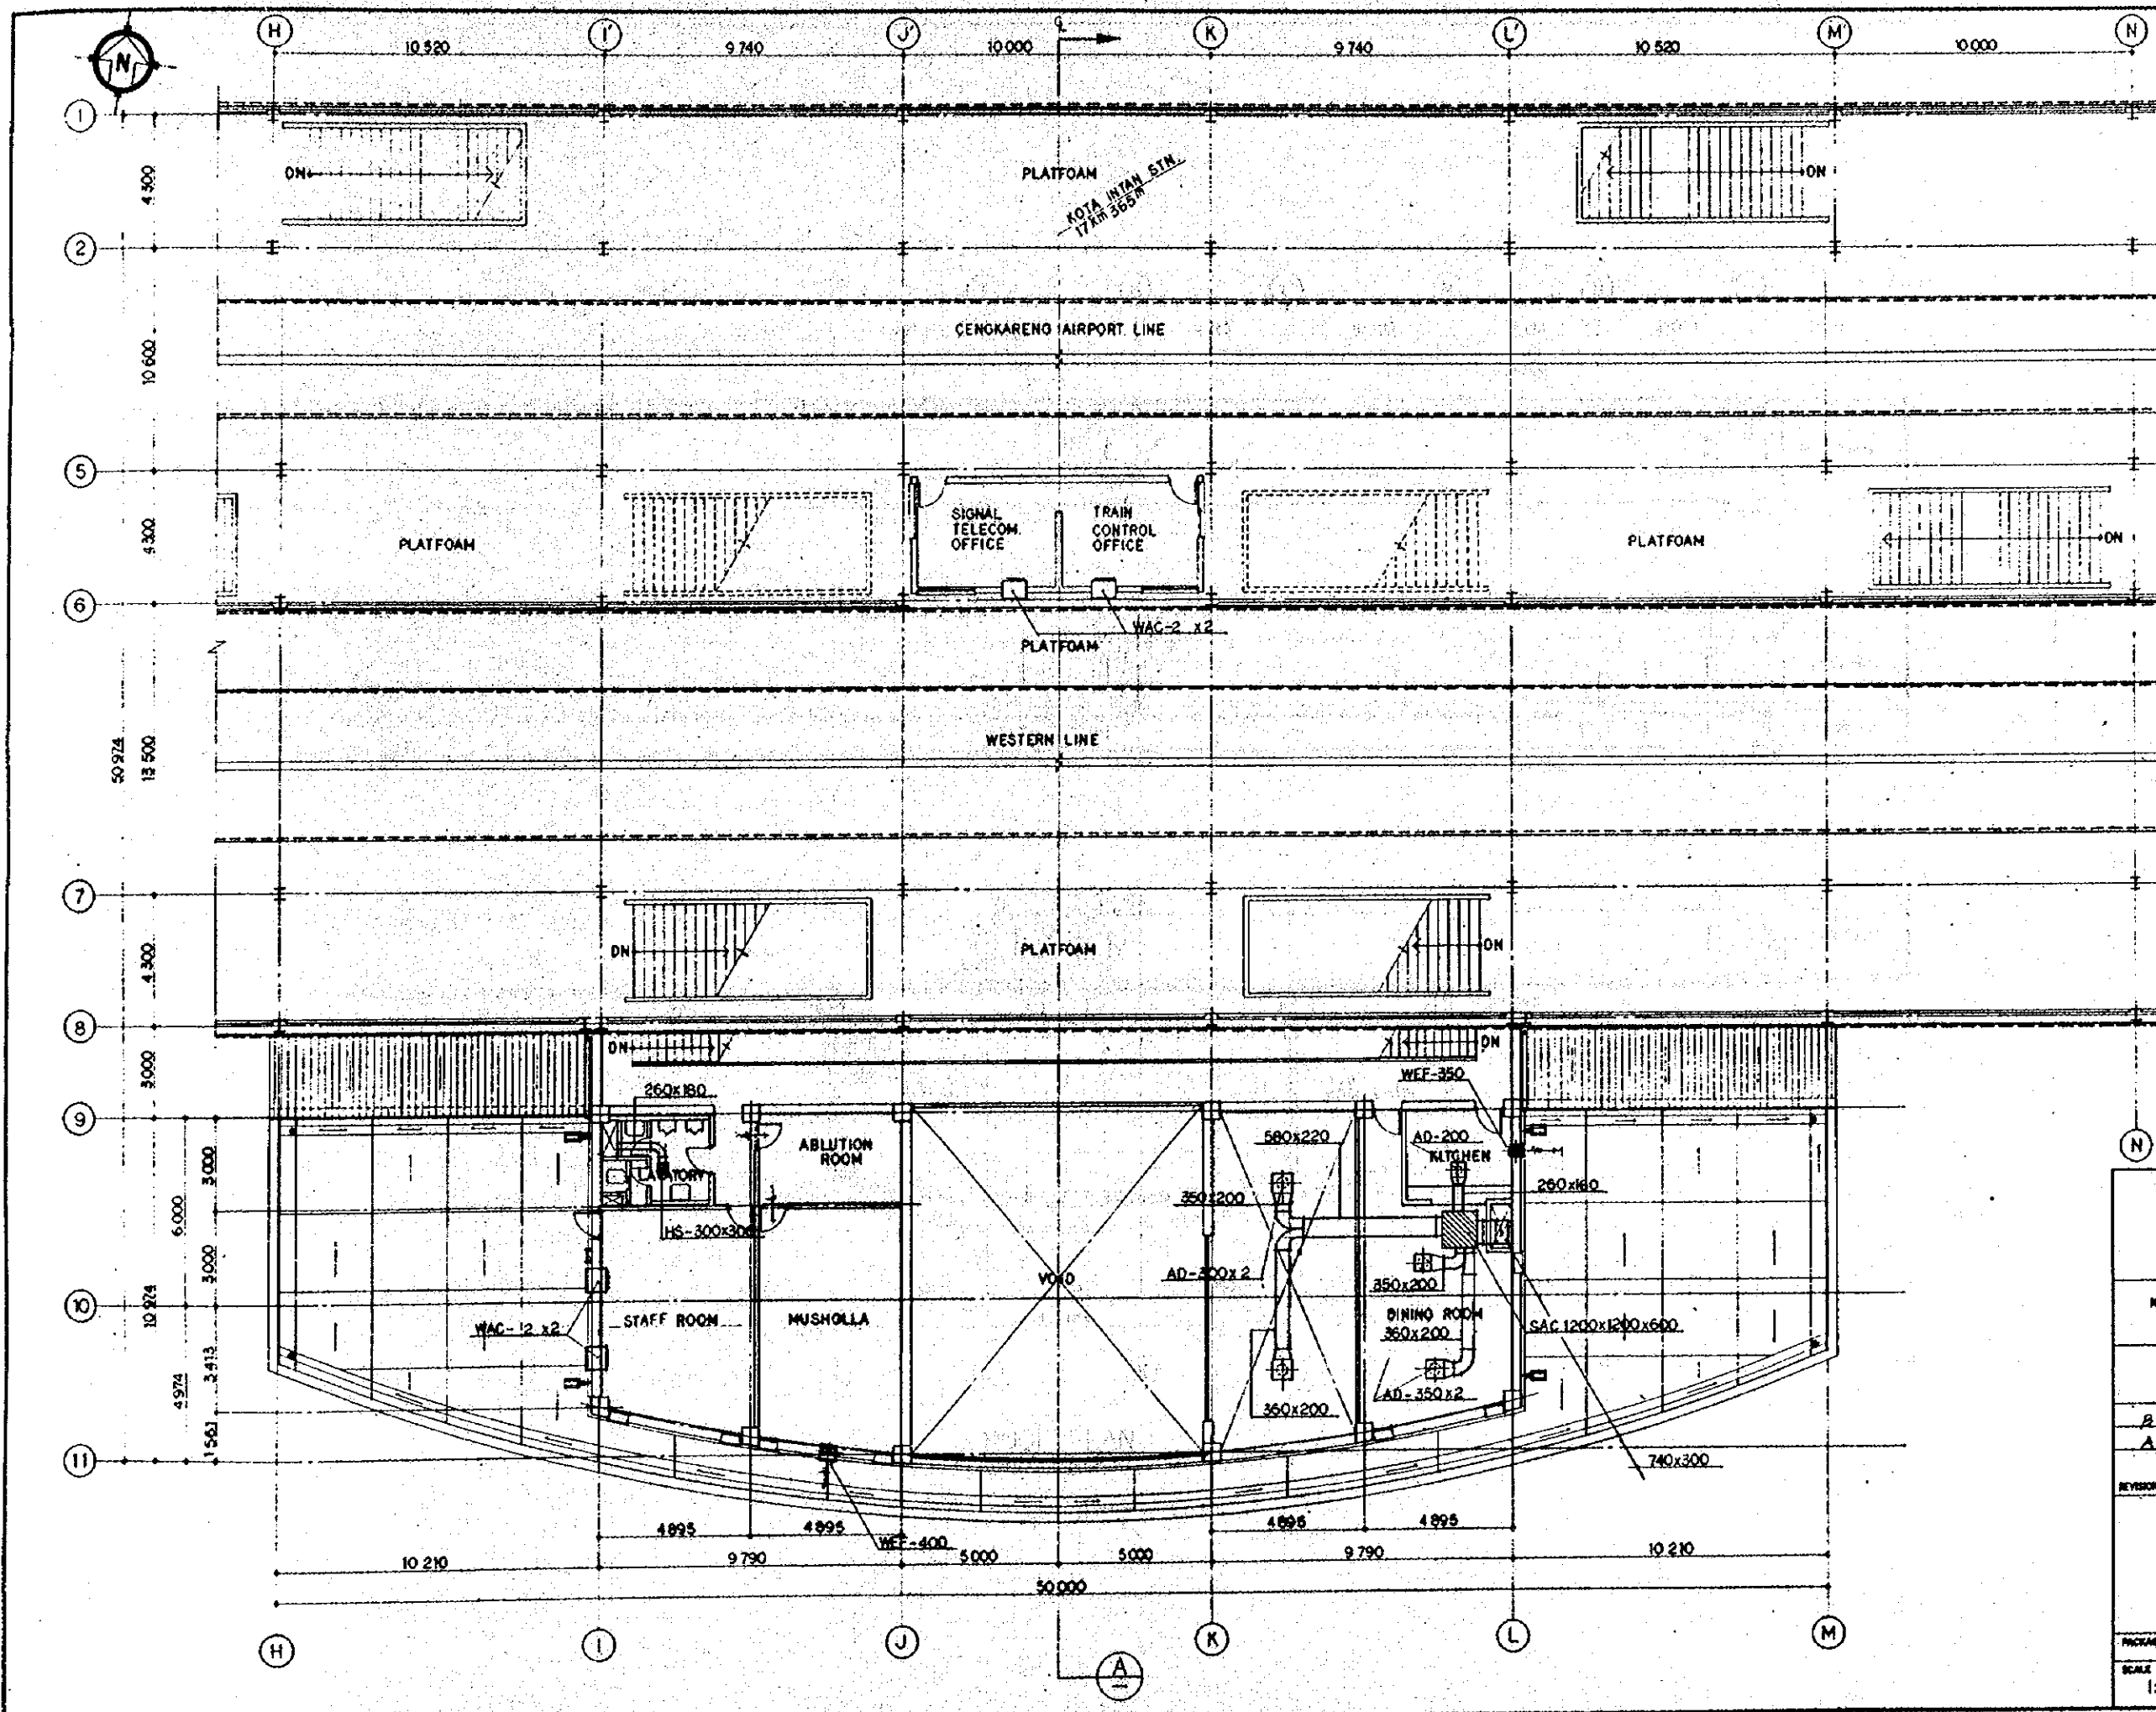


① DETAIL SCALE 1/50

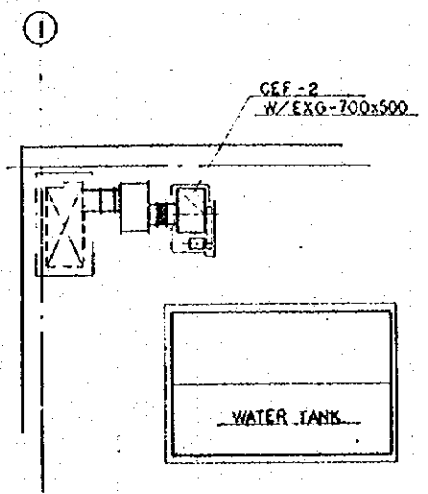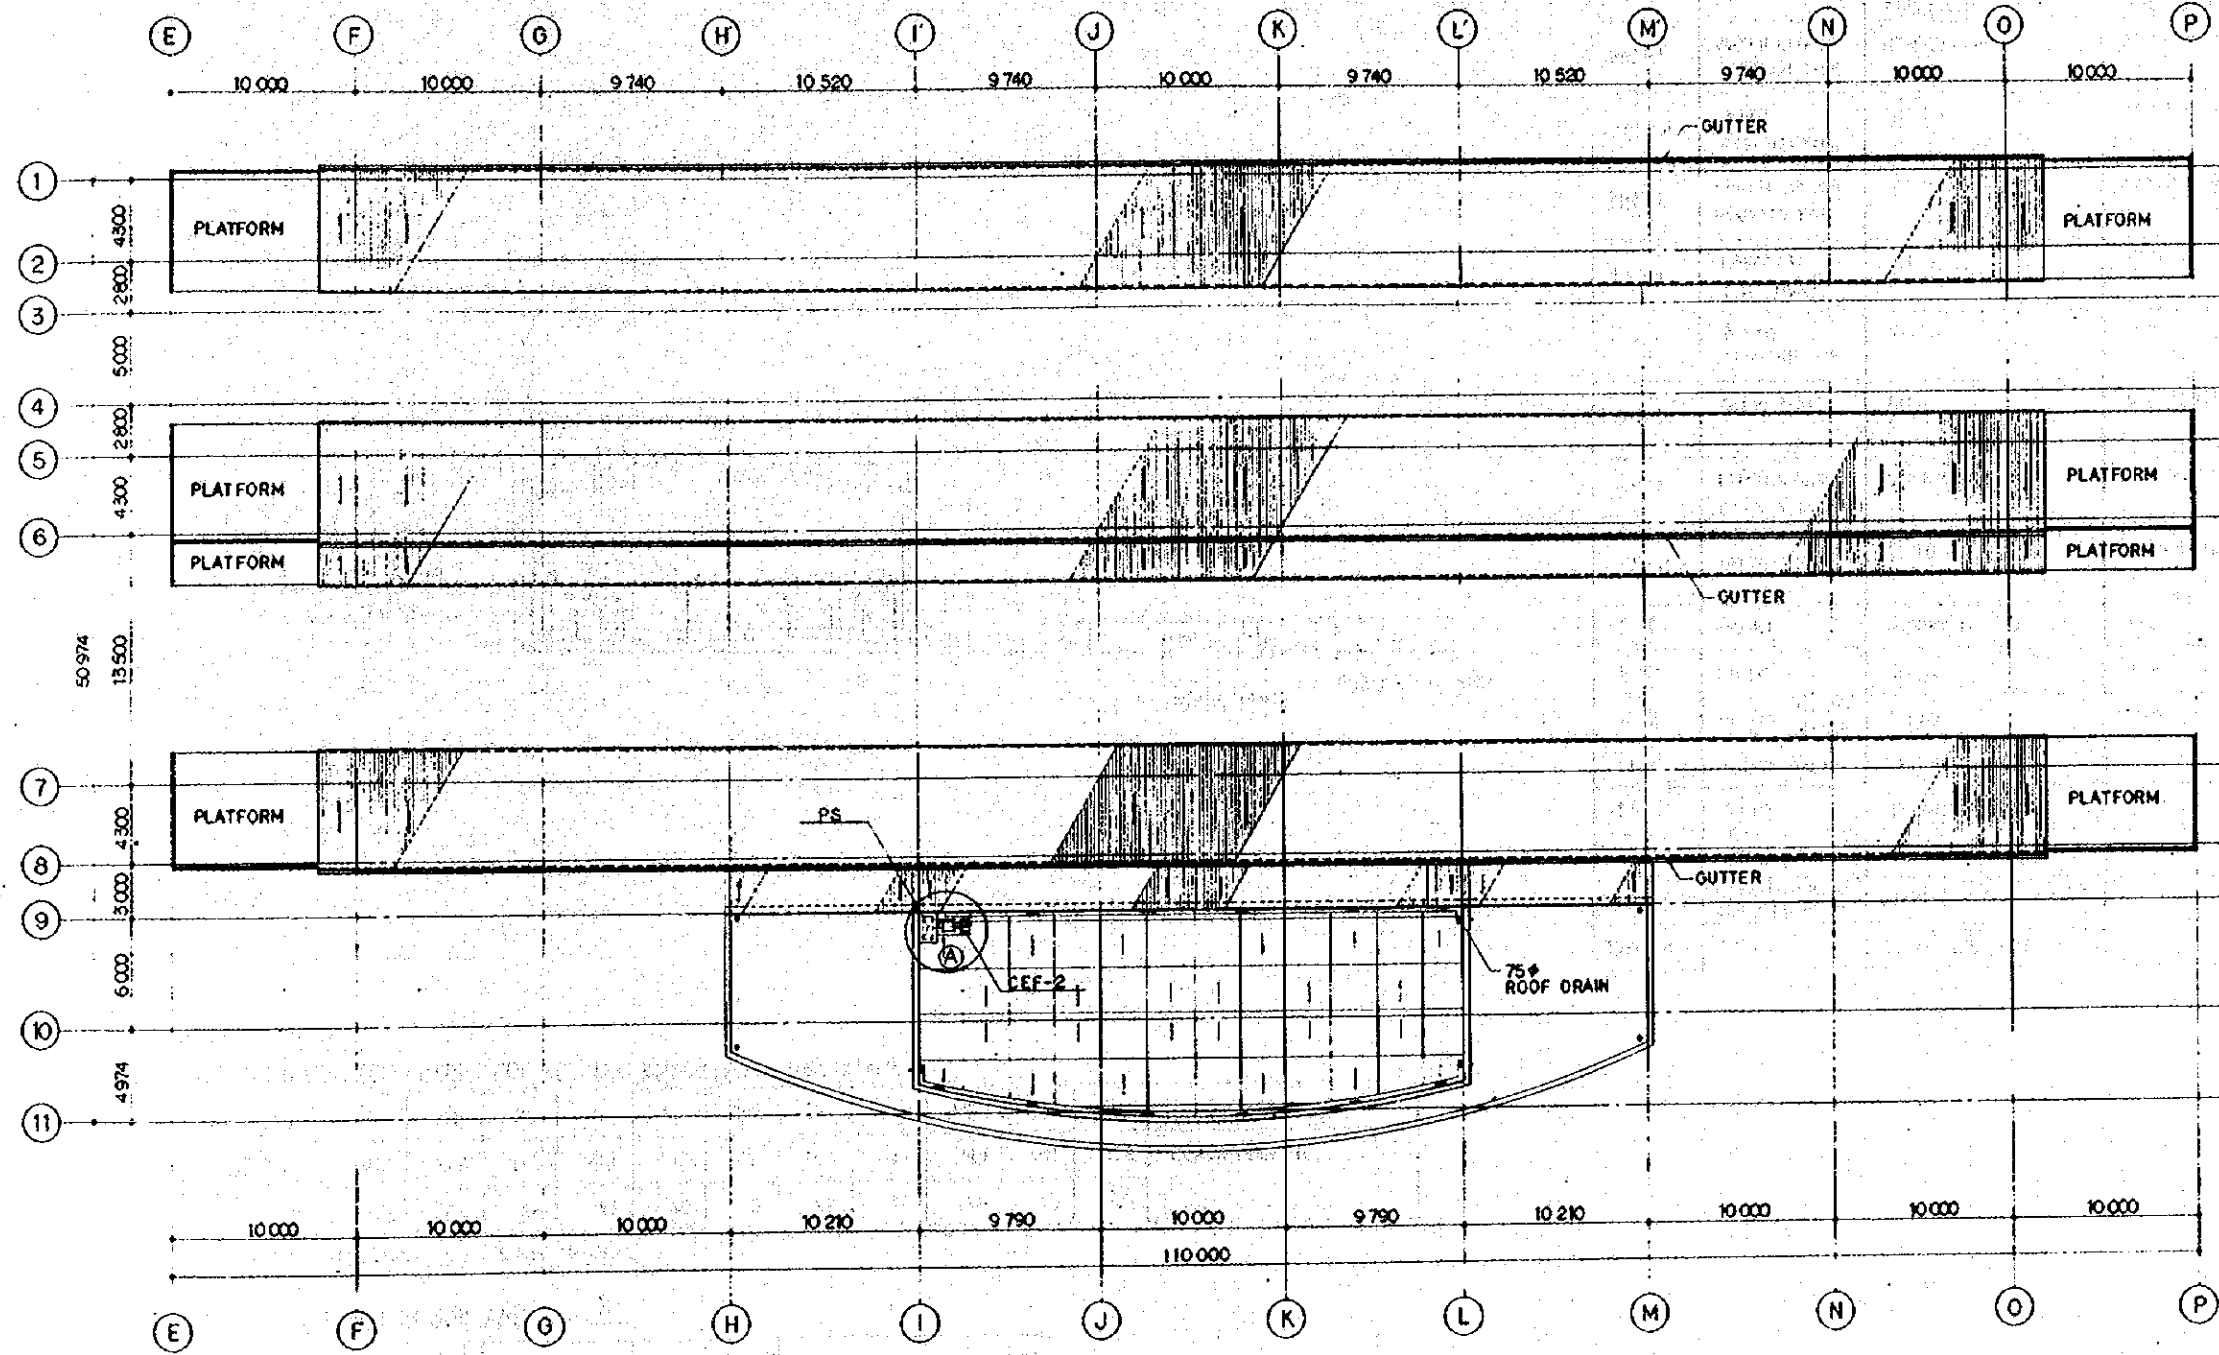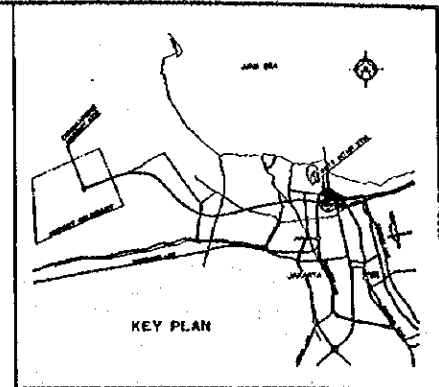ROOF PLAN
SCALE 1:200

REPUBLIC OF INDONESIA MINISTRY OF COMMUNICATIONS DIRECTORATE GENERAL OF LAND TRANSPORT AND INLAND WATERWAYS					
NEW RAILWAY LINE FOR CENGKARENG AIRPORT CONSTRUCTION PROJECT					
JAPAN INTERNATIONAL COOPERATION AGENCY (JICA)					
B	1.004.89	DT	Supp	K.M.	m.k
A	1.004.89	DT	Supp	K.M.	m.k
REVISIONS	DATE	DESIGNED	DRAWN	CHECKED	SUBMITTED
KOTA INTAN STATION VAC RF PLAN					
PACKAGE: I CIVIL AND ARCHITECTURAL WORK					
SCALE	DRAWING NO.				
1:200	AM - 019				

PLUMBING SYSTEM DIAGRAM

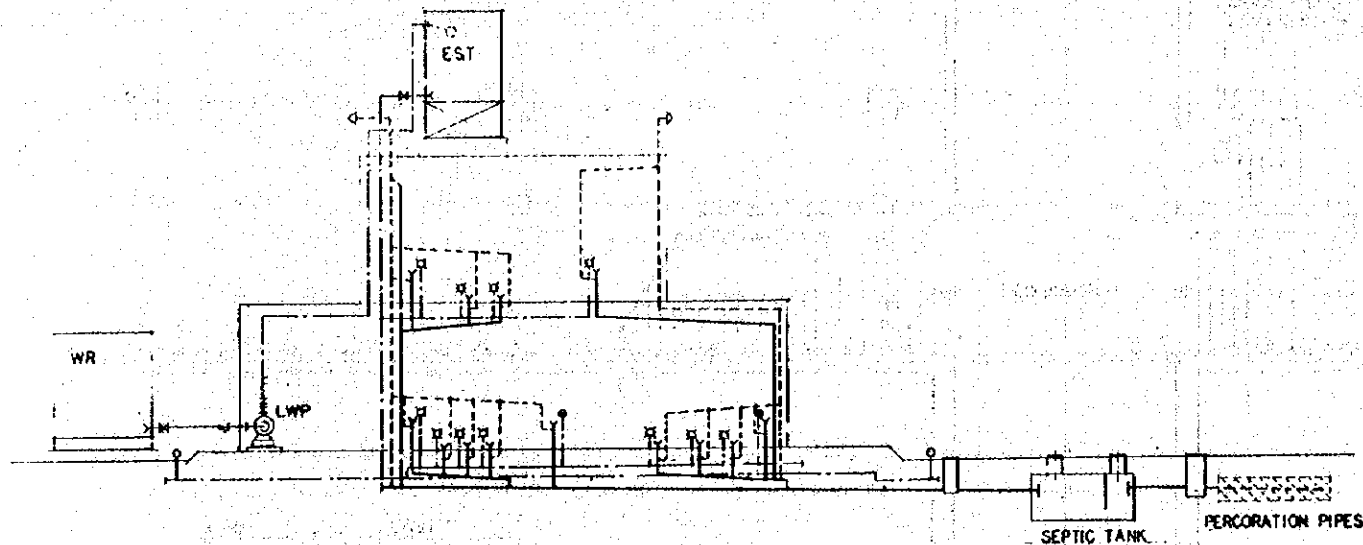

PLUMBING FIXTURES SCHEDULE

SYMBOL	FIXTURE NAME	DESCRIPTION			QTY	CONNECTION PIPE		
		MATERIAL	SIZE APPROX.	ACCESSORIES		WATER	WASTE	VENT
WC-1	WATER CLOSET EASTERN TYPE	VITREOUS CHINA	280x570x300 ^H	P-TRAP, F-2	8	25	100	80
WC-2	DITTO WESTERN TYPE	DITTO	360x600x360 ^H	DITTO, FLUSH-VALVE, TOILET PAPER HOLDER		25	100	80
UR-1	URINAL, FLOOR MOUNTED TYPE	DITTO	380x380x920 ^H	FLUSH-VALVE, INLET SPUD	8	20	75	50
LV-1	LAVATORY WALL HUNG	DITTO	530x430	F-1, P-TRAP, SHUT OFF VALVE, CONNECTING PIPE	8	20	50	40
LV-2	DITTO COUNTER-TOP	DITTO	480 ^H	DITTO		20	50	40
SK-1	SERVICE SINK	DITTO	560x450x630 ^H	F-2, SINK-TRAP	3	20	75	40
KS-1	KITCHEN SINK CABINET TYPE	STAINLESS STEEL	1000x560x800 ^H	F-1, SINK-TRAP	1	20	50	40
KS-2	DITTO	DITTO	1500x560x800 ^H	DITTO	1	20	50	40
F-1	FAUCET	CHROME PLATED	1/2		3	20		
F-2	DITTO	DITTO	3/4			25		
F-3	DITTO FOR IRRIGATION	DITTO	3/4	VALVE-BOX, W/KEY	15	25		
FD-1	FLOOR DRAIN	CAST IRON		WASTE FITTING	10		50	
FD-2	DITTO	DITTO		DITTO	1		75	
LWP-1	LIFT WATER PUMP CENTRIFUGAL-TYPE	65-50x550 x24 x 3.7 ^{l/min} ^{mH} ^{KW}						
LWP-2	DITTO	50-40x250 x24 x 2.2 ^{l/min} ^{mH} ^{KW}			1			

NOTES: PIPING

1. GALVANIZED STEEL PIPES FOR POTABLE WATER, VENT AND DRAIN

SIZE NOMINAL	15	20	25	32	40	50	65	80	100	125	150	REMARKS
OUTSIDE DIAMETER	21.7	27.2	34.0	42.7	48.6	60.5	76.3	89.1	114.3	139.8	165.2	SCREW-JOINTED
WALL THICKNESS	2.8	2.8	3.2	3.5	3.5	3.8	4.2	4.2	4.5	4.5	4.6	

FITTINGS SHALL COMPLY WITH THE PIPE MATERIAL.

2. CAST IRON PIPE FOR SOIL AND SEWER

SIZE NOMINAL	50	75	100	125	150	200	REMARKS
OUTSIDE DIAMETER	59	84	109	134	159	212	ONE TOUCH JOINT-TYPE
WALL THICKNESS	4.5	4.5	4.5	4.5	4.5	6.0	

FITTINGS SHALL COMPLY WITH THE PIPE MATERIAL.

REPUBLIC OF INDONESIA
 MINISTRY OF COMMUNICATIONS
 DIRECTORATE GENERAL OF LAND TRANSPORT AND INLAND WATERWAYS

NEW RAILWAY LINE FOR CENKARENG AIRPORT CONSTRUCTION PROJECT



JAPAN INTERNATIONAL COOPERATION AGENCY (JICA)

REVISIONS	DATE	DESIGNED	DRAWN	CHECKED	REVIEWED	SUBMITTED
B	1/28/84	UW	UW	UW	K.M	UW
A	SEPT. 84	UW	UW	UW	K.M	UW



KOTA INTAN STATION
 PLUMBING
 GENERAL NOTES AND APPARATUS SCHEDULE

PACKAGE: 1 CIVIL AND ARCHITECTURAL WORK



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REPUBLIC OF INDONESIA MINISTRY OF COMMUNICATIONS DIRECTORATE GENERAL OF LAND TRANSPORT AND INLAND WATERWAYS						
NEW RAILWAY LINE FOR CENKARENG AIRPORT CONSTRUCTION PROJECT						
JAPAN INTERNATIONAL COOPERATION AGENCY (JICA)						
REVISIONS	DATE	DESIGNED	DRAWN	CHECKED	EXTENDED	SUBMITTED
B	1 AUG 89	[Signature]	[Signature]	[Signature]	[Signature]	[Signature]
A	15 FEB 89	[Signature]	[Signature]	[Signature]	[Signature]	[Signature]
KOTA INTAN STATION PLUMBING IF PLAN						
PACKAGE: I CIVIL AND ARCHITECTURAL WORK						
SCALE: 1:100		DRAWING NO: AM - 021				




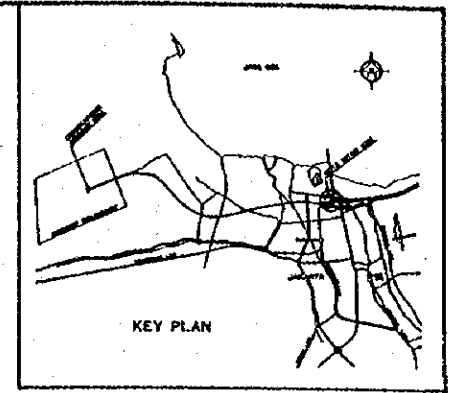
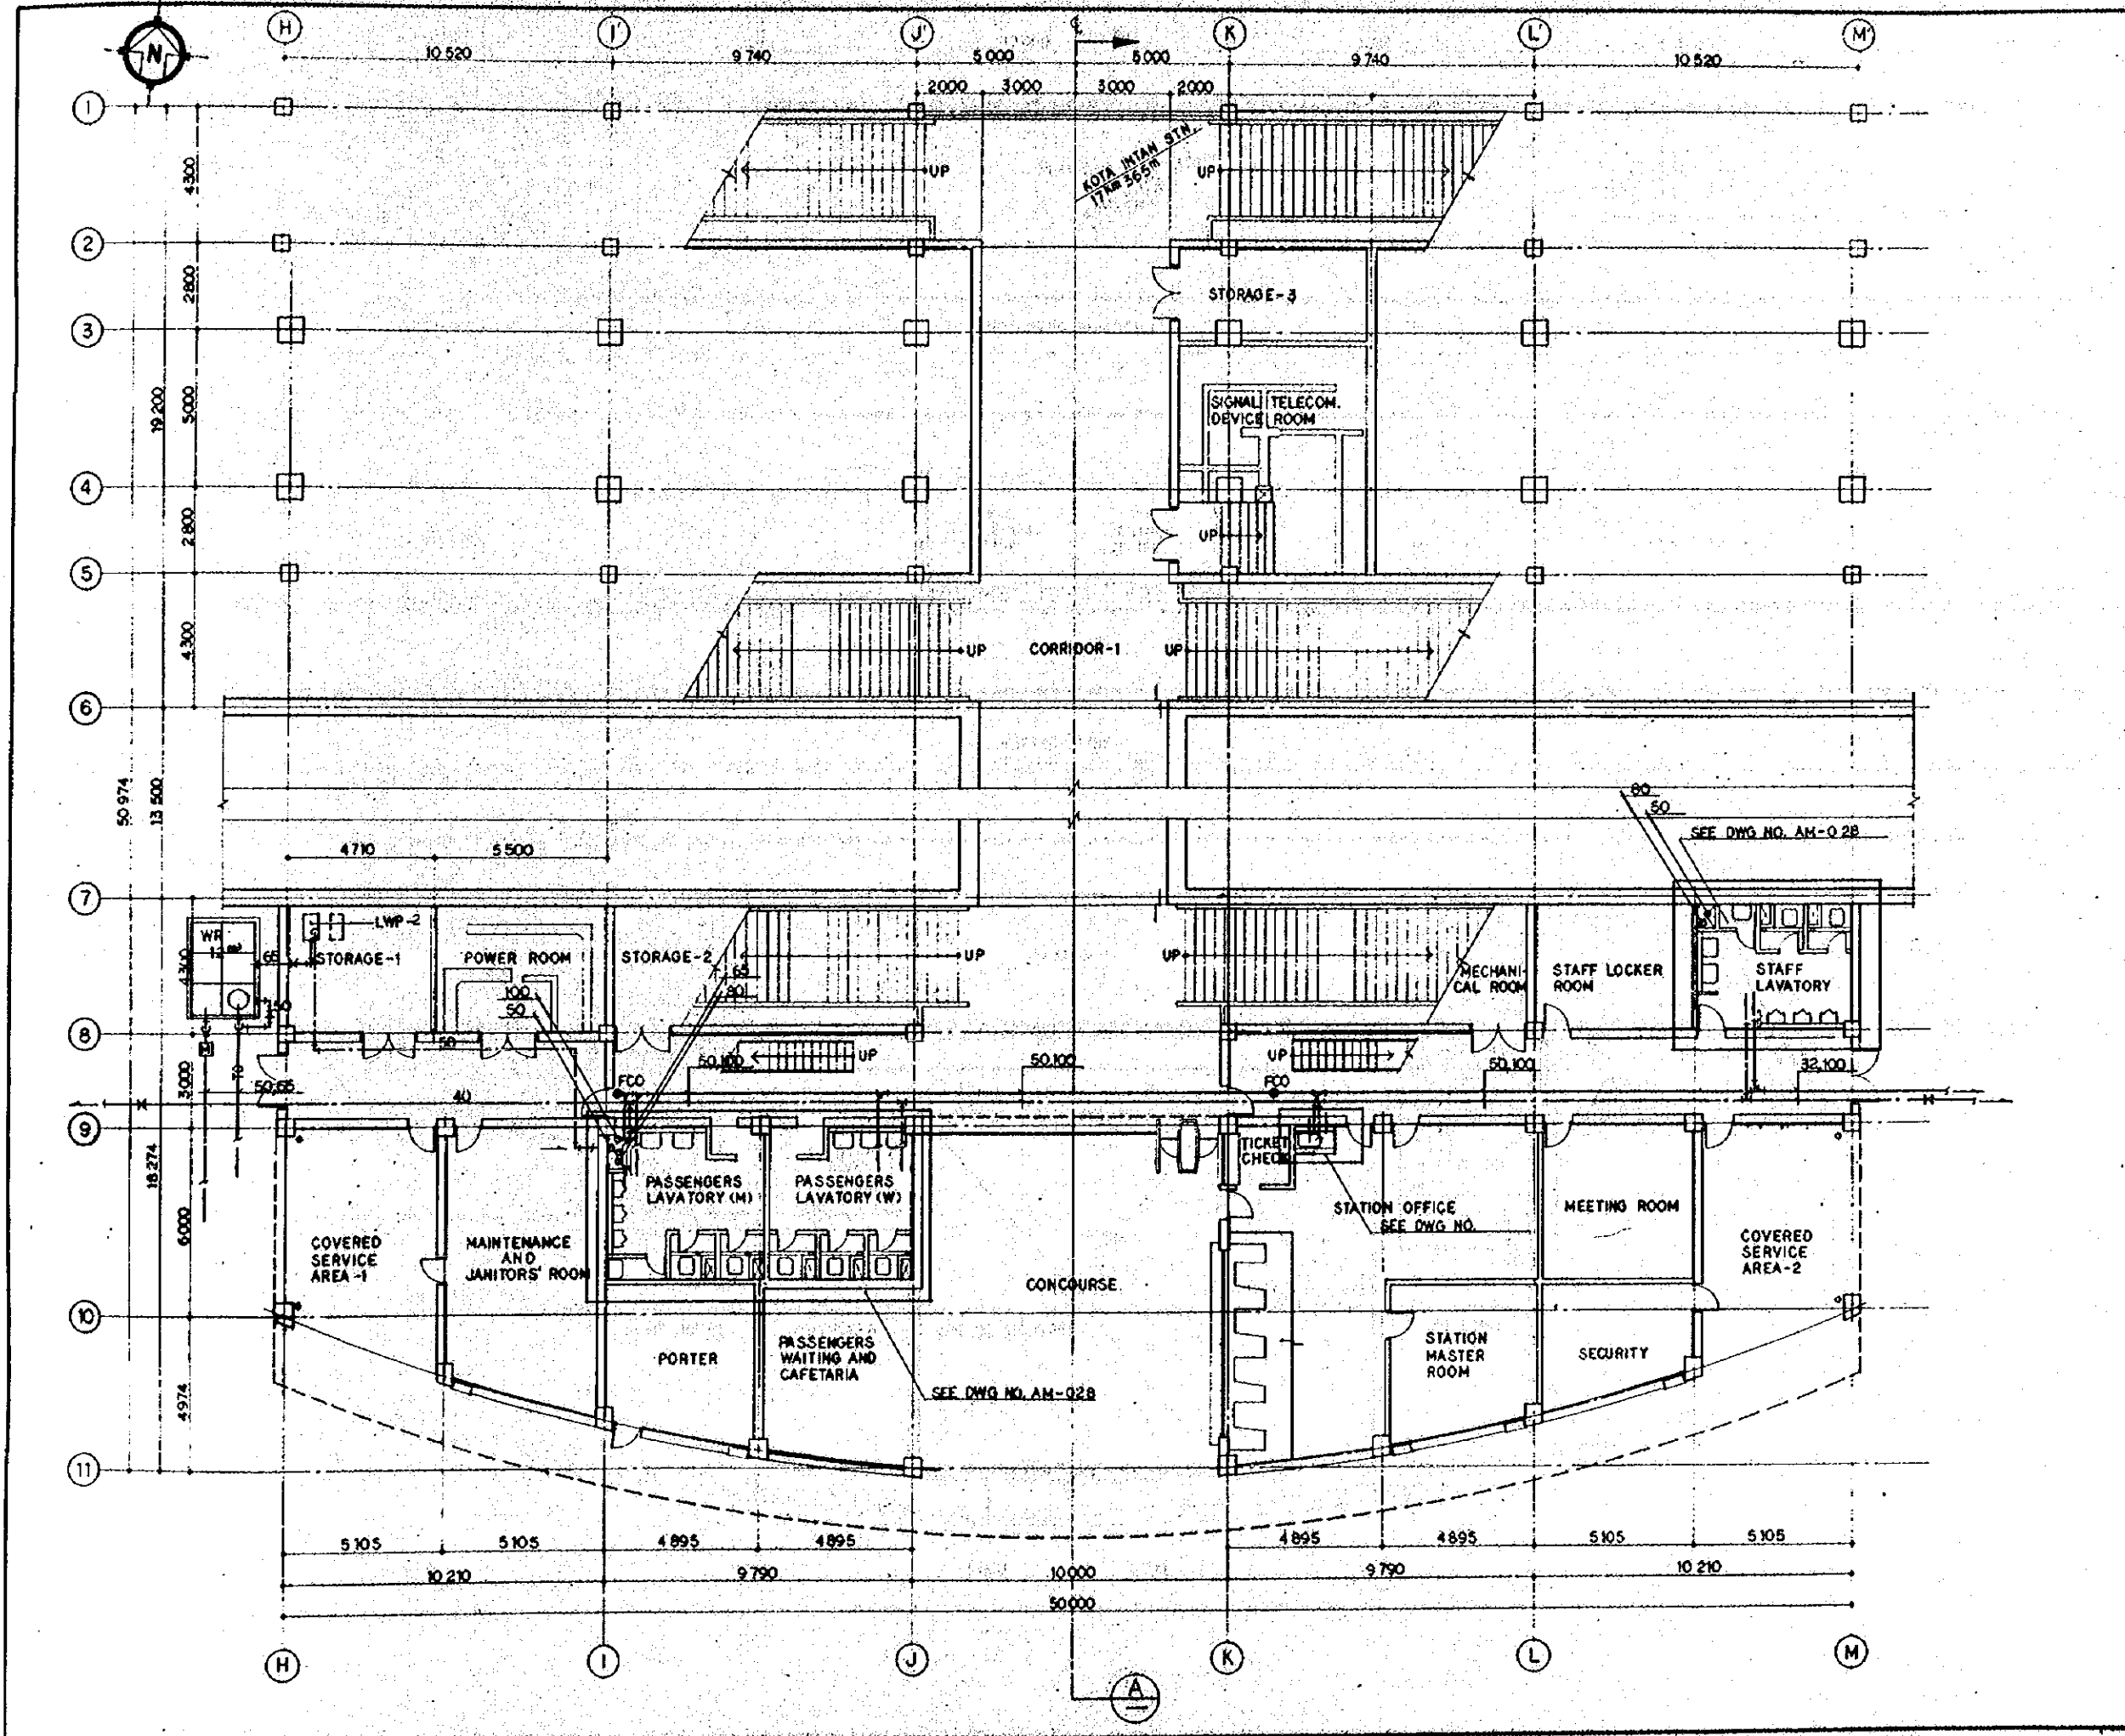


REPUBLIC OF INDONESIA MINISTRY OF COMMUNICATIONS DIRECTORATE GENERAL OF LAND TRANSPORT AND INLAND WATERWAYS					
NEW RAILWAY LINE FOR CENKARENG AIRPORT CONSTRUCTION PROJECT					
JAPAN INTERNATIONAL COOPERATION AGENCY (JICA)					
B	1 AUG 91	REV	BY	K.M	AK
A	15 FEB 91	REV	BY	K.M	AK
REVISIONS	DATE	DESCRIBED	BY	CHECKED	APPROVED
KOTA INTAN STATION PLUMBING 2F PLAN					
PACKAGE: I CIVIL AND ARCHITECTURAL WORK					
SCALE: 1:100		DRAWING NO: AM - 022			

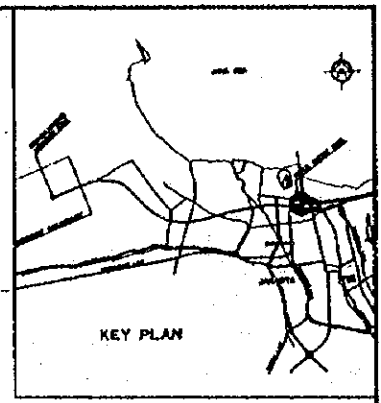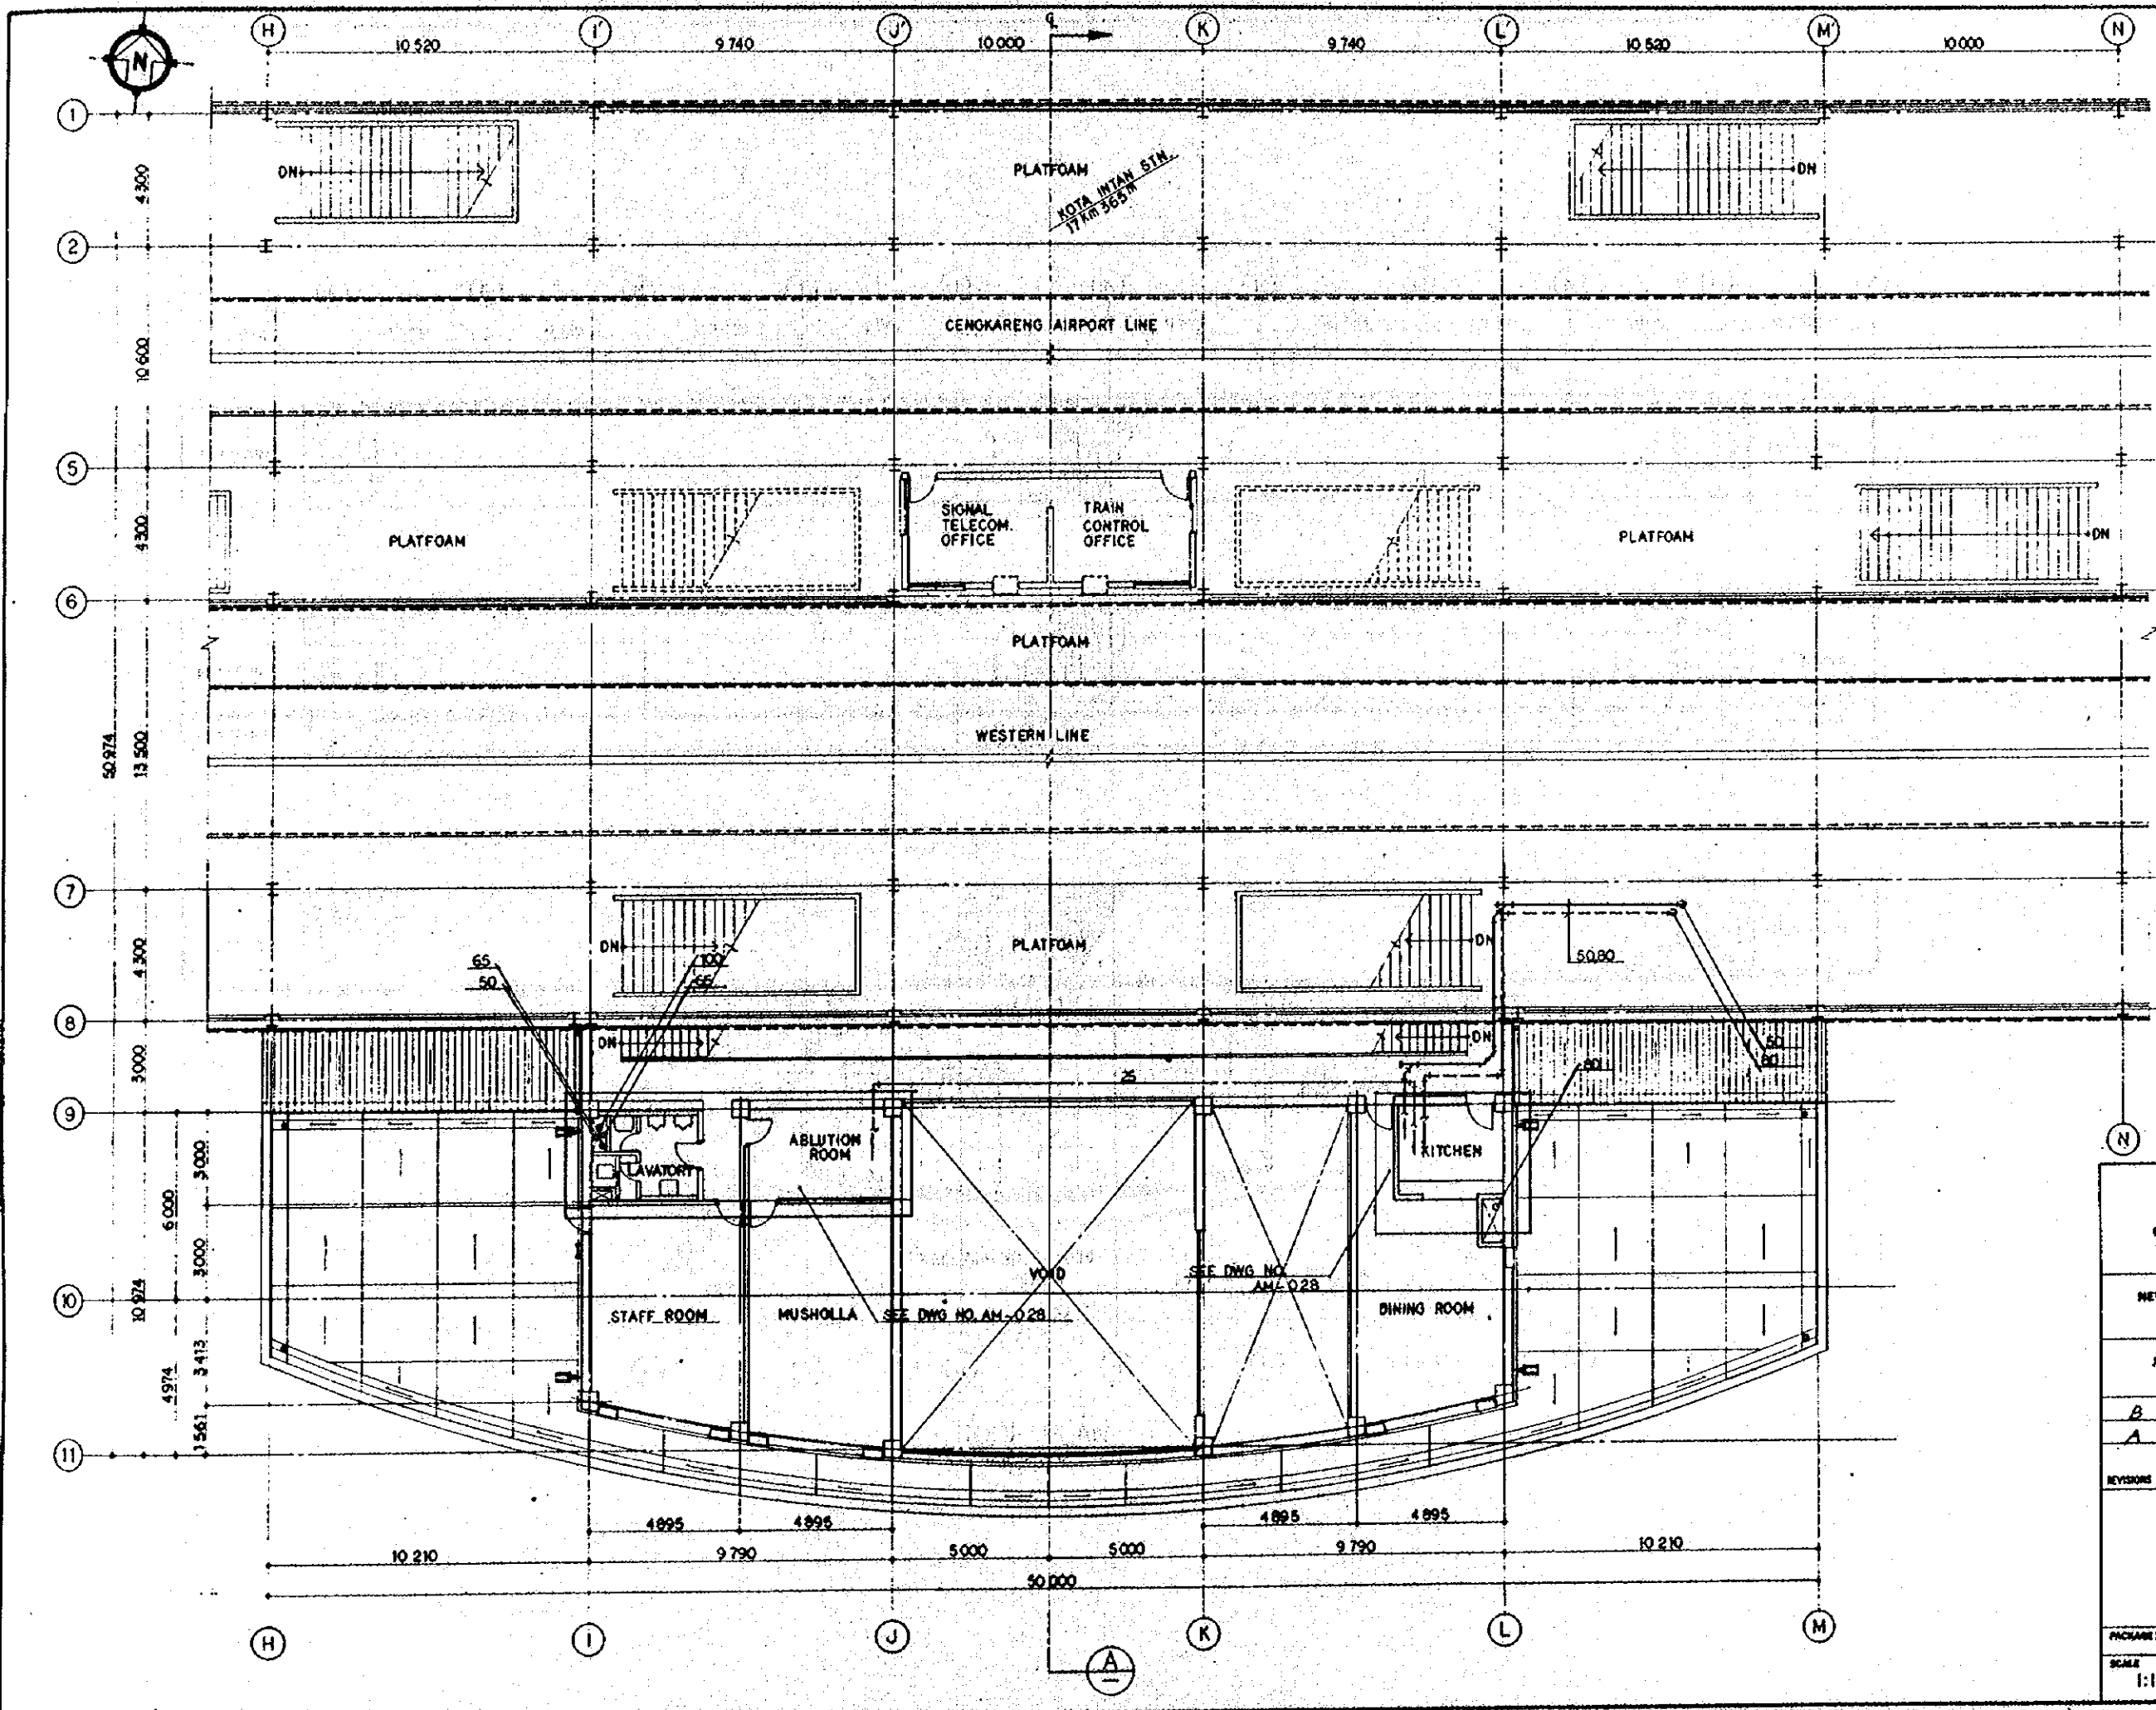


ROOF PLAN
SCALE 1:200

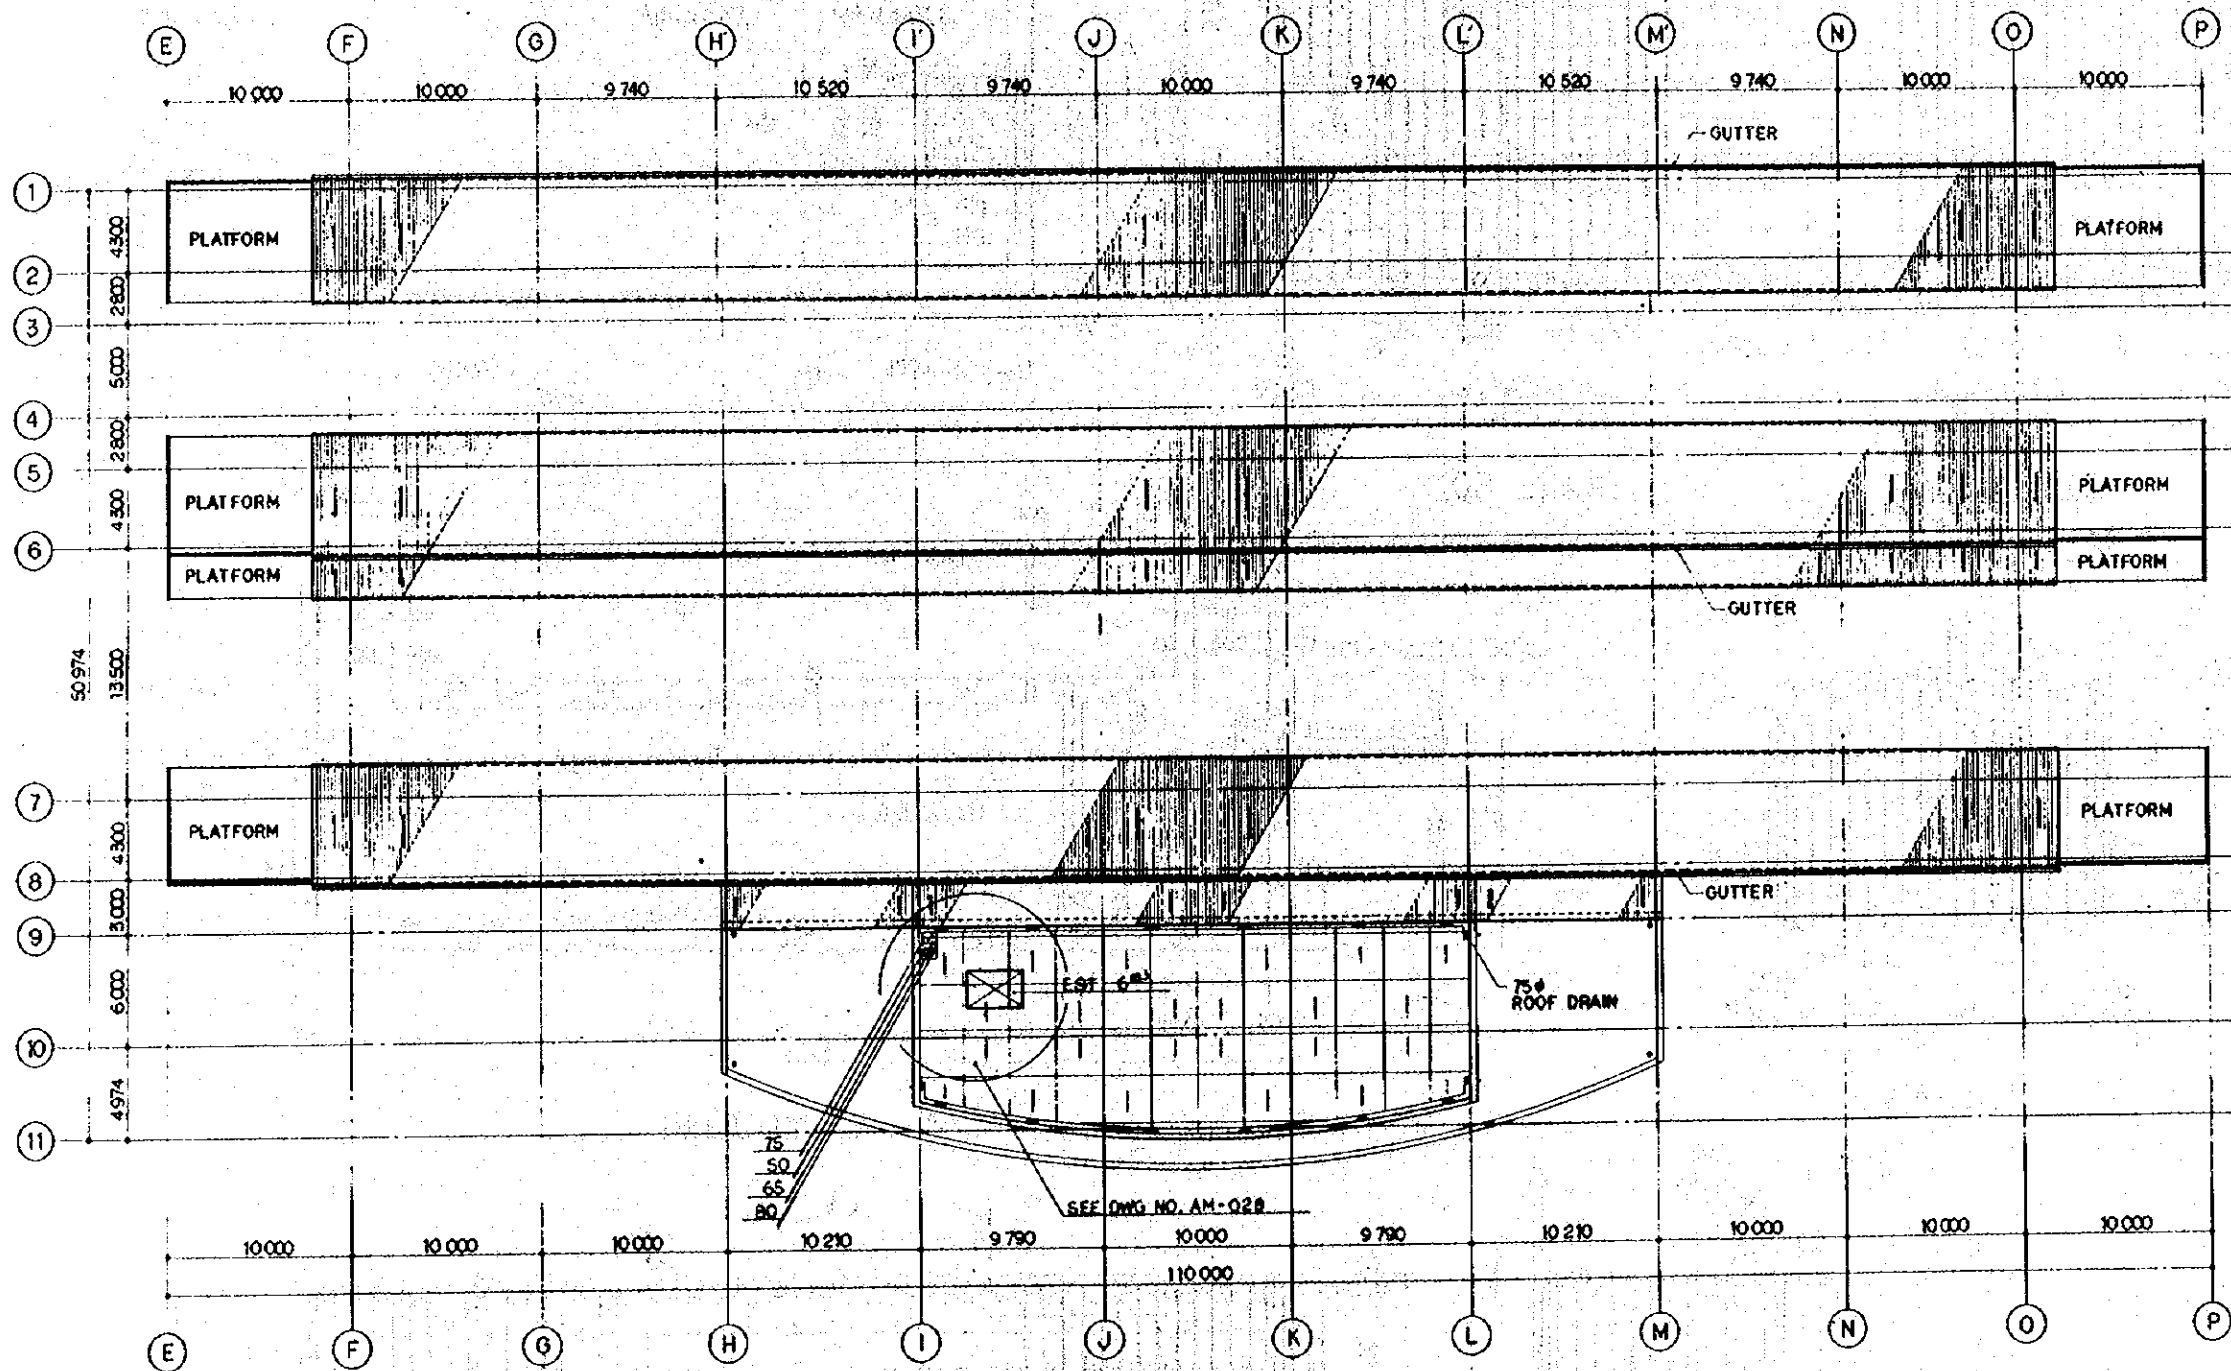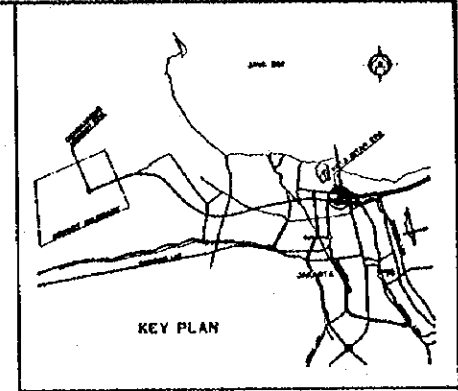REPUBLIC OF INDONESIA MINISTRY OF COMMUNICATIONS DIRECTORATE GENERAL OF LAND TRANSPORT AND INLAND WATERWAYS					
NEW RAILWAY LINE FOR CENGKARENG AIRPORT CONSTRUCTION PROJECT					
JAPAN INTERNATIONAL COOPERATION AGENCY (JICA)					
REVISIONS	DATE	DESIGNED	DRAWN	CHECKED	APPROVED
B	1 AUG 89	[Signature]	[Signature]	[Signature]	[Signature]
A	15 FEB 89	[Signature]	[Signature]	[Signature]	[Signature]
KOTA INTAN STATION PLUMBING RF PLAN					
PACKAGE: I CIVIL AND ARCHITECTURAL WORK					
SCALE: 1:200		DRAWING NO: AM - 023			

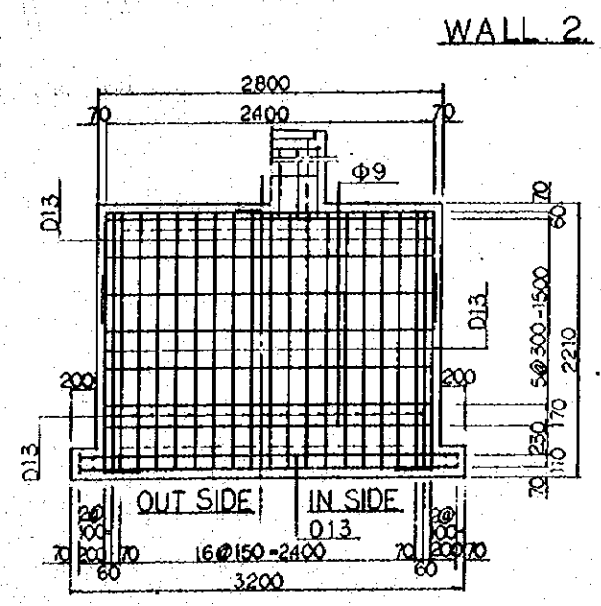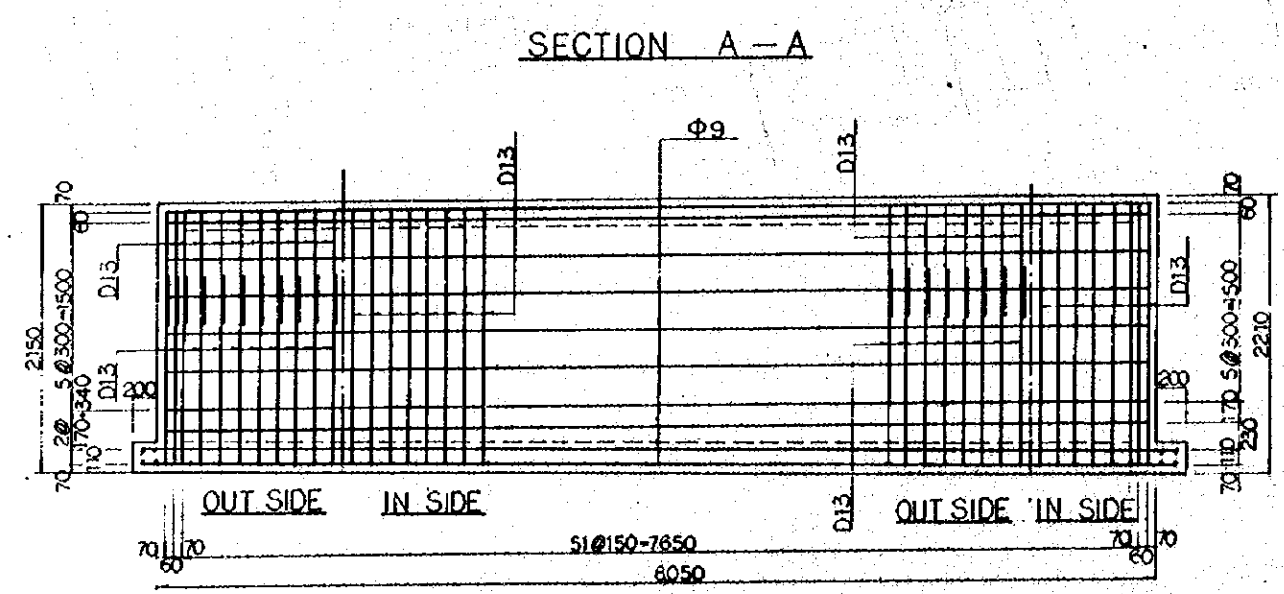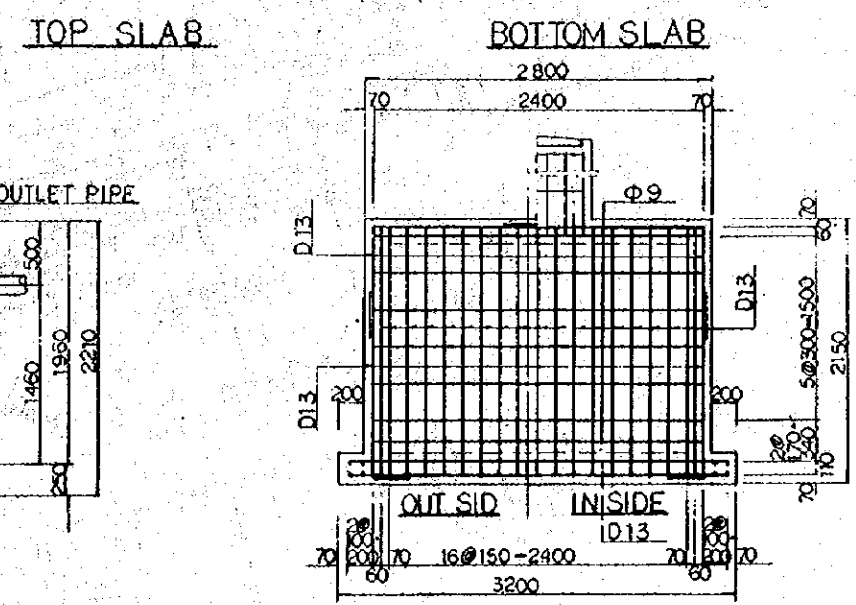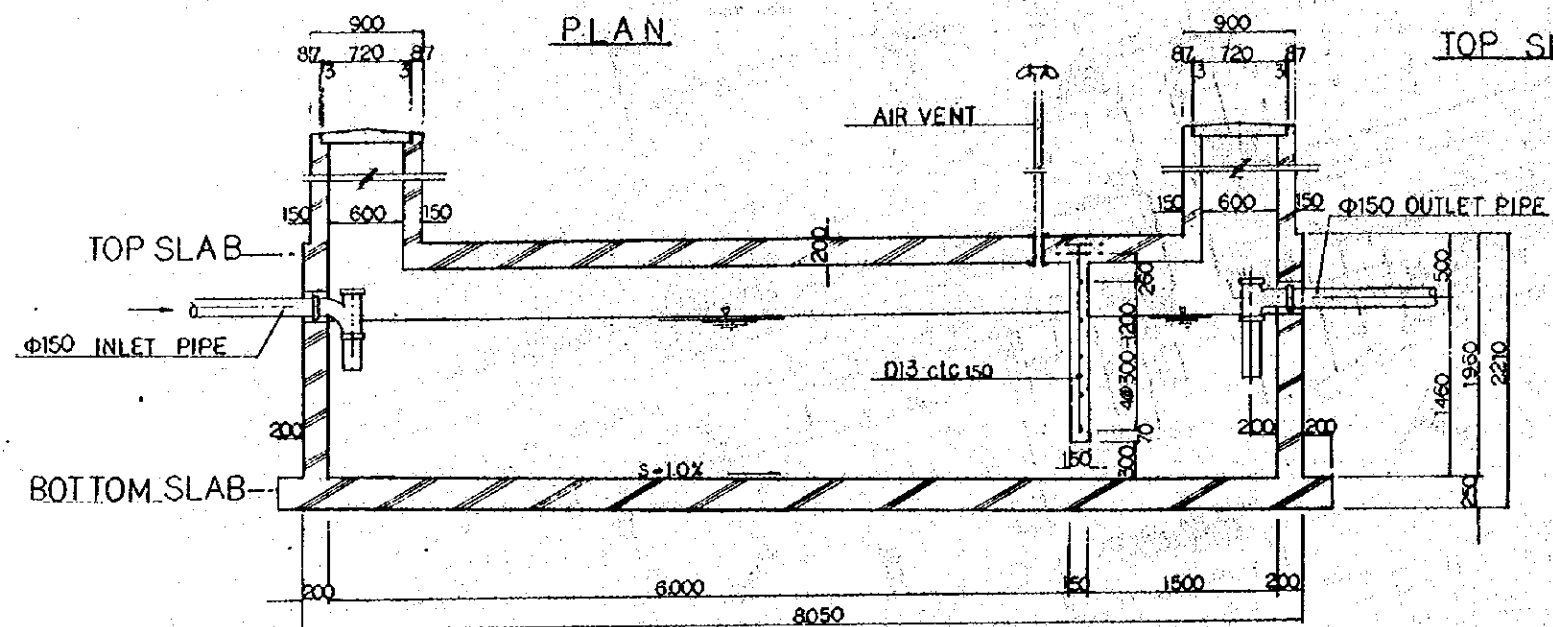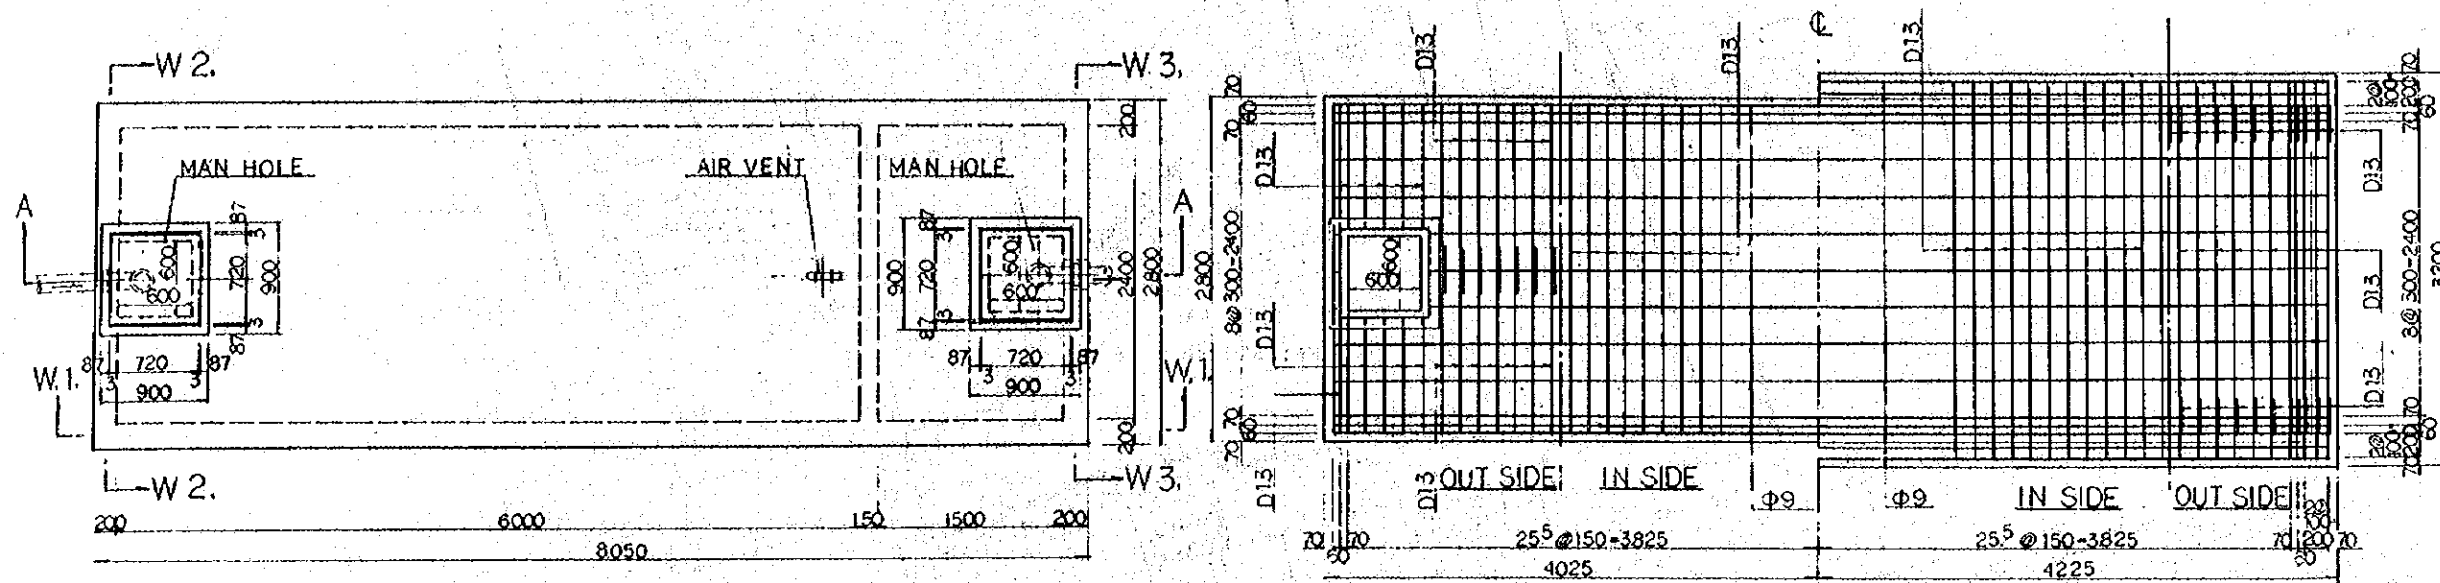

REPUBLIC OF INDONESIA MINISTRY OF COMMUNICATIONS DIRECTORATE GENERAL OF LAND TRANSPORT AND INLAND WATERWAYS					
NEW RAILWAY LINE FOR GENGKARENG AIRPORT CONSTRUCTION PROJECT					
JAPAN INTERNATIONAL COOPERATION AGENCY (JICA)					
REVISIONS	DATE	DESIGNED	DRAWN	CHECKED	REVIEWED
B	1 AUG 89	W.H.	W.H.	K.M.	K.K.
A	15 FEB 89	W.H.	W.H.	K.M.	K.K.
KOTA INTAN STATION PLUMBING SEPTIC TANK					
PACKAGE: I CIVIL AND ARCHITECTURAL WORK					
SCALE: 1:30		DRAWING NO: AM - 024			

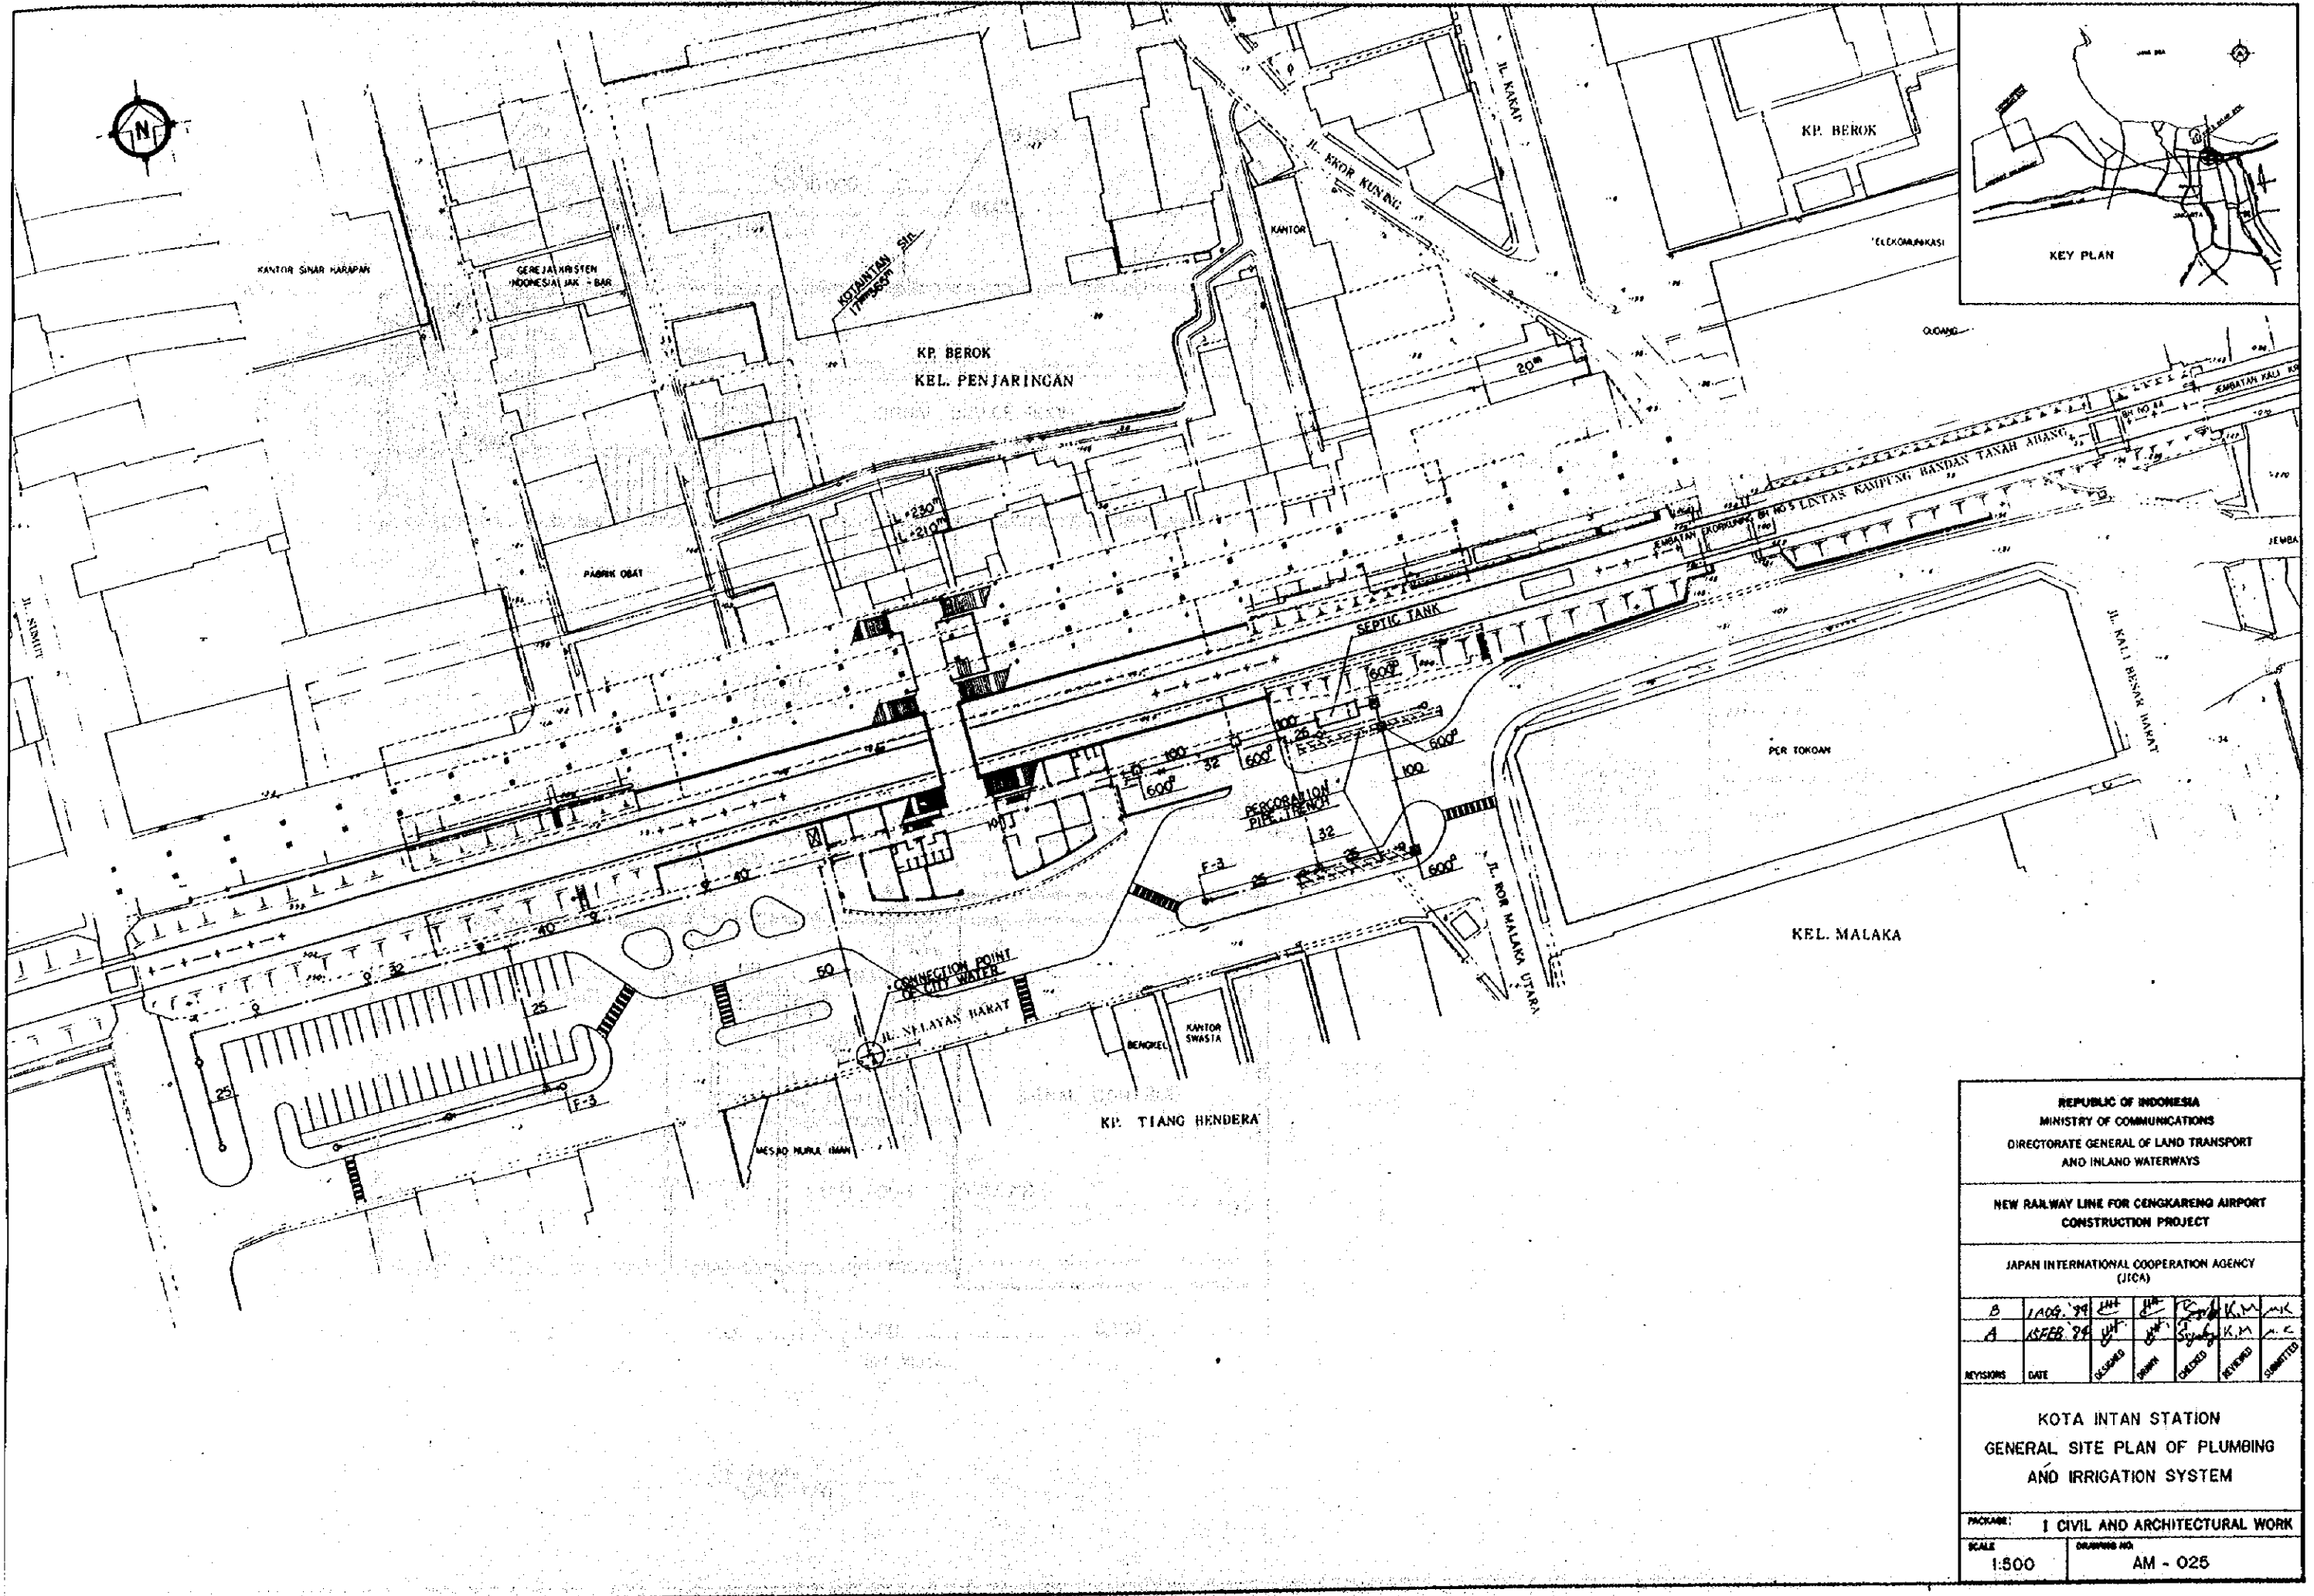

REPUBLIC OF INDONESIA
 MINISTRY OF COMMUNICATIONS
 DIRECTORATE GENERAL OF LAND TRANSPORT
 AND INLAND WATERWAYS


NEW RAILWAY LINE FOR CENGKARENG AIRPORT
 CONSTRUCTION PROJECT

JAPAN INTERNATIONAL COOPERATION AGENCY
 (JICA)


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A	15 FEB. '98	JHT	JHT	Syahrul	K.M.	M.K.
REVISIONS	DATE	DESIGNED	DRAWN	CHECKED	REVIEWED	APPROVED

KOTA INTAN STATION
 GENERAL SITE PLAN OF PLUMBING
 AND IRRIGATION SYSTEM


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 SCALE: 1:500
 DRAWING NO: AM - 025

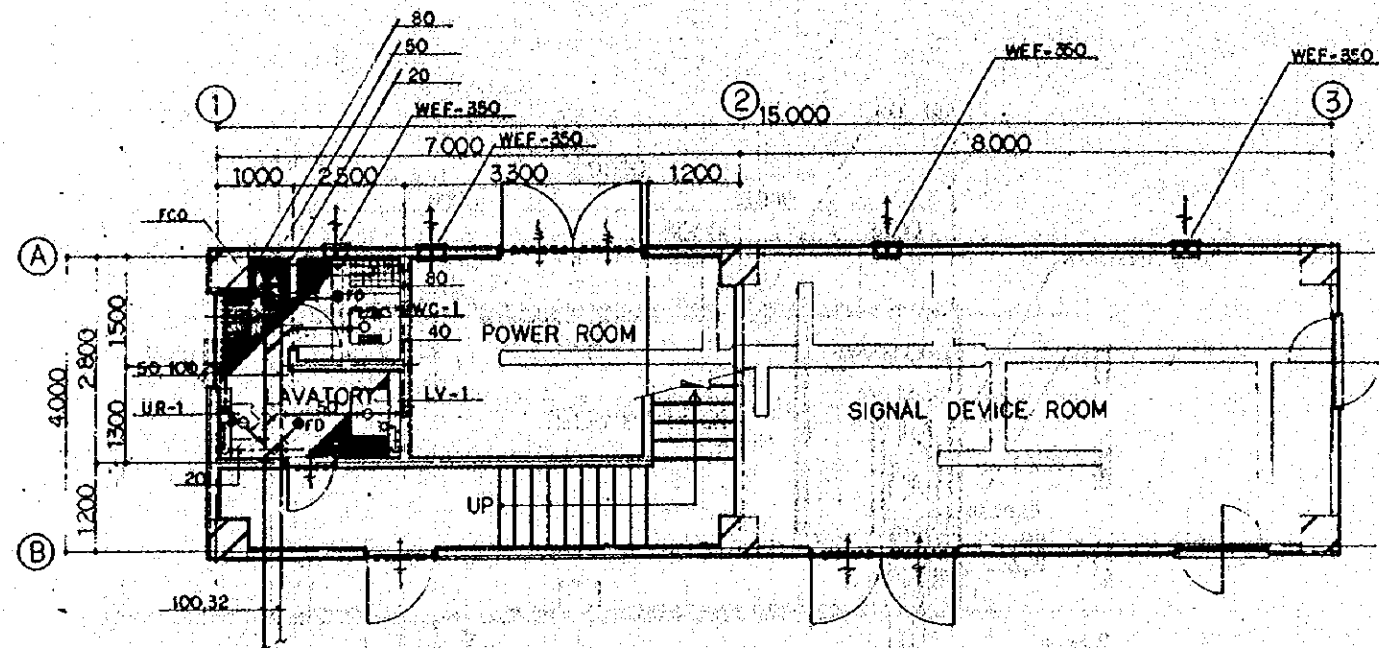

1F PLAN
SCALE 1:50

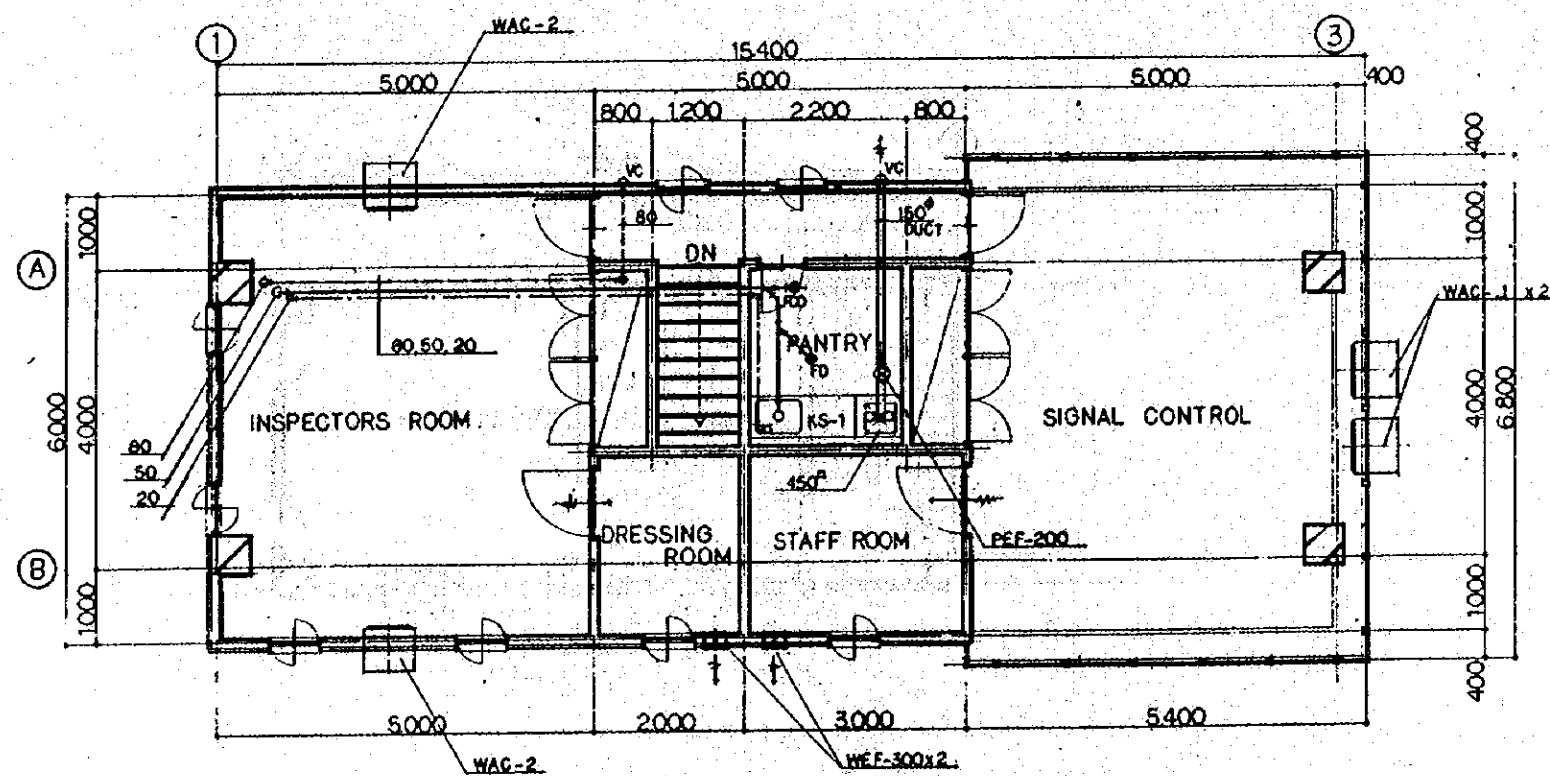

2F PLAN
SCALE 1:50

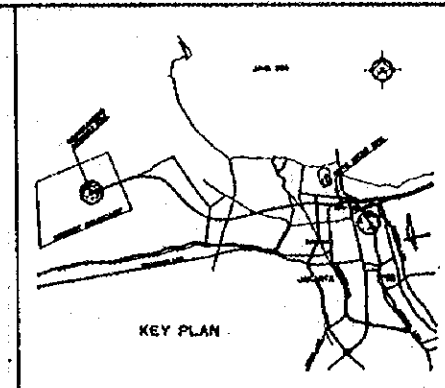

SCHEDULE OF VAC AND PLUMBING EQUIPMENT

SYMBOL	NAME OF EQUIPMENT	SPECIFICATION	QTY	REMARKS
WAC-1	WINDOW MOUNTED ROOM AIR CONDITIONER	CAP: 1.9 RT, 3.4 KW, 220 x 11", APPROX: 650 x 420 x 760 ^D	2	W/COOLER FRAME
+ -2	DITTO	14' x 2.3' x x, 650 x 420 x 650	2	DITTO
PEF-200	PIPE EXHAUST FAN	200 x 300 x 10 x 75 x (220 x 1")	1	HS, VC
WEF-250	WALL-TYPE EXHAUST FAN	250 x 300 x 6' x 26 x (DITTO)		EAG
+ -300	DITTO	300 x 600 x 8' x 60 x 1	2	DITTO
+ -350		350 x 850 x 8' x 100 x 1	4	
+ -400		400 x 1300 x 8' x 200 x 1		
WC-1	WATER CLOSET EASTERN TYPE	VITREOUS CHINA, APPROX: 280 x 570 x 300 ^H	1	W/P-TRAP, F-2
UR-1	URINAL, FLOOR MOUNTED TYPE	DITTO, DITTO: 380 x 380 x 920 ^H	1	W/FLUSH VALVE, INLET SPUD
LV-1	LAVATORY, WALL-HUNG	: 530 x 430	1	W/F-1, P-TRAP, SHUT OFF VALVE

REPUBLIC OF INDONESIA
MINISTRY OF COMMUNICATIONS
DIRECTORATE GENERAL OF LAND TRANSPORT AND INLAND WATERWAYS



NEW RAILWAY LINE FOR CENGKARENG AIRPORT
CONSTRUCTION PROJECT

JAPAN INTERNATIONAL COOPERATION AGENCY (JICA)


REVISIONS	DATE	REVISION	DATE	REVISION	DATE	REVISION	DATE
A	1/20/89	REVISED	1/20/89	REVISED	1/20/89	REVISED	1/20/89

SIGNAL CABIN A
VAC AND PLUMBING
1F, 2F PLAN AND
APPARATUS SCHEDULE

PACKAGE: I CIVIL AND ARCHITECTURAL WORK
SCALE: 1:50
DRAWING NO: AM - 026

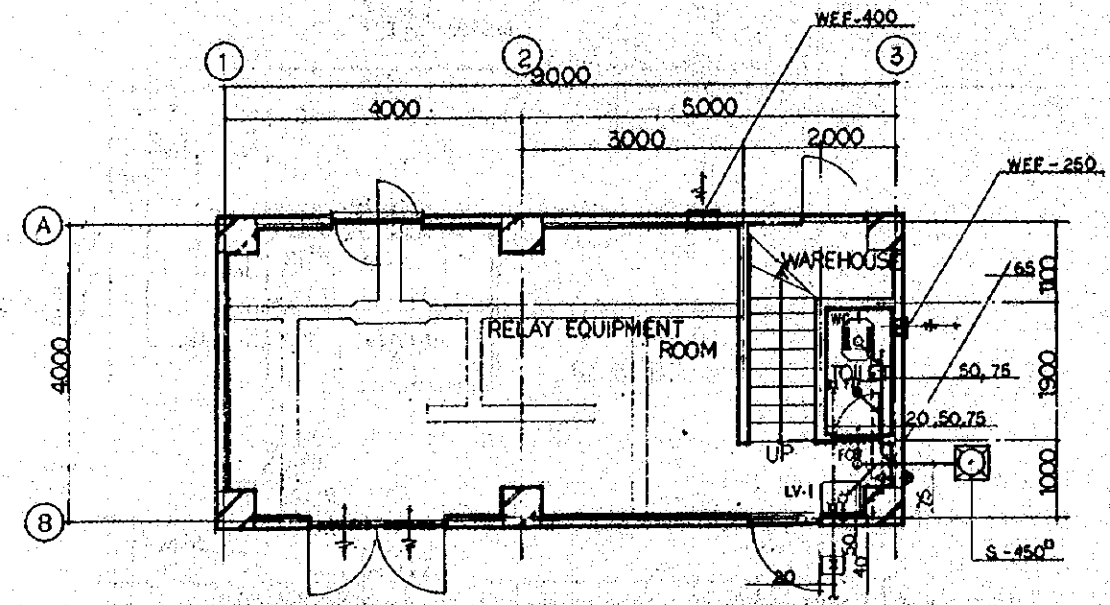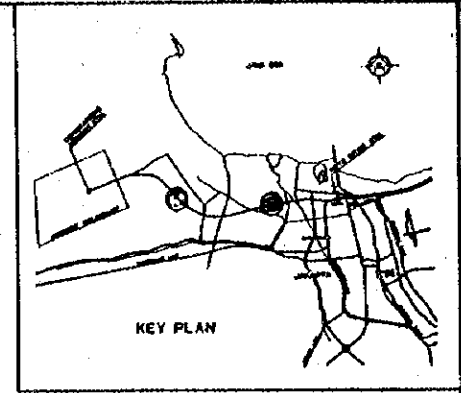

1F PLAN
SCALE 1:50

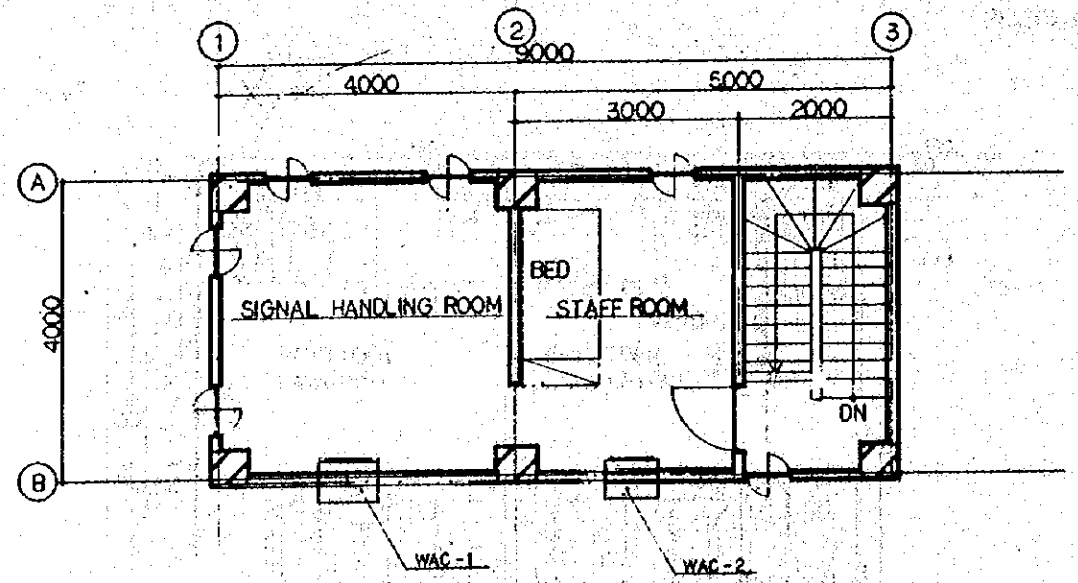

2F PLAN
SCALE 1:50

SCHEDULE OF VAC AND PLUMBING EQUIPMENT

SYMBOL	NAME OF EQUIPMENT	SPECIFICATION	QTY	REMARKS
WAC-1	WINDOW MOUNTED ROOM AIR CONDITIONER	CAP: 1.9 RT x 3.4 KW x 220 V x 1 P, APPROX: 650 W x 420 H x 760 D	1	W/COOLER FRAME
# - 2	DITTO	# : 14' x 2.5' x # x #, # : 650 x 420 x 650	1	DITTO
PEF-200	PIPE EXHAUST FAN	200 x 300 x 10 x 75 x (220 V x 1 P)		HS, VC
WEF-250	WALL-TYPE EXHAUST FAN	250 x 300 x 6' x 25' x (DITTO)	1	EAG
# - 300	DITTO	300 x 600 x 8' x 50' x ()	1	DITTO
# - 350	#	350 x 850 x 8' x 100' x ()	1	
# - 400	#	400 x 1300 x 8' x 200' x ()	1	
WC-1	WATER CLOSET EASTERN TYPE	VITREOUS CHINA, APPROX: 280 x 570 x 300 H	1	W/P-TRAP, F-2
UR-1	URINAL, FLOOR MOUNTED TYPE	DITTO, DITTO: 390 x 380 x 920 H		W/FLUSH VALVE, INLET SPUD
LV-1	LAVATORY, WALL-HUNG	#, #, # : 530 x 430	1	W/F-1, P-TRAP, SHUT OFF VALVE

REPUBLIC OF INDONESIA
 MINISTRY OF COMMUNICATIONS
 DIRECTORATE GENERAL OF LAND TRANSPORT AND INLAND WATERWAYS


NEW RAILWAY LINE FOR CENGKARENG AIRPORT
 CONSTRUCTION PROJECT

JAPAN INTERNATIONAL COOPERATION AGENCY (JICA)




REVISIONS	DATE	REASON	BY	CHECKED	APPROVED	SUBMITTED
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A	1 FEB 89	REV	Y. S. K. M.	K. M.	K. M.	K. M.

SIGNAL CABIN B
 VENTILATION AND PLUMBING
 1F, 2F PLAN AND
 APPARATUS SCHEDULE



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 SCALE: 1:50
 DRAWING NO: AM - 027

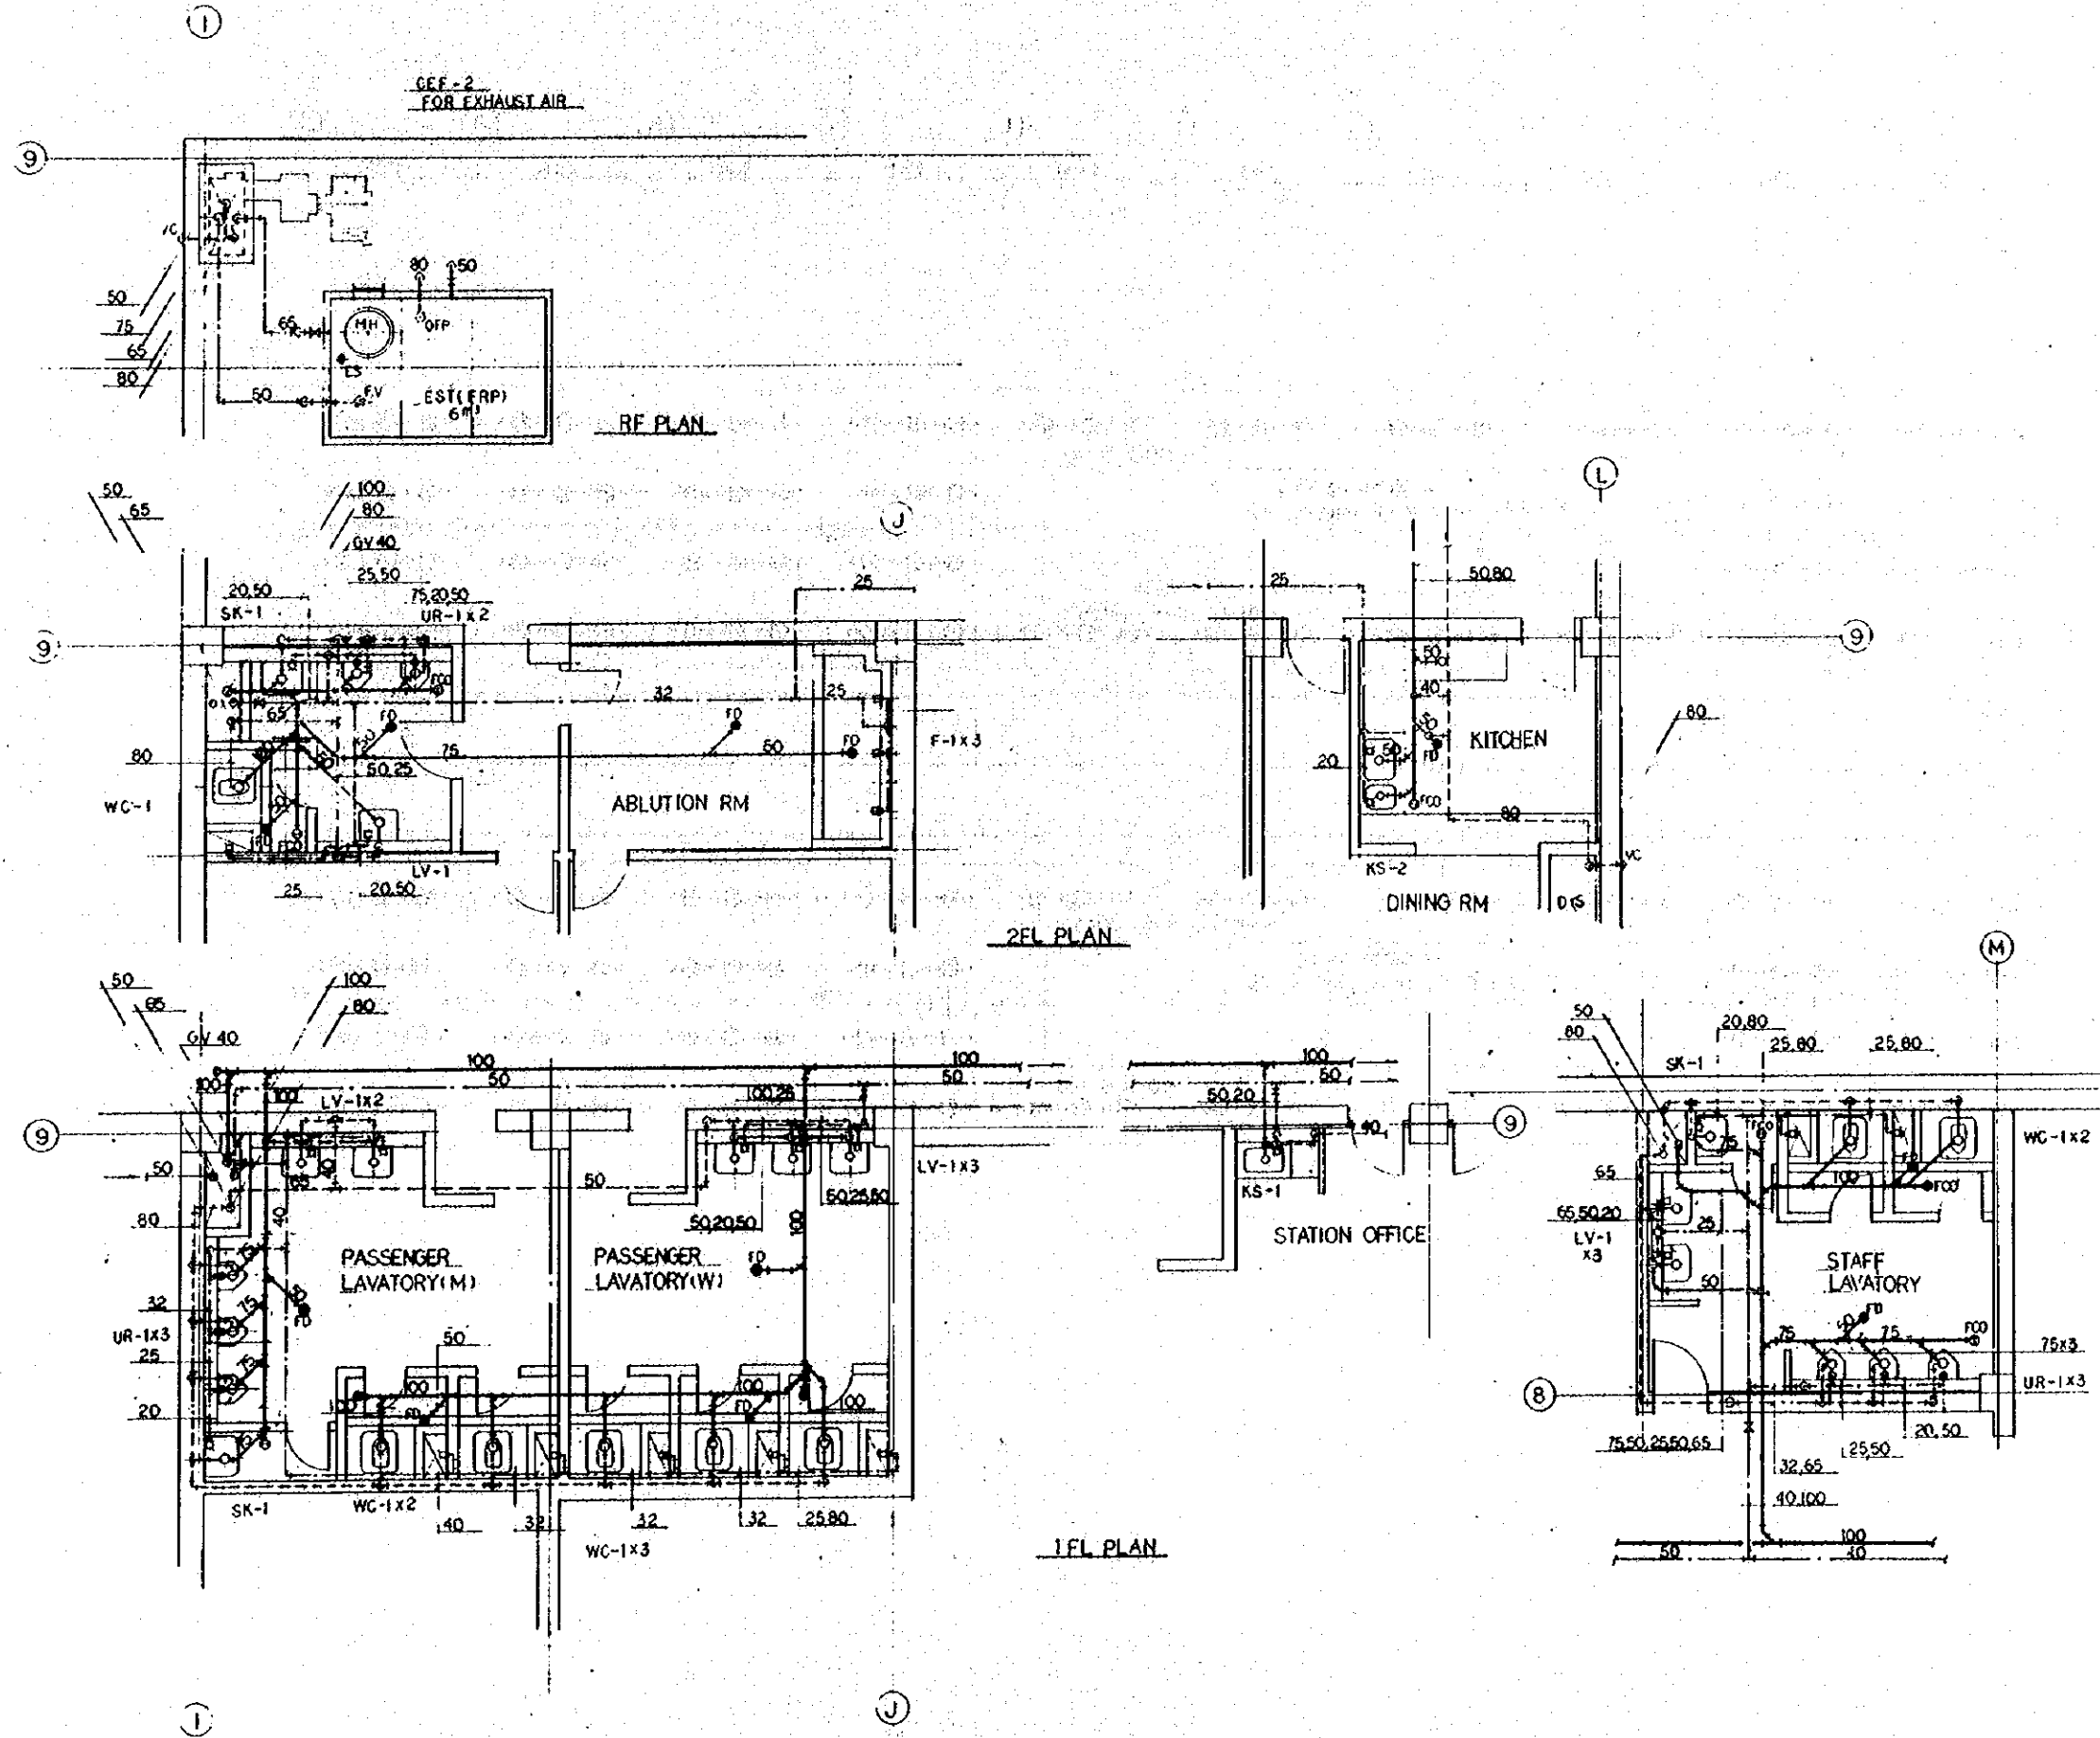

REPUBLIC OF INDONESIA MINISTRY OF COMMUNICATIONS DIRECTORATE GENERAL OF LAND TRANSPORT AND INLAND WATERWAYS					
NEW RAILWAY LINE FOR CENKARENG AIRPORT CONSTRUCTION PROJECT					
JAPAN INTERNATIONAL COOPERATION AGENCY (JICA)					
REVISIONS	DATE	DESIGNED	DRAWN	CHECKED	REVIEWED
B	1/09/2011	[Signature]	[Signature]	[Signature]	[Signature]
A	15/08/2011	[Signature]	[Signature]	[Signature]	[Signature]
KOTA INTAN STATION PLUMBING DETAIL PLAN					
PACKAGE: I CIVIL AND ARCHITECTURAL WORK					
SCALE: 1:50		DRAWING NO: AM - 028			

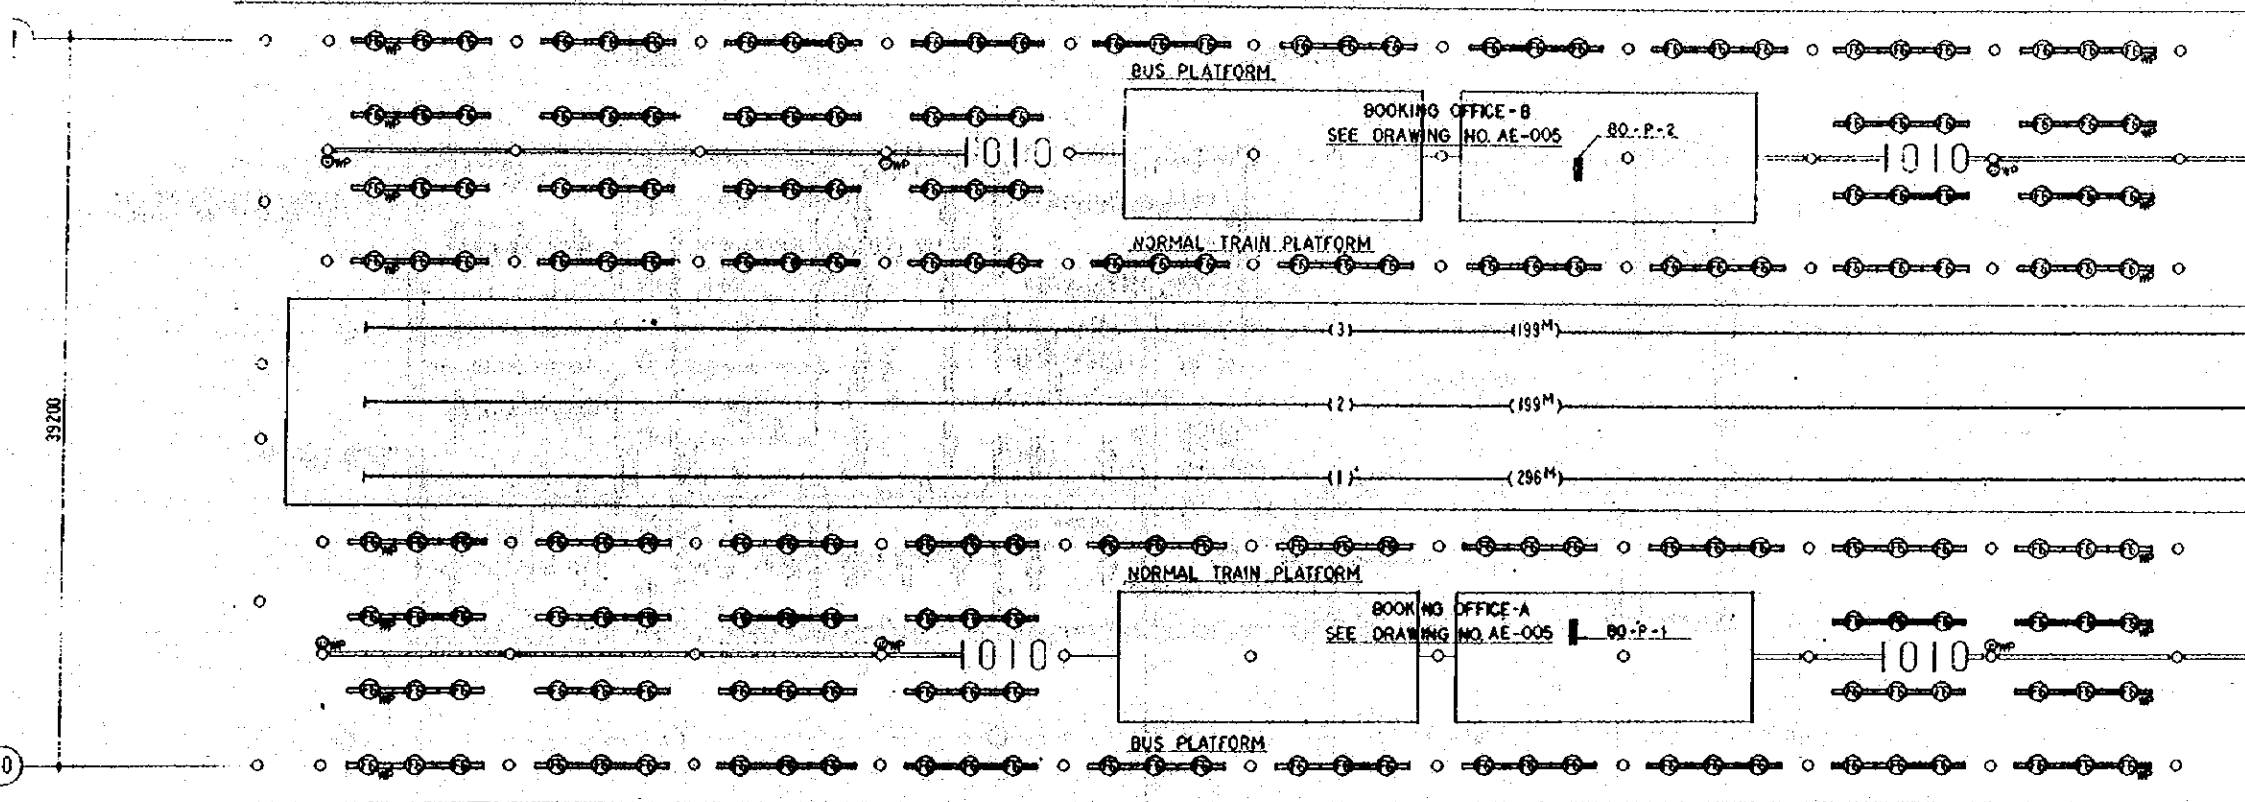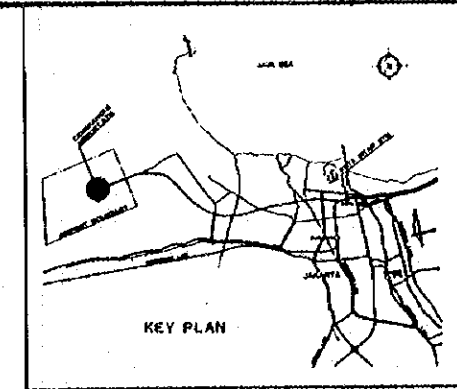
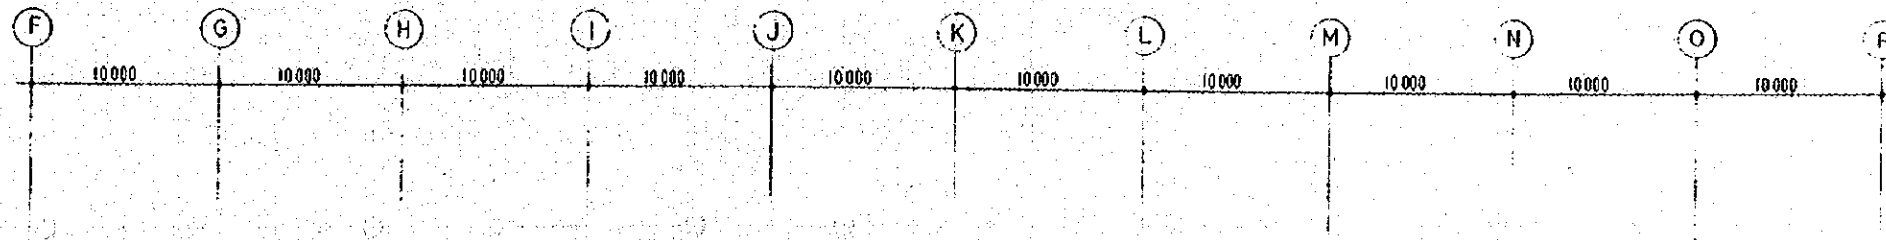


REPUBLIC OF INDONESIA MINISTRY OF COMMUNICATIONS DIRECTORATE GENERAL OF LAND TRANSPORT AND INLAND WATERWAYS						
NEW RAILWAY LINE FOR CENGKARENO AIRPORT CONSTRUCTION PROJECT						
JAPAN INTERNATIONAL COOPERATION AGENCY (JICA)						
REVISIONS	DATE	DESIGNED	DRAWN	CHECKED	REVIEWED	SUBMITTED
B	1.12.97	ET	TS	AK	AK	
A	11.02.97	ET	ET	ET	AK	AK
AIRPORT TERMINAL STATION PLATFORM LIGHTING AND RECEPTACLE SYSTEM						
PACKAGE: 1 CIVIL AND ARCHITECTURAL WORK						
SCALE: 1:200		DRAWING NO: AE-001				

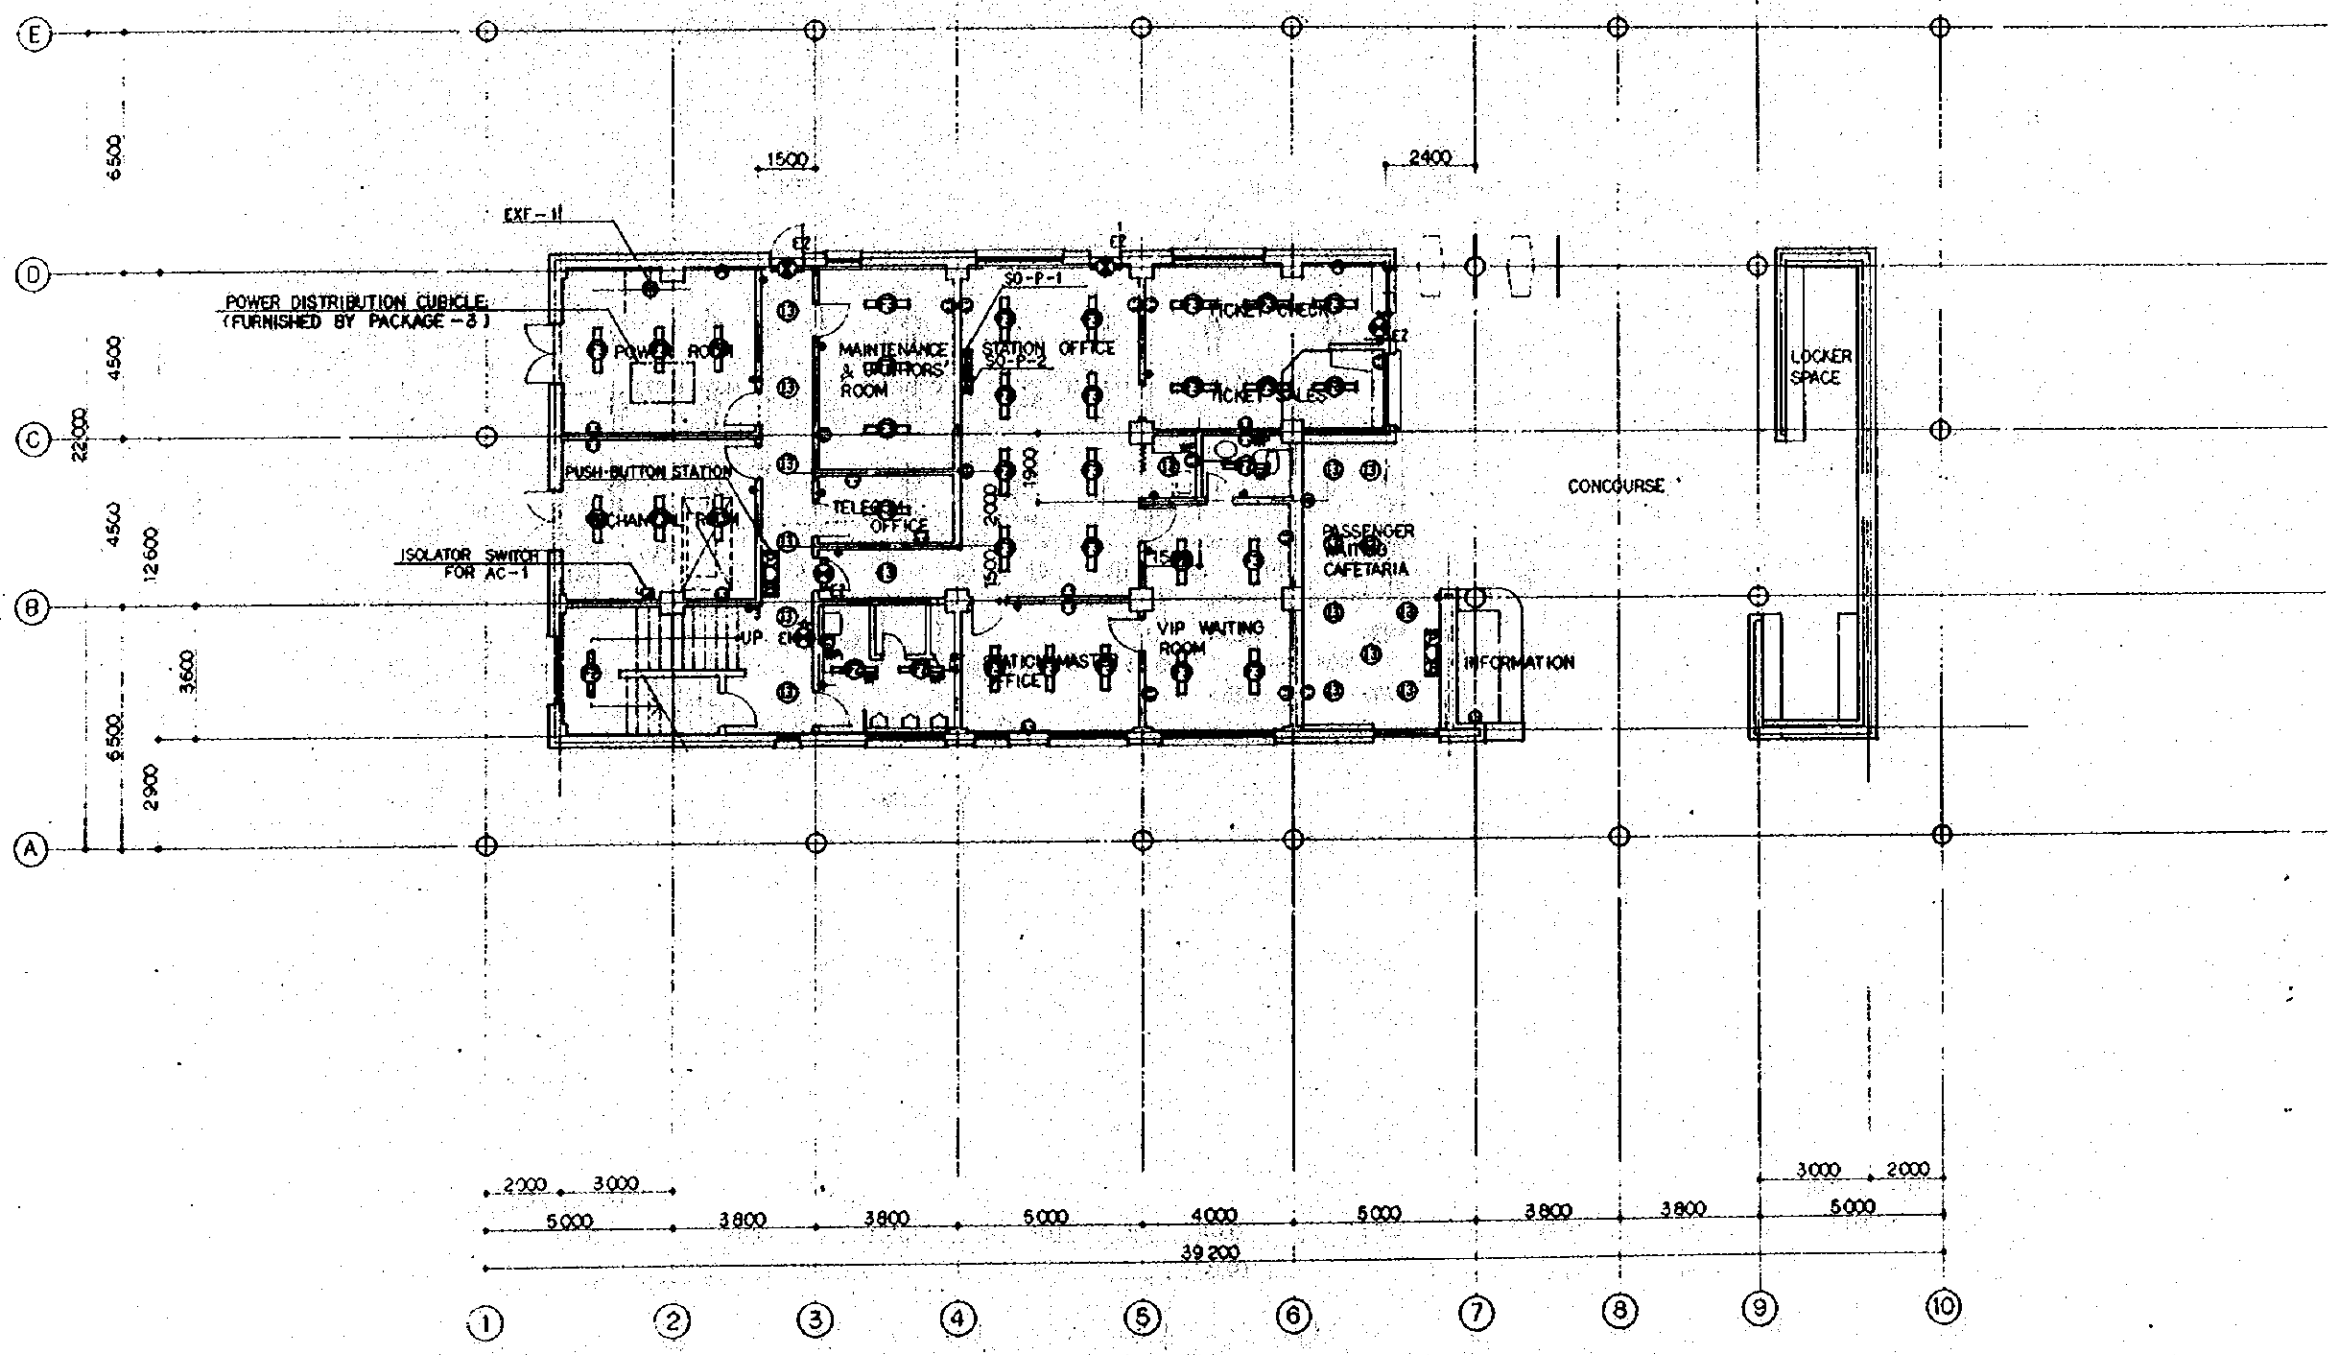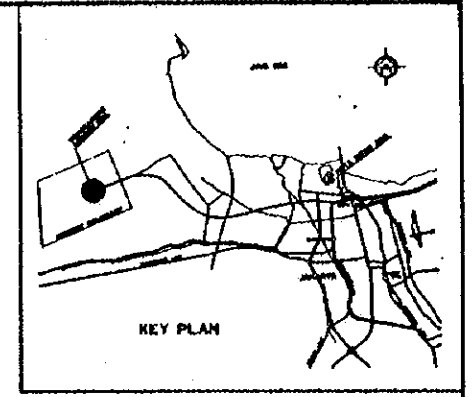



- NOTES**
- 1 ALL STAIRCASES SHALL HAVE NORMAL AND EMERGENCY LIGHTING.
 - 2 THREE WAY SWITCHES SHALL BE USED FOR ALL THE STAIRCASES.
 - 3 EMERGENCY LIGHTING SHALL BE PROVIDED IN OPERATING AREAS, AND ALL OTHER CRITICAL AREAS FOR OPERATING PERSONNEL SAFETY.

REPUBLIC OF INDONESIA MINISTRY OF COMMUNICATIONS DIRECTORATE GENERAL OF LAND TRANSPORT AND INLAND WATERWAYS					
NEW RAILWAY LINE FOR CENGKARENG AIRPORT CONSTRUCTION PROJECT					
JAPAN INTERNATIONAL COOPERATION AGENCY (JICA)					
B	1 AUG 88	E.T	E.T	S. K. M.	M. K.
A	15 FEB 88	S.T	E.T	S. K. M.	M. K.
REVISIONS	DATE	DESIGNED	DRAWN	CHECKED	REVIEWED
TERMINAL BLDG. 1F LIGHTING AND RECEPTACLE SYSTEM					
PACKAGE: I CIVIL AND ARCHITECTURAL WORK					
SCALE: 1:100		DRAWING NO: AE - 002			

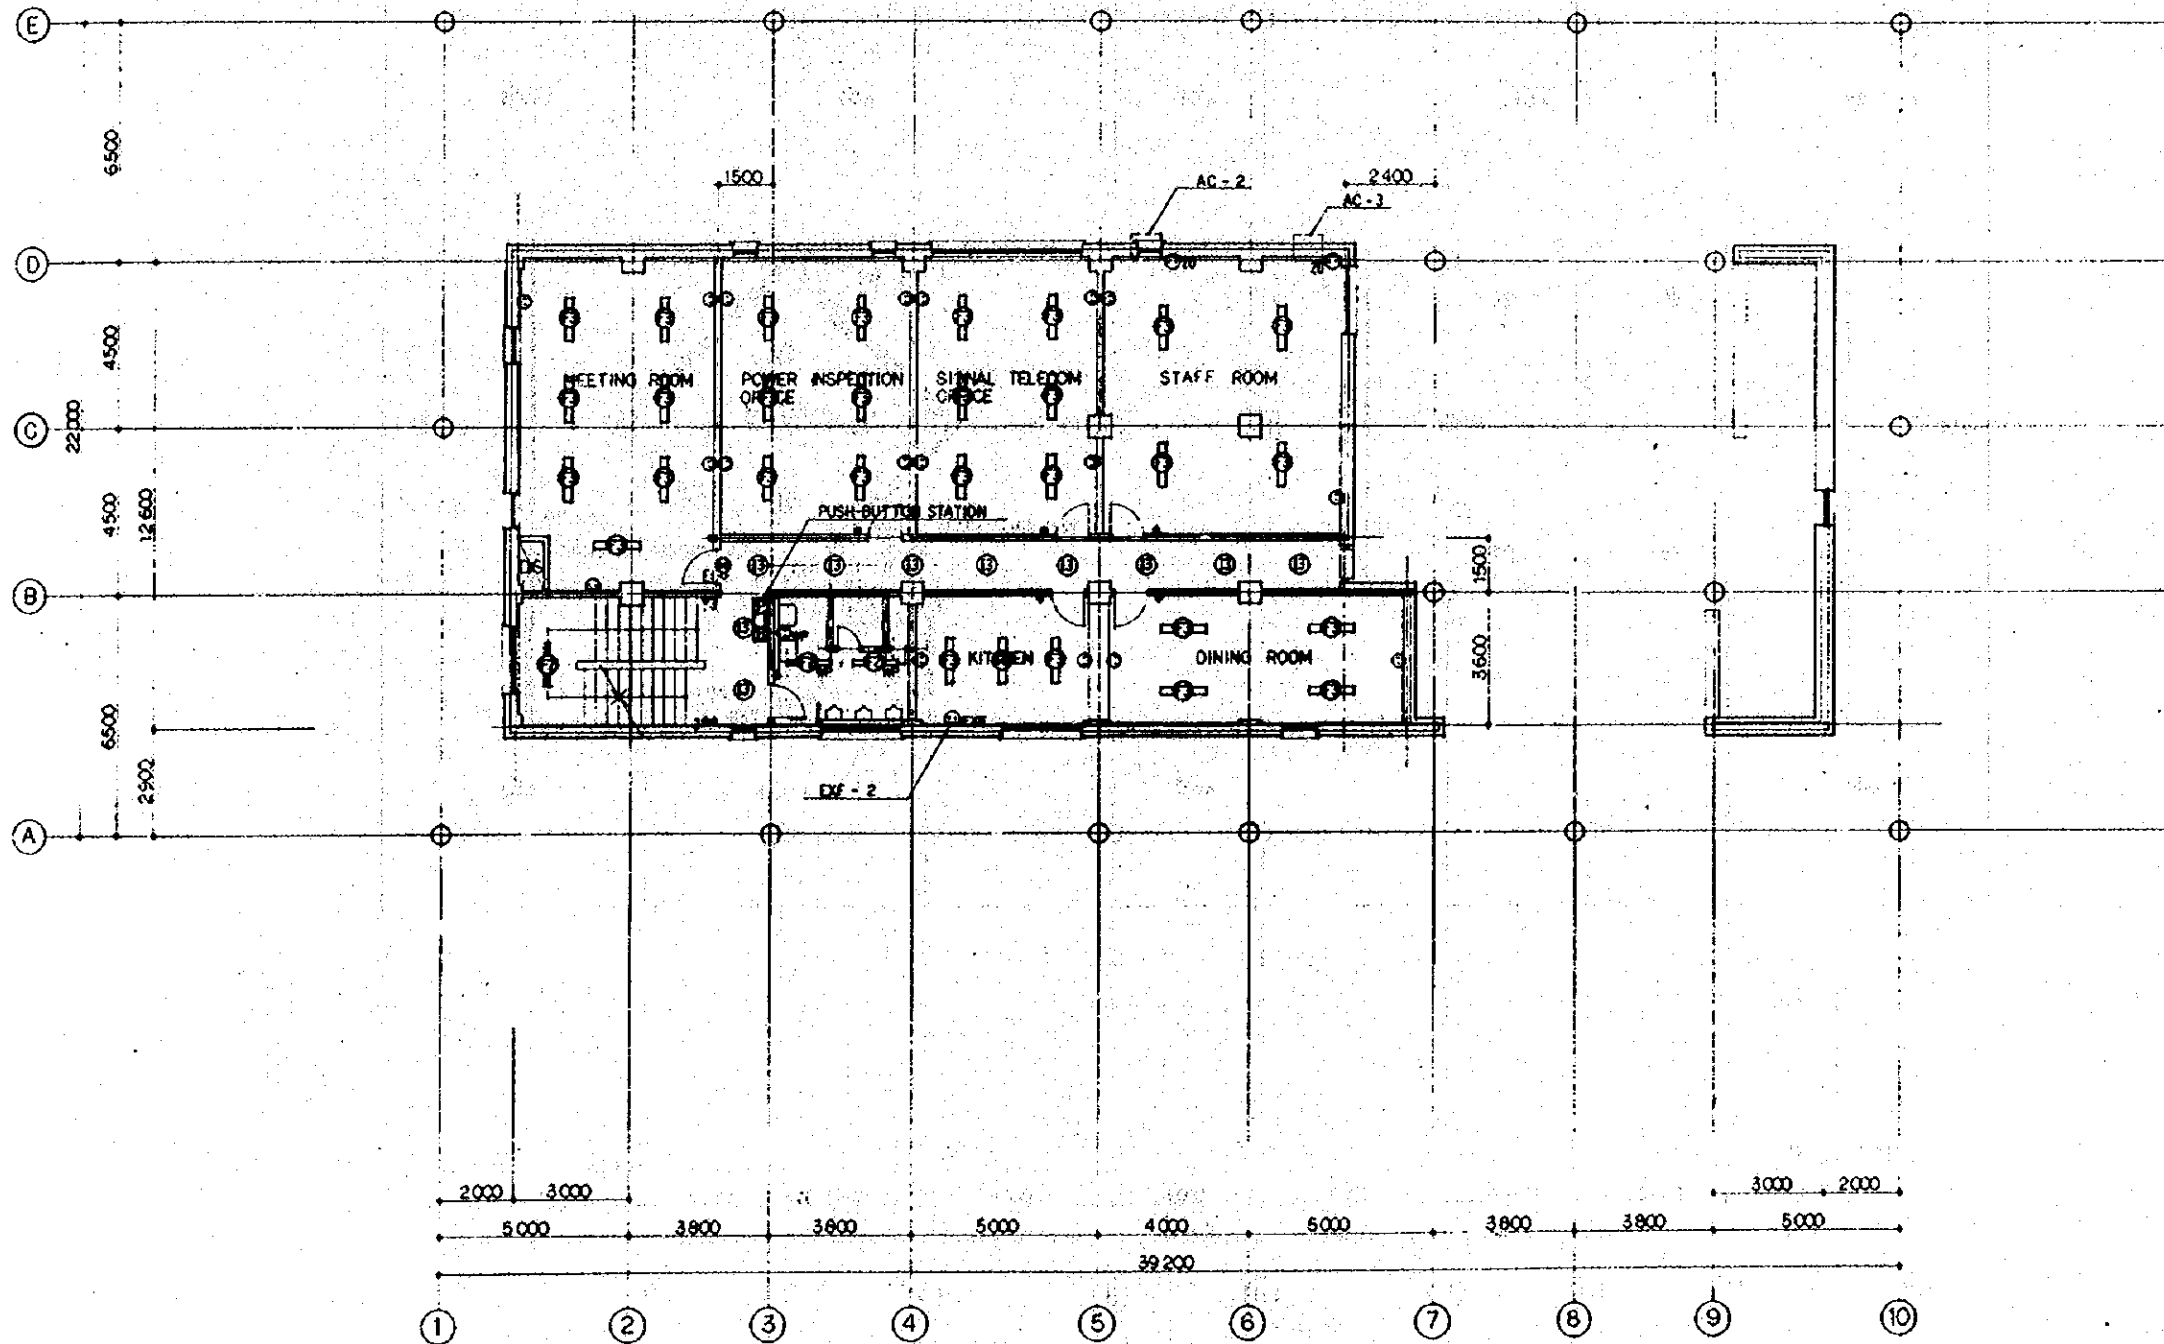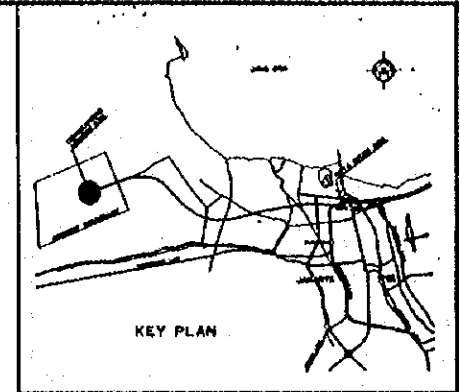

- NOTES**
- 1 ALL STAIRCASES SHALL HAVE NORMAL AND EMERGENCY LIGHTING.
 - 2 THREE WAY SWITCHES SHALL BE USED FOR ALL THE STAIRCASES.
 - 3 EMERGENCY LIGHTING SHALL BE PROVIDED IN OPERATING AREAS, AND ALL OTHER CRITICAL AREAS FOR OPERATING PERSONNEL SAFETY.

REPUBLIC OF INDONESIA MINISTRY OF COMMUNICATIONS DIRECTORATE GENERAL OF LAND TRANSPORT AND INLAND WATERWAYS						
NEW RAILWAY LINE FOR GENGKARENG AIRPORT CONSTRUCTION PROJECT						
JAPAN INTERNATIONAL COOPERATION AGENCY (JICA)						
B	1209.99	E.T	E.T	S-28	K.M	AK
A	0528.89	S.T	S.T	S-26	K.M	AK
REVISION	DATE	DESIGNED	CHECKED	APPROVED	REVIEWED	SUBMITTED
TERMINAL BLDG. 2F LIGHTING AND RECEPTACLE SYSTEM						
PACKAGE: I CIVIL AND ARCHITECTURAL WORK						
SCALE: 1:100				DRAWING NO: AE - 003		

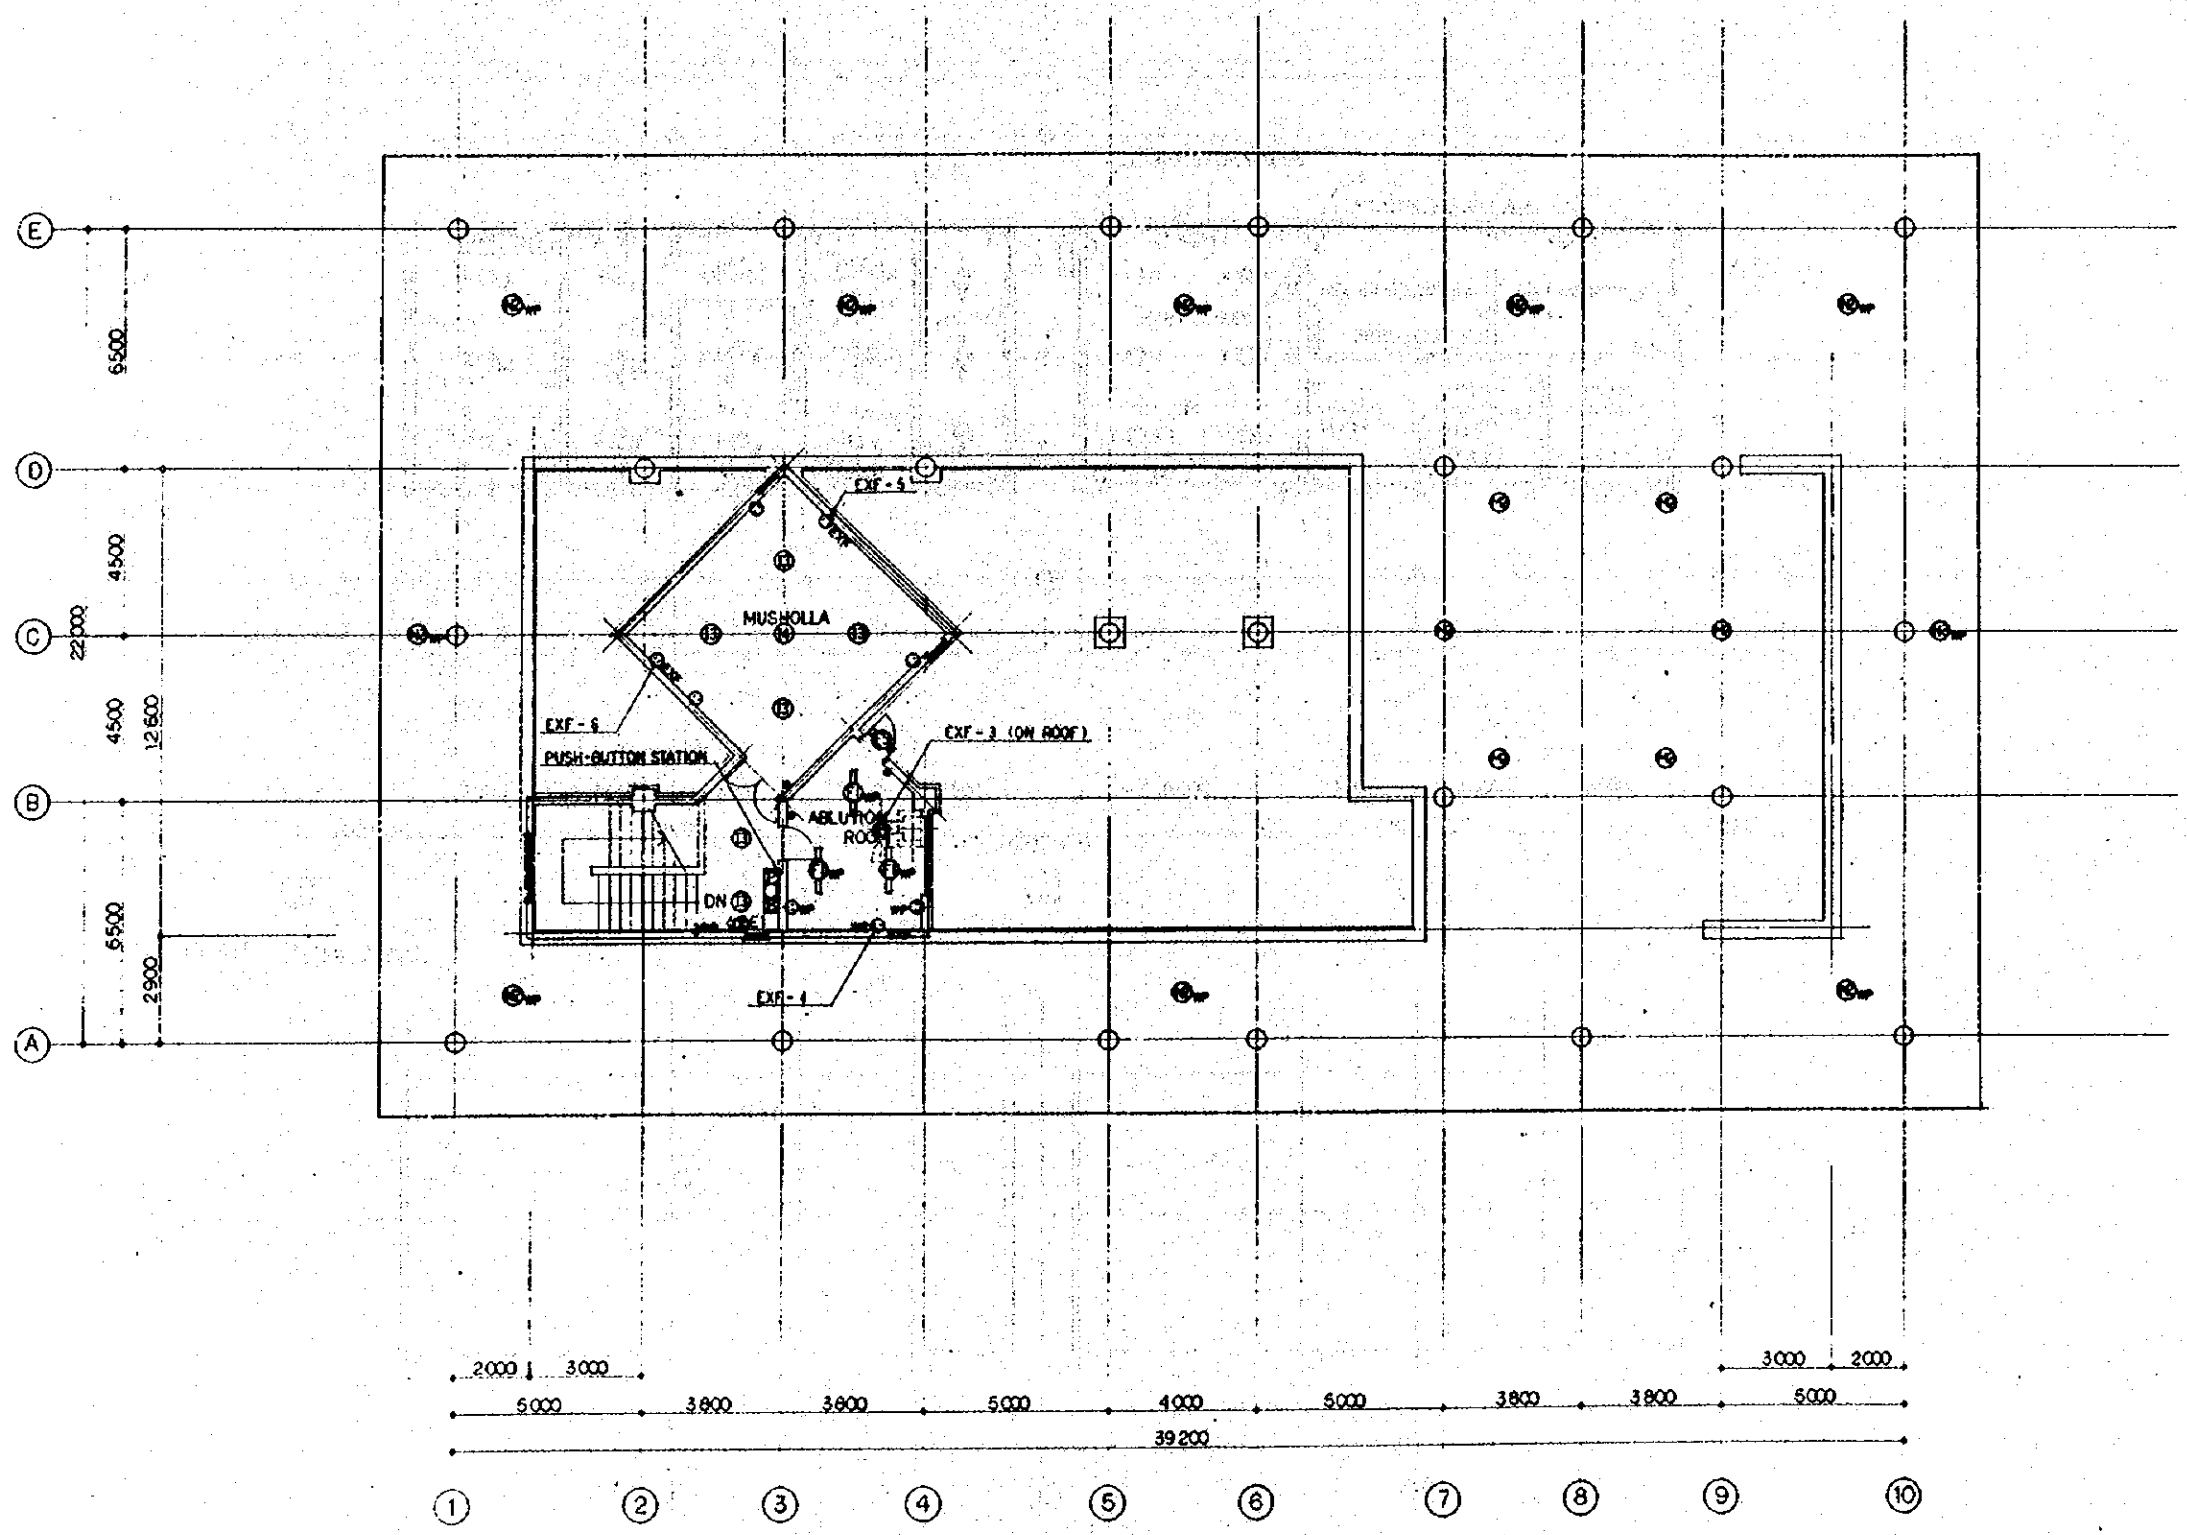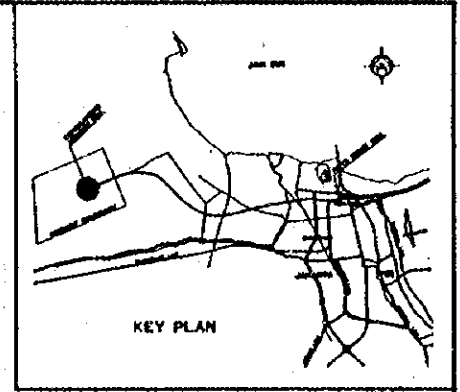

- NOTES**
- 1 ALL STAIRCASES SHALL HAVE NORMAL AND EMERGENCY LIGHTING.
 - 2 THREE WAY SWITCHES SHALL BE USED FOR ALL THE STAIRCASES.
 - 3 EMERGENCY LIGHTING SHALL BE PROVIDED IN OPERATING AREAS, AND ALL OTHER CRITICAL AREAS FOR OPERATING PERSONNEL SAFETY.

REPUBLIC OF INDONESIA
 MINISTRY OF COMMUNICATIONS
 DIRECTORATE GENERAL OF LAND TRANSPORT AND ISLAND WATERWAYS

NEW RAILWAY LINE FOR CENGKARENG AIRPORT CONSTRUCTION PROJECT



JAPAN INTERNATIONAL COOPERATION AGENCY (JICA)

REVISED	DATE	DESIGNED	DRAWN	CHECKED	REVIEWED	SUBMITTED
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A	15.02.89	E.T	E.T	E.A	K.M	M.K


TERMINAL BLDG.
 3F
 LIGHTING AND RECEPTACLE SYSTEM

PACKAGE: I CIVIL AND ARCHITECTURAL WORK

SCALE: 1:100 DRAWING NO: AE - 004

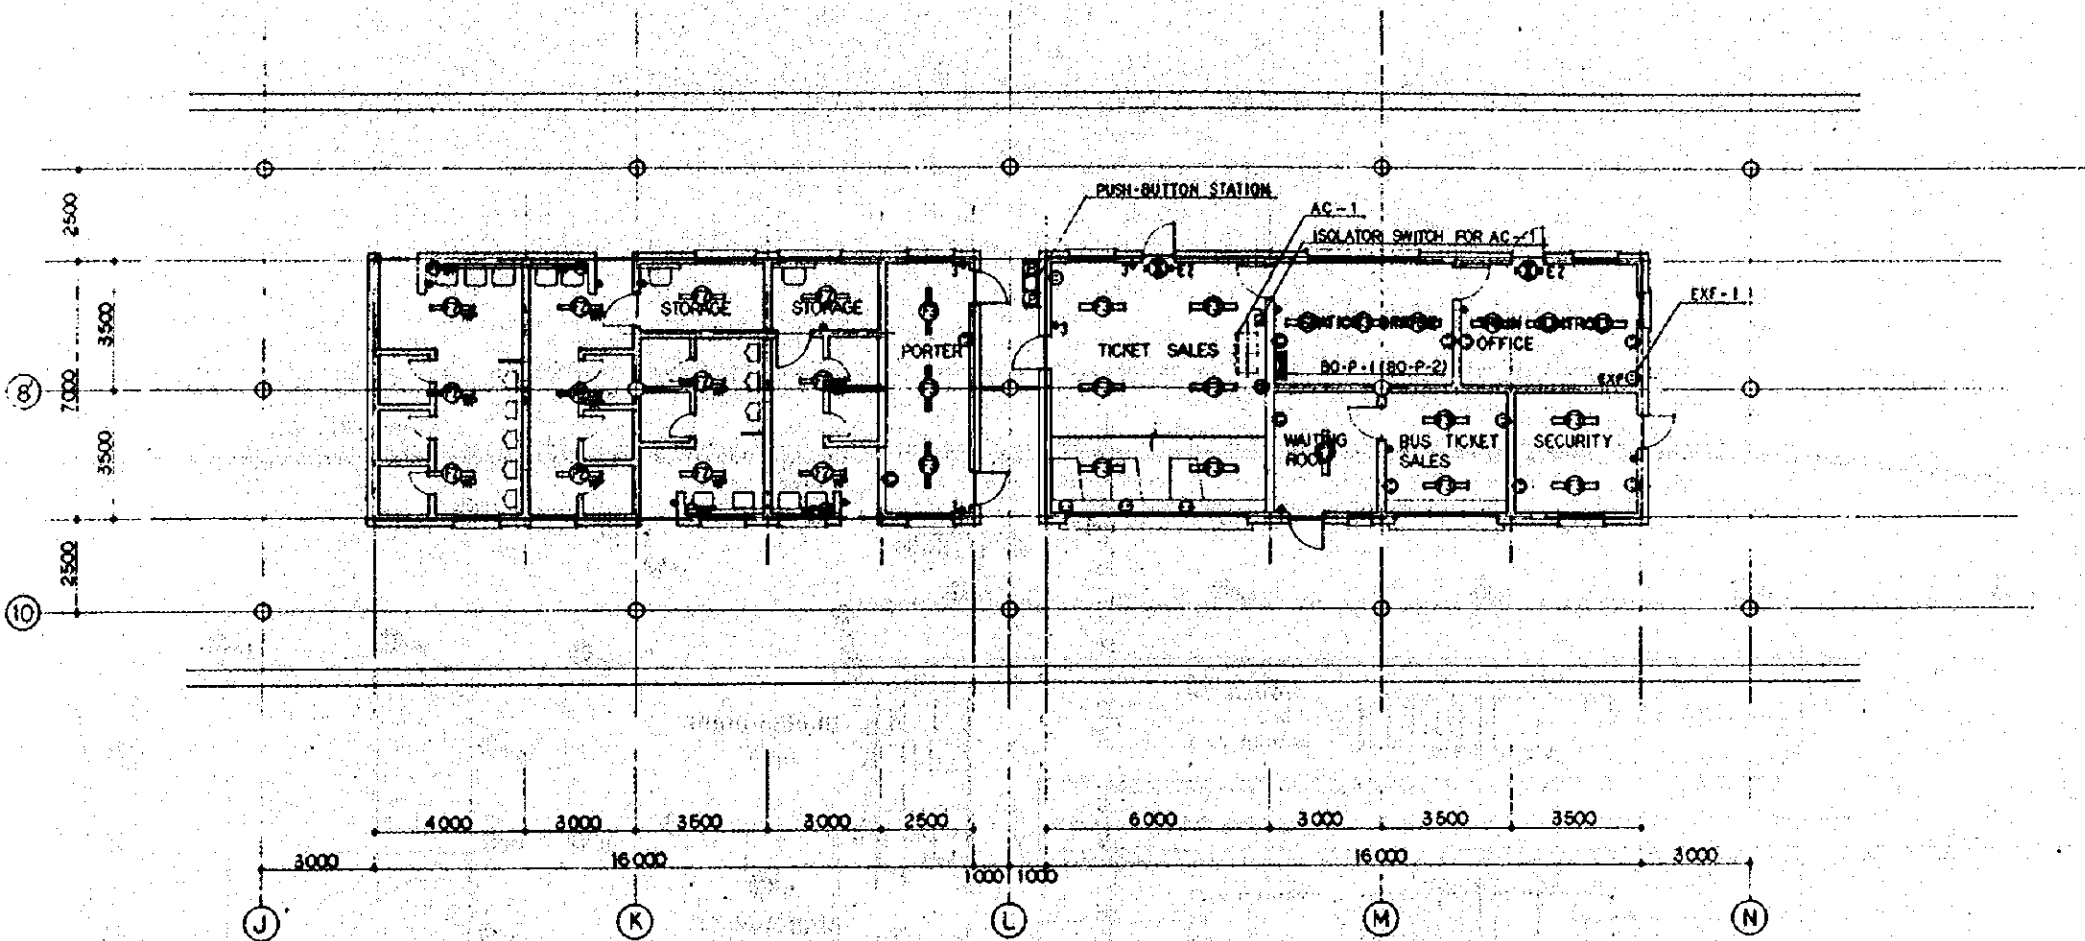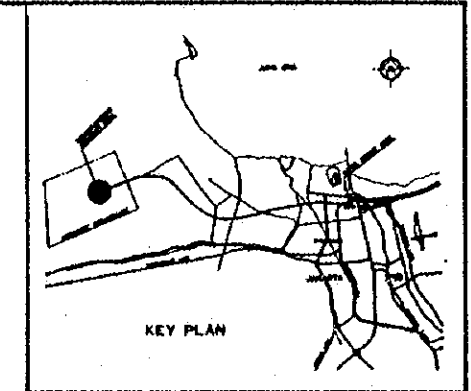

FL PLAN SCALE 1/100


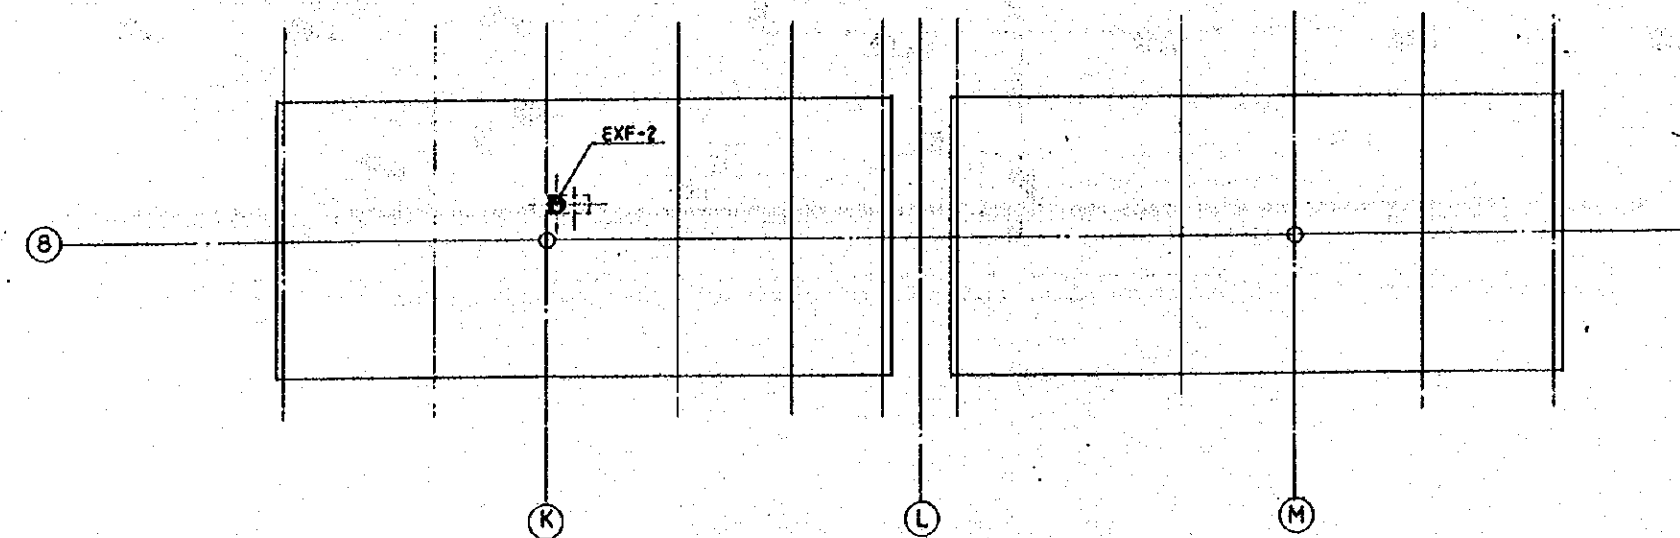


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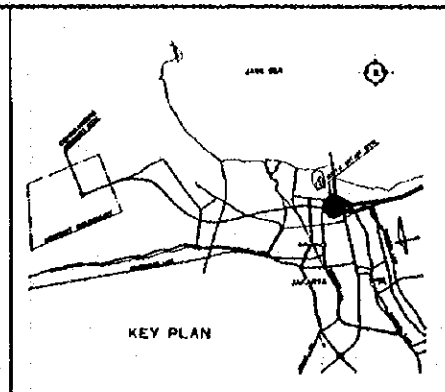
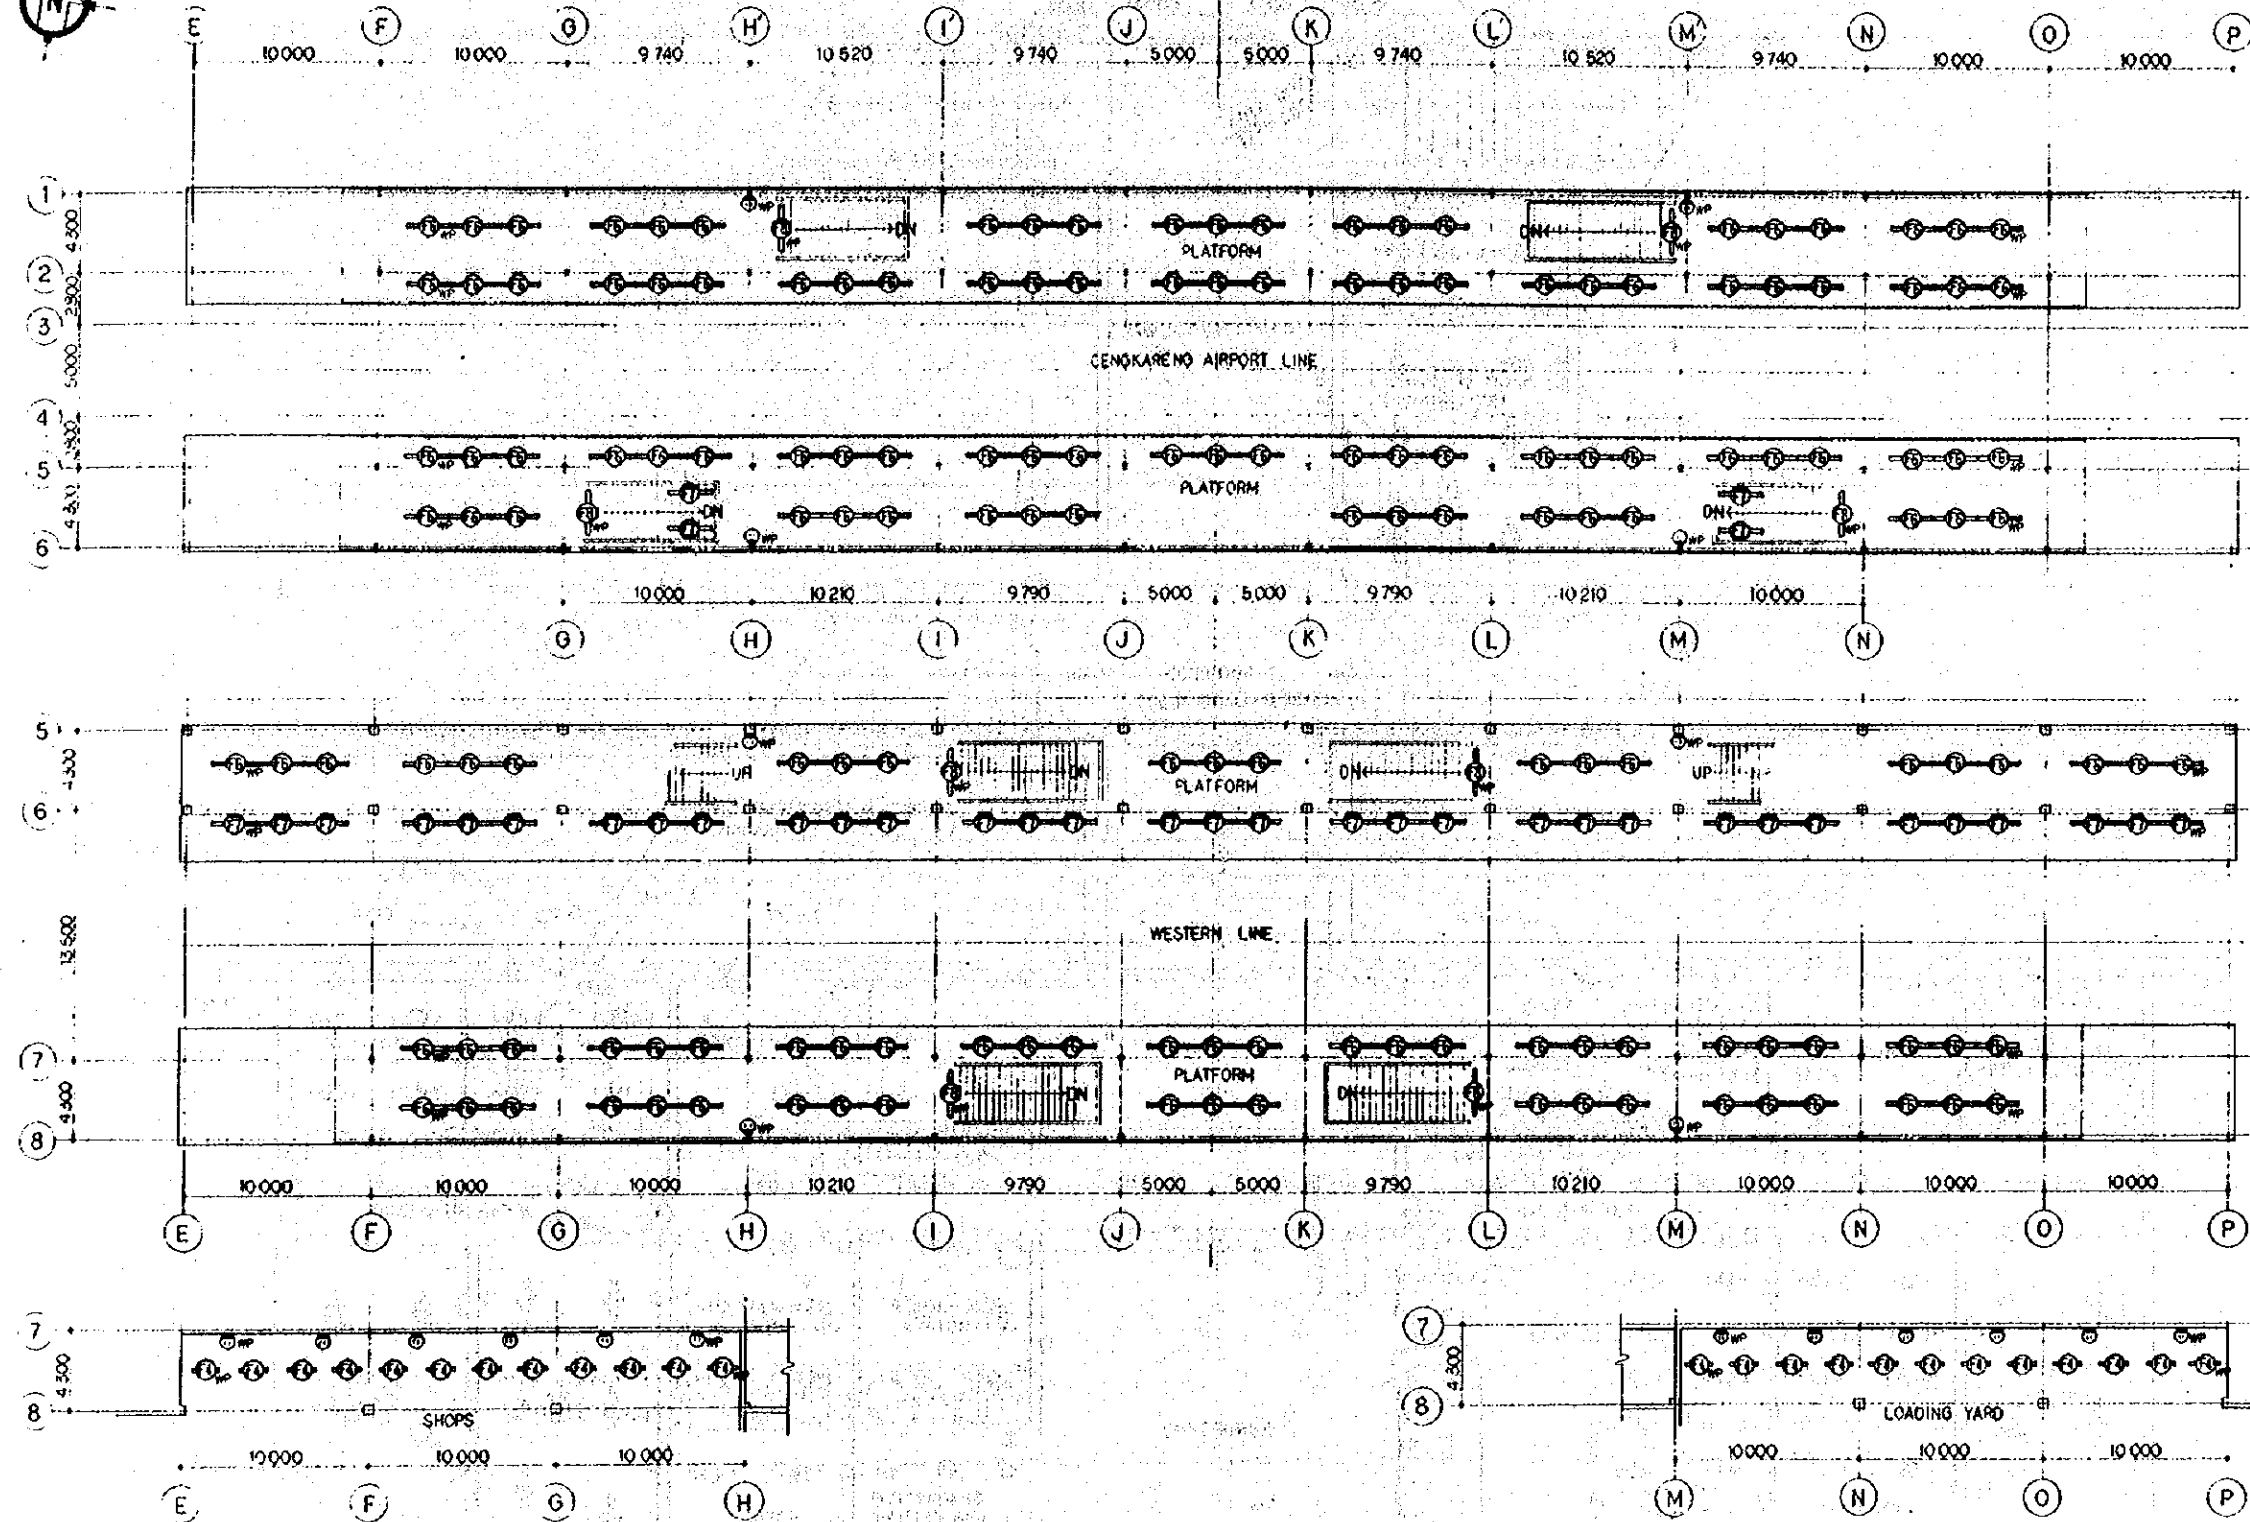
NOTES

- 1 ALL STAIRCASES SHALL HAVE NORMAL AND EMERGENCY LIGHTING.
- 2 THREE WAY SWITCHES SHALL BE USED FOR ALL THE STAIRCASES.
- 3 EMERGENCY LIGHTING SHALL BE PROVIDED IN OPERATING AREAS, AND ALL OTHER CRITICAL AREAS FOR OPERATING PERSONNEL SAFETY.



REPUBLIC OF INDONESIA MINISTRY OF COMMUNICATIONS DIRECTORATE GENERAL OF LAND TRANSPORT AND INLAND WATERWAYS						
NEW RAILWAY LINE FOR CENKARENG AIRPORT CONSTRUCTION PROJECT						
JAPAN INTERNATIONAL COOPERATION AGENCY (JICA)						
B	1.16.89	E.T	E.T	E.T	K.M	M.K
A	05.08.89	ST	BT	ST	K.M	M.K
REVISION	DATE	DESIGNED	DRAWN	CHECKED	REVIEWED	SUBMITTED
BOOKING OFFICE LIGHTING AND RECEPTACLE SYSTEM						
PACKAGE: I CIVIL AND ARCHITECTURAL WORK						
SCALE: 1:100		DRAWING NO: AE - 005				

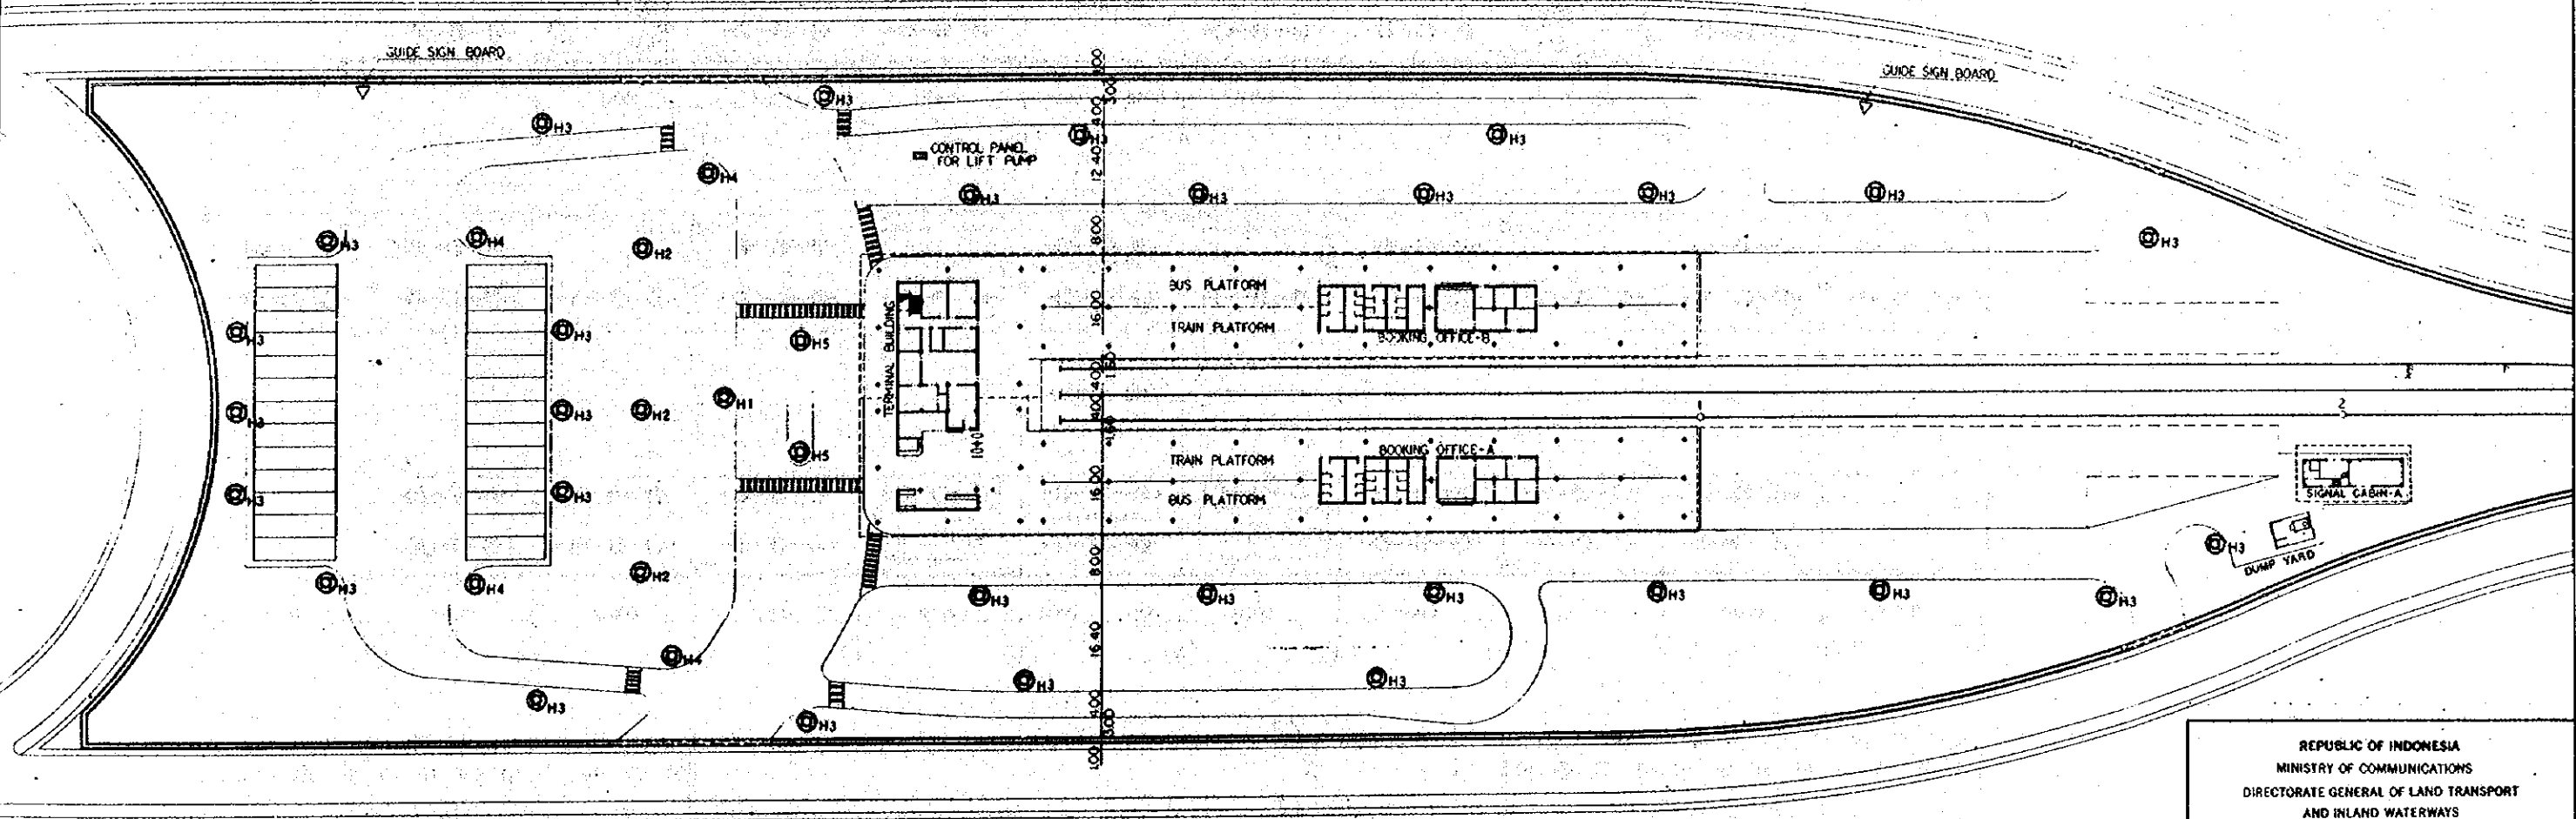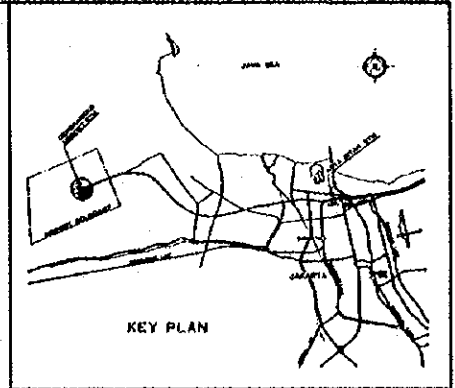

REPUBLIC OF INDONESIA MINISTRY OF COMMUNICATIONS DIRECTORATE GENERAL OF LAND TRANSPORT AND INLAND WATERWAYS						
NEW RAILWAY LINE FOR CENKARENG AIRPORT CONSTRUCTION PROJECT						
JAPAN INTERNATIONAL COOPERATION AGENCY (JICA)						
B	1 AUG 24	E.T	E.T	15.00	K.M	AK
A	15 FEB 24	E.T	E.T	15.00	K.M	AK
REVISIONS	DATE	REVISION	BY	CHECKED	APPROVED	SUBMITTED
AIRPORT TERMINAL STATION STATION PLAZA LIGHTING AND RECEPTACLE SYSTEM						
PACKAGE: I CIVIL AND ARCHITECTURAL WORK						
SCALE		DRAWING NO.				
1:500		AE - 006				




REPUBLIC OF INDONESIA MINISTRY OF COMMUNICATIONS DIRECTORATE GENERAL OF LAND TRANSPORT AND INLAND WATERWAYS					
NEW RAILWAY LINE FOR CENKARENO AIRPORT CONSTRUCTION PROJECT					
JAPAN INTERNATIONAL COOPERATION AGENCY (JICA)					
REVISIONS	DATE	DESIGNED	DRAWN	CHECKED	APPROVED
B	1 AUG 89	E.T.	E.T.	E.T.	K.M. n.k.
A	5 FEB 89	E.T.	E.T.	E.T.	K.M. n.k.
KOTA INTAN STATION PLATFORM LIGHTING AND RECEPTACLE SYSTEM					
PACKAGE: I CIVIL AND ARCHITECTURAL WORK					
SCALE: 1:200		DRAWING NO: AE - 007			

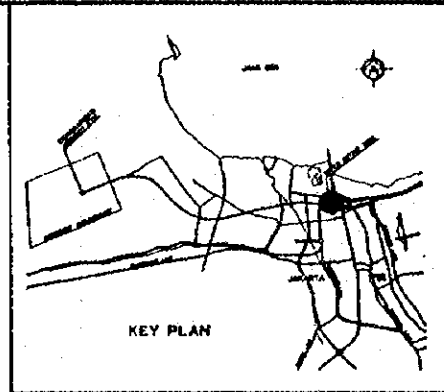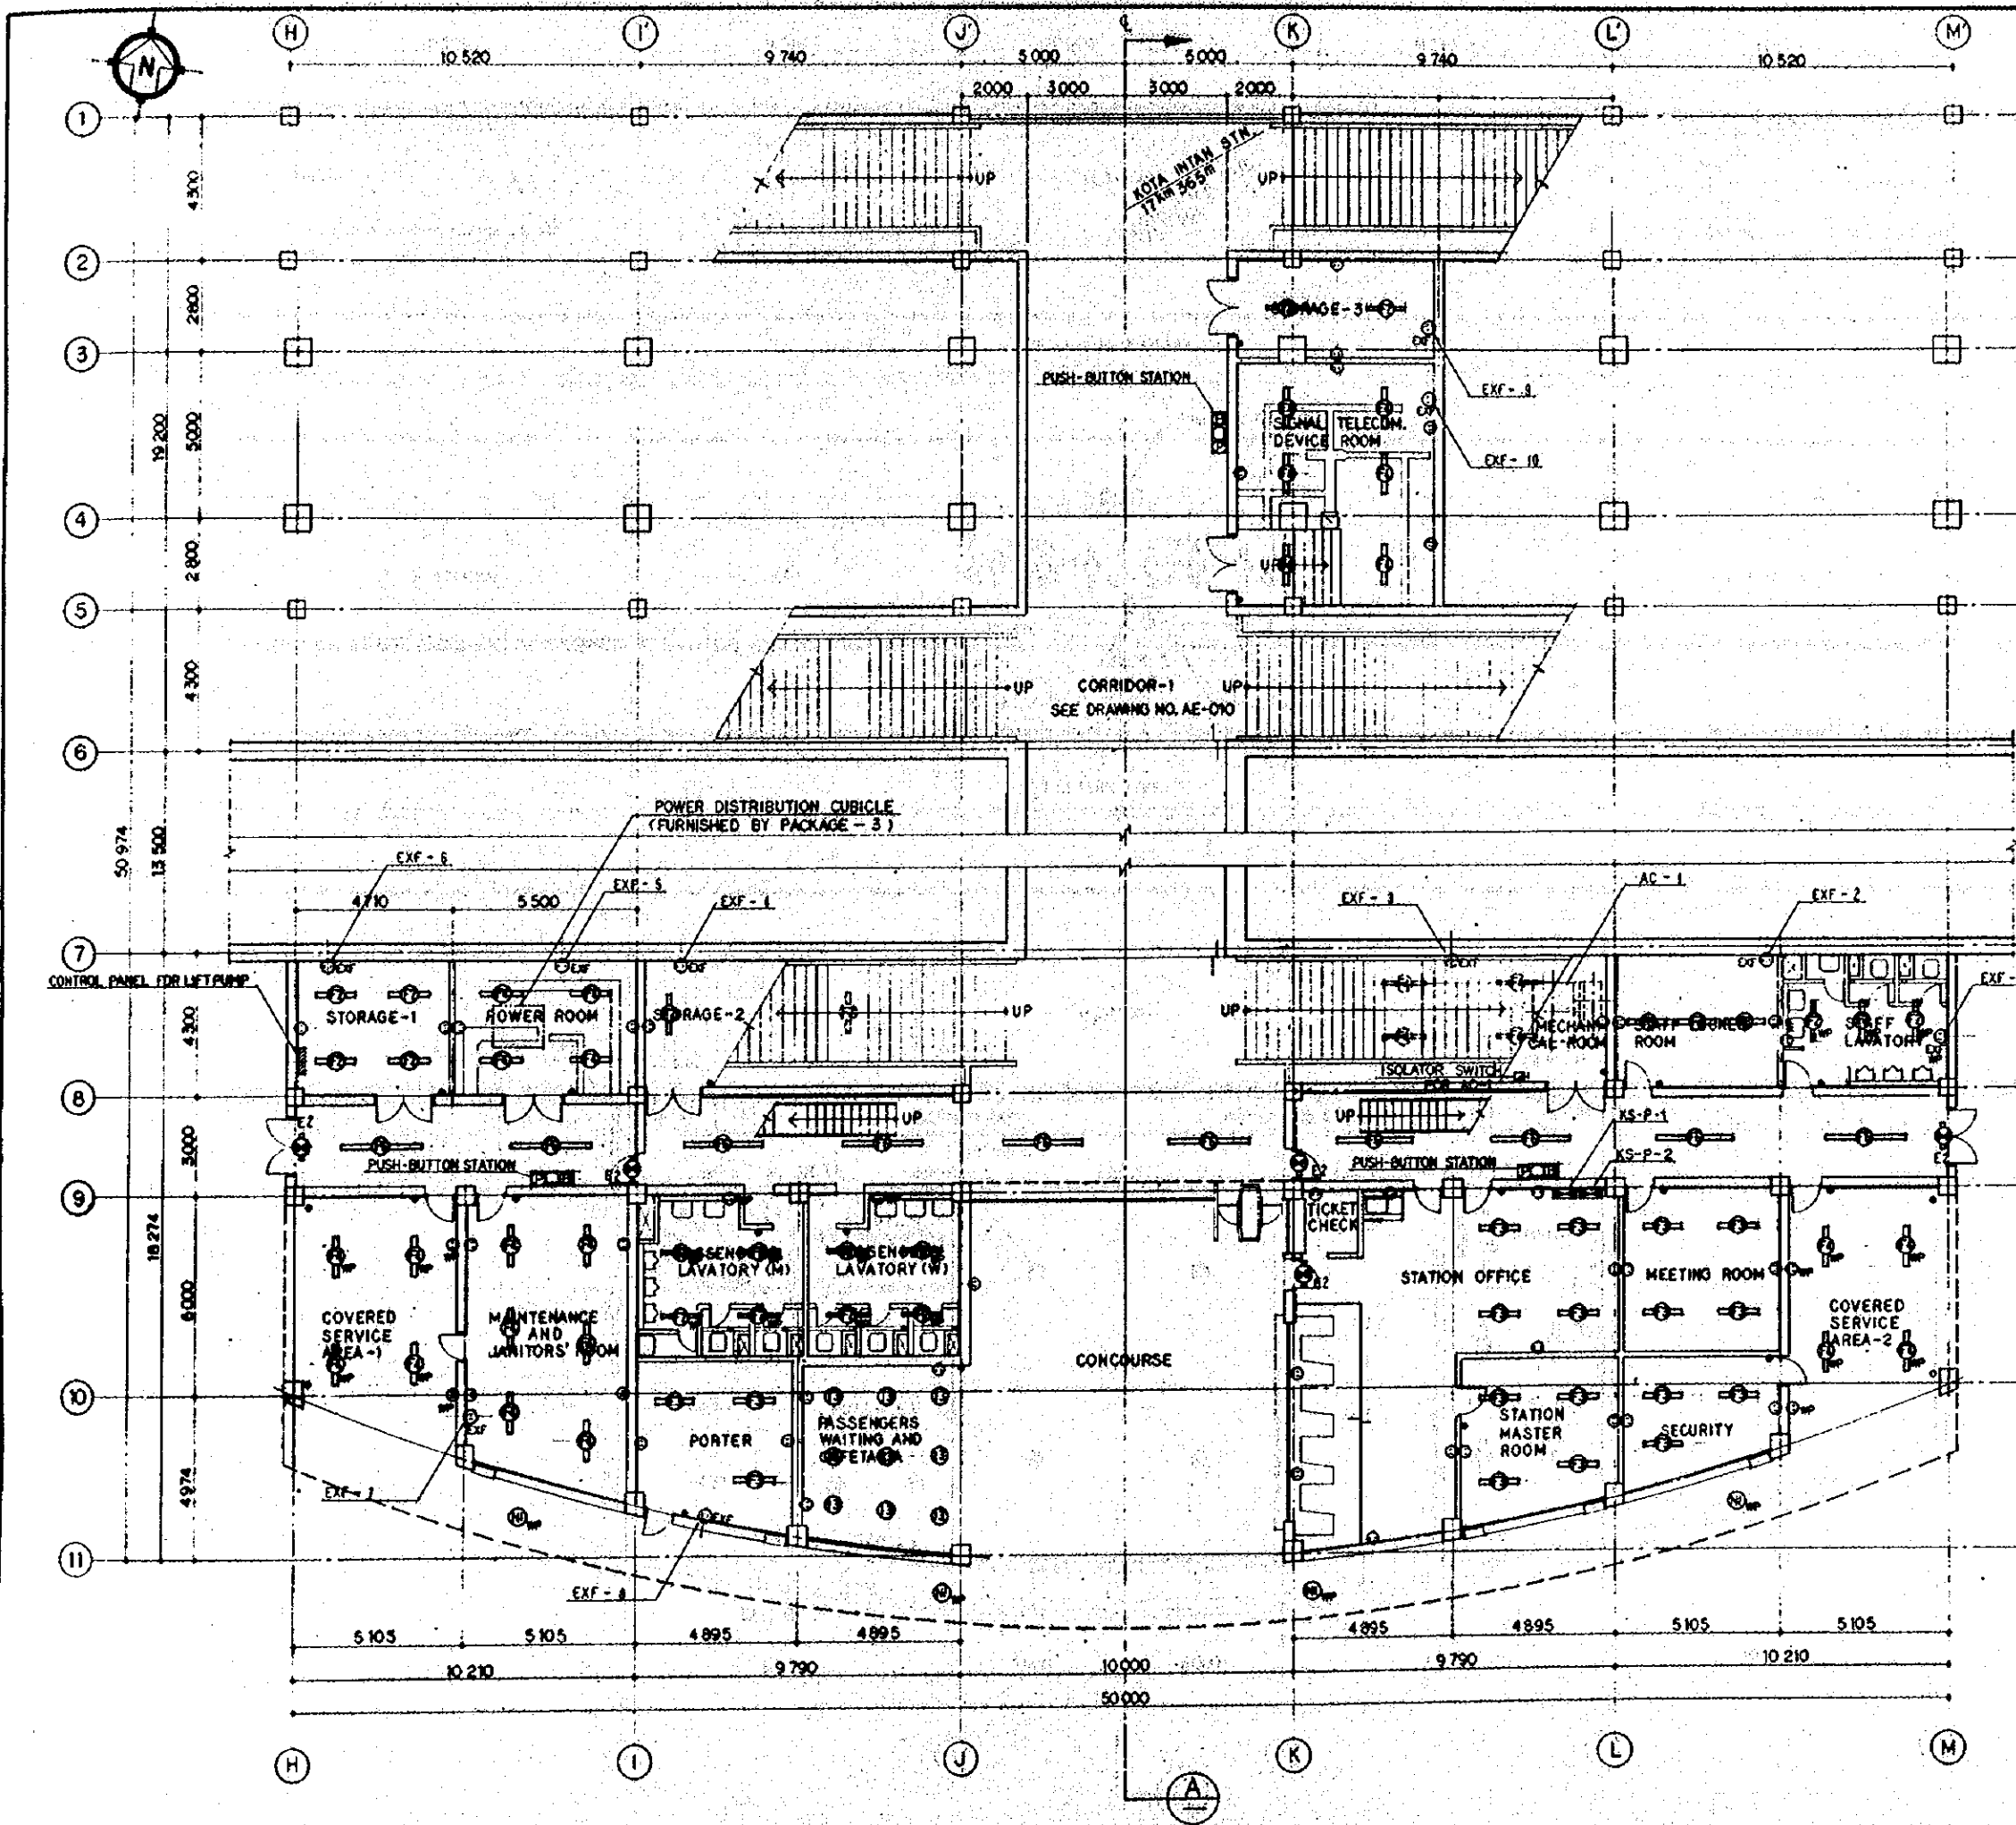

- NOTES**
- 1 ALL STAIRCASES SHALL HAVE NORMAL AND EMERGENCY LIGHTING.
 - 2 THREE WAY SWITCHES SHALL BE USED FOR ALL THE STAIRCASES.
 - 3 EMERGENCY LIGHTING SHALL BE PROVIDED IN OPERATING AREAS, AND ALL OTHER CRITICAL AREAS FOR OPERATING PERSONNEL SAFETY.

REPUBLIC OF INDONESIA MINISTRY OF COMMUNICATIONS DIRECTORATE GENERAL OF LAND TRANSPORT AND INLAND WATERWAYS					
NEW RAILWAY LINE FOR CENKARENG AIRPORT CONSTRUCTION PROJECT					
JAPAN INTERNATIONAL COOPERATION AGENCY (JICA)					
B	1 AUG 89	9.1	ET	ST	K.M. / K.
A	2 FEB 89	ET	ST	ST	K.M. / K.
REVISIONS	DATE	DESIGNED	DRAWN	CHECKED	REVIEWED
KOTA INTAN STATION IF LIGHTING AND RECEPTACLE SYSTEM					
PACKAGE: I CIVIL AND ARCHITECTURAL WORK					
SCALE: 1:100		DRAWING NO: AE - 008			

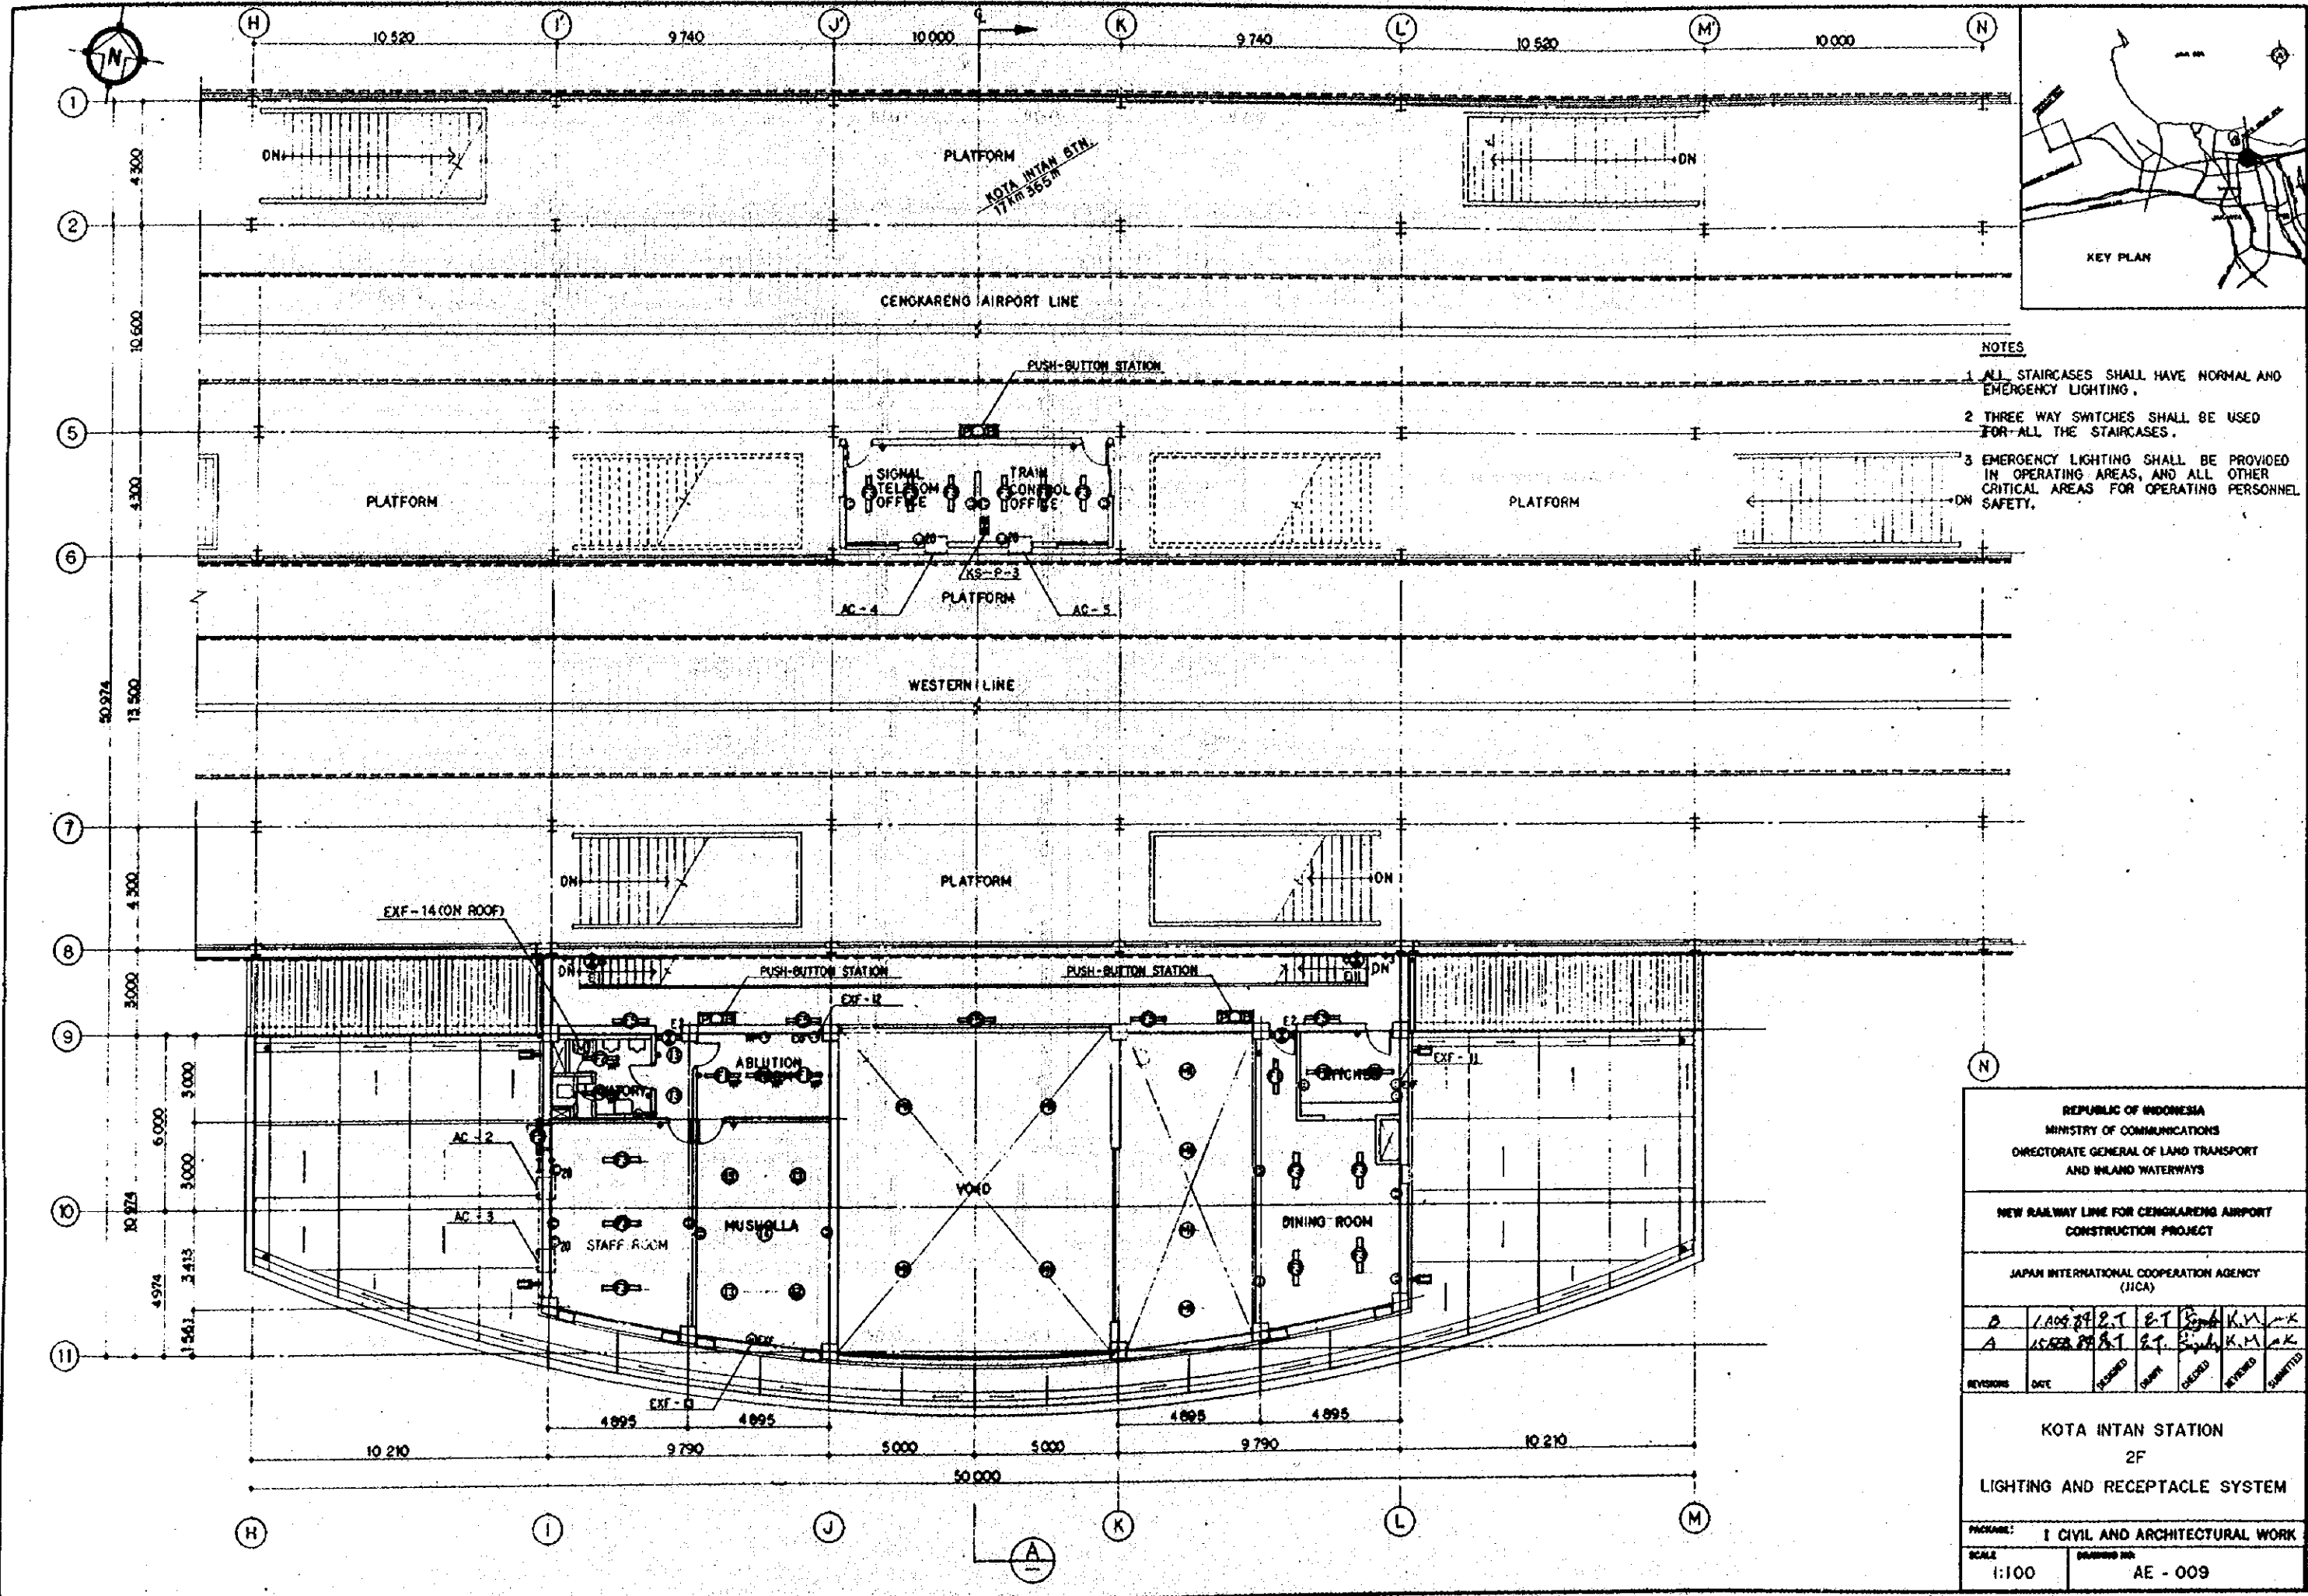

- NOTES**
- 1 ALL STAIRCASES SHALL HAVE NORMAL AND EMERGENCY LIGHTING.
 - 2 THREE WAY SWITCHES SHALL BE USED FOR ALL THE STAIRCASES.
 - 3 EMERGENCY LIGHTING SHALL BE PROVIDED IN OPERATING AREAS, AND ALL OTHER CRITICAL AREAS FOR OPERATING PERSONNEL SAFETY.

REPUBLIC OF INDONESIA
 MINISTRY OF COMMUNICATIONS
 DIRECTORATE GENERAL OF LAND TRANSPORT
 AND INLAND WATERWAYS



NEW RAILWAY LINE FOR CENGKARENG AIRPORT
 CONSTRUCTION PROJECT

JAPAN INTERNATIONAL COOPERATION AGENCY
 (JICA)

REVISIONS	DATE	DESIGNED	CHECKED	CREATED	REVIEWED	SUBMITTED
B	1 AUG 89	R.T.	R.T.	R.T.	K.M.	A.K.
A	15 FEB 89	R.T.	R.T.	R.T.	K.M.	A.K.

KOTA INTAN STATION
 2F
 LIGHTING AND RECEPTACLE SYSTEM

PACKAGE: I CIVIL AND ARCHITECTURAL WORK
 SCALE: 1:100
 DRAWING NO: AE - 009

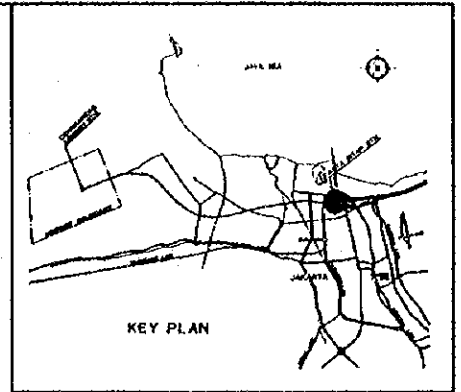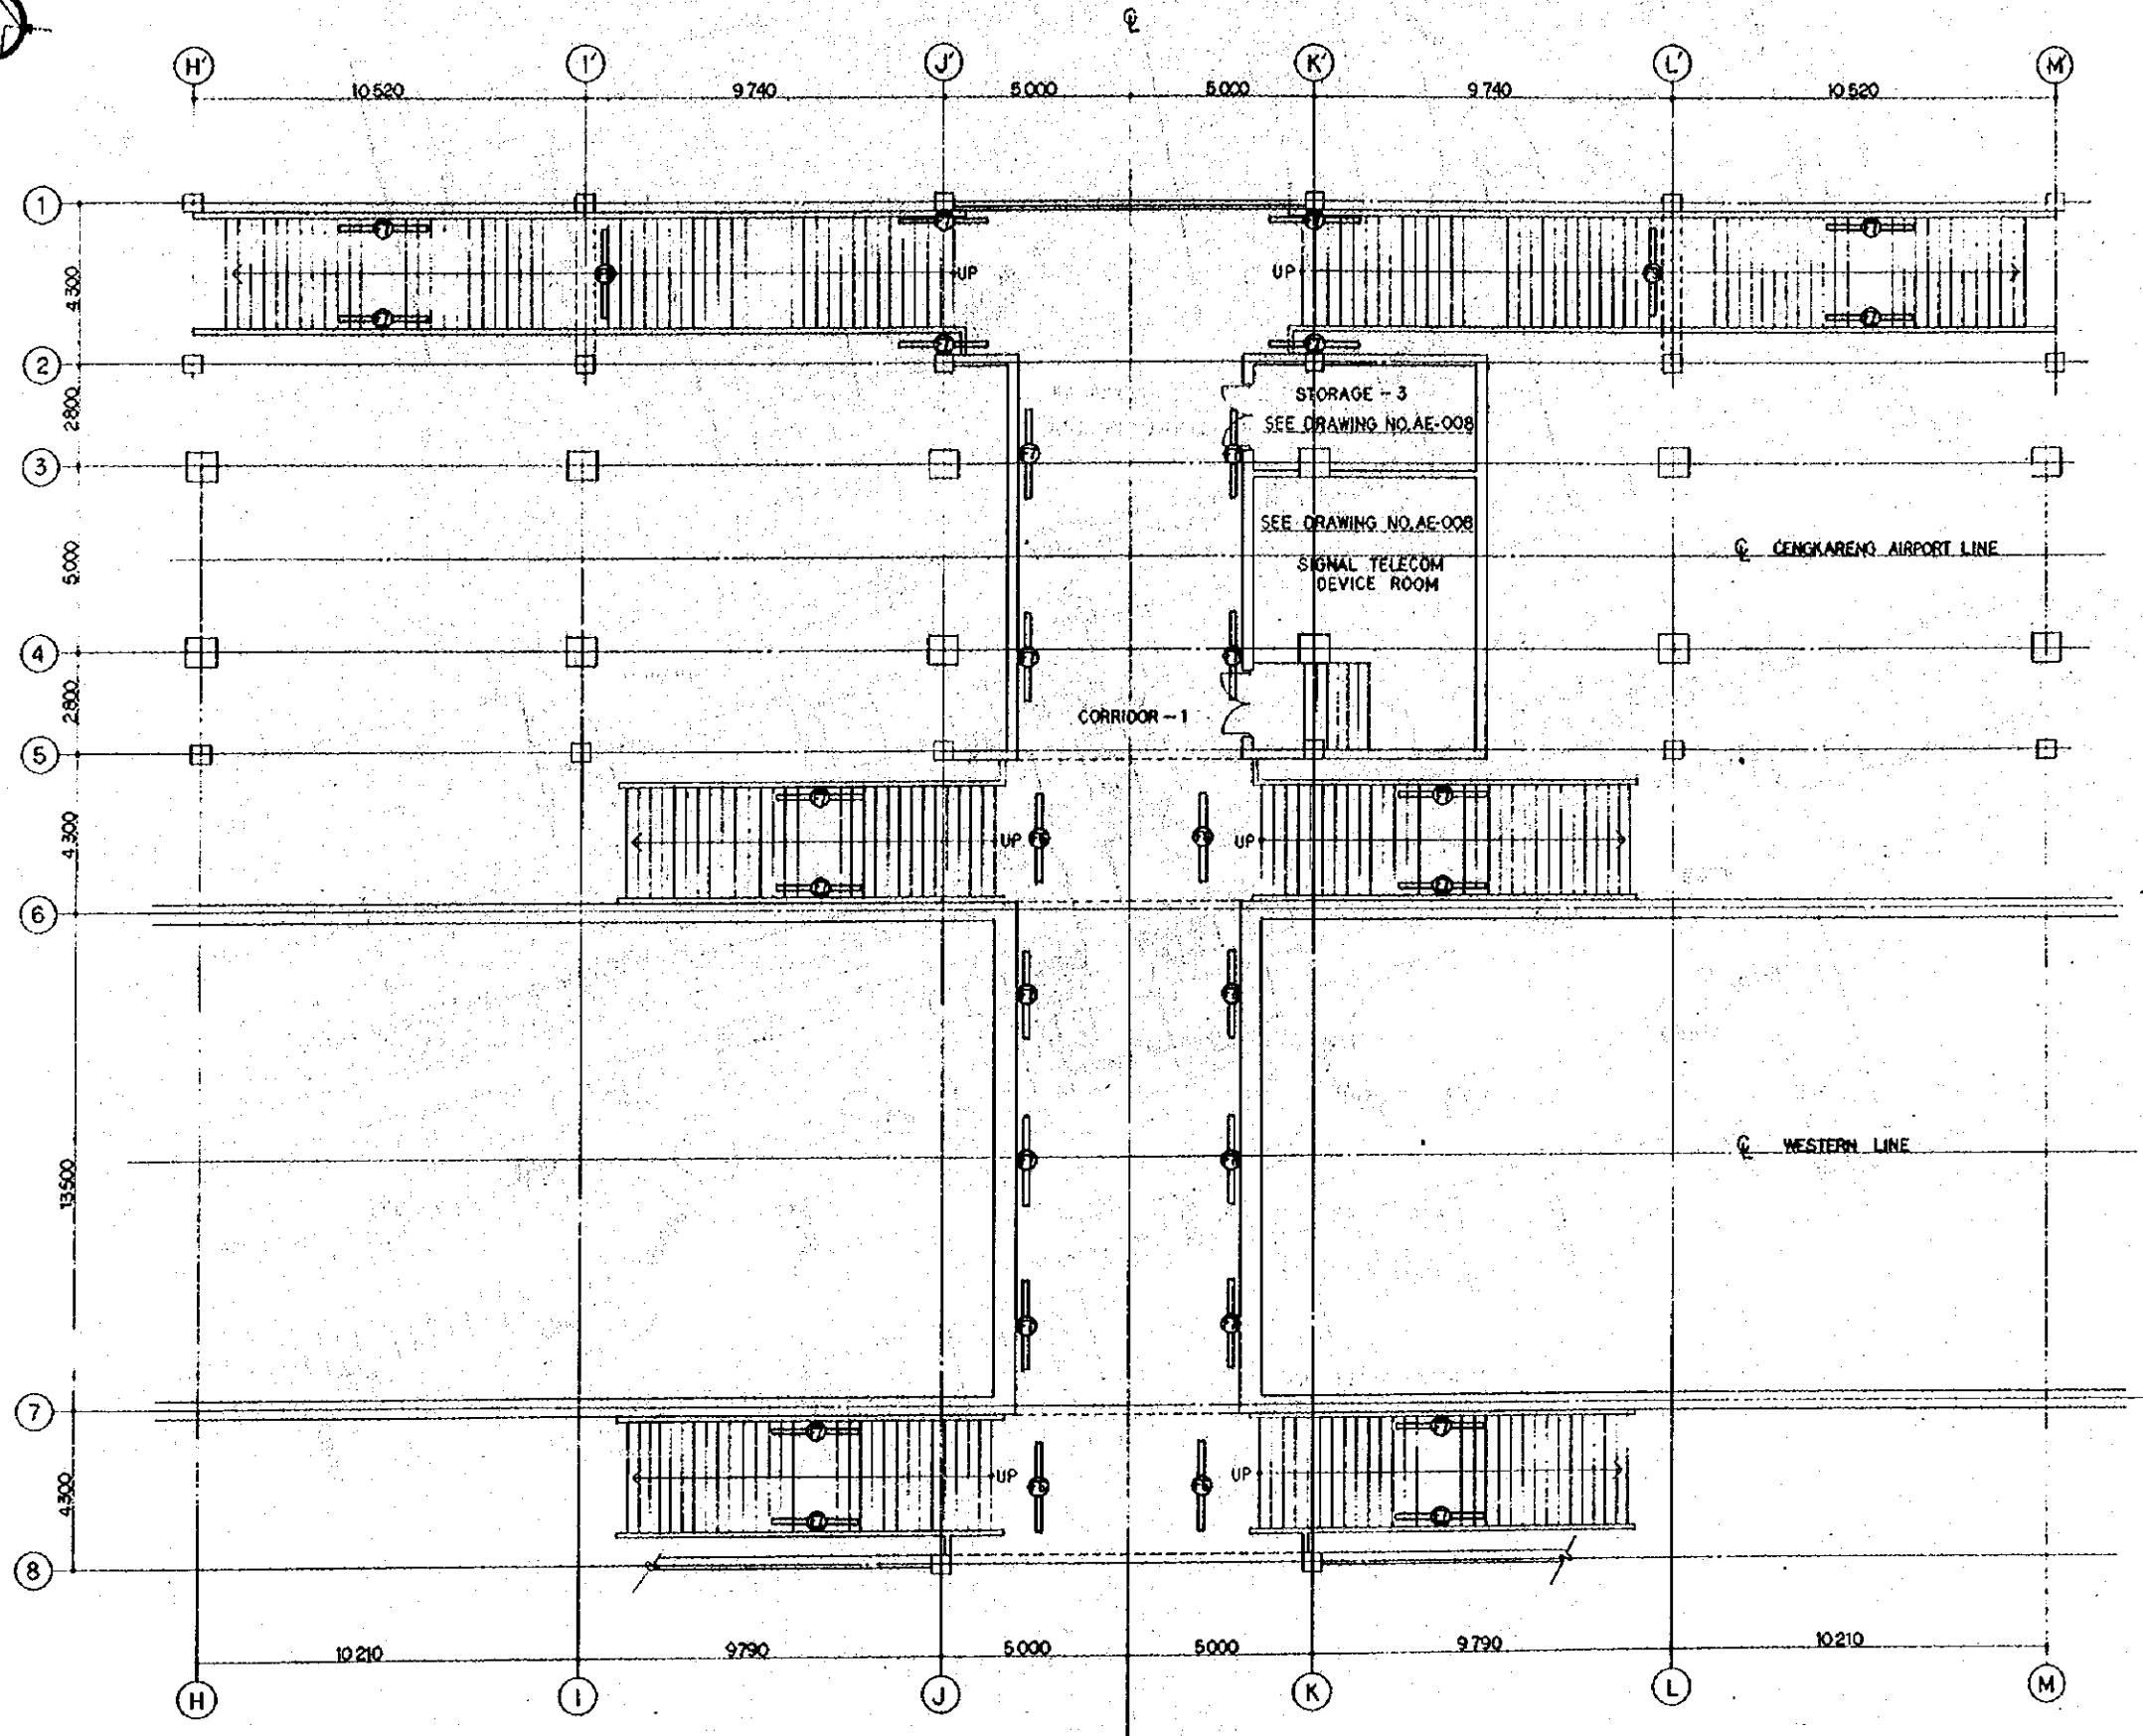

NOTES

- 1 ALL STAIRCASES SHALL HAVE NORMAL AND EMERGENCY LIGHTING.
- 2 THREE WAY SWITCHES SHALL BE USED FOR ALL THE STAIRCASES.
- 3 EMERGENCY LIGHTING SHALL BE PROVIDED IN OPERATING AREAS, AND ALL OTHER CRITICAL AREAS FOR OPERATING PERSONNEL SAFETY.

REPUBLIC OF INDONESIA
 MINISTRY OF COMMUNICATIONS
 DIRECTORATE GENERAL OF LAND TRANSPORT
 AND INLAND WATERWAYS

NEW RAILWAY LINE FOR CENGKARENG AIRPORT
 CONSTRUCTION PROJECT


JAPAN INTERNATIONAL COOPERATION AGENCY
 (JICA)

REVISIONS	DATE	REVISION	BY	CHECKED	REVIEWED	SUBMITTED
B	1409.29	E.T	E.T	S.K	K.M	M.K
A	15FEB.89	E.T	E.T	S.K	K.M	M.K


KOTA INTAN STATION
 CORRIDOR
 LIGHTING AND RECEPTACLE SYSTEM

PACKAGE: I CIVIL AND ARCHITECTURAL WORK


SCALE: 1:100
 DRAWING NO: AE - 010

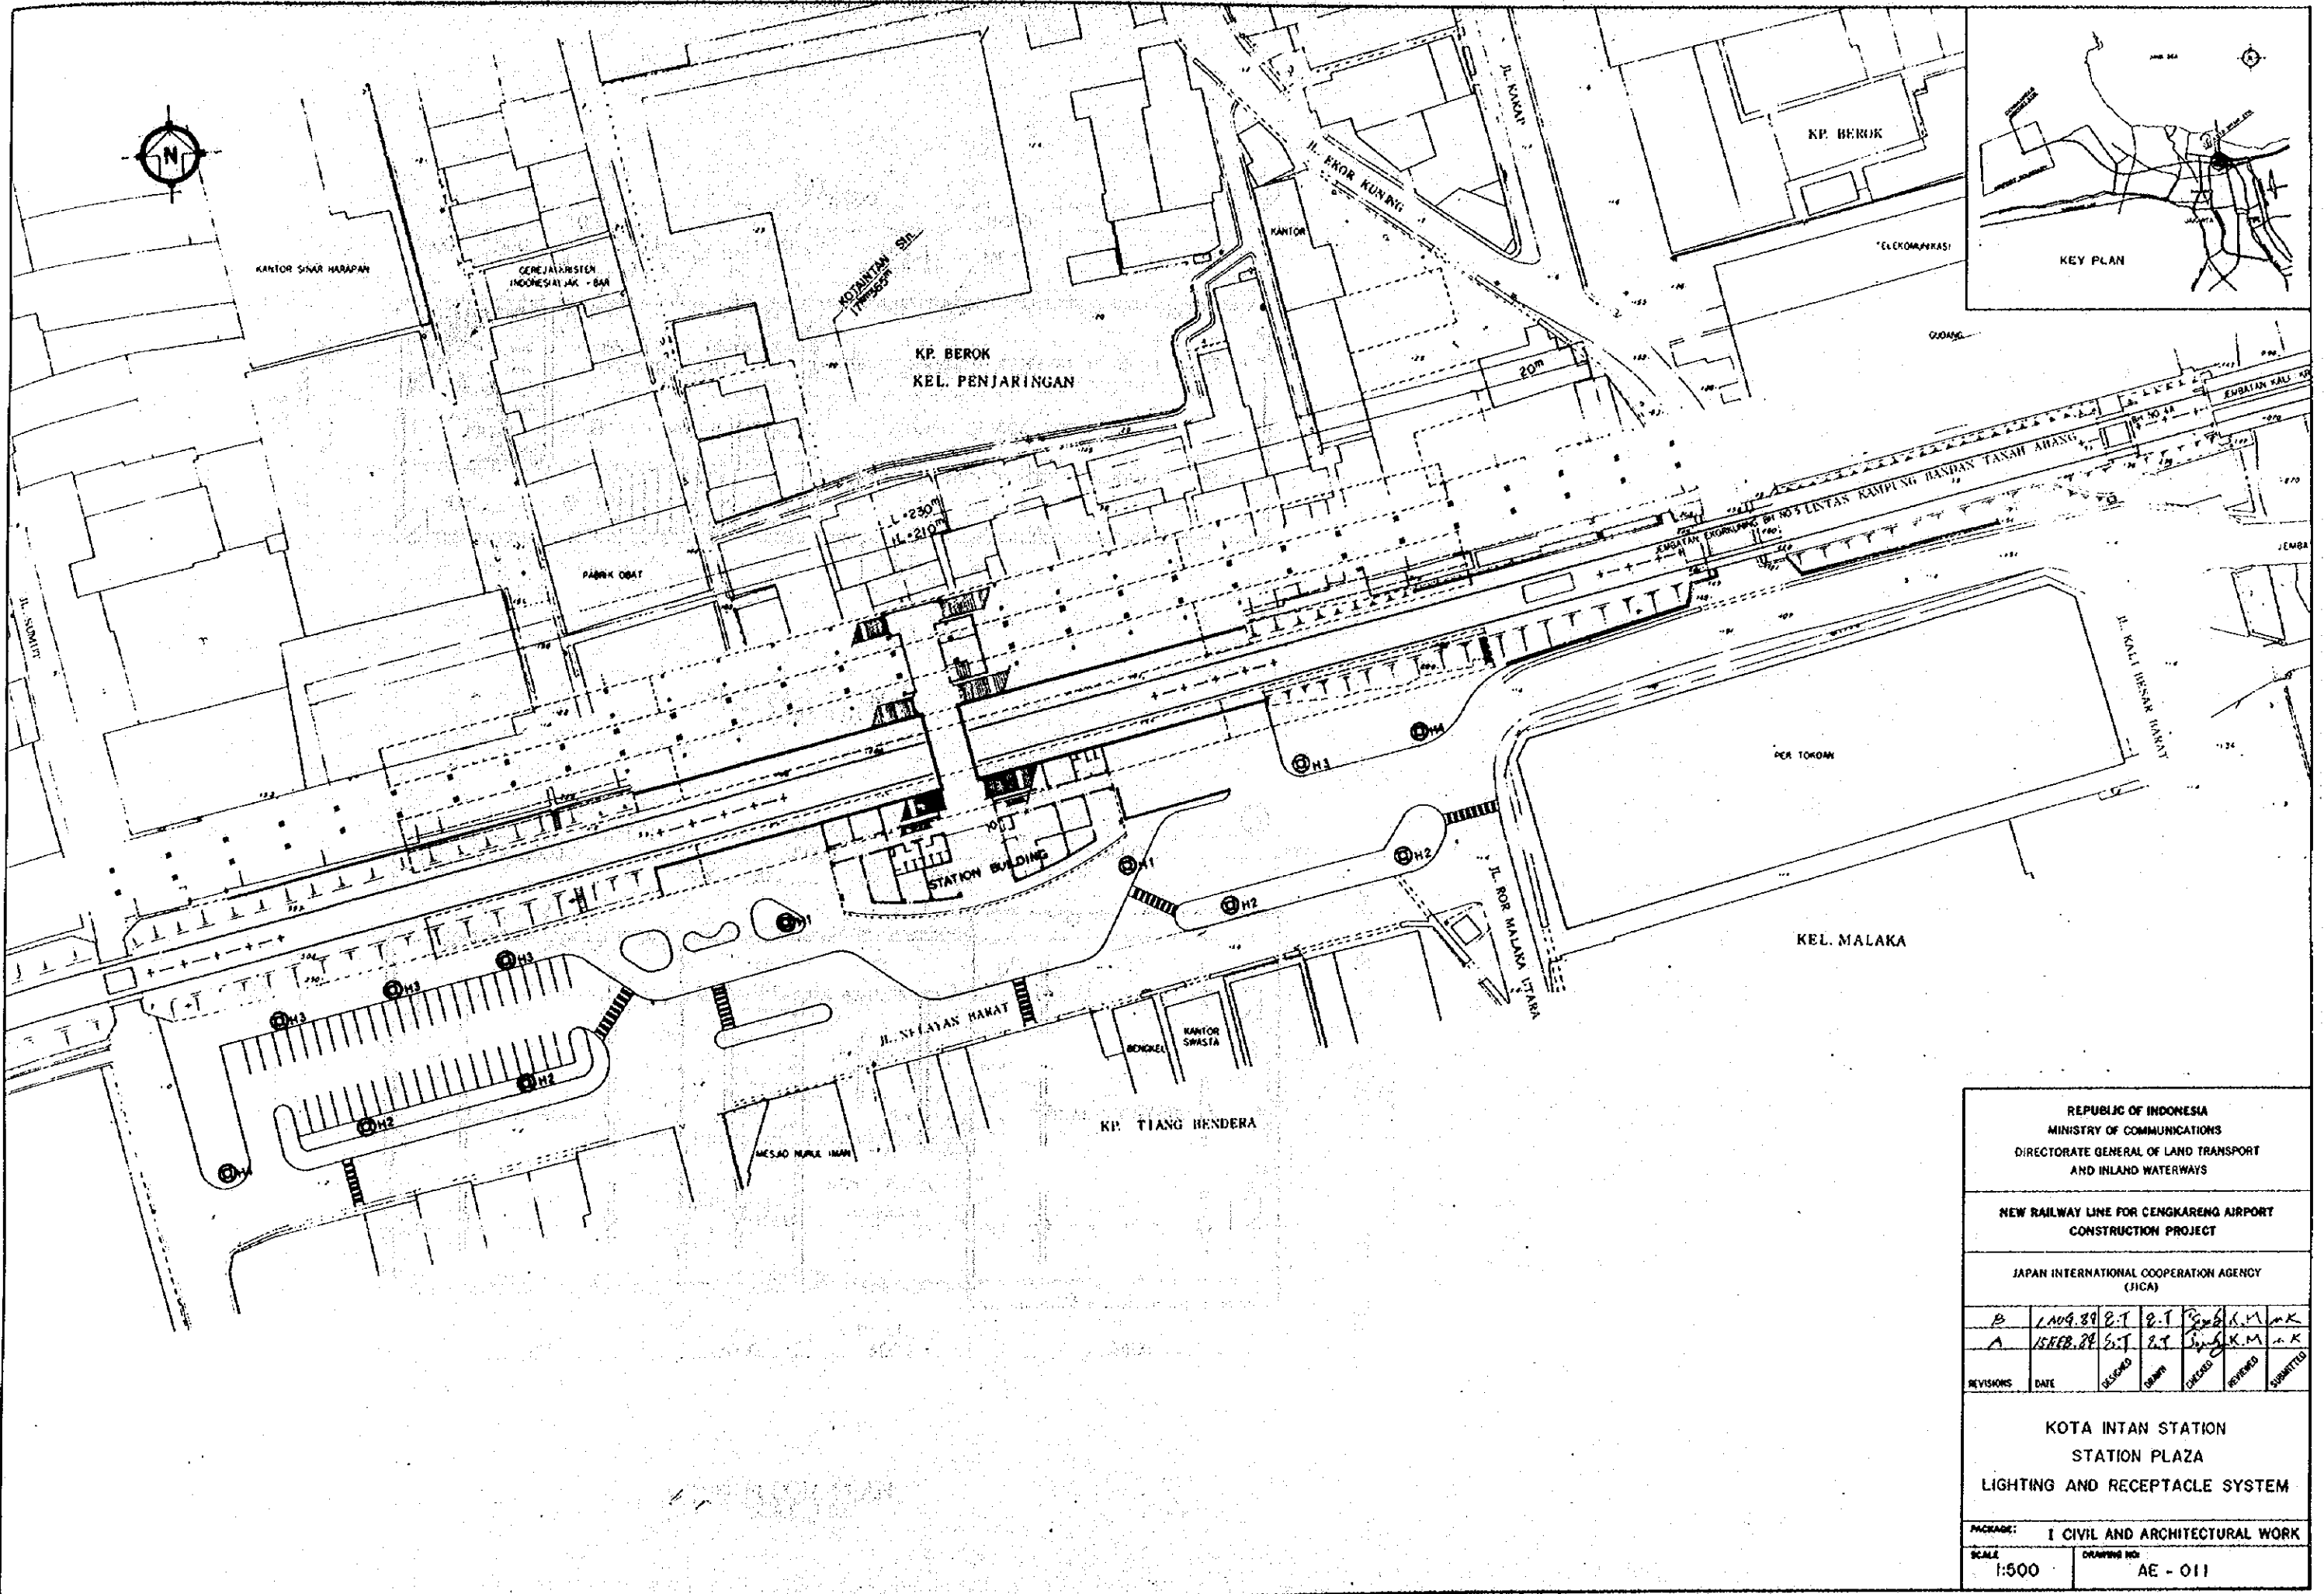


REPUBLIC OF INDONESIA MINISTRY OF COMMUNICATIONS DIRECTORATE GENERAL OF LAND TRANSPORT AND INLAND WATERWAYS					
NEW RAILWAY LINE FOR CENKARENG AIRPORT CONSTRUCTION PROJECT					
JAPAN INTERNATIONAL COOPERATION AGENCY (JICA)					
REVISIONS	DATE	DESIGNED	DRAWN	CHECKED	SUBMITTED
B	1 AUG. 89	B.T	B.T	Sing K.M	a.K
A	15 FEB. 88	B.T	B.T	Sing K.M	a.K
KOTA INTAN STATION STATION PLAZA LIGHTING AND RECEPTACLE SYSTEM					
PACKAGE: I CIVIL AND ARCHITECTURAL WORK					
SCALE: 1:500		DRAWING NO: AE - 011			

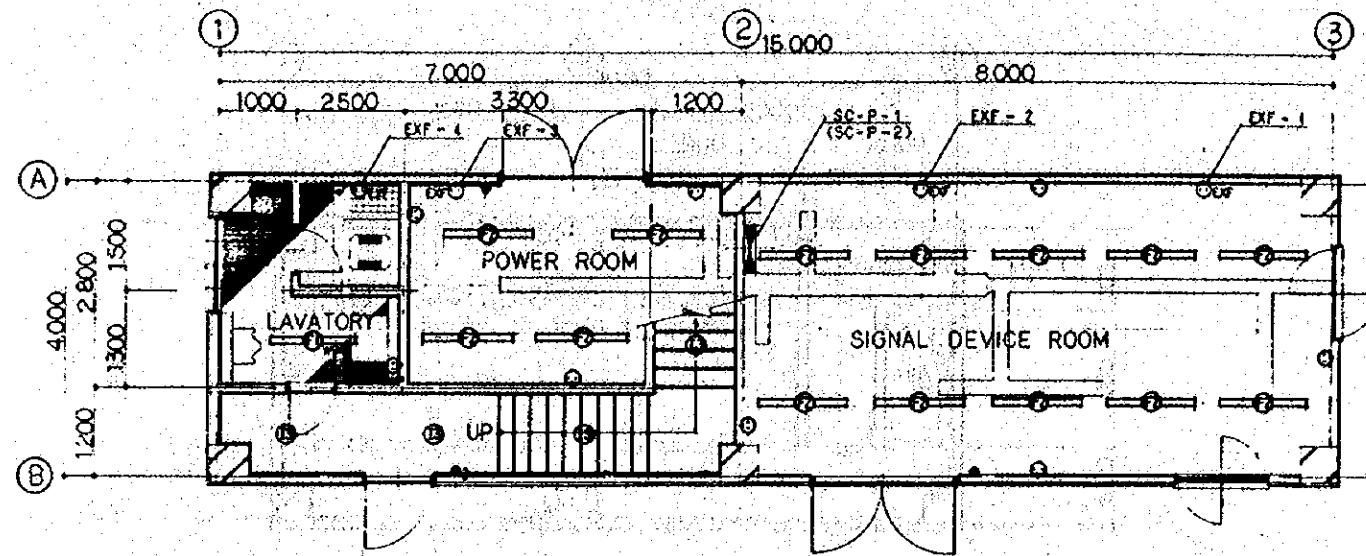

1st FLOOR PLAN
SCALE 1:50

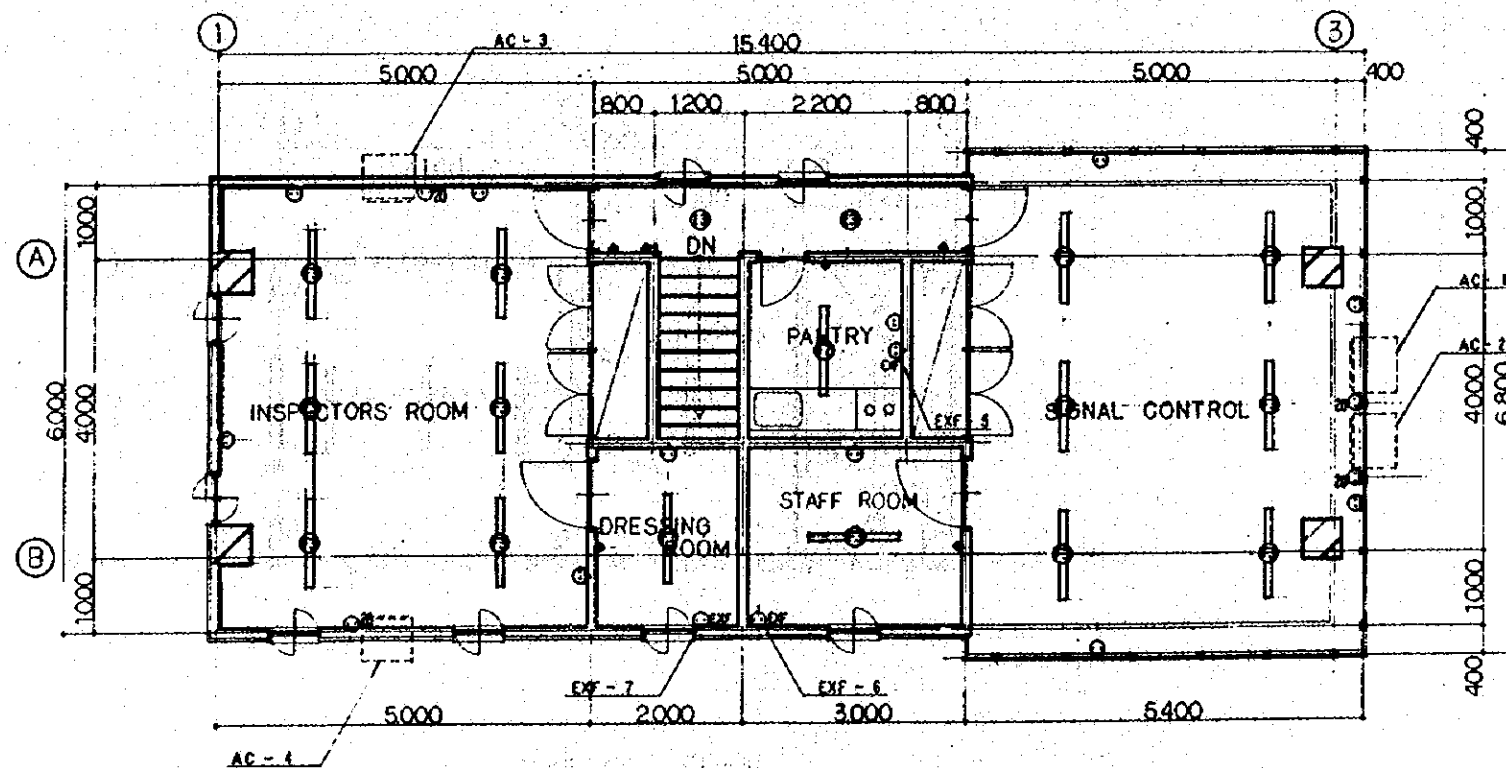

2nd FLOOR PLAN
SCALE 1:50

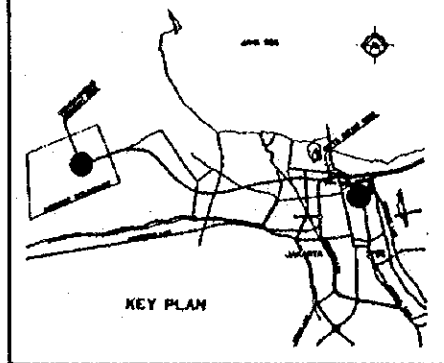


KEY PLAN


NOTES

- 1 ALL STAIRCASES SHALL HAVE NORMAL AND EMERGENCY LIGHTING.
- 2 THREE WAY SWITCHES SHALL BE USED FOR ALL THE STAIRCASES.
- 3 EMERGENCY LIGHTING SHALL BE PROVIDED IN OPERATING AREAS, AND ALL OTHER CRITICAL AREAS FOR OPERATING PERSONNEL SAFETY.


REPUBLIC OF INDONESIA MINISTRY OF COMMUNICATIONS DIRECTORATE GENERAL OF LAND TRANSPORT AND INLAND WATERWAYS					
NEW RAILWAY LINE FOR CENKARENG AIRPORT CONSTRUCTION PROJECT					
JAPAN INTERNATIONAL COOPERATION AGENCY (JICA)					
B	1 AUG 87	2-T	E.T	3000	K.M
A	17 FEB 87	2-T	E.T	3000	K.M
REVISION	DATE	DESIGNED	DRAWN	CHECKED	REVIEWED
SIGNAL CABIN A LIGHTING AND RECEPTACLE SYSTEM					
PACKAGE: 1 CIVIL AND ARCHITECTURAL WORK					
SCALE 1:50		DRAWING NO. AE - 012			

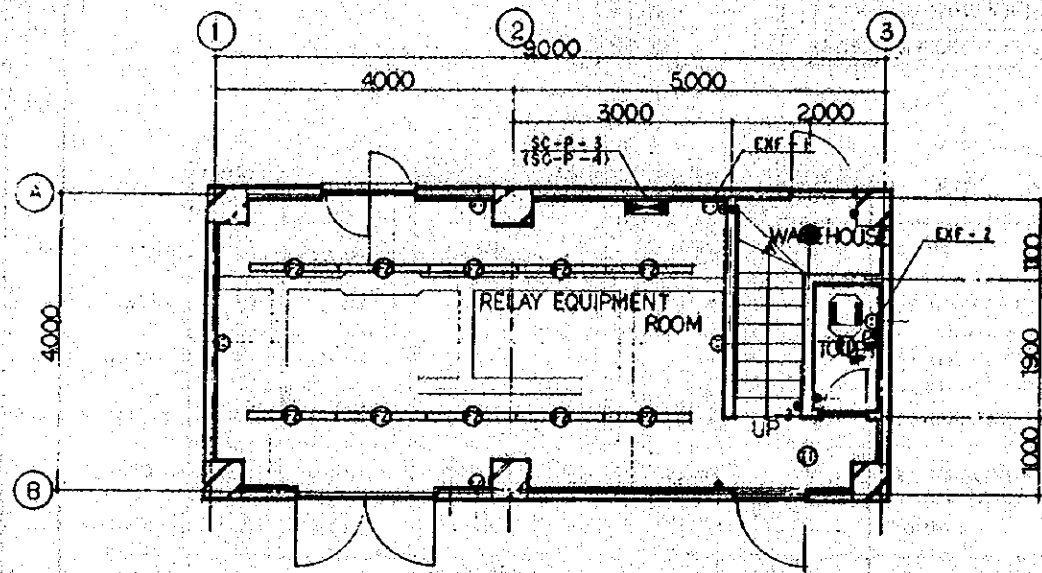



1st FLOOR PLAN
SCALE 1:50

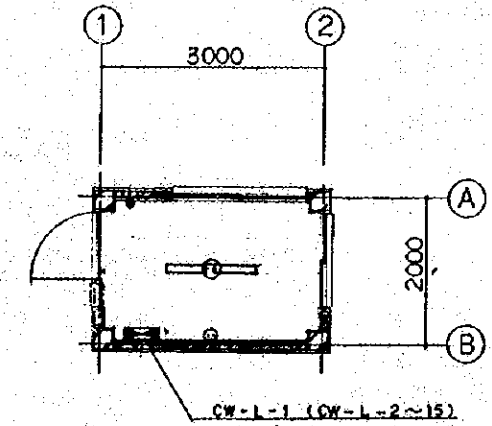

CROSSING WATCHMAN'S BOX
PLAN SCALE 1:50

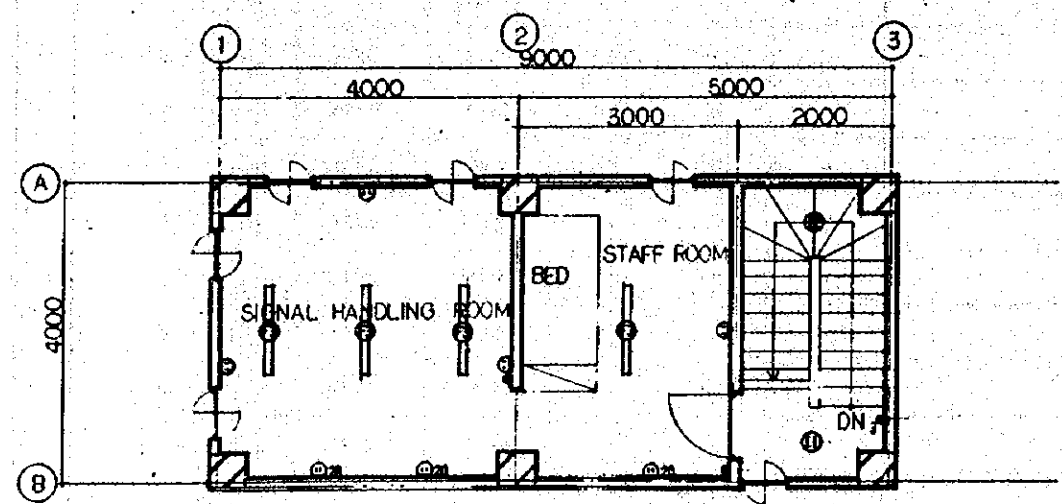

2nd FLOOR PLAN
SCALE 1:50
SIGNAL CABIN B

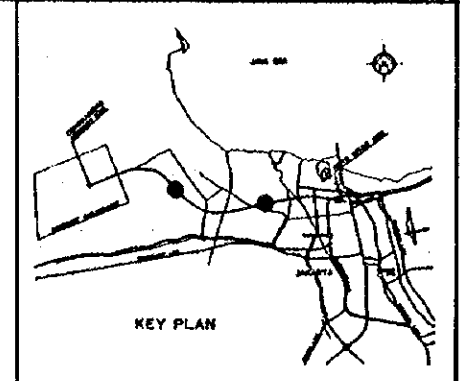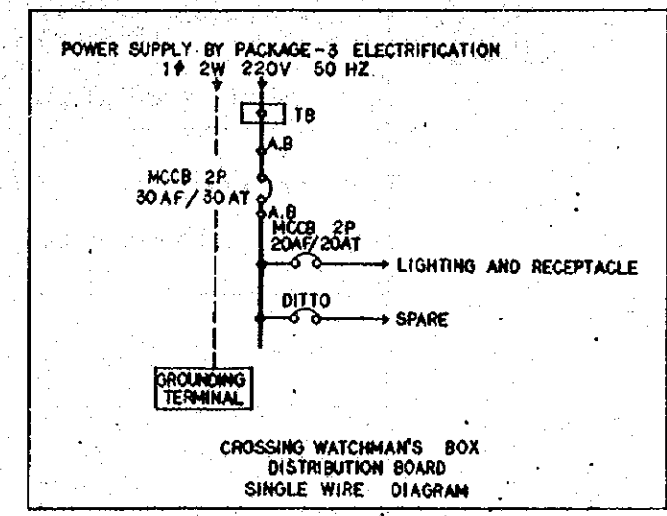


- NOTES
- 1 ALL STAIRCASES SHALL HAVE NORMAL AND EMERGENCY LIGHTING.
 - 2 THREE WAY SWITCHES SHALL BE USED FOR ALL THE STAIRCASES.
 - 3 EMERGENCY LIGHTING SHALL BE PROVIDED IN OPERATING AREAS, AND ALL OTHER CRITICAL AREAS FOR OPERATING PERSONNEL SAFETY.

REPUBLIC OF INDONESIA MINISTRY OF COMMUNICATIONS DIRECTORATE GENERAL OF LAND TRANSPORT AND INLAND WATERWAYS					
NEW RAILWAY LINE FOR CENGKARENG AIRPORT CONSTRUCTION PROJECT					
JAPAN INTERNATIONAL COOPERATION AGENCY (JICA)					
REVISION	DATE	DESIGNED	CHECKED	APPROVED	SUBMITTED
B	1 AUG 87	E.T	E.T	E.T	K.M.m.k
A	15 FEB 87	E.T	E.T	E.T	K.M.m.k
SIGNAL CABIN B AND CROSSING WATCHMAN'S BOX LIGHTING AND RECEPTACLE SYSTEM.					
PACKAGE: I CIVIL AND ARCHITECTURAL WORK					
SCALE: 1:50		DRAWING NO: AE - 013			

FROM
POWER DISTRIBUTION CUBICLE - 1
(FURNISHED BY PACKAGE - 3, ELECTRIFICATION WORK)

4⁰ x 60MM² + 35MM²

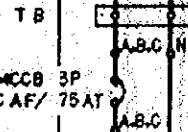


EQUIPMENT NAME	DISTRIBUTION PANEL
EQUIPMENT NO.	SO-P-1
VOLTAGE	3 ⁰ 4W 380/220V 50HZ
LOCATION	STATION OFFICE

PHASE - PHASE OR PHASE - NEUTRAL	LOAD CURRENT (A)	LOAD CAPACITY (VA)
A - N	45,9	10098
B - N	44,0	9676
C - N	39,7	8714
A - B - C	---	---
TOTAL	129,6	28488

CIRCUIT NO.	MCCB	DESCRIPTION	TOTAL LOAD CURRENT (A)	TOTAL LOAD CAPACITY (VA)	WIRE/CABLE (MM ²)	Q'TY	AREA
1	1P 20AF/20AT	LIGHTING	13.1	2880	4	6 (M2)	CONCOURSE
2	DITTO	DITTO	11.0	2408	4	25 (13, F2, F3)	PASSENGER WAITING AND CAFE, TICKET SALES/CHECK VIP WAITING ROOM, STATION MASTER ROOM, STAFF LAVATORY
3	DITTO	DITTO	12.4	2724	4	27 (13, F2, F3)	STATION OFFICE, MAINTENANCE AND JANITOR'S, TELECOM OFFICE, POWER ROOM, MECHANICAL ROOM, CORRIDOR (1FL)
4	DITTO	DITTO	14.9	3276	4	33 (F2, F3)	MEETING ROOM, POWER INSPECTION OFFICE, SIGNAL TELECOM OFFICE, STAFF ROOM, DINING ROOM, KITCHEN, STAFF LAVATORY
5	DITTO	DITTO	9.2	2008	4	21 (13, 14, F1, F5)	CORRIDOR (2FL, 3FL), ABLUTION ROOM, MUSHOLLA
6	DITTO	DITTO	13.7	3000	4	10 (N2)	CORRIDOR (OUT-DOOR)
7	DITTO	EMERGENCY LIGHTING	1.0	182	4	7 (E1, E2)	TICKET CHECK, STATION OFFICE, CORRIDOR
8	DITTO	RECEPTACLE	9.6	2100	4	14	INFORMATION, PASSENGER WAITING AND CAFE, TICKET SALES/CHECK VIP WAITING ROOM, LAVATORY, STATION MASTER ROOM
9	DITTO	DITTO	8.9	1950	4	13	POWER ROOM, MECHANICAL ROOM, MAINTENANCE AND JANITOR'S ROOM, TELECOM OFFICE, STATION OFFICE, STAFF LAVATORY
10	DITTO	DITTO	9.6	2100	4	14	MEETING ROOM, POWER INSPECTION OFFICE, SIGNAL TELECOM OFFICE, REST ROOM
11	DITTO	DITTO	6.9	1500	4	10	KITCHEN, DINING ROOM, STAFF LAVATORY, ABLUTION ROOM, MUSHOLLA
12	DITTO	PUSH-BUTTON STATION	0.2	40	4	4	CORRIDOR (1FL, 2FL, 3FL), PASSENGER WAITING AND CAFE.
13	DITTO	TELECOM	3.0	660	---	---	
14	DITTO	TELECOM	3.0	660	---	---	
15	DITTO	SIGN	4.6	1000	4		
16	DITTO	SIGN	4.6	1000	4		
17	DITTO	SIGN	4.6	1000	4		
18	DITTO	SPARE					
19	DITTO	SPARE					
20	DITTO	SPARE					

GROUNDING TERMINAL NEUTRAL TERMINAL

POWER SUPPLY SYSTEM DIAGRAM

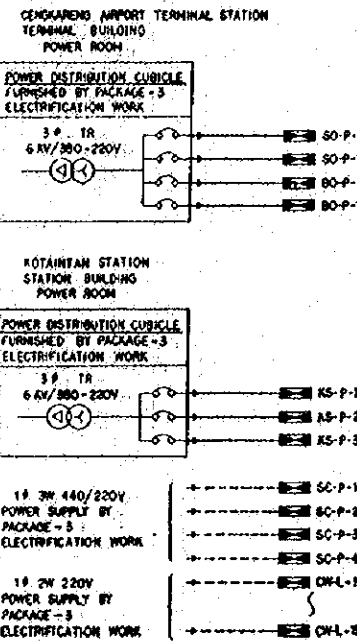

REPUBLIC OF INDONESIA
MINISTRY OF COMMUNICATIONS
DIRECTORATE GENERAL OF LAND TRANSPORT AND INLAND WATERWAYS

NEW RAILWAY LINE FOR CENGKARENG AIRPORT CONSTRUCTION PROJECT

JAPAN INTERNATIONAL COOPERATION AGENCY (JICA)

REVISORS	DATE	DESIGNED	DRAWN	CHECKED	REVIEWED	SUBMITTED
B	1 AUG 2011	E.T	E.T	E.T	E.T	E.T
A	15 FEB 2011	E.T	E.T	E.T	E.T	E.T

AIRPORT TERMINAL STATION
DISTRIBUTION BOARD
SINGLE WIRE DIAGRAM
1 SHEET 1 OF 2 1

PACKAGE: I CIVIL AND ARCHITECTURAL WORK
SCALE: NONE
DRAWING NO: AE-014

FROM
POWER DISTRIBUTION CUBICLE
(FURNISHED BY PACKAGE-3 ELECTRIFICATION WORK)

4^o x 95MM² + 60MM²


T B
A.B.C.N
A.B.C

MCCB 3P
225 AF/150 AT
A.B.C

EQUIPMENT NAME	DISTRIBUTION PANEL
EQUIPMENT NO.	SO - P - 2
VOLTAGE	3 ^o 4W 380/220V 50HZ
LOCATION	STATION OFFICE

PHASE -- PHASE OR PHASE -- NEUTRAL	LOAD CURRENT (A)	LOAD CAPACITY (VA)
A -- N	39.6	8 690
B -- N	37.7	8 294
C -- N	35.0	7 700
A -- B -- C	63.3	41 645
TOTAL	175.6	66 329

CIRCUIT NO.	MCCB	DESCRIPTION	TOTAL LOAD CURRENT (A)	TOTAL LOAD CAPACITY (VA)	WIRE/CABLE (MM ²)	Q'TY	AREA
1	3 P 75AF/50AT	AIR CONDITIONER AC-1	40.0	26 322	4 ^o x 16	1	MECHANICAL ROOM
2	3 P 30AF/30AT	LIFT PUMP	18.0	11 647	4 ^o x 10	1	OUT-DOOR
3	1 P 20AF/20AT	AIR CONDITIONER AC-2	14.0	3 080	4	1	STAFF ROOM
4	DITTO	AIR CONDITIONER AC-3	14.0	3 080	4	1	STAFF ROOM
5	DITTO	EXHAUST FAN EXP-1	3.5	2 310	3 ^o x 4	1	POWER ROOM
6	DITTO	EXHAUST FAN EXP-3	1.8	1 166	3 ^o x 4	1	ROOF
7	DITTO	EXHAUST FAN EXP-2,4,5,6	3.9	658	4	4	KITCHEN; ABLUTION ROOM; HUSHOLLA
8	DITTO	LIGHTING	12.6	2 772	2 ^o x 25	9 (H3)	STATION PLAZA
9	DITTO	DITTO	14.0	3 080	2 ^o x 25	10 (H3)	DITTO
10	1 P 30AF/30AT	DITTO	22.4	4 928	2 ^o x 16	3 (H1, H5)	DITTO
11	1 P 20AF/20AT	DITTO	12.8	2 816	2 ^o x 16	6 (H2, H3, H4)	DITTO
12	DITTO	DITTO	11.5	2 530	2 ^o x 16	6 (H2, H3, H4)	DITTO
13	DITTO	DITTO	7.0	1 540	2 ^o x 16	5 (H3)	DITTO
14	DITTO	SPARE					
15	DITTO	SPARE					
16	DITTO	SPARE					

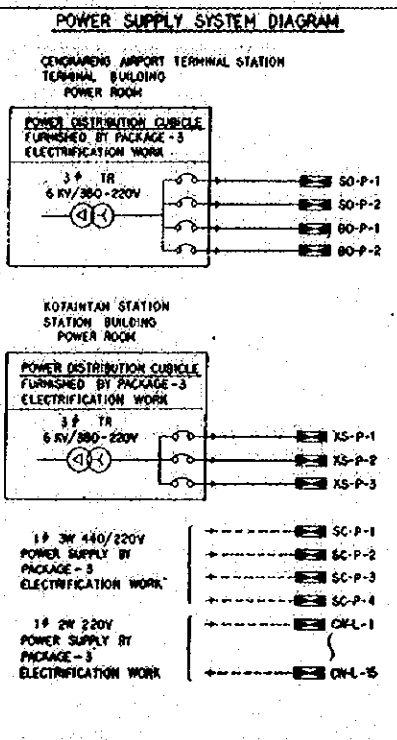

GROUNDING TERMINAL NEUTRAL TERMINAL

REPUBLIC OF INDONESIA
MINISTRY OF COMMUNICATIONS
DIRECTORATE GENERAL OF LAND TRANSPORT
AND INLAND WATERWAYS

NEW RAILWAY LINE FOR CENKARENG AIRPORT
CONSTRUCTION PROJECT

JAPAN INTERNATIONAL COOPERATION AGENCY
(JICA)

B	1 AUG 89	BT	BT	K.M.	K
A	15 FEB 89	BT	BT	K.M.	K

REVISIONS DATE DESIGNED DRAWN CHECKED REVIEWED SUBMITTED


AIRPORT TERMINAL STATION
DISTRIBUTION BOARD
SINGLE WIRE DIAGRAM
(SHEET 2 OF 2)

PACKAGE: I CIVIL AND ARCHITECTURAL WORK

SCALE DRAWING NO.
NONE AE - 015

FROM POWER DISTRIBUTION CUBICLE-1
(FURNISHED BY PACKAGE-3, ELECTRIFICATION WORK.)


4C x 70MM² + 35MM²

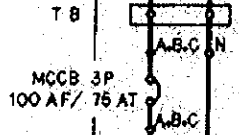

EQUIPMENT NAME	DISTRIBUTION PANEL
EQUIPMENT NO.	80-P-1 / 80-P-2
VOLTAGE	3P 4W 380/220V 50HZ
LOCATION	STATION OFFICE

PHASE OR PHASE - NEUTRAL	LOAD CURRENT (A)	LOAD CAPACITY (VA)
A - N	30.2	6630
B - N	29.8	6556
C - N	39.2	8620
A - B - C	18.2	11935
TOTAL	117.4	33741

CIRCUIT NO.	MCCB	DESCRIPTION	TOTAL LOAD CURRENT (A)	TOTAL LOAD CAPACITY (VA)	WIRE/CABLE (MM ²)	Q'TY	AREA
①	1P 20AF/20AT	LIGHTING	8.1	1768	4	17 (F3)	TICKET SALES, STATION OFFICE, TRAIN CONTROL OFFICE, WAITING ROOM, BUS TICKET SALES, SECURITY.
②	DITTO	DITTO	4.3	936	4	15 (F2, F3)	PORTER, LAVATORY, STORAGE
③	DITTO	DITTO	15.3	3360	6	24 (F6)	TRAIN PLATFORM
④	DITTO	DITTO	15.3	3360	4	24 (F6)	DITTO
⑤	DITTO	DITTO	15.3	3360	6	24 (F6)	BUS PLATFORM
⑥	DITTO	DITTO	15.3	3360	4	24 (F6)	DITTO
⑦	DITTO	EMERGENCY LIGHTING	0.3	52	4	2 (E2)	TICKET SALES, TRAIN CONTROL OFFICE
⑧	DITTO	RECEPTACLE	10.3	2250	4	15	TICKET SALES, STATION OFFICE, TRAIN CONTROL OFFICE, WAITING ROOM, BUS TICKET SALES, SECURITY.
⑨	DITTO	DITTO	4.1	900	4	6	PORTER, LAVATORY, STORAGE.
⑩	DITTO	DITTO	2.1	450	4	3	TRAIN PLATFORM.
⑪	3P 20AF/20AT	AIR CONDITIONER (AC-1)	13.0	8512	5C x 4	1	TICKET SALES.
⑫	DITTO	EXHAUST FAN (EXF-2)	5.2	3423	4	1	ROOF
⑬	1P 20AF/20AT	PUSH-BUTTON STATION	0.1	10	4	1	CORRIDOR
⑭	DITTO	SIGN	4.6	1000	4		
⑮	DITTO	SIGN	4.6	1000	4		
⑯	DITTO	SPARE					
⑰	DITTO	SPARE					
⑱	DITTO	SPARE					
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GROUNDING TERMINAL NEUTRAL TERMINAL

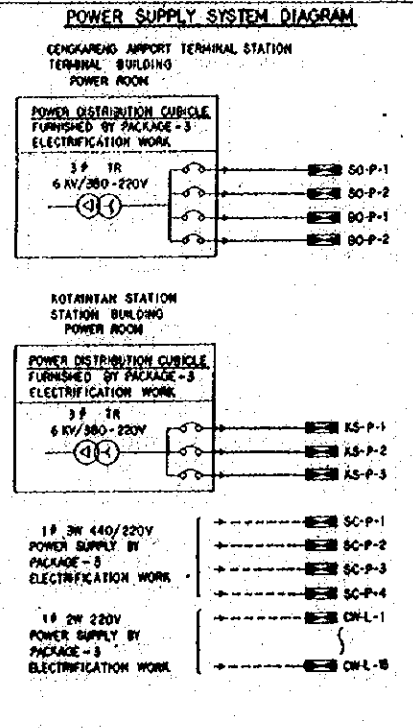REPUBLIC OF INDONESIA
MINISTRY OF COMMUNICATIONS
DIRECTORATE GENERAL OF LAND TRANSPORT AND INLAND WATERWAYS

NEW RAILWAY LINE FOR CENGKARENG AIRPORT - CONSTRUCTION PROJECT

JAPAN INTERNATIONAL COOPERATION AGENCY (JICA)

REVISIONS	DATE	REASON	DRAWN	CHECKED	REVIEWED	SUBMITTED
B	1 AUG 1981	E.T.	T.S.	K.M.	M.K.	
A	15 FEB 1981	S.T.	T.S.	K.M.	M.K.	

BOOKING OFFICE
DISTRIBUTION BOARD
SINGLE WIRE DIAGRAM.

PACKAGE: I CIVIL AND ARCHITECTURAL WORK
SCALE: NONE DRAWING NO: AE-016

FROM POWER DISTRIBUTION CUBICLE (FURNISHED BY PACKAGE-3 ELECTRIFICATION WORK)

4x35MM² + 25MM²

T B
A,B,C,N


MCCB 3P
100AF/ 75 AT
A,B,C

EQUIPMENT NAME	DISTRIBUTION PANEL
EQUIPMENT NO.	K5-P-1
VOLTAGE	3 ϕ 4W 380/220V 50HZ
LOCATION	STATION OFFICE

PHASE - PHASE OR PHASE - NEUTRAL	LOAD CURRENT (A)	LOAD CAPACITY (VA)
A - N	67.9	13148
B - N	60.7	13346
C - N	37.3	10014
A - B - C	---	---
TOTAL	165.9	36508

CIRCUIT NO.	MCCB	DESCRIPTION	TOTAL LOAD CURRENT (A)	TOTAL LOAD CAPACITY (VA)	WIRE/CABLE (MM ²)	Q'TY	AREA
①	1 P 20AF/20AT	LIGHTING	13.0	2860	4	29 (F2.F3.F4)	STATION OFFICE, STATION MASTER ROOM, MEETING ROOM, SECURITY, COVERED SERVICE AREA-2, MECHANICAL ROOM, STAFF LOCKER ROOM, STAFF LAVATORY
②	DITTO	DITTO	15.5	3396	4	40 (I3.F2.F3.F4)	PASSENGER WAITING AND CAFE, PORTER, PASSENGER LAVATORY (M/W), MAINTENANCE AND JANITOR'S ROOM, COVERED SERVICE AREA-1, POWER ROOM, STORAGE-1,2
③	DITTO	DITTO	12.8	2800	4	14 (F6.M1)	STATION OFFICE, CORRIDOR (1FL)
④	DITTO	DITTO	11.5	2520	4	18 (F6.F7)	CORRIDOR -1
⑤	DITTO	DITTO	10.2	2240	4	14 (F7.F9)	CORRIDOR -1
⑥	DITTO	DITTO	3.4	728	4	8 (F2.F4)	SIGNAL TELECOM DEVICE ROOM, STORAGE -3
⑦	DITTO	DITTO	10.8	2360	4	28 (I3.I4) (F1.F2.F3.F5)	KITCHEN, DINING ROOM, STAFF ROOM, ABLUTION ROOM, MUSHOLLA, CORRIDOR (2FL), LAVATORY
⑧	DITTO	DITTO	10.0	2200	4	8 (M1.N1)	CONCOURSE CORRIDOR (OUT-DOOR)
⑨	DITTO	EMERGENCY LIGHTING	1.1	234	4	9 (E1.E2)	
⑩	DITTO	RECEPTACLE	14.4	3150	4	21	STATION OFFICE, STATION MASTER ROOM, MEETING ROOM, SECURITY, COVERED SERVICE AREA-2, MECHANICAL ROOM, STAFF LOCKER ROOM, STAFF LAVATORY
⑪	DITTO	DITTO	13.0	2850	4	19	PASSENGER WAITING AND CAFE, PORTER, PASSENGER LAVATORY (M/W), MAINTENANCE AND JANITOR'S ROOM, COVERED SERVICE AREA-1, STORAGE-1,2, POWER ROOM
⑫	DITTO	DITTO	8.2	1800	4	12	KITCHEN, DINING ROOM, STAFF ROOM, ABLUTION ROOM, MUSHOLLA, LAVATORY
⑬	DITTO	PUSH-BUTTON STATION	0.3	50	4	5	CORRIDOR
⑭	DITTO	TELECOM	3.0	660	---	---	
⑮	DITTO	TELECOM	3.0	660	---	---	
⑯	DITTO	SIGN	9.1	2000	4		
⑰	DITTO	SIGN	9.1	2000	4		
⑱	DITTO	SIGN	9.1	2000	4		
⑲	DITTO	SIGN	9.1	2000	4		
⑳	DITTO	SPARE					
㉑	DITTO	SPARE					
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POWER SUPPLY SYSTEM DIAGRAM

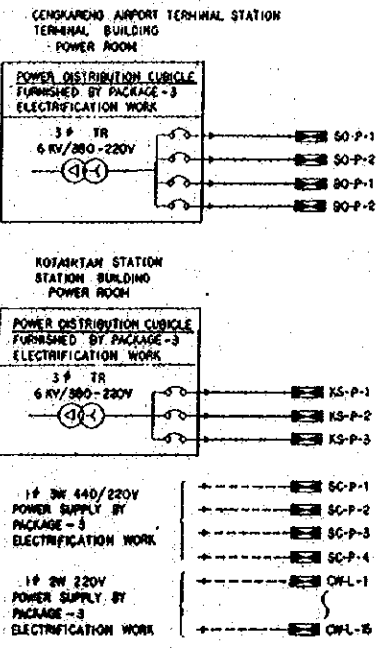

GROUNDING TERMINAL NEUTRAL TERMINAL

REPUBLIC OF INDONESIA
MINISTRY OF COMMUNICATIONS
DIRECTORATE GENERAL OF LAND TRANSPORT AND INLAND WATERWAYS

NEW RAILWAY LINE FOR CENKARENG AIRPORT CONSTRUCTION PROJECT

JAPAN INTERNATIONAL COOPERATION AGENCY (JICA)


B	1 AUG 89	2.T	ET	ET	ET	K.M	M.K
A	17 FEB 89	2.T	ET	ET	ET	K.M	M.K

REVISIONS DATE DESIGNED CHECKED REVISIONS SUBMITTED

KOTA INTAN STATION
STATION BLDG.
DISTRIBUTION BOARD
SINGLE WIRE DIAGRAM
(SHEET 1 OF 2)

PACKAGE: I CIVIL AND ARCHITECTURAL WORK
SCALE: NONE DRAWING NO: AE - 017


FROM
POWER DISTRIBUTION CUBICLE
(FURNISHED BY PACKAGE - 3 ELECTRIFICATION WORK)

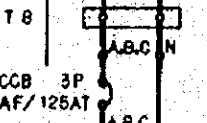

EQUIPMENT NAME	DISTRIBUTION PANEL
EQUIPMENT NO.	KS - P - 2
VOLTAGE	3P 4W 380 / 220V 50HZ
LOCATION	STATION OFFICE

PHASE - PHASE OR PHASE - NEUTRAL	LOAD CURRENT (A)	LOAD CAPACITY (VA)
A - N	39.1	8 596
B - N	38.0	8 368
C - N	42.2	9 276
A - B - C	50.6	33 305
TOTAL	169.9	59 535

CIRCUIT NO.	MCCB	DESCRIPTION	TOTAL LOAD CURRENT (A)	TOTAL LOAD CAPACITY (VA)	WIRE/CABLE (MM ²)	Q'TY	AREA
1	3 P 75AF / 50AT	AIR CONDITIONER (AC - 1)	40.0	26 322	4 x 16	1	MECHANICAL ROOM
2	3 P 20AF / 20AT	LIFT PUMP	7.1	4 673	4 x 4	1	STORAGE 1
3	1 P 20AF / 20AT	AIR CONDITIONER (AC - 2)	11.0	2 420	4	1	STAFF ROOM
4	DITTO	DITTO (AC - 3)	11.0	2 420	4	1	STAFF ROOM
5	DITTO	EXHAUST FAN (EXF - 11-10)	10.6	2 332	4	10	STAFF LAVATORY, STAFF LOCKER ROOM, MECHANICAL ROOM, POWER ROOM, STORAGE - 1, STORAGE - 2, MAINTENANCE AND JANITOR'S ROOM, SIGNAL, TELECOM, DEVICE ROOM, STORAGE - 3
6	DITTO	EXHAUST FAN (EXF - 11,12,13)	2.5	550	4	3	KITCHEN, ABLUTION ROOM, MUSHOLLA
7	1 P 30AF / 30AT	LIGHTING	21.8	4 796	2 x 10	1 (H 1)	STATION PLAZA
8	DITTO	DITTO	21.8	4 796	2 x 10	4 (H 2, H 3, H 4)	STATION PLAZA
9	1 P 20AF / 20AT	DITTO	9.1	2 002	2 x 10	1 (H 1)	STATION PLAZA
10	DITTO	DITTO	11.9	2 618	2 x 25	6 (H 2, H 3, H 4)	STATION PLAZA
11	1 P 20AF / 20AT	LIGHTING	5.7	1 248	4	12 (F 4)	SHOPS
12	DITTO	DITTO	5.7	1 248	4	12 (F 4)	LOADING YARD
13	DITTO	RECEPTACLE	4.1	900	4	6	SHOPS
14	DITTO	DITTO	4.1	900	4	6	LOADING YARD
15	3 P 20AF / 20AT	EXHAUST FAN (EXF - 14)	3.5	2 310	5 x 4	1	ROOF
16	1 P 20AF / 20AT	SPARE					
17	DITTO	SPARE					
18	DITTO	SPARE					

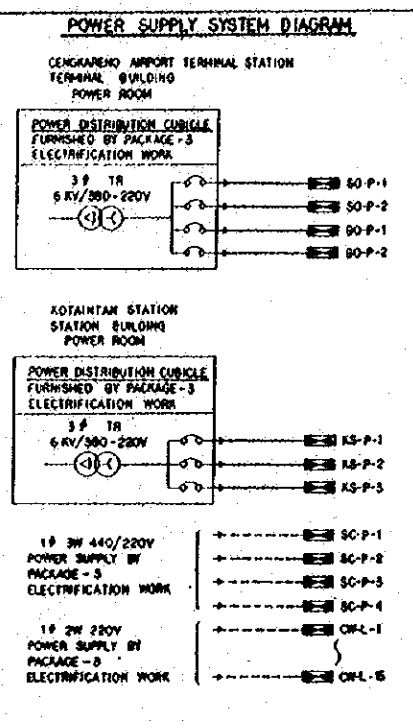

GROUNDING TERMINAL NEUTRAL TERMINAL

REPUBLIC OF INDONESIA
MINISTRY OF COMMUNICATIONS
DIRECTORATE GENERAL OF LAND TRANSPORT AND INLAND WATERWAYS

NEW RAILWAY LINE FOR CENGKARENG AIRPORT CONSTRUCTION PROJECT

JAPAN INTERNATIONAL COOPERATION AGENCY (JICA)

REVISIONS

B	1 AUG 89	E.T	E.T	S.M	K.M	M.K
A	10 FEB 89	E.T	E.T	S.M	K.M	M.K
	DATE	DESIGNED	DRAWN	CHECKED	REVIEWED	SUBMITTED

KOTA INTAN STATION
STATION BLDG.
DISTRIBUTION BOARD
SINGLE WIRE DIAGRAM
(SHEET 2 OF 2)

PACKAGE: 1 CIVIL AND ARCHITECTURAL WORK

SCALE: NONE DRAWING NO: AE - 018

FROM
POWER DISTRIBUTION CUBICLE-2
(FURNISHED BY PACKAGE-3 ELECTRIFICATION WORK)

4C x 70MM² + 35MM²


T B
MCCB 3 P
100AF/100AT
A,B,C,N
A,B,C

EQUIPMENT NAME	DISTRIBUTION PANEL
EQUIPMENT NO.	KS-P-3
VOLTAGE	3 ϕ 4W 380/220V 50HZ
LOCATION	TRAIN CONTROL OFFICE

PHASE -- PHASE OR PHASE -- NEUTRAL	LOAD CURRENT (A)	LOAD CAPACITY (VA)
A -- N	72.0	16844
B -- N	59.6	13110
C -- N	56.5	12420
A -- B -- C	---	---
TOTAL	188.1	41374

CIRCUIT NO.	MCCB	DESCRIPTION	TOTAL LOAD CURRENT(A)	TOTAL LOAD CAPACITY(VA)	WIRE/CABLE (MM ²)	Q'TY	AREA
1	1 P 20AF/20AT	LIGHTING	2.9	624	4	6 (F3)	SIGNAL TELECOM OFFICE. TRAIN CONTROL OFFICE
2	DITTO	DITTO	10.9	2380	6	16 (F6.F8)	PLATFORM (CENKARENG AIRPORT LINE)
3	DITTO	DITTO	11.5	2520	6	18 (F6)	DITTO (DITTO)
4	DITTO	DITTO	10.9	2380	6	16 (F6.F8)	DITTO (DITTO)
5	DITTO	DITTO	12.1	2660	4	18 (F6.F7.F8)	DITTO (DITTO)
6	DITTO	DITTO	9.6	2100	4	15 (F6)	DITTO (DITTO)
7	DITTO	DITTO	12.1	2660	4	18 (F6.F7.F8)	DITTO (DITTO)
8	DITTO	DITTO	13.4	2940	6	21 (F6.F7)	PLATFORM (WESTERN LINE)
9	DITTO	DITTO	10.2	2240	6	14 (F6.F7.F8)	DITTO (DITTO)
10	DITTO	DITTO	13.4	2940	6	21 (F6.F7)	DITTO (DITTO)
11	DITTO	DITTO	11.5	2520	6	18 (F6)	DITTO (DITTO)
12	DITTO	DITTO	10.2	2240	6	14 (F6.F8)	DITTO (DITTO)
13	DITTO	DITTO	11.5	2520	6	18 (F6)	DITTO (DITTO)
14	DITTO	RECEPTACLE	1.4	300	4	2	PLATFORM (CENKARENG AIRPORT LINE)
15	DITTO	DITTO	1.4	300	4	2	DITTO (DITTO)
16	DITTO	DITTO	1.4	300	4	2	PLATFORM (WESTERN LINE)
17	DITTO	DITTO	1.4	300	4	2	DITTO (DITTO)
18	DITTO	DITTO	2.8	600	4	4	SIGNAL TELECOM OFFICE. TRAIN CONTROL OFFICE
19	DITTO	AIR CONDITIONER (AC-4)	11.0	2420	4	1	SIGNAL TELECOM OFFICE
20	DITTO	AIR CONDITIONER (AC-5)	11.0	2420	4	1	TRAIN CONTROL OFFICE
21	DITTO	PUSH-BUTTON STATION	0.1	10	4	1	PLATFORM (CENKARENG AIRPORT LINE)
22	DITTO	SIGN	9.1	2000	4		
23	DITTO	SIGN	9.1	2000	4		
24	DITTO	SPARE					
25	DITTO	SPARE					
26	DITTO	SPARE					
27	DITTO	SPARE					

GROUNDING TERMINAL NEUTRAL TERMINAL

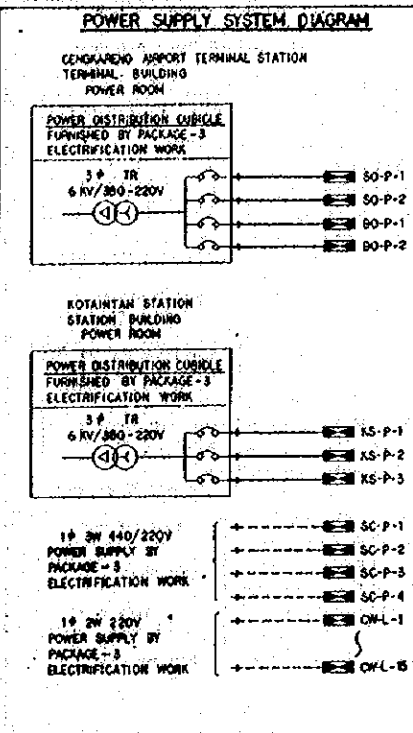

REPUBLIC OF INDONESIA
MINISTRY OF COMMUNICATIONS
DIRECTORATE GENERAL OF LAND TRANSPORT
AND INLAND WATERWAYS

NEW RAILWAY LINE FOR CENKARENG AIRPORT
CONSTRUCTION PROJECT

JAPAN INTERNATIONAL COOPERATION AGENCY
(JICA)

B	1 AUG 88	2	2	2	2	2	2	2
A	15 FEB 89	2	2	2	2	2	2	2


REVISIONS DATE CHECKED DRAWN CHECKED REVISIONS SUBMITTED

KOTA INTAN STATION
PLATFORM
DISTRIBUTION BOARD
SINGLE WIRE DIAGRAM

PACKAGE: I CIVIL AND ARCHITECTURAL WORK

SCALE: NONE DRAWING NO: AE - 019


FROM
POWER SUPPLY BY PACKAGE-3, ELECTRIFICATION WORK

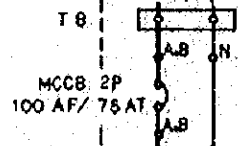

EQUIPMENT NAME	DISTRIBUTION PANEL
EQUIPMENT NO.	SC-P-1/SC-P-2
VOLTAGE	1 ϕ 3W 440/220V 50HZ
LOCATION	SIGNAL DEVICE ROOM

PHASE -- PHASE OR PHASE -- NEUTRAL	LOAD CURRENT (A)	LOAD CAPACITY (VA)
A -- N	44.6	9796
B -- N	45.6	10036
C -- N	---	---
A -- B -- C	---	---
TOTAL	90.2	19832

CIRCUIT NO.	MCCB	DESCRIPTION	TOTAL LOAD CURRENT (A)	TOTAL LOAD CAPACITY (VA)	WIRE/CABLE (MM ²)	Q'TY	AREA
①	1P 20AF/20AT	LIGHTING	6.3	1380	4	21 (F1,F2,F3,13)	SIGNAL DEVICE ROOM, POWER ROOM, LAVATORY, CORRIDOR (1FL,2FL)
②	DITTO	DITTO	6.7	1456	4	15 (F1, F3)	SIGNAL CONTROL ROOM, INSPECTORS ROOM, DRESSING ROOM, STAFF ROOM, PANTRY
③	DITTO	RECEPTACLE	5.5	1200	4	8	SIGNAL DEVICE ROOM, POWER ROOM, LAVATORY
④	DITTO	DITTO	7.5	1650	4	11	SIGNAL CONTROL ROOM, INSPECTORS ROOM, DRESSING ROOM, STAFF ROOM, PANTRY
⑤	DITTO	AIR CONDITIONER (AC-1)	16.0	3520	4	1	SIGNAL CONTROL ROOM
⑥	DITTO	DITTO (AC-2)	16.0	3520	4	1	DITTO
⑦	DITTO	DITTO (AC-3)	11.0	2420	4	1	INSPECTORS ROOM
⑧	DITTO	DITTO (AC-4)	11.0	2420	4	1	DITTO
⑨	DITTO	EXHAUST FAN (EXF-1,2,3,4)	2.8	616	4	4	SIGNAL DEVICE ROOM, POWER ROOM, LAVATORY
⑩	DITTO	DITTO (EXF-5,6,7)	1.5	330	4	3	PANTRY, STAFF ROOM, DRESSING ROOM
⑪	DITTO	TELECOM	3.0	660	---	---	
⑫	DITTO	DITTO	3.0	660	---	---	
⑬	DITTO	SPARE					
⑭	DITTO	SPARE					
⑮	DITTO	SPARE					
⑯	DITTO	INCINERATOR	2.8	616	2 ^c x4	1	DUMP YARD (SC-P-1 ONLY)

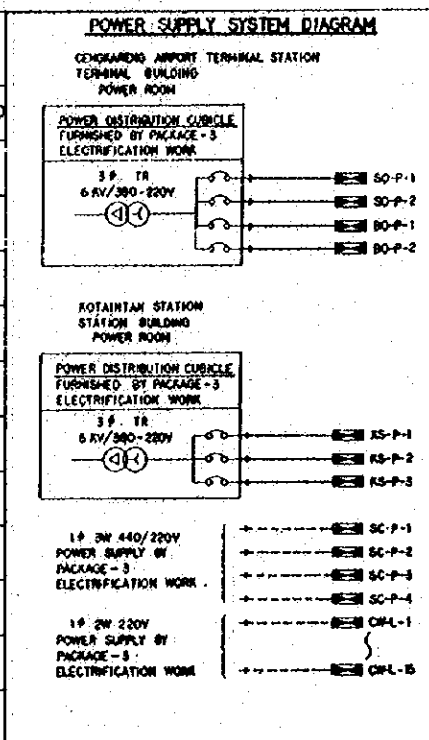

GROUNDING TERMINAL NEUTRAL TERMINAL

REPUBLIC OF INDONESIA
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DIRECTORATE GENERAL OF LAND TRANSPORT AND INLAND WATERWAYS

NEW RAILWAY LINE FOR CENKARENG AIRPORT
CONSTRUCTION PROJECT









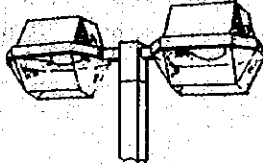
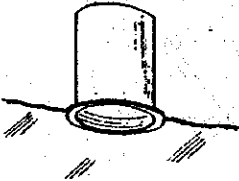




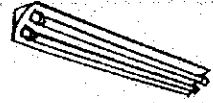


JAPAN INTERNATIONAL COOPERATION AGENCY (JICA)

B	1 AUG 79	E.T.	E.T.	B.K.M.	K.K.
A	1 FEB 81	E.T.	E.T.	B.K.M.	K.K.

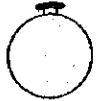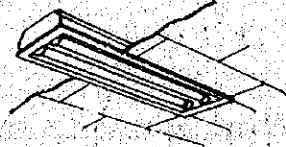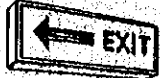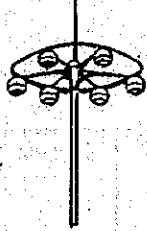REVISORS DATE DESIGNED DRAWN CHECKED REVIEWED SUBMITTED

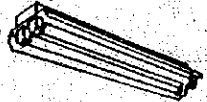SIGNAL CABIN A
DISTRIBUTION BOARD
SINGLE WIRE DIAGRAM

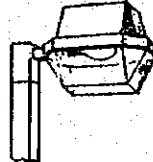PACKAGE: I CIVIL AND ARCHITECTURAL WORK
SCALE: NONE DRAWING NO: AE - 020

 <p>IL 100W 220V</p> <p>TYPE I1</p>	 <p>TYPE F1 FL 40Wx1 220V TYPE F3 FL 40Wx2 220V</p> <p>TYPE F1, F3</p>	 <p>FL 20Wx1 220V</p> <p>TYPE E1</p>	 <p>HL 700Wx6 220V</p> <p>TYPE H1</p>	 <p>HL 40Wx1 220V</p> <p>TYPE H5</p>
 <p>IL 100W 220V</p> <p>TYPE I2</p>	 <p>TYPE F2 FL 40Wx1 220V TYPE F4 FL 40Wx2 220V TYPE F6 FL 110Wx1 220V TYPE F8 FL 110Wx2 220V</p> <p>TYPE F2, F4, F6, F8</p>	 <p>FL 20Wx1 220W</p> <p>TYPE E2</p>	 <p>HL 250Wx2 220V</p> <p>TYPE H2</p>	
 <p>IL 100W 220V</p> <p>TYPE I3</p>	 <p>FL 40Wx1 220V</p> <p>TYPE F5</p>	 <p>TYPE N1 NL 150Wx1 220V TYPE N2 NL 250Wx1 220V</p> <p>TYPE N1, N2</p>	 <p>HL 250Wx1 220V</p> <p>TYPE H3</p>	
 <p>IL 40Wx5 220V</p> <p>TYPE I4</p>	 <p>TYPE F7 FL 110Wx1 TYPE F9 FL 110Wx2</p> <p>TYPE F7, F9</p>	 <p>TYPE M1 ML 300Wx1 220V TYPE M2 ML 400Wx1 220V</p> <p>TYPE M1, M2</p>	 <p>HL 200Wx1 220V</p> <p>TYPE H4</p>	

REPUBLIC OF INDONESIA
 MINISTRY OF COMMUNICATIONS
 DIRECTORATE GENERAL OF LAND TRANSPORT
 AND INLAND WATERWAYS


**NEW RAILWAY LINE FOR CENKARENG AIRPORT
 CONSTRUCTION PROJECT**

JAPAN INTERNATIONAL COOPERATION AGENCY
 (JICA)


REVISED	NO.	DATE	BY	CHECKED	SCALE

**STANDARD DETAIL OF
 LIGHTING FIXTURE**


PROGRAM: **1 CIVIL AND ARCHITECTURAL WORK**
 SCALE: **NONE** DRAWING NO: **AE - 022**

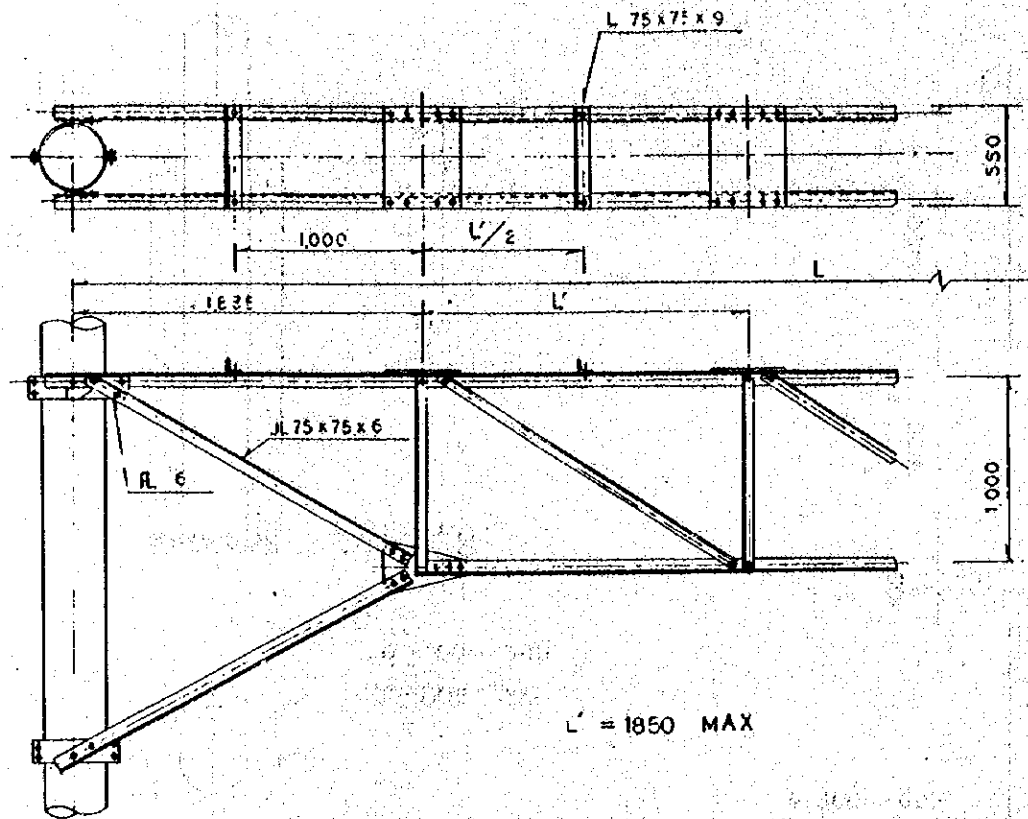


V-TRUSS BEAM ($19M \leq L < 21M$) SCALE 1:20

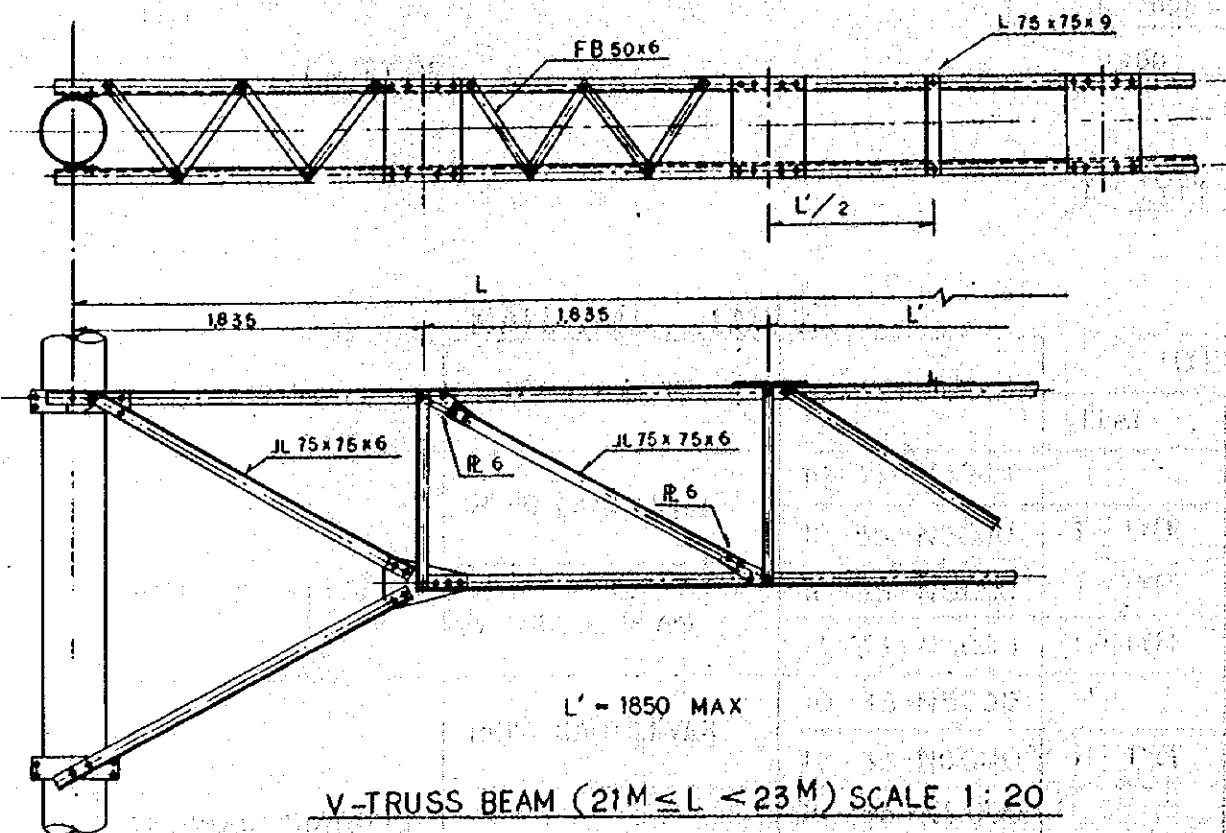


V-TRUSS BEAM ($21M \leq L < 23M$) SCALE 1:20

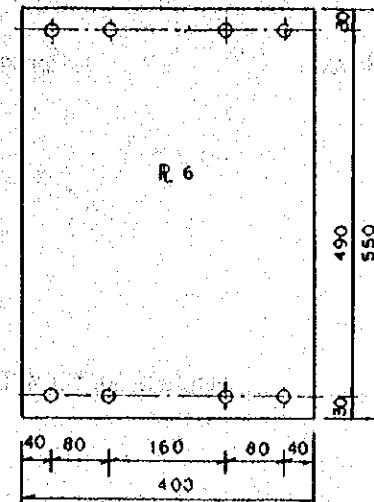


TRUSS BEAM PLATE SCALE 1:5

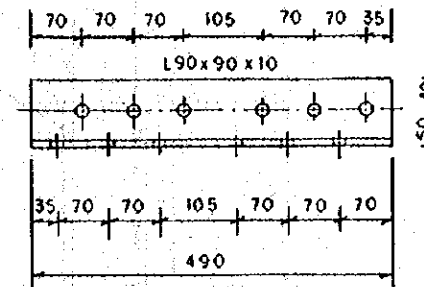


JOINTING ANGLE SCALE 1:5

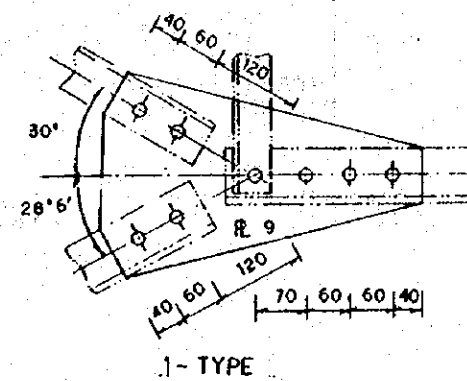

1-TYPE

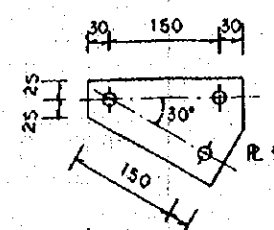


2-TYPE

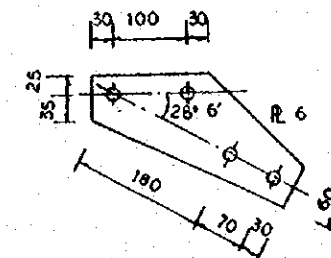

3-TYPE

GUSSET PLATES SCALE 1:5

REPUBLIC OF INDONESIA MINISTRY OF COMMUNICATIONS DIRECTORATE GENERAL OF LAND TRANSPORT AND INLAND WATERWAYS						
NEW RAILWAY LINE FOR CEMKARENG AIRPORT CONSTRUCTION PROJECT						
JAPAN INTERNATIONAL COOPERATION AGENCY (JICA)						
B	14 Aug 1984	S.H	S.H	K.U	K.M	M.K
A	15 Feb 1984	S.H	S.H	K.U	K.M	M.K
REVISIONS	DATE	DESIGNED	CHECKED	APPROVED	REVIEWED	EXAMINED
DETAILS OF V-TRUSS BEAM (2)						
PACKAGE: I CIVIL AND ARCHITECTURAL WORK						
SCALE: AS NOTED		DRAWING NO: EC-015				

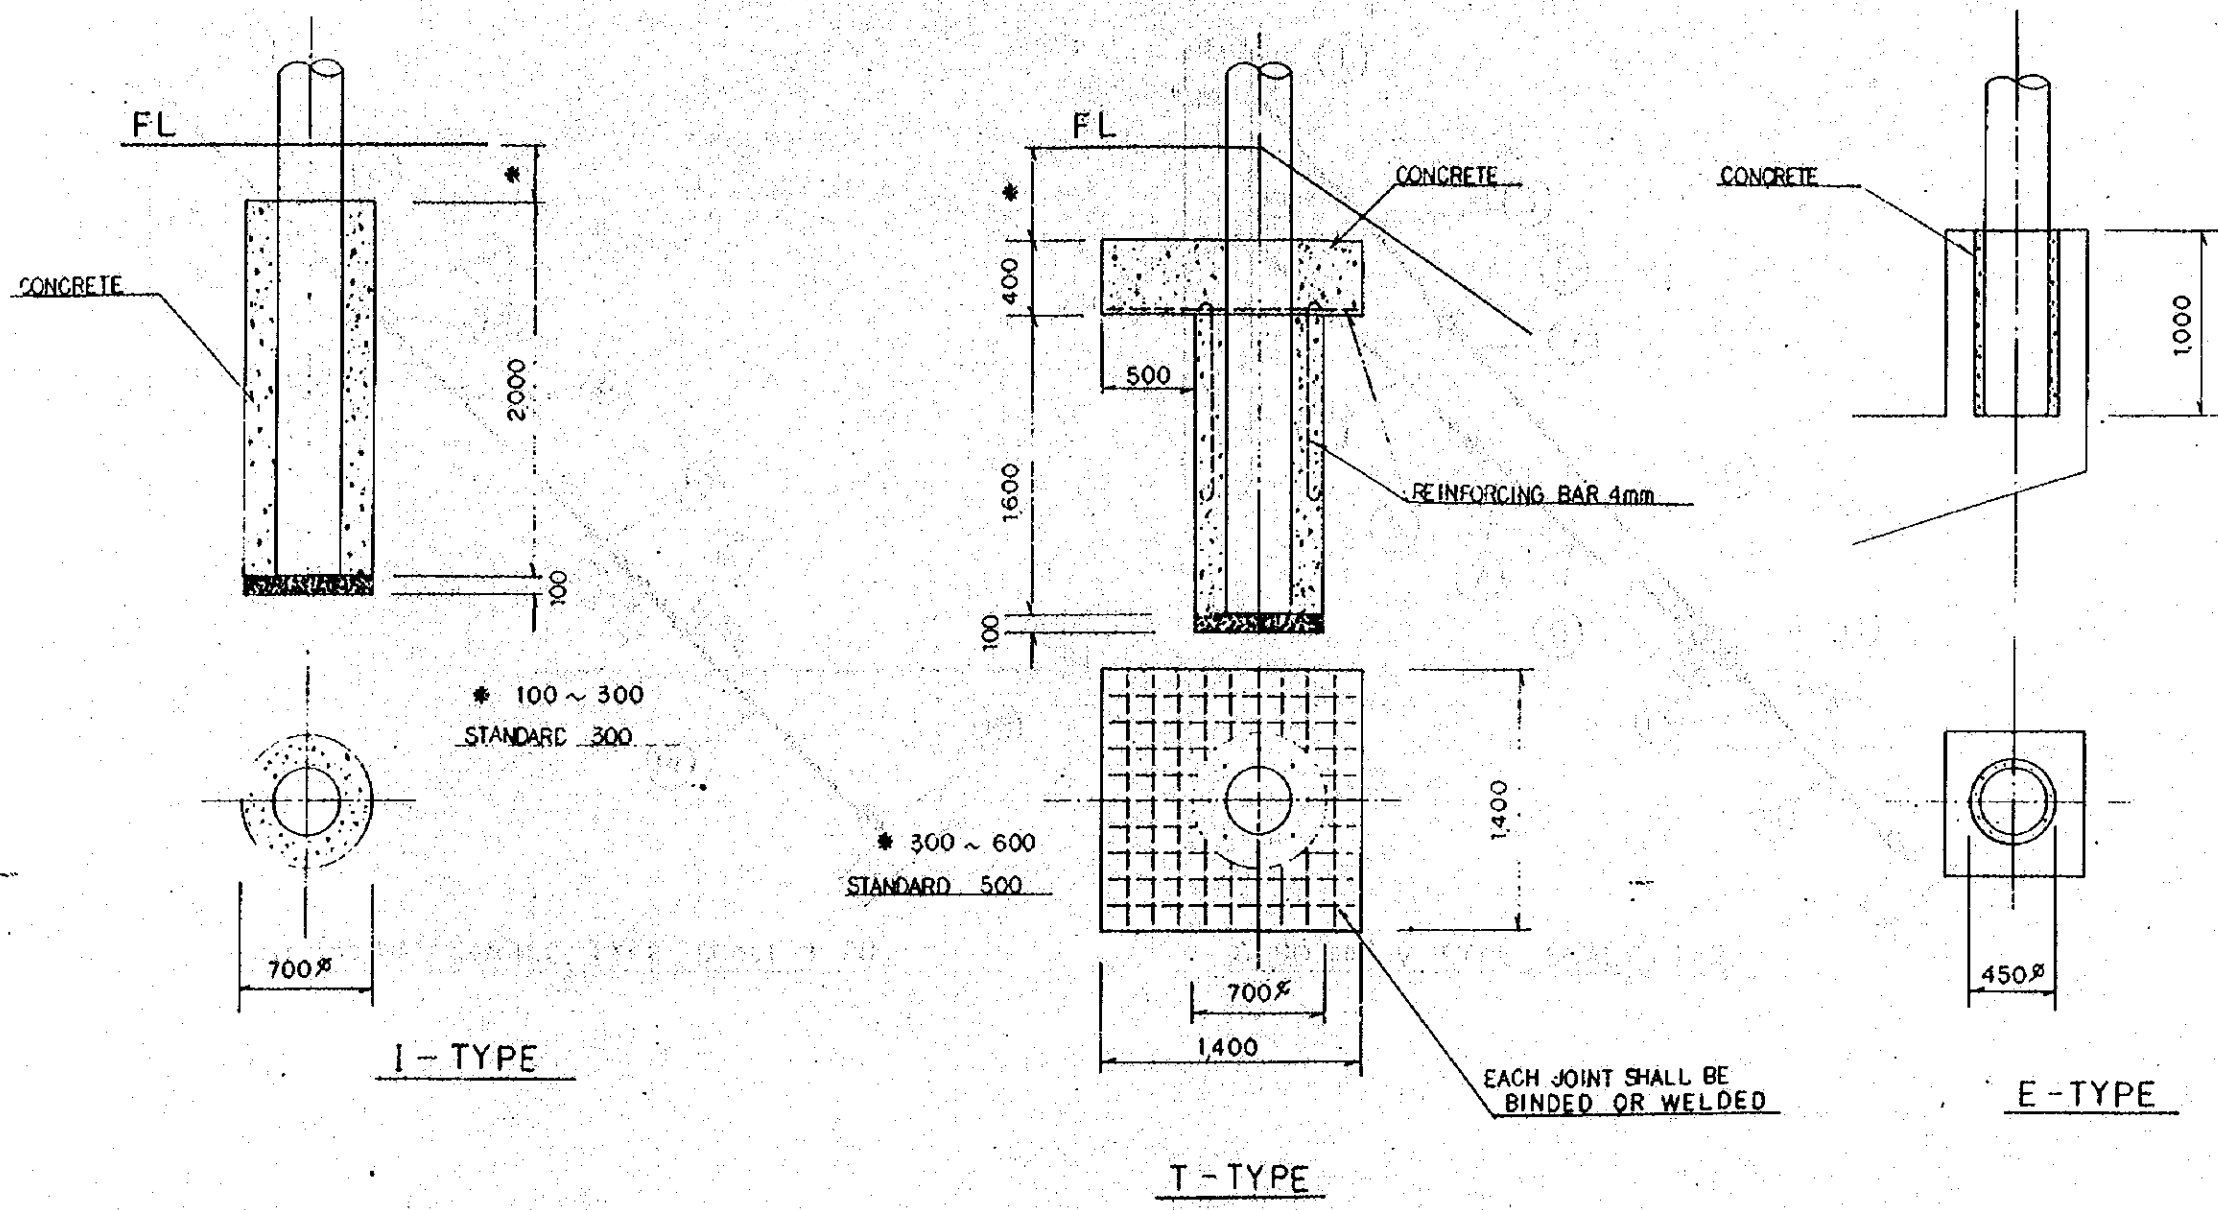

NOTE:
CONCRETE CLASS SHALL BE CLASS F

MATERIAL TABLE

SECTION	BEAM TYPE	CONCRETE POLE	POLE FOUNDATION		
			FLAT	EMBANKMENT BANK	ELEVATED STRUCTURE
INSIDE OF STATION	RIGID CANTILEVER	10-35-N5000			E-TYPE
		12-35-N5000	I-TYPE	T-TYPE	
	V-TRUSS BEAM	10-35-N5000	I-TYPE		E-TYPE
		11-35-N5000	I-TYPE		
BETWEEN STATIONS	RIGID CANTILEVER	10-35-N5000			E-TYPE
		12-35-N5000	I-TYPE	T-TYPE	
	V-TRUSS BEAM	10-35-N5000			E-TYPE
		11-35-N5000	I-TYPE		
		12-35-N5000	I-TYPE		

REPUBLIC OF INDONESIA
MINISTRY OF COMMUNICATIONS
DIRECTORATE GENERAL OF LAND TRANSPORT
AND INLAND WATERWAYS

NEW RAILWAY LINE FOR CENGKARENG AIRPORT
CONSTRUCTION PROJECT


JAPAN INTERNATIONAL COOPERATION AGENCY
(JICA)

B	1 Aug '84	S.H	S.H	K.H	K.M	M.K
A	16 Feb '84	S.H	S.H	K.H	K.M	M.K


REVISIONS DATE DESIGNED DRAWN CHECKED REVISION SUBMITTED

DETAILS OF CONCRETE
POLE FOUNDATION


PACKAGE: I CIVIL AND ARCHITECTURAL WORK
SCALE: 1:20 DRAWING NO: EC-016

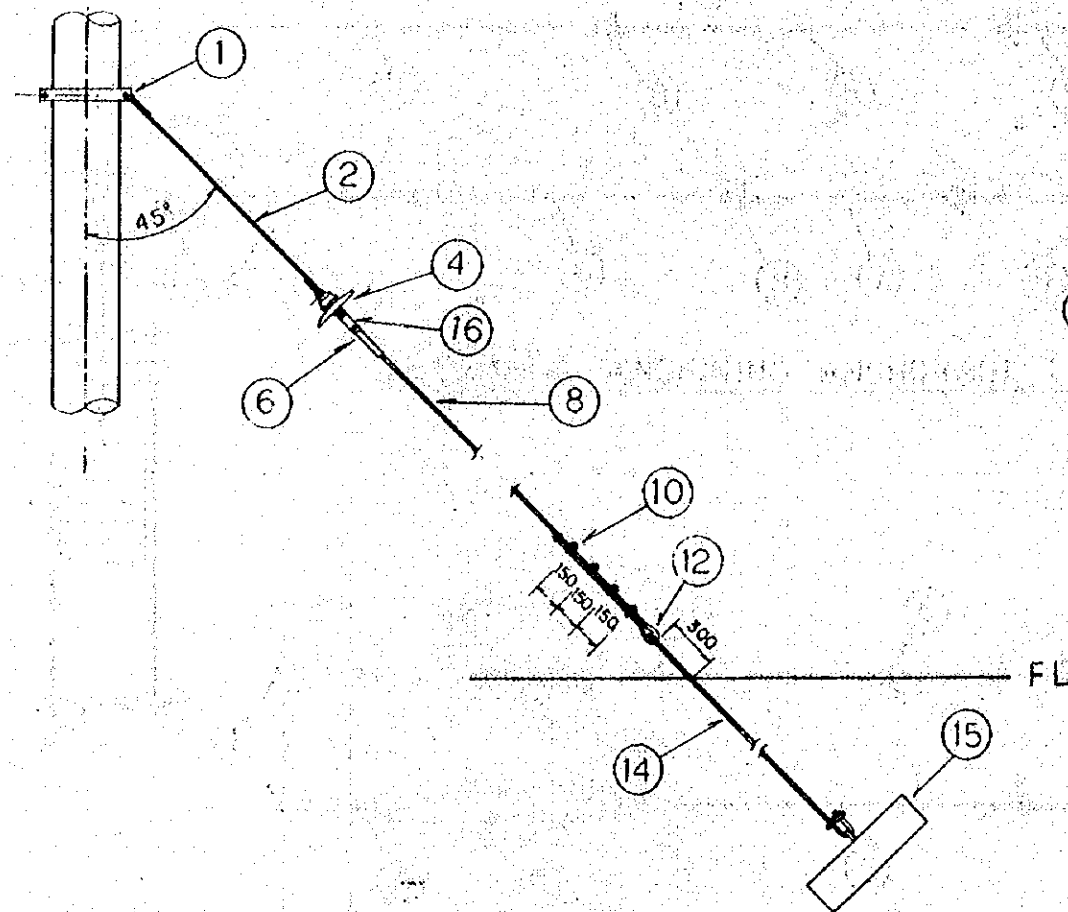

ST 135 mm² SINGLE TYPE SCALE 1:20

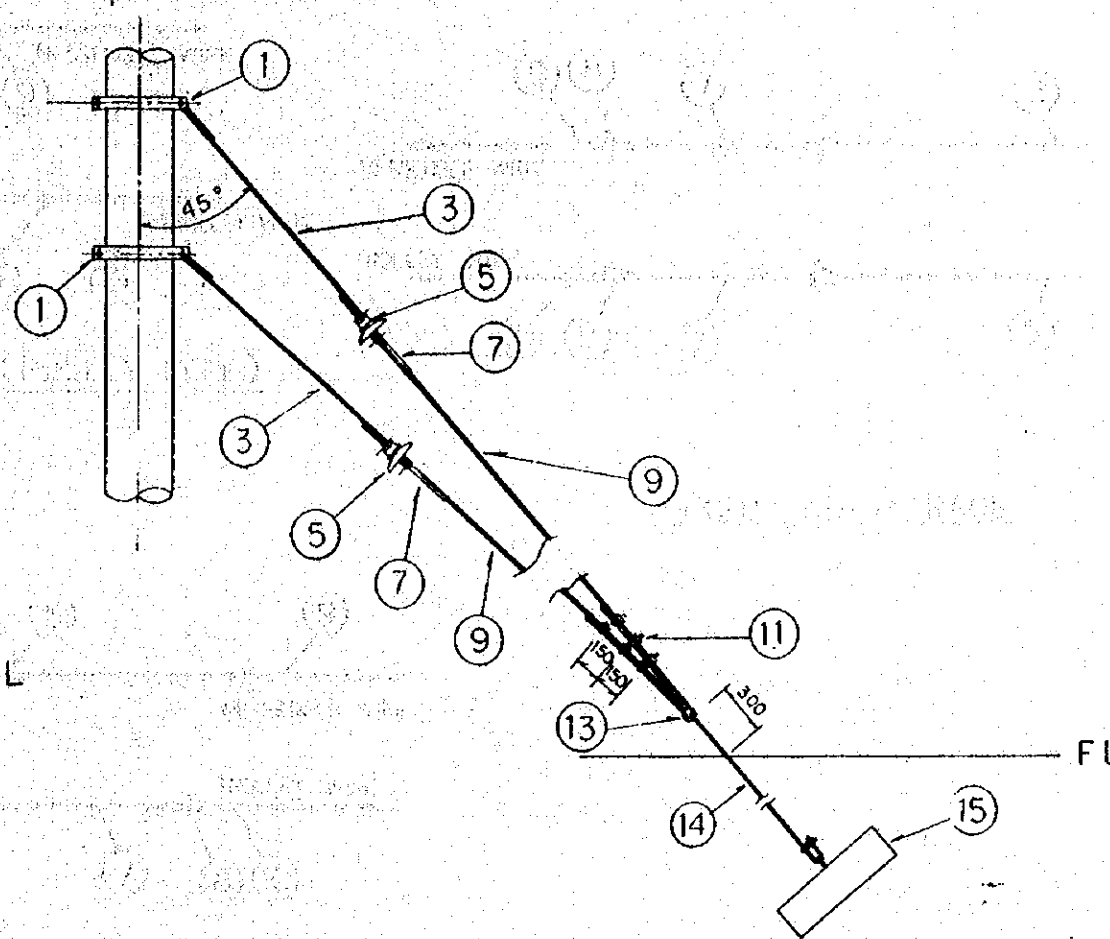


ST 90 mm² V-TYPE SCALE 1:20

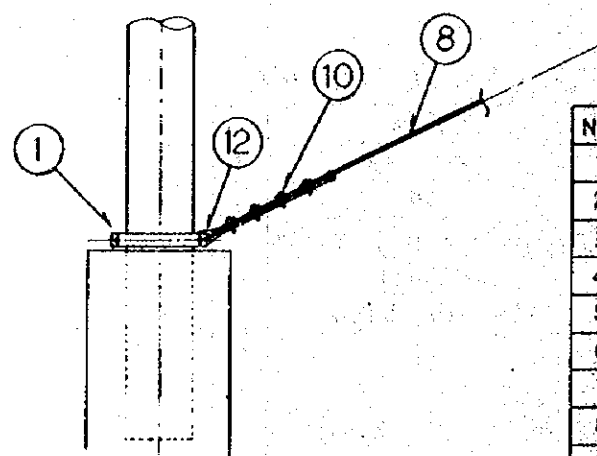

ELEVATED STRUCTURE SCALE 1:20


MATERIAL TABLE

No	ARTICLE	TYPE
1	POLE BAND	B 2
2	CONNECTING ROD	19 [#] x 1500
3	DO	16 [#] x 1500
4	SUSPENSION INSULATOR	250 EP-J
5	DO	180 C
6	COMPRESSION DEAD-END FITTING	FOR 135 mm ²
7	DO	FOR 90 mm ²
8	GALVANIZED STEEL WIRE STRANDS	135 mm ²
9	DO	90 mm ²
10	WIRE CLIP	FOR 135 mm ² x 2
11	DO	FOR 90 mm ² x 2
12	GUY THIMBLE	FOR 135 mm ² x 1
13	DO	FOR 90 mm ² x 2
14	GUY ROD	25 [#] x 3000
15	GUY ANCHOR	CONCRETE TYPE
16	CONNECTING FITTING	H TYPE

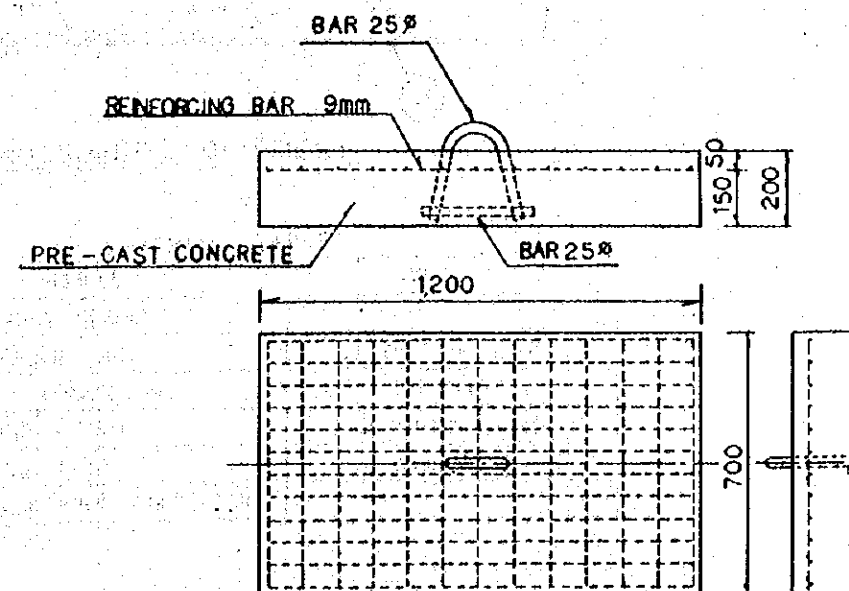


GUY ANCHOR SCALE 1:10


REPUBLIC OF INDONESIA						
MINISTRY OF COMMUNICATIONS						
DIRECTORATE GENERAL OF LAND TRANSPORT AND INLAND WATERWAYS						
NEW RAILWAY LINE FOR CENKARENG AIRPORT CONSTRUCTION PROJECT						
JAPAN INTERNATIONAL COOPERATION AGENCY (JICA)						
B	1/AUG/84	S.H	S.H	K.U	K.M	M.K
A	15/MAR/84	S.H	S.H	K.U	U.M	M.K
REVISION	DATE	DESIGNED	FRANK	CHECKED	EXTEND	SUBMITTED
DETAILS OF GUY						
PROJECT: I CIVIL AND ARCHITECTURAL WORK						
SCALE	DRAWING NO.					
AS NOTED	EC - 017					

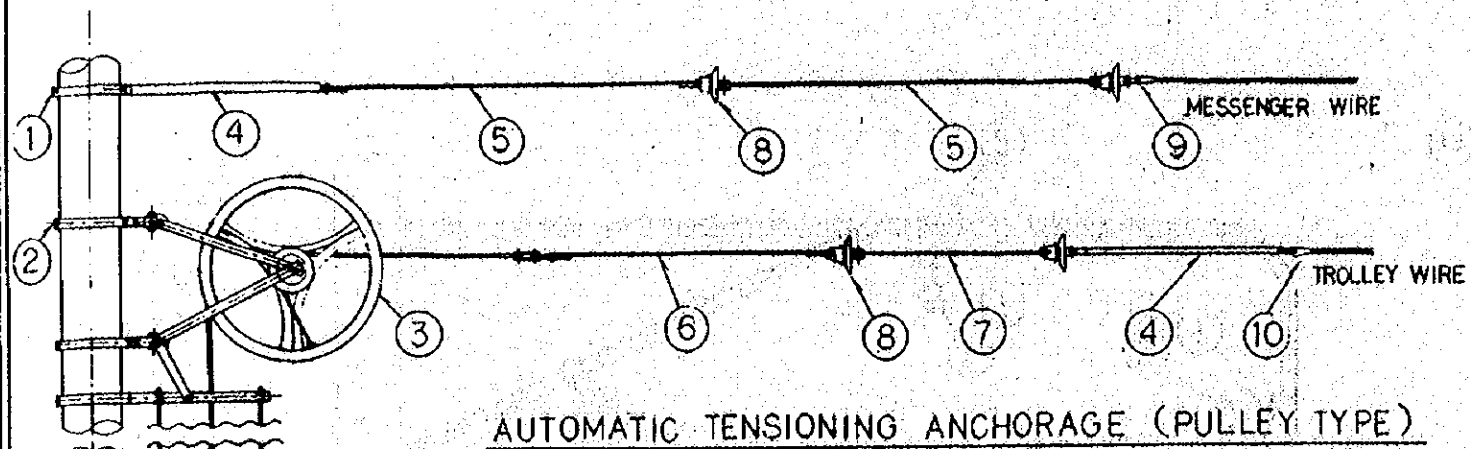


AUTOMATIC TENSIONING ANCHORAGE (PULLEY TYPE)

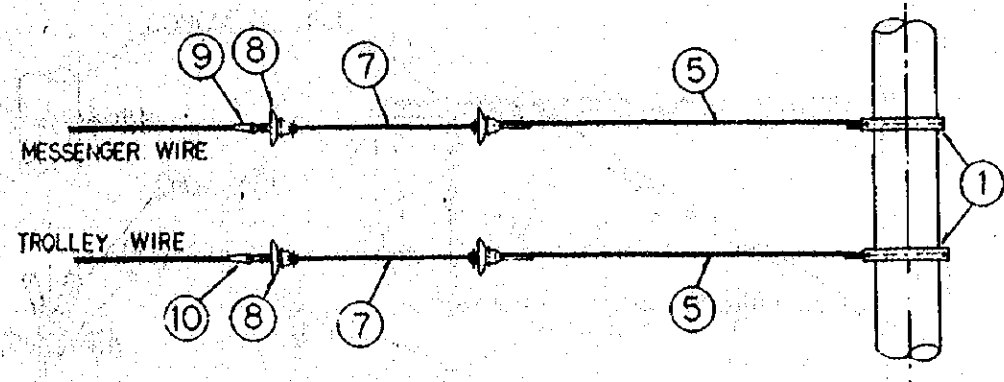

FIXED ANCHORAGE

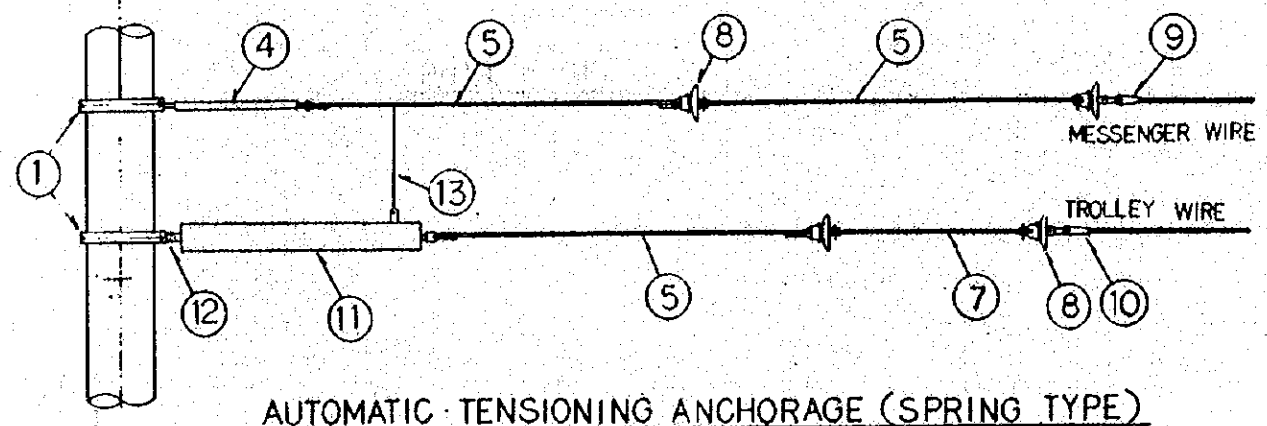

AUTOMATIC TENSIONING ANCHORAGE (SPRING TYPE)

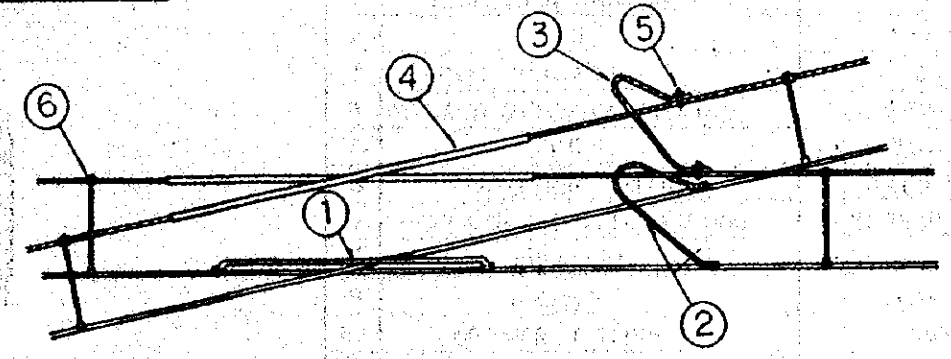

CROSSOVER EQUIPMENT

ANCHORAGE MATERIAL TABLE

NO	ARTICLE	TYPE
1	POLE BAND	B2
2	DO	TK 1
3	AUTOMATIC TENSIONING DEVICE	PULLEY TYPE
4	TURNBUCKLE	L = 600 mm
5	CONNECTING ROD	16 ϕ x 2000
6	DO	16 ϕ x 1500
7	DO	16 ϕ x 1000
8	SUSPENSION TYPE INSULATOR	180 C
9	DEAD-END FITTING	BS 90
10	DO	WTS 90
11	AUTOMATIC TENSIONING DEVICE	SPRING TYPE
12	CONNECTING FITTING	9 x 50 x 200

MATERIAL TABLE

NO	ARTICLE	TYPE
1	CROSS CLAMP	
2	FEEDER EAR	Cu 100 mm ² L = 800
3	CONNECTOR	St 90 mm ²
4	LINE GUARD	St 90 mm ² L = 2000
5	WIRE CLIP	St 90 mm ² x 2
6	MESSENGER WIRE PROTECTOR	

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 AND INLAND WATERWAYS

NEW RAILWAY LINE FOR CENGKARENG AIRPORT
 CONSTRUCTION PROJECT

JAPAN INTERNATIONAL COOPERATION AGENCY
 (JICA)


B	1 Aug '84	S.H	S.H	K.U	K.M	M.K
A	15 Feb '84	S.H	S.H	K.U	K.M	M.K

REVISION DATE CHECKED DRAWN CHECKED REVIEWED SUBMITTED


DETAILS OF AUTOMATIC
 TENSIONING EQUIPMENT

PACKAGE: I CIVIL AND ARCHITECTURAL WORK


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PULL - OFF

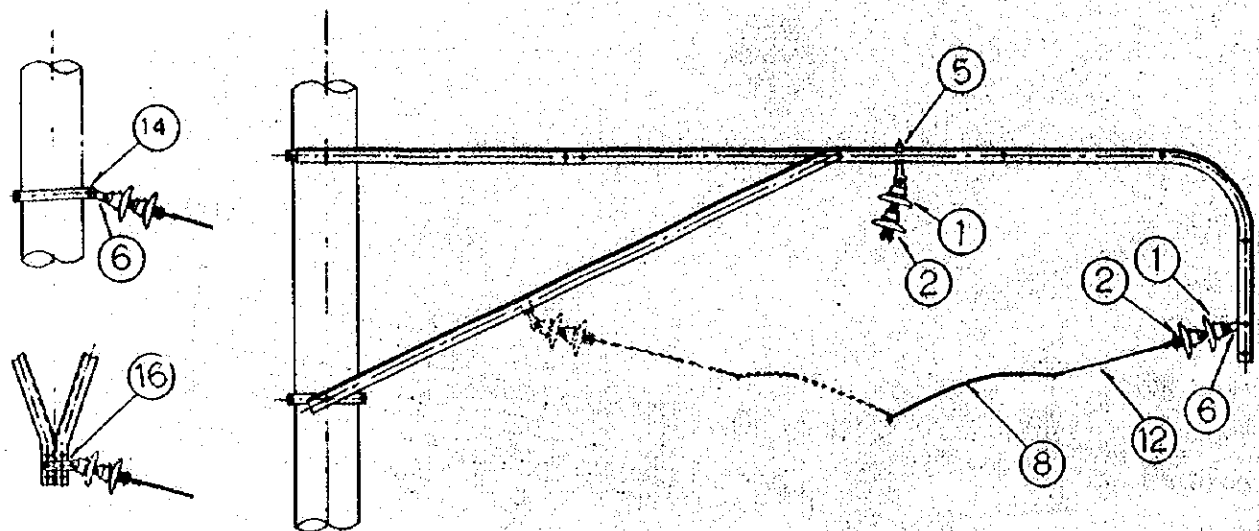

STEADY BRACE (FOR MOVABLE PIPE)

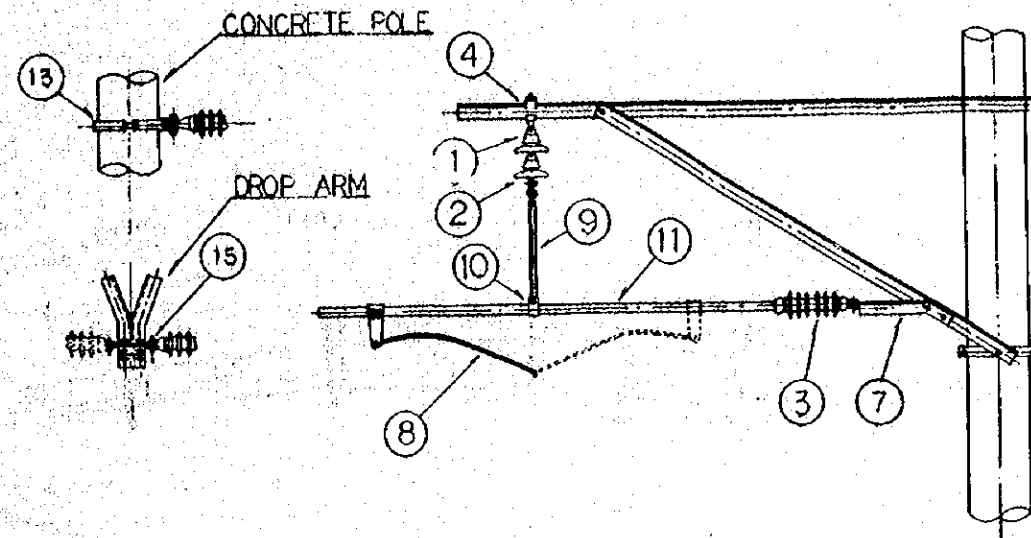

STEADY BRACE (FOR SPAN WIRE)

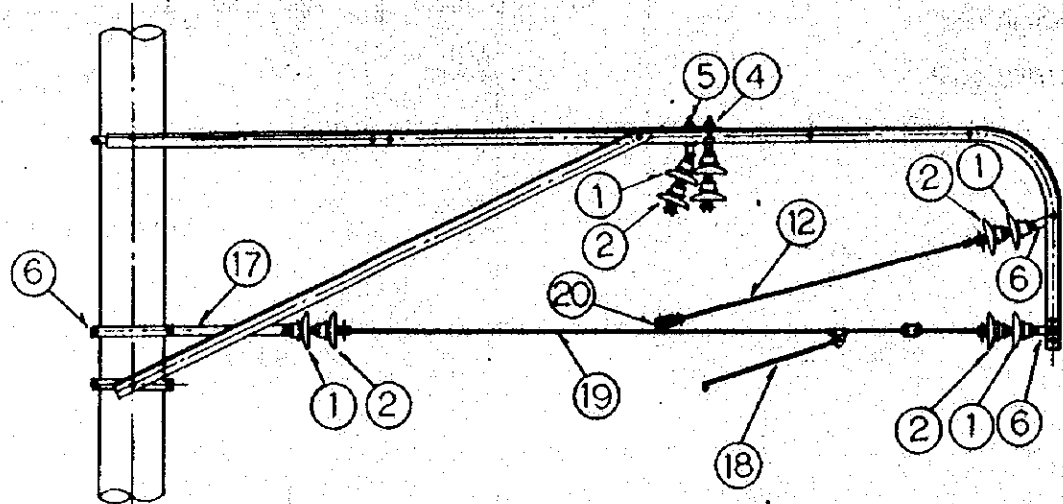MATERIAL TABLE

No	ARTICLE	TYPE
1	SUSPENSION INSULATOR	180 EP
2	DO	180 C
3	STEM INSULATOR	DC
4	INSULATOR SUSPENSION FITTING	FOR STRAIGHT SECTION
5	DO	FOR CURVED SECTION
6	CONNECTING FITTING	6 x 50 x 100
7	INSULATOR INSTALLING FITTING	FOR RIGID CANTILEVER
8	PULL-OFF	BOWED-TYPE L=900
9	DROPPER	6 x 38 x 565
10	DROPPER FITTING	48.6°
11	PIPE	48.6°
12	HARD DRAWN COPPER WIRE	CU 35mm ²
13	POLE BAND	F1
14	DO	B1
15	INSULATOR INSTALLING FITTING	FOR DROP ARM
16	CONNECTING FITTING	6 x 50 x 150
17	DO	6 x 50 x 150
18	STEADY BRACE	
19	ROD FOR SPAN WIRE	13°
20	PULLEY FOR PULL-OFF	

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NEW RAILWAY LINE FOR CENKARENG AIRPORT
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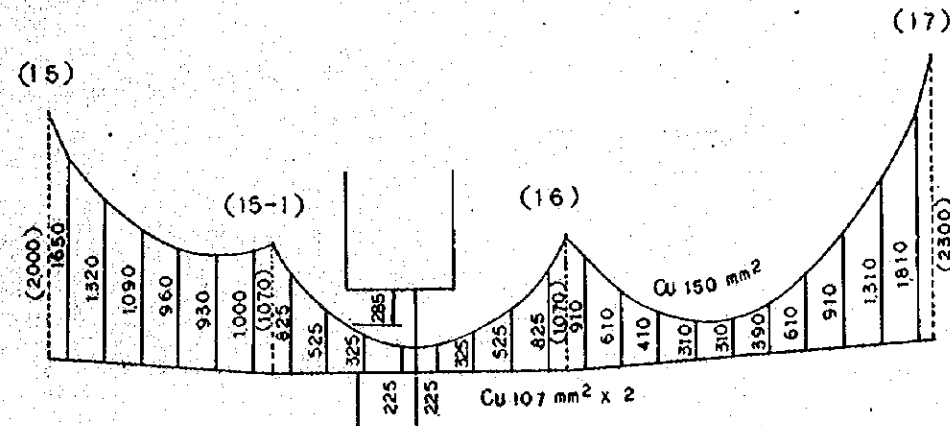
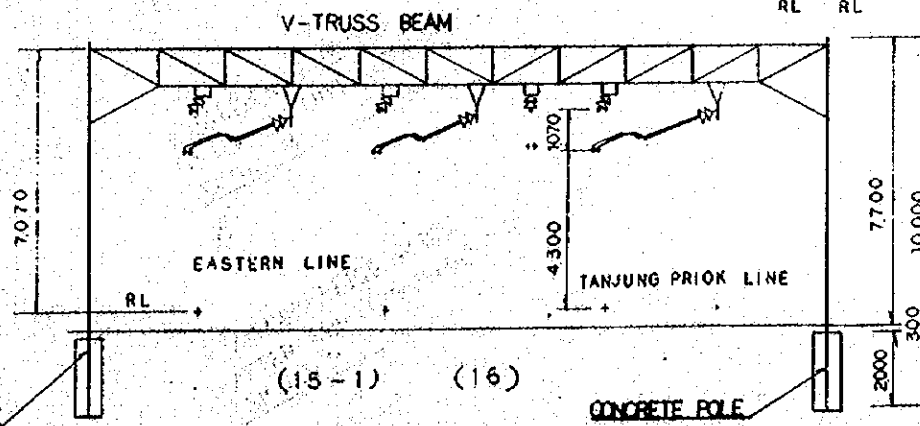
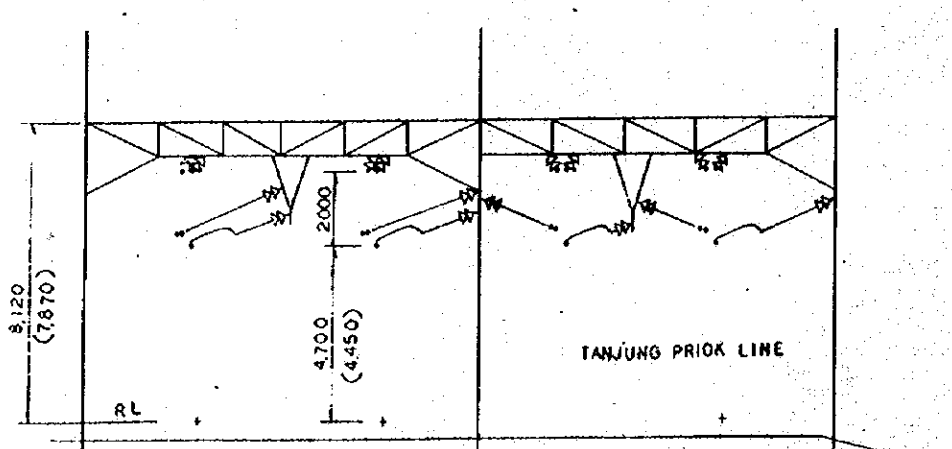
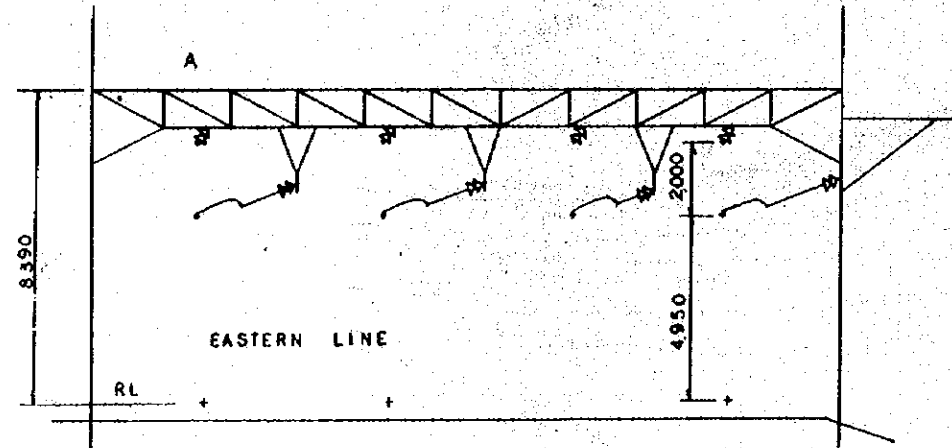
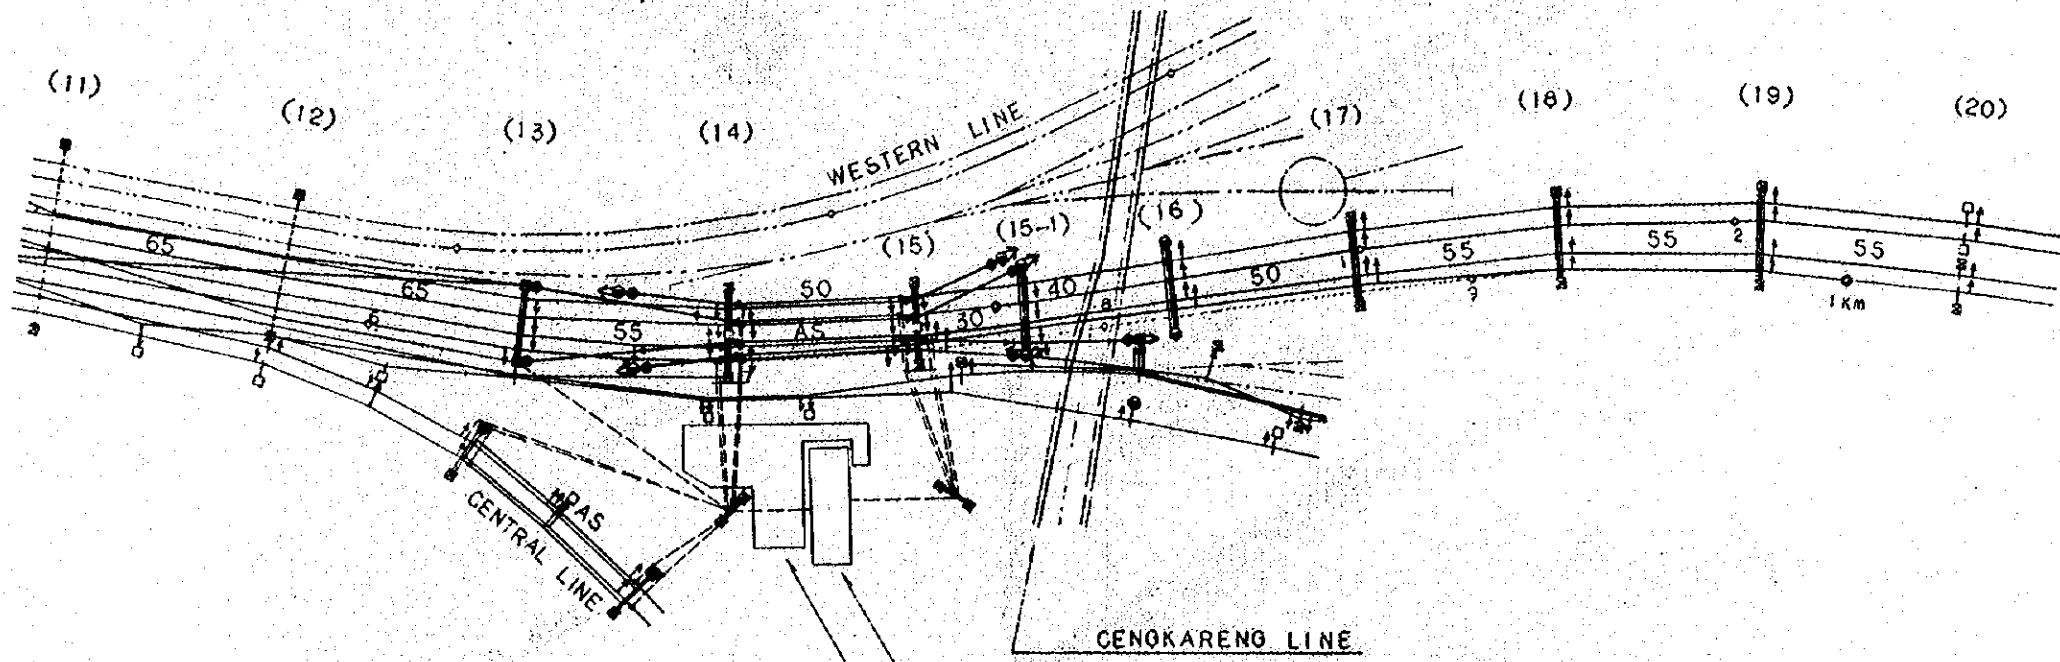
JAPAN INTERNATIONAL COOPERATION AGENCY
 (JICA)

B	1 Aug 89	S.H	S.H	K.H	K.H	M.K
A	15 Feb 89	S.H	S.H	K.H	K.H	M.K

REVISIONS: DATE, CHECKED, DRAWN, LAYOUT, REVISED, SUBMITTED

DETAILS OF PULL-OFF
 AND
 STEADY BRACE

PACKAGE: I CIVIL AND ARCHITECTURAL WORK
 SCALE: 1:20 DRAWING NO: EC-021



LENGTH OF HANGER (mm)
SCALE (H) 1:500 (V) 1:30

HEIGHT FROM RAIL TOP (m)

POLE NO.	MESSENGER	TROLLEY	GRADIENT OF TROLLEY
12	7.2	5.2	3.8 / 1000
13	6.99	4.95	4.5 /
14	6.72	4.70	5.0 /
15	6.47	4.45	5.0 /
15-1	5.37	4.3	0
16	5.37	4.3	4.4 /
17	6.52	4.52	4.9 /
18	6.79	4.79	4.9 /
19	7.06	5.06	4.3 /
20	7.3	5.3	

ASSEMBLY SKETCHES SCALE 1:100

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AND INLAND WATERWAYS

NEW RAILWAY LINE FOR GENOKARENG AIRPORT
CONSTRUCTION PROJECT



JAPAN INTERNATIONAL COOPERATION AGENCY
(JICA)

B	1 AUG. 84	S.H.	S.H.	K.H.	K.M.	M.K.
A	15 FEB. 84	S.H.	S.H.	K.H.	K.M.	M.K.

REVISIONS DATE DESIGNED DRAWN CHECKED REVISION SUBMITTED

DIAGRAMMATIC PLAN OF TRACTION
POWER DISTRIBUTION LINE FOR
JAKARTA KOTA STATION

PACKAGE: I CIVIL AND ARCHITECTURAL WORK
SCALE: AS NOTED DRAWING NO.: EC-025

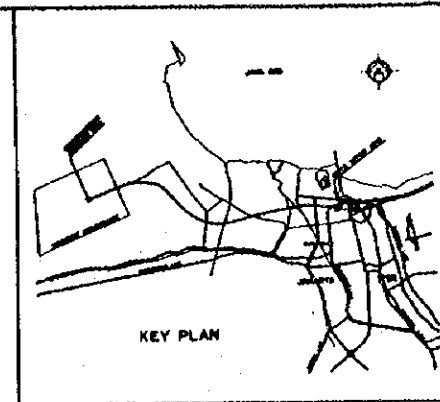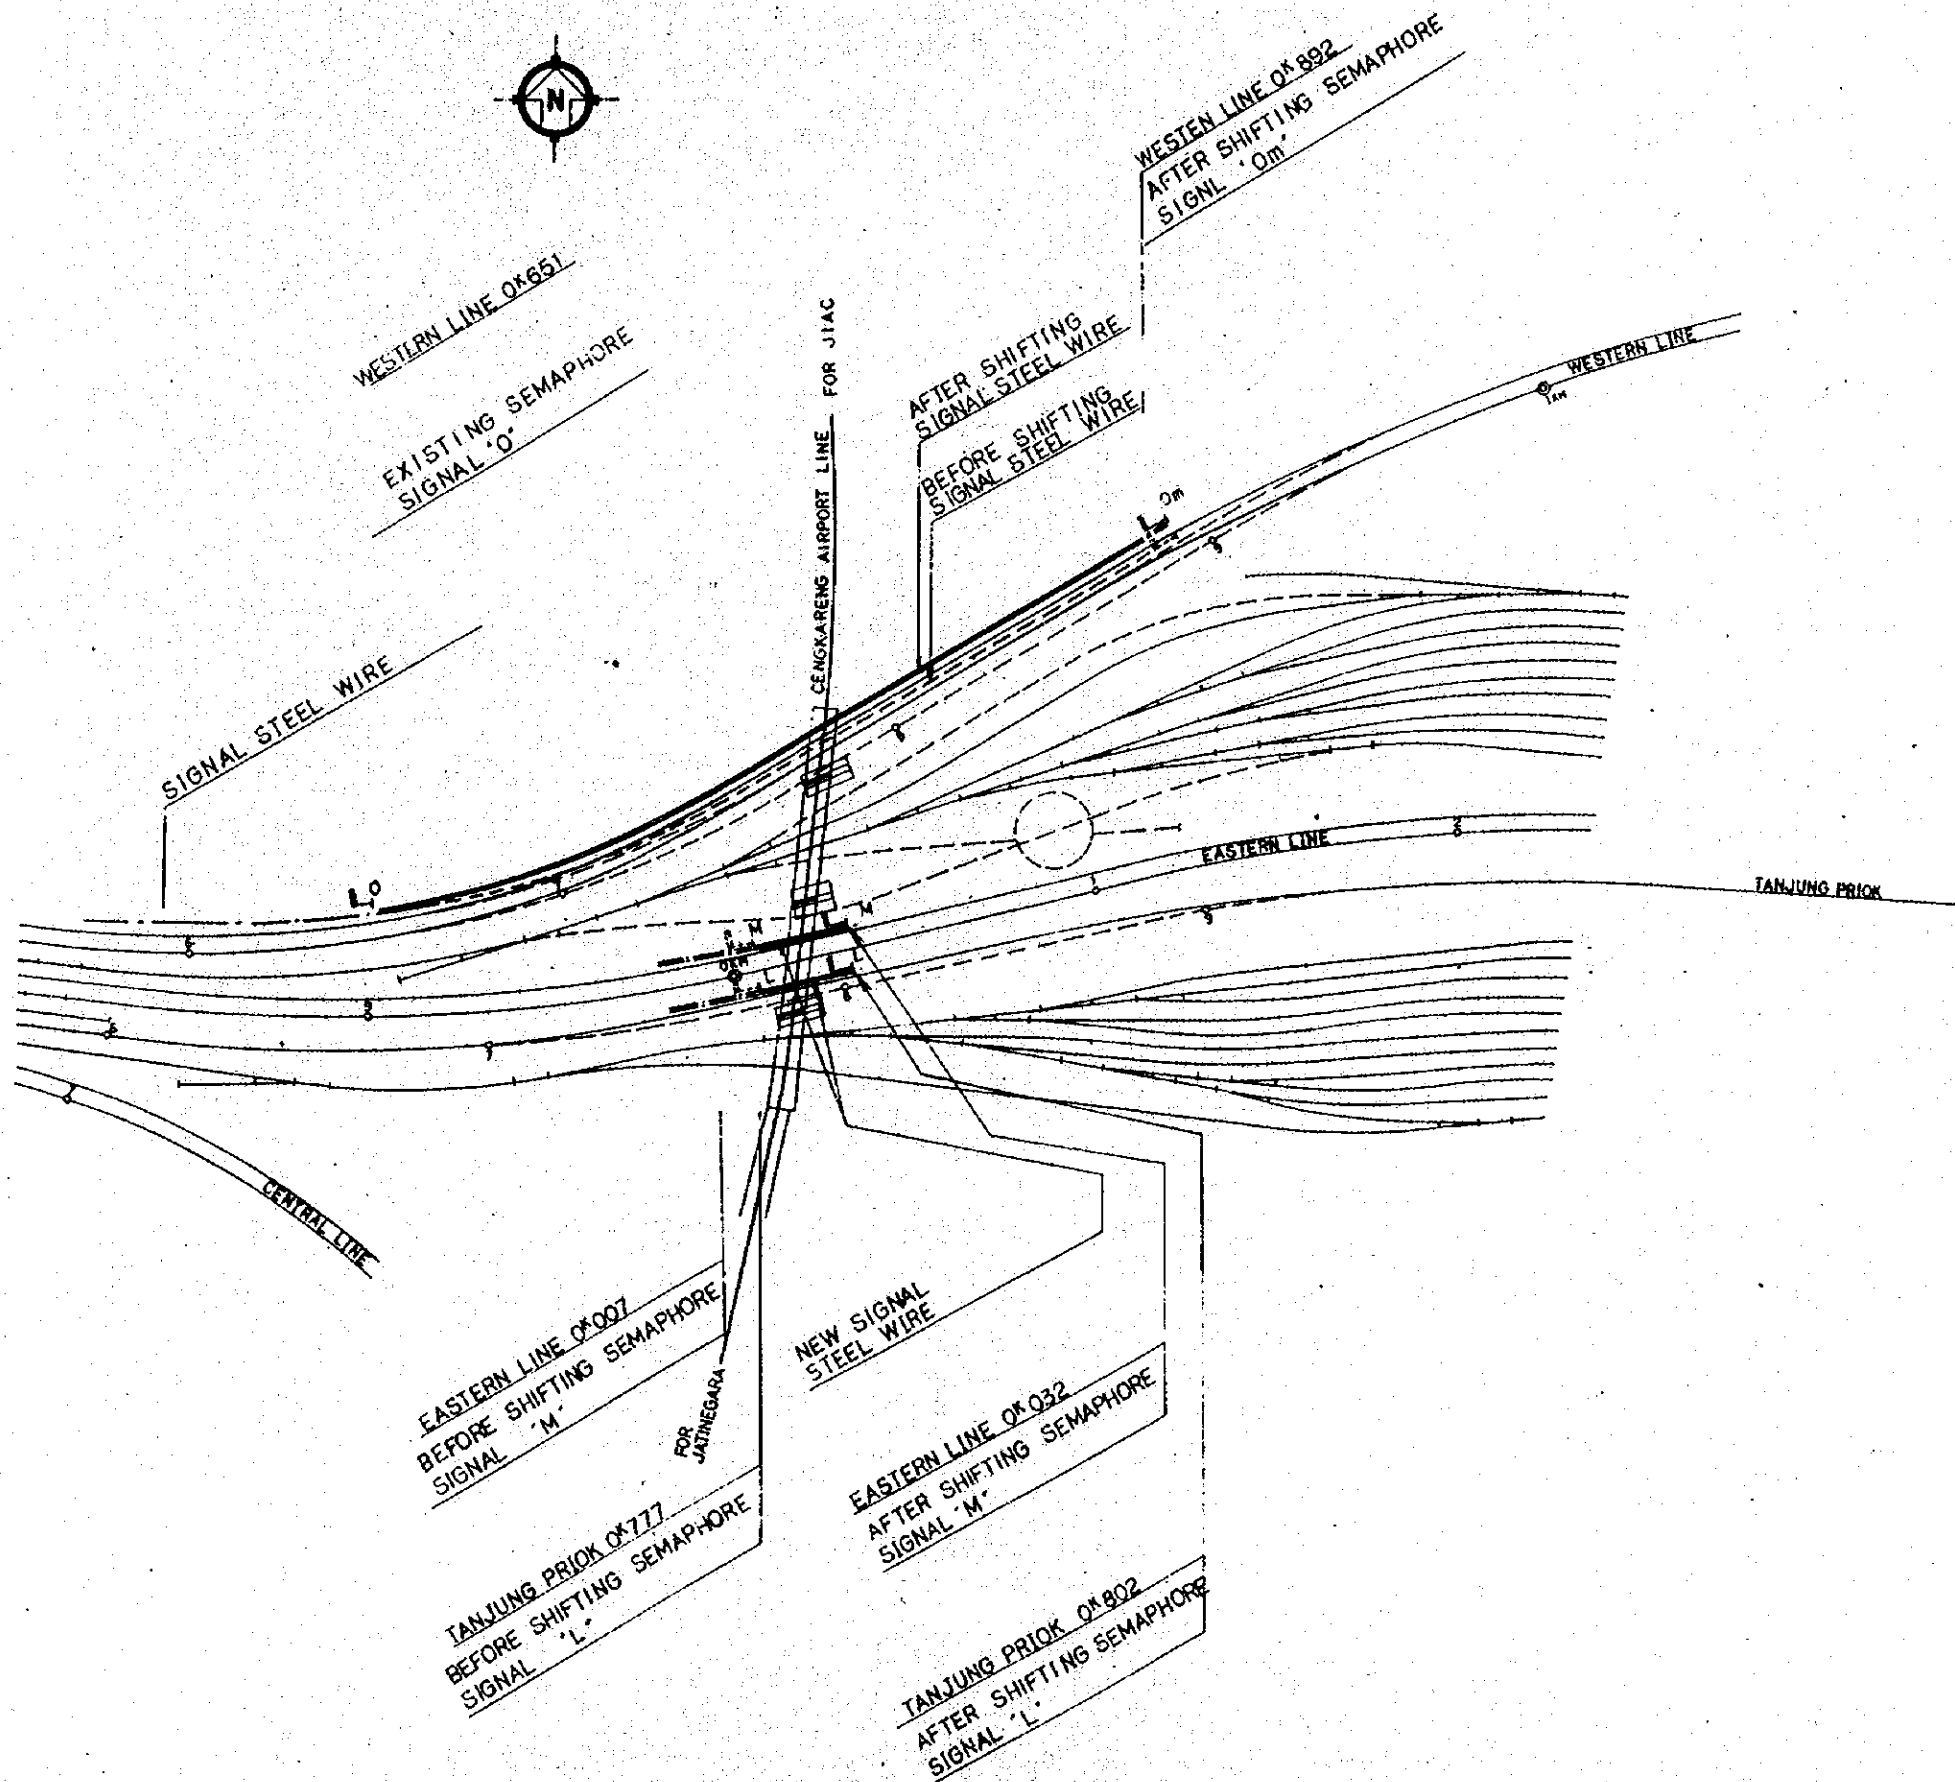

REPUBLIC OF INDONESIA						
MINISTRY OF COMMUNICATIONS						
DIRECTORATE GENERAL OF LAND TRANSPORT AND INLAND WATERWAYS						
NEW RAILWAY LINE FOR CENKARENG AIRPORT CONSTRUCTION PROJECT						
JAPAN INTERNATIONAL COOPERATION AGENCY (JICA)						
B	1 AUG '84	SH	SH	KL	K.M	M.K
A	15 FEB '84	SH	SH	KL	K.M	M.K
REVISION	DATE	DESIGNED	CHECKED	REVIEWED	SUBMITTED	
MODIFICATION OF EXISTING SIGNAL EQUIPMENT AT JAKARTA KOTA STATION						
PROGRAM: I CIVIL AND ARCHITECTURAL WORK						
SCALE: 1:1,000		DRAWING NO: ES-035				

