

**REPUBLIC OF INDONESIA  
MINISTRY OF COMMUNICATIONS  
DIRECTORATE GENERAL OF LAND TRANSPORT  
AND INLAND WATERWAYS**

**TENDER DOCUMENTS  
FOR  
NEW RAILWAY LINE FOR CENGKARENG AIRPORT  
CONSTRUCTION PROJECT**

**PACKAGE I CIVIL AND ARCHITECTURAL WORK**

**PART F DRAWINGS**

**3 of 3**

**AUGUST 1984**

**JAPAN INTERNATIONAL COOPERATION AGENCY  
(JICA)**

国際協力事業団

|          |           |      |
|----------|-----------|------|
| 納入<br>月日 | '84.11.19 | L108 |
| 登録No.    | 10866     | 61.6 |
|          |           | SDF  |

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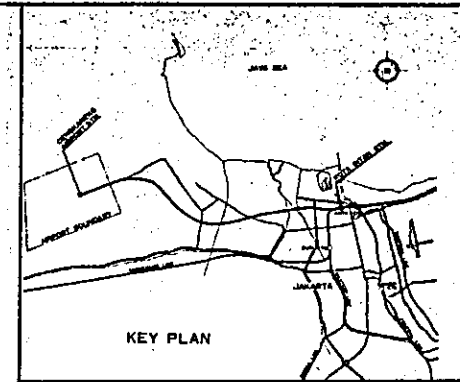
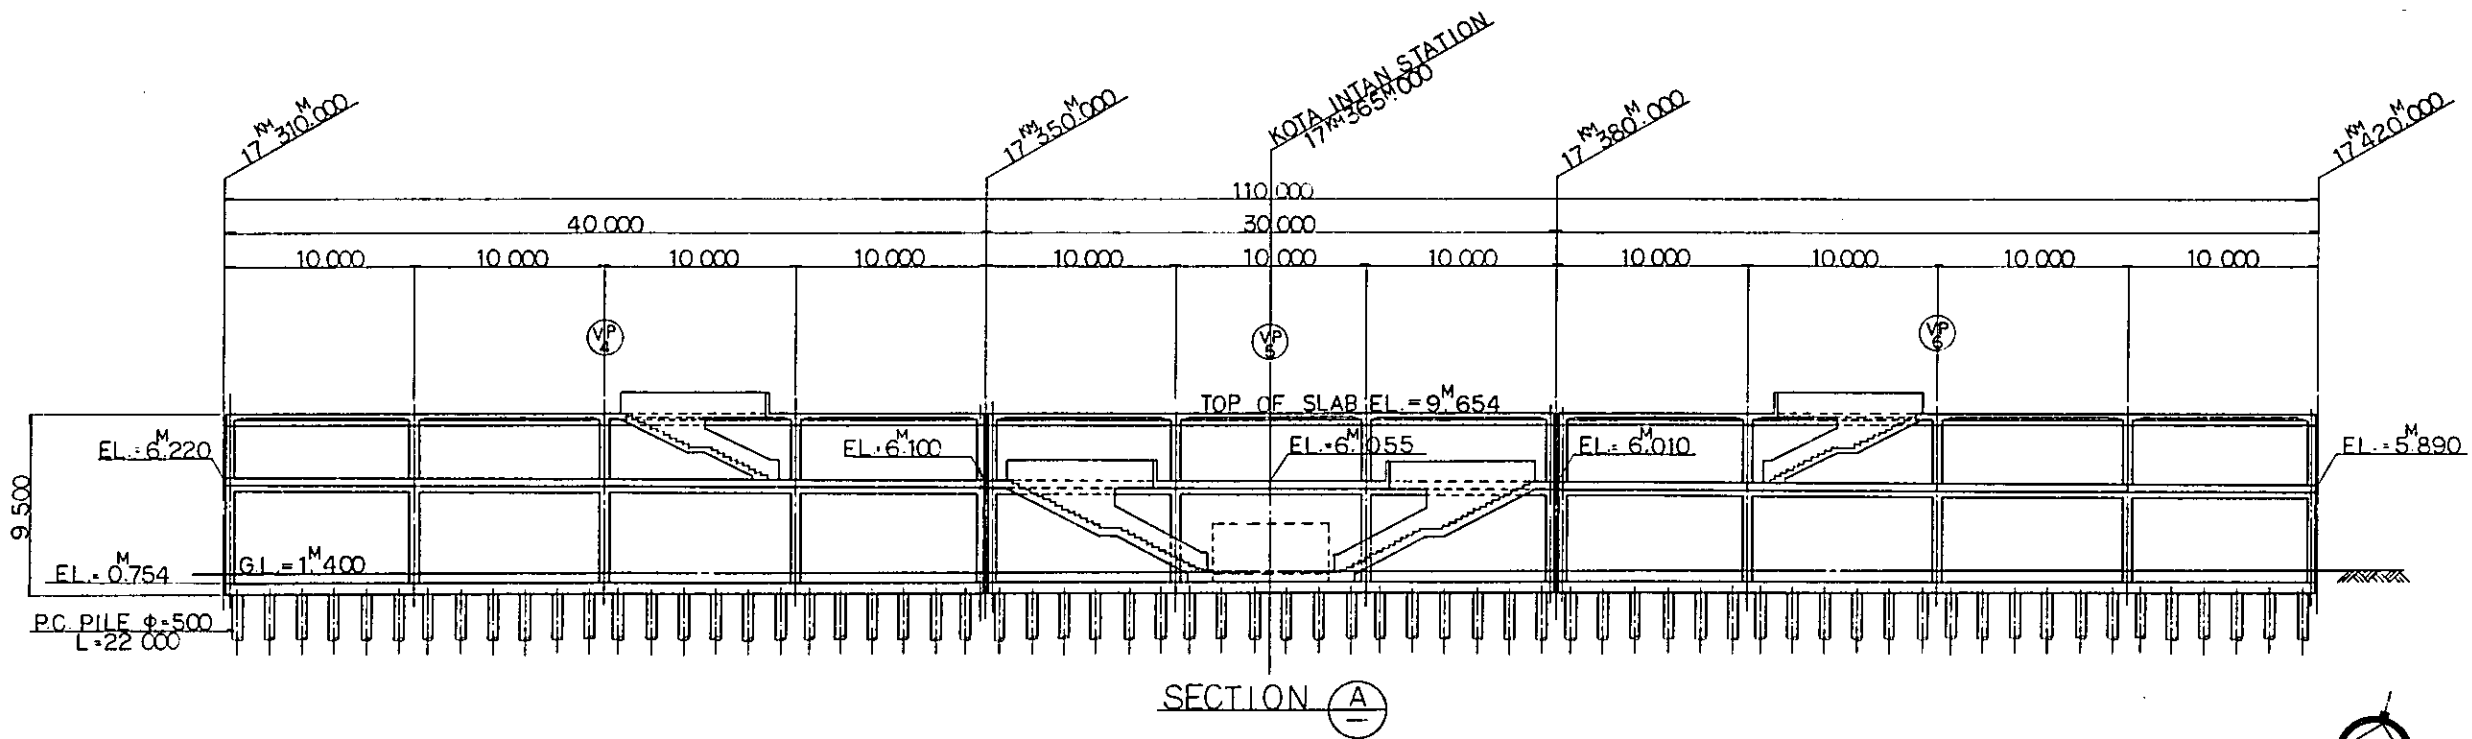
| DWG. No. | TITLE  | DWG. No. | TITLE  |
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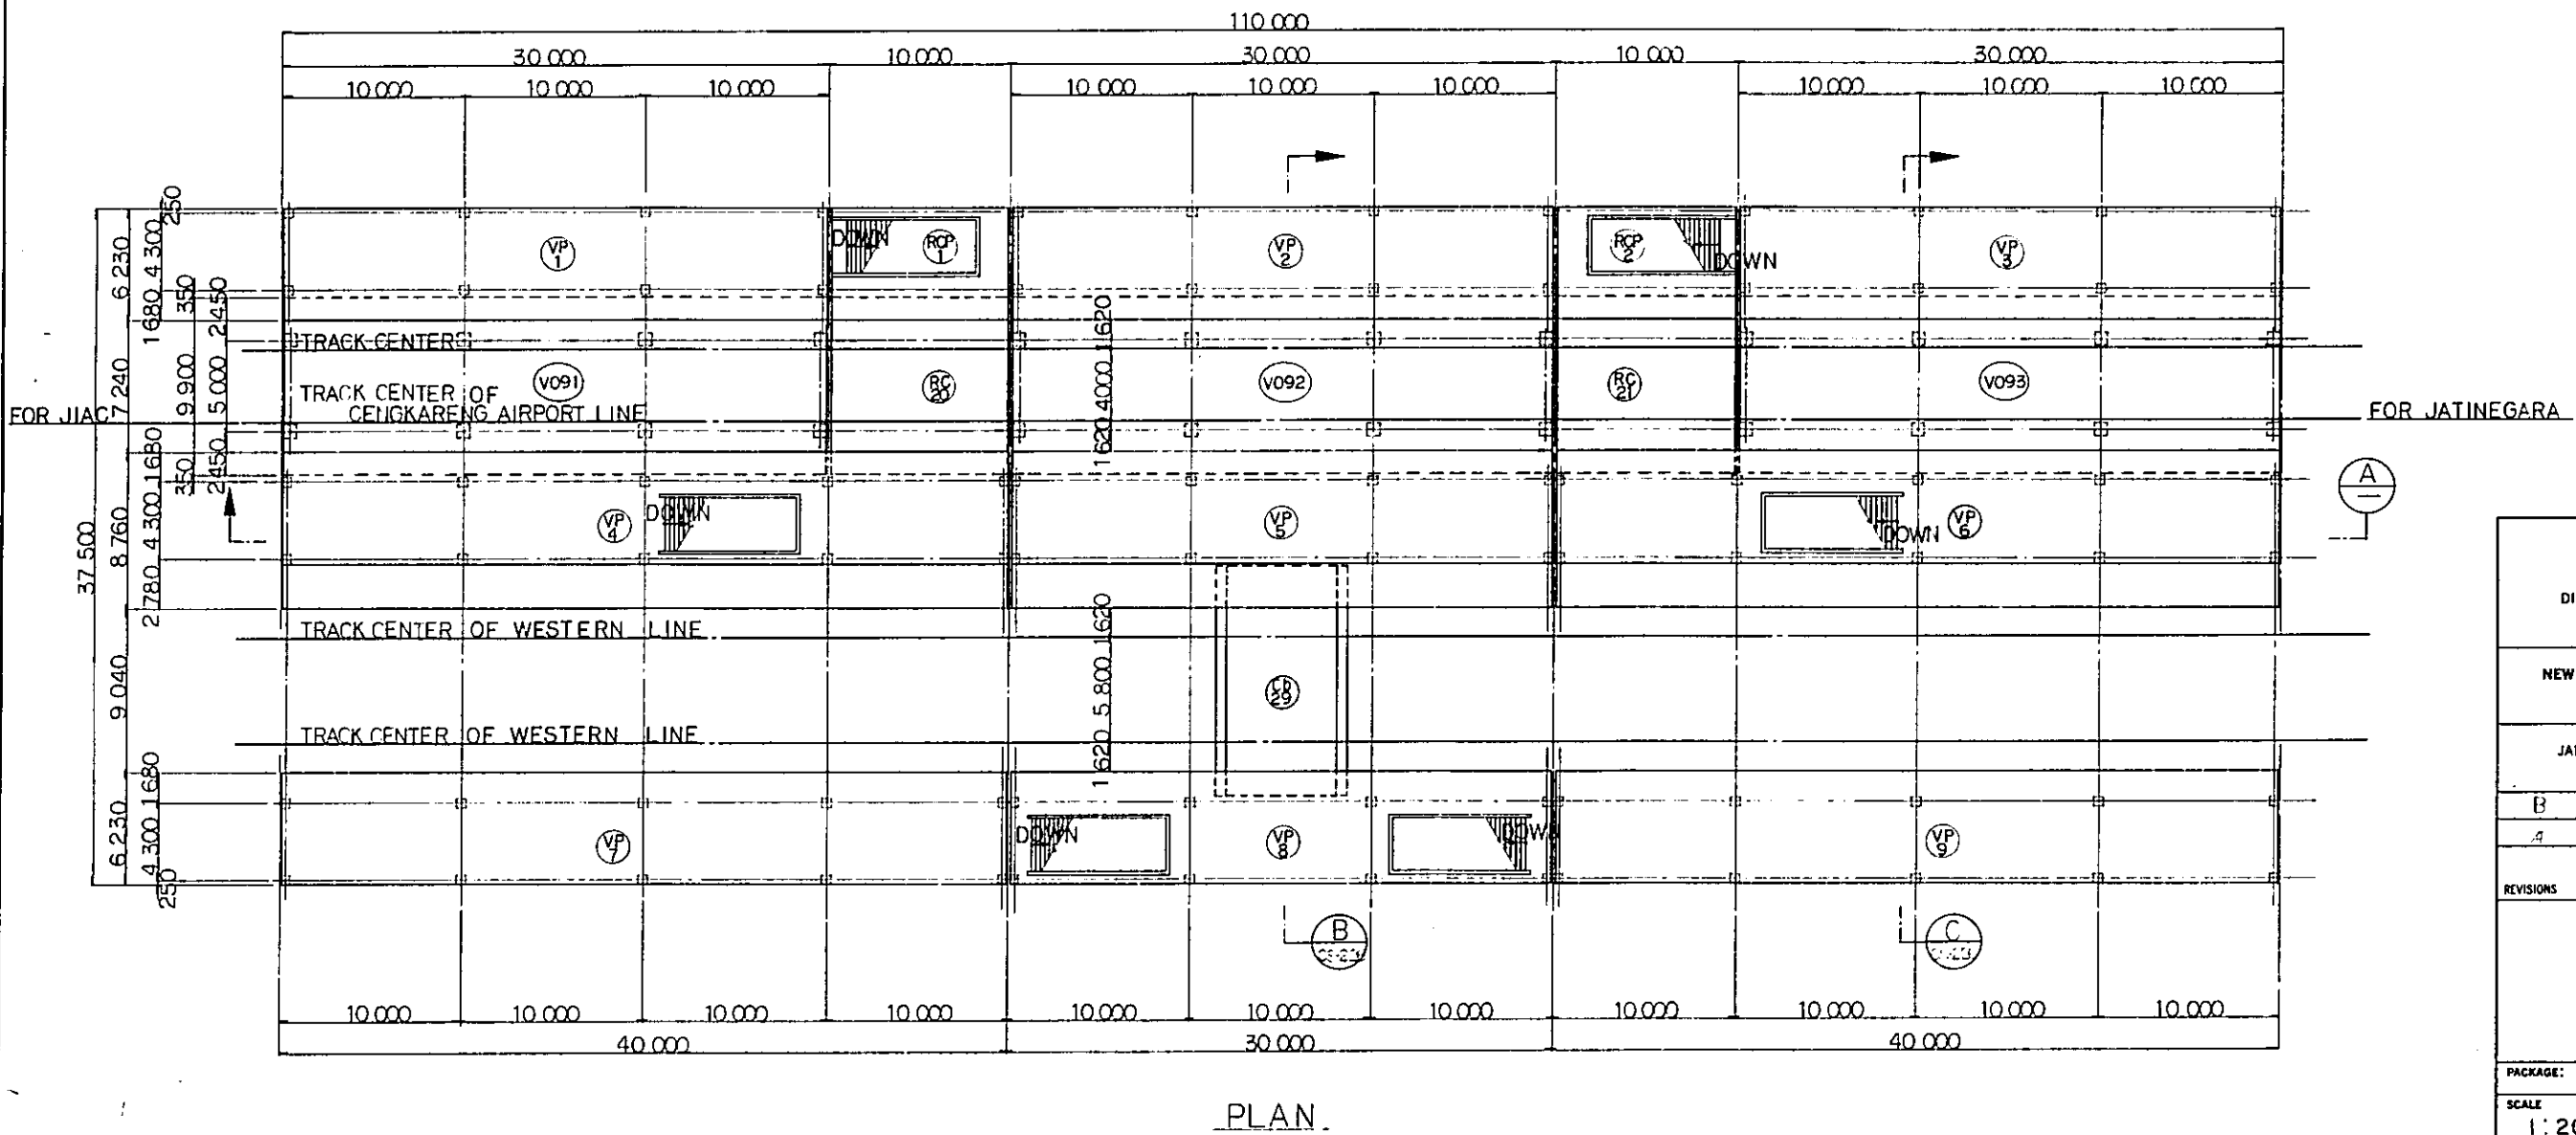
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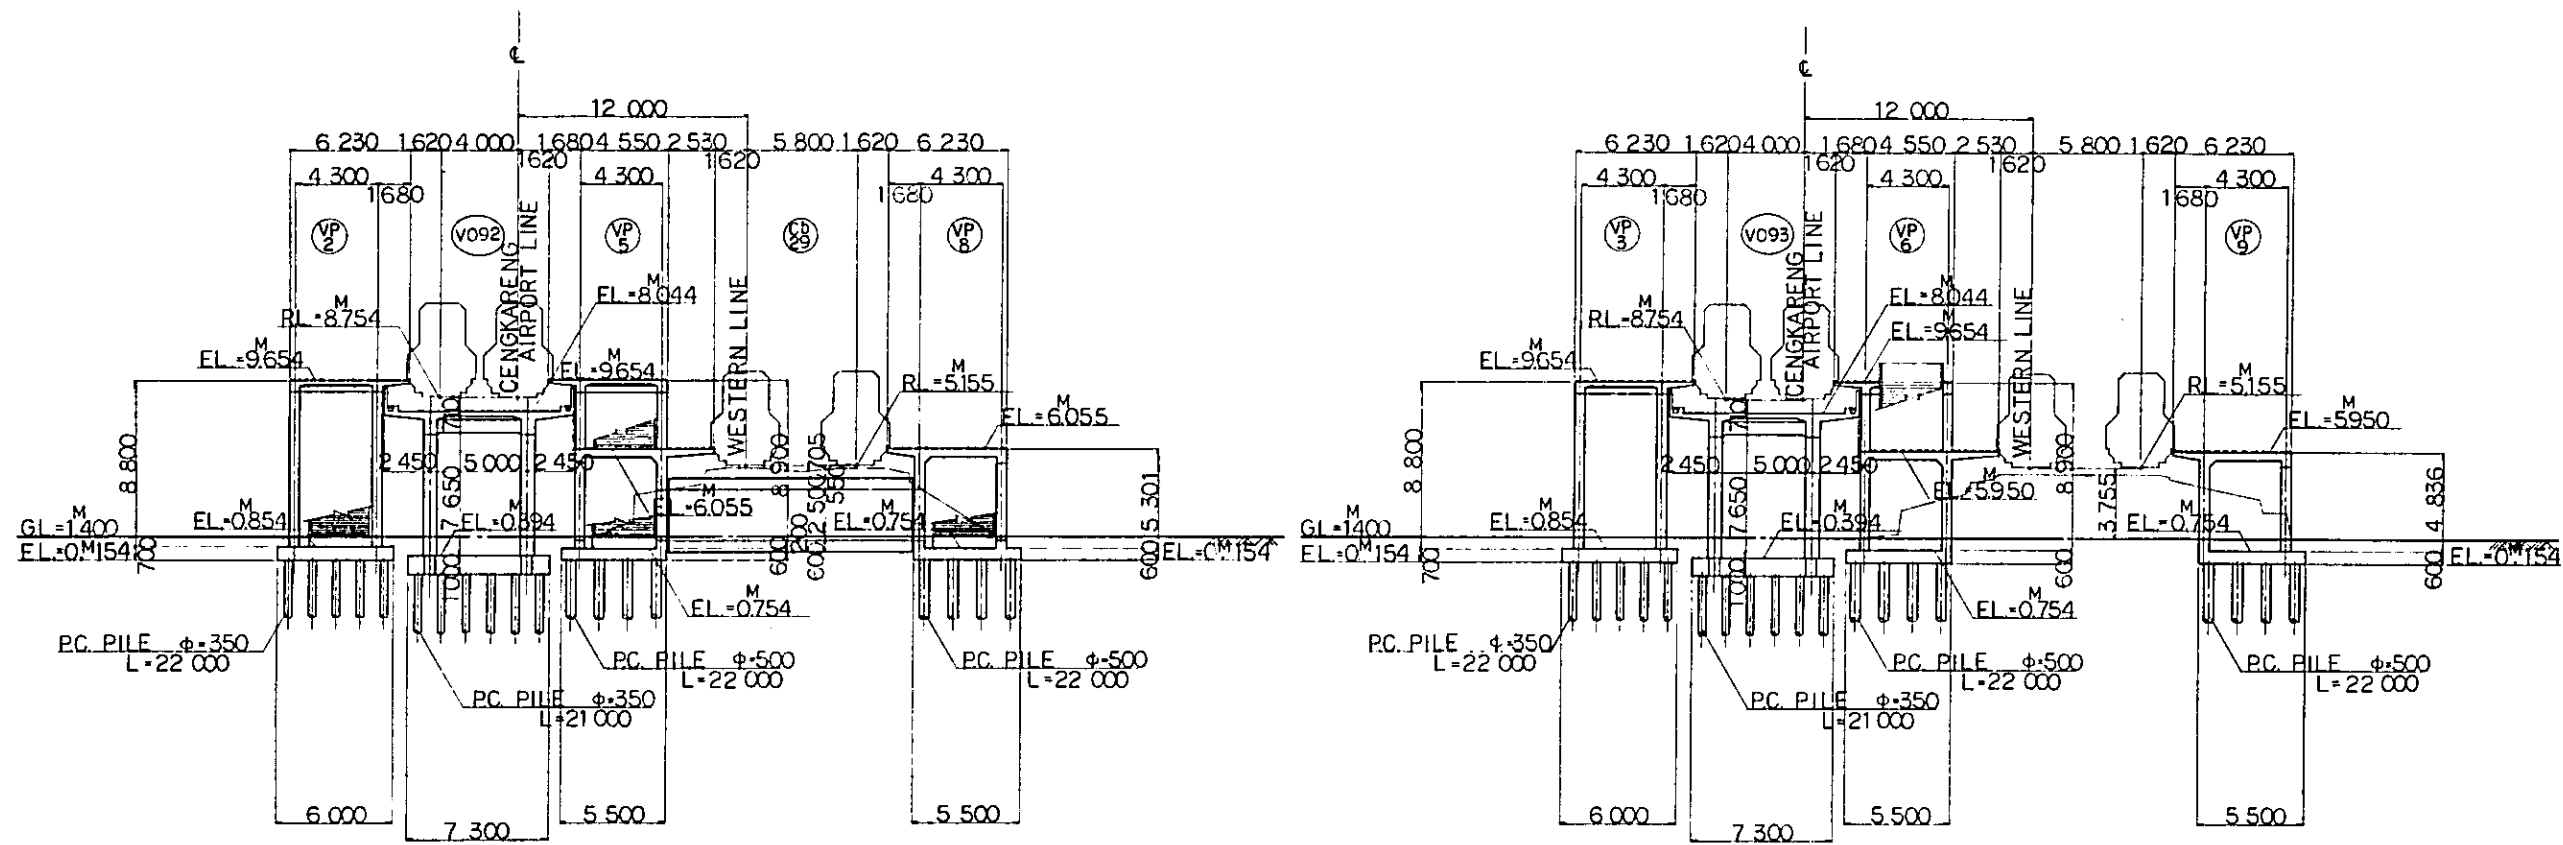
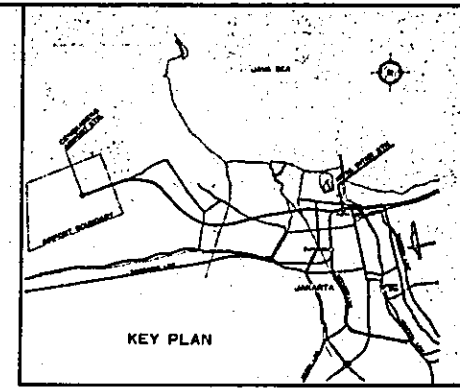
| DWG. No. | TITLE  | DWG. No. | TITLE |
|----------|--|----------|-------|
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NOTE:  
 1. ALL DIMENSIONS ARE SHOWN IN MILLIMETERS UNLESS OTHERWISE INDICATED



|  |             |          |       |         |          |           |
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| REPUBLIC OF INDONESIA<br>MINISTRY OF COMMUNICATIONS<br>DIRECTORATE GENERAL OF LAND TRANSPORT<br>AND INLAND WATERWAYS |             |          |       |         |          |           |
| NEW RAILWAY LINE FOR CENKARENG AIRPORT<br>CONSTRUCTION PROJECT   |             |          |       |         |          |           |
| JAPAN INTERNATIONAL COOPERATION AGENCY<br>(JICA)   |             |          |       |         |          |           |
| B  | 1AUG'84     | K.S.     | M.Y.  | K.A.    | K.M.     | M.K.      |
| A  | 15FEB'84    | K.S.     | M.Y.  | K.A.    | K.M.     | M.K.      |
| REVISIONS  | DATE        | DESIGNED | DRAWN | CHECKED | REVIEWED | SUBMITTED |
| KOTA INTAN STATION<br>GENERAL VIEW<br>(SHEET 1 OF 2)   |             |          |       |         |          |           |
| PACKAGE: I CIVIL AND ARCHITECTURAL WORK  |             |          |       |         |          |           |
| SCALE  | DRAWING NO: |          |       |         |          |           |
| 1:200  | CS-225      |          |       |         |          |           |



SECTION B (17<sup>M</sup>370<sup>M</sup>.000)

SECTION C (17<sup>M</sup>400<sup>M</sup>.000)

CROSS SECTION OF KOTA INTAN STATION

NOTE:  
1. ALL DIMENSIONS ARE SHOWN IN MILLIMETERS UNLESS OTHERWISE INDICATED

REPUBLIC OF INDONESIA  
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NEW RAILWAY LINE FOR CENGKARENG AIRPORT CONSTRUCTION PROJECT

JAPAN INTERNATIONAL COOPERATION AGENCY (JICA)

|   |            |    |    |    |    |    |
|---|------------|----|----|----|----|----|
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| A | 15 FEB '84 | KJ | my | KJ | KM | KK |


REVISIONS    DATE    DESIGNED    DRAWN    CHECKED    REVERED    SUBMITTED

KOTA INTAN STATION  
GENERAL VIEW  
(SHEET 2 OF 2)


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SCALE: 1:200      DRAWING NO: CS-226




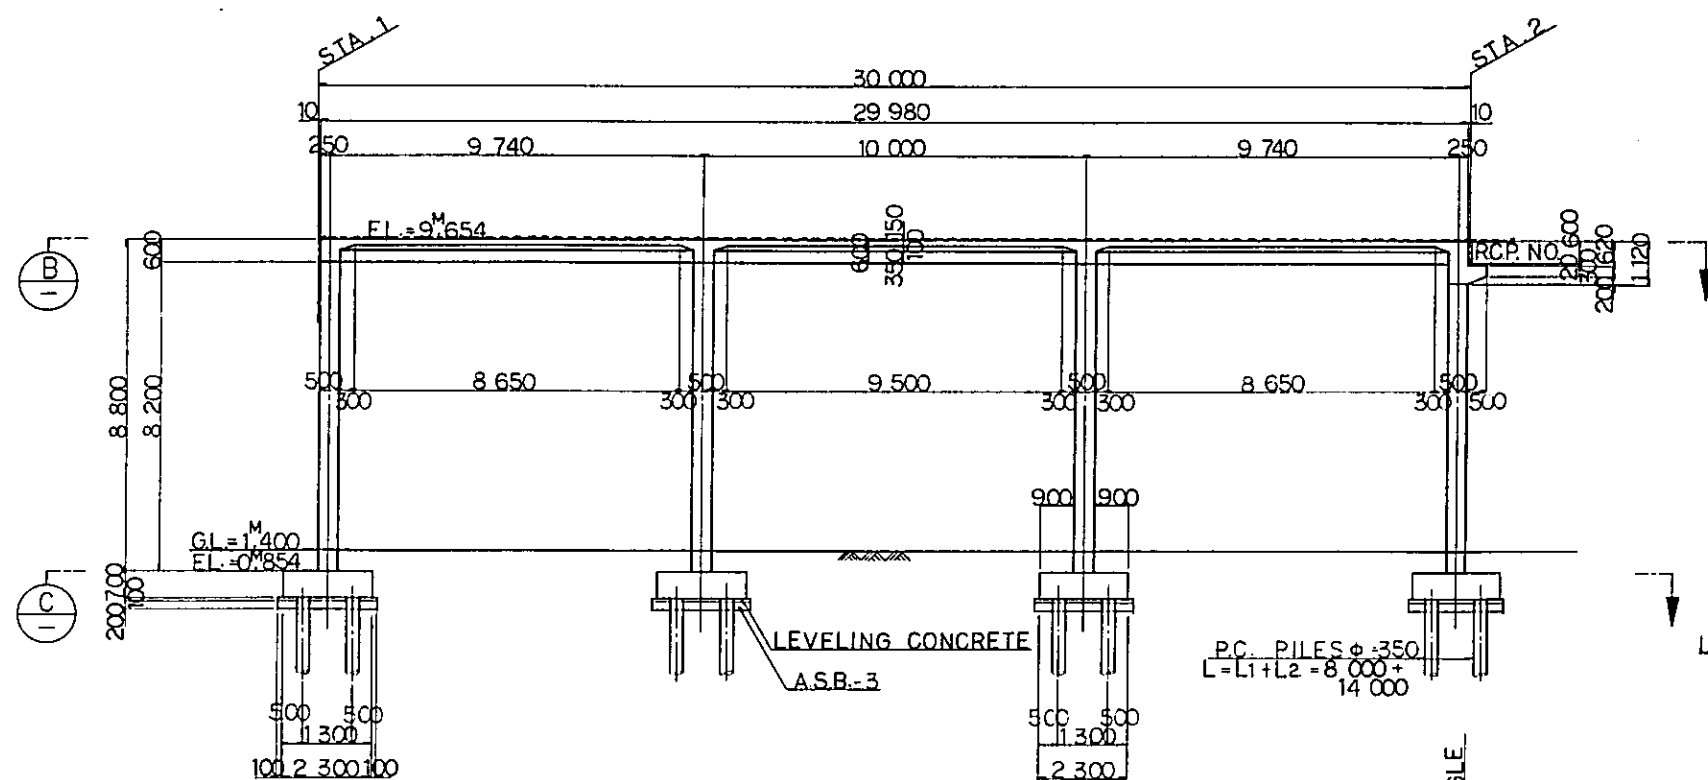


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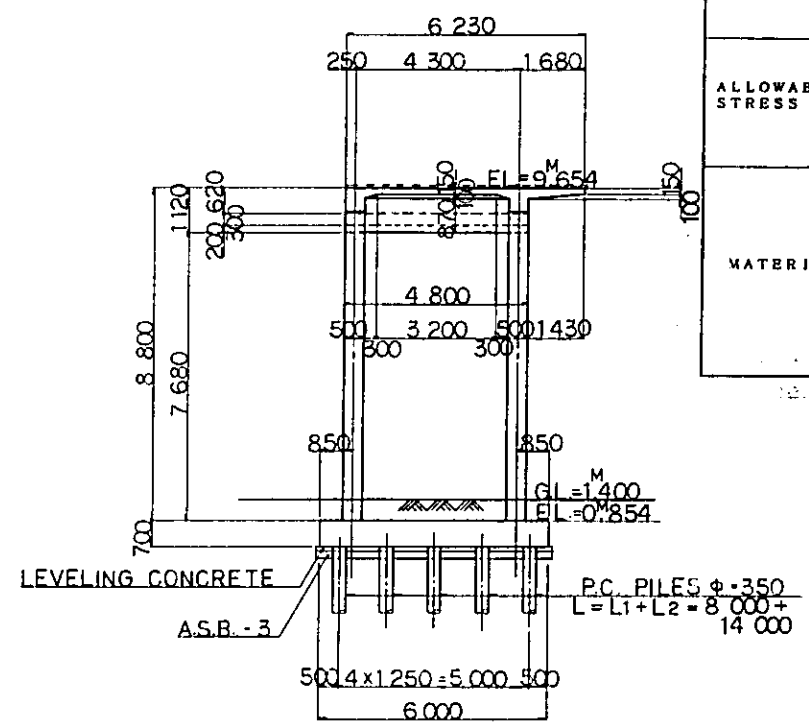
SECTION B

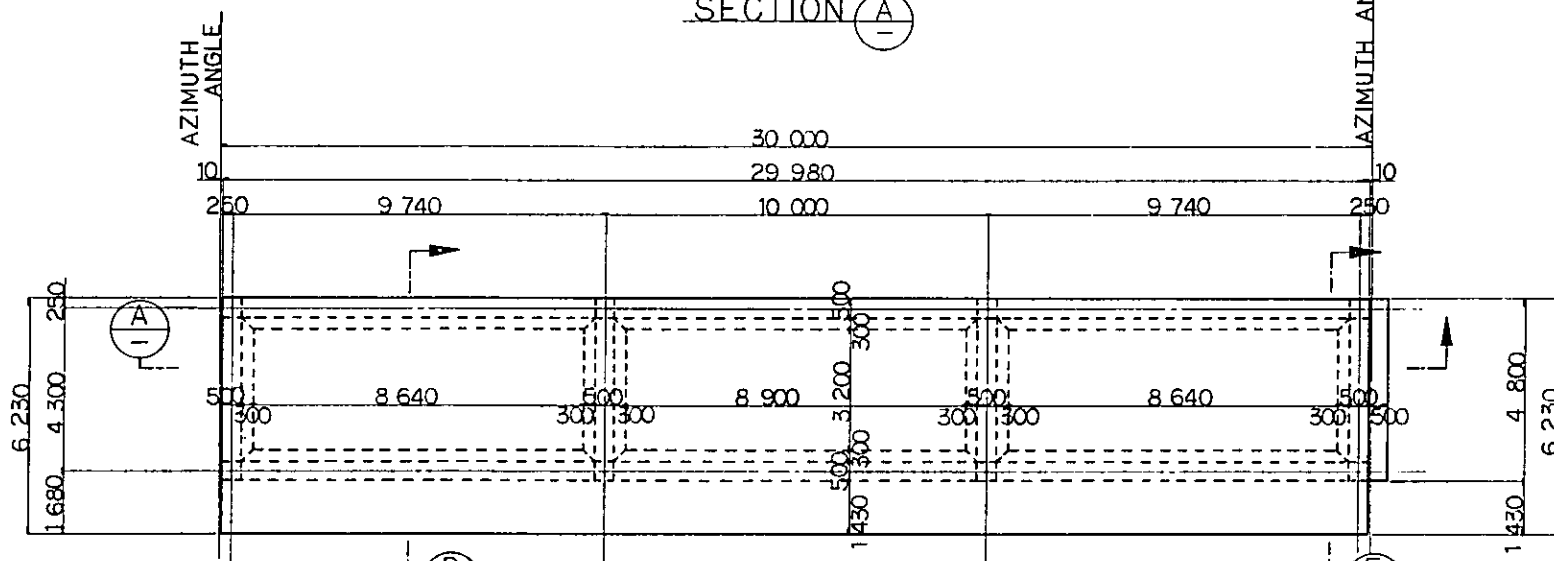

SECTION C

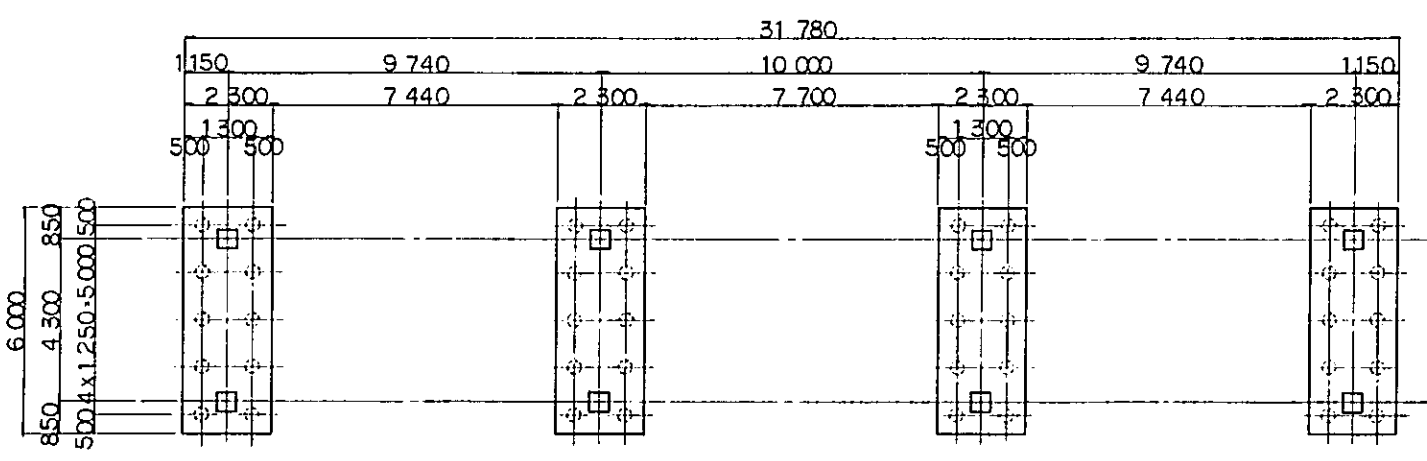

SECTION D

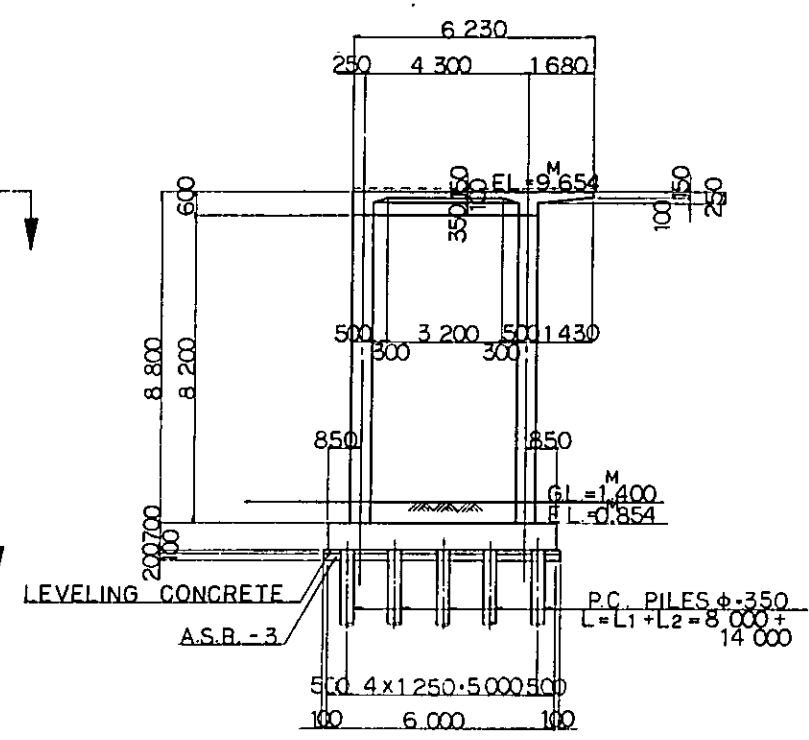

SECTION E

- NOTES :
1. ALL DIMENSIONS ARE SHOWN IN MILLIMETERS UNLESS OTHERWISE INDICATED
  2. REFERENCE DRAWING FOR BAR ARRANGEMENT: CS-229~233.
  3. TYPES OF PC. PILE
- 

DESIGN CRITERIA

|                  |                                      |  |
|------------------|--------------------------------------|--|
| DESIGN LOAD      | TRAIN LOAD                           | EQUIVALENT TO KS-16  |
|                  | SEISMIC EFFECT                       | IN HORIZONTAL DIRECTION $K_h=0.1$<br>IN VERTICAL DIRECTION $K_h=0.1$ |
| ALLOWABLE STRESS | REINFORCING BAR                      | ALLOWABLE TENSILE STRESS 1800 kg/cm <sup>2</sup>                     |
|                  | CONCRETE                             | ALLOWABLE COMPRESSIVE STRESS 90 kg/cm <sup>2</sup>                   |
| MATERIAL         | TYPE OF REINFORCING BAR              | SD-38 BAP  |
|                  | CONCRETE OF DESIGN CRITERIA STRENGTH | $\sigma_{ck}=240 \text{ kg/cm}^2$                                    |
|                  | MAX SIZE OF COARSE AGGREGATE         | 25 mm  |

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JAPAN INTERNATIONAL COOPERATION AGENCY (JICA)

|           |          |          |       |         |          |           |
|-----------|----------|----------|-------|---------|----------|-----------|
| B         | 1 AUG 84 | K.V.     | M.Y.  | K.S.    | K.M.     | M.K.      |
| A         | 1 FEB 84 | K.V.     | M.Y.  | K.S.    | K.M.     | M.K.      |
| REVISIONS | DATE     | DESIGNED | DRAWN | CHECKED | REVIEWED | SUBMITTED |



PLATFORM VPI, VP3  
GENERAL VIEW

PACKAGE: I CIVIL AND ARCHITECTURAL WORK

SCALE: 1:100  
DRAWING NO: CS-227

DIMENSION SCHEDULE



|      | STATION                                       | AZIMUTH ANGLE | RCP NO. |
|------|---|---------------|---------|
| VP 1 | STA. 1 17 <sup>KM</sup> 310 <sup>M</sup> .000 | 345° 30' 45"  | —       |
|      | STA. 2 17 <sup>KM</sup> 340 <sup>M</sup> .000 | '             | RCP 1   |
| VP 3 | STA. 2 17 <sup>KM</sup> 380 <sup>M</sup> .000 | 345° 30' 45"  | RCP. 2  |
|      | STA. 1 17 <sup>KM</sup> 420 <sup>M</sup> .000 | '             | —       |

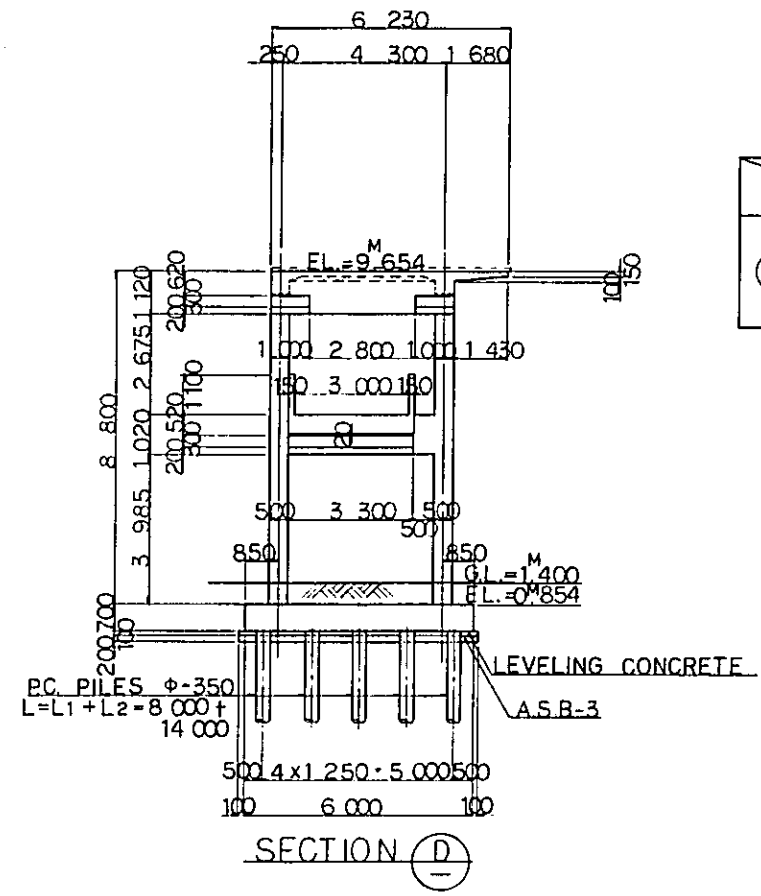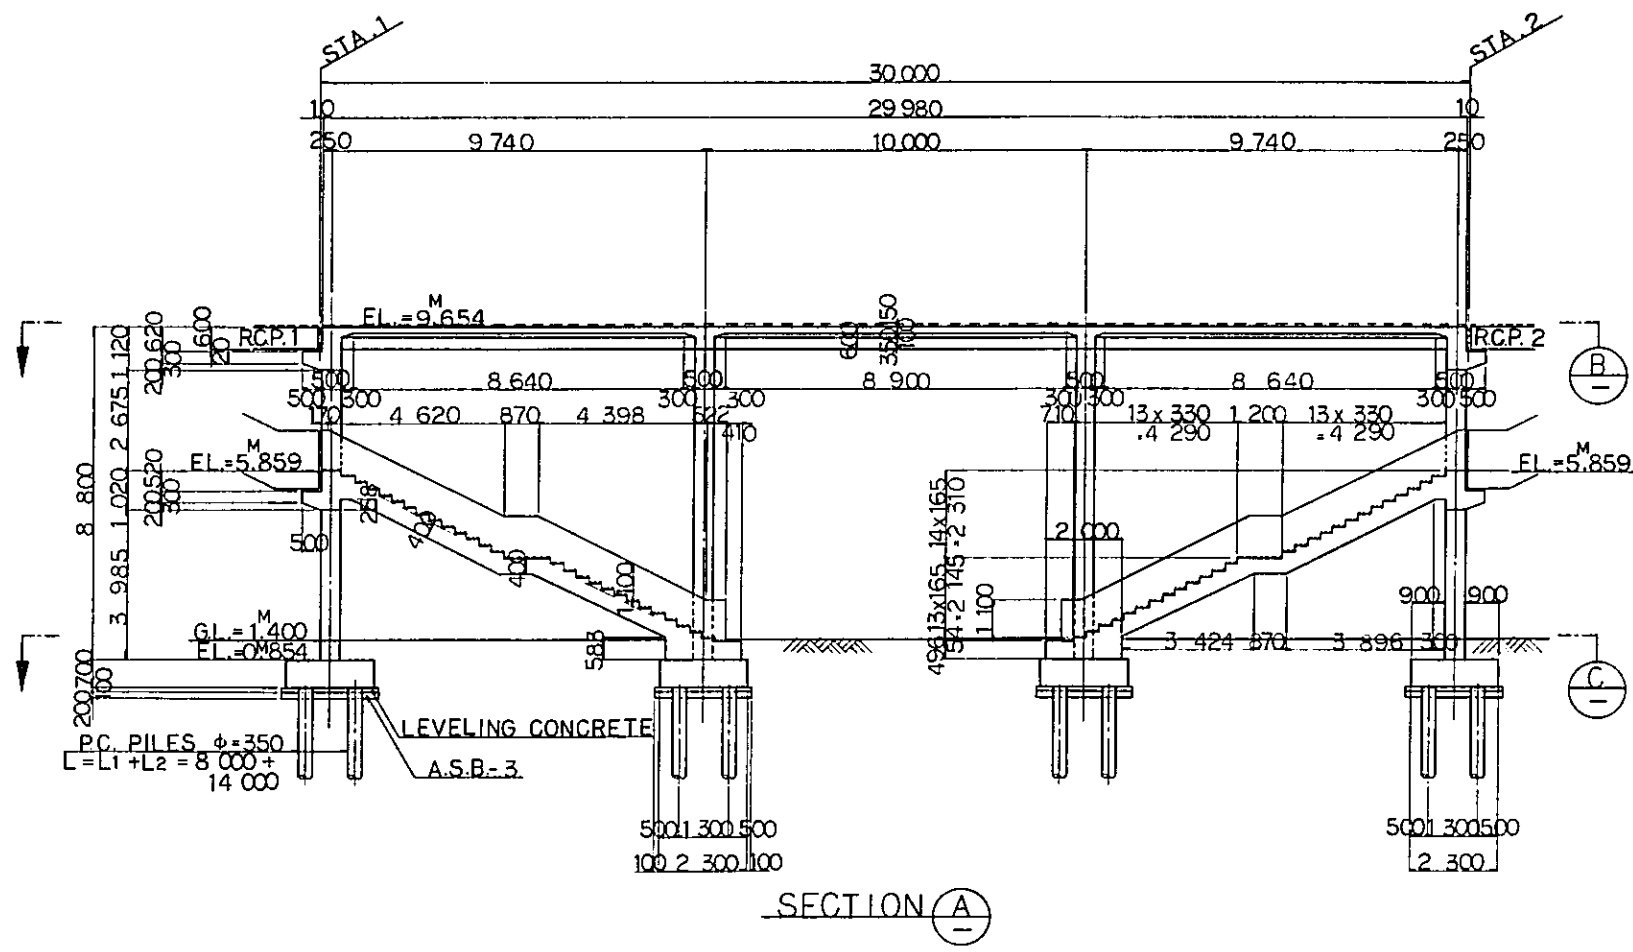

**DIMENSION SCHEDULE**

|      | STATION                                      | AZIMUTH ANGLE |
|------|--|---------------|
| VP 2 | STA.1 17 <sup>KM</sup> 350 <sup>M</sup> .000 | 345° 30' 45"  |
|      | STA.2 17 <sup>KM</sup> 380 <sup>M</sup> .000 | "             |

- NOTES :**
- ALL DIMENSIONS ARE SHOWN IN MILLIMETERS UNLESS OTHERWISE INDICATED
  - REFERENCE DRAWING FOR BAR ARRANGEMENT: CS-229~234.
  - TYPES OF P.C. PILE
- 

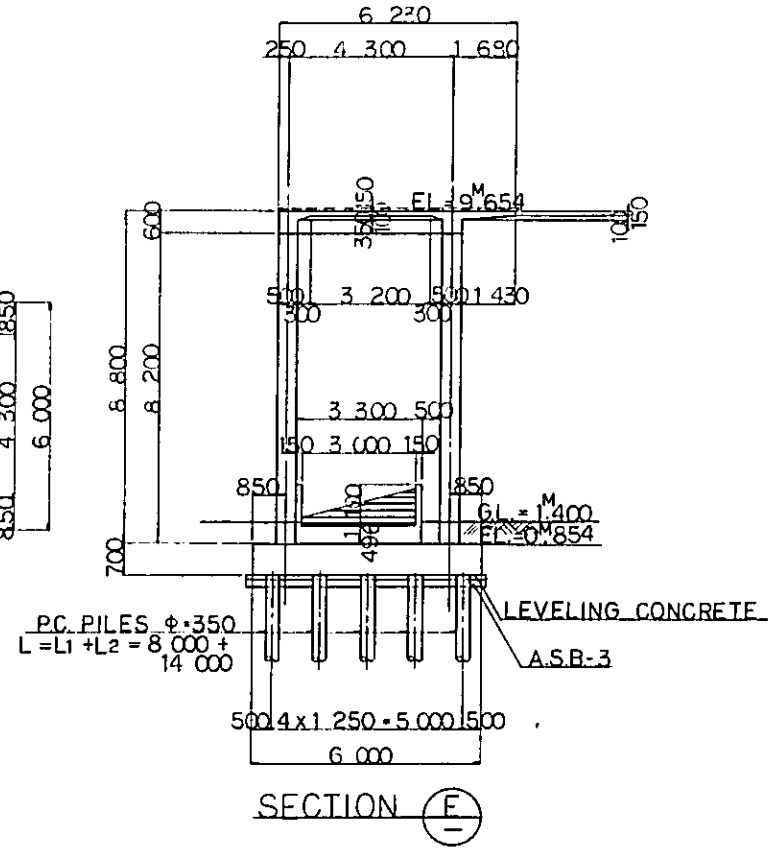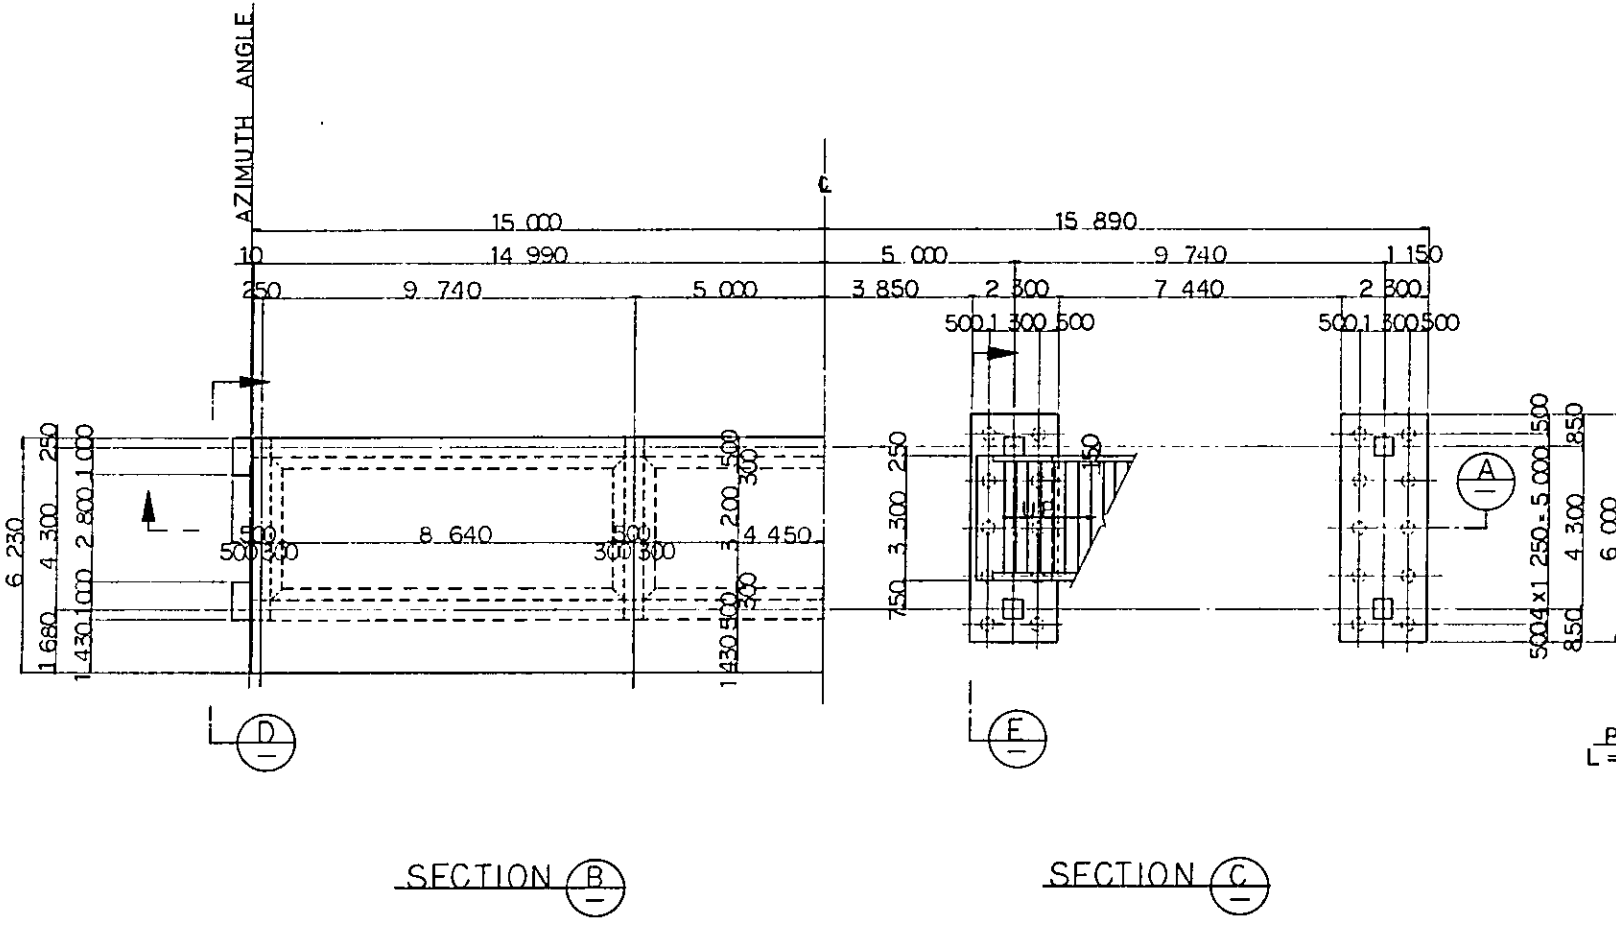

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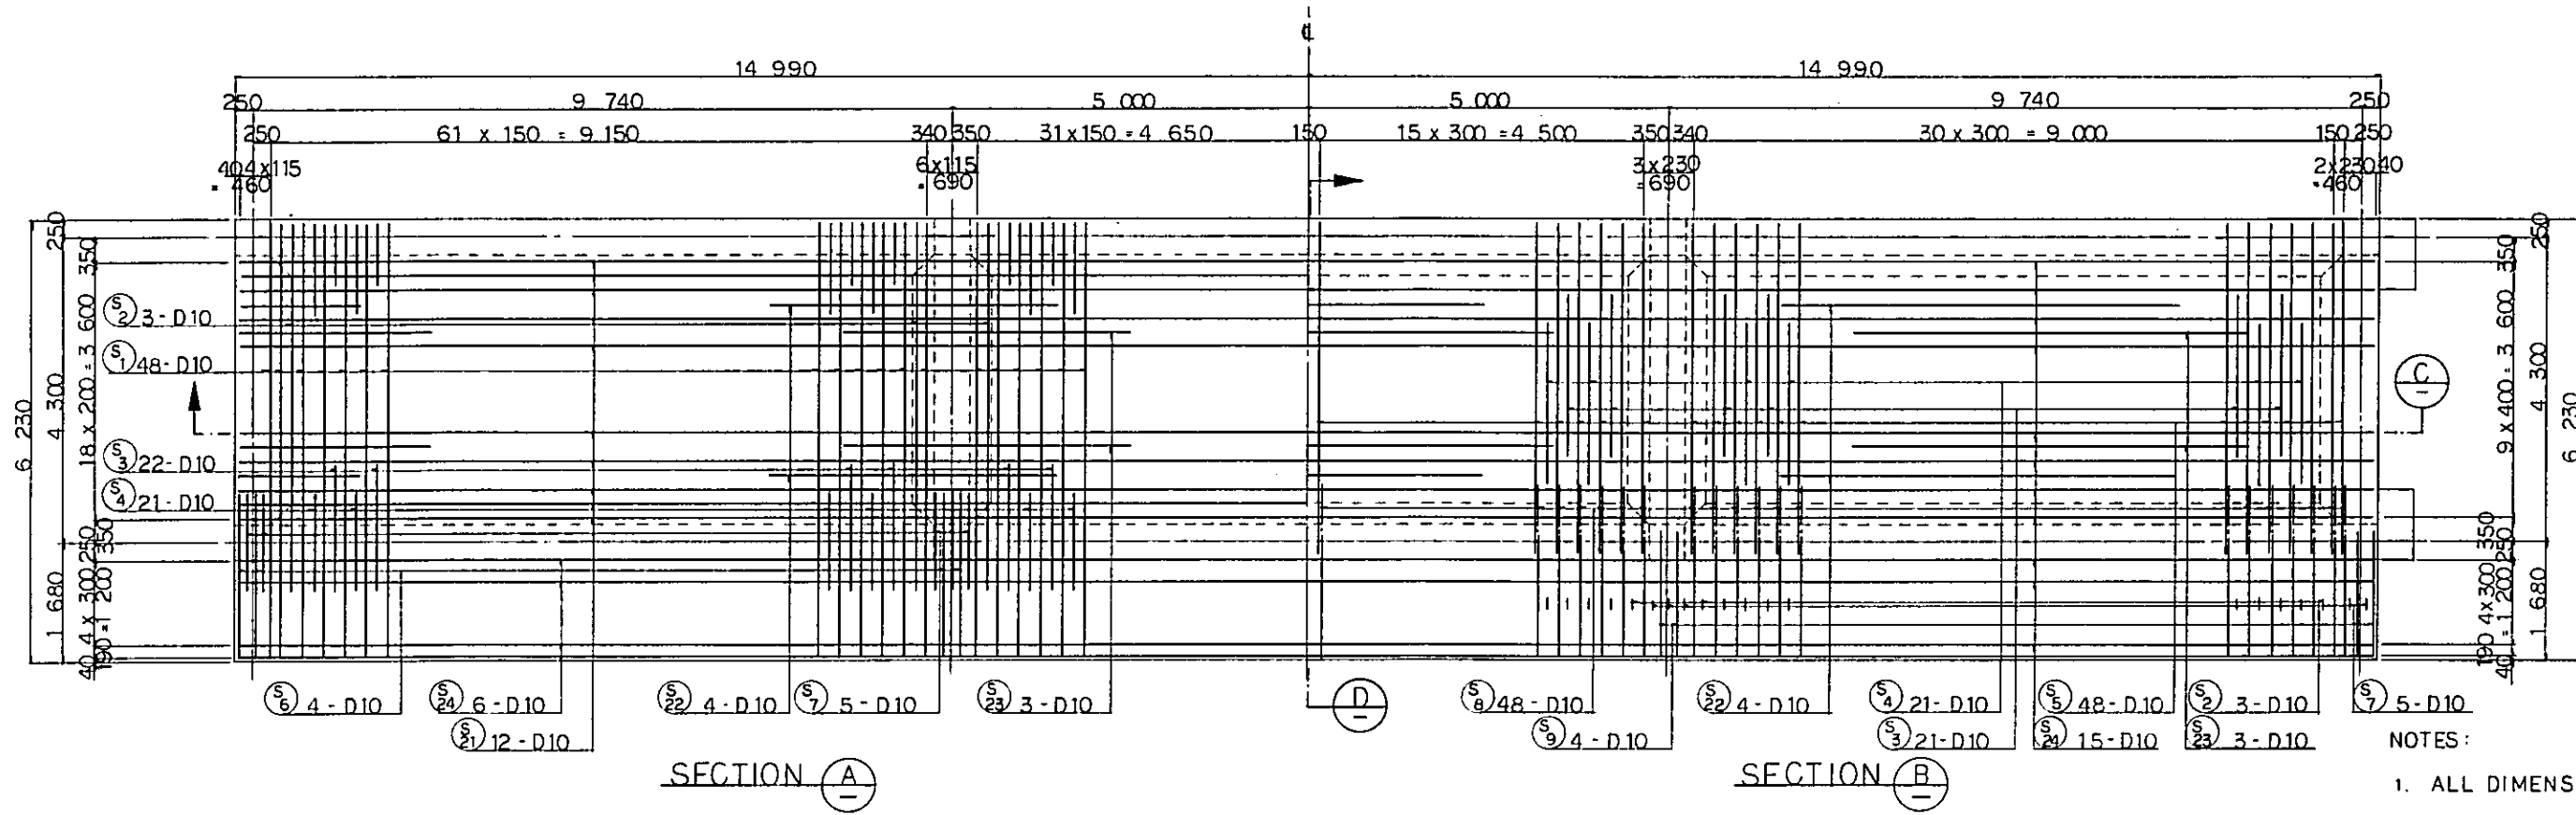
JAPAN INTERNATIONAL COOPERATION AGENCY  
(JICA)

| REVISIONS | DATE     | DESIGNED | DRAWN | CHECKED | REVIEWED | SUBMITTED |
|-----------|----------|----------|-------|---------|----------|-----------|
| E         | 1AUG/84  | K.J      | m.y   | K.A     | K.M      | m.K       |
| A         | 15FEB/84 | K.J      | m.y   | F.J     | K.M      | m.K       |






**PLATFORM VP2  
GENERAL VIEW**

PACKAGE: I CIVIL AND ARCHITECTURAL WORK


SCALE: 1:100      DRAWING NO: CS-228







- NOTES:
1. ALL DIMENSIONS ARE SHOWN IN MILLIMETERS UNLESS OTHERWISE INDICATED
  2. REFERENCE DRAWING FOR GENERAL VIEW : CS-228.

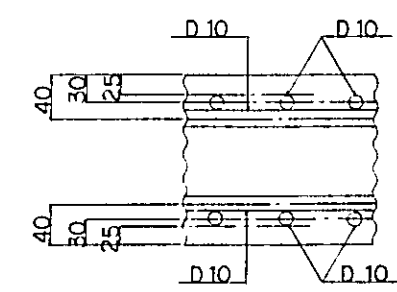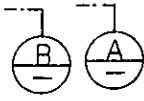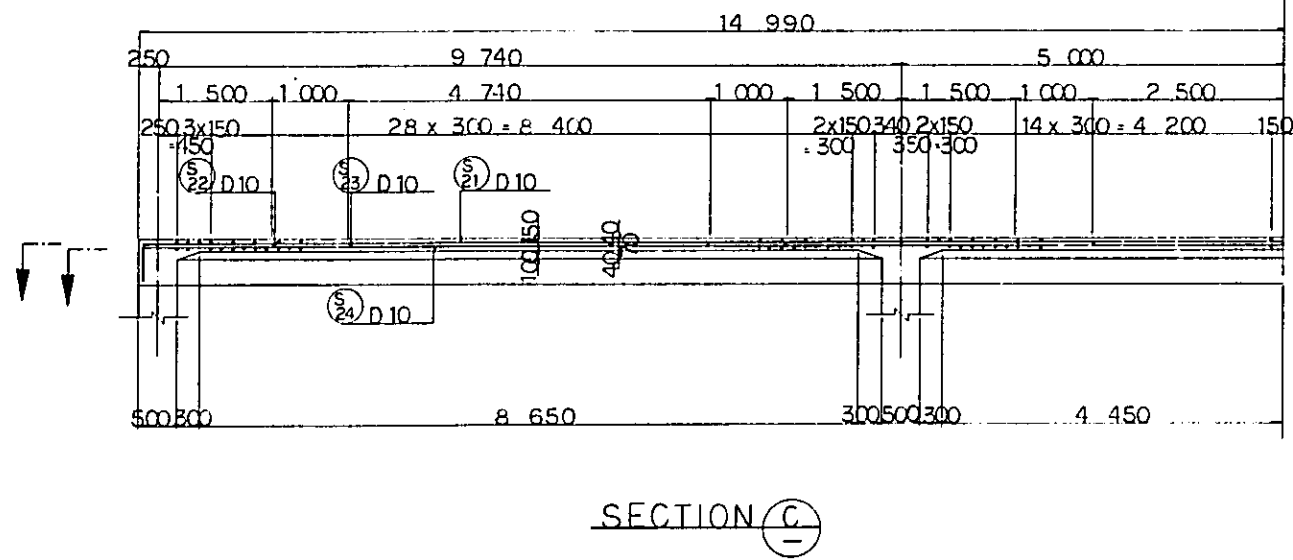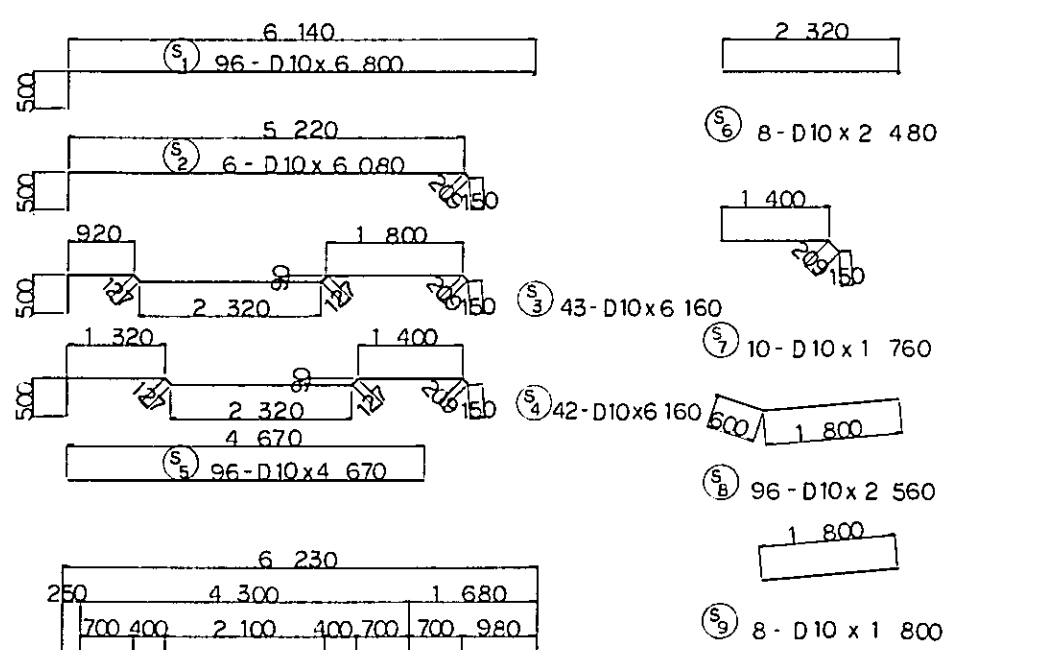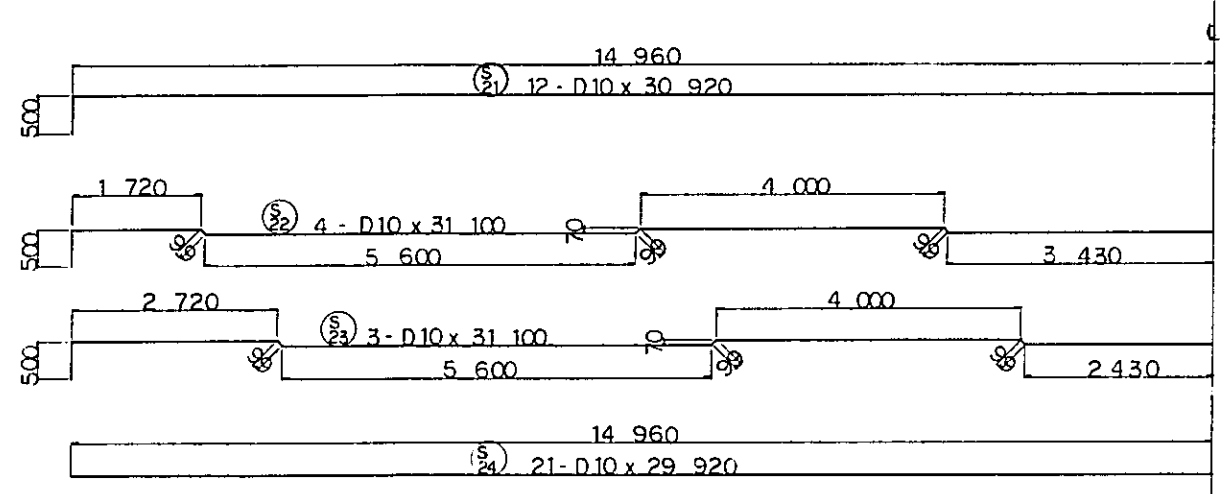

|   |            |                     |       |         |          |           |
|---|------------|---------------------|-------|---------|----------|-----------|
| REPUBLIC OF INDONESIA<br>MINISTRY OF COMMUNICATIONS,<br>DIRECTORATE GENERAL OF LAND TRANSPORT<br>AND INLAND WATERWAYS |            |                     |       |         |          |           |
| NEW RAILWAY LINE FOR CENGKARENG AIRPORT<br>CONSTRUCTION PROJECT   |            |                     |       |         |          |           |
| JAPAN INTERNATIONAL COOPERATION AGENCY<br>(JICA)  |            |                     |       |         |          |           |
| B   | 1 AUG '84  | K.J.                | m.y.  | K.A.    | K.M.     | K.K.      |
| A   | 11 FEB '84 | K.J.                | m.y.  | K.A.    | K.M.     | K.K.      |
| REVISIONS   | DATE       | DESIGNED            | DRAWN | CHECKED | REVIEWED | SUBMITTED |
| PLATFORM VP2<br>BAR ARRANGEMENT<br>(SHEET 1 OF 6)   |            |                     |       |         |          |           |
| PACKAGE: I CIVIL AND ARCHITECTURAL WORK   |            |                     |       |         |          |           |
| SCALE: 1:50   |            | DRAWING NO.: CS-229 |       |         |          |           |












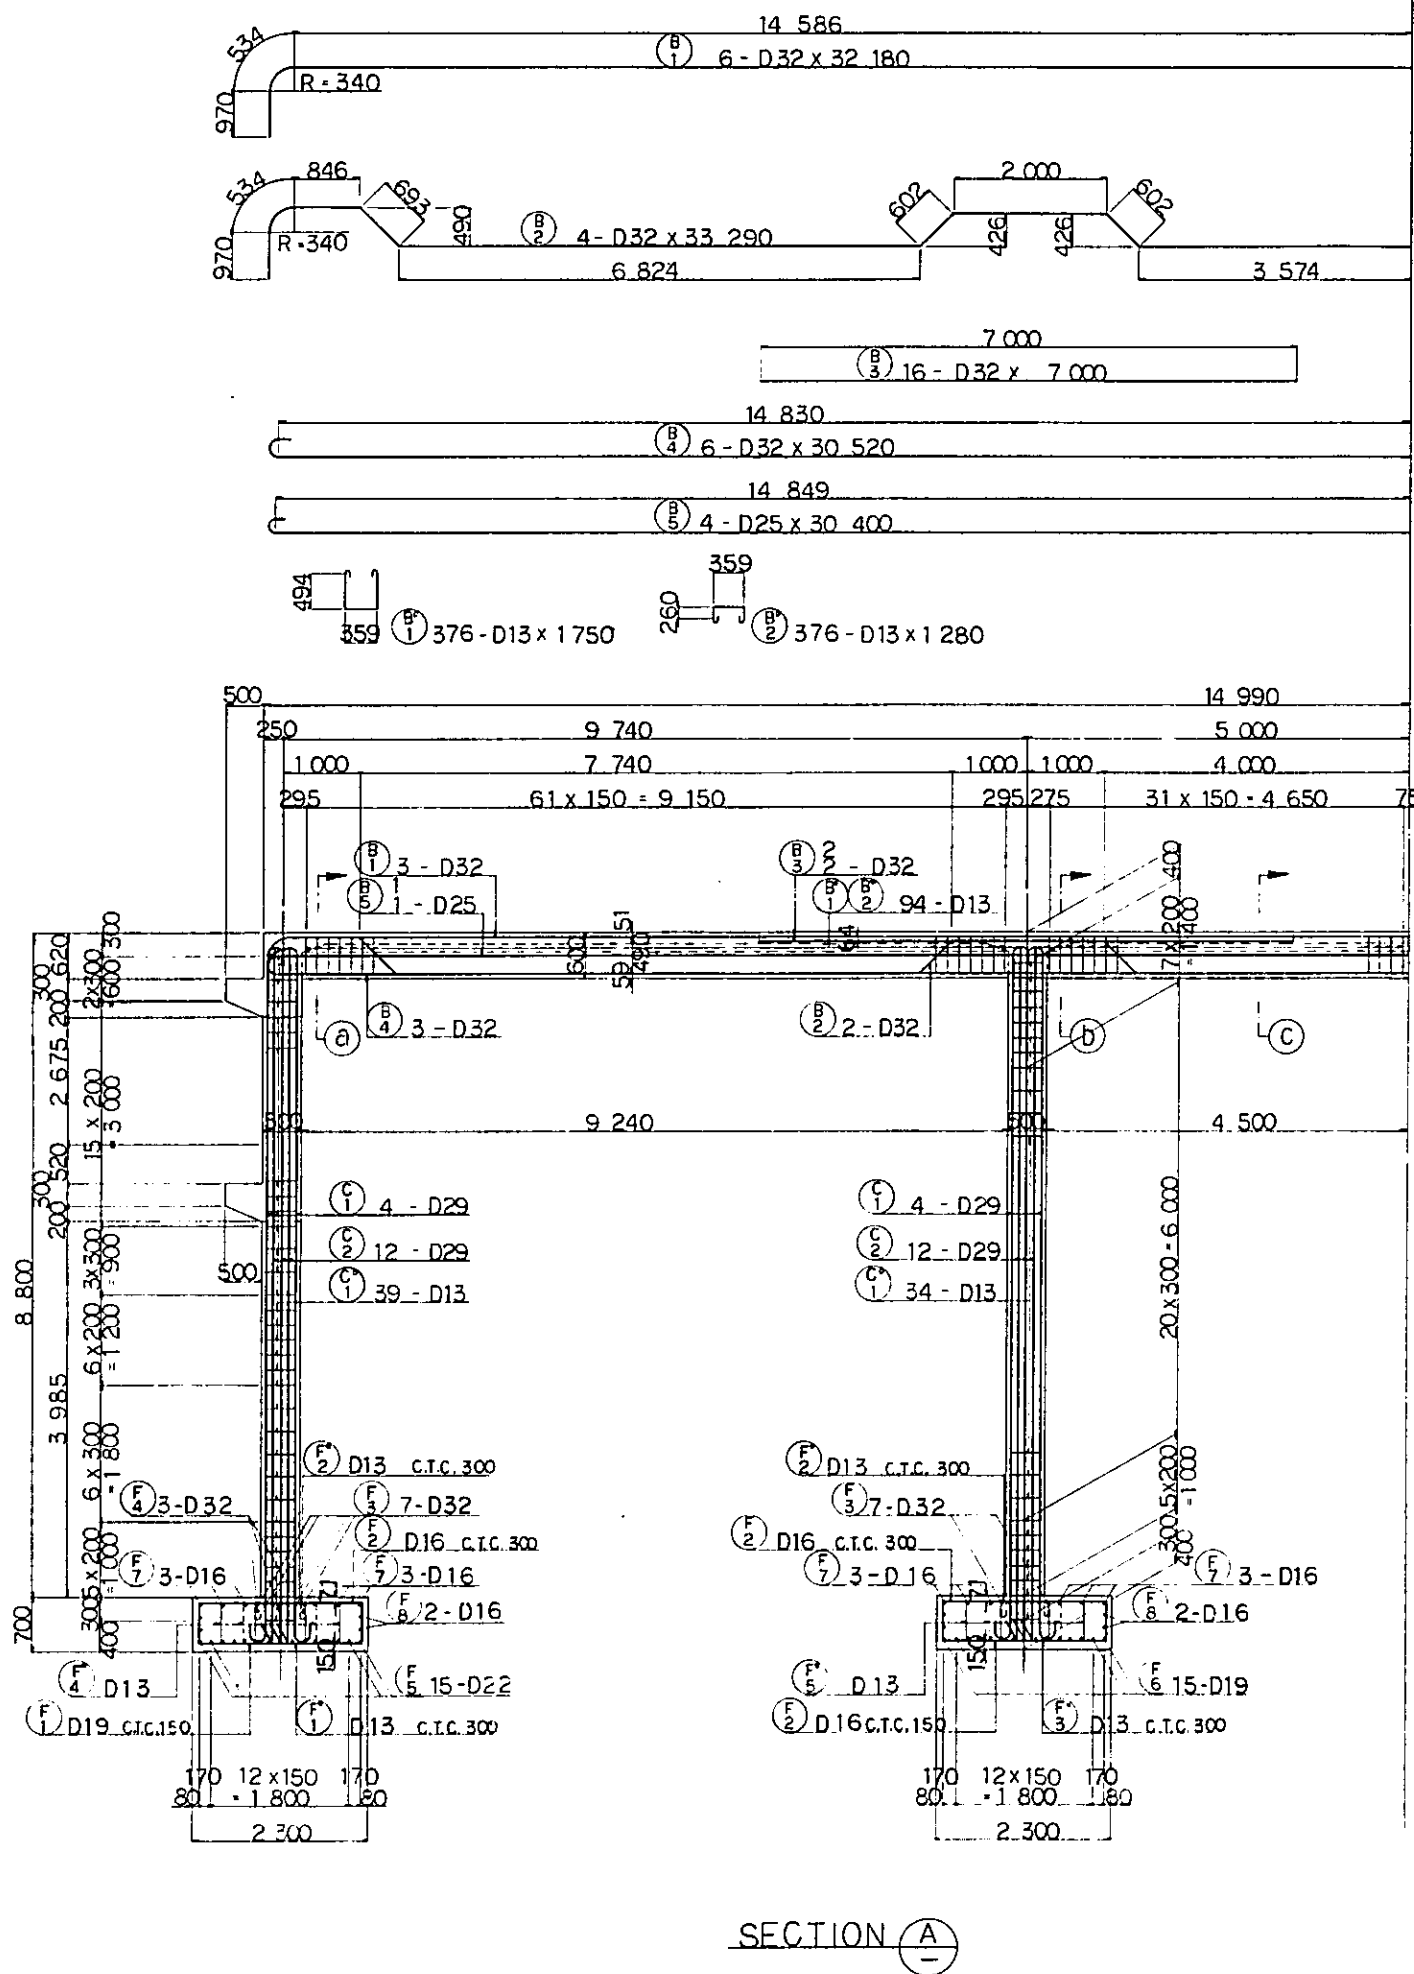


SECTION A-A

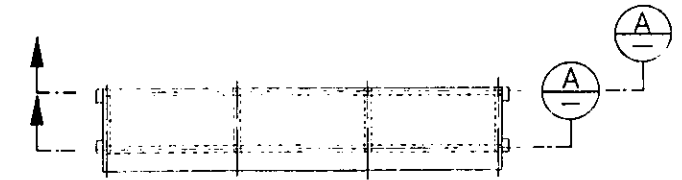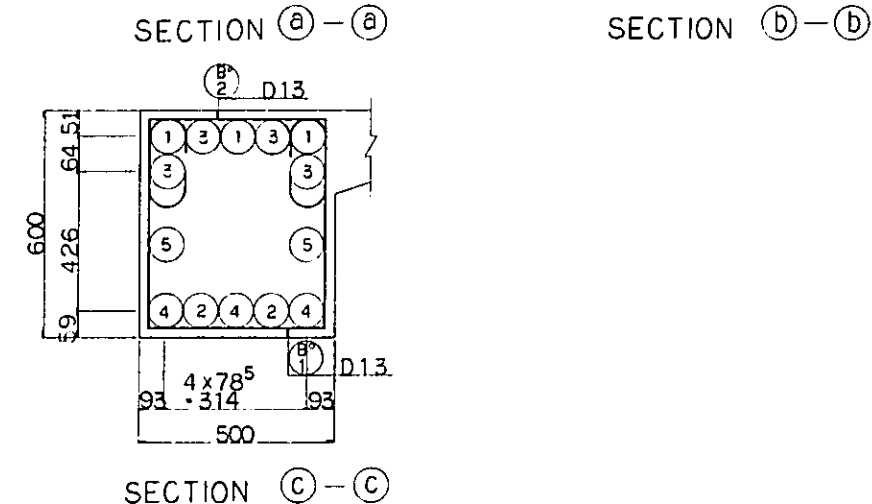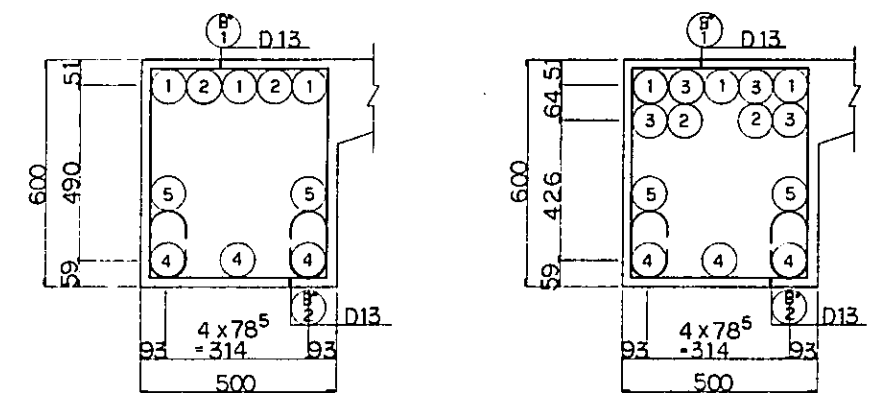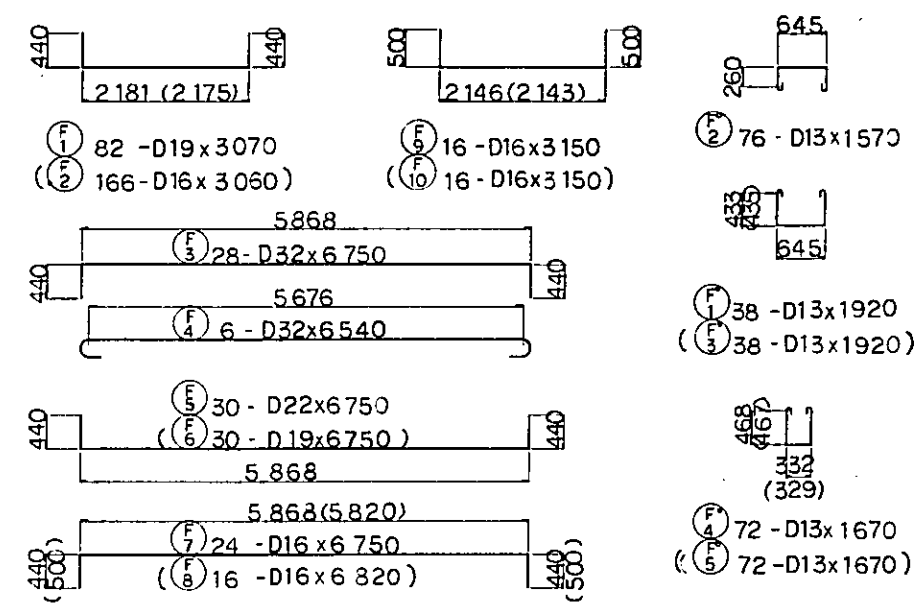


- NOTES:
1. ALL DIMENSIONS ARE SHOWN IN MILLIMETERS UNLESS OTHERWISE INDICATED
  2. REFERENCE DRAWING FOR GENERAL VIEW : CS-228.

|  |           |          |       |                      |         |           |  |
|--|-----------|----------|-------|----------------------|---------|-----------|--|
| REPUBLIC OF INDONESIA  |           |          |       |                      |         |           |  |
| MINISTRY OF COMMUNICATIONS                                   |           |          |       |                      |         |           |  |
| DIRECTORATE GENERAL OF LAND TRANSPORT AND INLAND WATERWAYS   |           |          |       |                      |         |           |  |
| NEW RAILWAY LINE FOR CENGKARENG AIRPORT CONSTRUCTION PROJECT |           |          |       |                      |         |           |  |
| JAPAN INTERNATIONAL COOPERATION AGENCY (JICA)                |           |          |       |                      |         |           |  |
| REVISED  | DATE      | DESIGNED | DRAWN | CHECKED              | REVISED | SUBMITTED |  |
| R  | 1 AUG '84 | K.B      | m.y   | K.A                  | K.M     | K.K       |  |
| 9  | FEB '85   | K.B      | m.y   | K.A                  | K.M     | K.K       |  |
| PLATFORM VP2<br>BAR ARRANGEMENT<br>(SHEET 2 OF 6)            |           |          |       |                      |         |           |  |
| PACKAGE : I CIVIL AND ARCHITECTURAL WORK                     |           |          |       |                      |         |           |  |
| SCALE : 1 : 50   |           |          |       | DRAWING NO. : CS-230 |         |           |  |

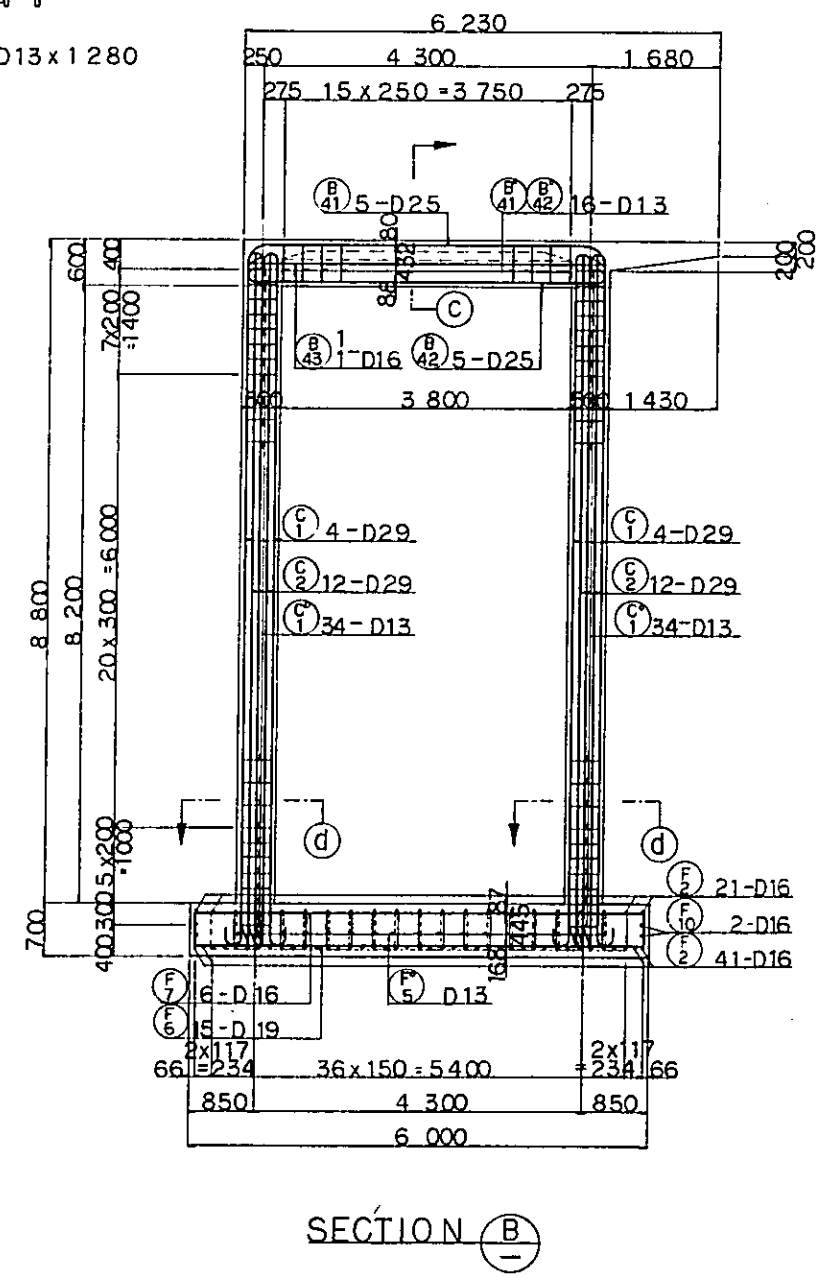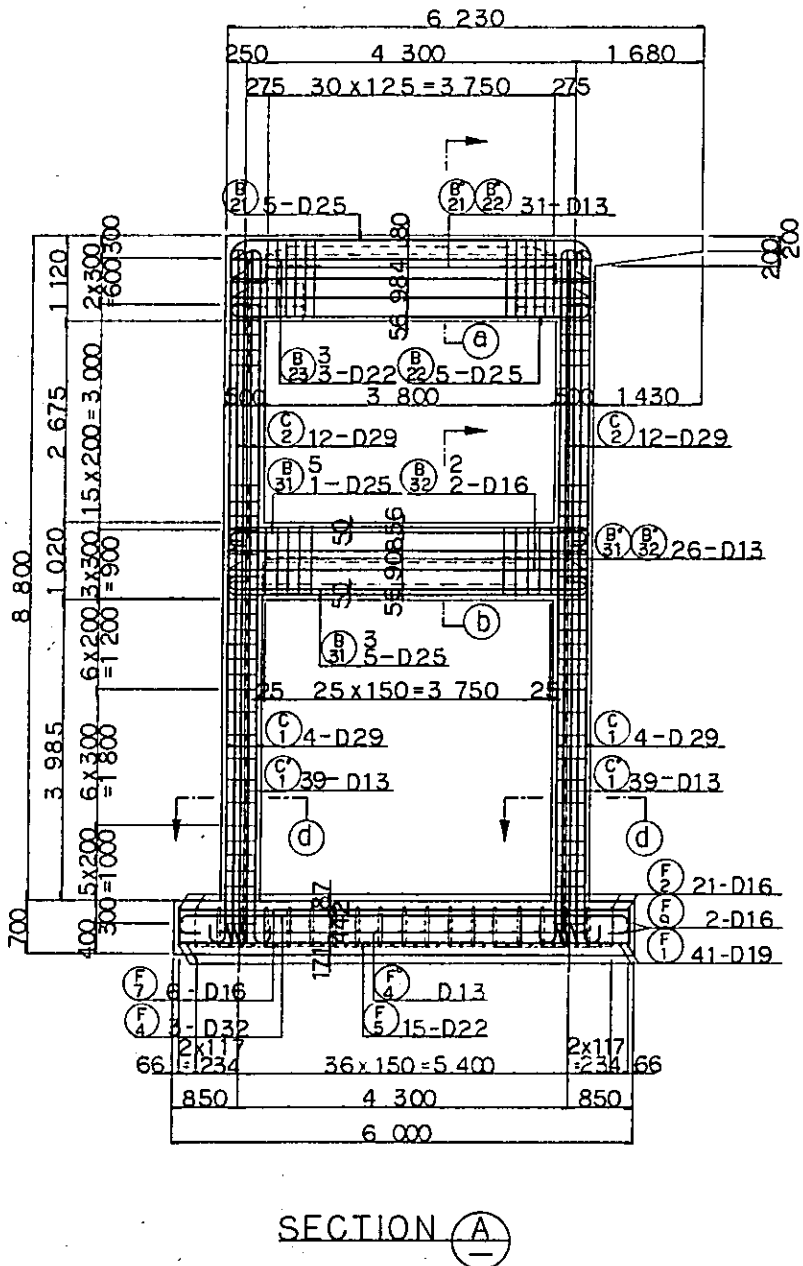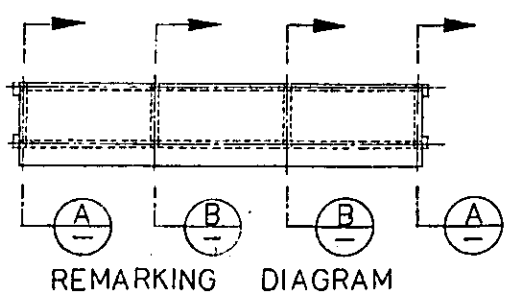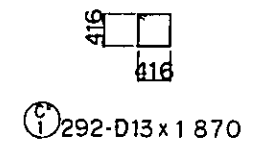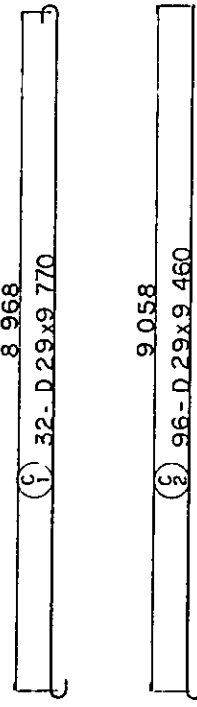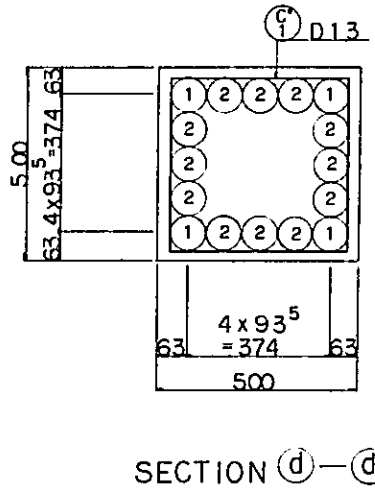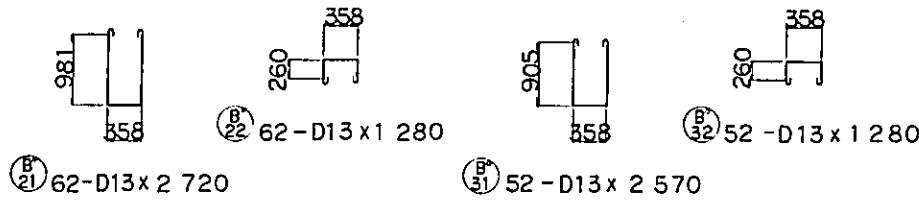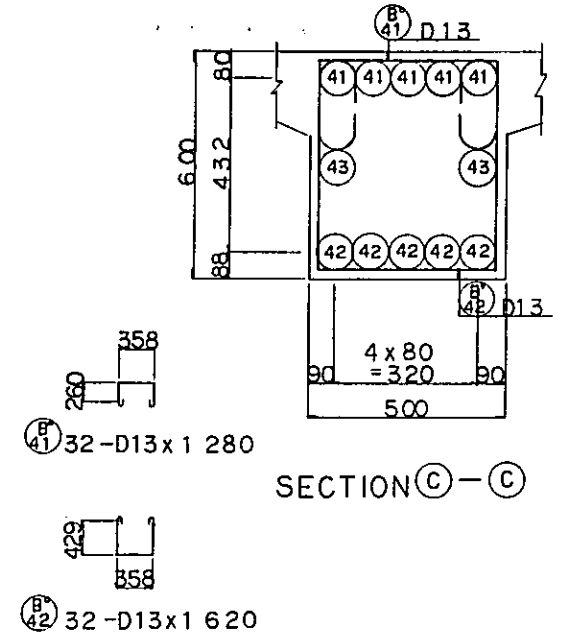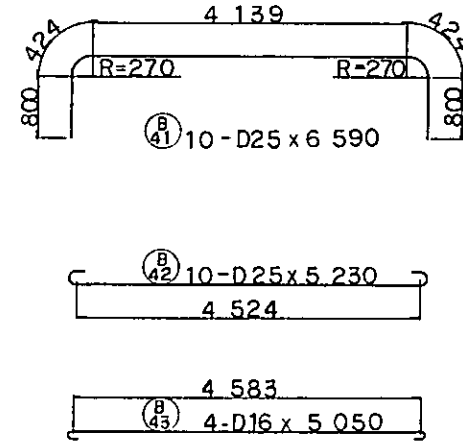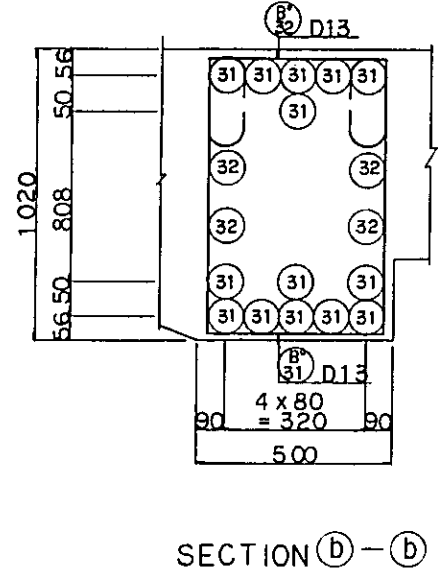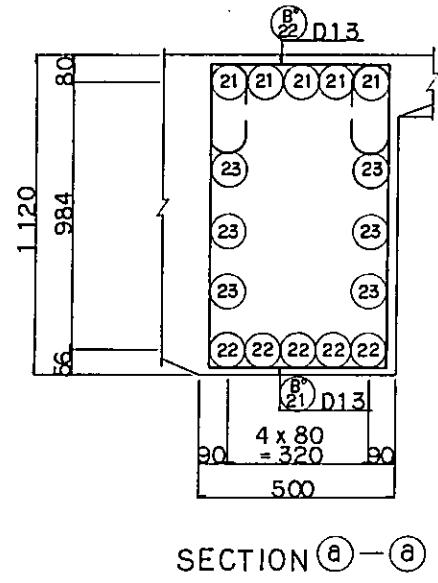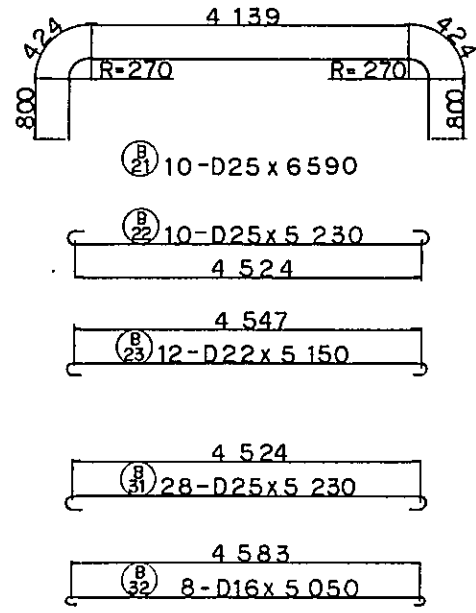


NOTES:  
 1. ALL DIMENSIONS ARE SHOWN IN MILLIMETERS UNLESS OTHERWISE INDICATED  
 2. REFERENCE DRAWING FOR GENERAL VIEW : CS-228.

|   |                     |          |       |         |          |           |
|---|---------------------|----------|-------|---------|----------|-----------|
| REPUBLIC OF INDONESIA<br>MINISTRY OF COMMUNICATIONS<br>DIRECTORATE GENERAL OF LAND TRANSPORT AND INLAND WATERWAYS |                     |          |       |         |          |           |
| NEW RAILWAY LINE FOR CENGKARENG AIRPORT CONSTRUCTION PROJECT  |                     |          |       |         |          |           |
| JAPAN INTERNATIONAL COOPERATION AGENCY (JICA)   |                     |          |       |         |          |           |
| B   | 1AUG/84             | K.Y.     | M.Y.  | K.A.    | K.M.     | K.K.      |
| A   | 10FEB/84            | K.Y.     | M.Y.  | K.A.    | K.M.     | K.K.      |
| REVISIONS   | DATE                | DESIGNED | DRAWN | CHECKED | REVIEWED | SUBMITTED |
| PLATFORM VP2<br>BAR ARRANGEMENT<br>(SHEET 3 OF 6)   |                     |          |       |         |          |           |
| PACKAGE: I CIVIL AND ARCHITECTURAL WORK   |                     |          |       |         |          |           |
| SCALE: 1:50   | DRAWING NO.: CS-231 |          |       |         |          |           |

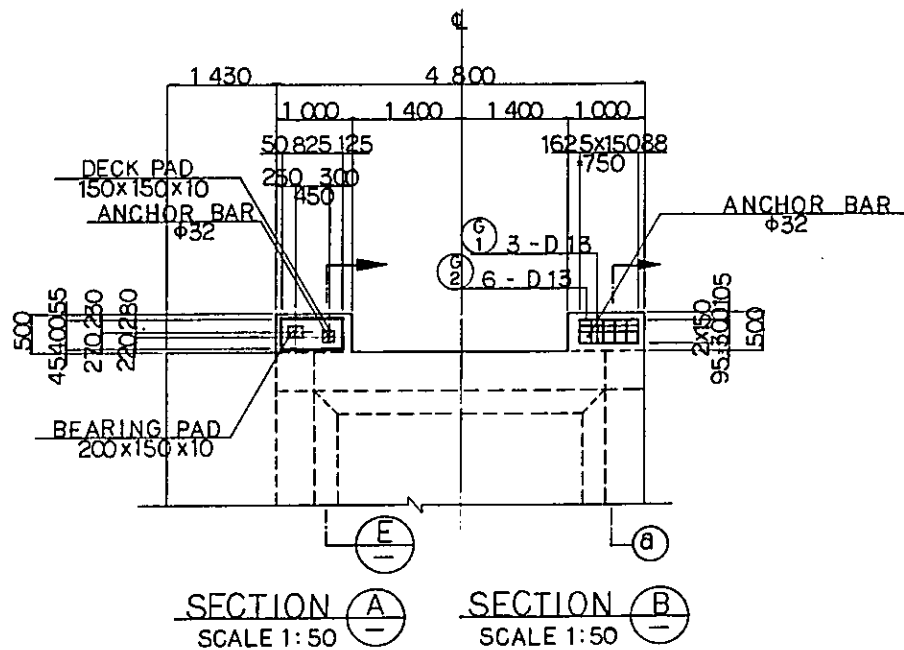


SECTION A-A  
SCALE 1:50

SECTION B-B  
SCALE 1:50

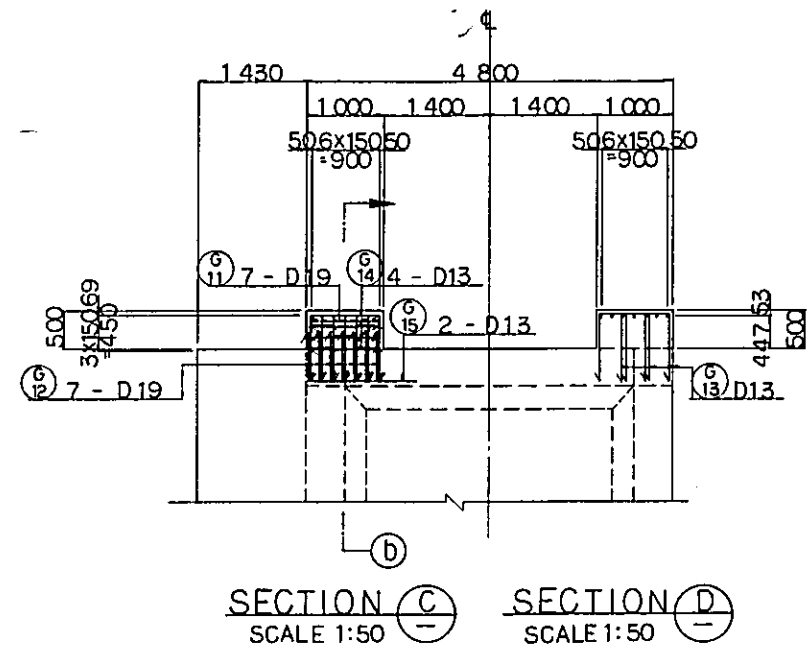


SECTION C-C  
SCALE 1:50


SECTION D-D  
SCALE 1:50

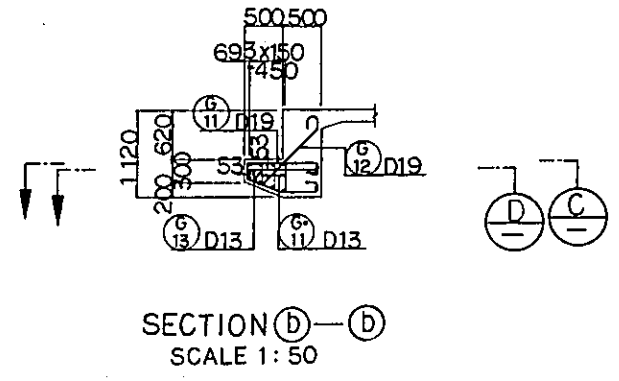


SECTION B-B-D  
SCALE 1:50

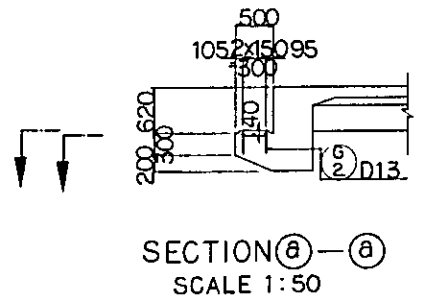


SECTION A-A-A  
SCALE 1:50

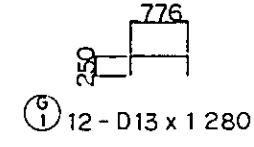


G1 12-D13 x 1 280

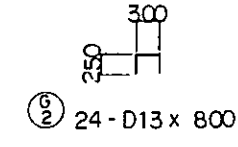

G2 24-D13 x 800

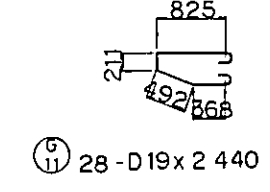


G11 28-D19 x 2 440

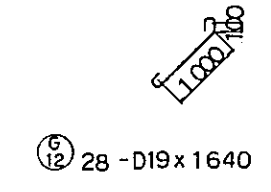


G12 28-D19 x 1 640


NOTES:  
1. ALL DIMENSIONS ARE SHOWN IN MILLIMETERS UNLESS OTHERWISE INDICATED  
2. REFERENCE DRAWING FOR GENERAL VIEW : CS-228.

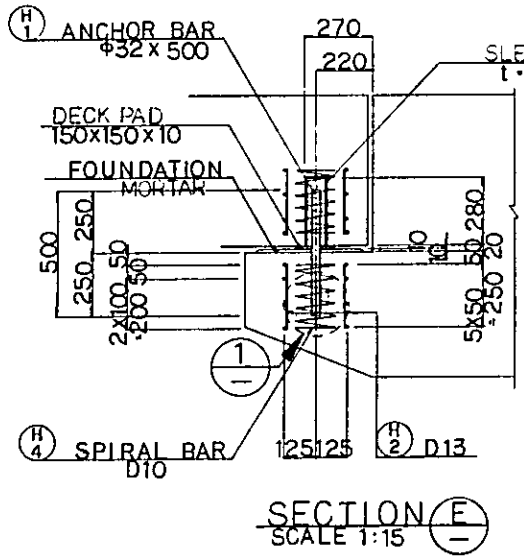


SECTION E-E  
SCALE 1:15

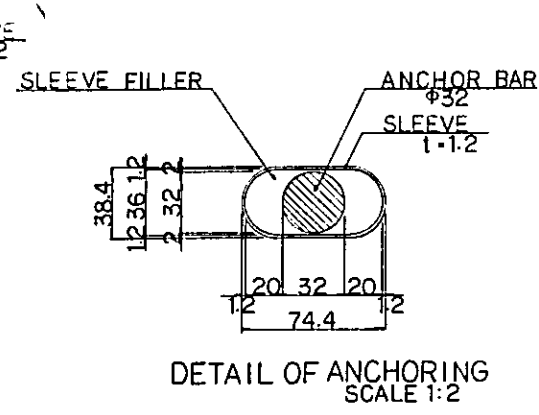


DETAIL OF ANCHORING  
SCALE 1:2

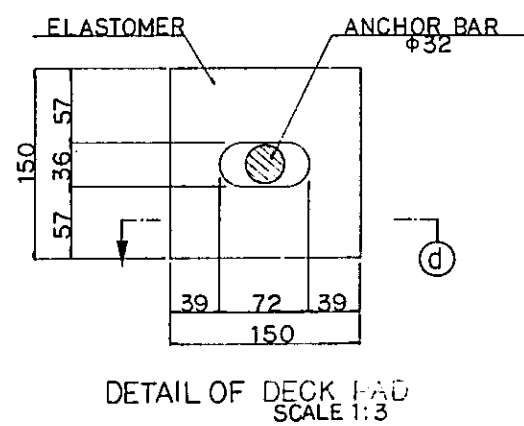


DETAIL OF DECK PAD  
SCALE 1:3

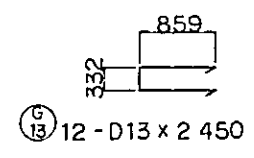


G13 12-D13 x 2 450

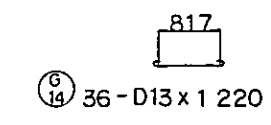


G14 36-D13 x 1 220

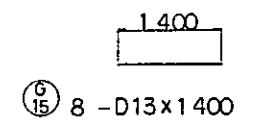


G15 8-D13 x 1 400

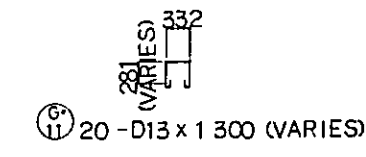


G16 20-D13 x 1 300 (VARIES)

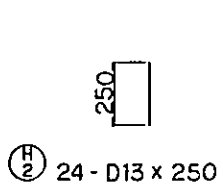


H2 24-D13 x 250

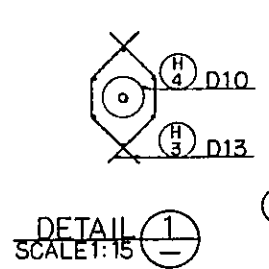


DETAIL 1  
SCALE 1:15

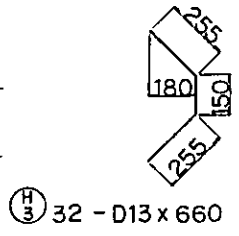


H3 32-D13 x 660

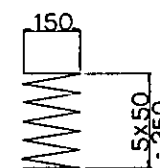

H4 4-D10 x 3 300

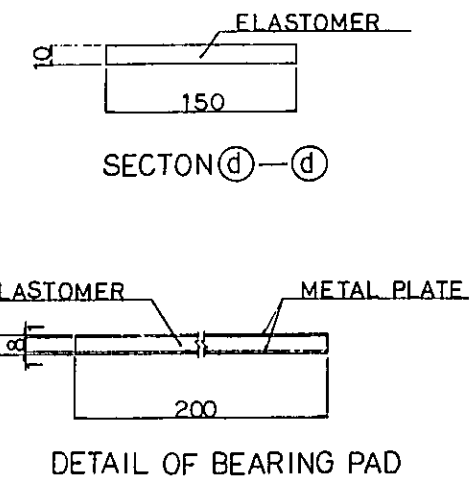


DETAIL OF BEARING PAD

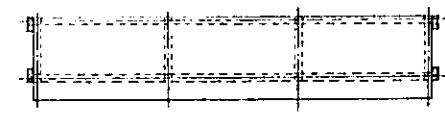


REMARKING DIAGRAM


|   |             |          |       |         |           |
|---|-------------|----------|-------|---------|-----------|
| REPUBLIC OF INDONESIA<br>MINISTRY OF COMMUNICATIONS,<br>DIRECTORATE GENERAL OF LAND TRANSPORT<br>AND INLAND WATERWAYS |             |          |       |         |           |
| NEW RAILWAY LINE FOR CENGKARENG AIRPORT<br>CONSTRUCTION PROJECT   |             |          |       |         |           |
| JAPAN INTERNATIONAL COOPERATION AGENCY<br>(JICA)  |             |          |       |         |           |
| B   | 1AUG'84     | K.V.     | m.y.  | K.A.    | K.M.      |
| A   | 11FEB'84    | K.V.     | m.y.  | K.A.    | K.M.      |
| REVISIONS   | DATE        | DESIGNED | DRAWN | CHECKED | SUBMITTED |
| PLATFORM VP2<br>BAR ARRANGEMENT<br>(SHEET 4 OF 6)   |             |          |       |         |           |
| PACKAGE: I CIVIL AND ARCHITECTURAL WORK   |             |          |       |         |           |
| SCALE   | DRAWING NO. |          |       |         |           |
| AS NOTED  | CS-232      |          |       |         |           |

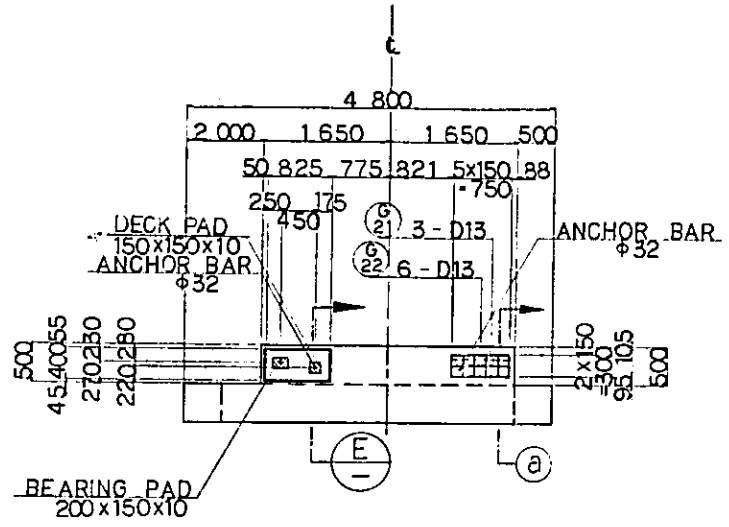


SECTION A SCALE 1:50 SECTION B SCALE 1:50

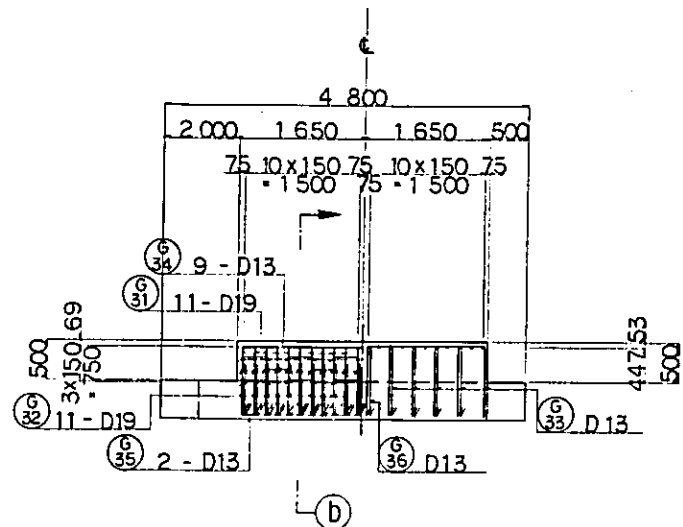


SECTION C SCALE 1:50 SECTION D SCALE 1:50

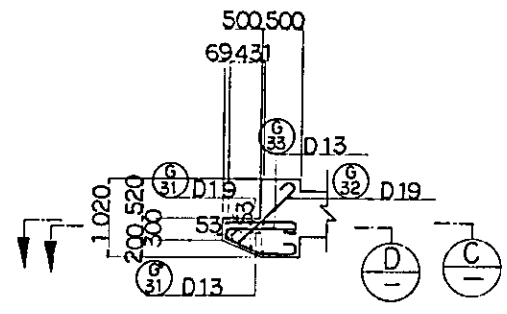


SECTION b-b SCALE 1:50

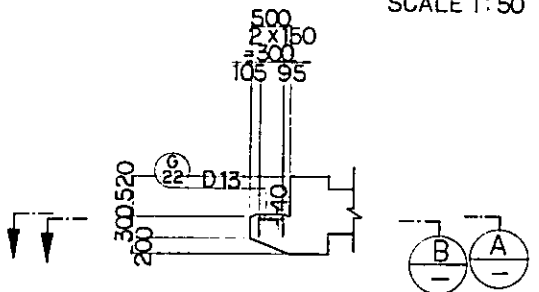


SECTION a-a SCALE 1:50

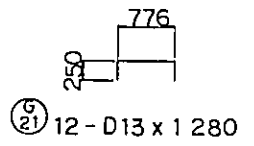


(G21) 12 - D13 x 1280

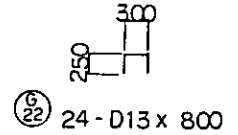


(G22) 24 - D13 x 800

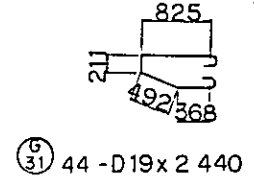


(G31) 44 - D19 x 2440

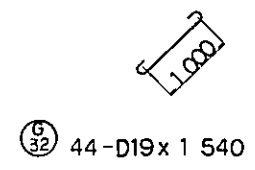


(G32) 44 - D19 x 1540

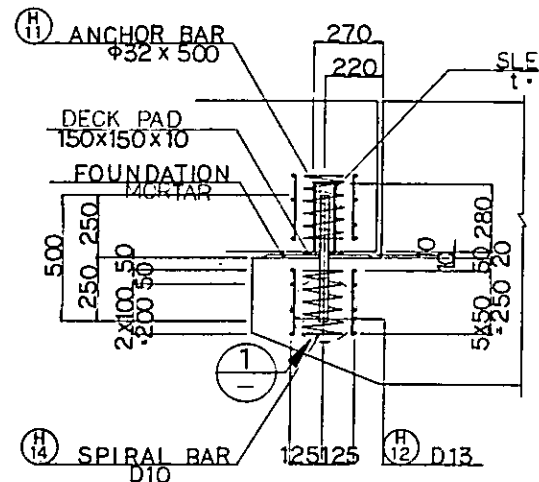


SECTION E SCALE 1:15

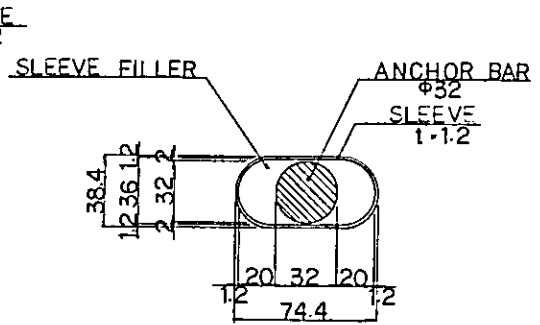


DETAIL OF ANCHORING SCALE 1:2

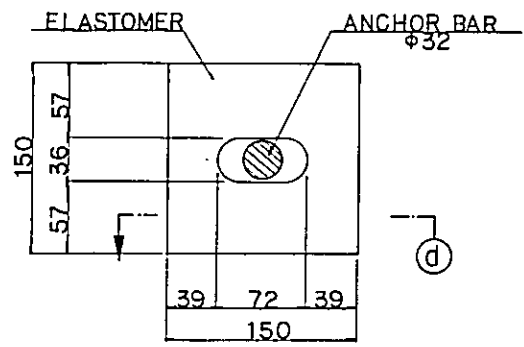


DETAIL OF DECK PAD SCALE 1:3

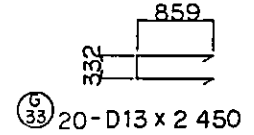


(G33) 20 - D13 x 2450

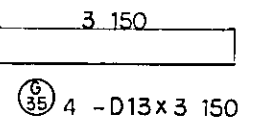


(G35) 4 - D13 x 3150

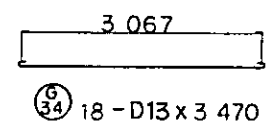


(G34) 18 - D13 x 3470

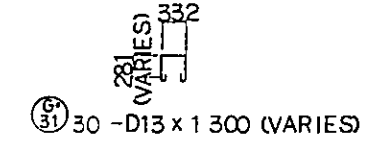


(G31) 30 - D13 x 1300 (VARIES)

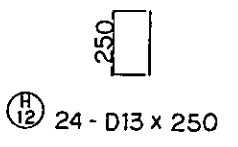


(H12) 24 - D13 x 250

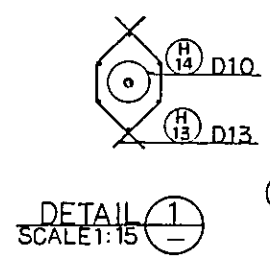


DETAIL 1 SCALE 1:15

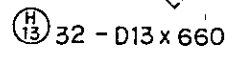


(H13) 32 - D13 x 660

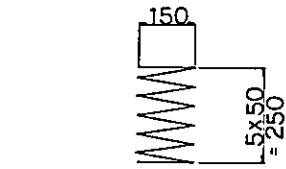


(H14) 4 - D10 x 3300

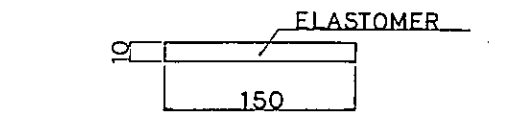

SECTION d-d

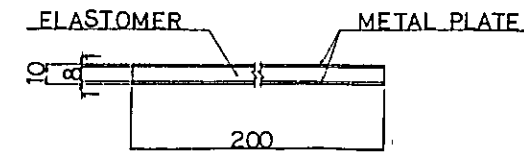

DETAIL OF BEARING PAD

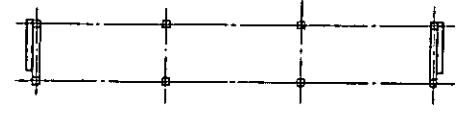


REMARKING DIAGRAM


- NOTES:
1. ALL DIMENSIONS ARE SHOWN IN MILLIMETERS UNLESS OTHERWISE INDICATED
  2. REFERENCE DRAWING FOR GENERAL VIEW : CS-228.

|   |         |          |       |         |          |
|---|---------|----------|-------|---------|----------|
| REPUBLIC OF INDONESIA<br>MINISTRY OF COMMUNICATIONS<br>DIRECTORATE GENERAL OF LAND TRANSPORT AND INLAND WATERWAYS |         |          |       |         |          |
| NEW RAILWAY LINE FOR CENGKARENG AIRPORT<br>CONSTRUCTION PROJECT   |         |          |       |         |          |
| JAPAN INTERNATIONAL COOPERATION AGENCY (JICA)   |         |          |       |         |          |
| E   | 1AUG84  | K.A.     | m.y.  | K.A.    | K.M.     |
| A   | 12SEP84 | K.A.     | m.y.  | K.A.    | K.M.     |
| REVISIONS   | DATE    | DESIGNED | DRAWN | CHECKED | REVIEWED |
| PACKAGE: I CIVIL AND ARCHITECTURAL WORK<br>SCALE: AS NOTED<br>DRAWING NO: CS-233                                  |         |          |       |         |          |



PLATFORM VP2  
 BAR ARRANGEMENT  
 (SHEET 5 OF 6)

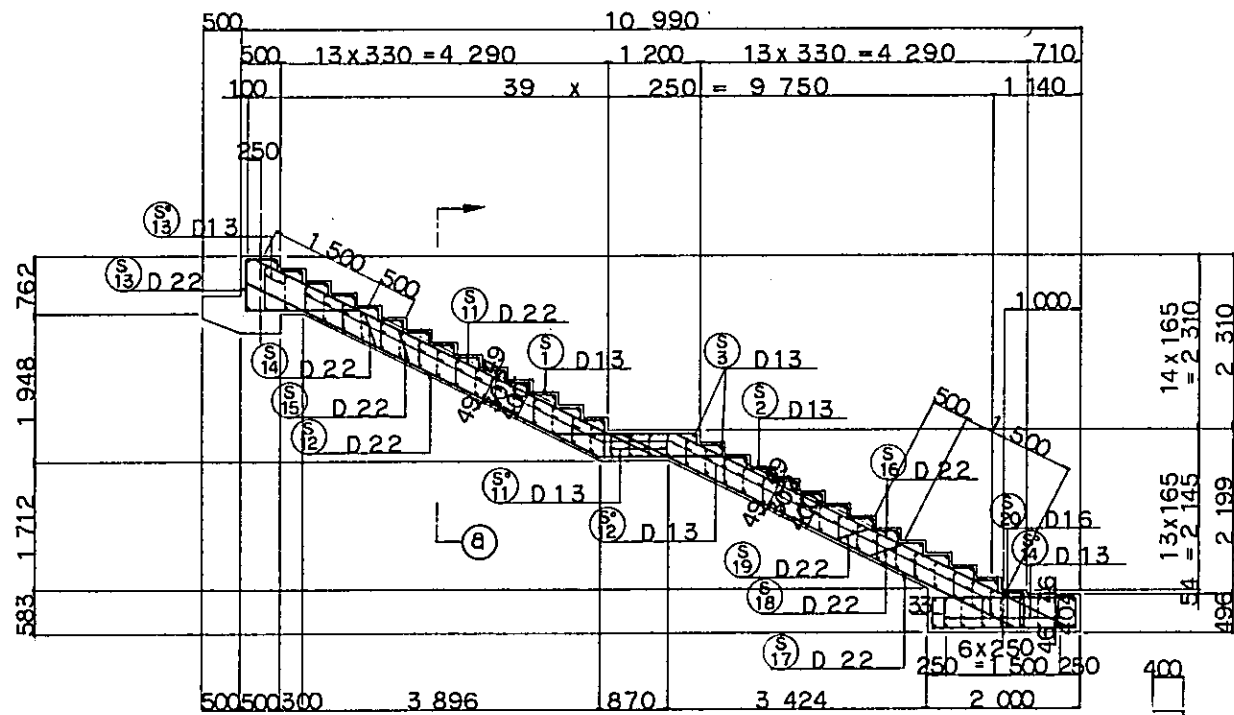

SECTION A-A

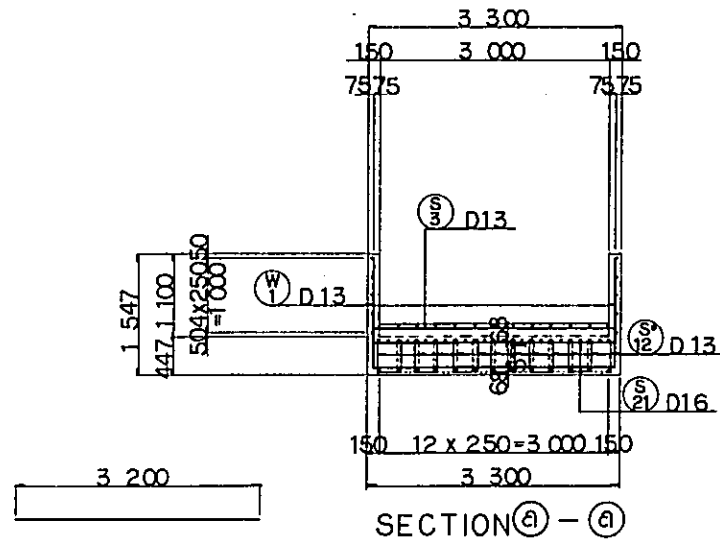


SECTION A-A

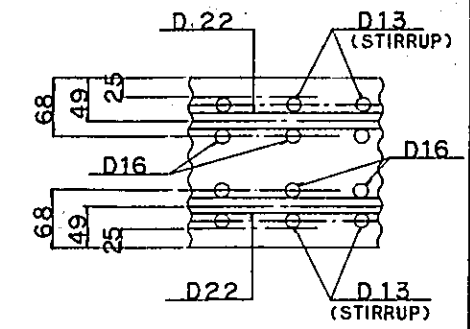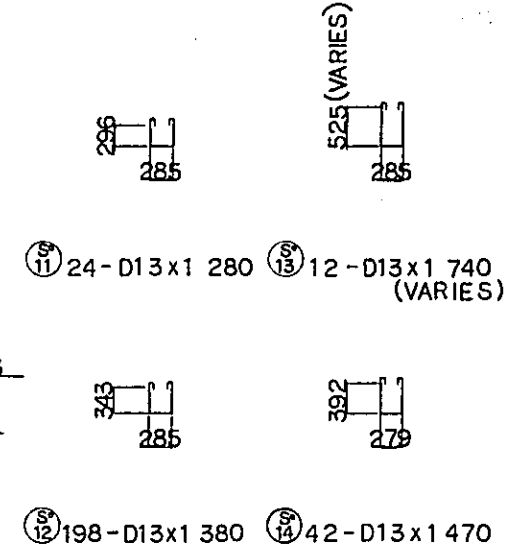


CONCRETE COVER

NOTES:

1. ALL DIMENSIONS ARE SHOWN IN MILLIMETERS UNLESS OTHERWISE INDICATED
2. REFERENCE DRAWING FOR GENERAL VIEW : CS-228.

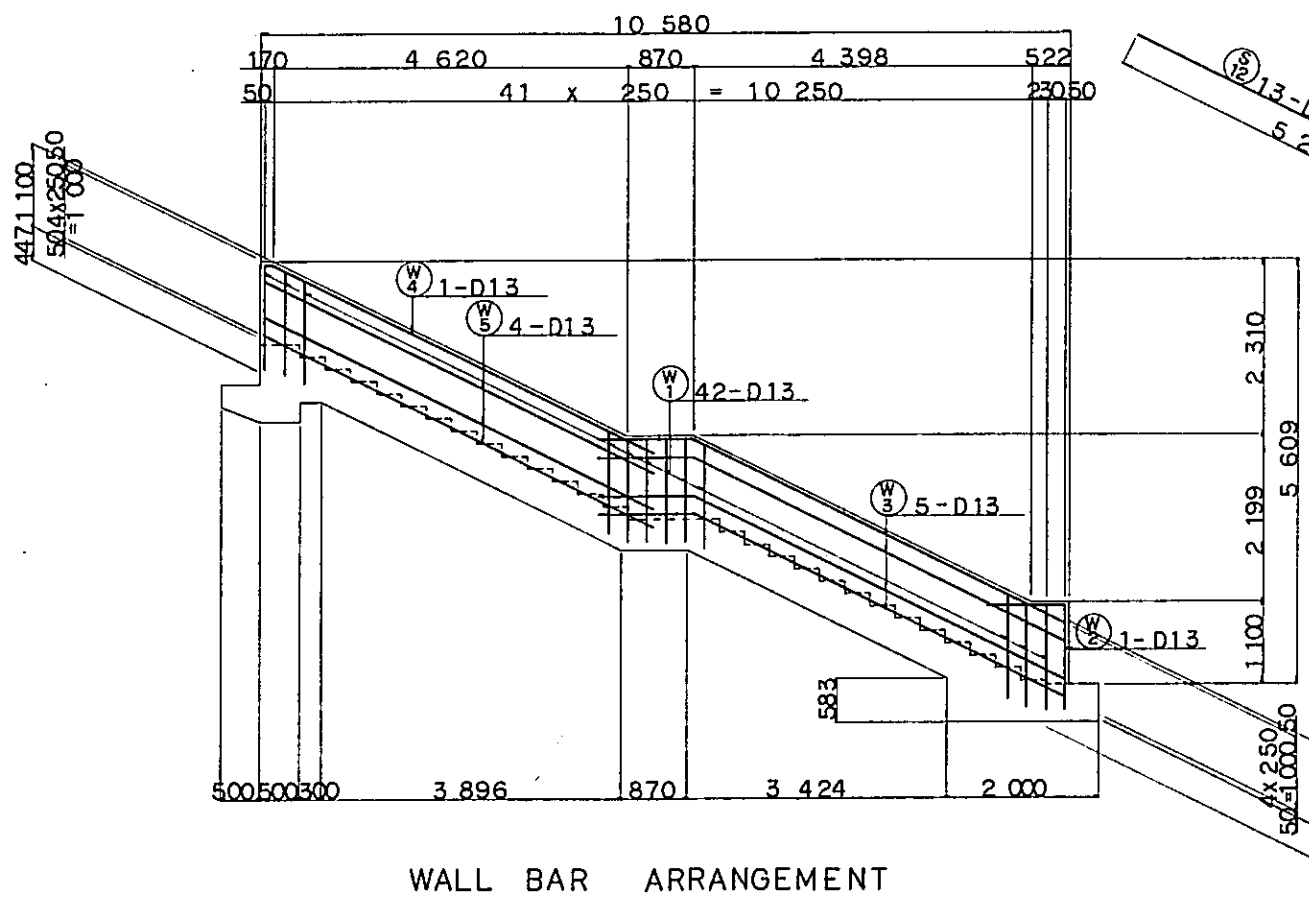


WALL BAR ARRANGEMENT

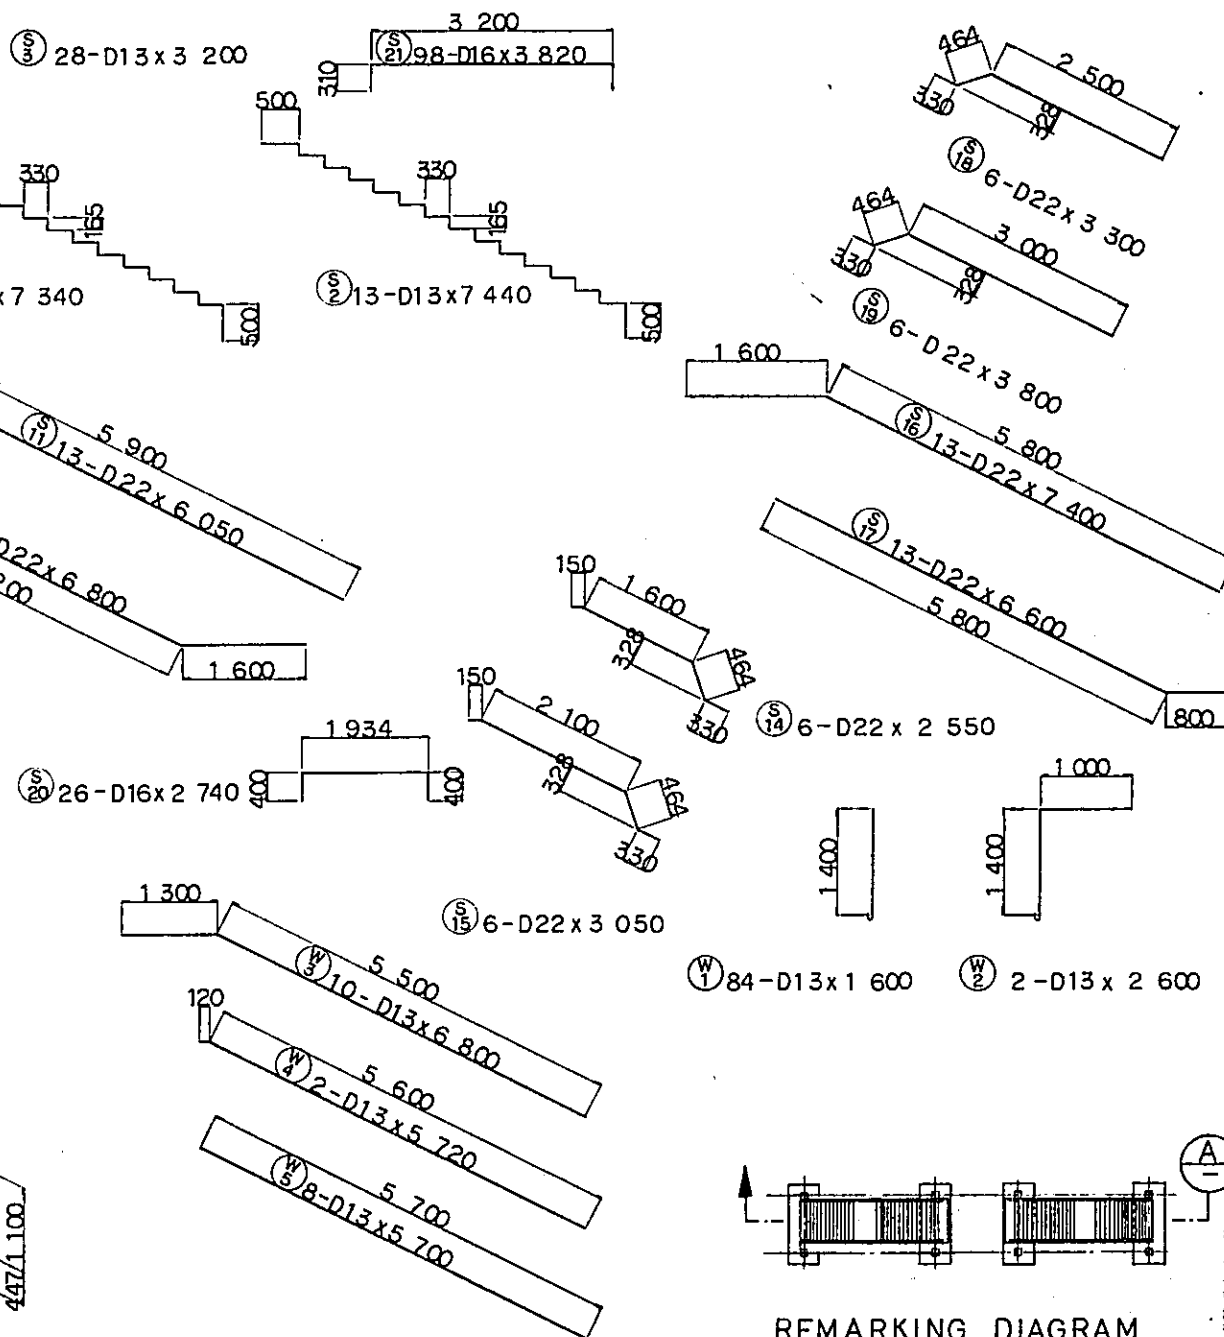

REMARKING DIAGRAM


|   |                    |
|---|--------------------|
| REPUBLIC OF INDONESIA                                       |                    |
| MINISTRY OF COMMUNICATIONS                                  |                    |
| DIRECTORATE GENERAL OF LAND TRANSPORT AND INLAND WATERWAYS  |                    |
| NEW RAILWAY LINE FOR CENKARENG AIRPORT CONSTRUCTION PROJECT |                    |
| JAPAN INTERNATIONAL COOPERATION AGENCY (JICA)               |                    |
| B   | 1 AUG. 84          |
| A   | 10 FEB. 84         |
| REVISIONS   | DATE               |
| DESIGNED  | DRAWN              |
| CHECKED   | REVIEWED           |
| SUBMITTED   |                    |
| PLATFORM VP2 BAR ARRANGEMENT (SHEET 6 OF 6)                 |                    |
| PACKAGE: I CIVIL AND ARCHITECTURAL WORK                     |                    |
| SCALE: 1:50   | DRAWING NO: CS-234 |



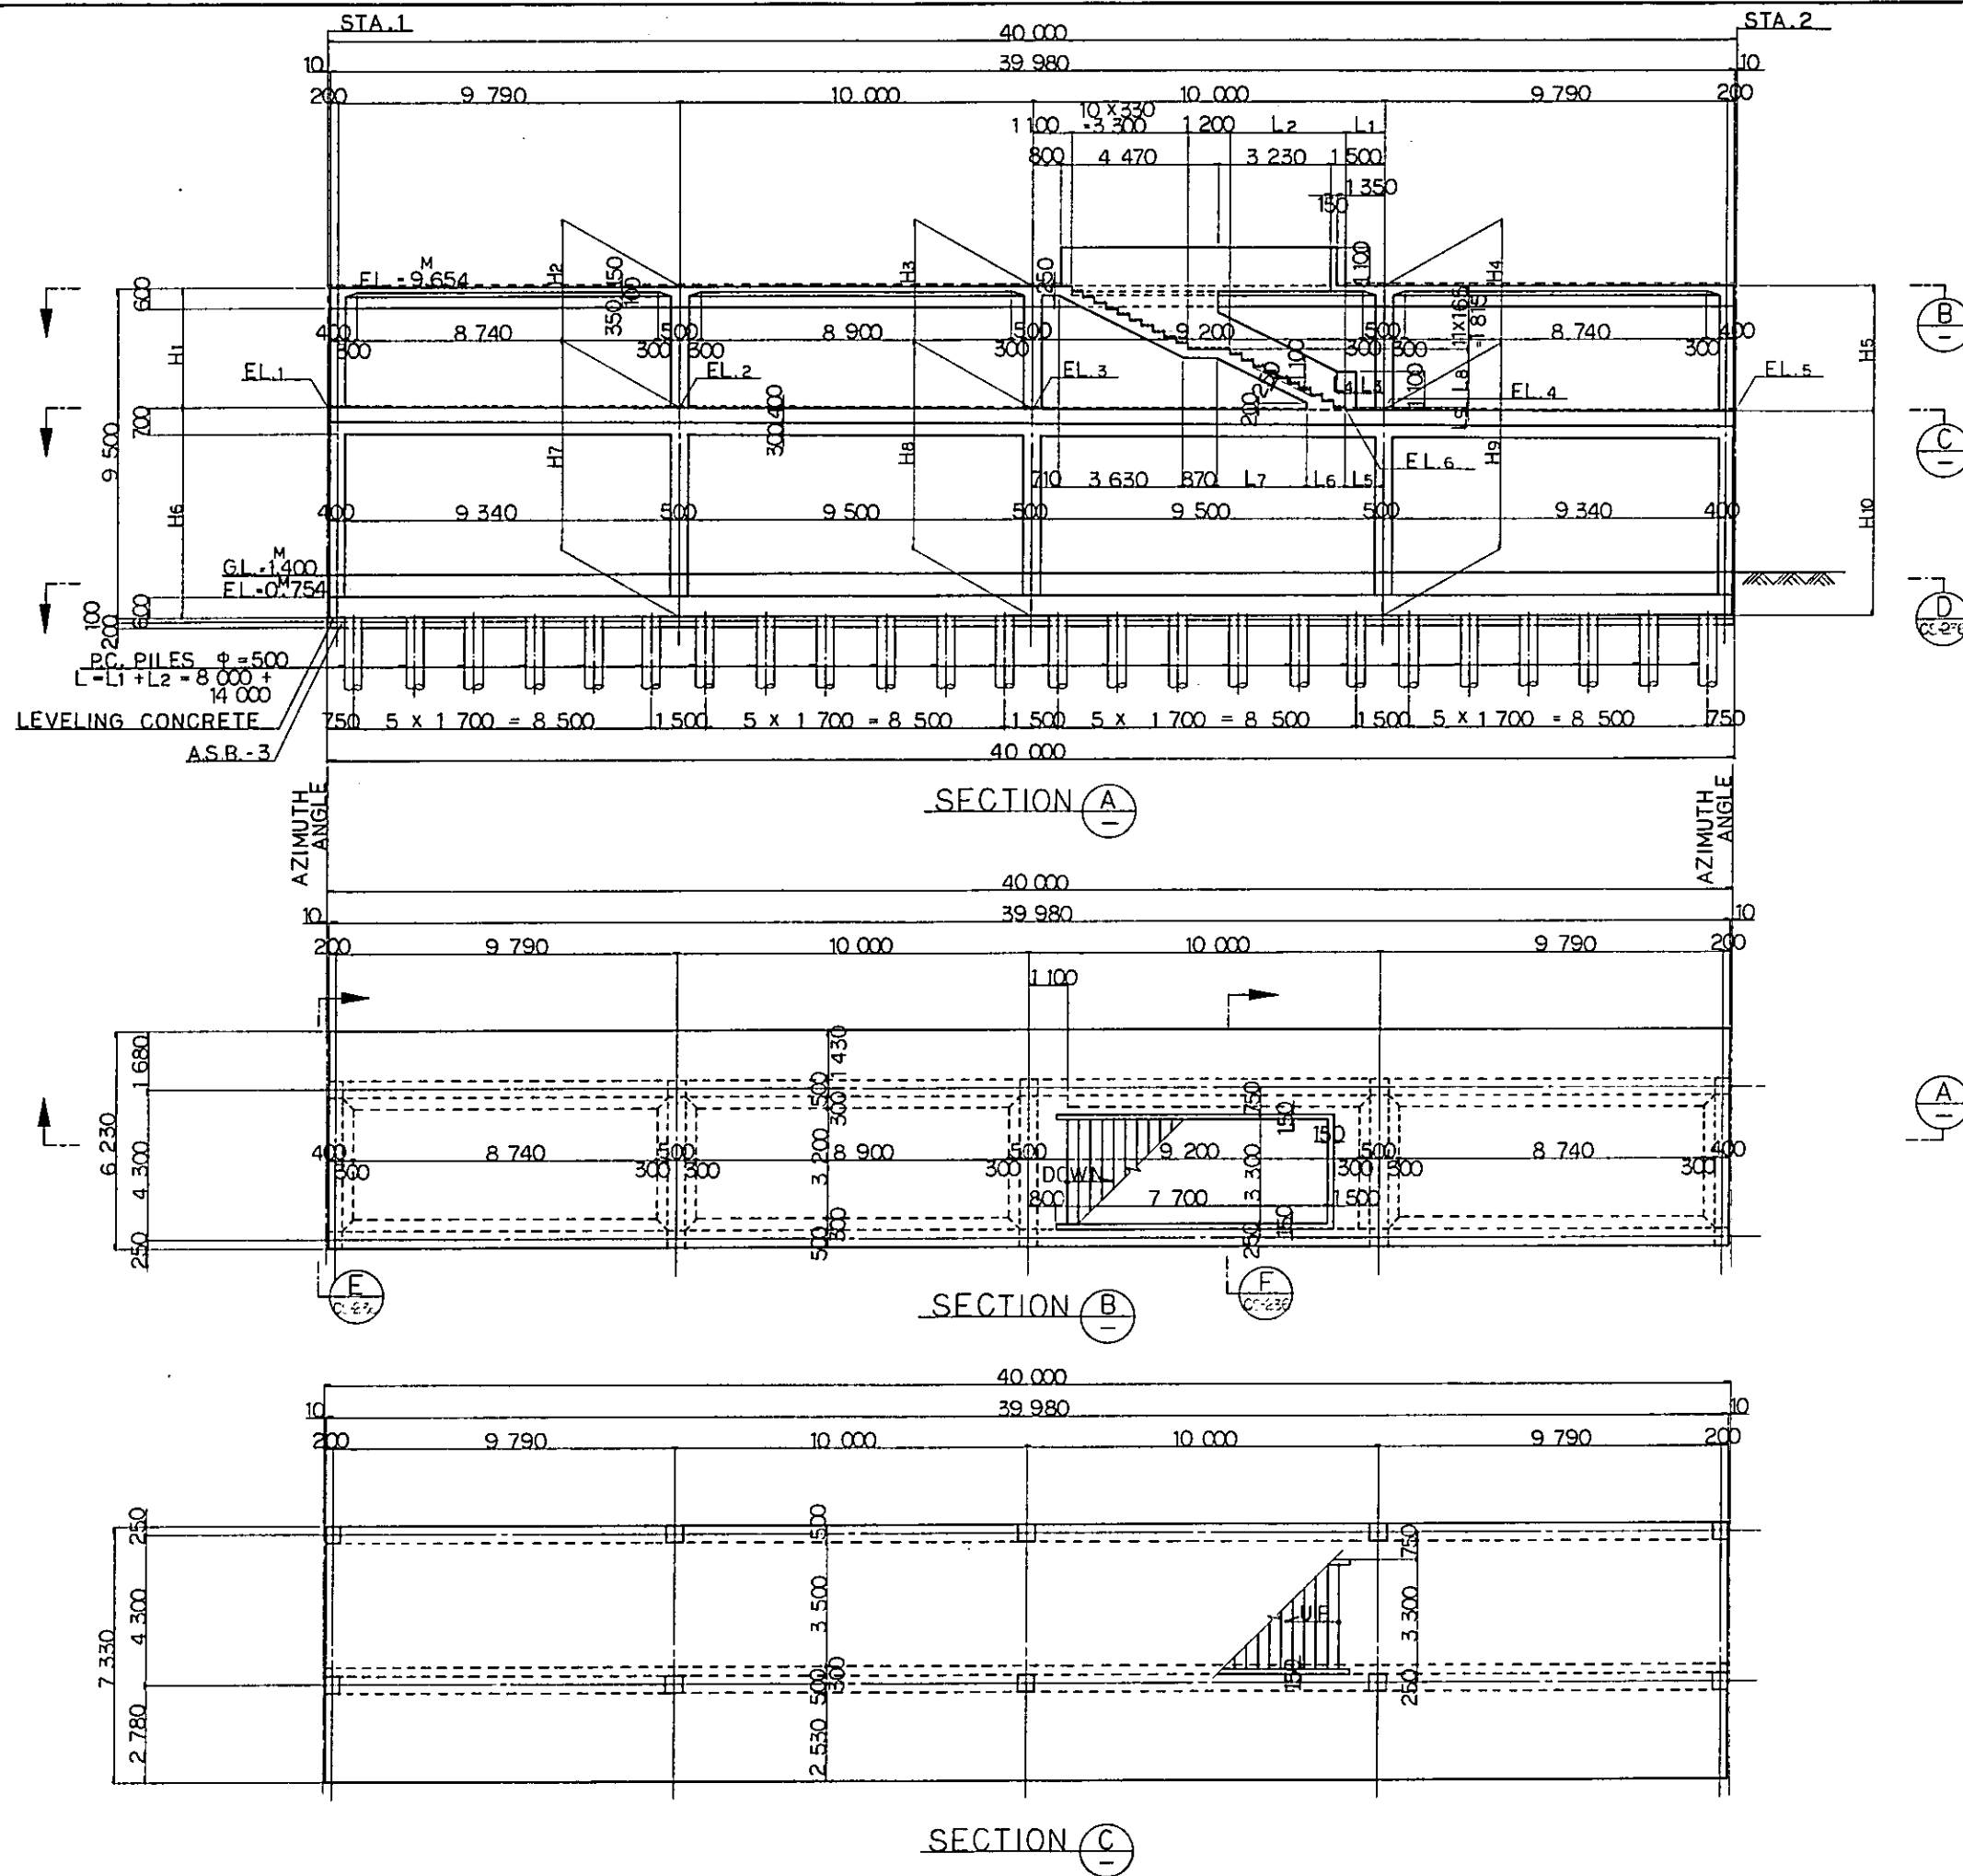

NOTES:

1. ALL DIMENSIONS ARE SHOWN IN MILLIMETERS UNLESS OTHERWISE INDICATED
2. REFERENCE DRAWING FOR BAR ARRANGEMENT: CS-238 ~ 244.
3. TYPES OF PC. PILE

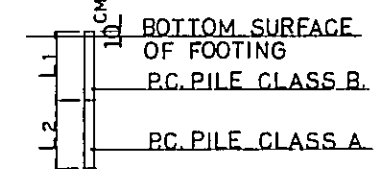

DESIGN CRITERIA

|                  |                                      |  |
|------------------|--------------------------------------|--|
| DESIGN LOAD      | TRAIN LOAD                           | EQUIVALENT TO KS-16  |
|                  | SEISMIC EFFECT                       | IN HORIZONTAL DIRECTION $K_h=0.1$<br>IN VERTICAL DIRECTION $K_h=0$ |
| ALLOWABLE STRESS | REINFORCING BAR                      | ALLOWABLE TENSILE STRESS 180 kg/cm <sup>2</sup>                    |
|                  | CONCRETE                             | ALLOWABLE COMPRESSIVE STRESS 90 kg/cm <sup>2</sup>                 |
| MATERIAL         | TYPE OF REINFORCING BAR              | SD-38  |
|                  | CONCRETE OF DESIGN CRITERIA STRENGTH | $\sigma_{ck}=240 \text{ kg/cm}^2$                                  |
|                  | MAX SIZE OF COARSE AGGREGATE         | 25 mm  |

REPUBLIC OF INDONESIA  
MINISTRY OF COMMUNICATIONS  
DIRECTORATE GENERAL OF LAND TRANSPORT AND INLAND WATERWAYS


NEW RAILWAY LINE FOR CENGKARENG AIRPORT  
CONSTRUCTION PROJECT

JAPAN INTERNATIONAL COOPERATION AGENCY  
(JICA)


|           |          |          |       |         |          |           |
|-----------|----------|----------|-------|---------|----------|-----------|
| REVISIONS | DATE     | DESIGNED | DRAWN | CHECKED | REVIEWED | SUBMITTED |
| B         | 1 AUG 84 | K.V.     | M.Y.  | K.D.    | K.M.     | M.K.      |
| A         | 1 FEB 84 | K.V.     | M.Y.  | K.D.    | K.M.     | M.K.      |

PLATFORM VP4, VP6  
GENERAL VIEW  
(SHEET 1 OF 2)

PACKAGE: I CIVIL AND ARCHITECTURAL WORK  
SCALE: 1:100 DRAWING NO: CS-235

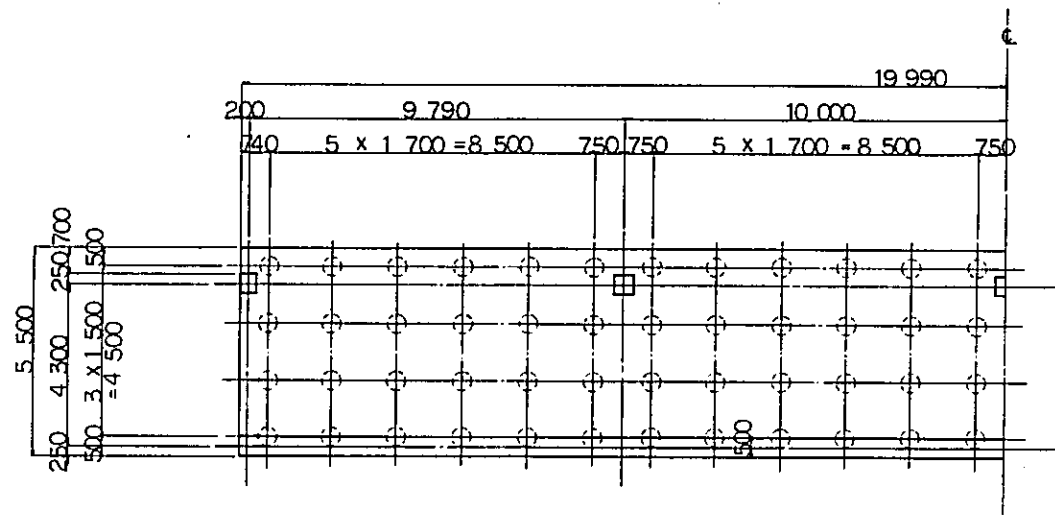

SECTION D  
CS-235

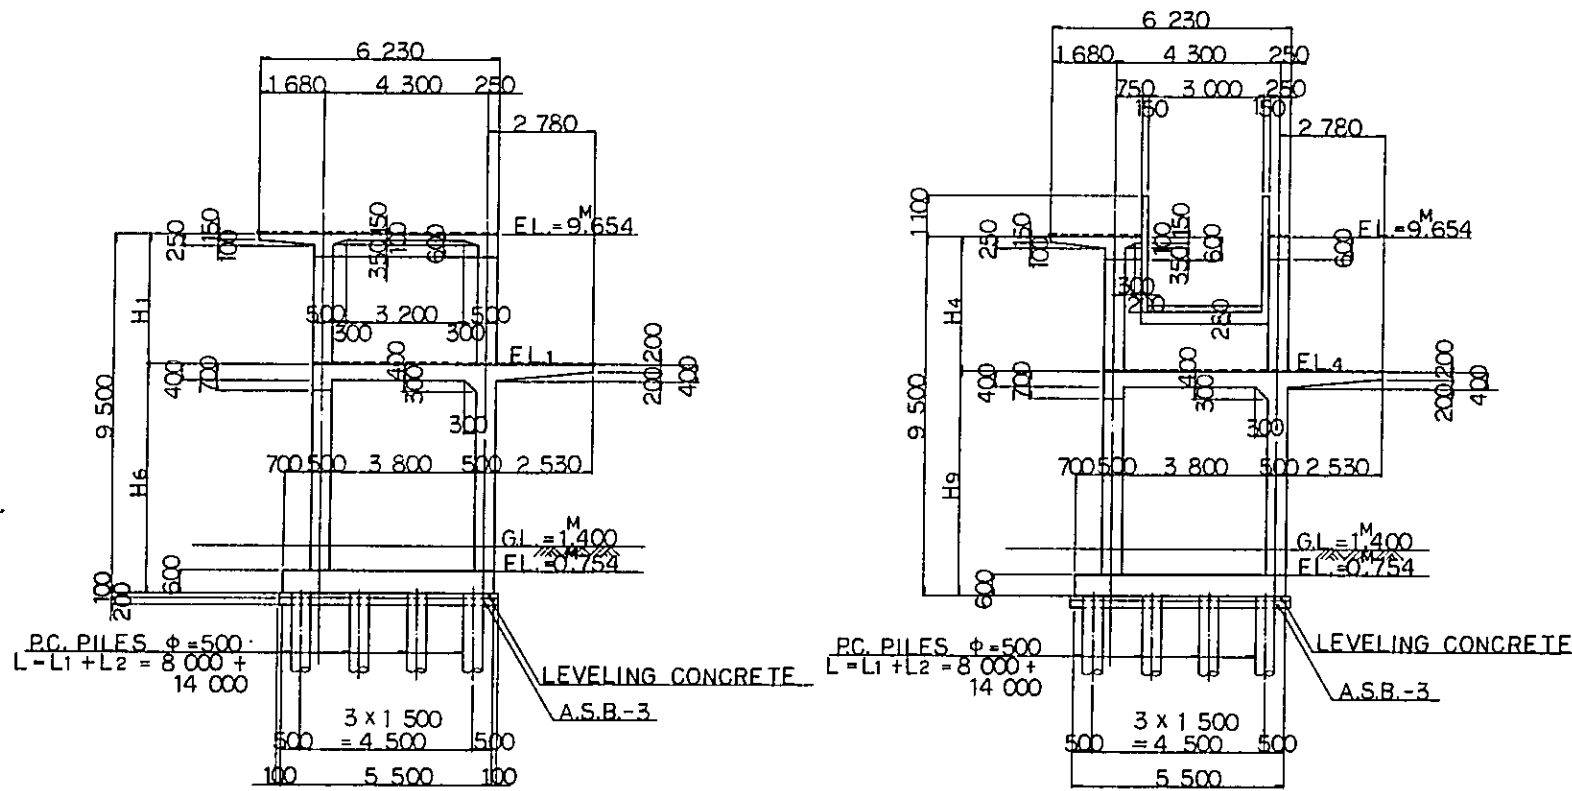

SECTION E  
CS-235


SECTION F  
CS-235

DIMENSION SCHEDULE

| NO.           | (VP <sub>4</sub> )      | (VP <sub>6</sub> )      | REMARKS |
|---------------|-------------------------|-------------------------|---------|
| STA 1         | 17 <sup>M</sup> 310.000 | 17 <sup>M</sup> 420.000 |         |
| STA 2         | 17 <sup>M</sup> 350.000 | 17 <sup>M</sup> 380.000 |         |
| AZIMUTH ANGLE | 345° 30' 45"            | 345° 30' 45"            |         |
| H1            | 3.434                   | 3.764                   |         |
| H2            | 3.464                   | 3.734                   |         |
| H3            | 3.494                   | 3.704                   |         |
| H4            | 3.524                   | 3.674                   |         |
| H5            | 3.554                   | 3.644                   |         |
| H6            | 6.066                   | 5.736                   |         |
| H7            | 6.036                   | 5.766                   |         |
| H8            | 6.006                   | 5.796                   |         |
| H9            | 5.976                   | 5.826                   |         |
| H10           | 5.946                   | 5.856                   |         |
| EL1           | 6 <sup>M</sup> 220      | 5 <sup>M</sup> 890      |         |
| EL2           | 6 <sup>M</sup> 190      | 5 <sup>M</sup> 920      |         |
| EL3           | 6 <sup>M</sup> 160      | 5 <sup>M</sup> 950      |         |
| EL4           | 6 <sup>M</sup> 130      | 5 <sup>M</sup> 980      |         |
| EL5           | 6 <sup>M</sup> 100      | 6 <sup>M</sup> 010      |         |
| EL6           | 6 <sup>M</sup> 133      | 5 <sup>M</sup> 978      |         |
| L1            | 1.100                   | 770                     |         |
| L2            | 10 x 330 = 3.300        | 11 x 330 = 3.630        |         |
| L3            | 800                     | 470                     |         |
| L4            | 518                     | 538                     |         |
| L5            | 850                     | 520                     |         |
| L6            | 1.178                   | 1.198                   |         |
| L7            | 2.512                   | 2.822                   |         |
| L8            | 10 x 165 = 1.650        | 11 x 165 = 1.815        |         |
| L9            | 56                      | 46                      |         |

NOTES :

1. ALL DIMENSIONS ARE SHOWN IN MILLIMETERS UNLESS OTHERWISE INDICATED
2. REFERENCE DRAWING FOR BAR ARRANGEMENT: CS-238~244
3. TYPES OF PC. PILE

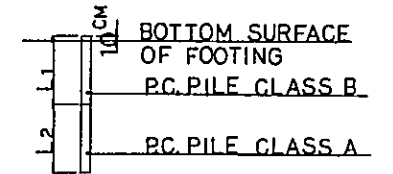

REPUBLIC OF INDONESIA  
MINISTRY OF COMMUNICATIONS  
DIRECTORATE GENERAL OF LAND TRANSPORT AND INLAND WATERWAYS

NEW RAILWAY LINE FOR CENGKARENG AIRPORT  
CONSTRUCTION PROJECT

JAPAN INTERNATIONAL COOPERATION AGENCY (JICA)





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|---|---------|-----|-----|-----|-----|-----|
| B | 1AUG'84 | K.V | m.y | K.I | K.M | K.K |
| A | 1FEB'84 | K.V | m.y | K.I | K.M | K.K |

REVISIONS    DATE    DESIGNED    DRAWN    CHECKED    REVIEWED    SUBMITTED

PLATFORM VP4, VP6  
GENERAL VIEW  
(SHEET 2 OF 2)


PACKAGE: I CIVIL AND ARCHITECTURAL WORK

SCALE: 1:100    DRAWING NO: CS-236

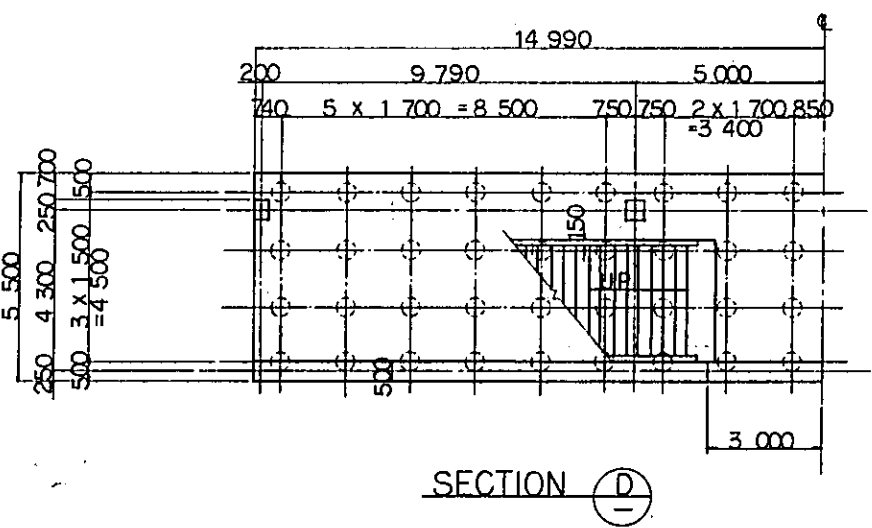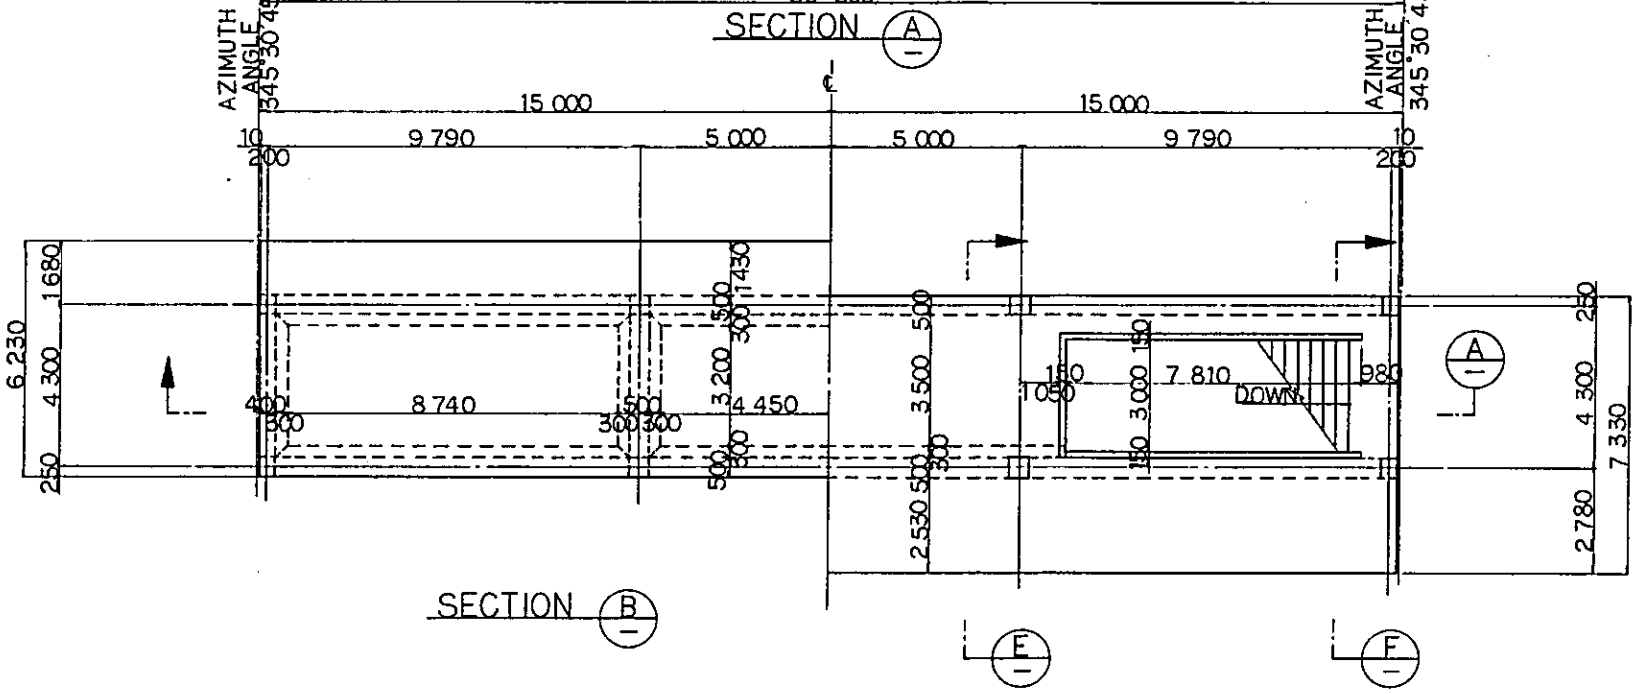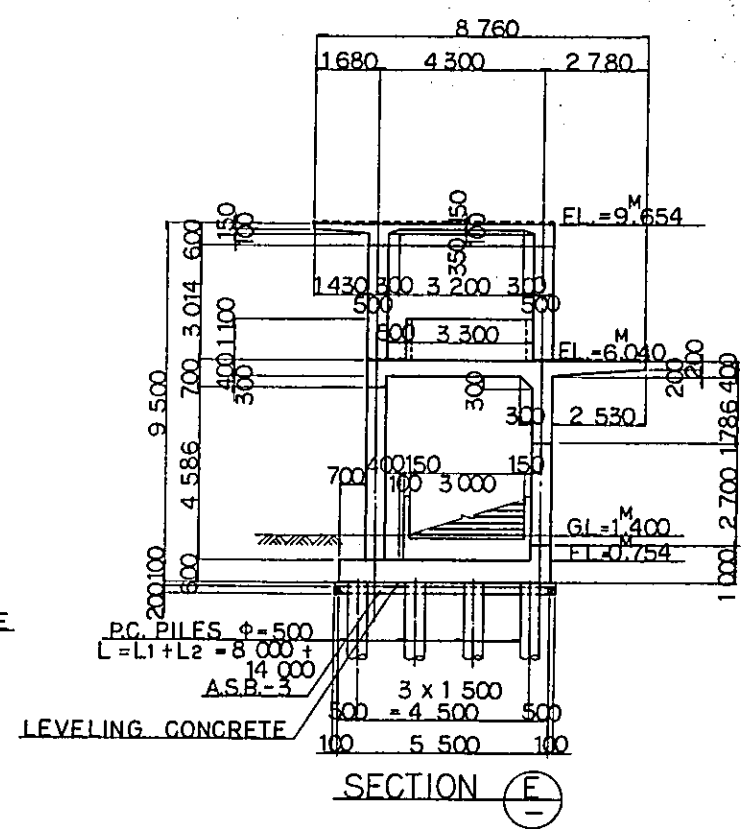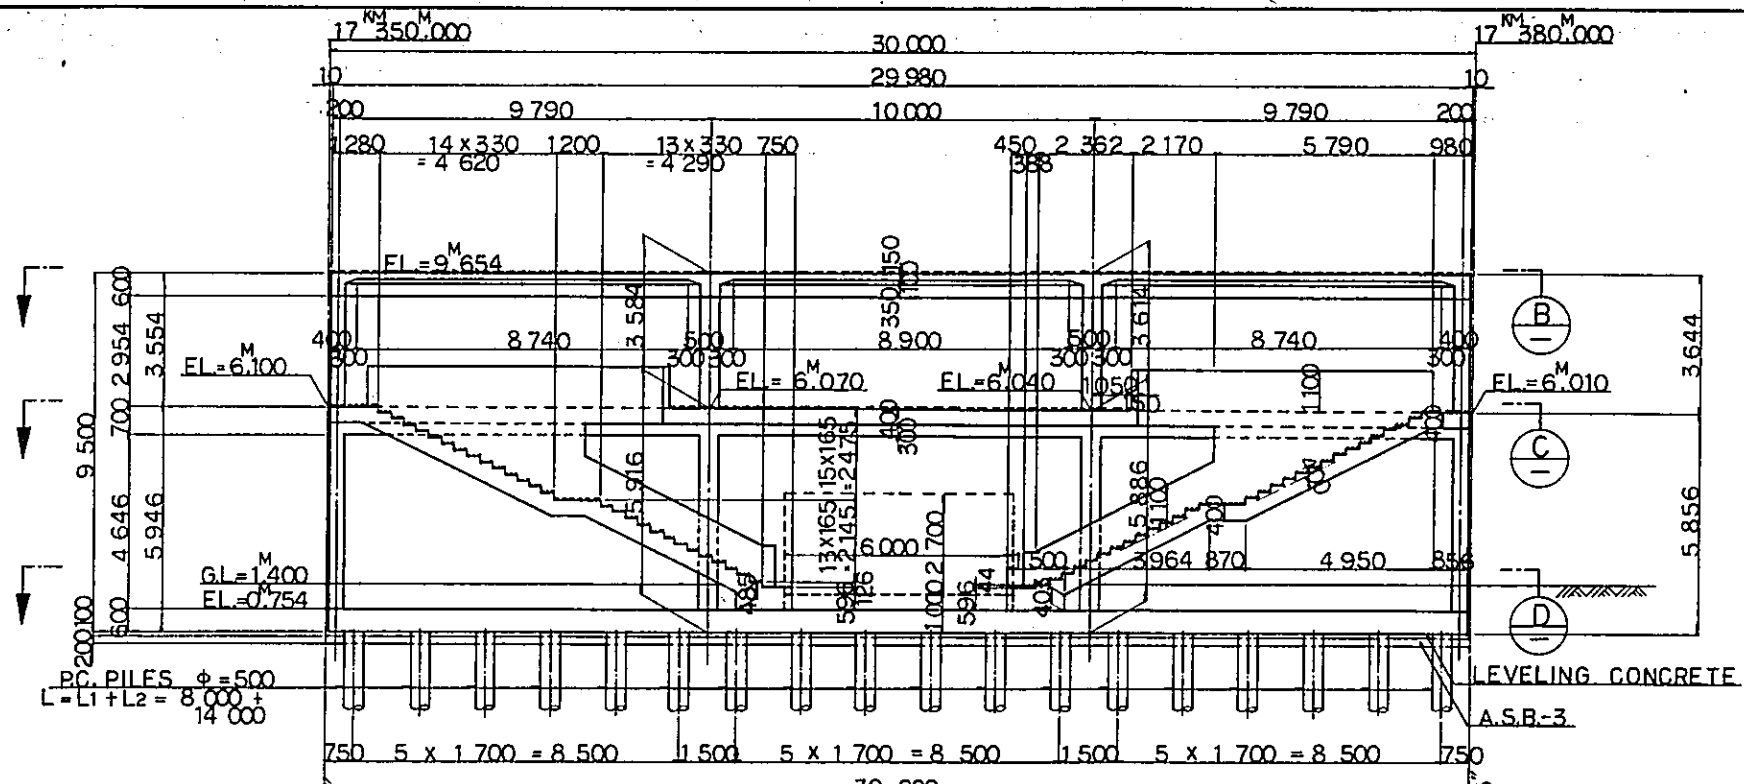

DESIGN CRITERIA

| DESIGN LOAD      | TRAIN LOAD                           | EQUIVALENT TO KS-16  |
|------------------|--------------------------------------|--|
|                  | SEISMIC EFFECT                       | IN HORIZONTAL DIRECTION $K_h=0.1$<br>IN VERTICAL DIRECTION $K_h=0$ |
| ALLOWABLE STRESS | REINFORCING BAR                      | ALLOWABLE TENSILE STRESS 1800 kg/cm <sup>2</sup>                   |
|                  | CONCRETE                             | ALLOWABLE COMPRESSIVE STRESS 90 kg/cm <sup>2</sup>                 |
| MATERIAL         | TYPE OF REINFORCING BAR              | SD-30  |
|                  | CONCRETE OF DESIGN CRITERIA STRENGTH | $f'_{ck}=240 \text{ kg/cm}^2$                                      |
|                  | MAX SIZE OF COARSE AGGREGATE         | 25mm   |

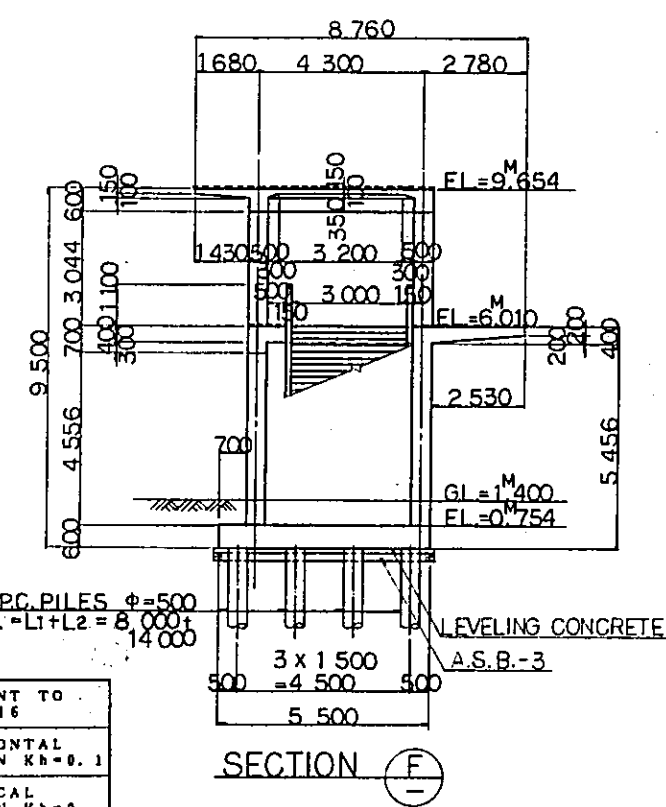

- NOTES:
- ALL DIMENSIONS ARE SHOWN IN MILLIMETERS UNLESS OTHERWISE INDICATED
  - REFERENCE DRAWING FOR BAR ARRANGEMENT: CS-238 ~ 244.
  - TYPES OF P.C. PILE
- 

REPUBLIC OF INDONESIA  
 MINISTRY OF COMMUNICATIONS  
 DIRECTORATE GENERAL OF LAND TRANSPORT AND INLAND WATERWAYS

NEW RAILWAY LINE FOR CENGKARENG AIRPORT CONSTRUCTION PROJECT


JAPAN INTERNATIONAL COOPERATION AGENCY (JICA)

| REVISIONS | DATE     | DESIGNED | DRAWN | CHECKED | REVIEWED | SUBMITTED |
|-----------|----------|----------|-------|---------|----------|-----------|
| B         | 1AUG'84  | K.V.     | m.y.  | K.R.    | M.M.     | K.K.      |
| A         | 11FEB'84 | K.V.     | m.y.  | K.R.    | K.M.     | K.K.      |



PLATFORM VP5  
 GENERAL VIEW

PACKAGE: I CIVIL AND ARCHITECTURAL WORK



SCALE: 1:100 DRAWING NO: CS-237

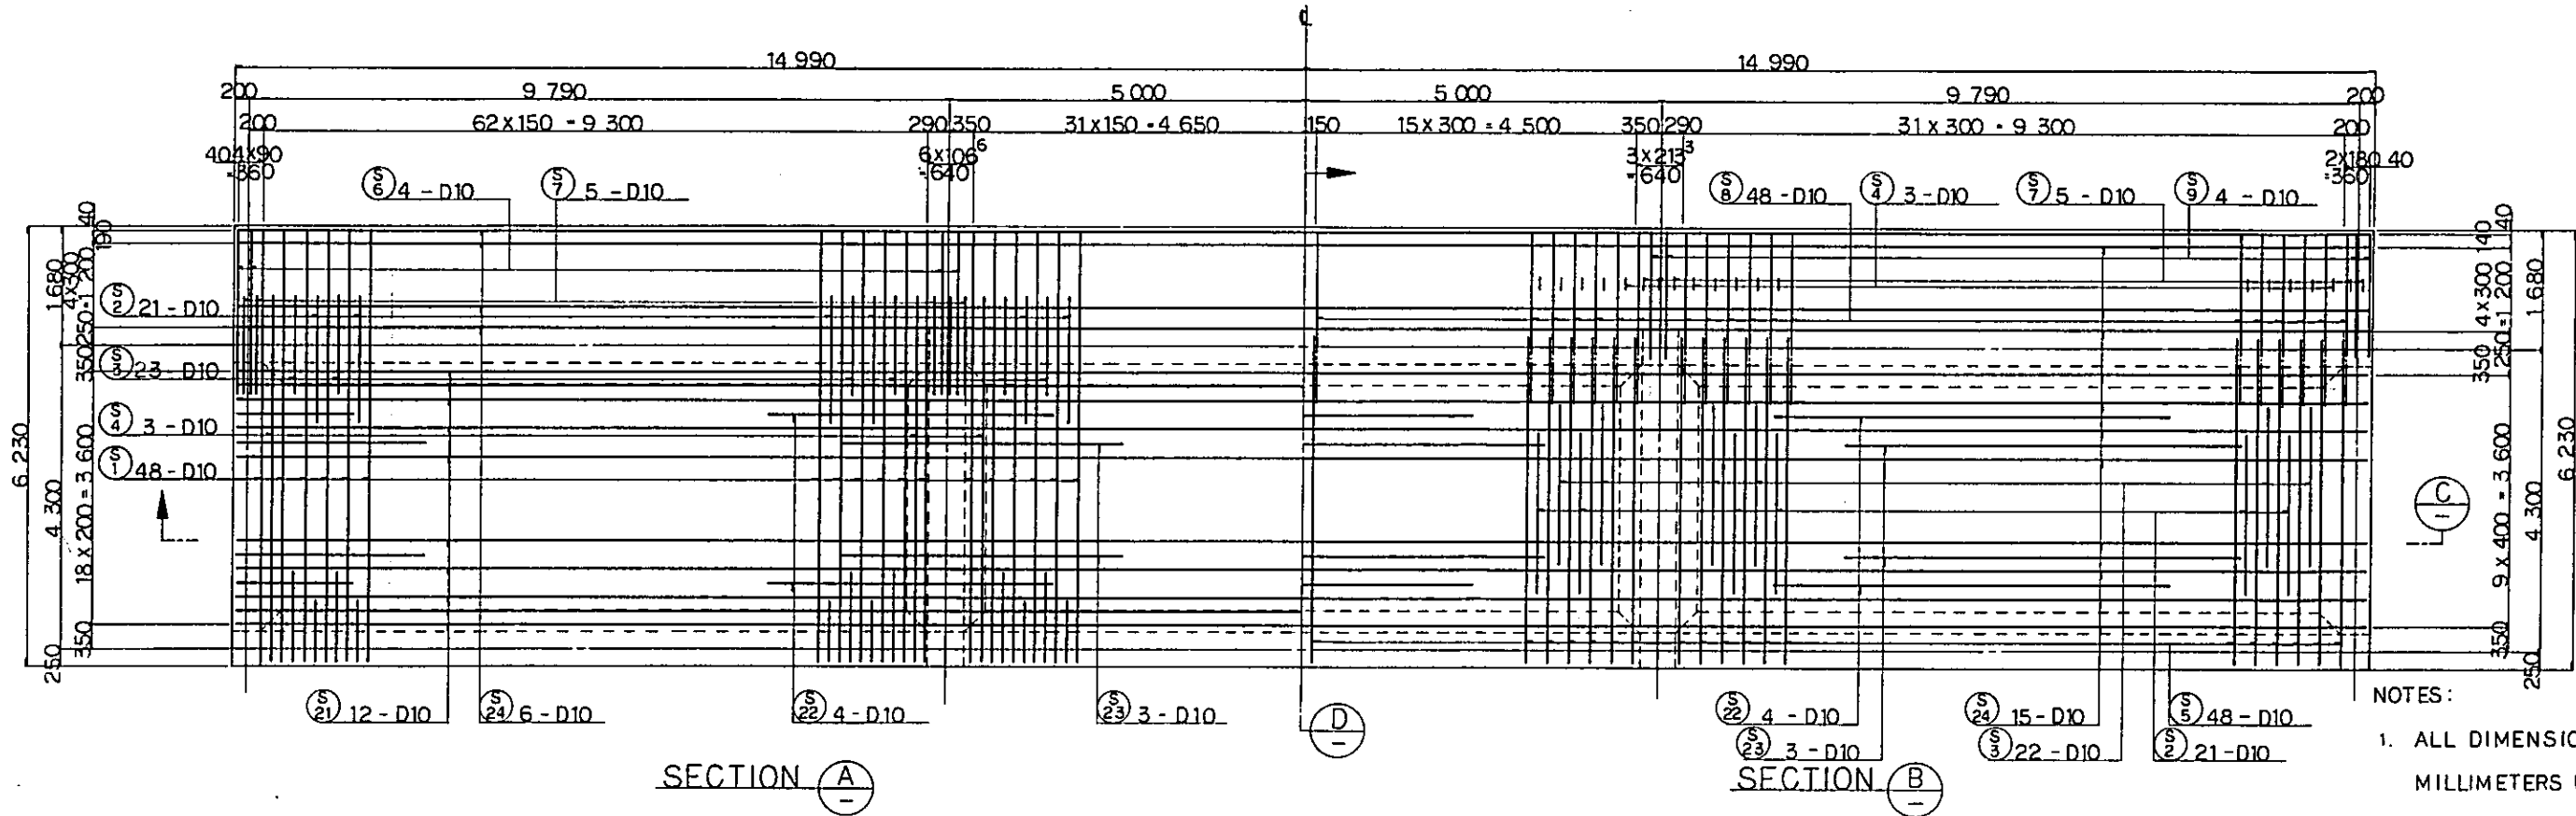





- NOTES:
1. ALL DIMENSIONS ARE SHOWN IN MILLIMETERS UNLESS OTHERWISE INDICATED
  2. REFERENCE DRAWING FOR GENERAL VIEW : CS-237.

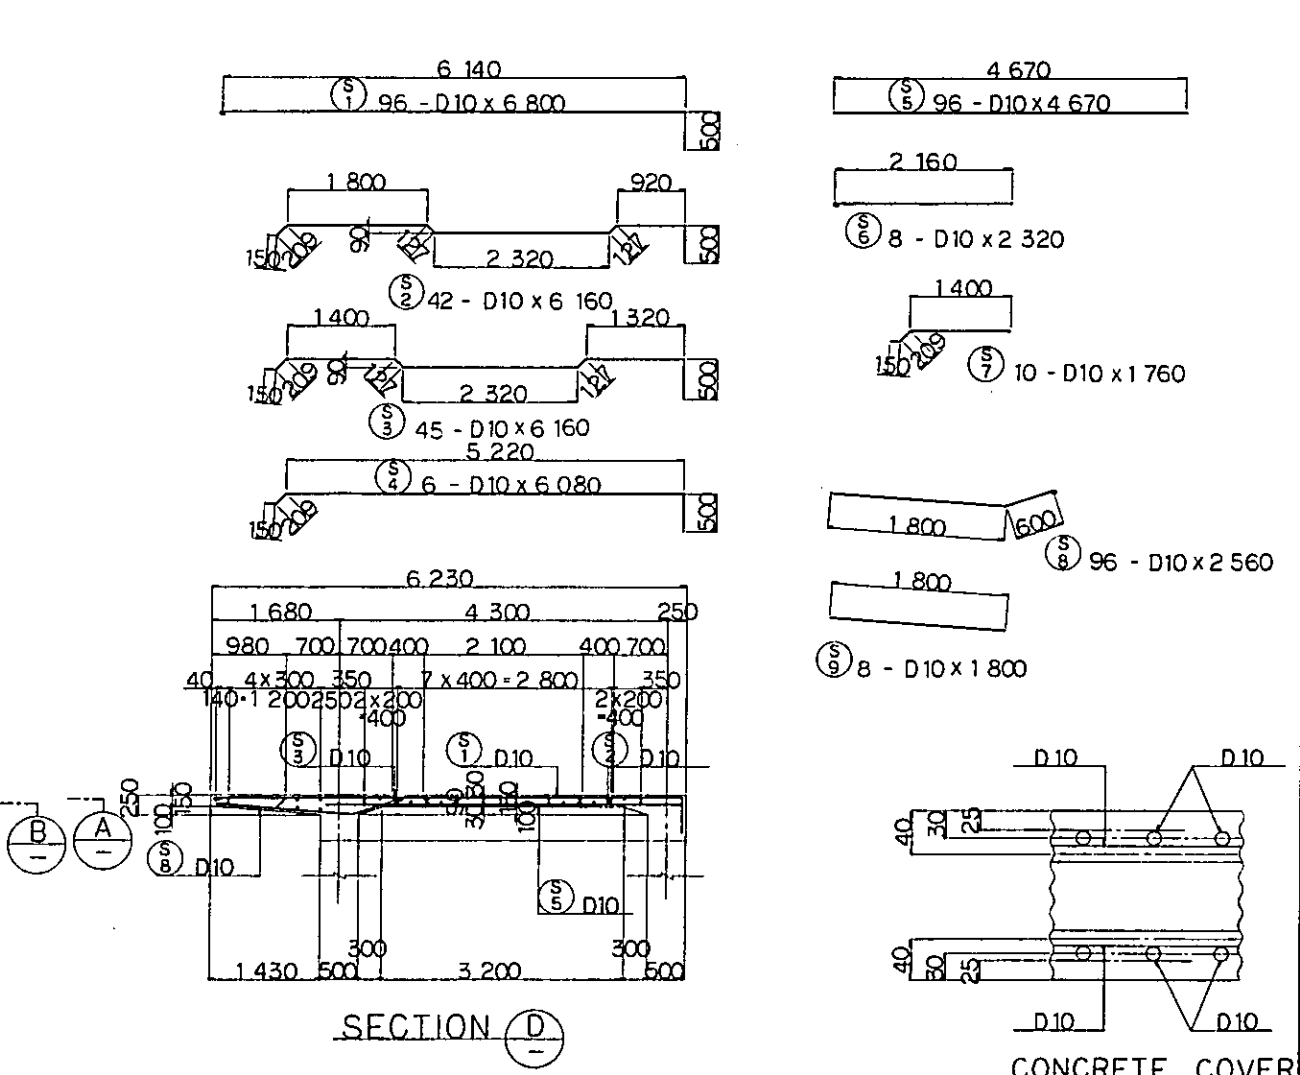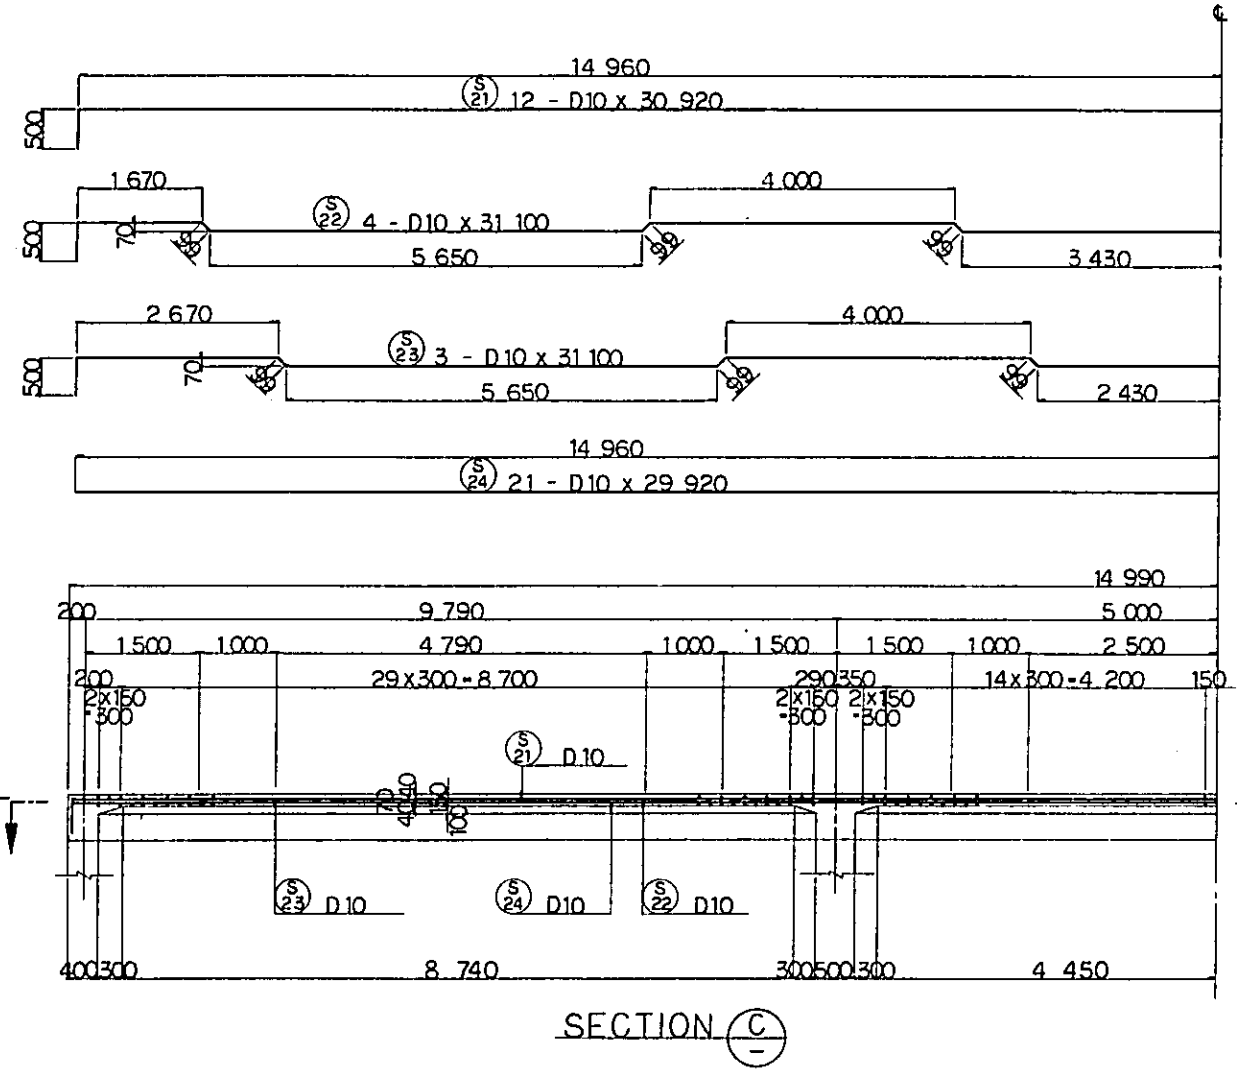









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|--|------------|-------------|-------|---------|----------|-----------|
| REPUBLIC OF INDONESIA<br>MINISTRY OF COMMUNICATIONS<br>DIRECTORATE GENERAL OF LAND TRANSPORT<br>AND INLAND WATERWAYS |            |             |       |         |          |           |
| NEW RAILWAY LINE FOR CENGKARENG AIRPORT<br>CONSTRUCTION PROJECT  |            |             |       |         |          |           |
| JAPAN INTERNATIONAL COOPERATION AGENCY<br>(JICA)   |            |             |       |         |          |           |
| B  | 1 AUG. '84 | K.V.        | m.y.  | K.A.    | K.M.     | M.K.      |
| 1  | SITB. 01   | K.V.        | m.y.  | K.A.    | K.M.     | M.K.      |
| REVISORS   | DATE       | DESIGNED    | DRAWN | CHECKED | REVIEWED | SUBMITTED |
| PLATFORM VP5<br>BAR ARRANGEMENT<br>(SHEET 1 OF 7)  |            |             |       |         |          |           |
| PACKAGE: I CIVIL AND ARCHITECTURAL WORK  |            |             |       |         |          |           |
| SCALE  |            | DRAWING NO. |       |         |          |           |
| 1:50   |            | CS-238      |       |         |          |           |

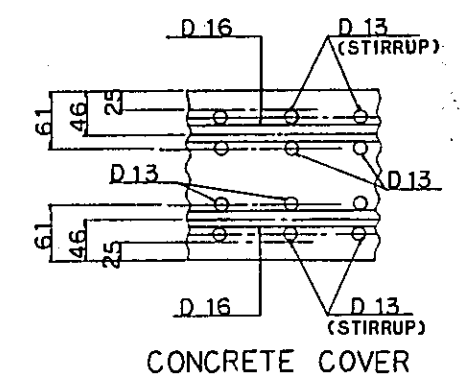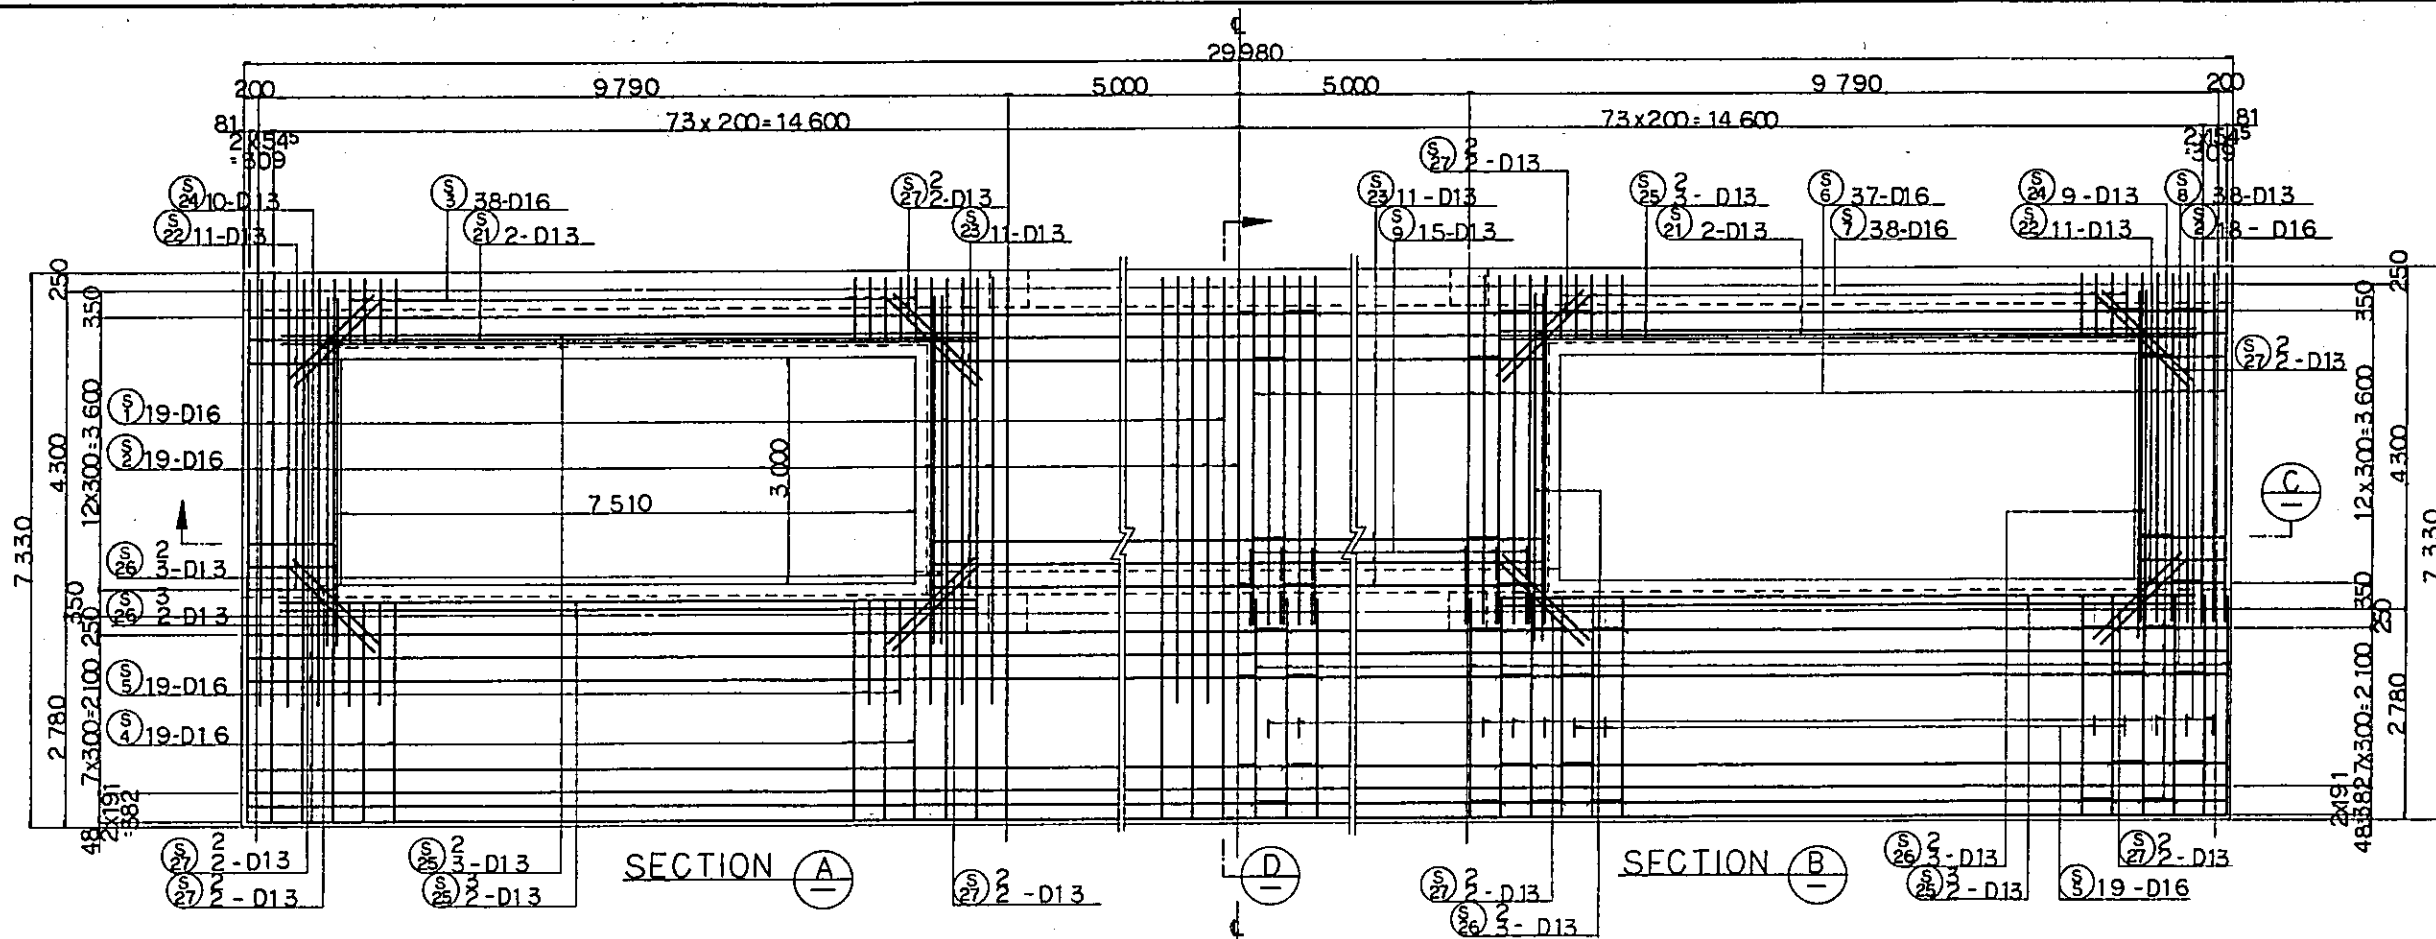

- NOTES:
1. ALL DIMENSIONS ARE SHOWN IN MILLIMETERS UNLESS OTHERWISE INDICATED
  2. REFERENCE DRAWING FOR GENERAL VIEW :CS-237.

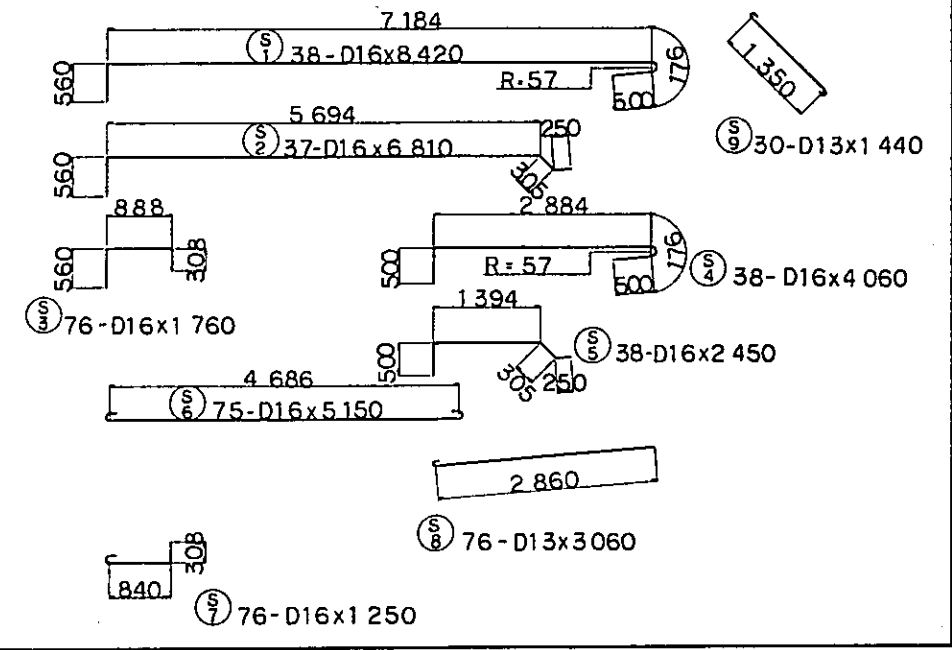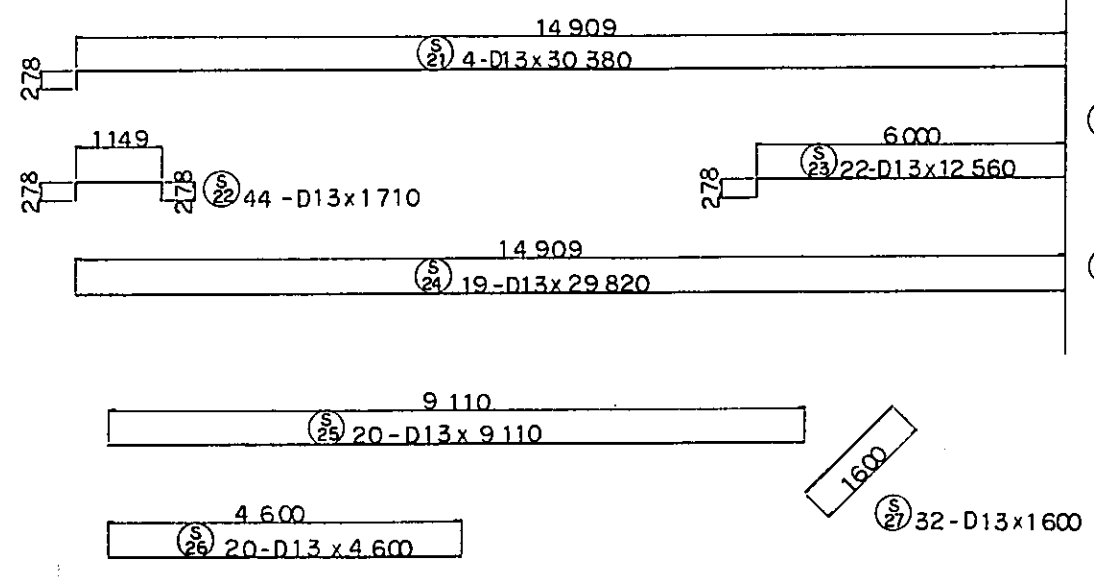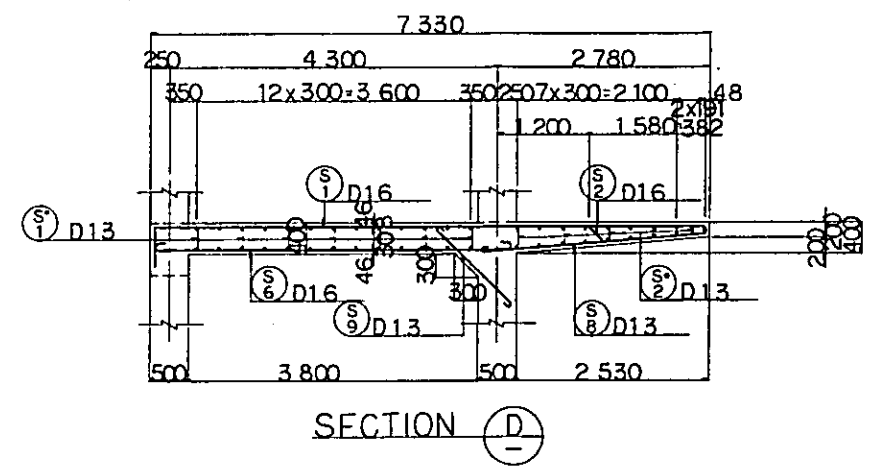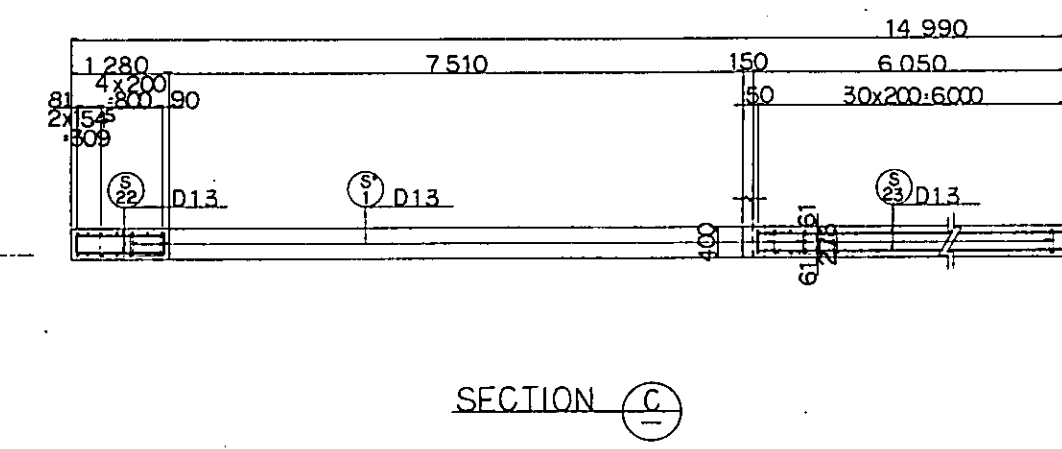

|  |             |          |       |         |          |          |
|--|-------------|----------|-------|---------|----------|----------|
| REPUBLIC OF INDONESIA<br>MINISTRY OF COMMUNICATIONS<br>DIRECTORATE GENERAL OF LAND TRANSPORT<br>AND INLAND WATERWAYS |             |          |       |         |          |          |
| NEW RAILWAY LINE FOR CENKARENG AIRPORT<br>CONSTRUCTION PROJECT   |             |          |       |         |          |          |
| JAPAN INTERNATIONAL COOPERATION AGENCY<br>(JICA)   |             |          |       |         |          |          |
| B  | 1 AUG 84    | K.V.     | m.y.  | K.H.    | K.M.     | m.K.     |
| A  | 1 FEB 84    | K.V.     | m.y.  | K.H.    | K.M.     | m.K.     |
| REVISIONS  | DATE        | DESIGNED | DRAWN | CHECKED | REVIEWED | APPROVED |
| PLATFORM VP5<br>BAR ARRANGEMENT<br>(SHEET 2 OF 7)  |             |          |       |         |          |          |
| PACKAGE: I CIVIL AND ARCHITECTURAL WORK  |             |          |       |         |          |          |
| SCALE  | DRAWING NO. |          |       |         |          |          |
| 1:50   | CS-239      |          |       |         |          |          |

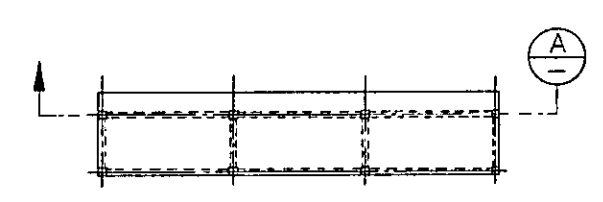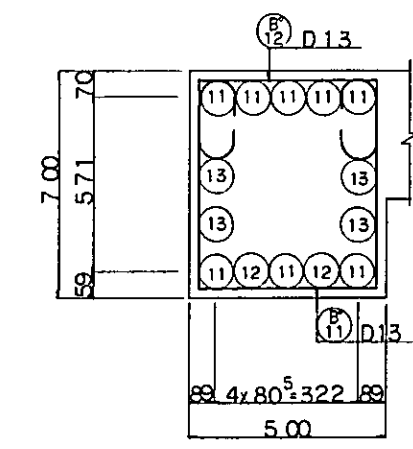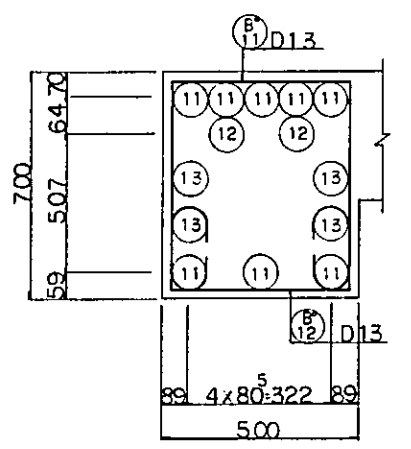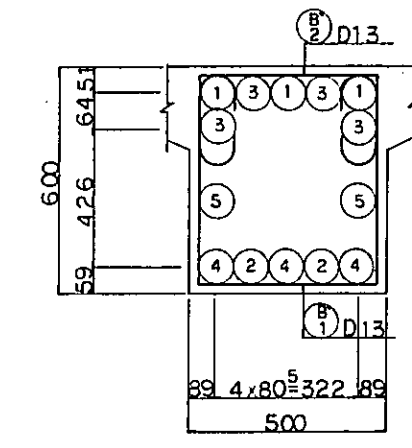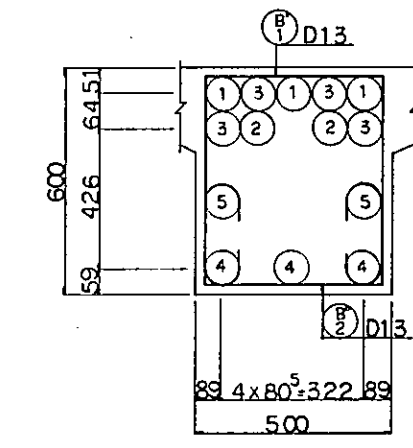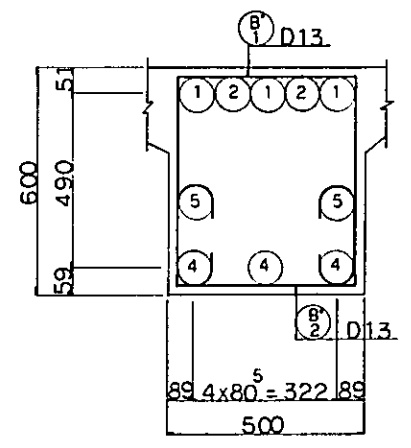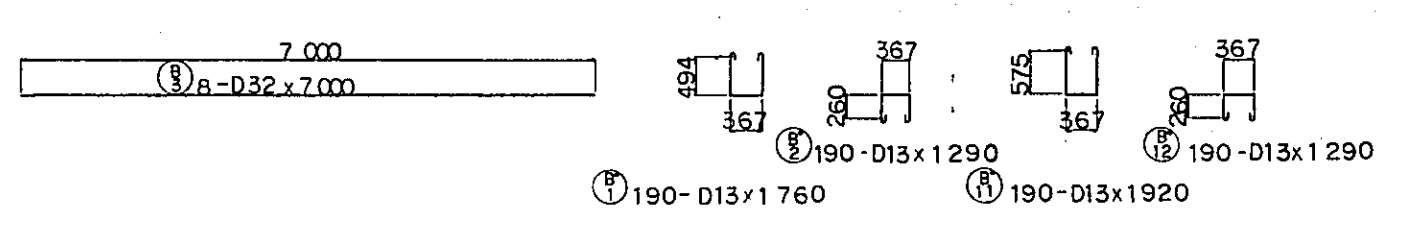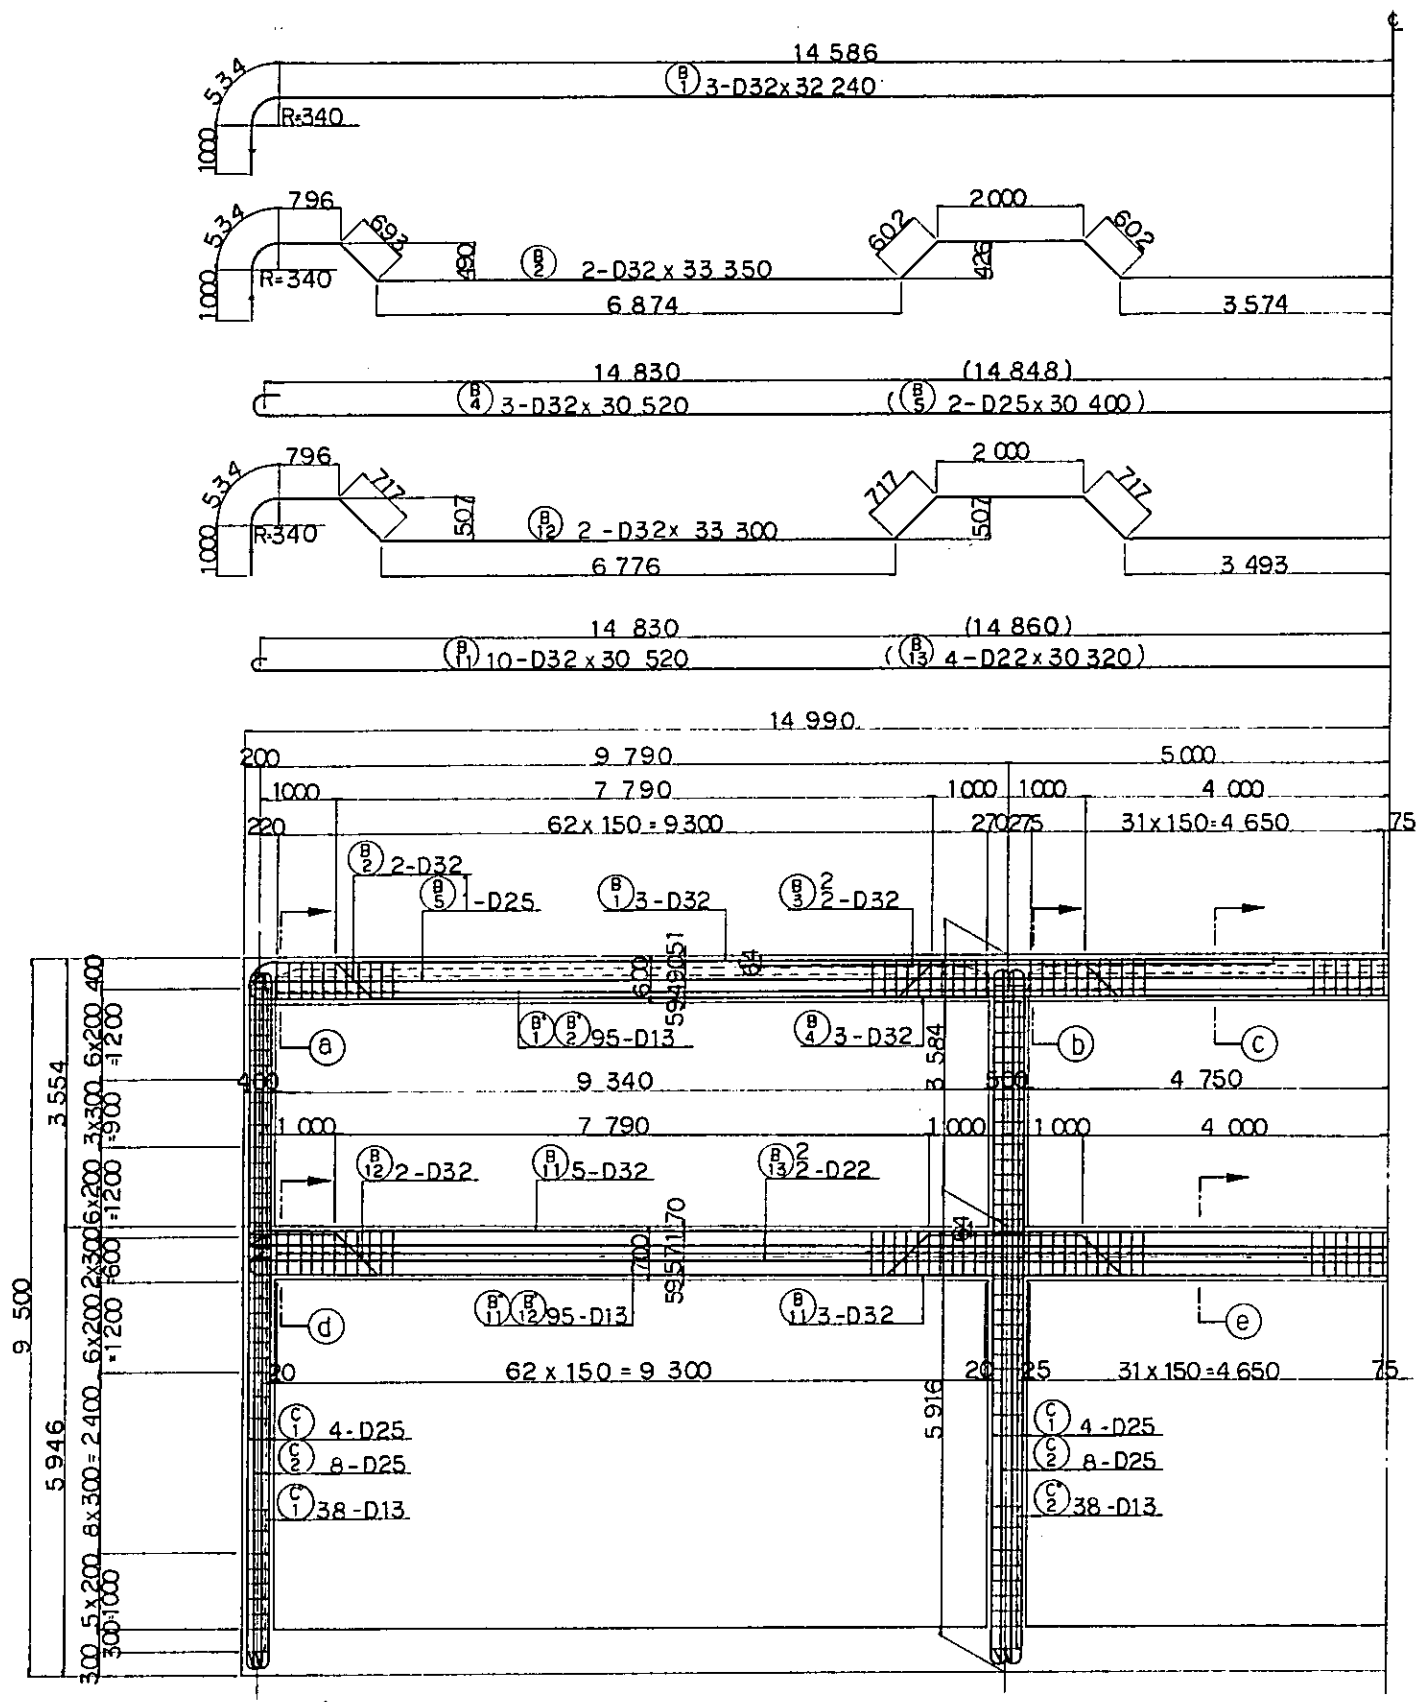


- NOTES:  
 1. ALL DIMENSIONS ARE SHOWN IN MILLIMETERS UNLESS OTHERWISE INDICATED  
 2. REFERENCE DRAWING FOR GENERAL VIEW :CS-237.

|   |          |          |       |         |          |
|---|----------|----------|-------|---------|----------|
| REPUBLIC OF INDONESIA<br>MINISTRY OF COMMUNICATIONS<br>DIRECTORATE GENERAL OF LAND TRANSPORT AND INLAND WATERWAYS |          |          |       |         |          |
| NEW RAILWAY LINE FOR CENGKARENG AIRPORT<br>CONSTRUCTION PROJECT   |          |          |       |         |          |
| JAPAN INTERNATIONAL COOPERATION AGENCY<br>(JICA)  |          |          |       |         |          |
| B   | 1 AUG 84 | K.J.     | m.y.  | K.A.    | K.M.     |
| A   | 1 FEB 84 | K.J.     | m.y.  | K.A.    | K.M.     |
| REVISIONS   | DATE     | DESIGNED | DRAWN | CHECKED | REVIEWED |
| PACKAGE: I CIVIL AND ARCHITECTURAL WORK<br>SCALE: 1:50<br>DRAWING NO: CS-240                                      |          |          |       |         |          |


SECTION A-A

SECTION d-d

SECTION e-e

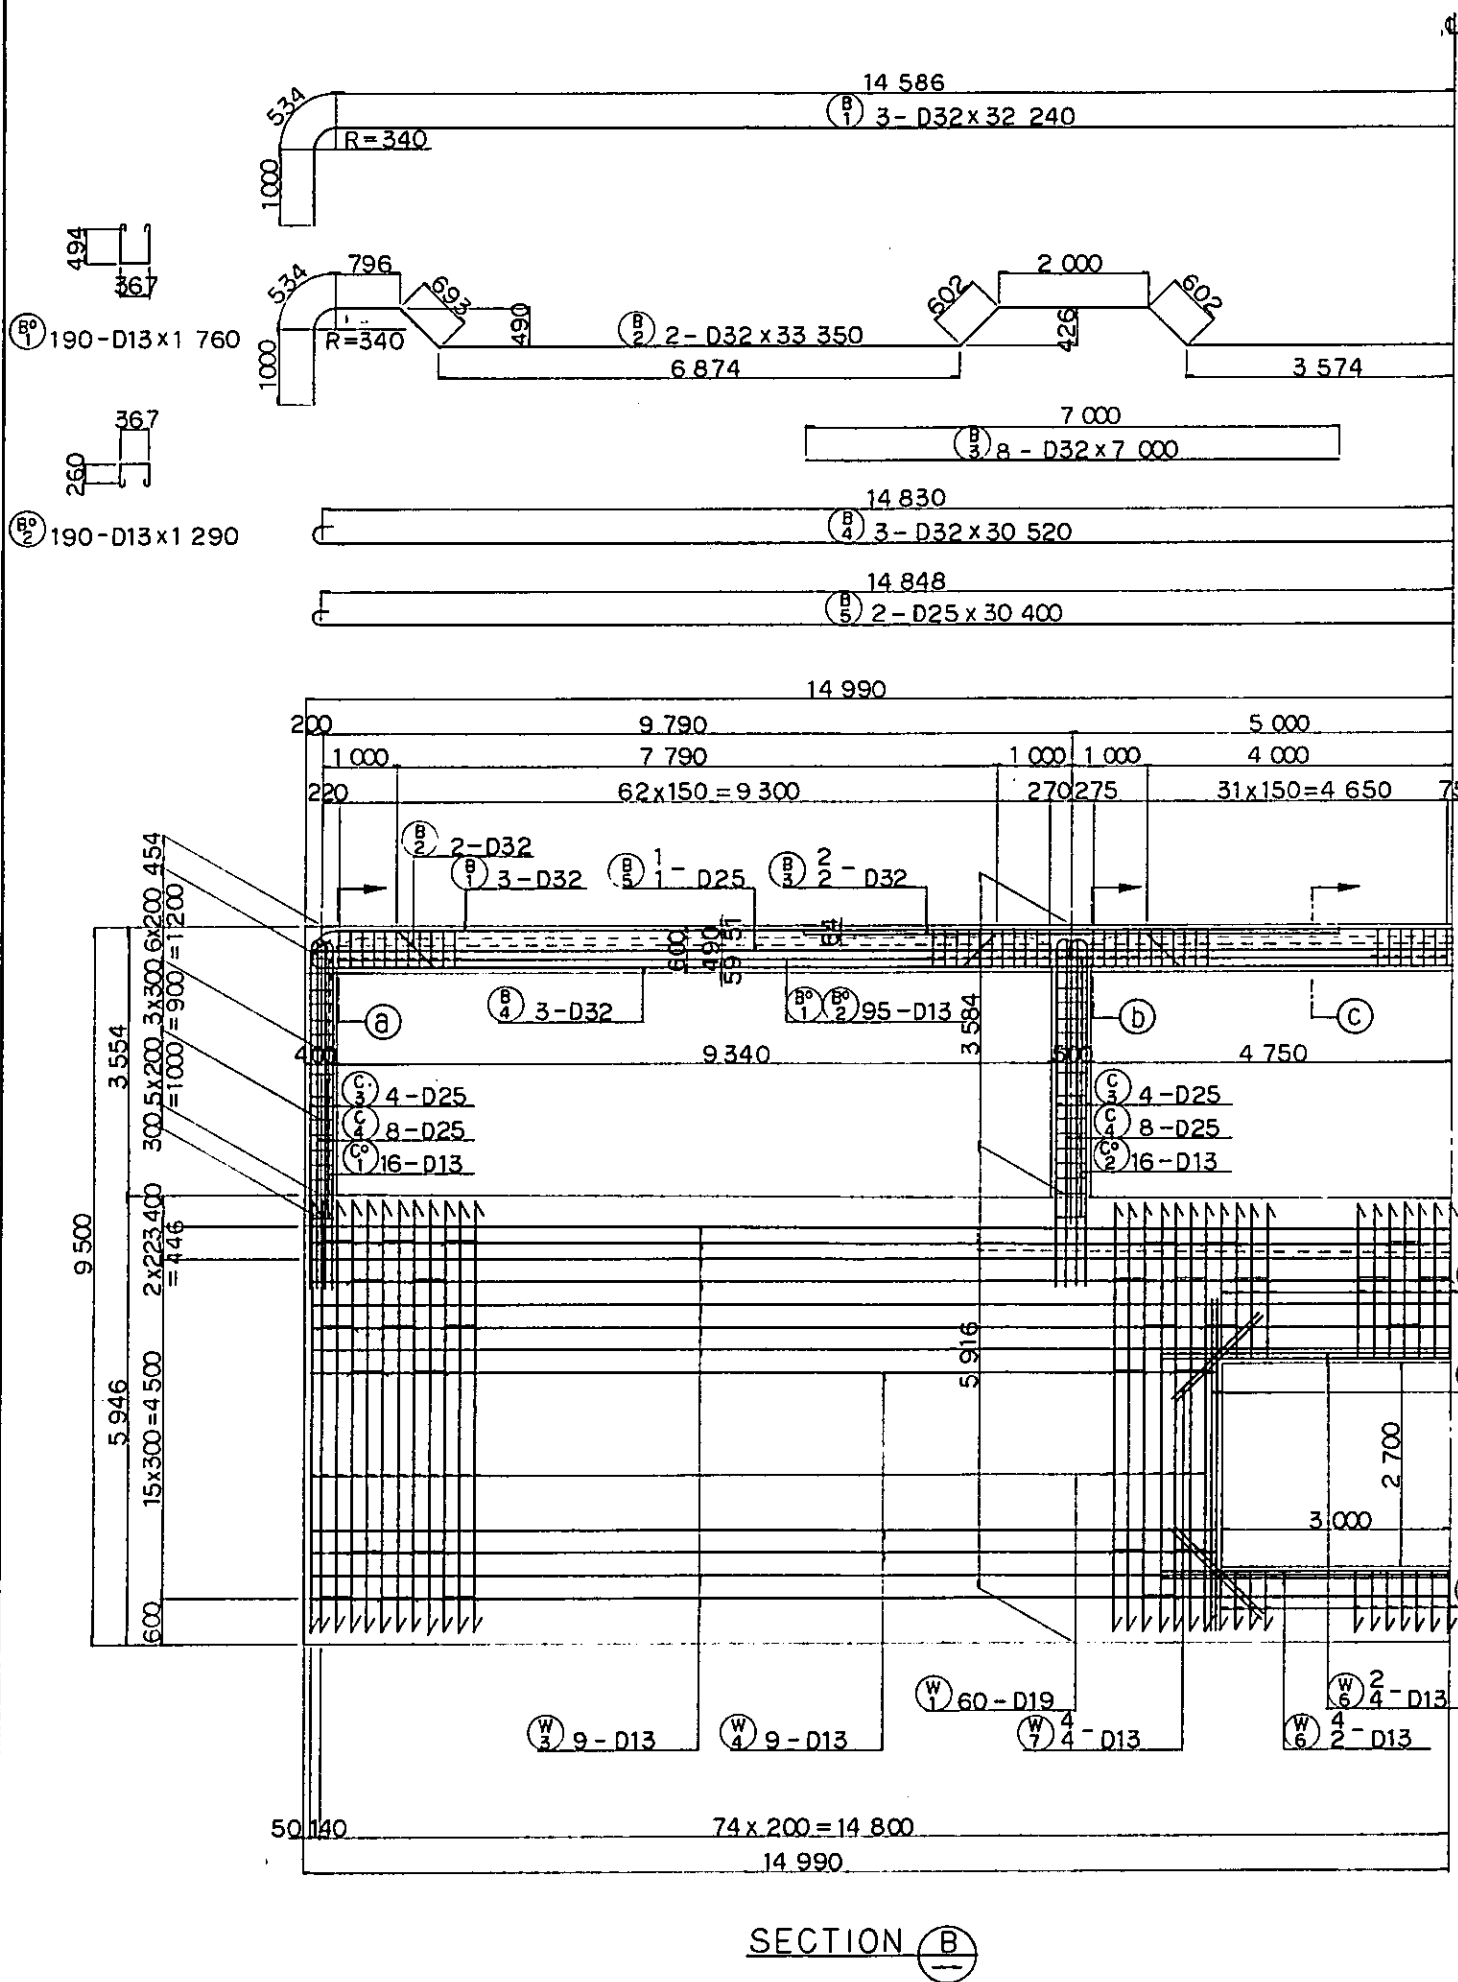


SECTION B

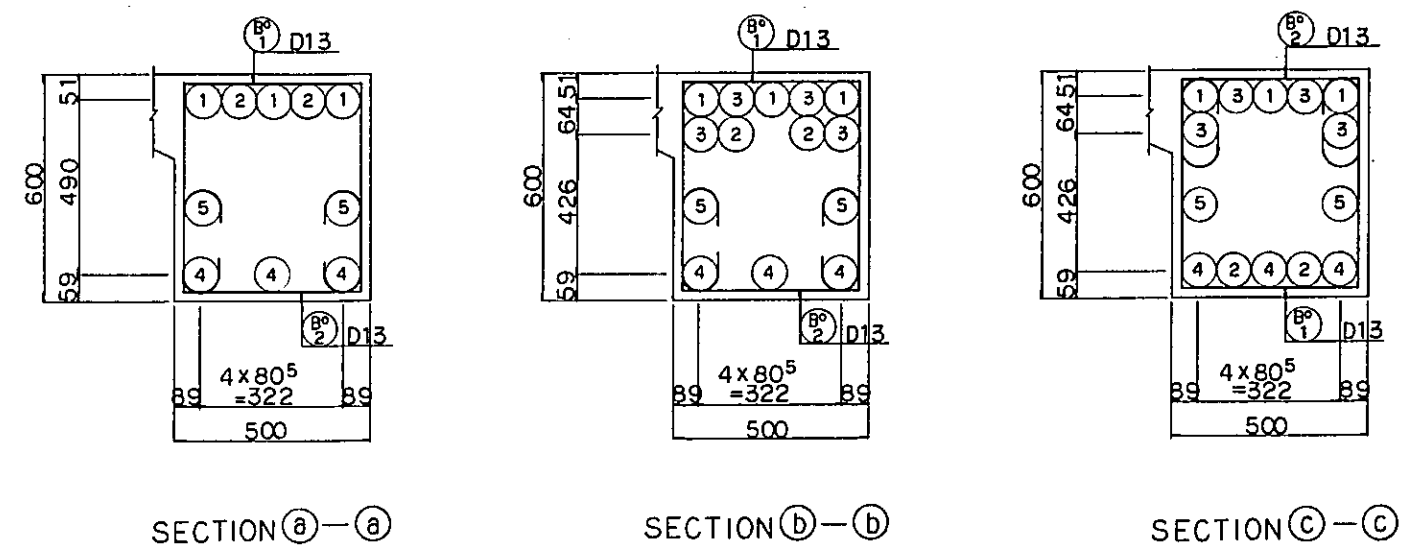

SECTION A-A

SECTION B-B





SECTION C-C

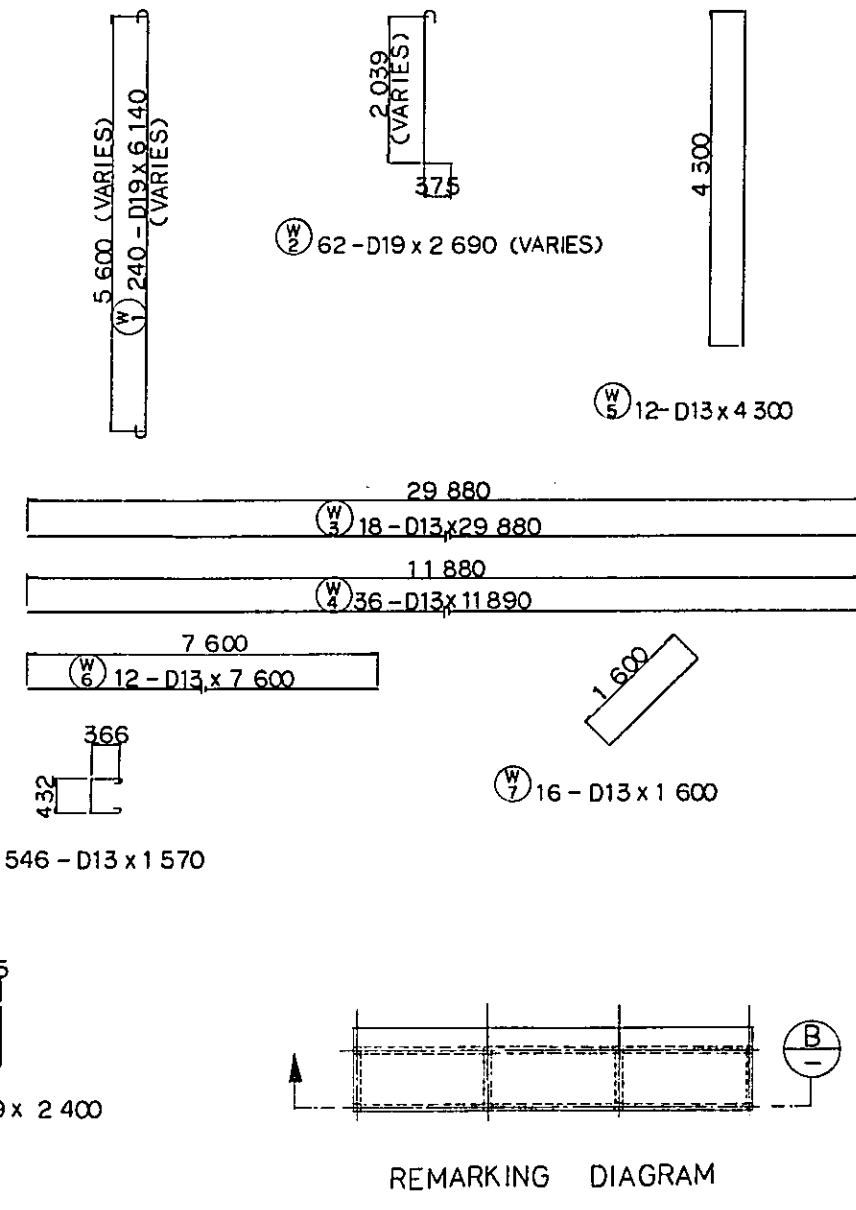

REMARKING DIAGRAM


- NOTES:
1. ALL DIMENSIONS ARE SHOWN IN MILLIMETERS UNLESS OTHERWISE INDICATED
  2. REFERENCE DRAWING FOR GENERAL VIEW :CS-237.

|  |          |                    |       |         |          |
|--|----------|--------------------|-------|---------|----------|
| REPUBLIC OF INDONESIA<br>MINISTRY OF COMMUNICATIONS<br>DIRECTORATE GENERAL OF LAND TRANSPORT<br>AND INLAND WATERWAYS |          |                    |       |         |          |
| NEW RAILWAY LINE FOR CENGKARENG AIRPORT<br>CONSTRUCTION PROJECT  |          |                    |       |         |          |
| JAPAN INTERNATIONAL COOPERATION AGENCY<br>(JICA)   |          |                    |       |         |          |
| B  | 1AUG'84  | K.A.               | M.Y.  | K.A.    | K.M.     |
| A  | 10FEB'84 | K.A.               | M.Y.  | K.A.    | K.M.     |
| REVISIONS  | DATE     | DESIGNED           | DRAWN | CHECKED | REVIEWED |
| PLATFORM VP5<br>BAR ARRANGEMENT<br>(SHEET 4 OF 7)  |          |                    |       |         |          |
| PACKAGE: I CIVIL AND ARCHITECTURAL WORK  |          |                    |       |         |          |
| SCALE: 1:50  |          | DRAWING NO: CS-241 |       |         |          |

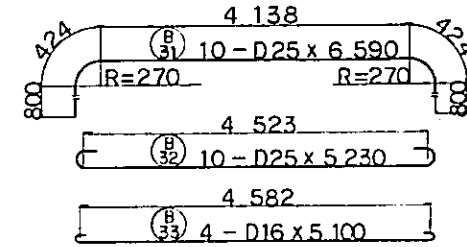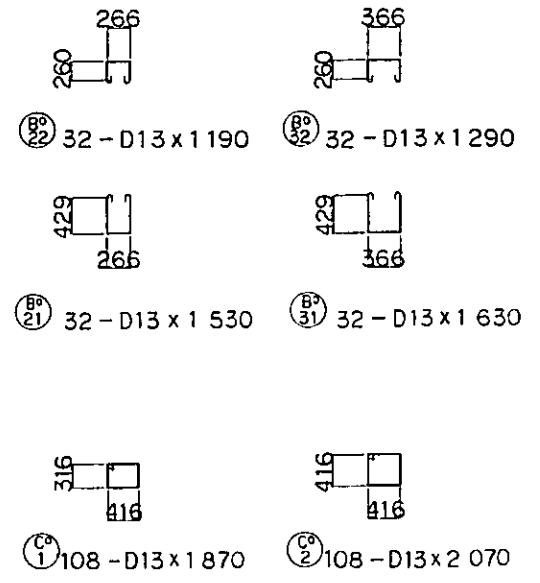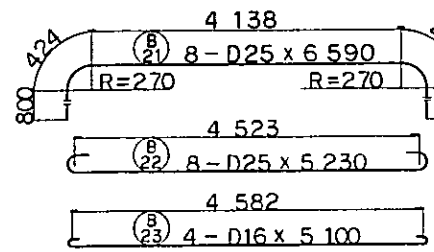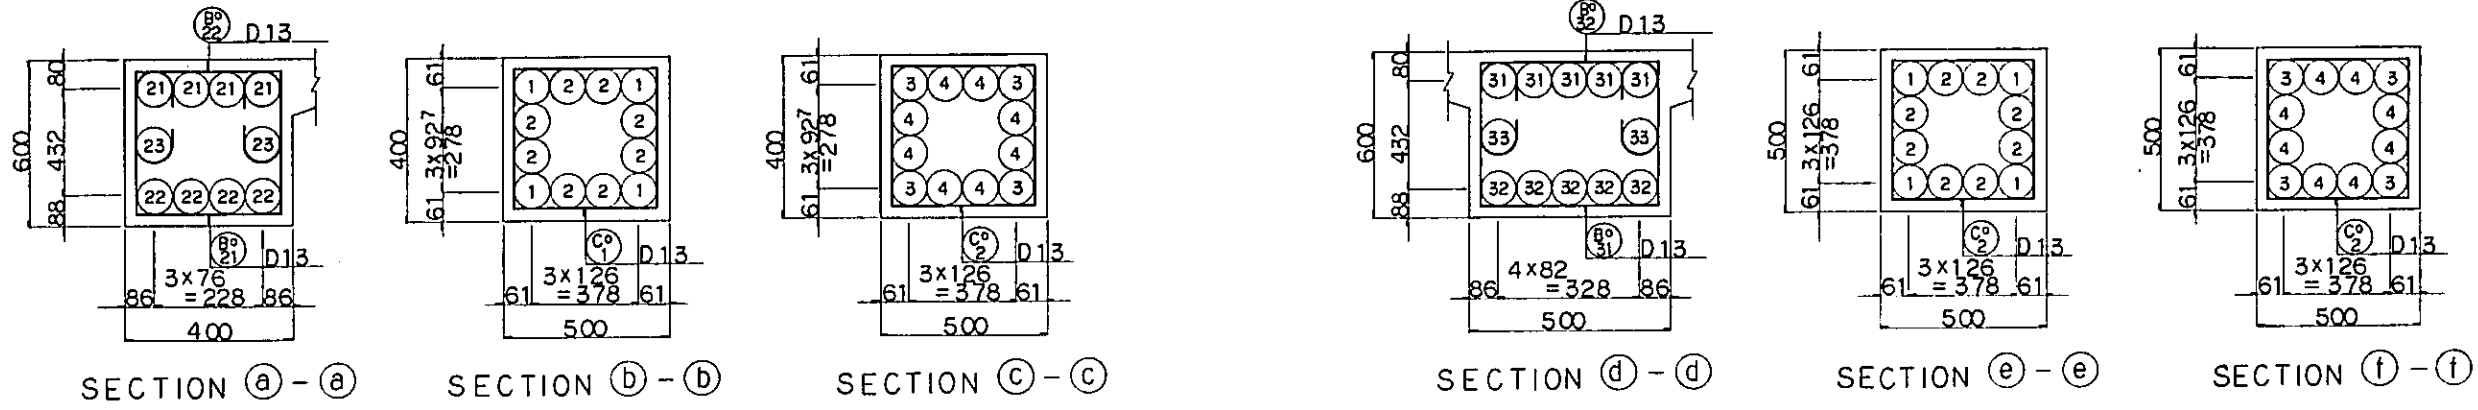


NOTES:


1. ALL DIMENSIONS ARE SHOWN IN MILLIMETERS UNLESS OTHERWISE INDICATED
2. REFERENCE DRAWING FOR GENERAL VIEW : CS-237.

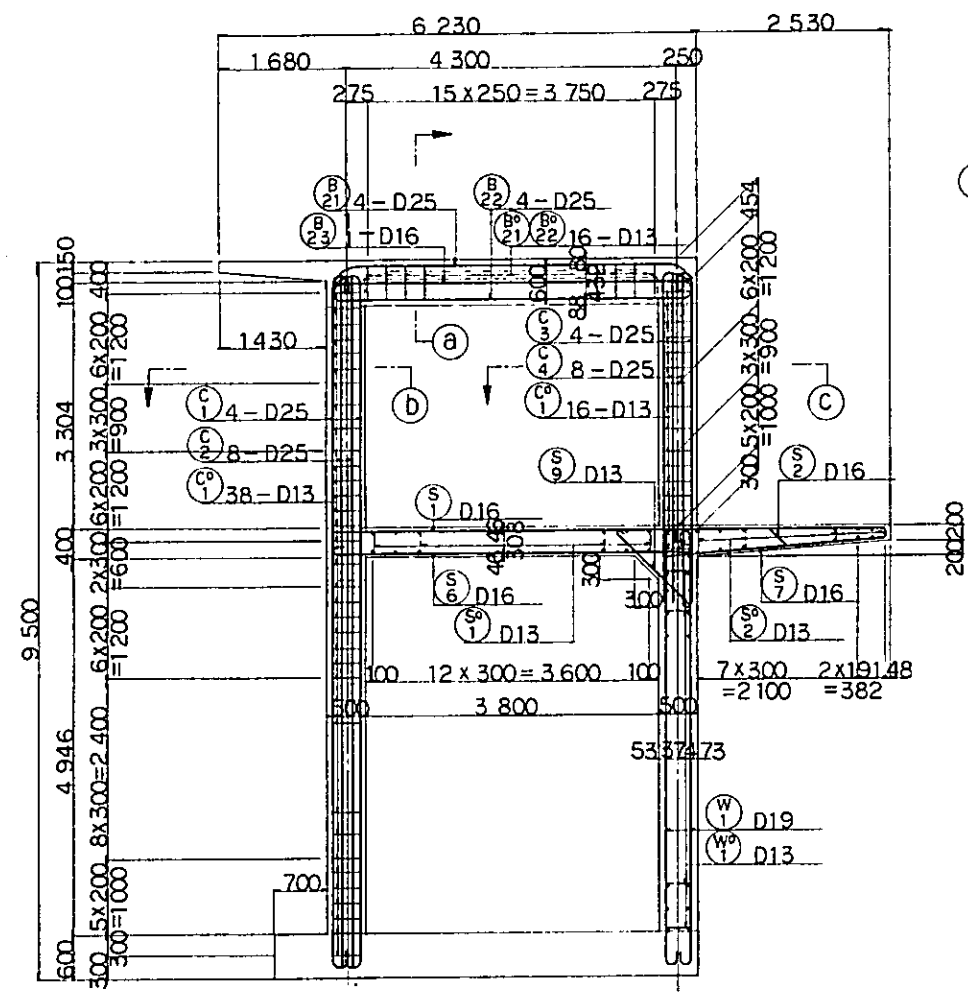

SECTION A

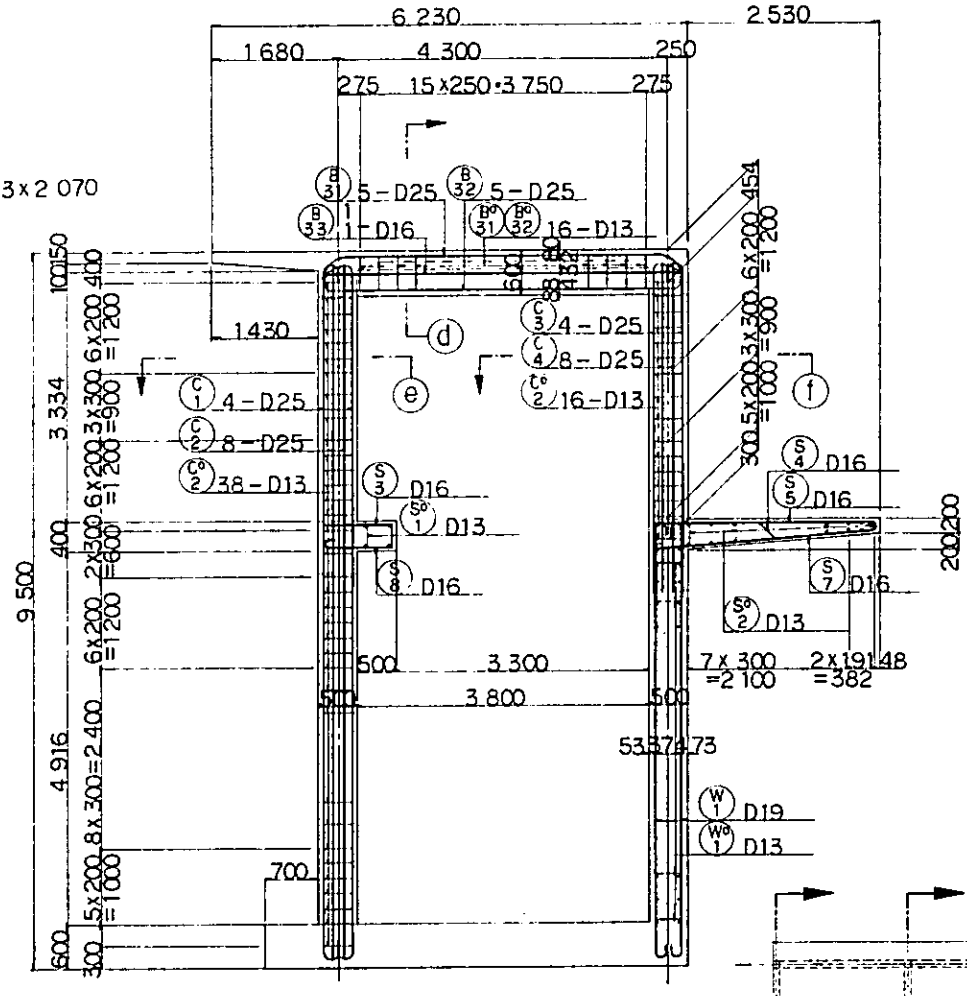


SECTION B

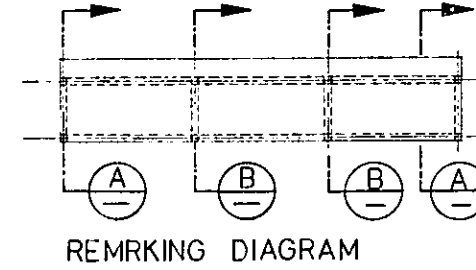

REMARKING DIAGRAM

|   |         |          |                           |         |          |           |
|---|---------|----------|---------------------------|---------|----------|-----------|
| <p>REPUBLIC OF INDONESIA<br/>         MINISTRY OF COMMUNICATIONS<br/>         DIRECTORATE GENERAL OF LAND TRANSPORT<br/>         AND INLAND WATERWAYS</p> |         |          |                           |         |          |           |
| <p>NEW RAILWAY LINE FOR CENGKARENG AIRPORT<br/>         CONSTRUCTION PROJECT</p>  |         |          |                           |         |          |           |
| <p>JAPAN INTERNATIONAL COOPERATION AGENCY<br/>         (JICA)</p>   |         |          |                           |         |          |           |
| B   | 1AUG/84 | K.L.     | m.y.                      | K.S.    | K.M.     | m.K.      |
| A   | 1AUG/84 | K.L.     | m.y.                      | K.S.    | K.M.     | m.K.      |
| REVISIONS   | DATE    | DESIGNED | DRAWN                     | CHECKED | REVIEWED | SUBMITTED |
| <p>PLATFORM VP5<br/>         BAR ARRANGEMENT<br/>         (SHEET 5 OF 7)</p>  |         |          |                           |         |          |           |
| <p>PACKAGE: I CIVIL AND ARCHITECTURAL WORK</p>  |         |          |                           |         |          |           |
| <p>SCALE: 1:50</p>  |         |          | <p>DRAWING NO: CS-242</p> |         |          |           |




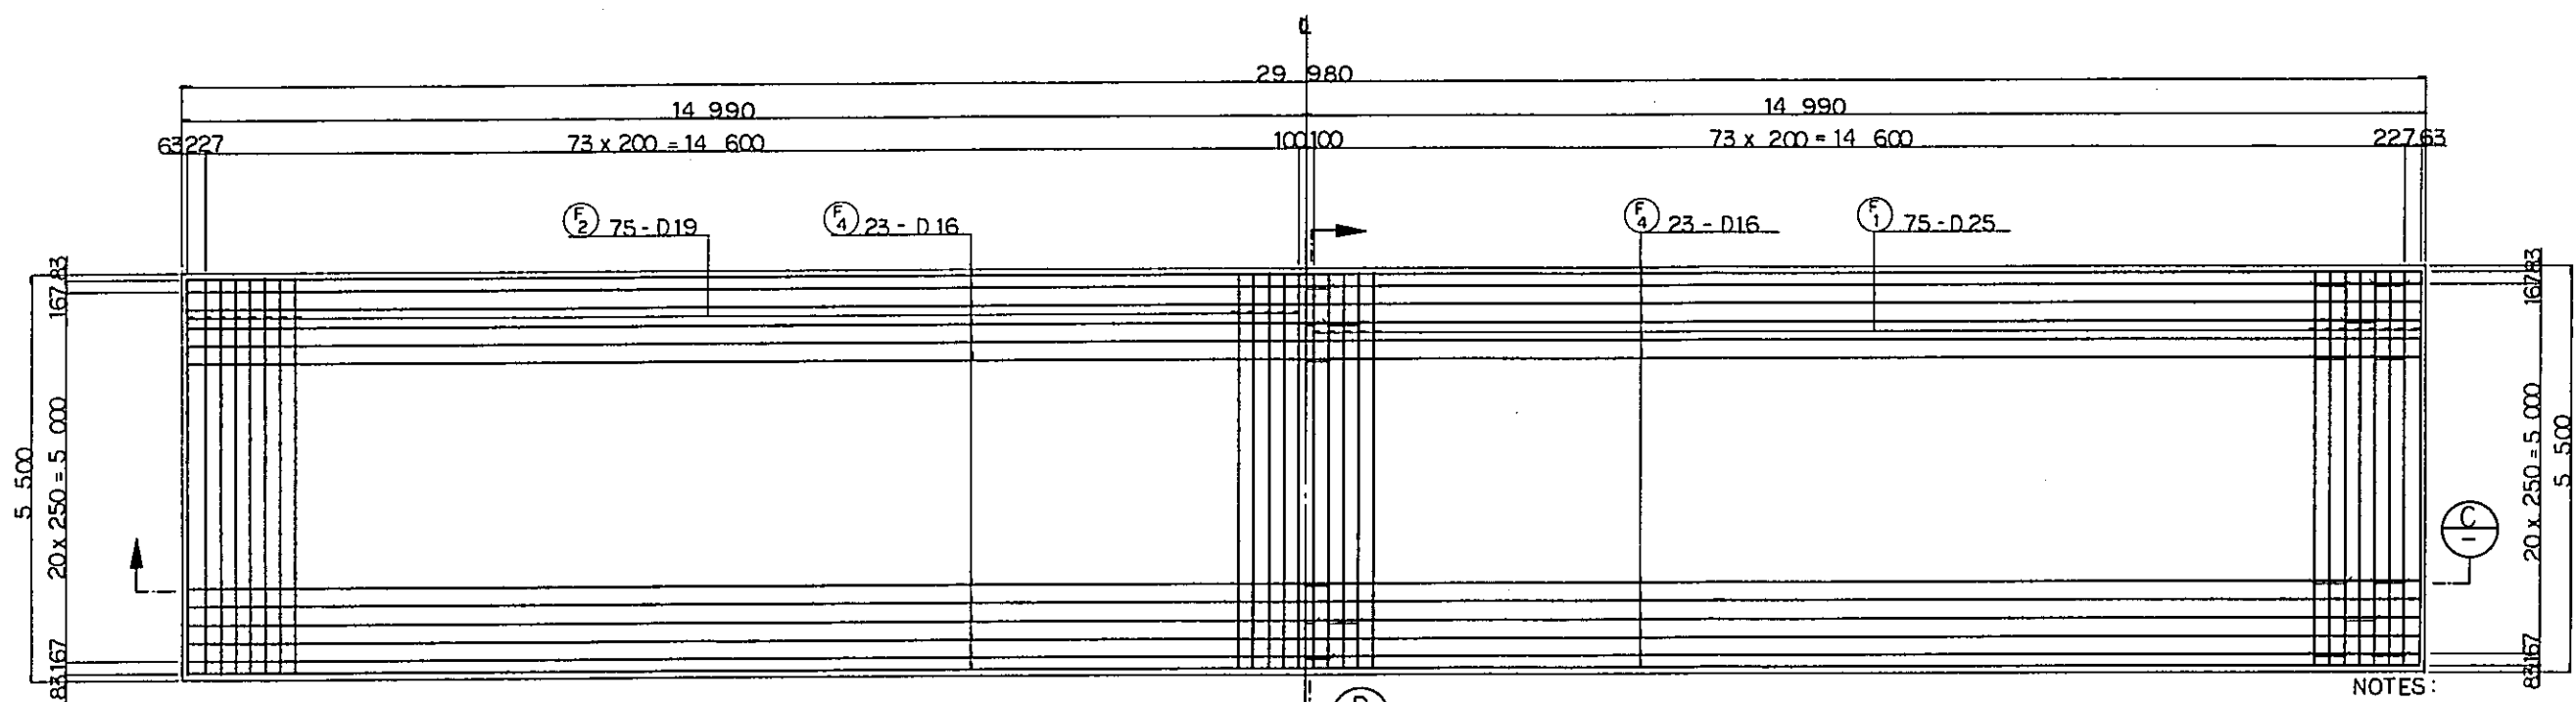


SECTION A

SECTION B

- NOTES:
1. ALL DIMENSIONS ARE SHOWN IN MILLIMETERS UNLESS OTHERWISE INDICATED
  2. REFERENCE DRAWING FOR GENERAL VIEW : CS-237.

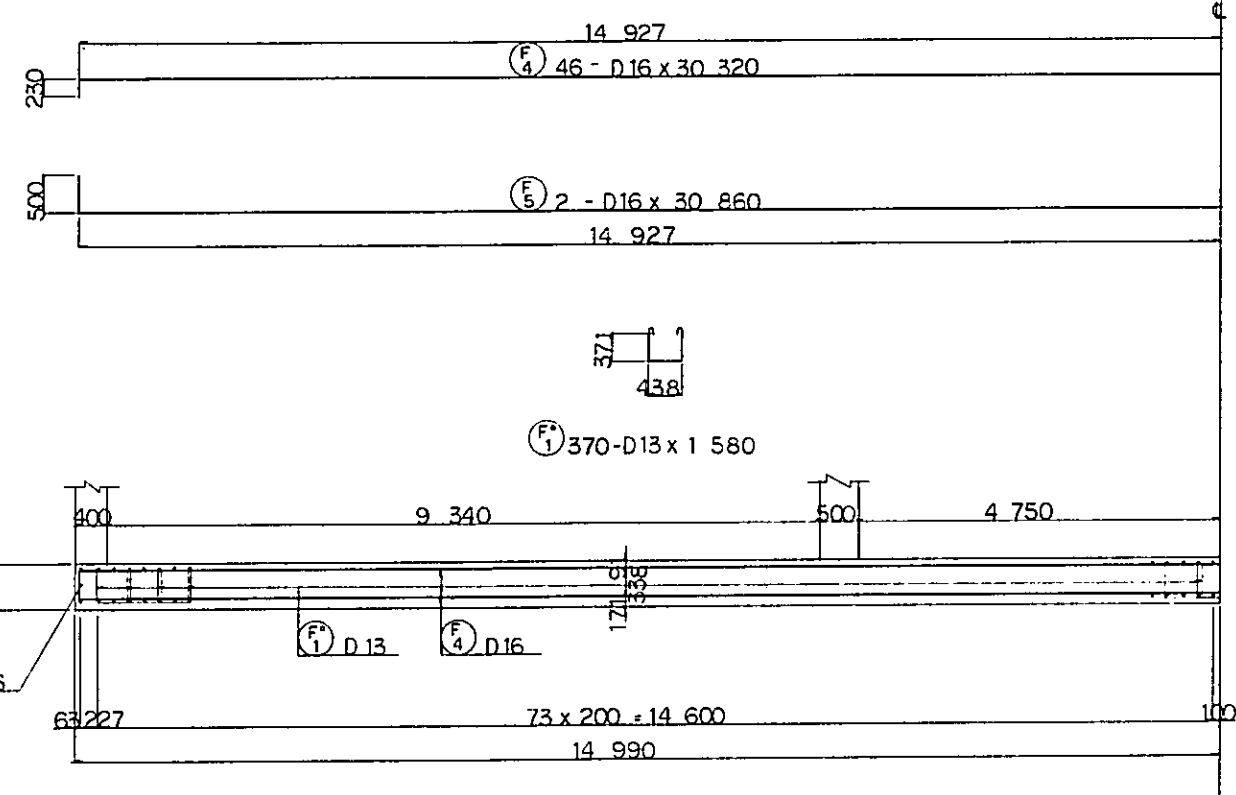


SECTION C

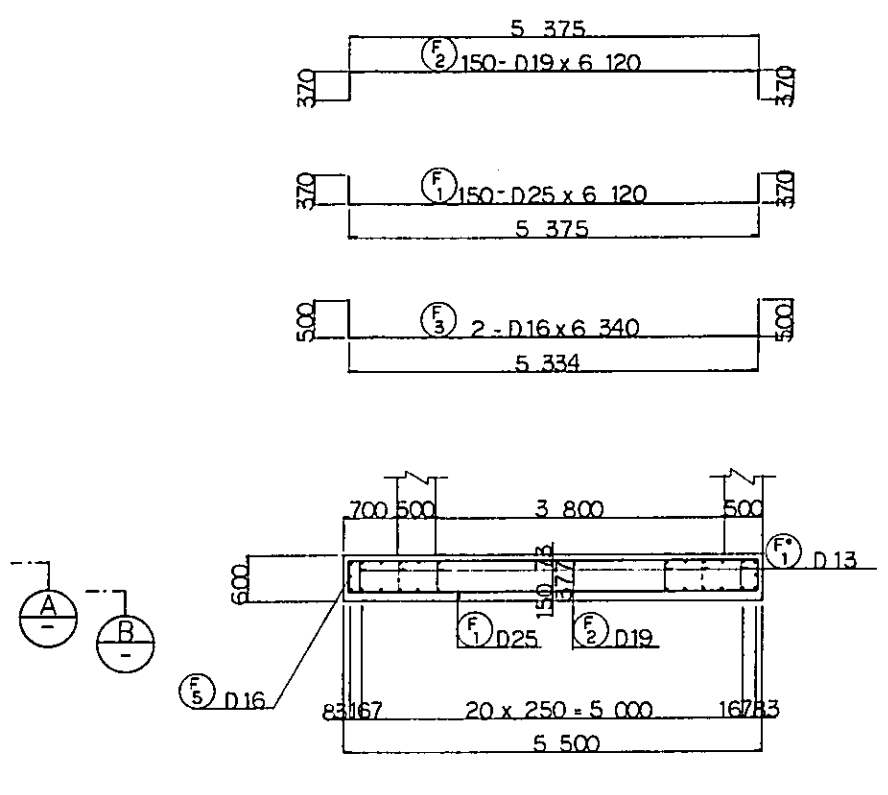


SECTION D

|  |             |          |       |         |          |           |
|--|-------------|----------|-------|---------|----------|-----------|
| REPUBLIC OF INDONESIA<br>MINISTRY OF COMMUNICATIONS<br>DIRECTORATE GENERAL OF LAND TRANSPORT<br>AND INLAND WATERWAYS |             |          |       |         |          |           |
| NEW RAILWAY LINE FOR CENGKARENG AIRPORT<br>CONSTRUCTION PROJECT  |             |          |       |         |          |           |
| JAPAN INTERNATIONAL COOPERATION AGENCY<br>(JICA)   |             |          |       |         |          |           |
| B  | 1AUG'84     | K.V      | m.y   | K.S     | K.M      | m.K       |
| A  | 1FEB'84     | K.V      | m.y   | K.A     | K.M      | m.K       |
| REVISIONS  | DATE        | DESIGNED | DRAWN | CHECKED | REVIEWED | SUBMITTED |
| PLATFORM VP5<br>BAR ARRANGEMENT<br>(SHEET 6 OF 7)  |             |          |       |         |          |           |
| PACKAGE: I CIVIL AND ARCHITECTURAL WORK  |             |          |       |         |          |           |
| SCALE  | DRAWING NO. |          |       |         |          |           |
| 1:50   | CS-243      |          |       |         |          |           |

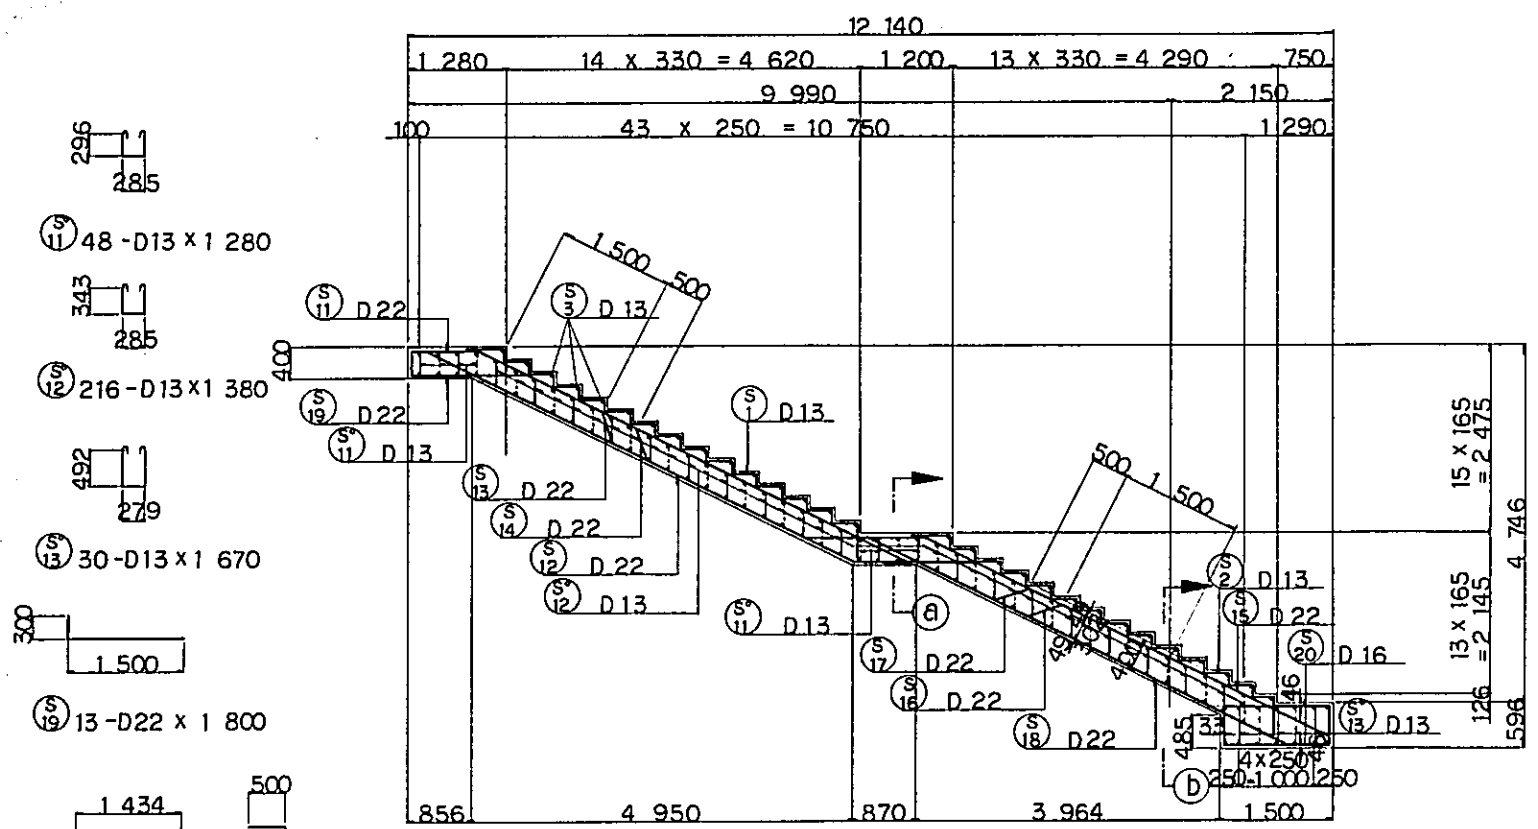


SECTION A

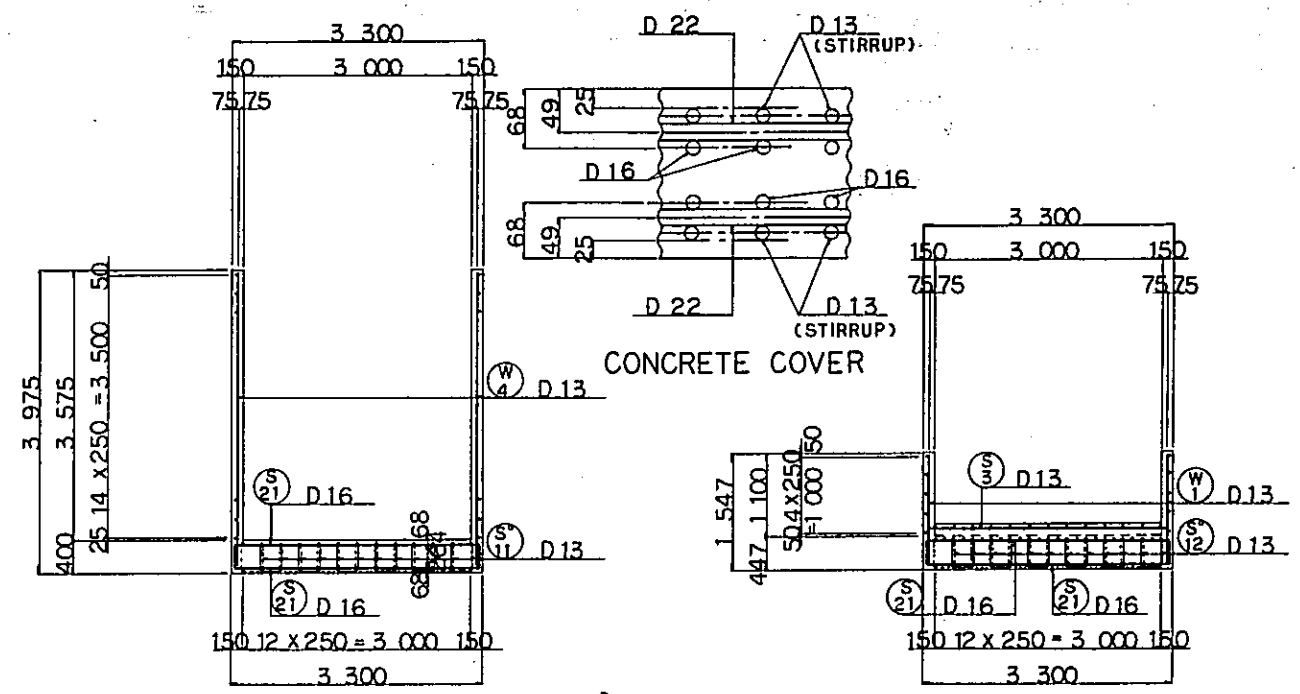


SECTION A - A

SECTION B - B

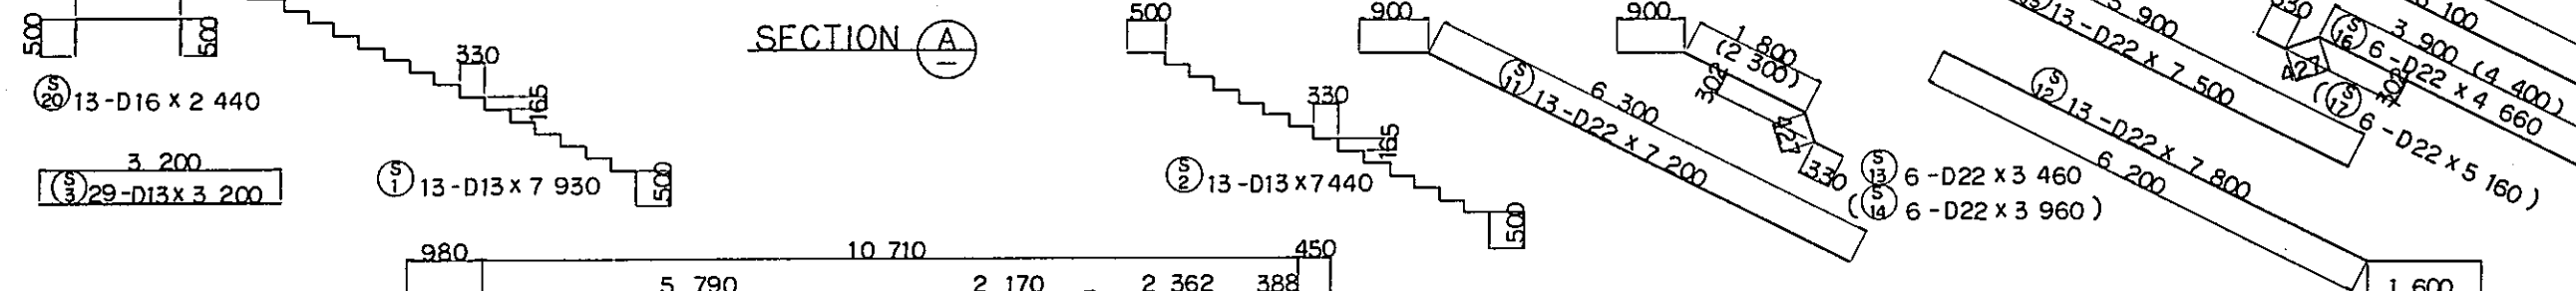

REMARKING DIAGRAM

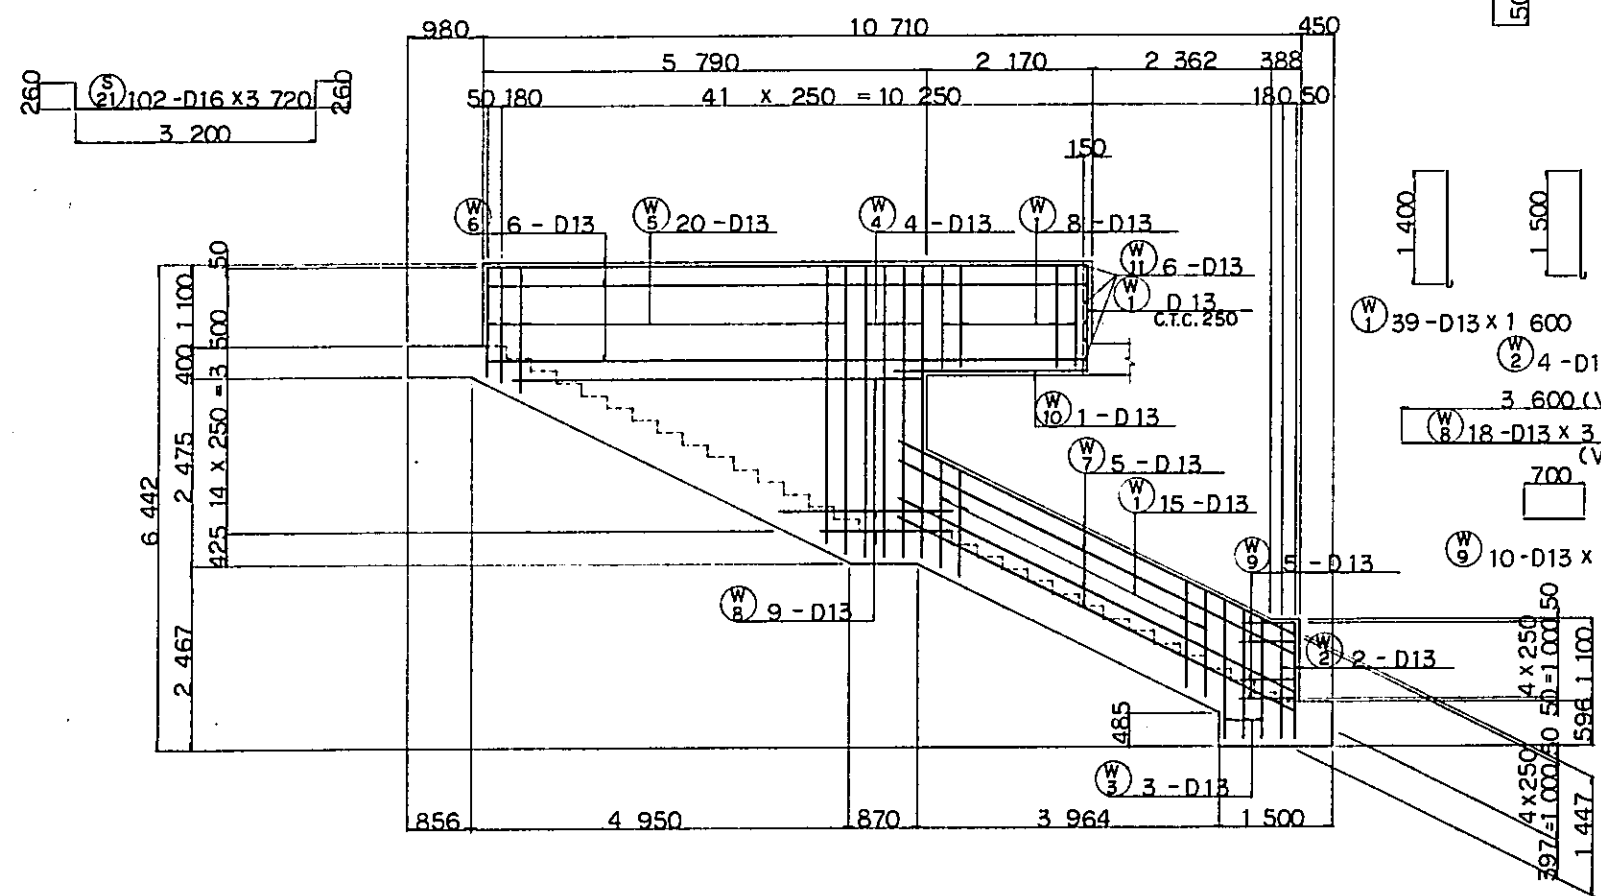

WALL BAR ARRANGEMENT

- NOTES :
1. ALL DIMENSIONS ARE SHOWN IN MILLIMETERS UNLESS OTHERWISE INDICATED
  2. REFERENCE DRAWING FOR GENERAL VIEW :CS-237.

REPUBLIC OF INDONESIA  
 MINISTRY OF COMMUNICATIONS,  
 DIRECTORATE GENERAL OF LAND TRANSPORT  
 AND INLAND WATERWAYS


NEW RAILWAY LINE FOR CENGKARENG AIRPORT  
 CONSTRUCTION PROJECT

JAPAN INTERNATIONAL COOPERATION AGENCY  
 (JICA)

|           |         |          |          |         |          |          |
|-----------|---------|----------|----------|---------|----------|----------|
| B         | 1AUG'84 | K.I.M.Y. | K.A.K.M. | K.K.    |          |          |
| A         |         | K.I.M.Y. | K.A.K.M. | K.K.    |          |          |
| REVISIONS | DATE    | DESIGNED | DRAWN    | CHECKED | REVIEWED | APPROVED |


PLATFORM VP5  
 BAR ARRANGEMENT  
 (SHEET 7 OF 7)

PACKAGE: I CIVIL AND ARCHITECTURAL WORK  
 SCALE: 1:50 DRAWING NO: CS-244

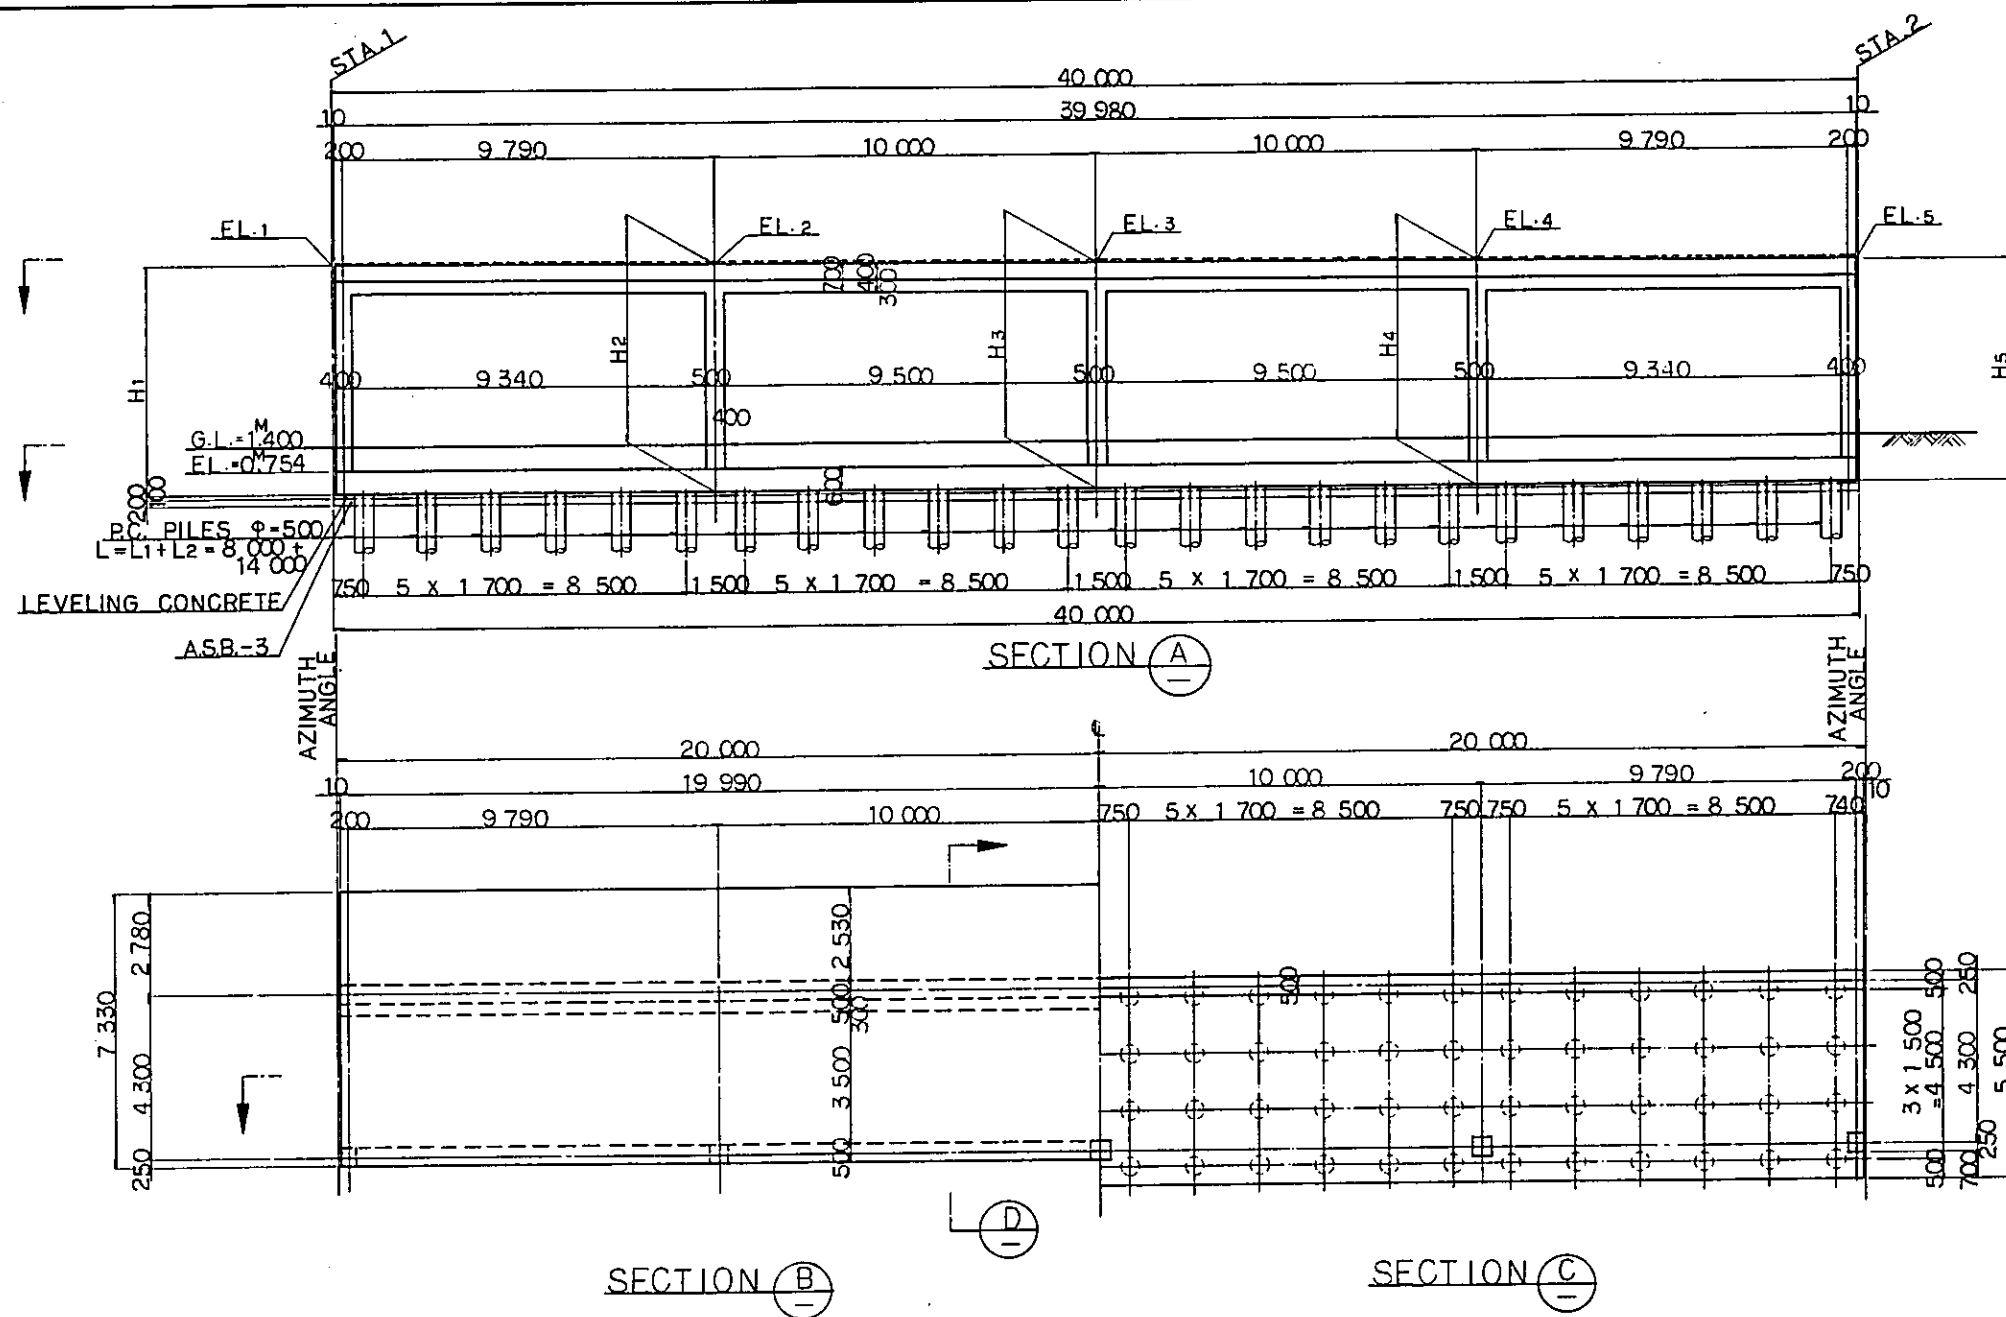

- NOTES :
1. ALL DIMENSIONS ARE SHOWN IN MILLIMETERS UNLESS OTHERWISE INDICATED
  2. REFERENCE DRAWING FOR BAR ARRANGEMENT: CS-238-244
  3. TYPES OF P.C. PILE
    - 1. BOTTOM SURFACE OF FOOTING
    - 2. P.C. PILE CLASS B
    - 3. P.C. PILE CLASS A
  4. GRADING CONCRETE SHALL BE SIMULTANEOUSLY PLACED WITH SLAB CONCRETE

| DESIGN LOAD      | TRAIN LOAD                           | EQUIVALENT TO                                       |
|------------------|--------------------------------------|---|
|                  | SEISMIC EFFECT                       | IN HORIZONTAL DIRECTION $K_h=0.1$                   |
| ALLOWABLE STRESS | REINFORCING BAR                      | ALLOWABLE TENSILE STRESS: 1800 kg/cm <sup>2</sup>   |
|                  | CONCRETE                             | ALLOWABLE COMPRESSIVE STRESS: 90 kg/cm <sup>2</sup> |
| MATERIAL         | TYPE OF REINFORCING BAR              | SD-38   |
|                  | CONCRETE OF DESIGN CRITERIA STRENGTH | $\sigma_{ck} = 2400 \text{ kg/cm}^2$                |
|                  | MAX SIZE OF COARSE AGGREGATE         | 25 mm   |

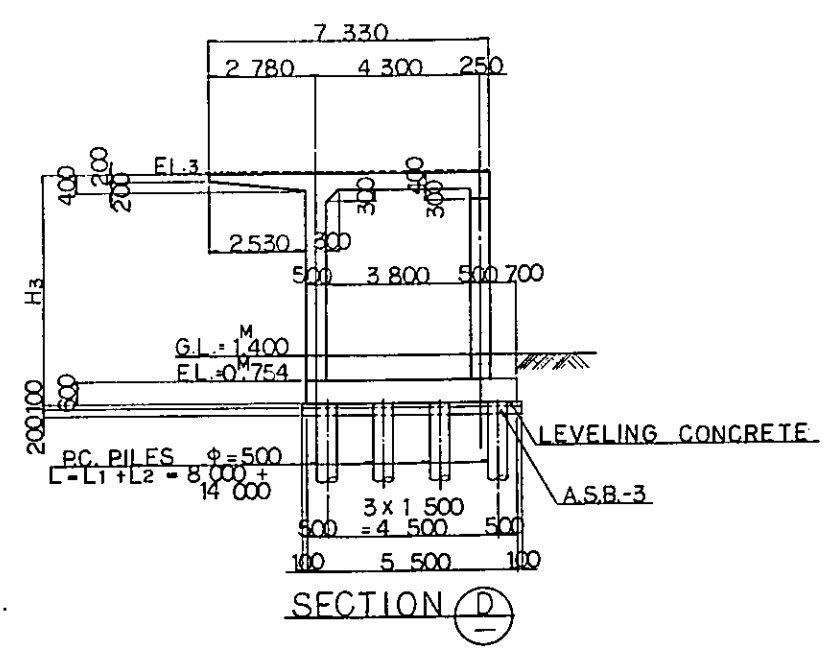

DIMENSION SCHEDULE

| NO.           | (VP 7)                  | (VP 9)                  | REMARKS |
|---------------|-------------------------|-------------------------|---------|
| STA.1         | 17 <sup>M</sup> 310.000 | 17 <sup>M</sup> 420.000 |         |
| STA.2         | 17 <sup>M</sup> 350.000 | 17 <sup>M</sup> 380.000 |         |
| AZIMUTH ANGLE | 345° 30' 45"            | 345° 30' 45"            |         |
| H.1           | 6.066                   | 5.736                   |         |
| H.2           | 6.036                   | 5.766                   |         |
| H.3           | 6.006                   | 5.796                   |         |
| H.4           | 5.976                   | 5.826                   |         |
| H.5           | 5.945                   | 5.856                   |         |
| EL. 1         | 6 <sup>M</sup> 220      | 5 <sup>M</sup> 890      |         |
| EL. 2         | 6 <sup>M</sup> 190      | 5 <sup>M</sup> 920      |         |
| EL. 3         | 6 <sup>M</sup> 160      | 5 <sup>M</sup> 950      |         |
| EL. 4         | 6 <sup>M</sup> 130      | 5 <sup>M</sup> 980      |         |
| EL. 5         | 6 <sup>M</sup> 100      | 6 <sup>M</sup> 010      |         |

REPUBLIC OF INDONESIA  
MINISTRY OF COMMUNICATIONS  
DIRECTORATE GENERAL OF LAND TRANSPORT AND INLAND WATERWAYS




NEW RAILWAY LINE FOR CENGKARENG AIRPORT  
CONSTRUCTION PROJECT

JAPAN INTERNATIONAL COOPERATION AGENCY (JICA)

| REVISIONS | DATE      | DESIGNED | DRAWN | CHECKED | REVIEWED | SUBMITTED |
|-----------|-----------|----------|-------|---------|----------|-----------|
| B         | 1 AUG. 84 | K.V.     | m.y.  | K.A.    | K.M.     | r.k.      |
| A         | 1 FEB. 84 | K.V.     | m.y.  | K.A.    | K.M.     | r.k.      |

PLATFORM VP7, VP9  
GENERAL VIEW

PACKAGE: I CIVIL AND ARCHITECTURAL WORK  
SCALE: 1:100 DRAWING NO: CS-245

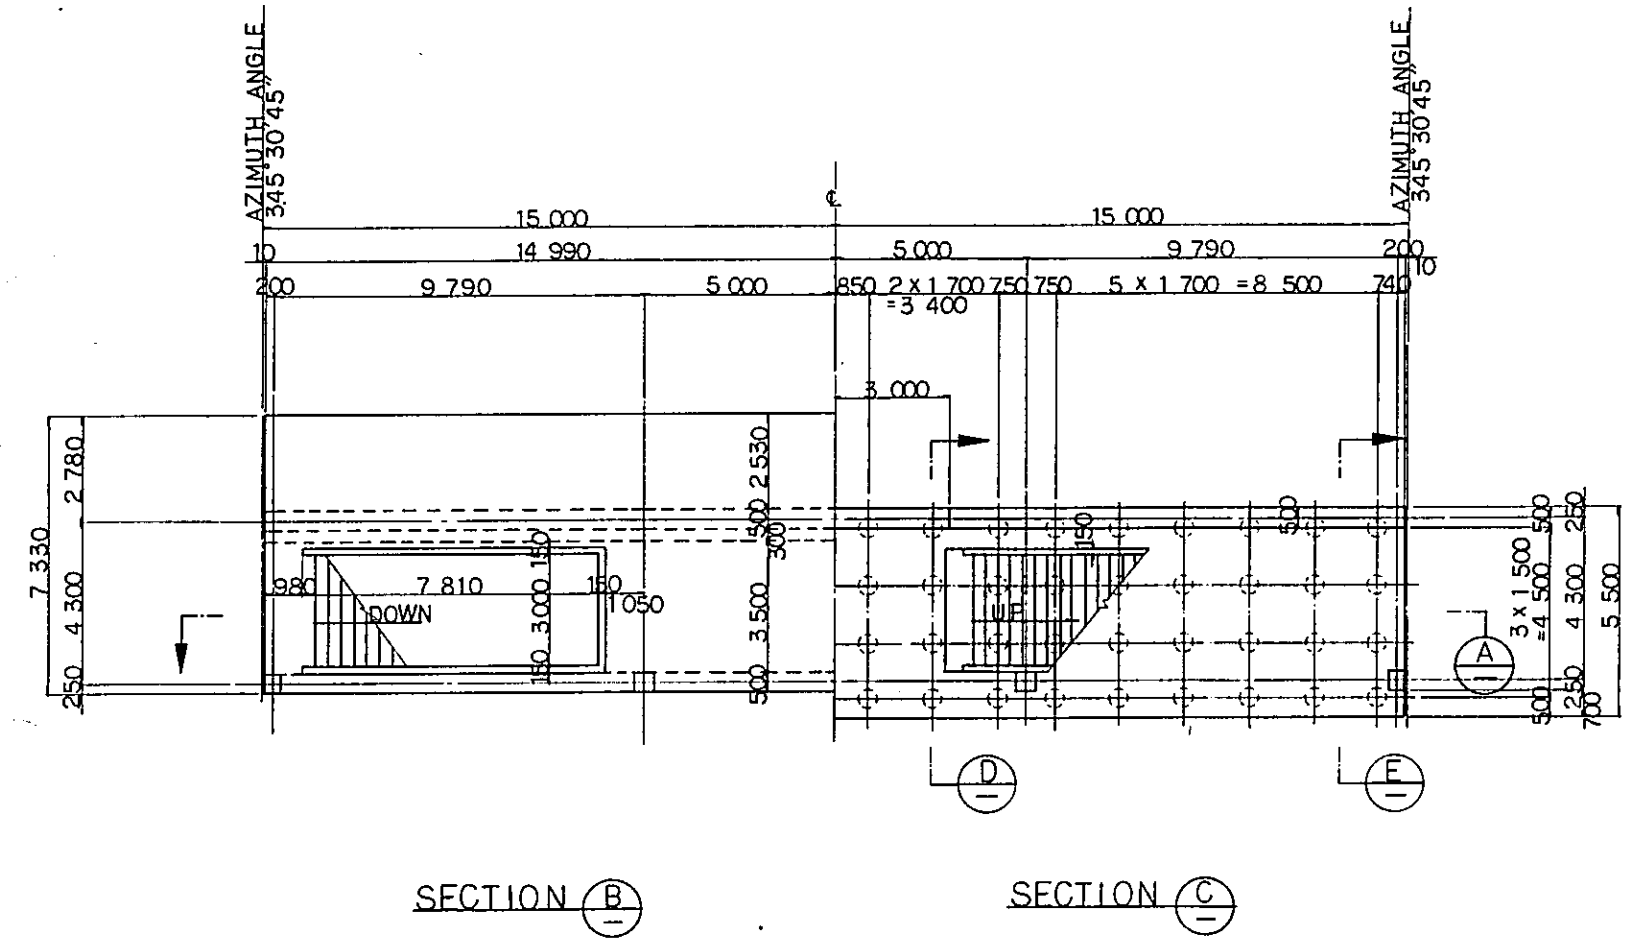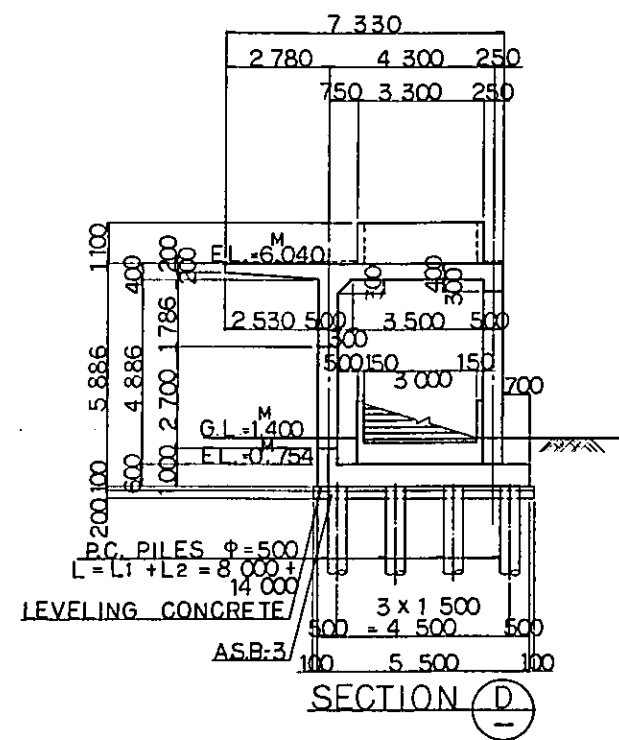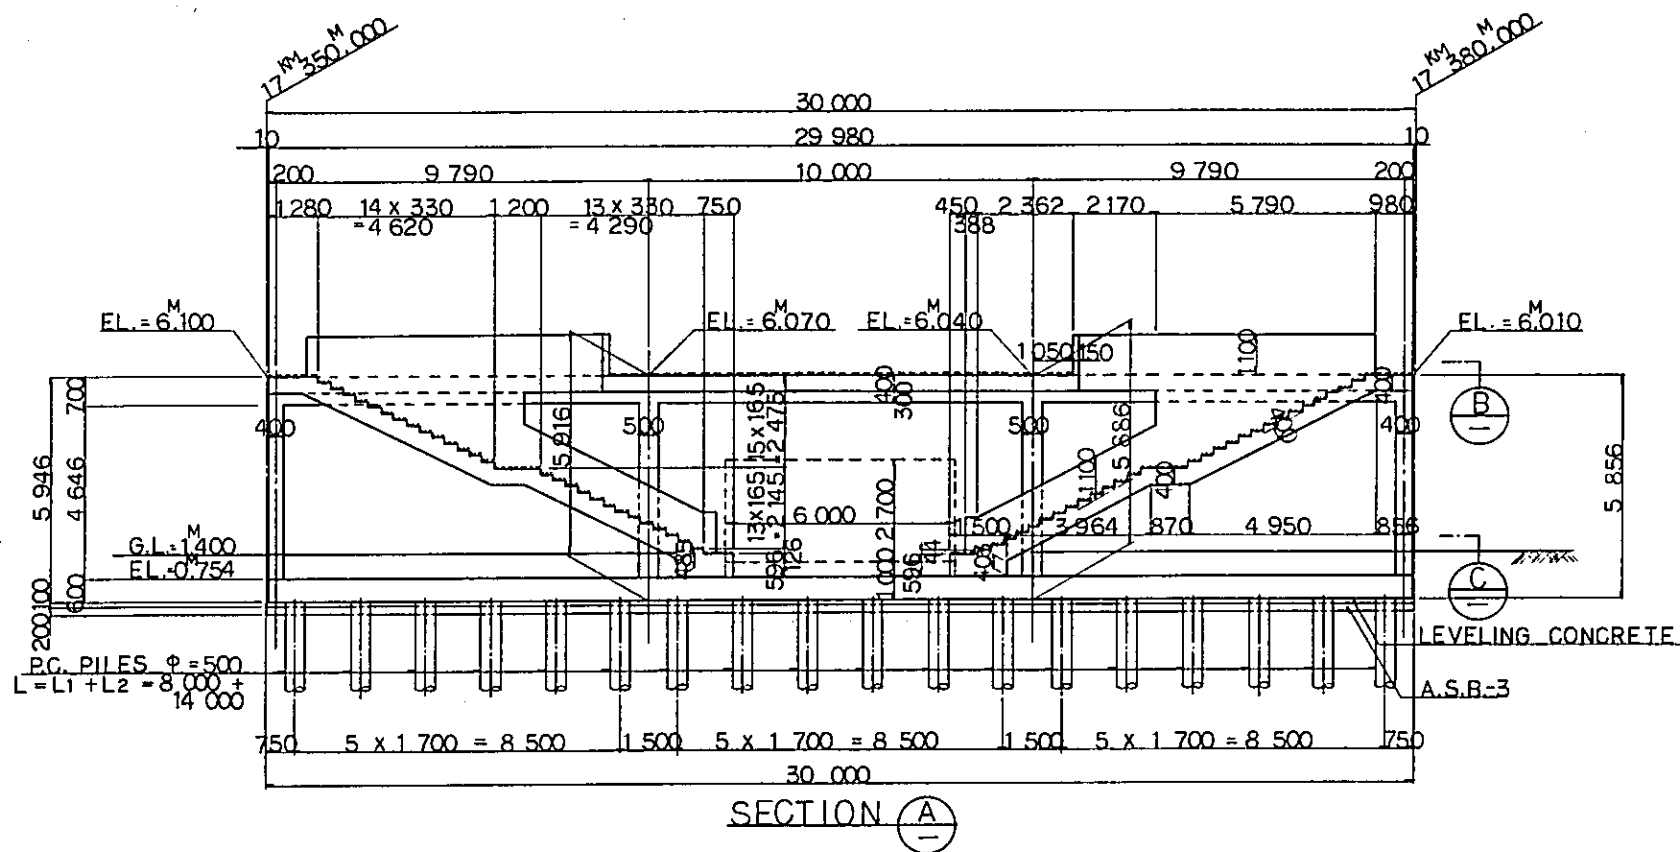

- NOTES :
1. ALL DIMENSIONS ARE SHOWN IN MILLIMETERS UNLESS OTHERWISE INDICATED
  2. REFERENCE DRAWING FOR BAR ARRANGEMENT: CS-232 ~ 244.
  3. TYPES OF PC. PILE
    - BOTTOM SURFACE OF FOOTING
    - PC. PILE CLASS B.
    - PC. PILE CLASS A.
  4. GRADING CONCRETE SHALL BE SIMULTANEOUSLY PLACED WITH SLAB CONCRETE
- DESIGN CRITERIA

|                  |                                      |  |
|------------------|--------------------------------------|--|
| DESIGN LOAD      | TRAIN LOAD                           | EQUIVALENT TO  |
|                  | SEISMIC EFFECT                       | IN HORIZONTAL DIRECTION $K=0.1$<br>IN VERTICAL DIRECTION $K=0.9$ |
| ALLOWABLE STRESS | REINFORCING BAR                      | ALLOWABLE TENSILE STRESS 1800 kg/cm <sup>2</sup>                 |
|                  | CONCRETE                             | ALLOWABLE COMPRESSIVE STRESS 80 kg/cm <sup>2</sup>               |
| MATERIAL         | TYPE OF REINFORCING BAR              | SD-30  |
|                  | CONCRETE OF DESIGN CRITERIA STRENGTH | $f'_{ck} = 210 \text{ kg/cm}^2$                                  |
|                  | MAX SIZE OF COARSE AGGREGATE         | 25 mm  |

REPUBLIC OF INDONESIA  
 MINISTRY OF COMMUNICATIONS  
 DIRECTORATE GENERAL OF LAND TRANSPORT AND INLAND WATERWAYS

NEW RAILWAY LINE FOR CENGKARENG AIRPORT CONSTRUCTION PROJECT


JAPAN INTERNATIONAL COOPERATION AGENCY (JICA)

|   |          |     |     |     |     |     |
|---|----------|-----|-----|-----|-----|-----|
| B | 1AUG'84  | K.V | m.y | K.A | K.M | K.K |
| A | 11FEB'84 | K.V | m.y | K.A | K.M | K.K |


REVISORS DATE DESIGNED DRAWN CHECKED REVIEWED SUBMITTED

PLATFORM VP8  
 GENERAL VIEW


PACKAGE: I CIVIL AND ARCHITECTURAL WORK  
 SCALE: 1:100 DRAWING NO: CS-246

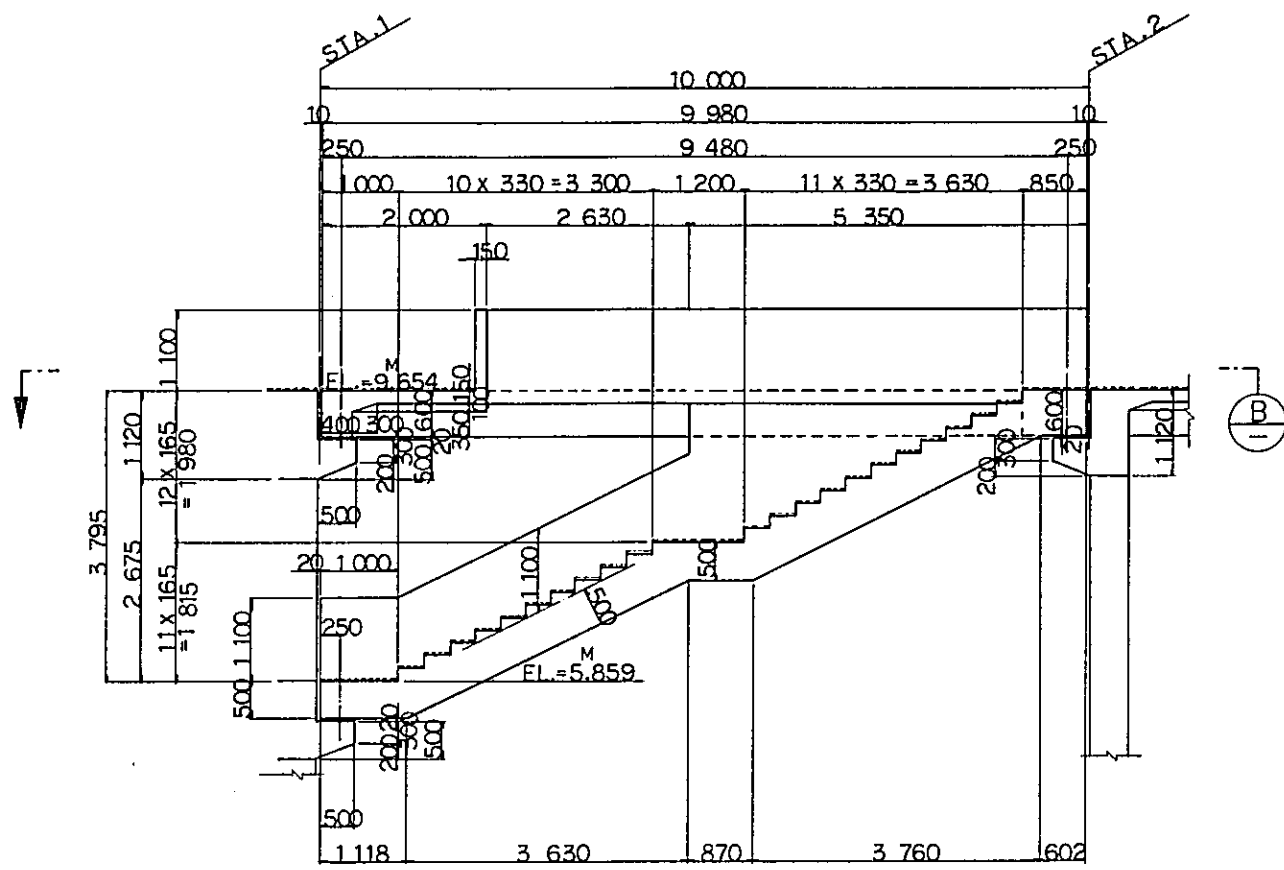


SECTION A

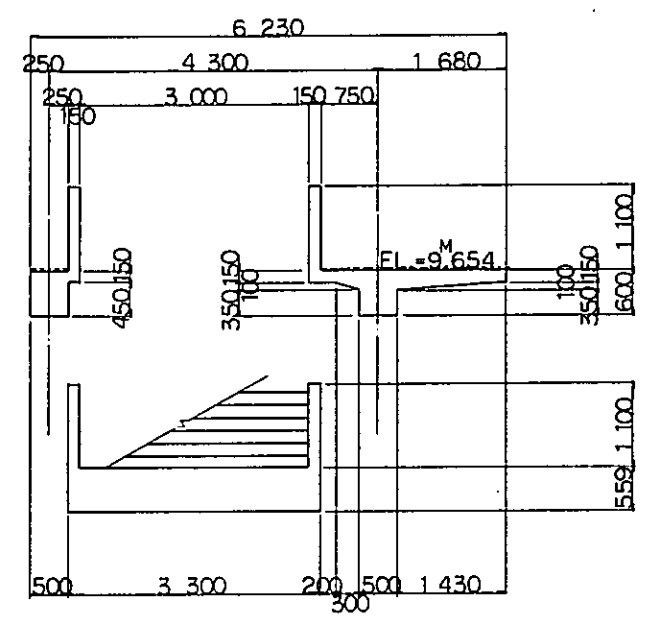

SECTION C

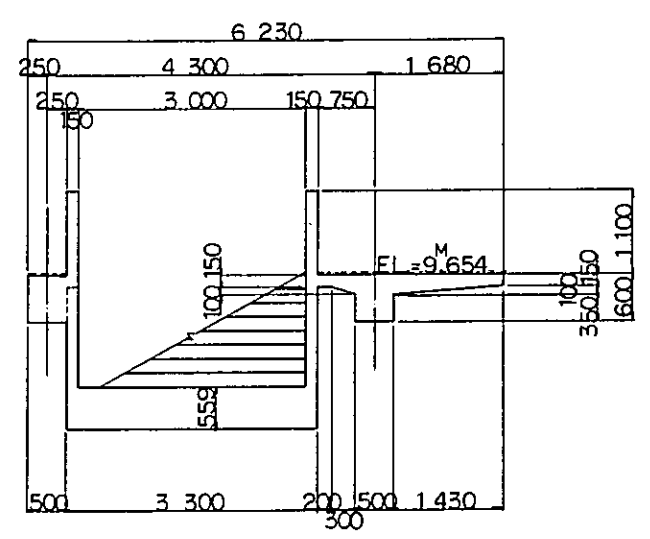

SECTION D

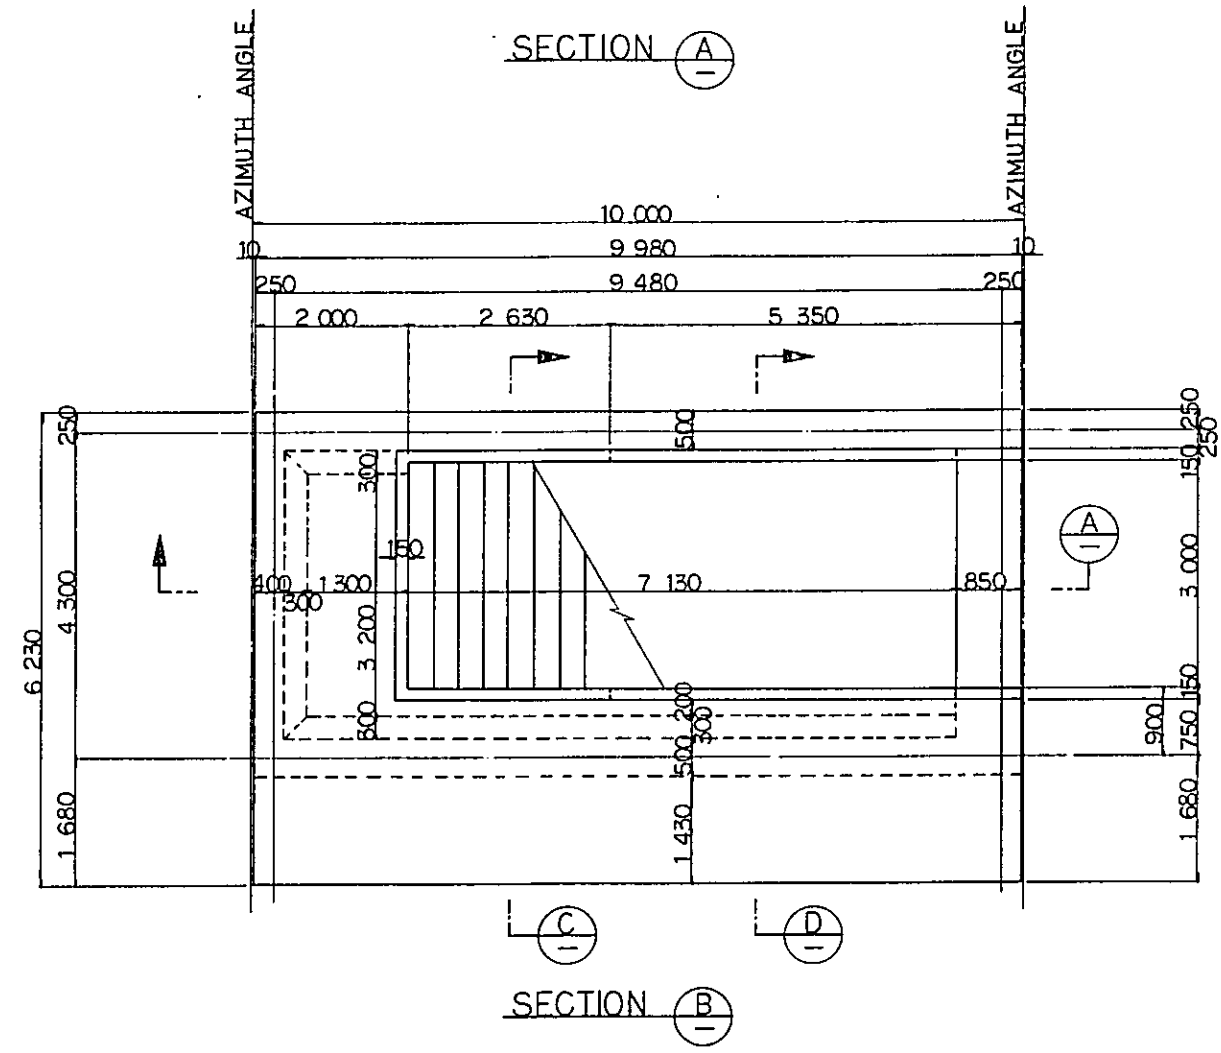

SECTION B

DIMENSION SCHEDULE

|       | STATION                                      | AZIMUTH ANGLE |
|-------|--|---------------|
| RCP 1 | STA.2 17 <sup>KM</sup> 340 <sup>M</sup> .000 | 345° 30' 45"  |
|       | STA.1 17 <sup>KM</sup> 350 <sup>M</sup> .000 | .             |
| RCP 2 | STA.1 17 <sup>KM</sup> 380 <sup>M</sup> .000 | 345° 30' 45"  |
|       | STA.2 17 <sup>KM</sup> 390 <sup>M</sup> .000 | .             |

- NOTES :
1. ALL DIMENSIONS ARE SHOWN IN MILLIMETERS UNLESS OTHERWISE INDICATED
  2. REFERENCE DRAWING FOR BAR ARRANGEMENT : CS-248 ~250

REPUBLIC OF INDONESIA  
 MINISTRY OF COMMUNICATIONS  
 DIRECTORATE GENERAL OF LAND TRANSPORT AND INLAND WATERWAYS

NEW RAILWAY LINE FOR CENGKARENG AIRPORT  
 CONSTRUCTION PROJECT


JAPAN INTERNATIONAL COOPERATION AGENCY  
 (JICA)

|   |            |          |          |      |
|---|------------|----------|----------|------|
| B | 1 AUG '84  | K.V.M.Y. | K.A.K.M. | M.K. |
| A | 10 FEB '84 | K.V.M.Y. | K.A.K.M. | M.K. |


REVISIONS DATE CHECKED DRAWN CHECKED REVIEWED SUBMITTED

PLATFORM RCPI, RCP2  
 GENERAL VIEW


PACKAGE: I CIVIL AND ARCHITECTURAL WORK  
 SCALE: 1:50 DRAWING NO: CS-247

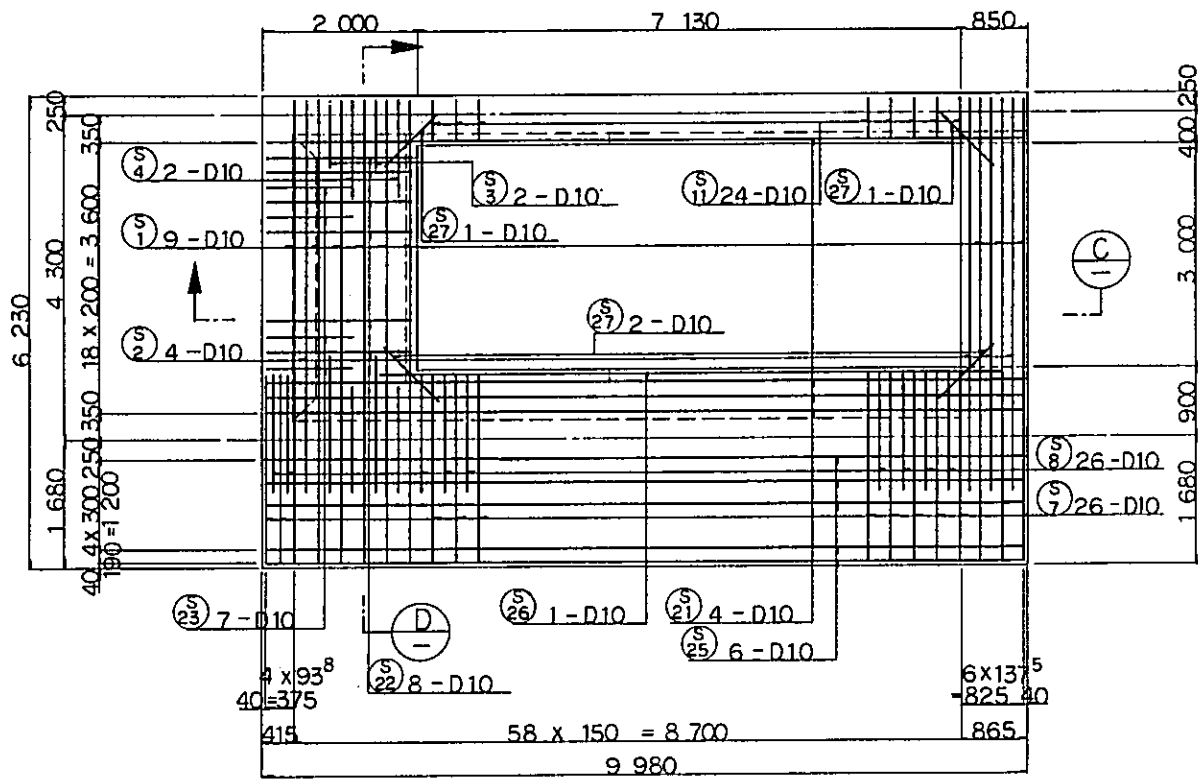


SECTION A

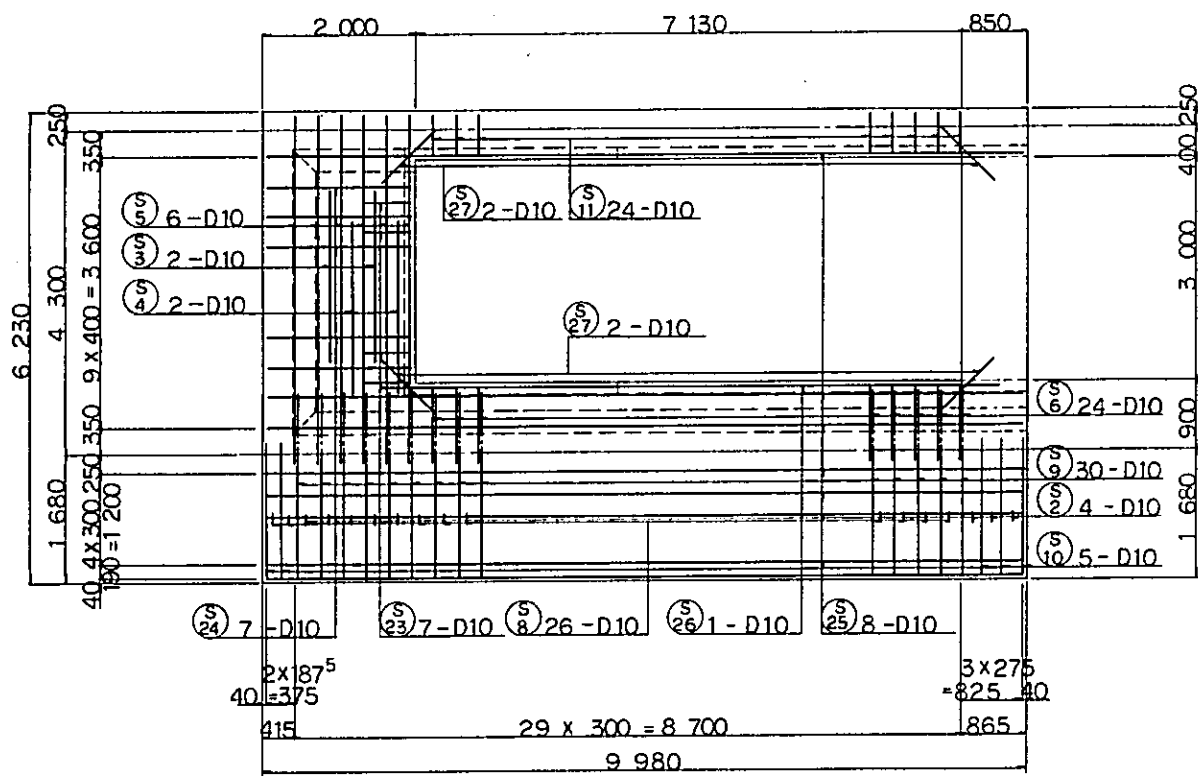


SECTION B

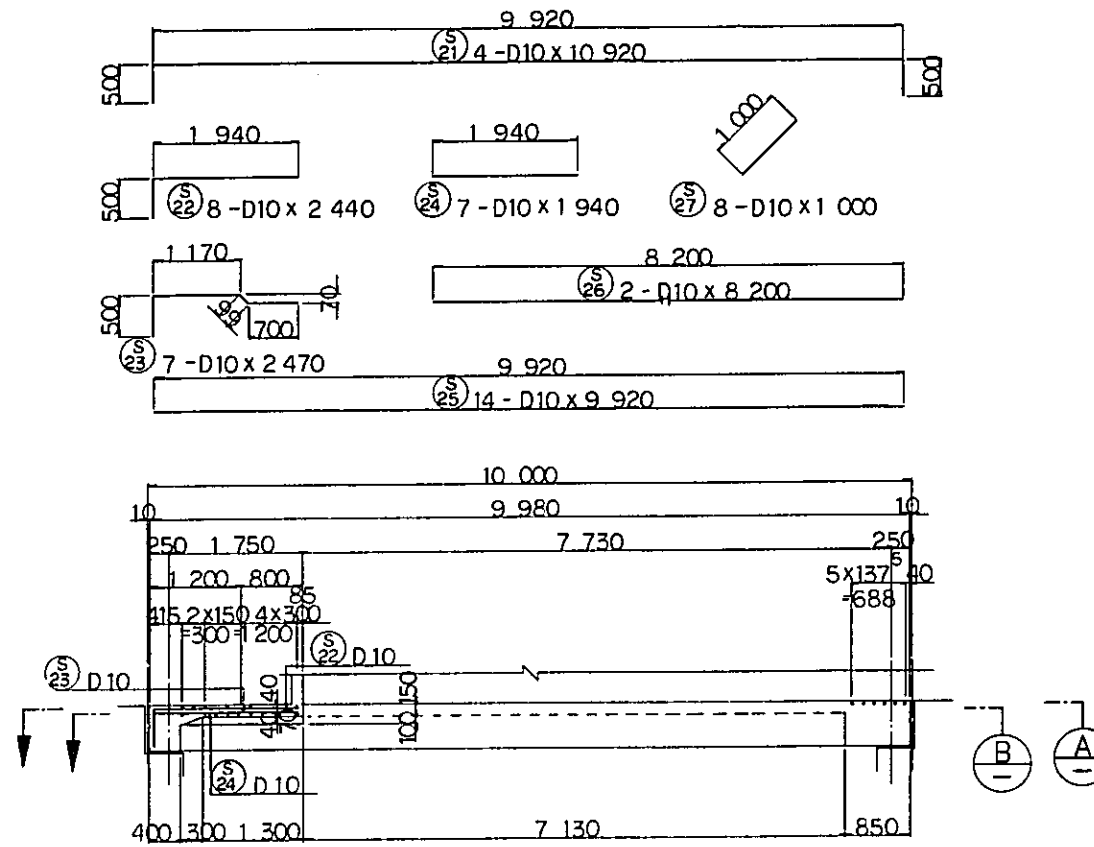

SECTION C

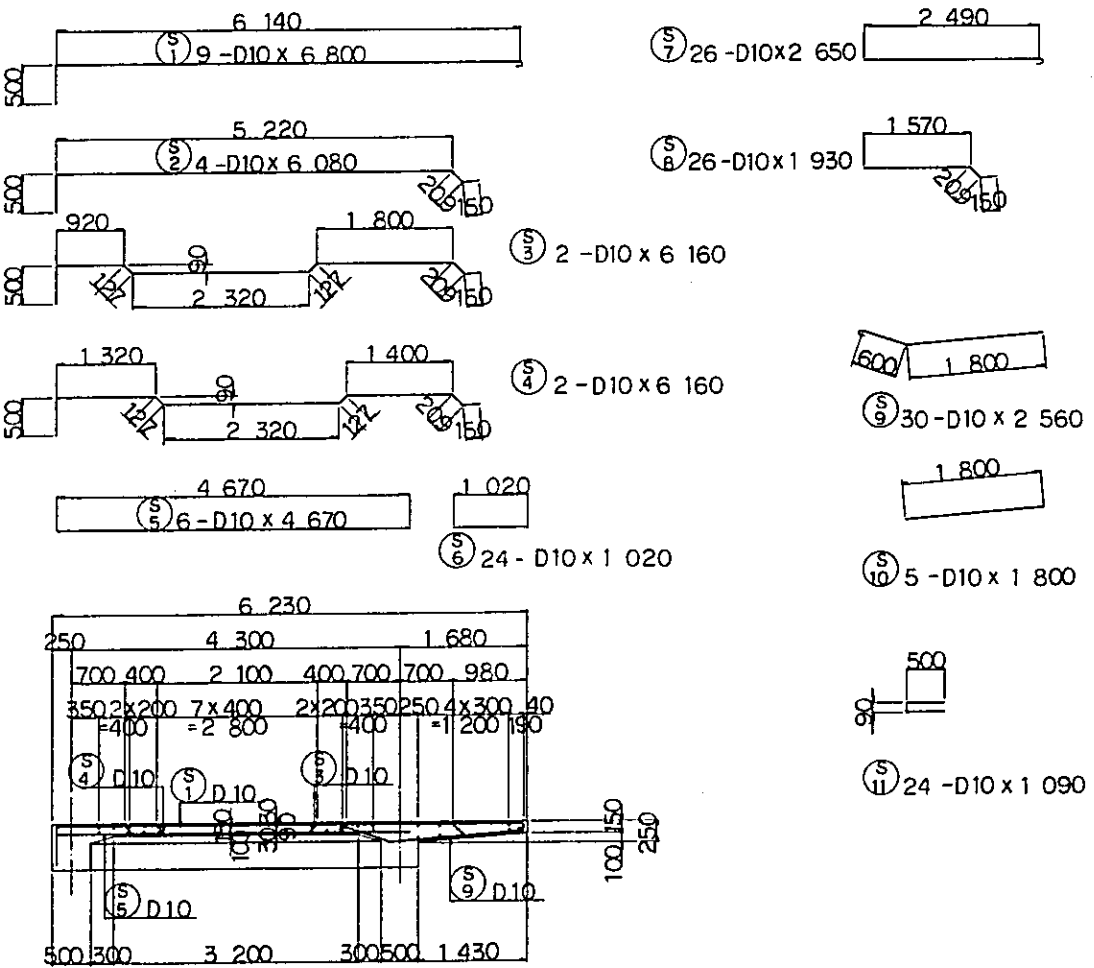


SECTION D

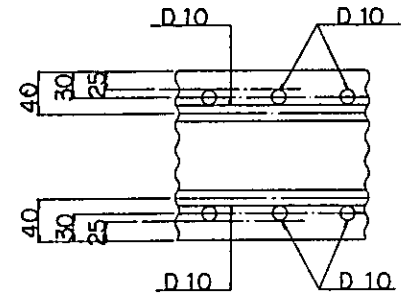


CONCRETE COVER

- NOTES:
- ALL DIMENSIONS ARE SHOWN IN MILLIMETERS UNLESS OTHERWISE INDICATED
  - REFERENCE DRAWING FOR GENERAL VIEW : CS -247.


|  |             |          |       |         |          |
|--|-------------|----------|-------|---------|----------|
| REPUBLIC OF INDONESIA  |             |          |       |         |          |
| MINISTRY OF COMMUNICATIONS                                   |             |          |       |         |          |
| DIRECTORATE GENERAL OF LAND TRANSPORT AND INLAND WATERWAYS   |             |          |       |         |          |
| NEW RAILWAY LINE FOR CENGKARENG AIRPORT CONSTRUCTION PROJECT |             |          |       |         |          |
| JAPAN INTERNATIONAL COOPERATION AGENCY (JICA)                |             |          |       |         |          |
| B  | 1AUG'84     | K.V      | m.y   | K.A     | K.M      |
| A  | 27FEB'84    | K.V      | m.y   | K.A     | K.M      |
| REVISIONS  | DATE        | DESIGNED | DRAWN | CHECKED | REVIEWED |
| PLATFORM RCPI BAR ARRANGEMENT (SHEET 1 OF 3)                 |             |          |       |         |          |
| PACKAGE: I CIVIL AND ARCHITECTURAL WORK                      |             |          |       |         |          |
| SCALE  | DRAWING NO. |          |       |         |          |
| 1 : 50   | CS-248      |          |       |         |          |

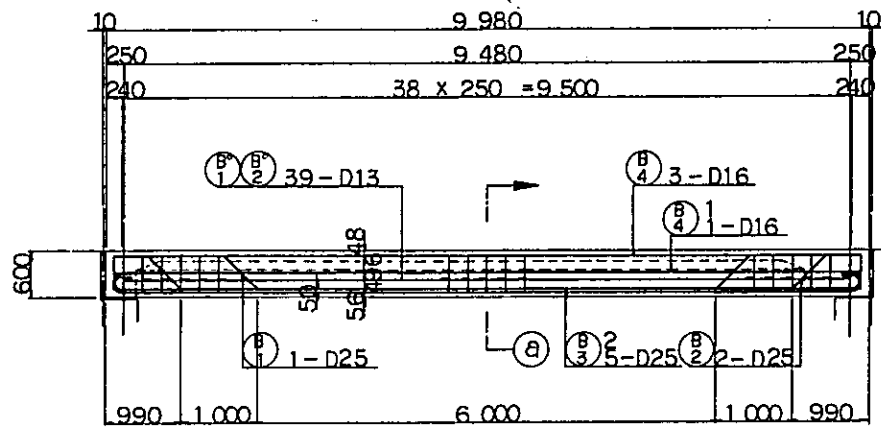













SECTION A

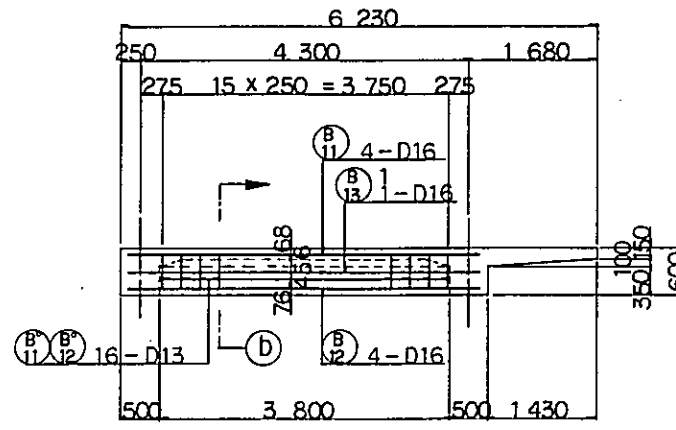

SECTION B

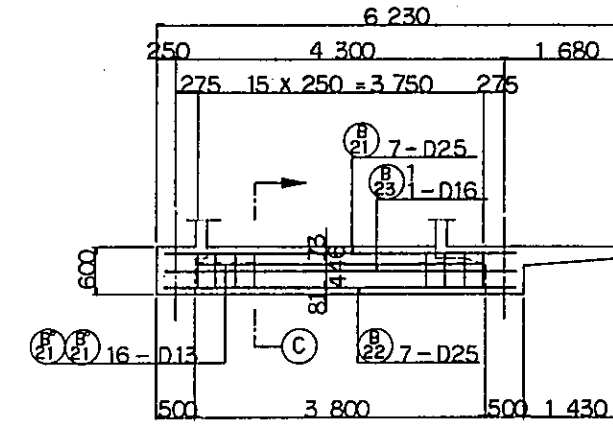

SECTION C

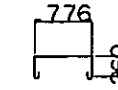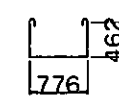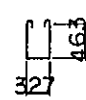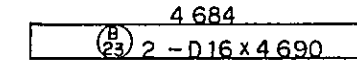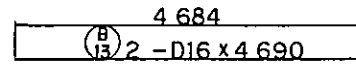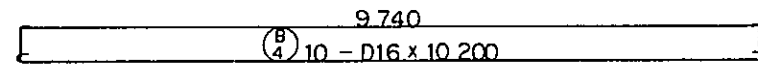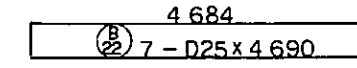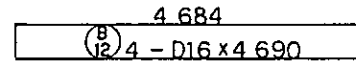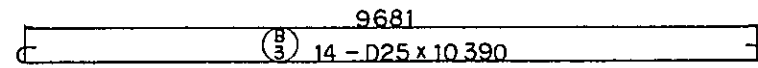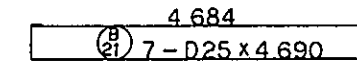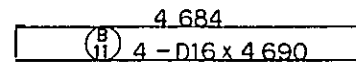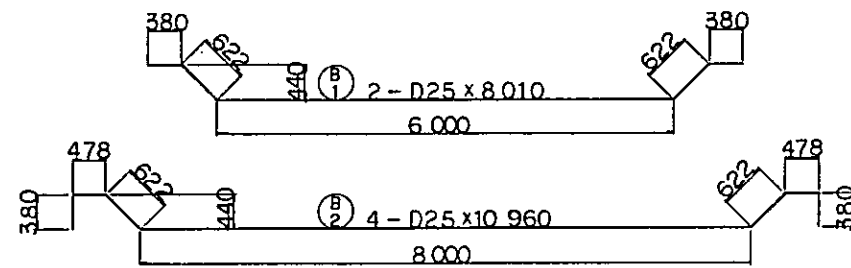


SECTION A-1


SECTION A-2

SECTION B-1


SECTION C-1

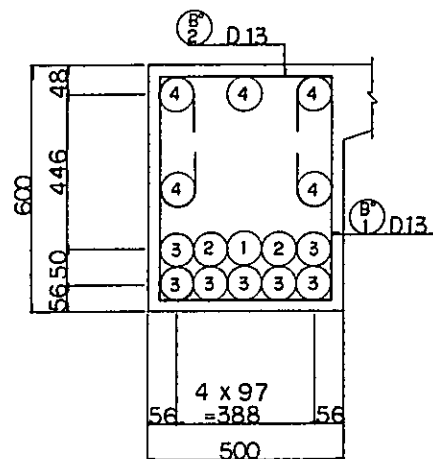


SECTION a-a

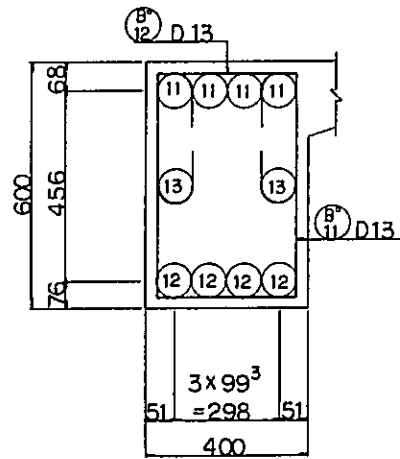

SECTION b-b

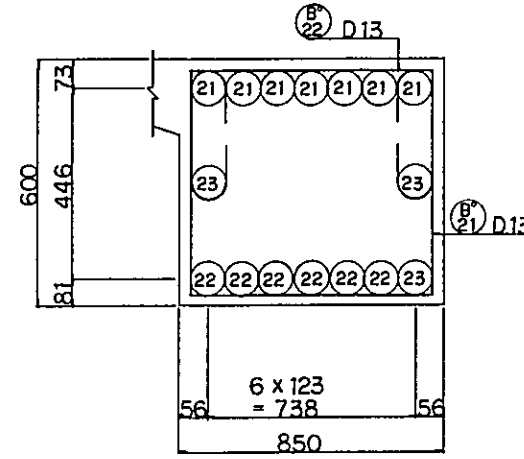

SECTION c-c

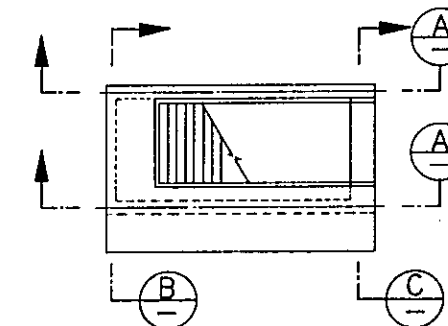


REMARKING DIAGRAM

NOTES:


1. ALL DIMENSIONS ARE SHOWN IN MILLIMETERS UNLESS OTHERWISE INDICATED
2. REFERENCE DRAWING FOR GENERAL VIEW : CS-247.

|  |           |             |       |             |             |
|--|-----------|-------------|-------|-------------|-------------|
| REPUBLIC OF INDONESIA<br>MINISTRY OF COMMUNICATIONS<br>DIRECTORATE GENERAL OF LAND TRANSPORT<br>AND INLAND WATERWAYS |           |             |       |             |             |
| NEW RAILWAY LINE FOR CENGKARENG AIRPORT<br>CONSTRUCTION PROJECT  |           |             |       |             |             |
| JAPAN INTERNATIONAL COOPERATION AGENCY<br>(JICA)   |           |             |       |             |             |
| B  | 1 AUG '84 | K. J.       | m. y. | K. S. K. M. | m. K.       |
| A  |           | K. F. B. S. | K. J. | m. y.       | K. S. K. M. |
| REVISIONS  | DATE      | DESIGNED    | DRAWN | CHECKED     | REVIEWED    |
| PACKAGE: I CIVIL AND ARCHITECTURAL WORK  |           |             |       |             |             |
| SCALE: 1:50 DRAWING NO.: CS-249  |           |             |       |             |             |


PLATFORM RCPI  
BAR ARRANGEMENT  
(SHEET 2 OF 3)

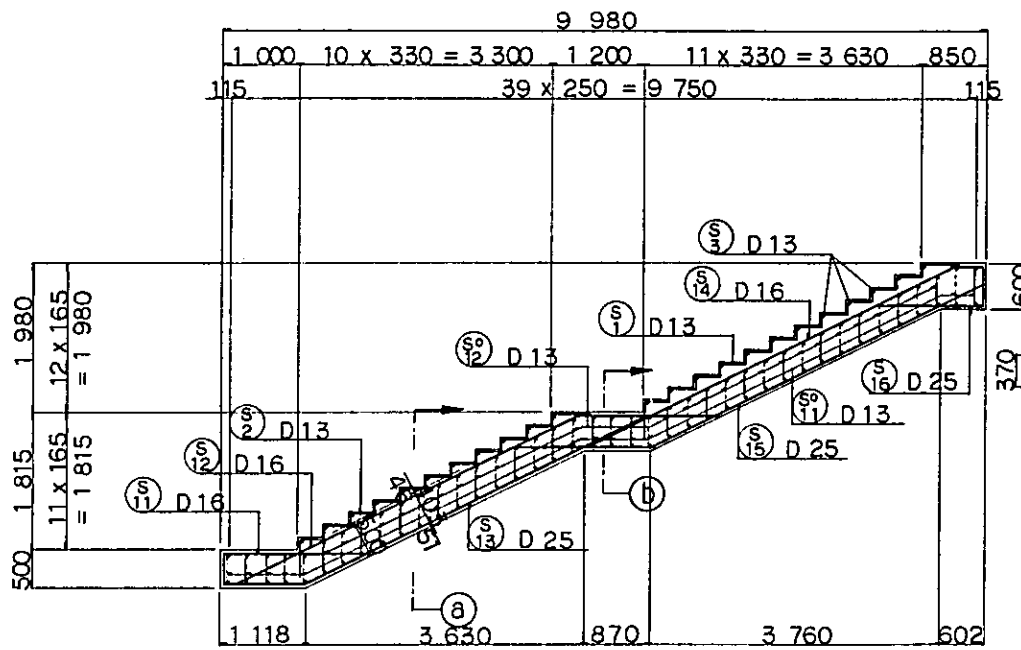


SECTION A-A

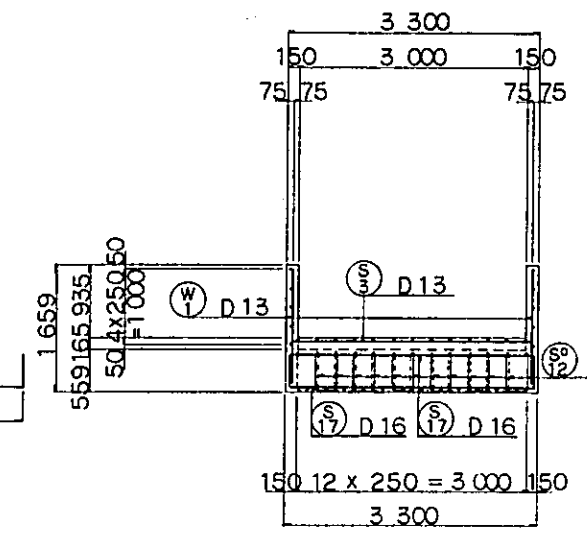


SECTION B-B

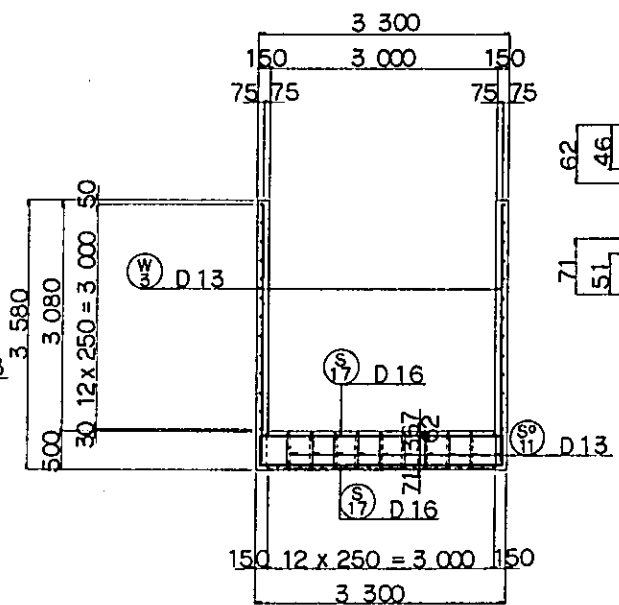


SECTION C-C

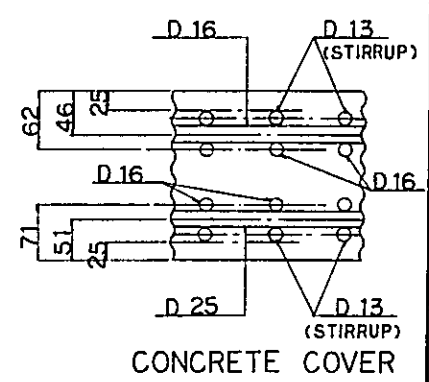


- NOTES:
1. ALL DIMENSIONS ARE SHOWN IN MILLIMETERS UNLESS OTHERWISE INDICATED
  2. REFERENCE DRAWING FOR GENERAL VIEW : CS-247.

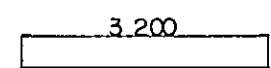


S1 23-D13 x 3 200

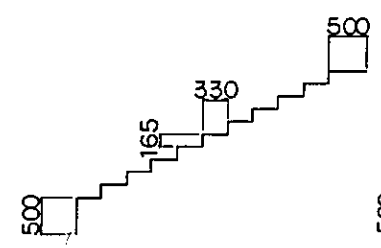


S2 13-D13 x 5 950

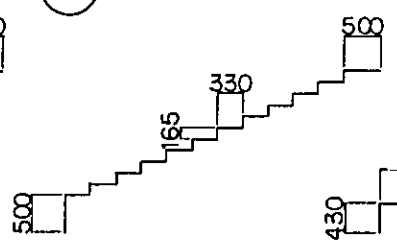


S3 13-D13 x 6 450

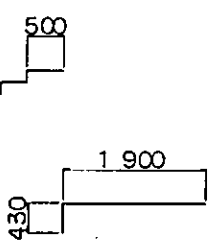


S4 13-D16 x 2 330

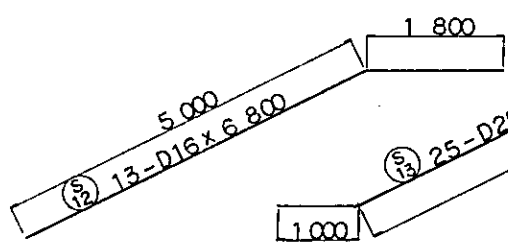


S12 13-D16 x 6 800

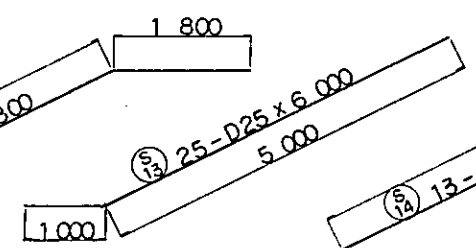

S13 25-D25 x 6 000

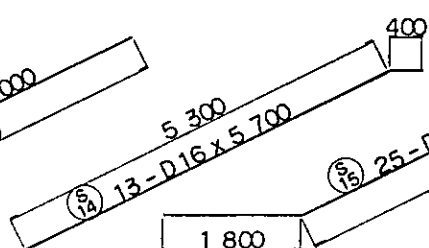


S14 13-D16 x 5 700

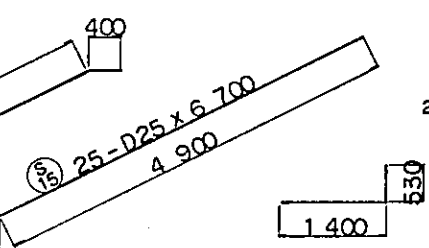


S15 25-D25 x 6 700

S16 25-D25 x 1 930

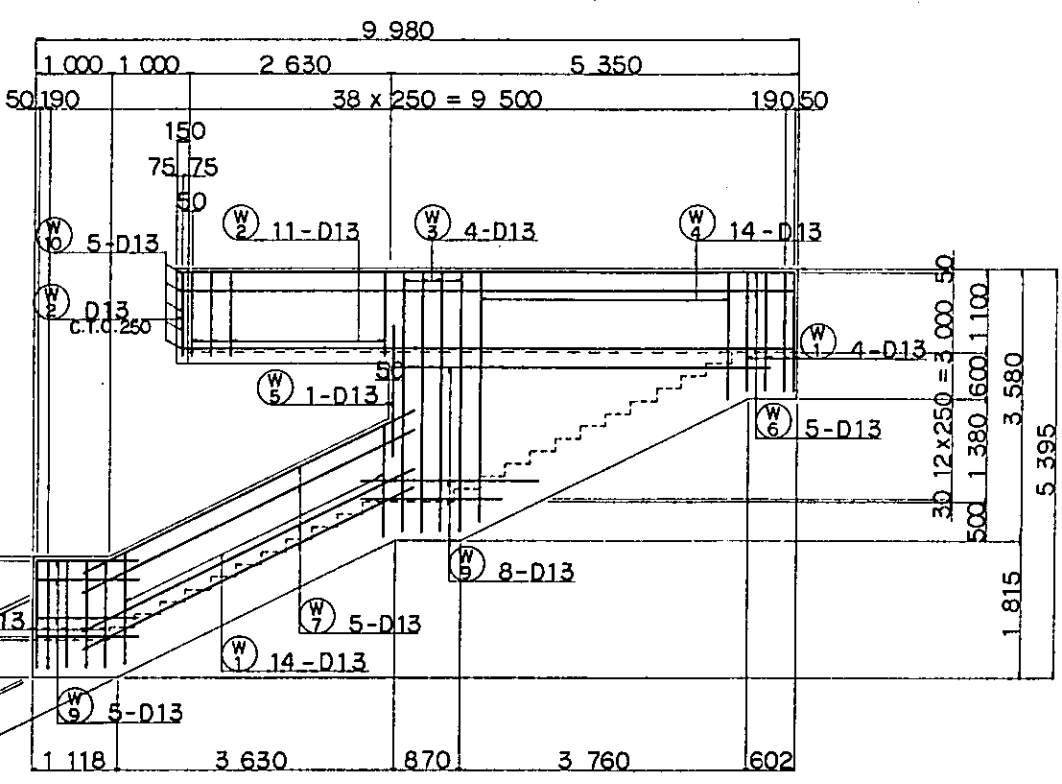

WALL BAR ARRANGEMENT

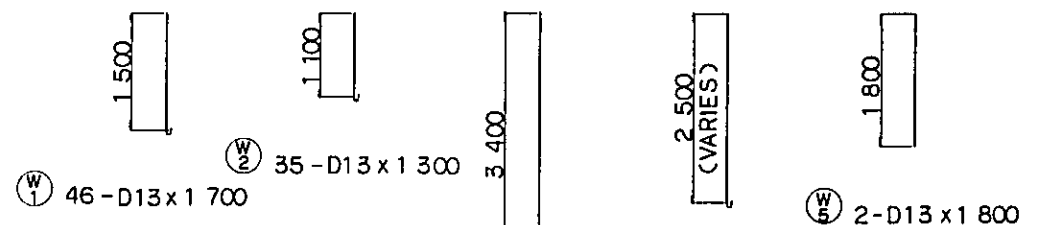


W1 46-D13 x 1 700

W2 35-D13 x 1 300


W3 8-D13 x 3 600

W4 28-D13 x 2 700 (VARIES)

W5 2-D13 x 1 800

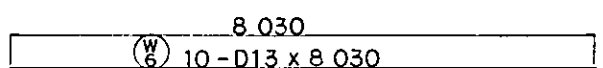


W6 10-D13 x 8 030

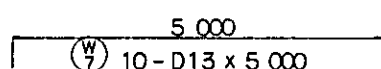

W7 10-D13 x 5 000




W8 10-D13 x 1 400

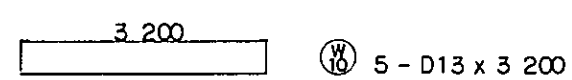

W10 5-D13 x 3 200



W9 16-D13 x 3 400 (VARIES)

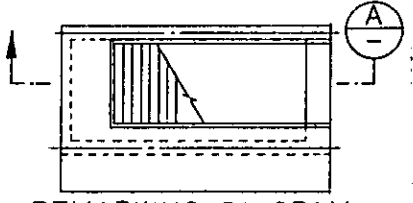


REMARKING DIAGRAM

|  |             |          |       |         |           |
|--|-------------|----------|-------|---------|-----------|
| REPUBLIC OF INDONESIA<br>MINISTRY OF COMMUNICATIONS<br>DIRECTORATE GENERAL OF LAND TRANSPORT<br>AND INLAND WATERWAYS |             |          |       |         |           |
| NEW RAILWAY LINE FOR CENGKARENG AIRPORT<br>CONSTRUCTION PROJECT  |             |          |       |         |           |
| JAPAN INTERNATIONAL COOPERATION AGENCY<br>(JICA)   |             |          |       |         |           |
| REVISIONS  | DATE        | DESIGNED | DRAWN | CHECKED | SUBMITTED |
| B  | 1 AUG 84    | K.I.     | M.Y.  | K.A.    | K.M.      |
| A  | JCEB 84     | K.I.     | M.Y.  | K.A.    | K.M.      |
| PLATFORM RCPI<br>BAR ARRANGEMENT<br>(SHEET 3 OF 3)   |             |          |       |         |           |
| PACKAGE: I CIVIL AND ARCHITECTURAL WORK  |             |          |       |         |           |
| SCALE  | DRAWING NO. |          |       |         |           |
| 1:50   | CS-250      |          |       |         |           |





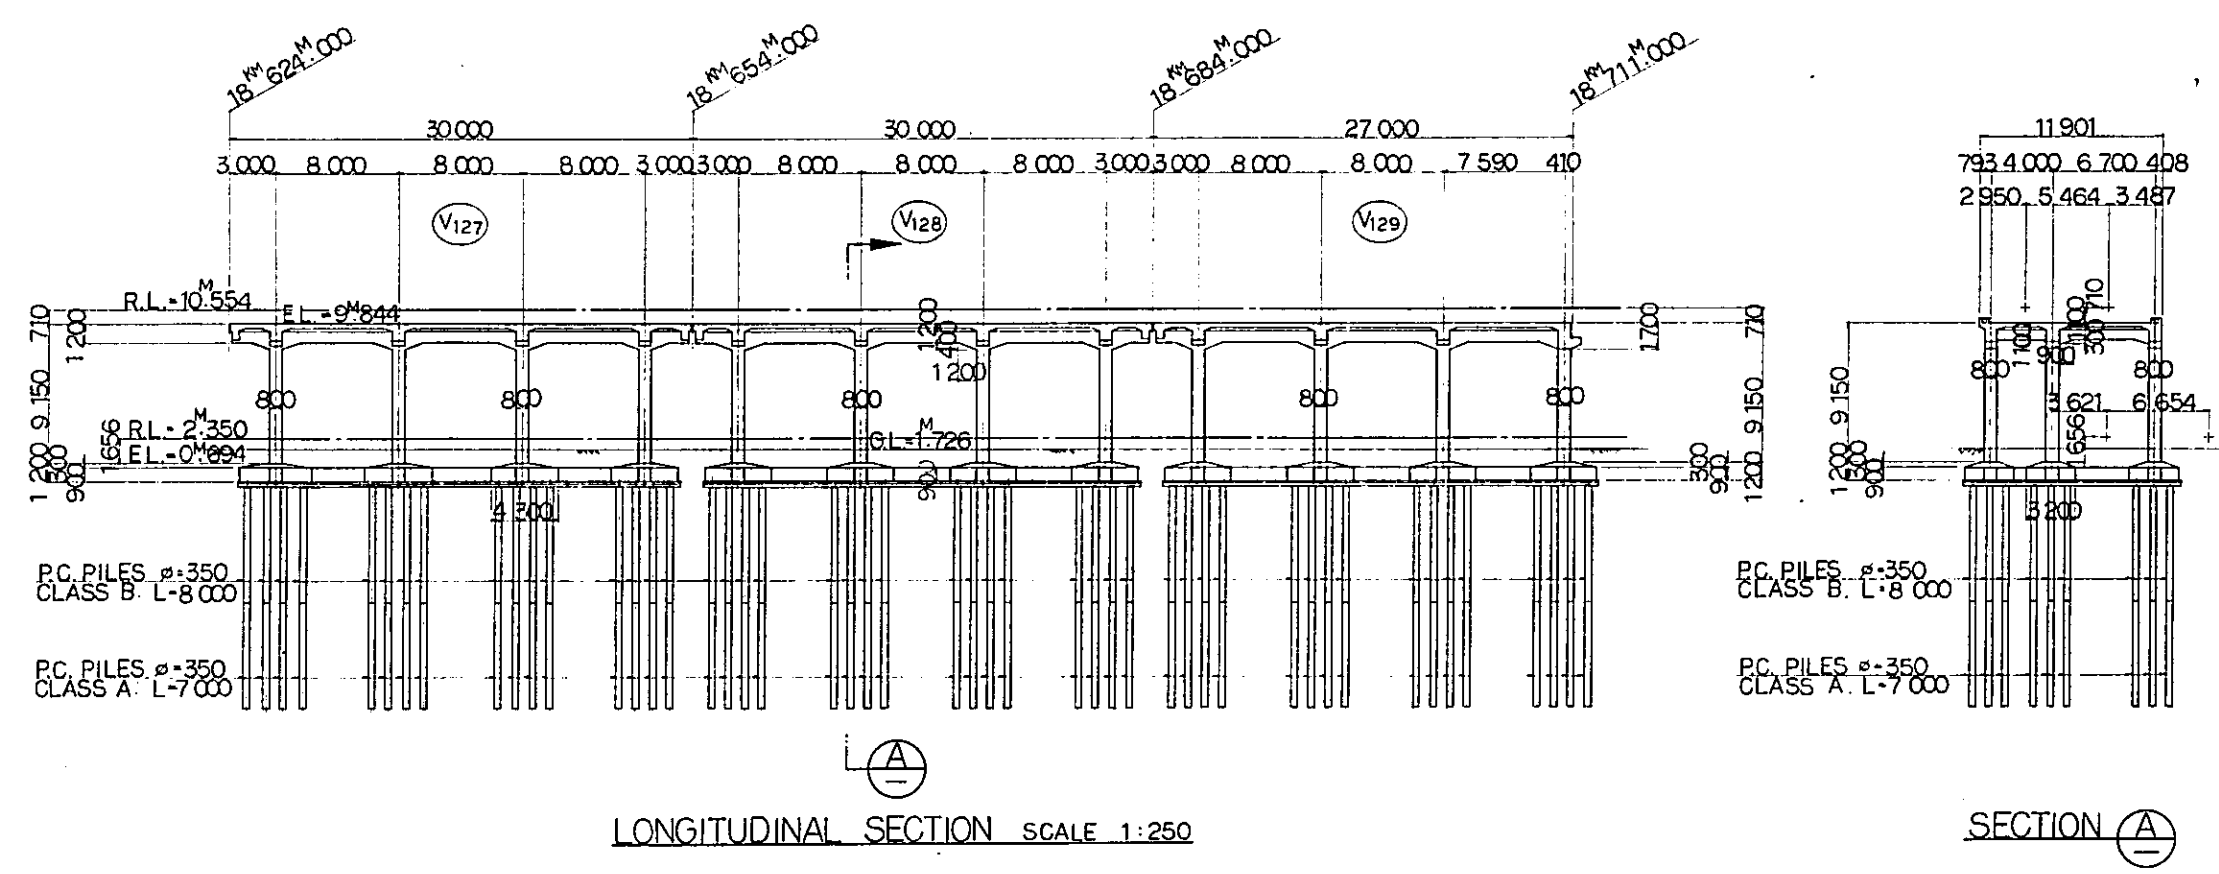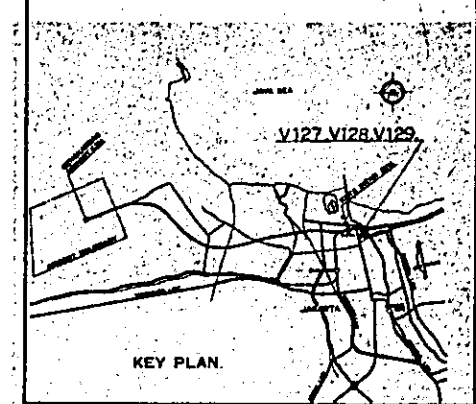

NOTE :  
 1 ALL DIMENSIONS ARE SHOWN IN MILLIMETERS UNLESS OTHERWISE INDICATED.

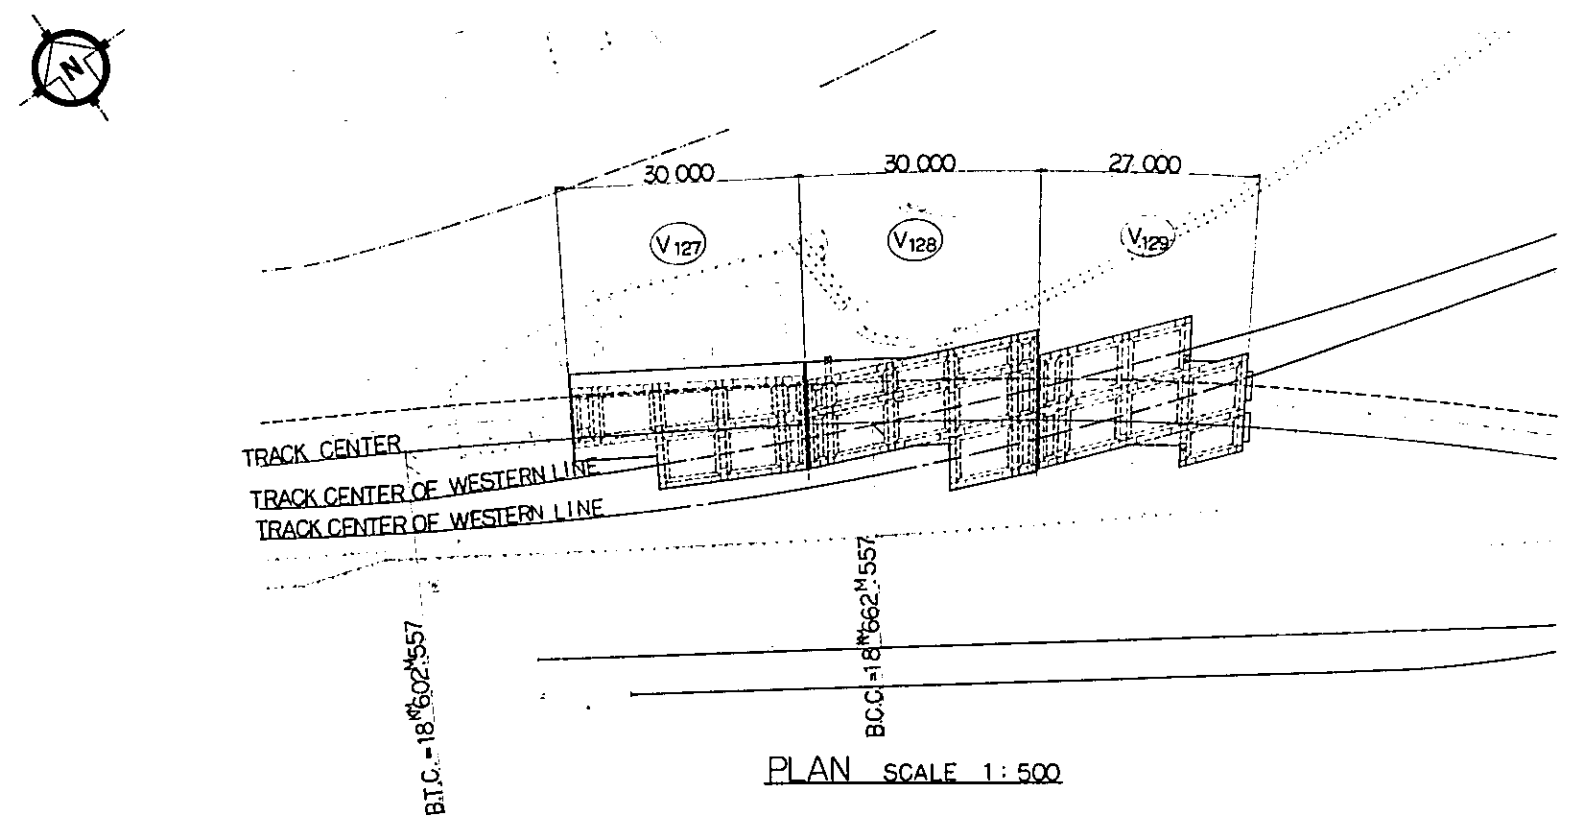

|   |             |          |       |         |          |
|---|-------------|----------|-------|---------|----------|
| REPUBLIC OF INDONESIA<br>MINISTRY OF COMMUNICATIONS<br>DIRECTORATE GENERAL OF LAND TRANSPORT AND INLAND WATERWAYS |             |          |       |         |          |
| NEW RAILWAY LINE FOR CENGKARENG AIRPORT<br>CONSTRUCTION PROJECT   |             |          |       |         |          |
| JAPAN INTERNATIONAL COOPERATION AGENCY<br>(JICA)  |             |          |       |         |          |
| B   | 1AUG'84     | T.K.A.D. | K.A.  | K.M.    | M.K.     |
| A   | 15FEB'84    | T.K.A.D. | K.A.  | K.M.    | M.K.     |
| REVISIONS   | DATE        | DESIGNED | DRAWN | CHECKED | REVIEWED |
| <b>GENERAL VIEW OF VIADUCT AT OVER-PASS OF THE WESTERN LINE.</b>  |             |          |       |         |          |
| PACKAGE: I CIVIL AND ARCHITECTURAL WORK   |             |          |       |         |          |
| SCALE   | DRAWING NO. |          |       |         |          |
| 1:500,250   | CS-251      |          |       |         |          |

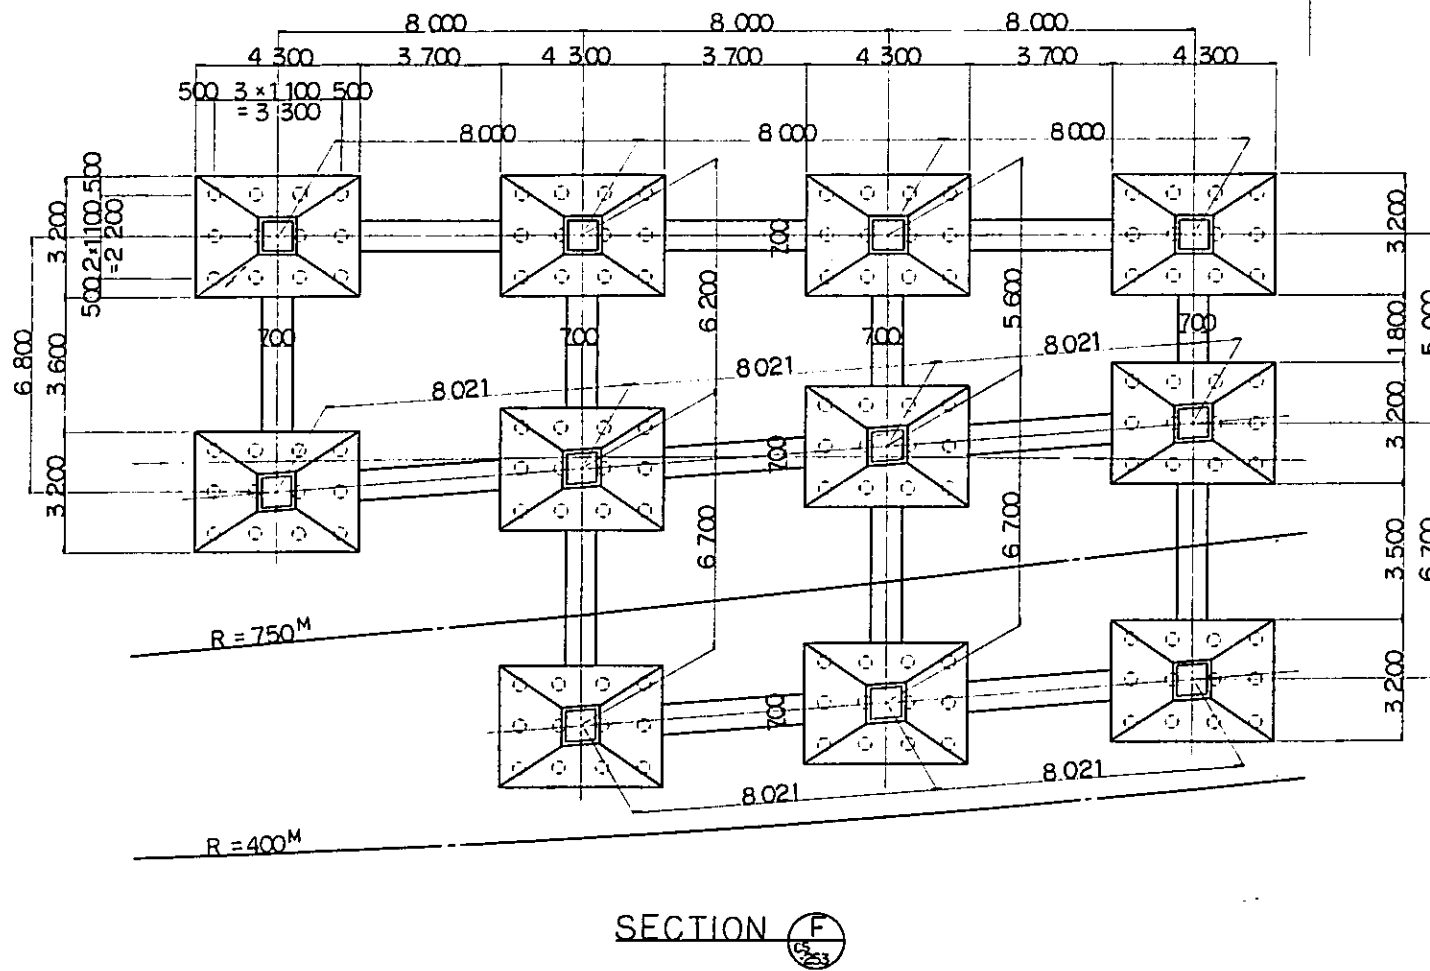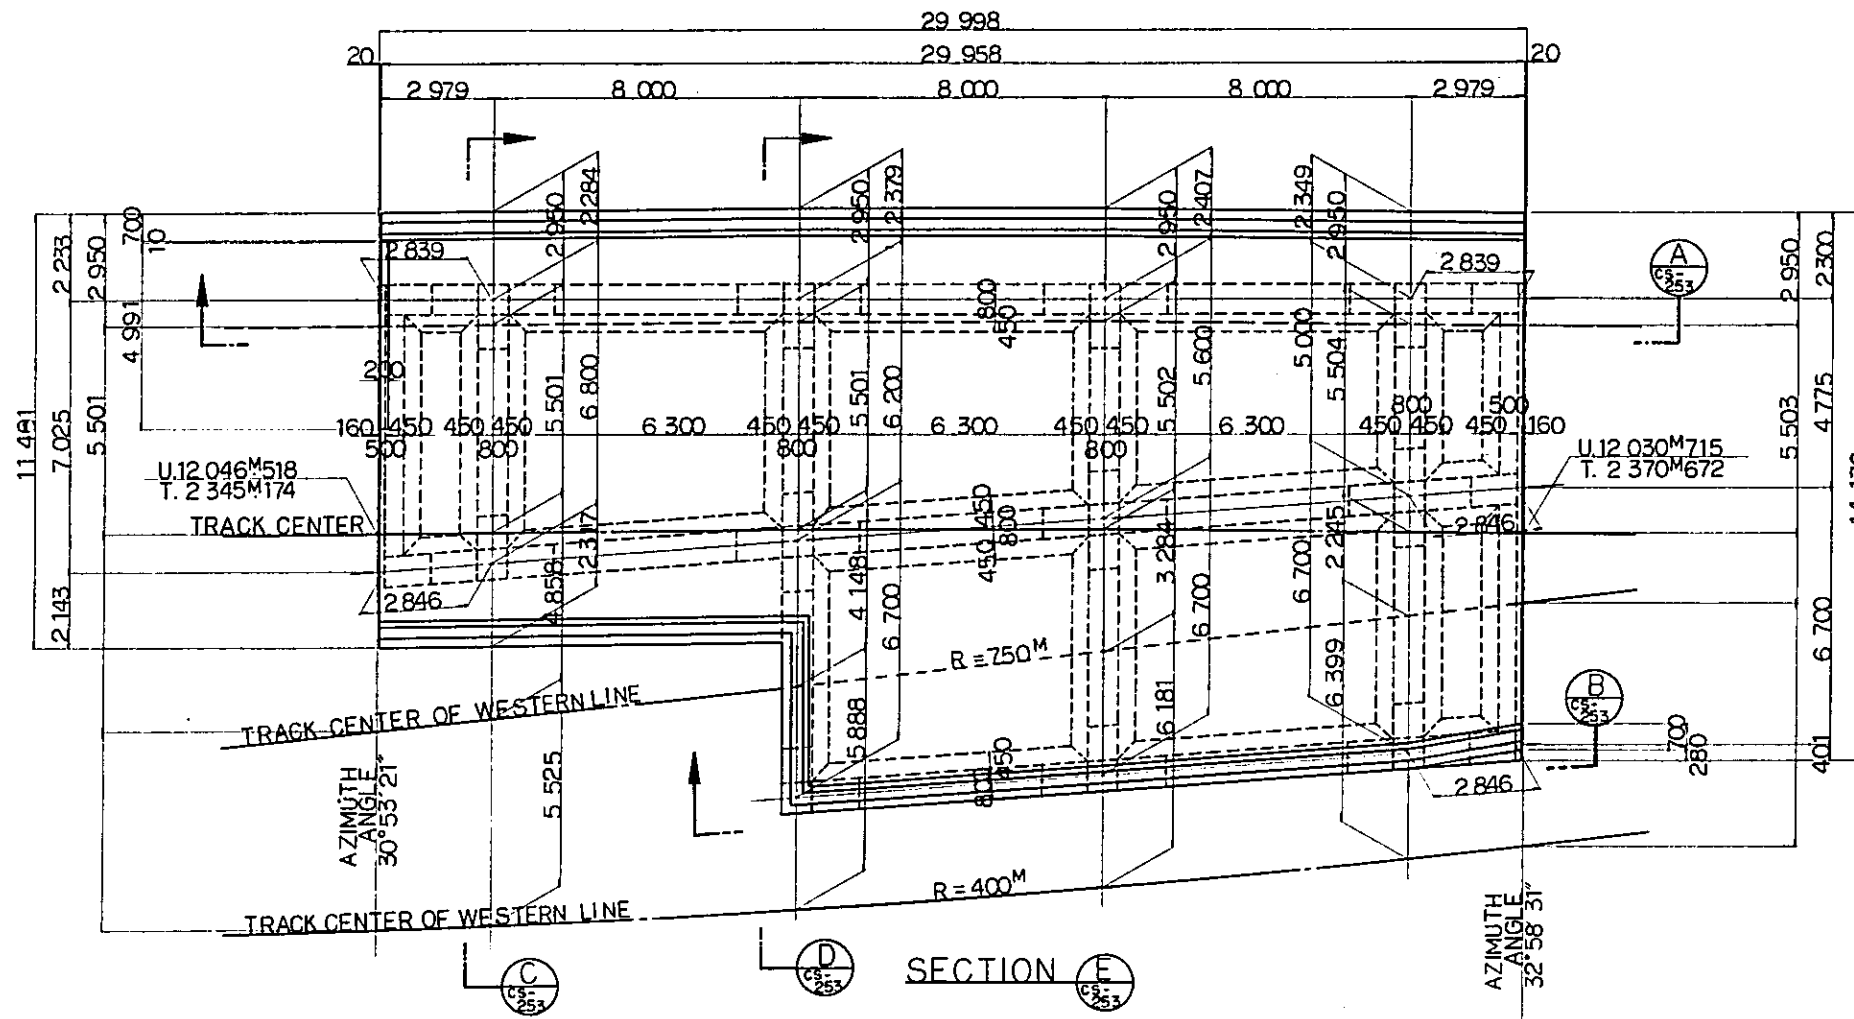


NOTES:


1. ALL DIMENSIONS ARE SHOWN IN MILLIMETERS UNLESS OTHERWISE INDICATED
2. REFERENCE DRAWING FOR BAR ARRANGEMENT:

|          |          |
|----------|----------|
| CS - 258 | CS - 265 |
| CS - 259 | CS - 266 |
| CS - 260 | CS - 267 |
| CS - 261 | CS - 268 |
| CS - 262 | CS - 269 |
| CS - 263 | CS - 270 |
| CS - 264 | CS - 271 |


|  |                    |       |         |          |          |
|--|--------------------|-------|---------|----------|----------|
| REPUBLIC OF INDONESIA<br>MINISTRY OF COMMUNICATIONS<br>DIRECTORATE GENERAL OF LAND TRANSPORT<br>AND INLAND WATERWAYS |                    |       |         |          |          |
| NEW RAILWAY LINE FOR CENGKARENG AIRPORT<br>CONSTRUCTION PROJECT  |                    |       |         |          |          |
| JAPAN INTERNATIONAL COOPERATION AGENCY<br>(JICA)   |                    |       |         |          |          |
| B  | 1 AUG '84          | TK    | AD      | KD       | KM       |
| A  | 15 FEB '84         | TK    | AD      | KD       | KM       |
| REVISIONS  | DATE               | DRAWN | CHECKED | REVIEWED | APPROVED |
| <b>VIADUCT VI27<br/>         GENERAL VIEW<br/>         (SHEET 1 OF 2)</b>  |                    |       |         |          |          |
| PACKAGE: I CIVIL AND ARCHITECTURAL WORK  |                    |       |         |          |          |
| SCALE: 1:100   | DRAWING NO: CS-252 |       |         |          |          |

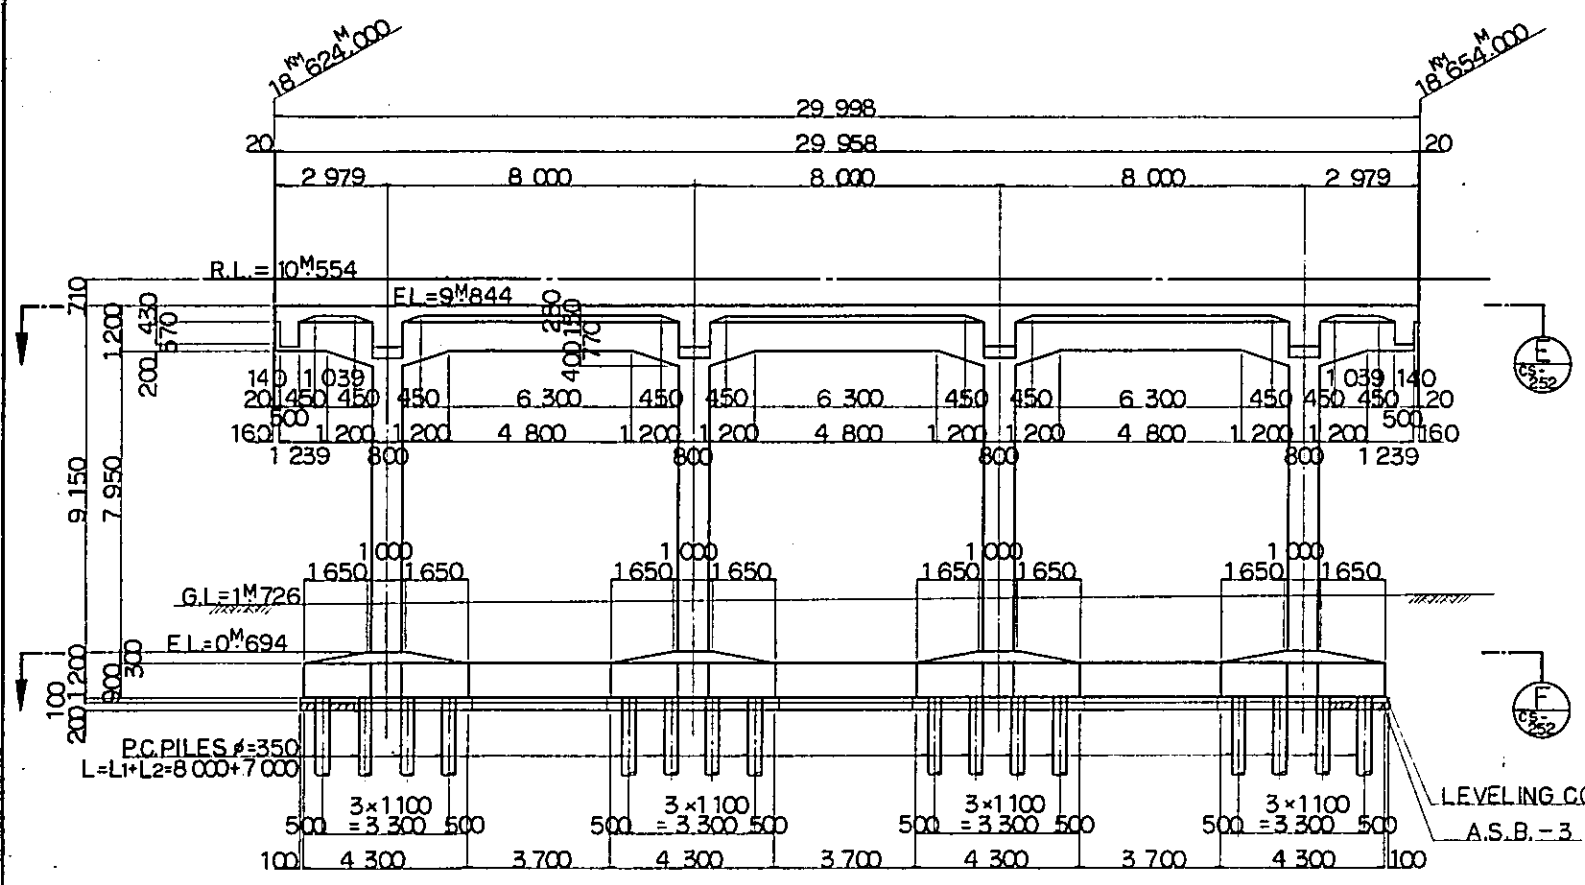


SECTION A

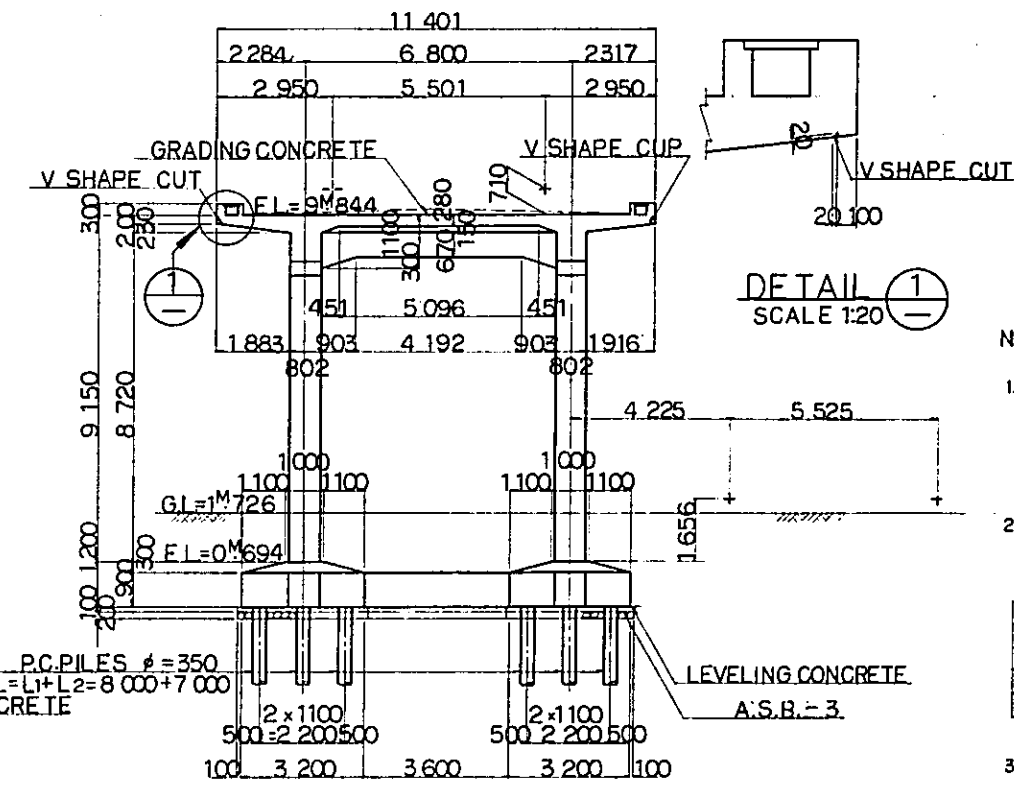

SECTION C

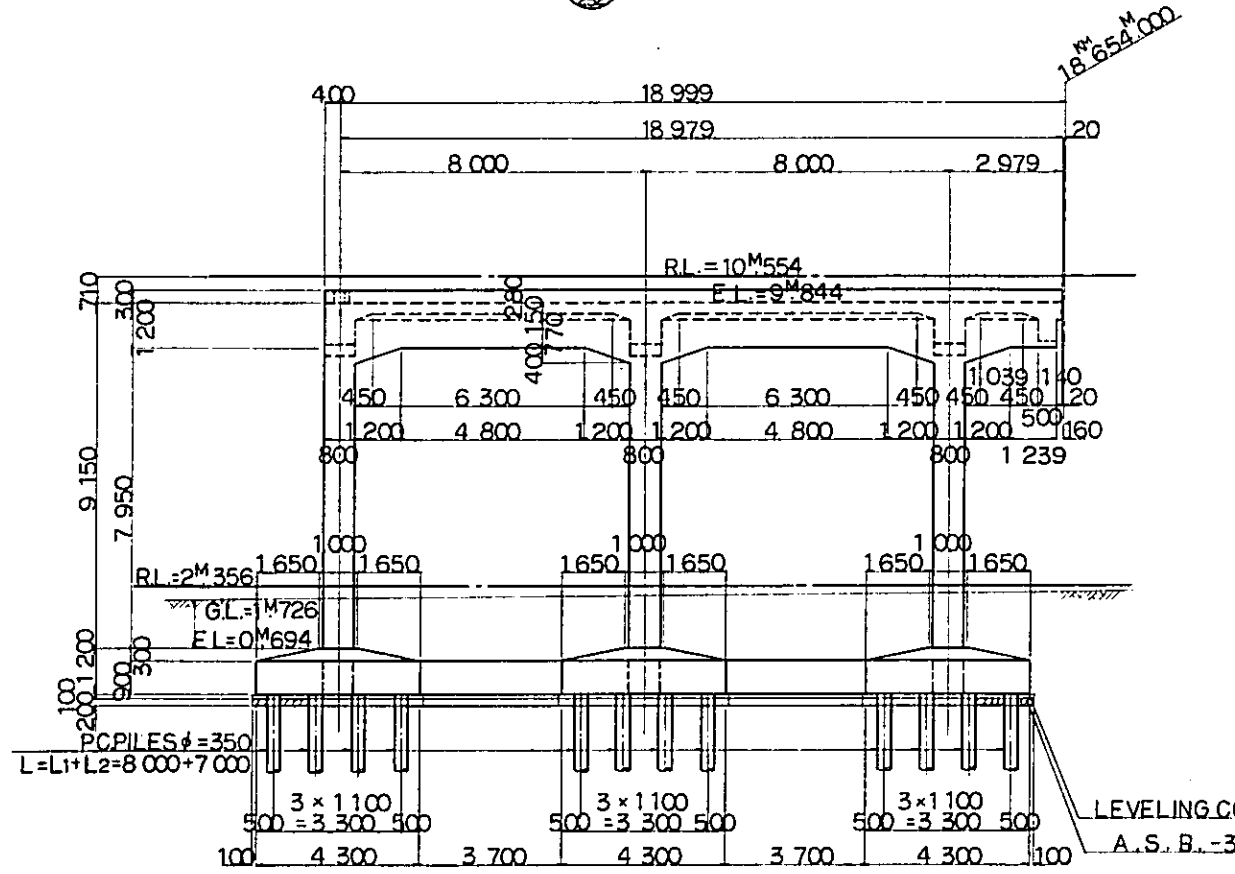

SECTION B

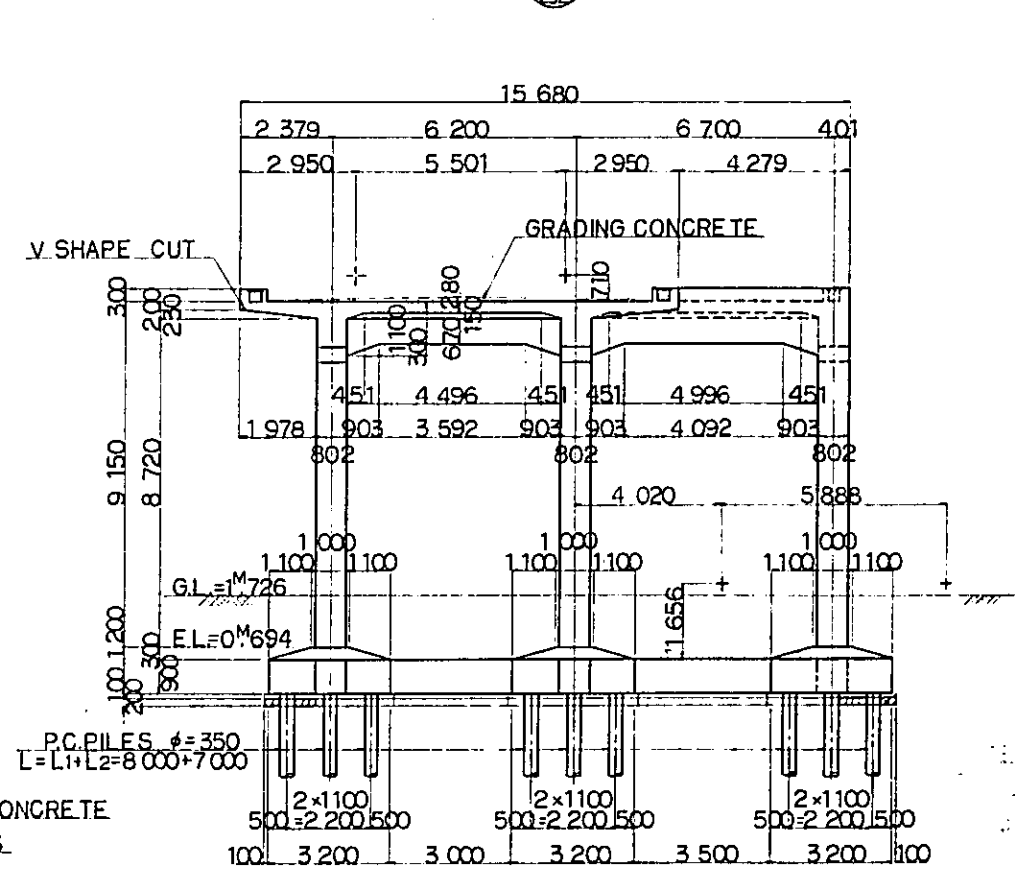

SECTION D

DETAIL 1  
SCALE 1:20


NOTES:

1. ALL DIMENSIONS ARE SHOWN IN MILLIMETERS UNLESS OTHERWISE INDICATED

2. REFERENCE DRAWING FOR BAR ARRANGEMENT:

|        |        |        |
|--------|--------|--------|
| CS-258 | CS-263 | CS-268 |
| CS-259 | CS-264 | CS-269 |
| CS-260 | CS-265 | CS-270 |
| CS-261 | CS-266 | CS-271 |
| CS-262 | CS-267 |        |

3. TYPES OF P.C. PILE

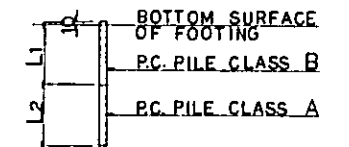

4. GRADING CONCRETE SHALL BE SIMULTANEOUSLY PLACED WITH SLAB CONCRETE

REPUBLIC OF INDONESIA  
MINISTRY OF COMMUNICATIONS  
DIRECTORATE GENERAL OF LAND TRANSPORT AND INLAND WATERWAYS



NEW RAILWAY LINE FOR CENGKARENG AIRPORT  
CONSTRUCTION PROJECT

JAPAN INTERNATIONAL COOPERATION AGENCY (JICA)

|           |            |          |          |          |           |
|-----------|------------|----------|----------|----------|-----------|
| REVISIONS | DATE       | DESIGNED | CHECKED  | REVIEWED | SUBMITTED |
| B         | 1 AUG. 84  | T.K.A.O. | K.A.K.M. |          |           |
| A         | 15 FEB. 84 | T.K.A.O. | K.A.K.M. |          |           |

VIADUCT V127  
GENERAL VIEW  
(SHEET 2 OF 2)

PACKAGE: I CIVIL AND ARCHITECTURAL WORK  
SCALE: 1:100  
DRAWING NO.: CS-253

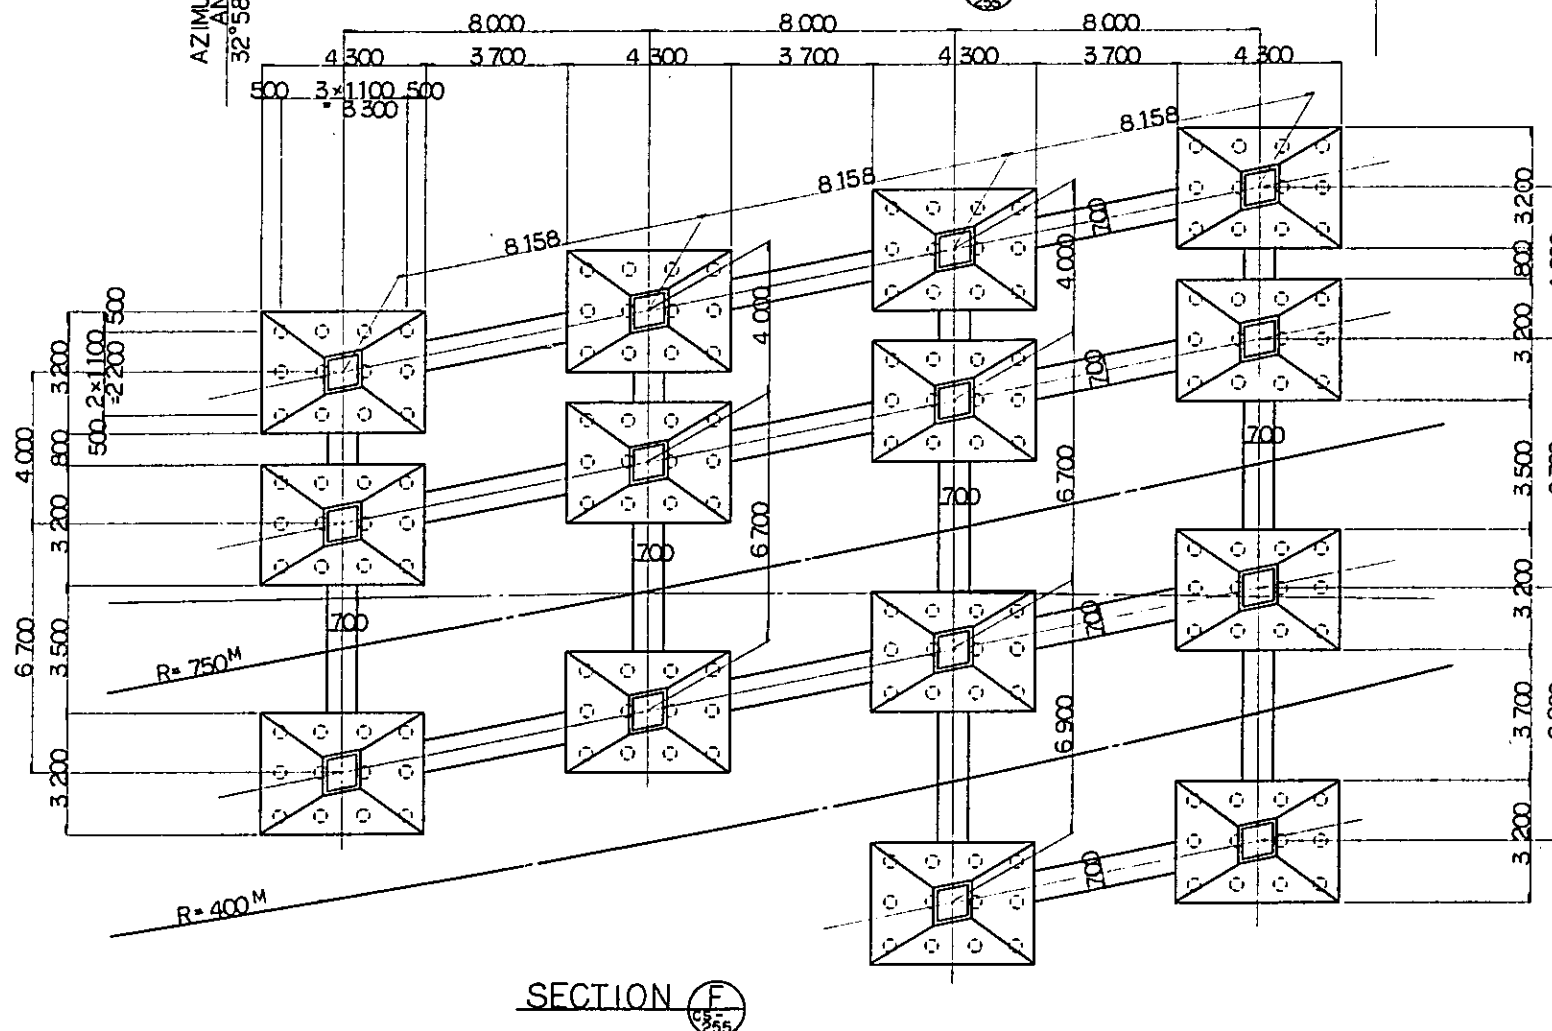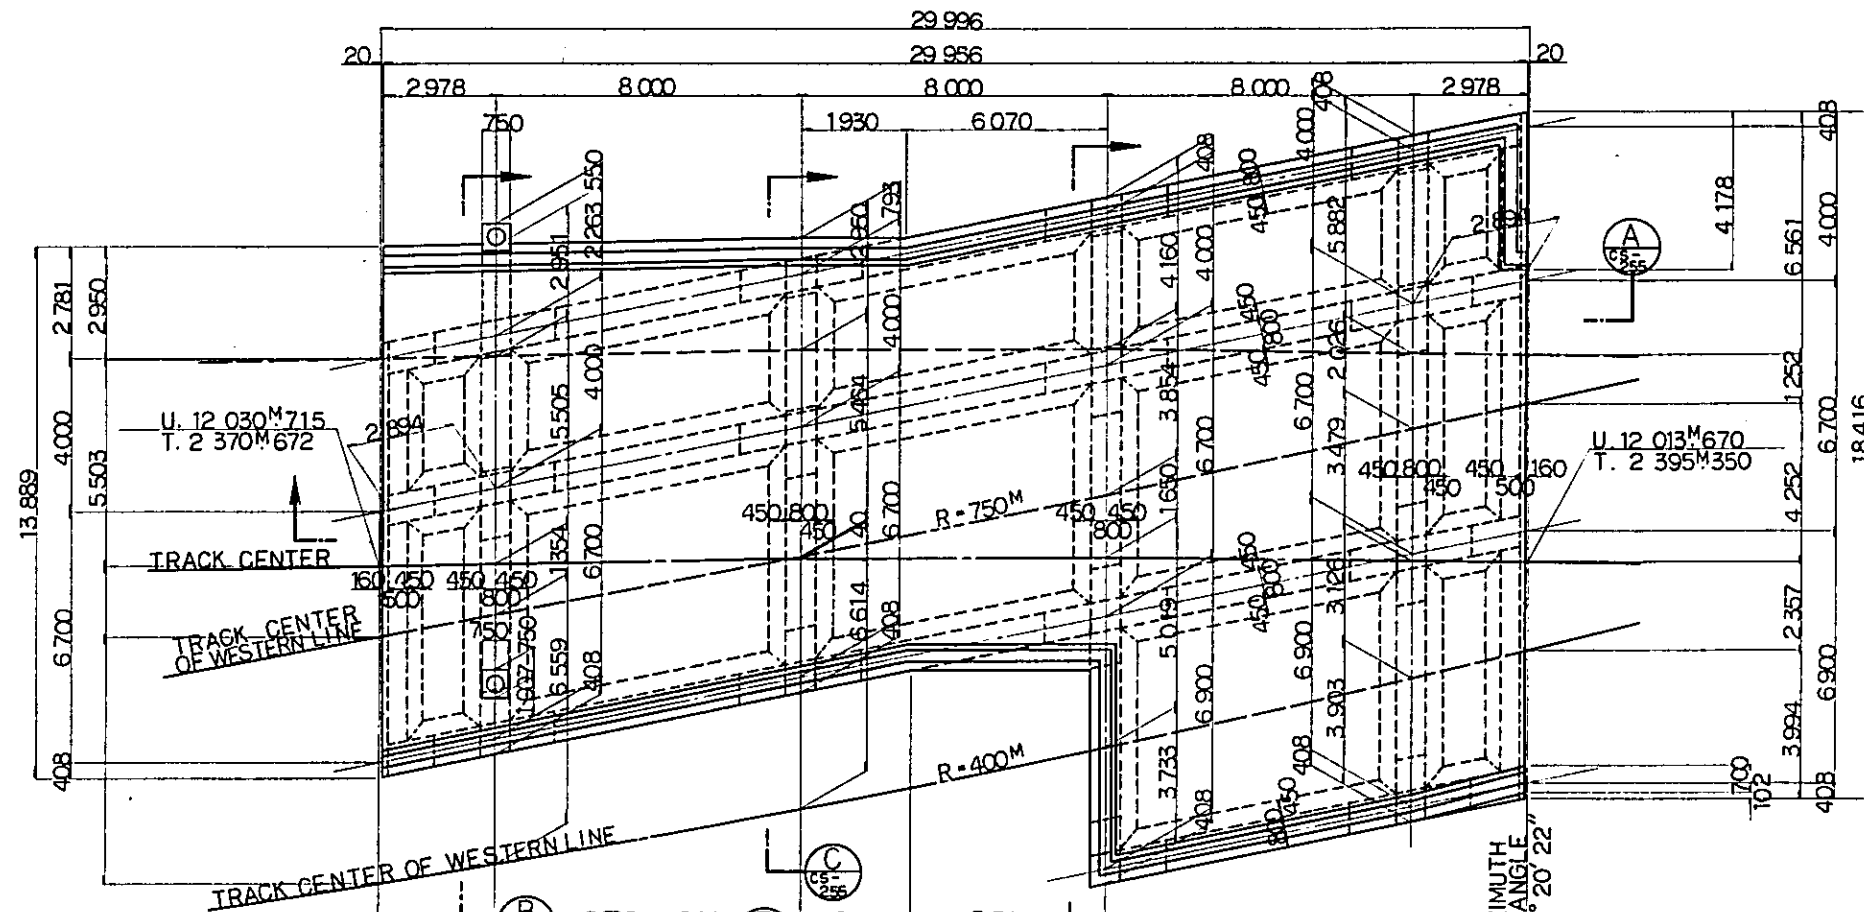

- NOTES:
1. ALL DIMENSIONS ARE SHOWN IN MILLIMETERS UNLESS OTHERWISE INDICATED
  2. REFERENCE DRAWING FOR BAR ARRANGEMENT:

|          |          |
|----------|----------|
| CS - 258 | CS - 265 |
| CS - 259 | CS - 266 |
| CS - 260 | CS - 267 |
| CS - 261 | CS - 268 |
| CS - 262 | CS - 269 |
| CS - 263 | CS - 270 |
| CS - 264 | CS - 271 |

REPUBLIC OF INDONESIA  
 MINISTRY OF COMMUNICATIONS  
 DIRECTORATE GENERAL OF LAND TRANSPORT AND INLAND WATERWAYS

NEW RAILWAY LINE FOR CENGKARENG AIRPORT  
 CONSTRUCTION PROJECT


JAPAN INTERNATIONAL COOPERATION AGENCY  
 (JICA)

|   |         |          |    |
|---|---------|----------|----|
| B | 1AUG'84 | TKADKAKM | TK |
| A | 1FEB'84 | TKADKAKM | TK |


REVISIONS    DATE    DESIGNED    DRAWN    CHECKED    REVIEWED    SUBMITTED

VIADUCT VI28  
 GENERAL VIEW  
 (SHEET 1 OF 2)


PACKAGE: I CIVIL AND ARCHITECTURAL WORK  
 SCALE: 1:100    DRAWING NO: CS-254

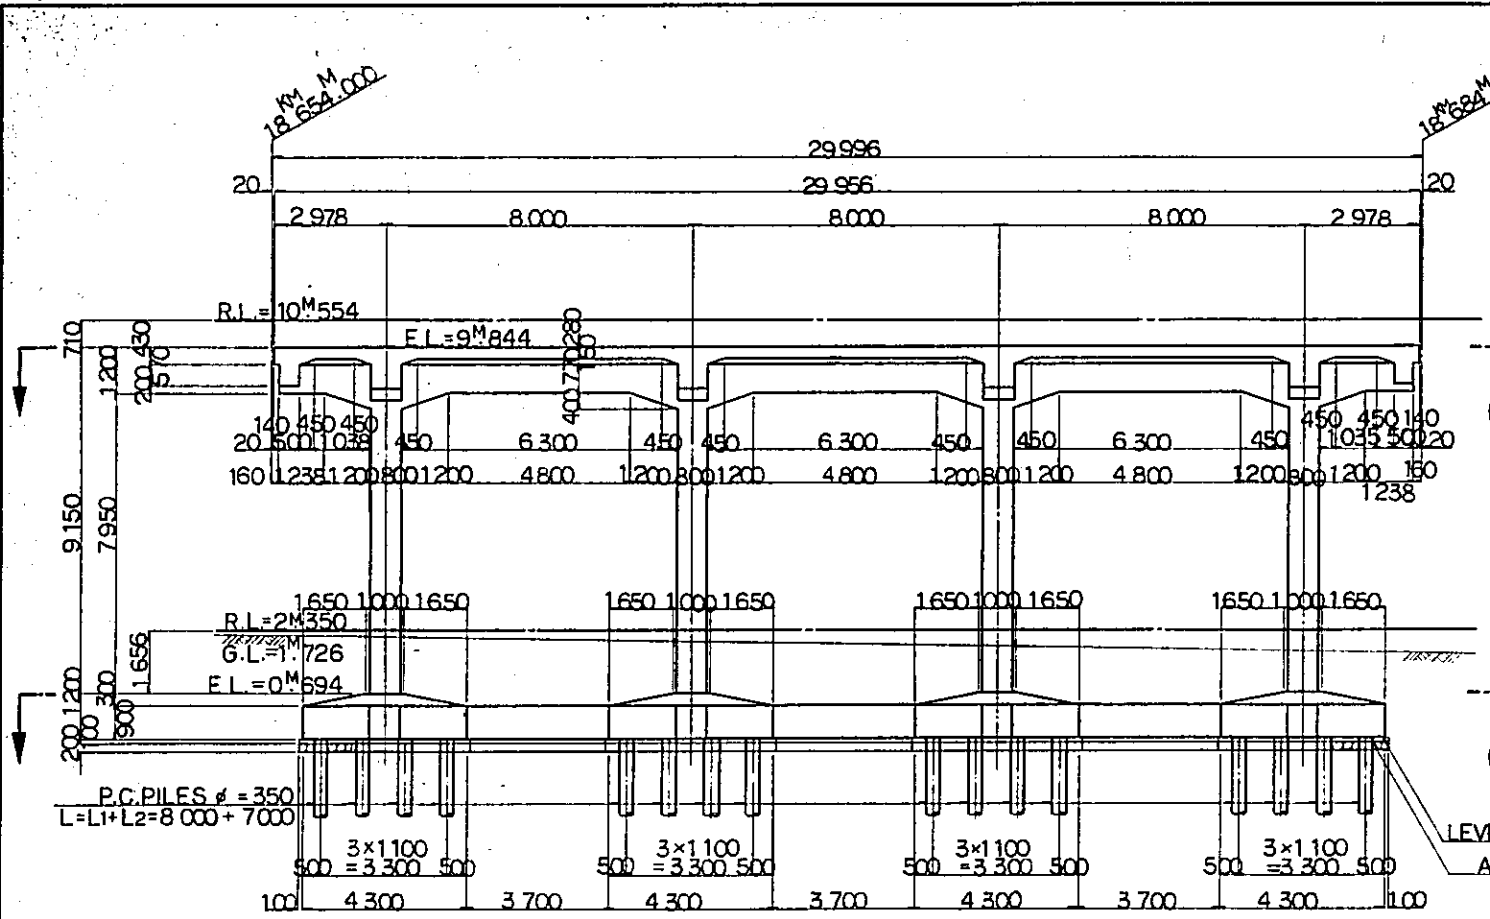


SECTION A  
CS-254

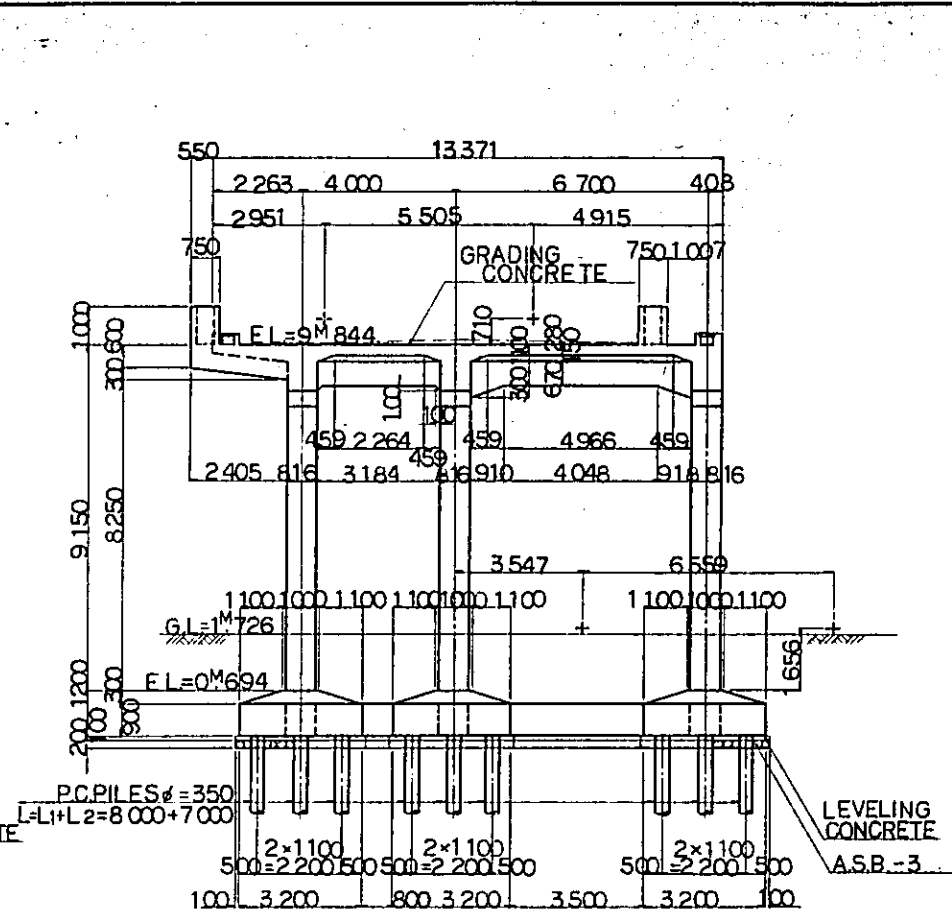

SECTION B  
CS-254

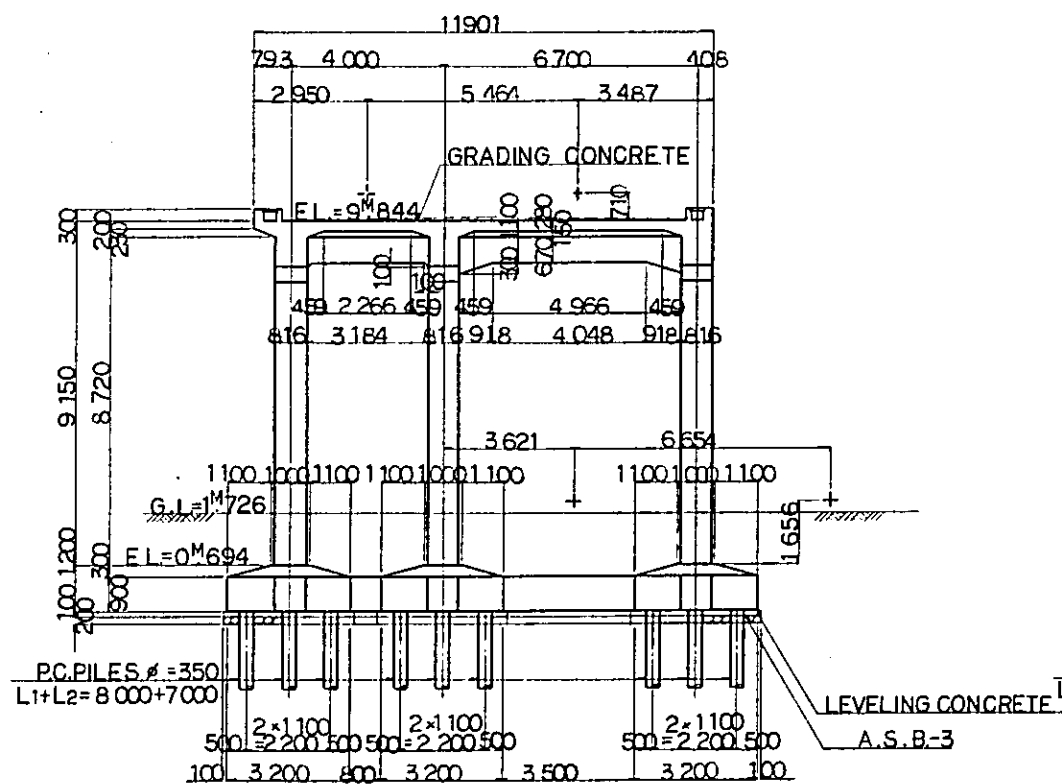


SECTION C  
CS-254

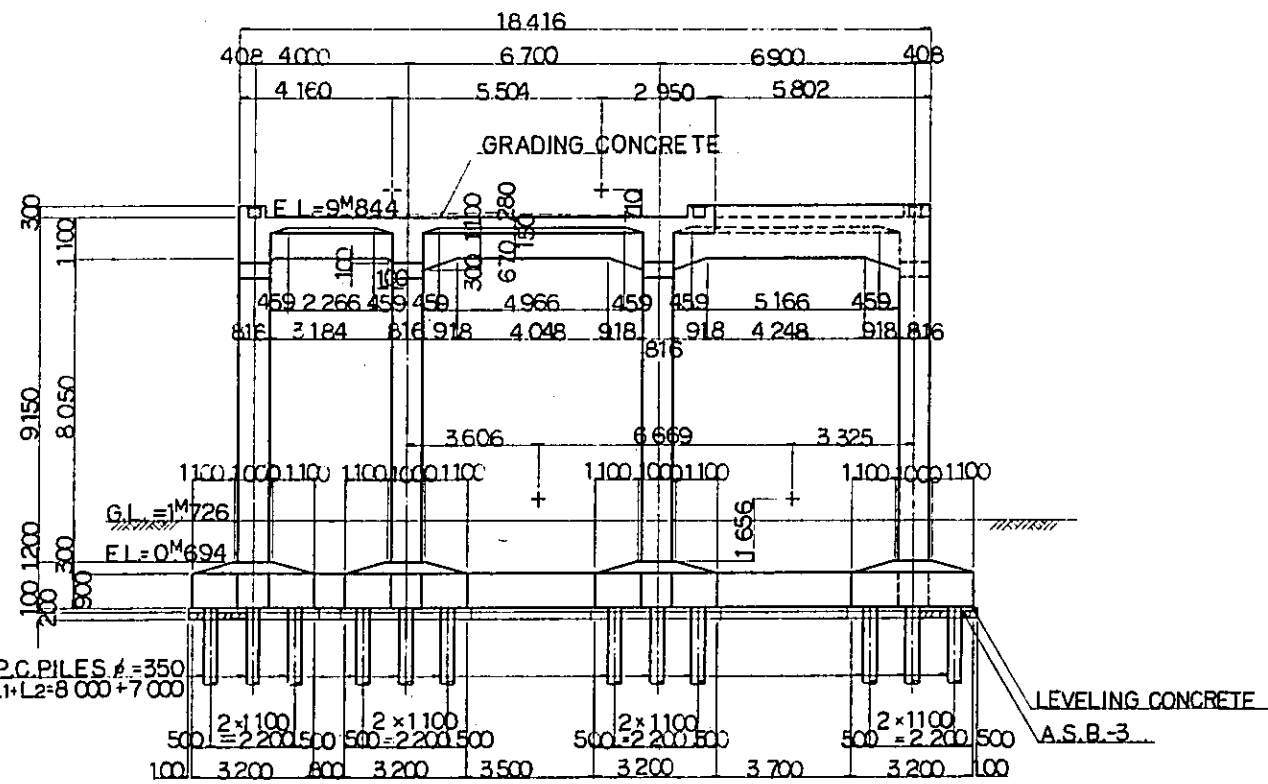

SECTION D  
CS-254



NOTES:  
1. ALL DIMENSIONS ARE SHOWN IN MILLIMETERS UNLESS OTHERWISE INDICATED  
2. REFERENCE DRAWING FOR BAR ARRANGEMENT:

|        |        |        |
|--------|--------|--------|
| CS-258 | CS-263 | CS-268 |
| CS-259 | CS-264 | CS-269 |
| CS-260 | CS-265 | CS-270 |
| CS-261 | CS-266 | CS-271 |
| CS-262 | CS-267 |        |

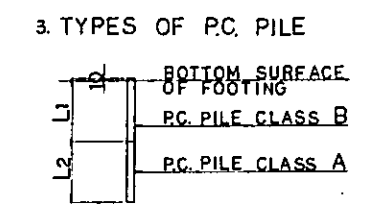

4. GRADING CONCRETE SHALL BE SIMULTANEOUSLY PLACED WITH SLAB CONCRETE

|   |             |          |       |         |          |
|---|-------------|----------|-------|---------|----------|
| REPUBLIC OF INDONESIA<br>MINISTRY OF COMMUNICATIONS<br>DIRECTORATE GENERAL OF LAND TRANSPORT AND INLAND WATERWAYS |             |          |       |         |          |
| NEW RAILWAY LINE FOR CENGKARENG AIRPORT CONSTRUCTION PROJECT  |             |          |       |         |          |
| JAPAN INTERNATIONAL COOPERATION AGENCY (JICA)   |             |          |       |         |          |
| B   | 1 AUG 84    | TK       | AD    | SK      | AK       |
| A   | 17 FEB 84   | TK       | AD    | SK      | AK       |
| REVISIONS   | DATE        | DESIGNED | DRAWN | CHECKED | APPROVED |
| VIADUCT V128<br>GENERAL VIEW<br>(SHEET 2 OF 2)  |             |          |       |         |          |
| PACKAGE: I CIVIL AND ARCHITECTURAL WORK   |             |          |       |         |          |
| SCALE   | DRAWING NO. |          |       |         |          |
| 1:100   | CS-255      |          |       |         |          |

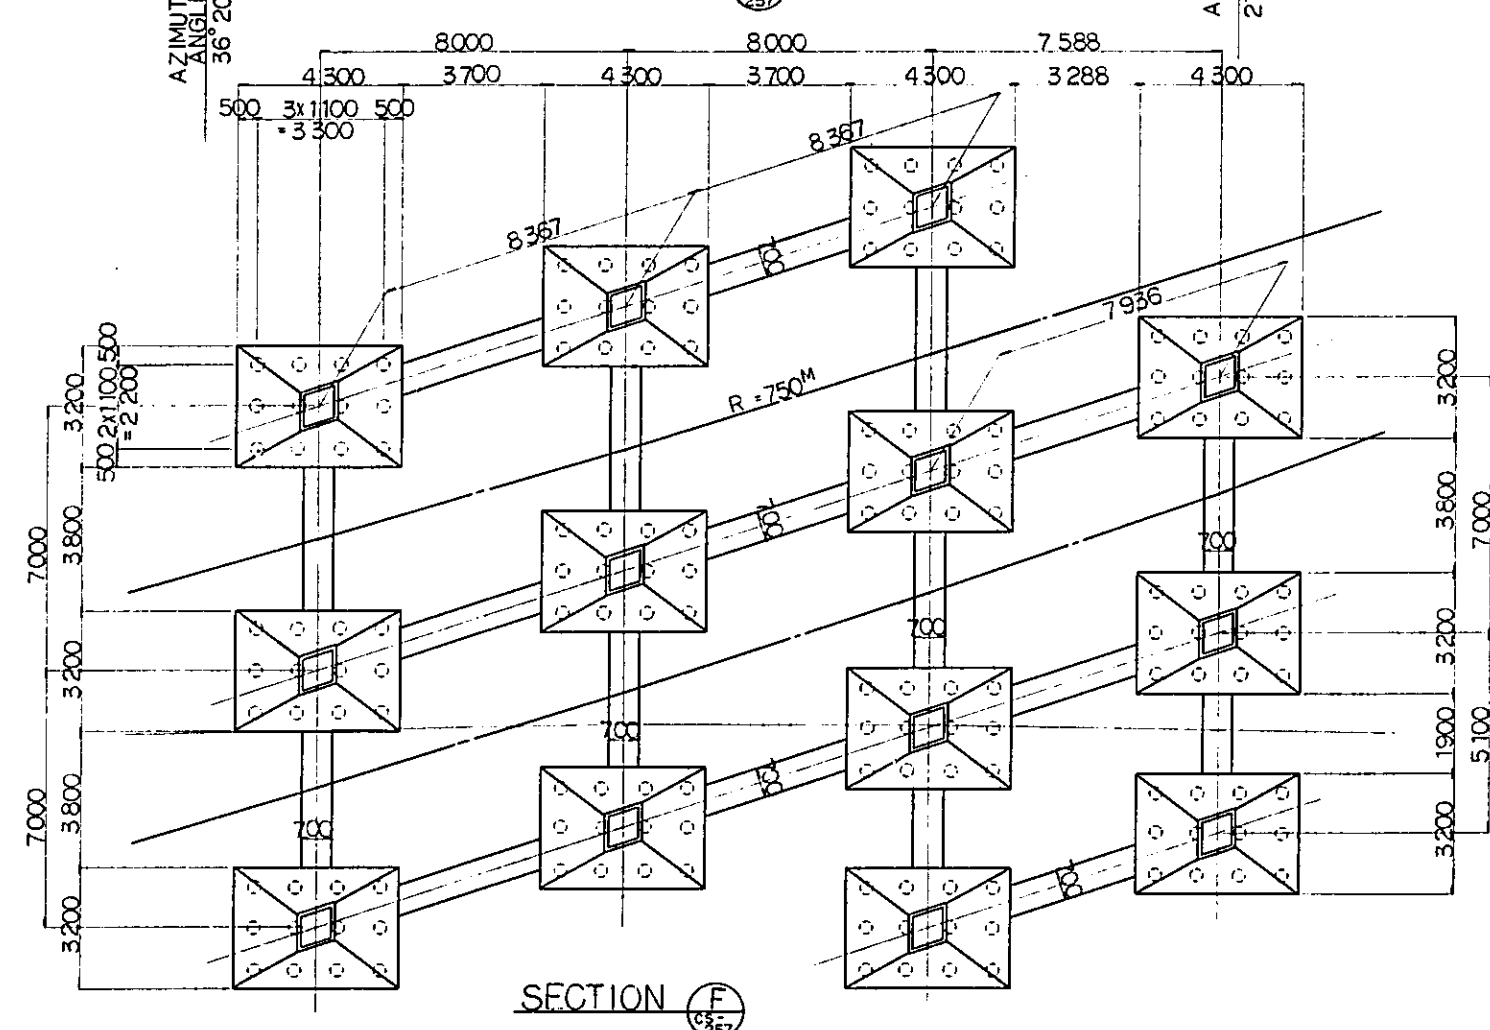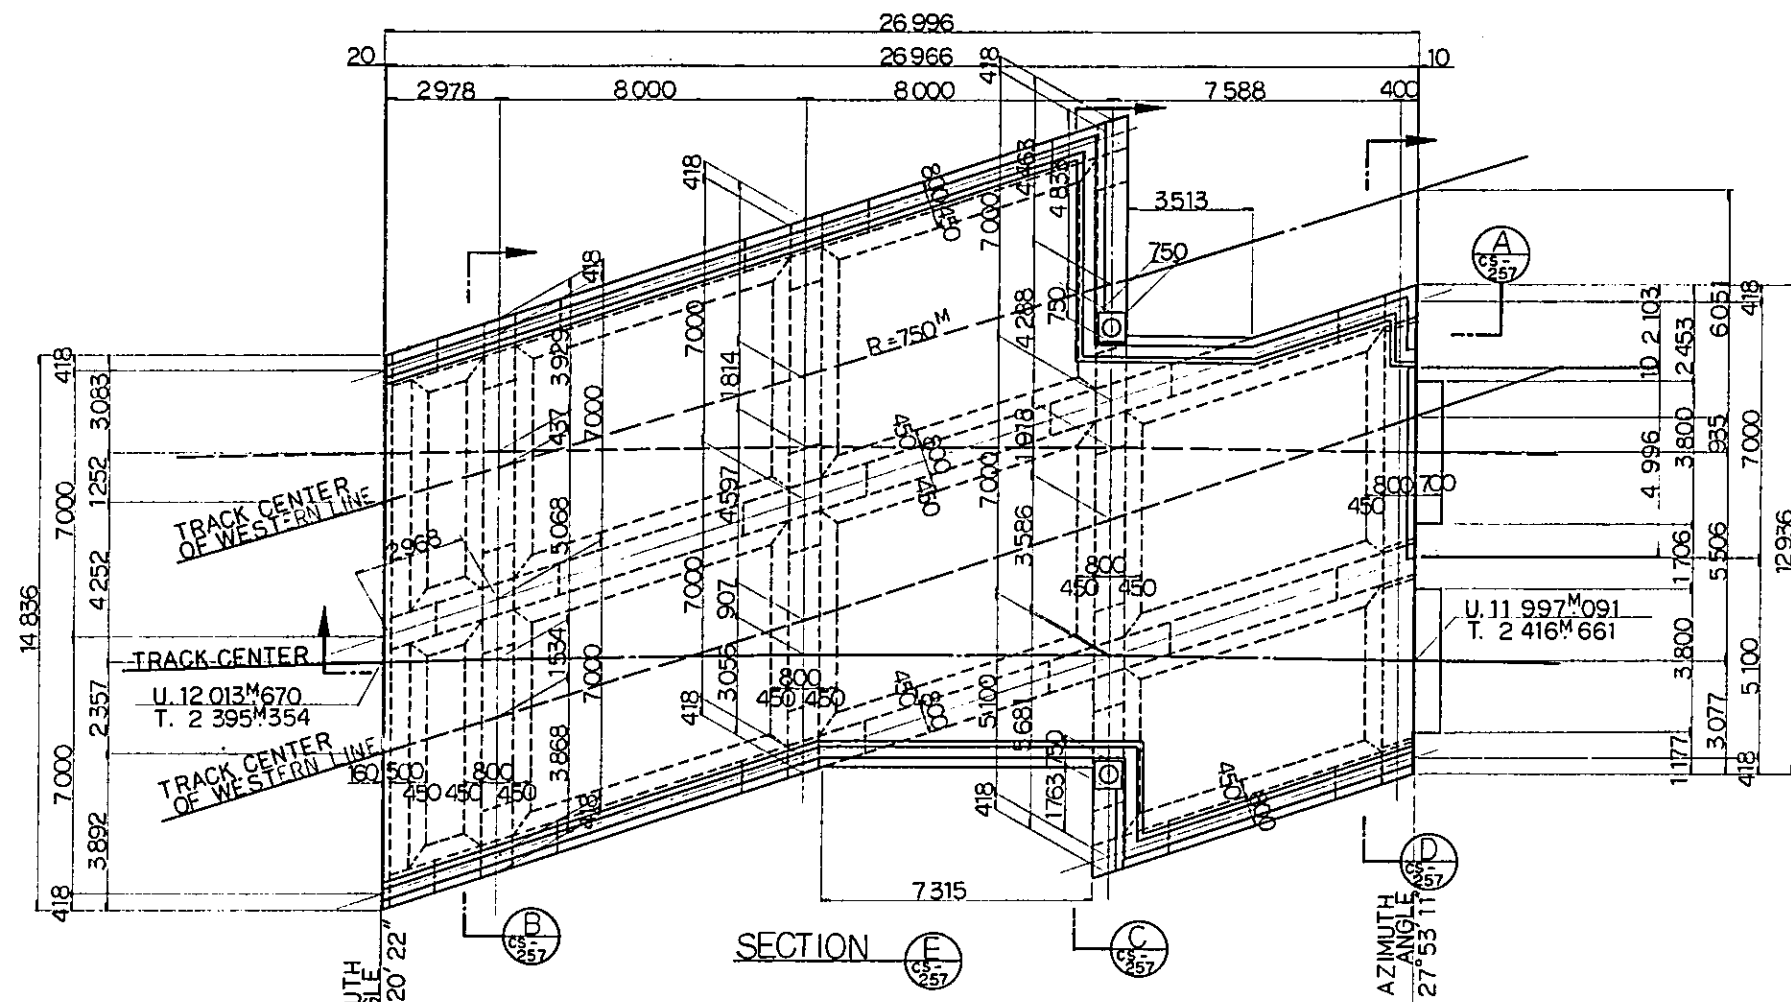

NOTES:  
 1. ALL DIMENSIONS ARE SHOWN IN MILLIMETERS UNLESS OTHERWISE INDICATED  
 2. REFERENCE DRAWING FOR BAR ARRANGEMENT:

|          |          |
|----------|----------|
| CS - 258 | CS - 265 |
| CS - 259 | CS - 266 |
| CS - 260 | CS - 267 |
| CS - 261 | CS - 268 |
| CS - 262 | CS - 269 |
| CS - 263 | CS - 270 |
| CS - 264 | CS - 271 |

REPUBLIC OF INDONESIA  
 MINISTRY OF COMMUNICATIONS  
 DIRECTORATE GENERAL OF LAND TRANSPORT AND INLAND WATERWAYS

NEW RAILWAY LINE FOR CENGKARENG AIRPORT  
 CONSTRUCTION PROJECT


JAPAN INTERNATIONAL COOPERATION AGENCY (JICA)

|   |           |    |    |    |    |  |
|---|-----------|----|----|----|----|--|
| B | 1 AUG '84 | TK | AO | KA | UM |  |
| A | 1 FEB '84 | TK | AO | KA | UM |  |


REVISIONS    DATE    DESIGNED    DRAWN    CHECKED    REVIEWED    SUBMITTED

VIADUCT V129  
 GENERAL VIEW  
 (SHEET 1 OF 2)


PACKAGE: I CIVIL AND ARCHITECTURAL WORK  
 SCALE: 1:100    DRAWING NO: CS-256

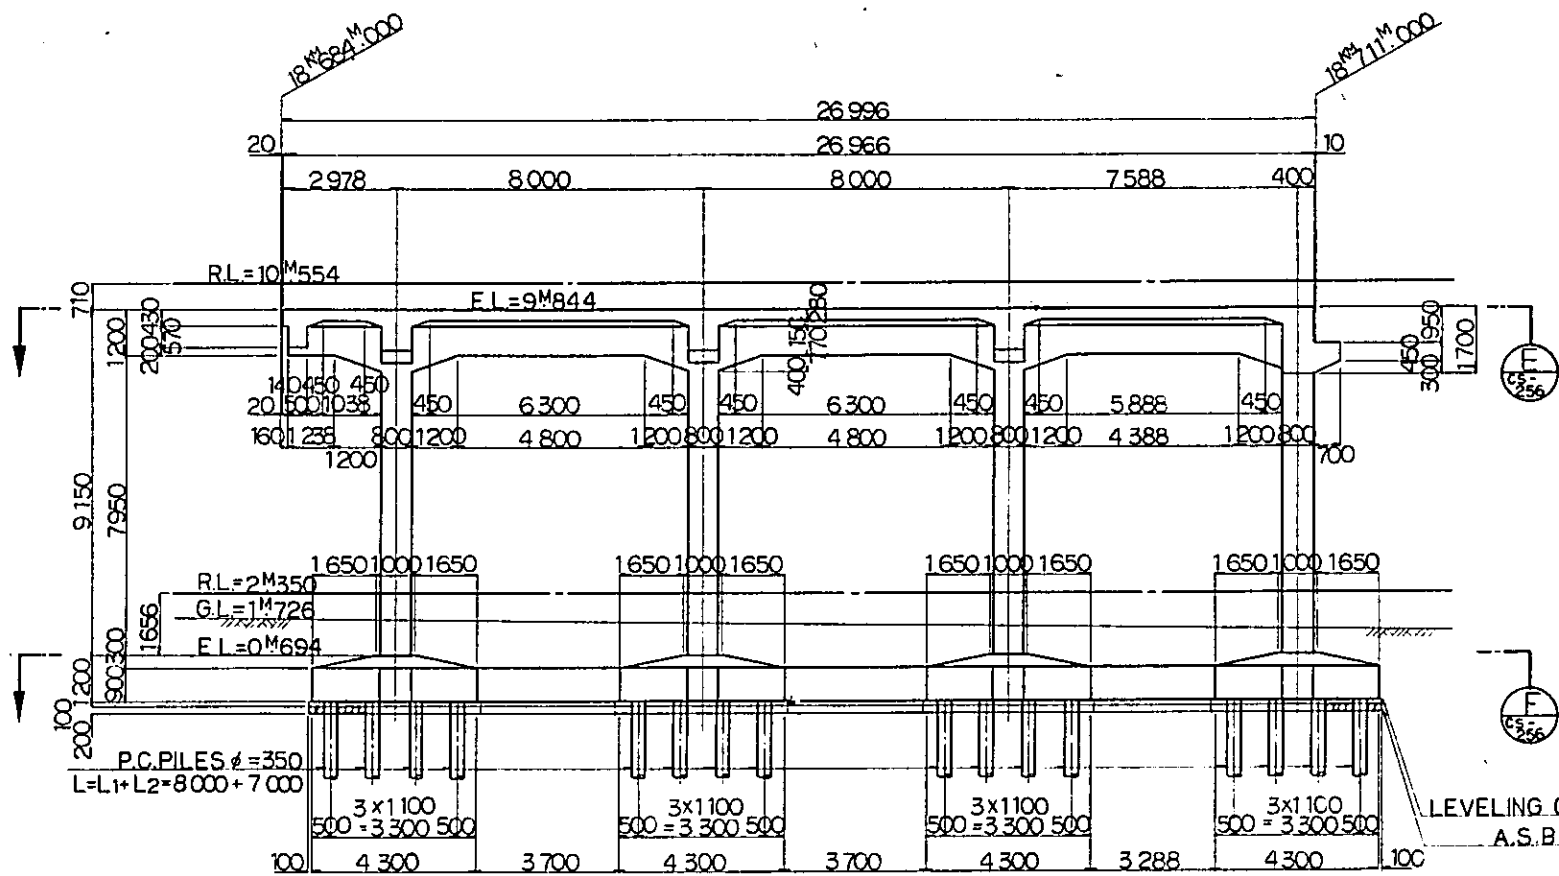


SECTION A  
CS-256

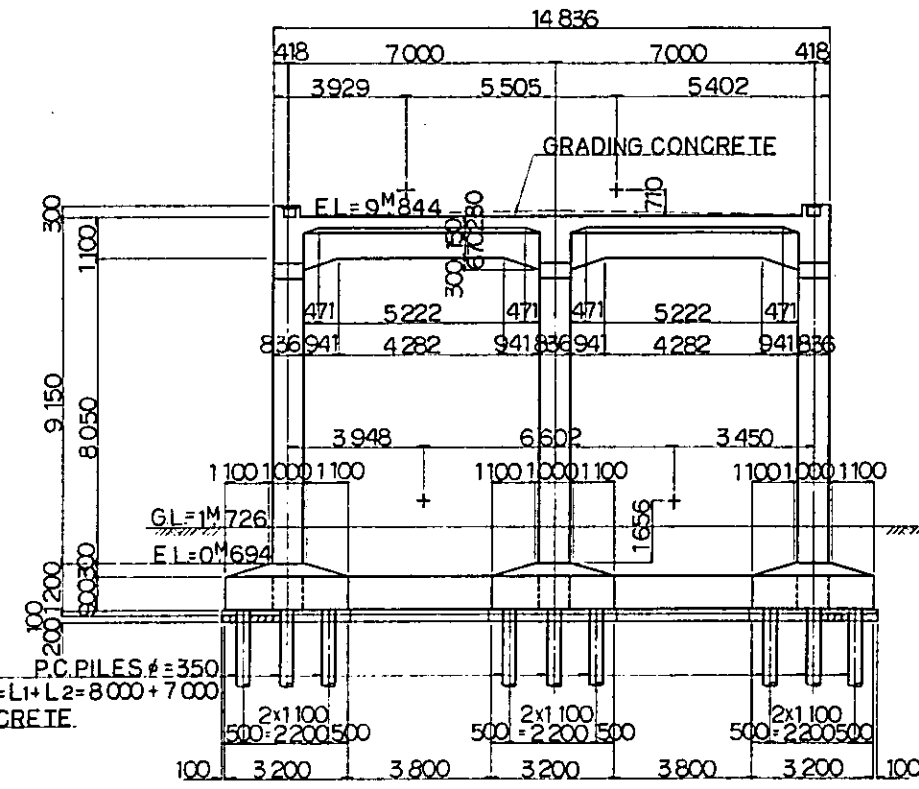

SECTION B  
CS-256

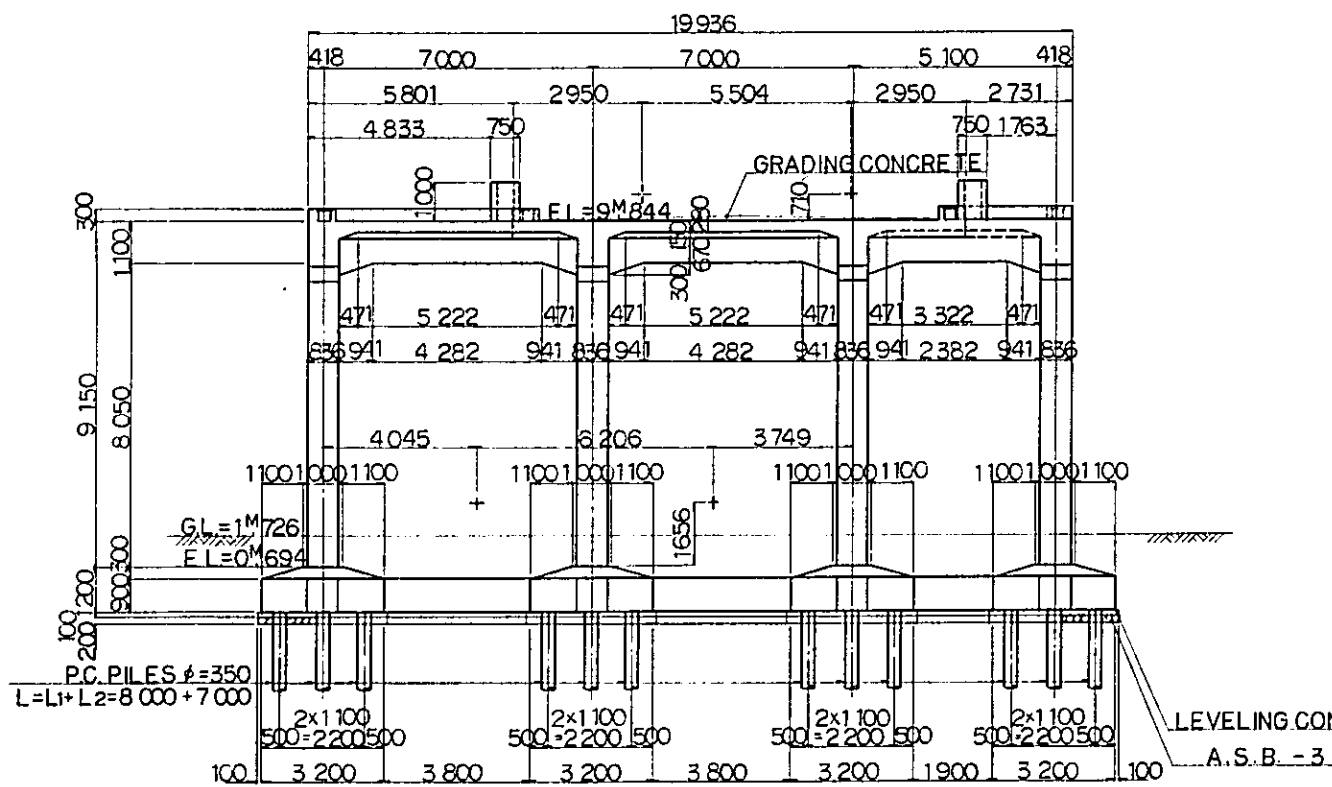

SECTION C  
CS-256

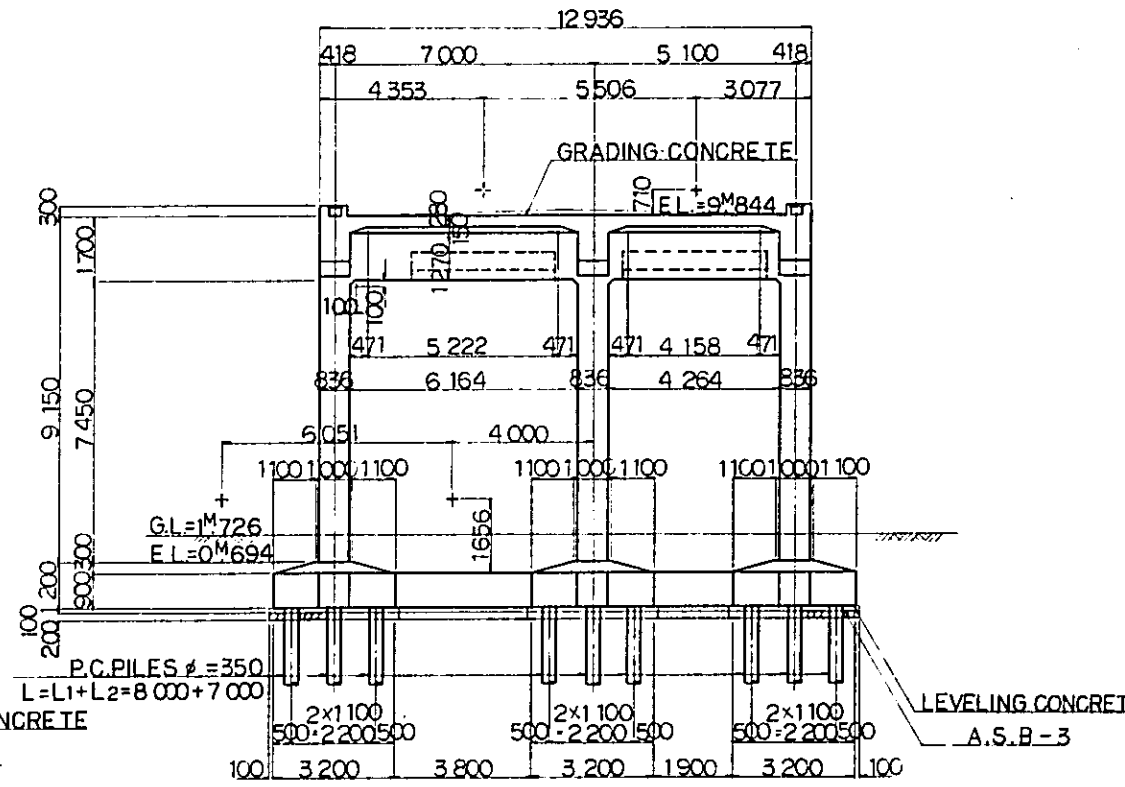


SECTION D  
CS-256

NOTES:  
1. ALL DIMENSIONS ARE SHOWN IN MILLIMETERS UNLESS OTHERWISE INDICATED

2. REFERENCE DRAWING FOR BAR ARRANGEMENT:


|        |        |        |
|--------|--------|--------|
| CS-258 | CS-263 | CS-268 |
| CS-259 | CS-264 | CS-269 |
| CS-260 | CS-265 | CS-270 |
| CS-261 | CS-266 | CS-271 |
| CS-262 | CS-267 |        |

3. TYPES OF P.C. PILE

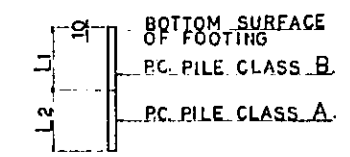

4. GRADING CONCRETE SHALL BE SIMULTANEOUSLY PLACED WITH SLAB CONCRETE

|   |                    |       |         |          |           |
|---|--------------------|-------|---------|----------|-----------|
| REPUBLIC OF INDONESIA<br>MINISTRY OF COMMUNICATIONS<br>DIRECTORATE GENERAL OF LAND TRANSPORT AND INLAND WATERWAYS |                    |       |         |          |           |
| NEW RAILWAY LINE FOR CENGKARENG AIRPORT<br>CONSTRUCTION PROJECT   |                    |       |         |          |           |
| JAPAN INTERNATIONAL COOPERATION AGENCY (JICA)   |                    |       |         |          |           |
| B   | 1 AUG '84          | TK    | AD      | KA       | KM        |
| A   | 15 FEB '84         | TK    | AD      | KA       | KM        |
| REVISORS  | DATE               | DRAWN | CHECKED | REVIEWED | SUBMITTED |
| VIADUCT V129<br>GENERAL VIEW<br>(SHEET 2 OF 2)  |                    |       |         |          |           |
| PACKAGE: I CIVIL AND ARCHITECTURAL WORK   |                    |       |         |          |           |
| SCALE   | DRAWING NO. CS-257 |       |         |          |           |

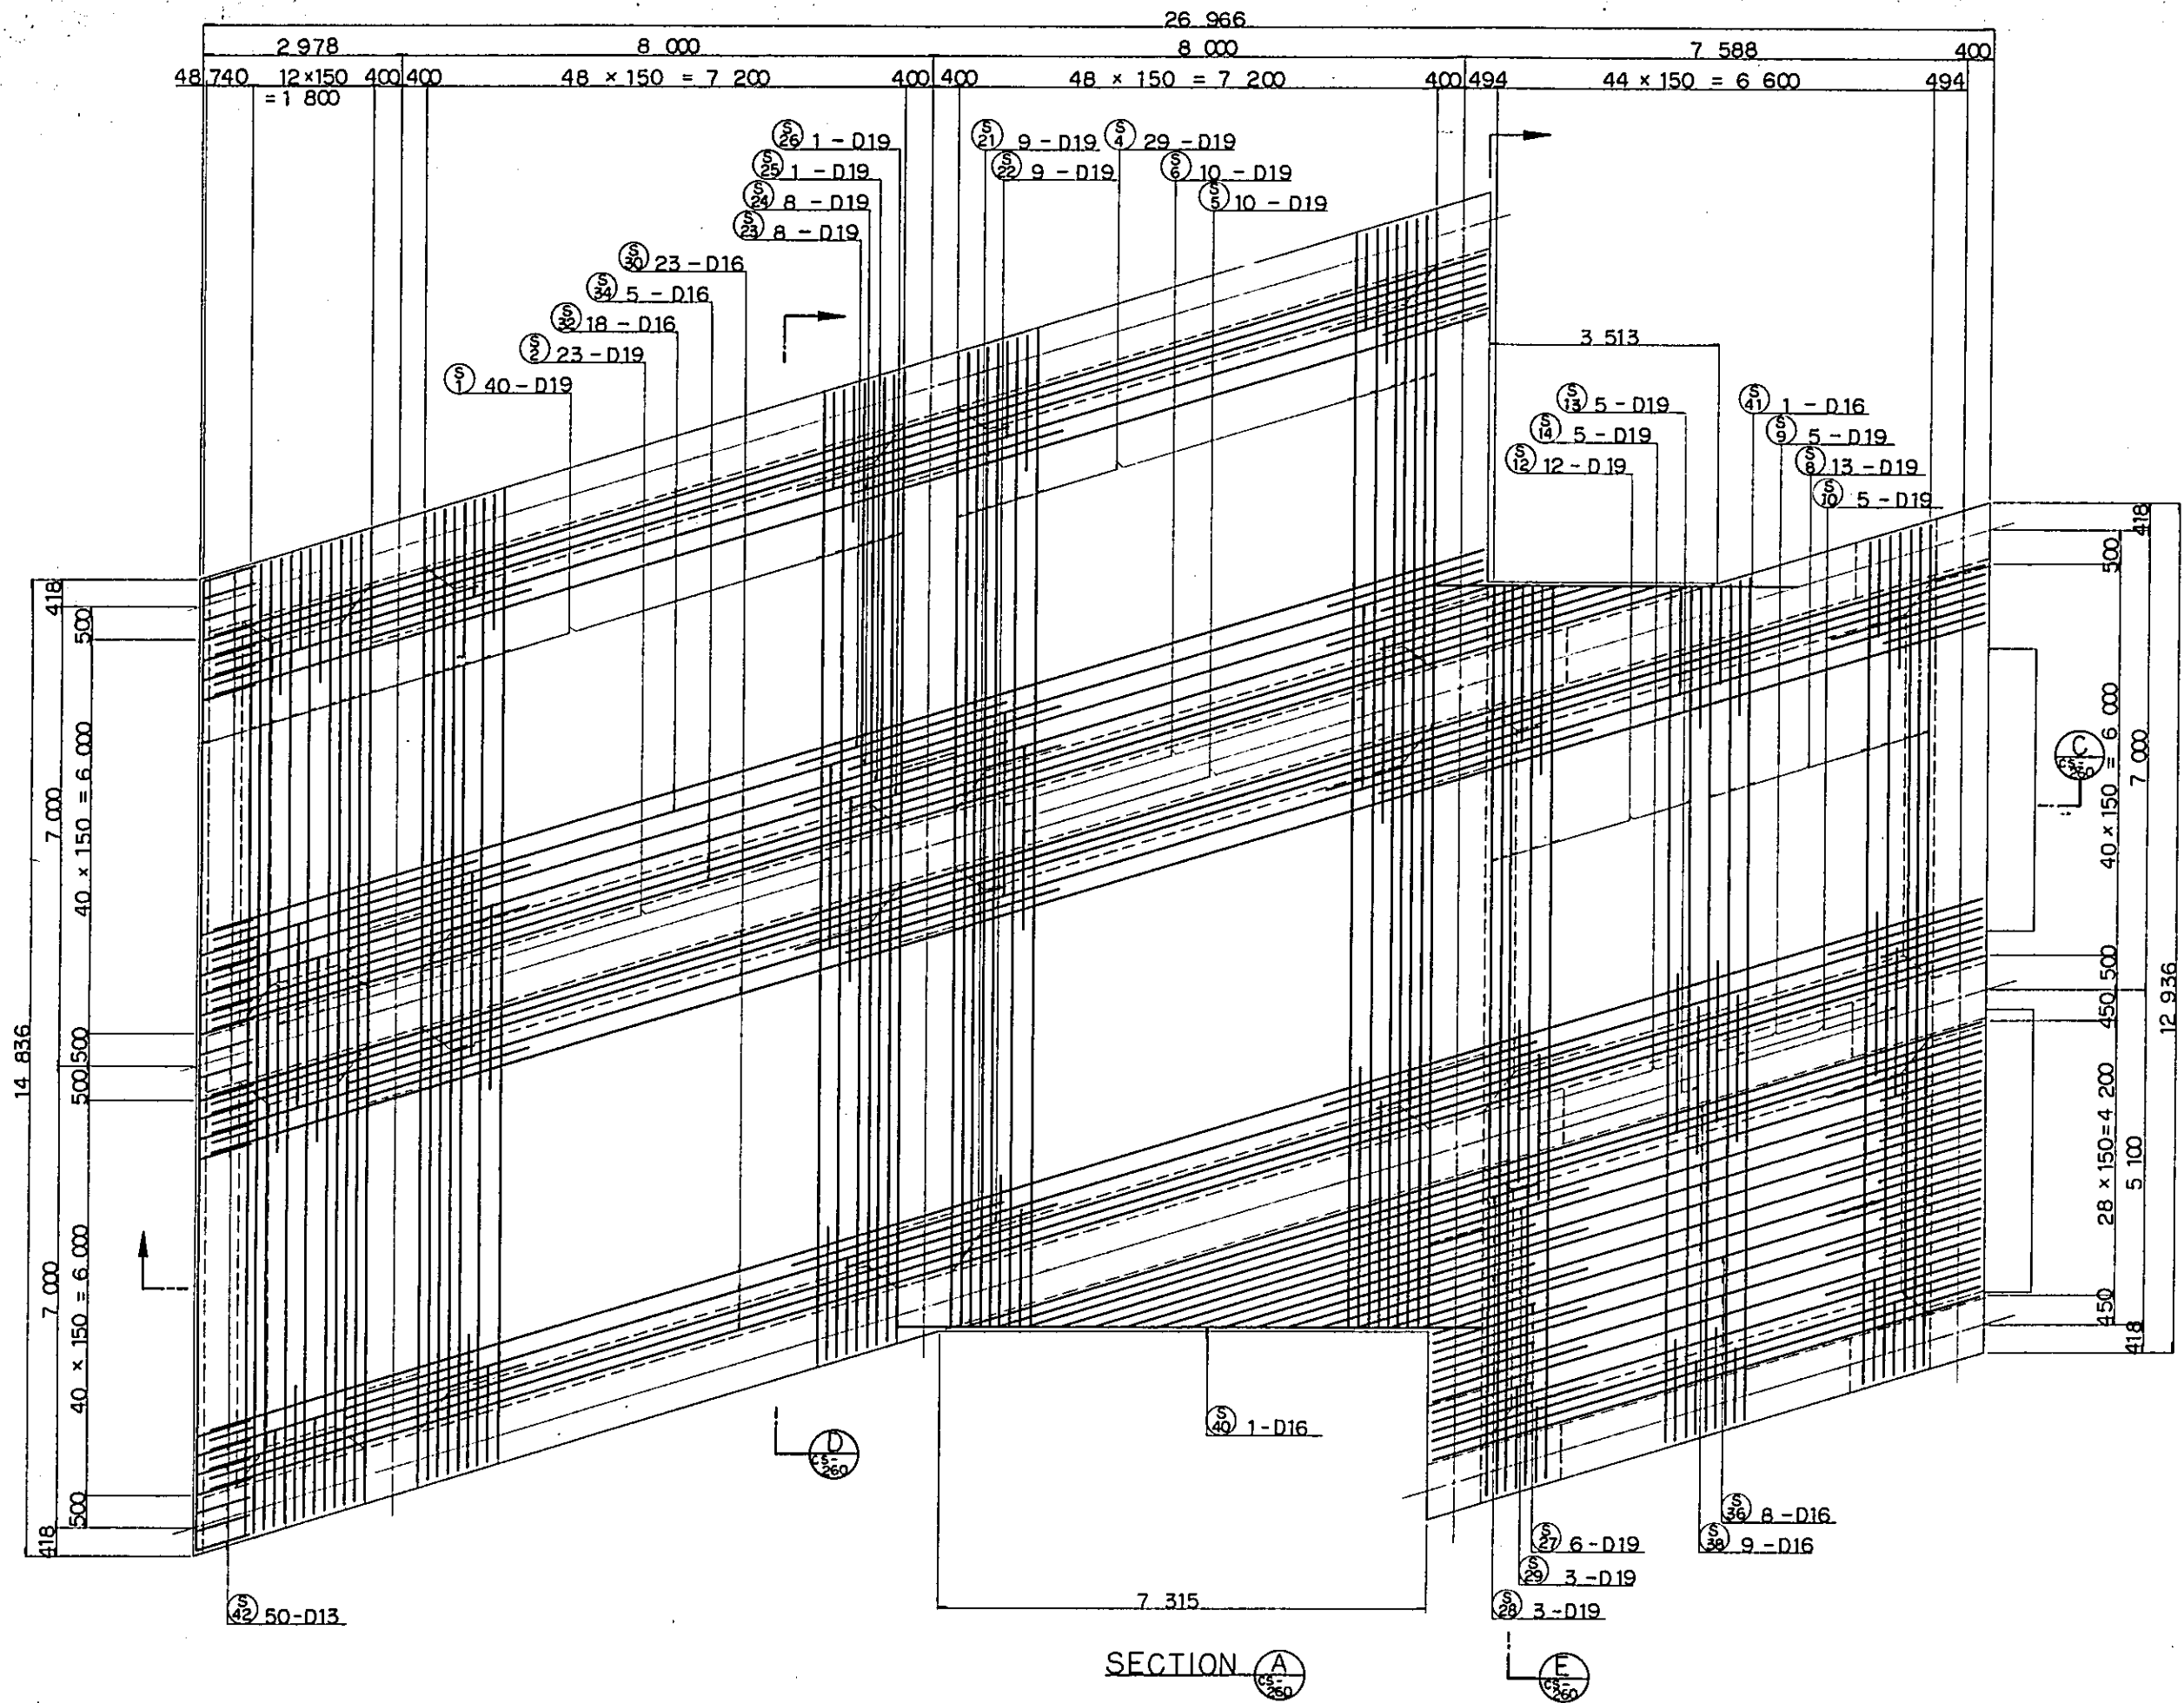


NOTES:

- ALL DIMENSIONS ARE SHOWN IN MILLIMETERS UNLESS OTHERWISE INDICATED
- REFERENCE DRAWING FOR GENERAL VIEW : CS - 256, CS - 257.








|  |                    |          |       |         |           |
|--|--------------------|----------|-------|---------|-----------|
| REPUBLIC OF INDONESIA<br>MINISTRY OF COMMUNICATIONS<br>DIRECTORATE GENERAL OF LAND TRANSPORT<br>AND INLAND WATERWAYS |                    |          |       |         |           |
| NEW RAILWAY LINE FOR CENGKARENG AIRPORT<br>CONSTRUCTION PROJECT  |                    |          |       |         |           |
| JAPAN INTERNATIONAL COOPERATION AGENCY<br>(JICA)   |                    |          |       |         |           |
| B  | 1 AUG '84          | TK       | AO    | KA      | AK        |
| A  | 1 FEB '84          | TK       | AO    | KA      | AK        |
| REVISIONS  | DATE               | DESIGNED | DRAWN | CHECKED | SUBMITTED |
| VIADUCT VI29<br>BAR ARRANGEMENT<br>(SHEET 1 OF 14)   |                    |          |       |         |           |
| PACKAGE: I CIVIL AND ARCHITECTURAL WORK  |                    |          |       |         |           |
| SCALE  | DRAWING NO: CS-258 |          |       |         |           |
| 1:50   |                    |          |       |         |           |











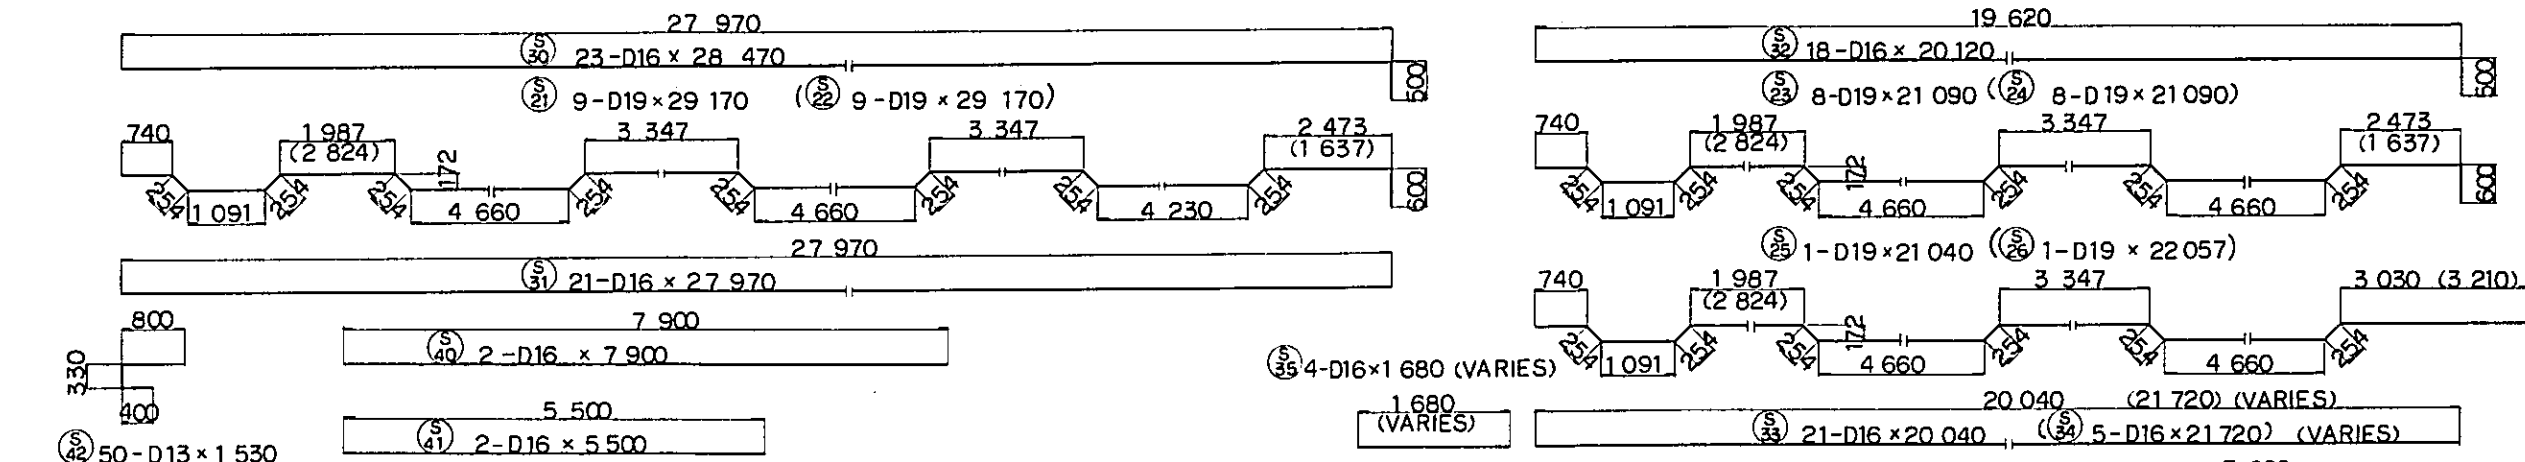



NOTES:  
 1. ALL DIMENSIONS ARE SHOWN IN MILLIMETERS UNLESS OTHERWISE INDICATED  
 2. REFERENCE DRAWING FOR GENERAL VIEW: CS - 256, CS - 257.

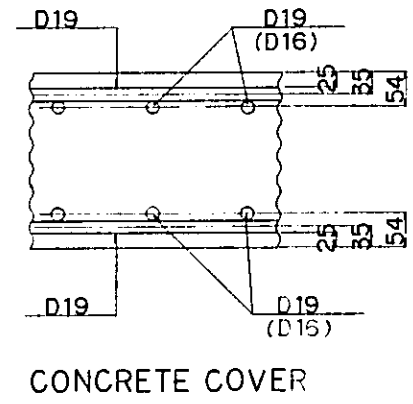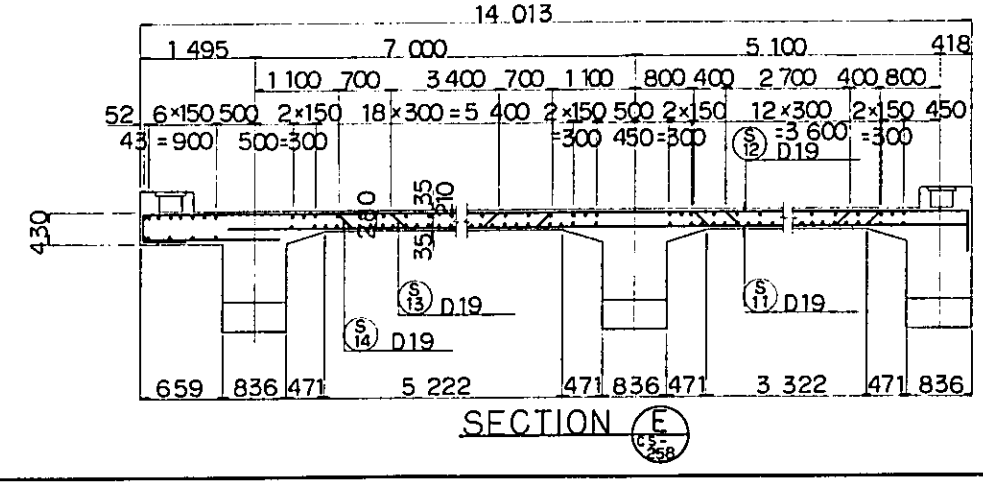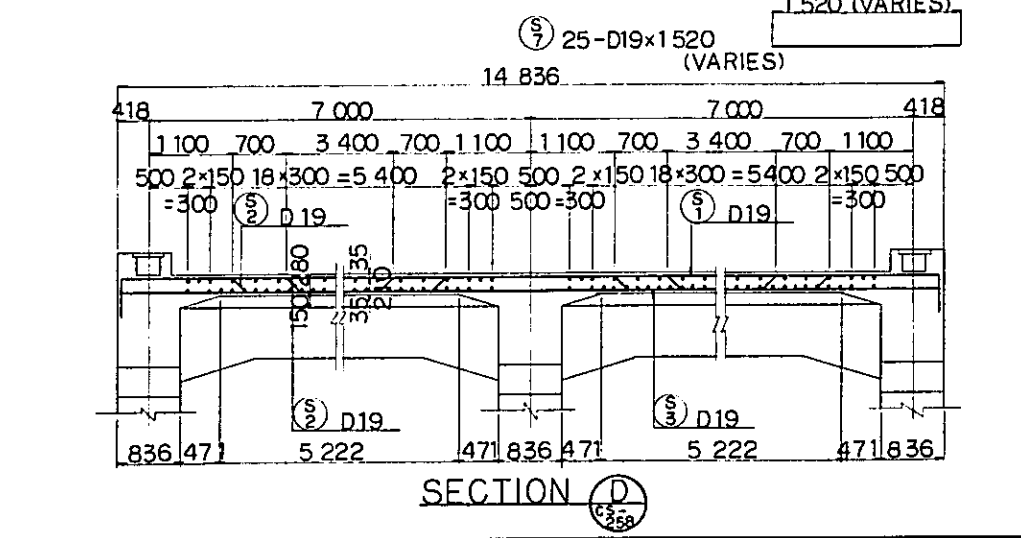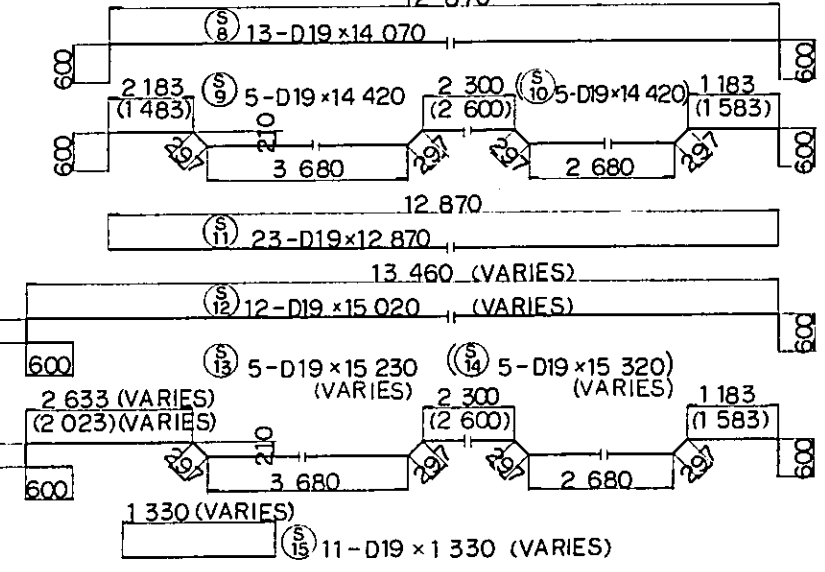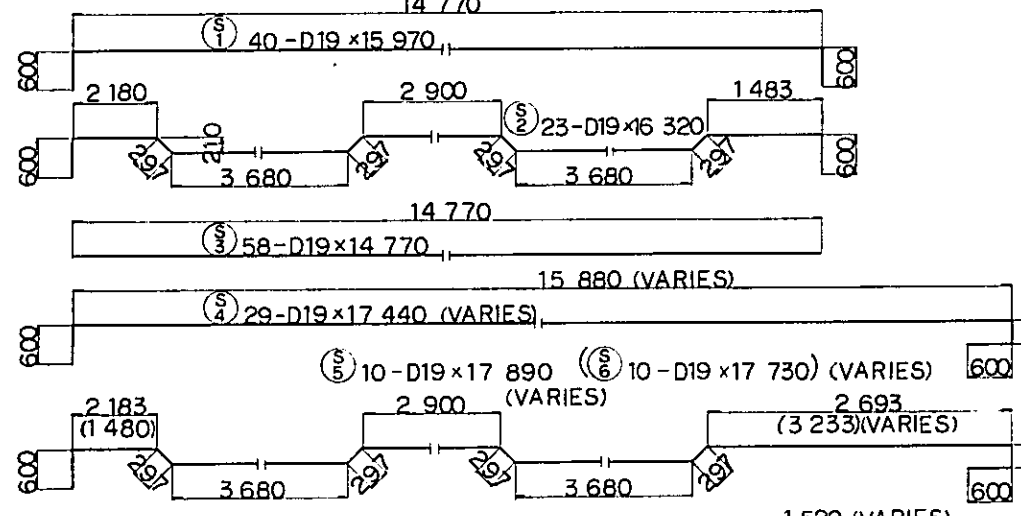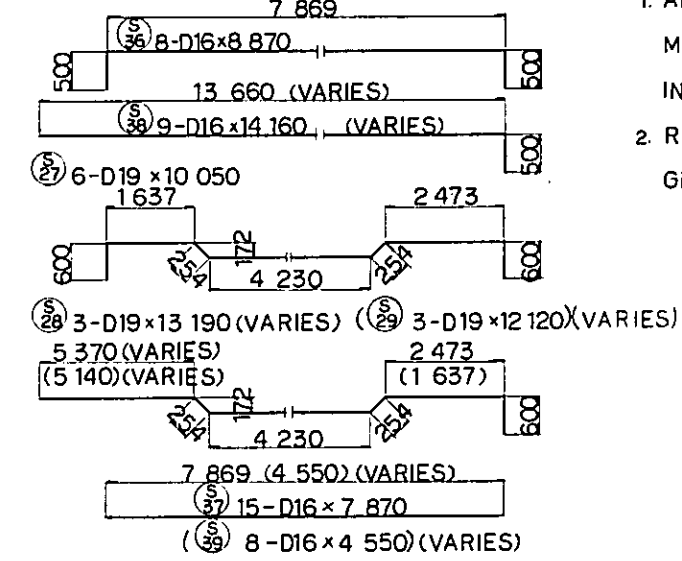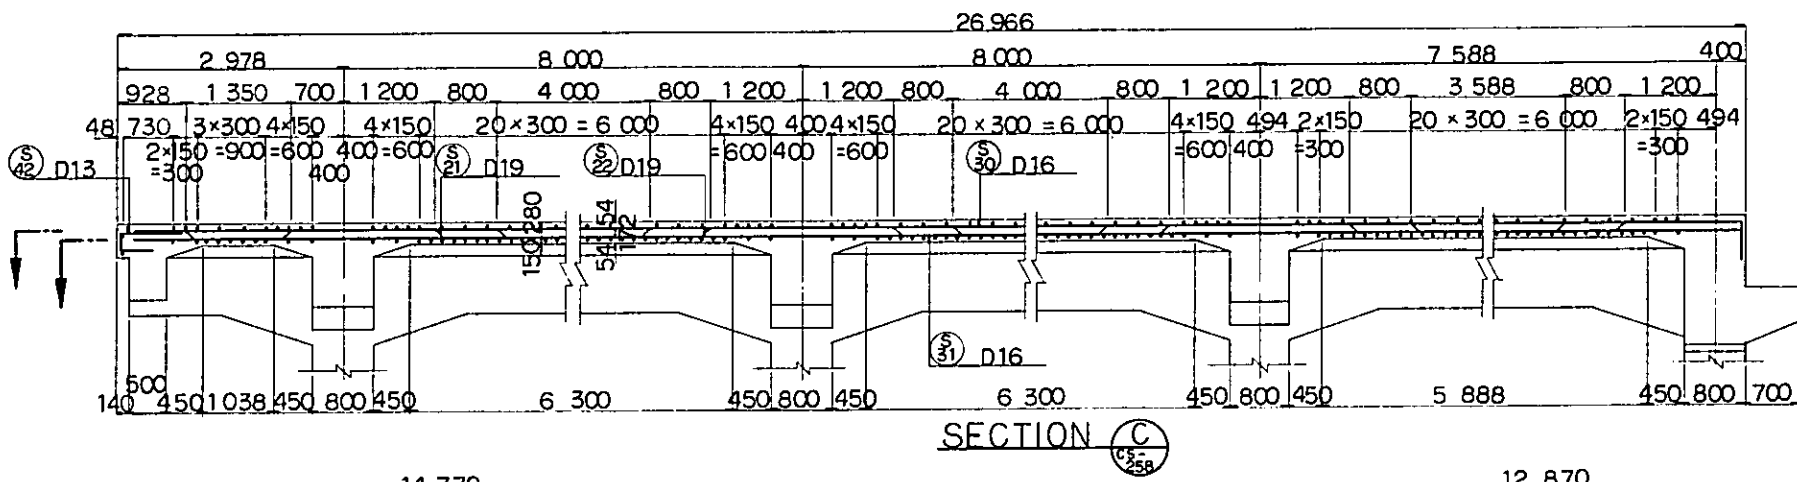


|  |           |                    |       |         |          |
|--|-----------|--------------------|-------|---------|----------|
| REPUBLIC OF INDONESIA<br>MINISTRY OF COMMUNICATIONS<br>DIRECTORATE GENERAL OF LAND TRANSPORT<br>AND INLAND WATERWAYS |           |                    |       |         |          |
| NEW RAILWAY LINE FOR CENGKARENG AIRPORT<br>CONSTRUCTION PROJECT  |           |                    |       |         |          |
| JAPAN INTERNATIONAL COOPERATION AGENCY<br>(JICA)   |           |                    |       |         |          |
| B  | 1 AUG '84 | TK                 | IO    | KA      | VM       |
| A  |           | TK                 | AD    | KA      | VM       |
| REVISIONS  | DATE      | DESIGNED           | DRAWN | CHECKED | REVIEWED |
| VIADUCT V129<br>BAR ARRANGEMENT<br>(SHEET 3 OF 14)   |           |                    |       |         |          |
| PACKAGE: I CIVIL AND ARCHITECTURAL WORK  |           |                    |       |         |          |
| SCALE: 1:50  |           | DRAWING NO: CS-260 |       |         |          |

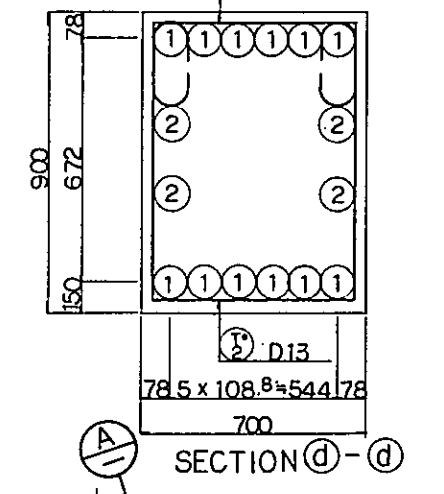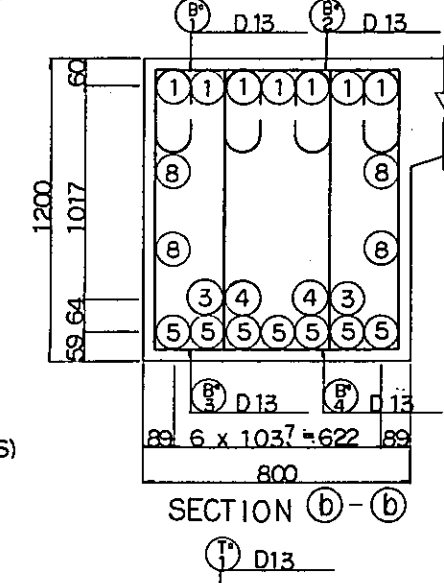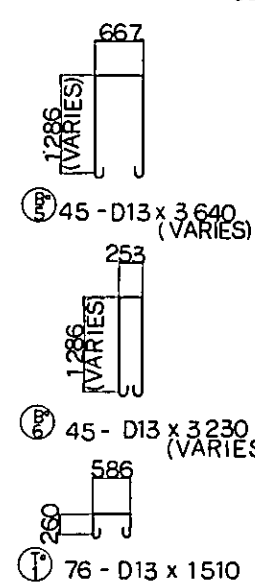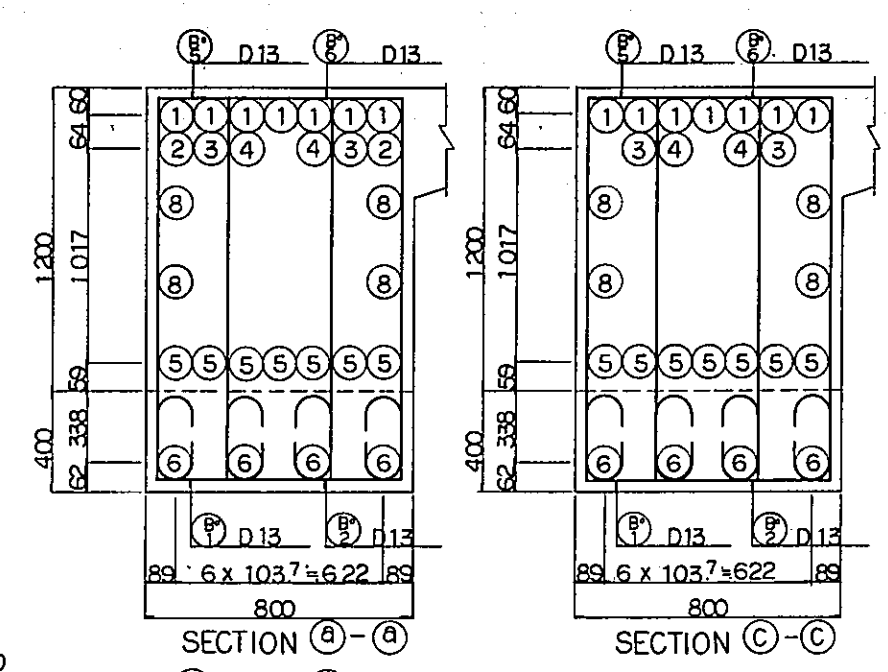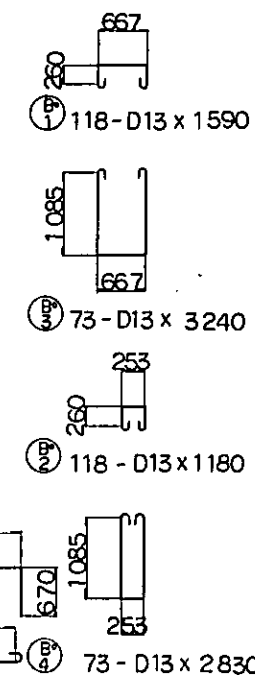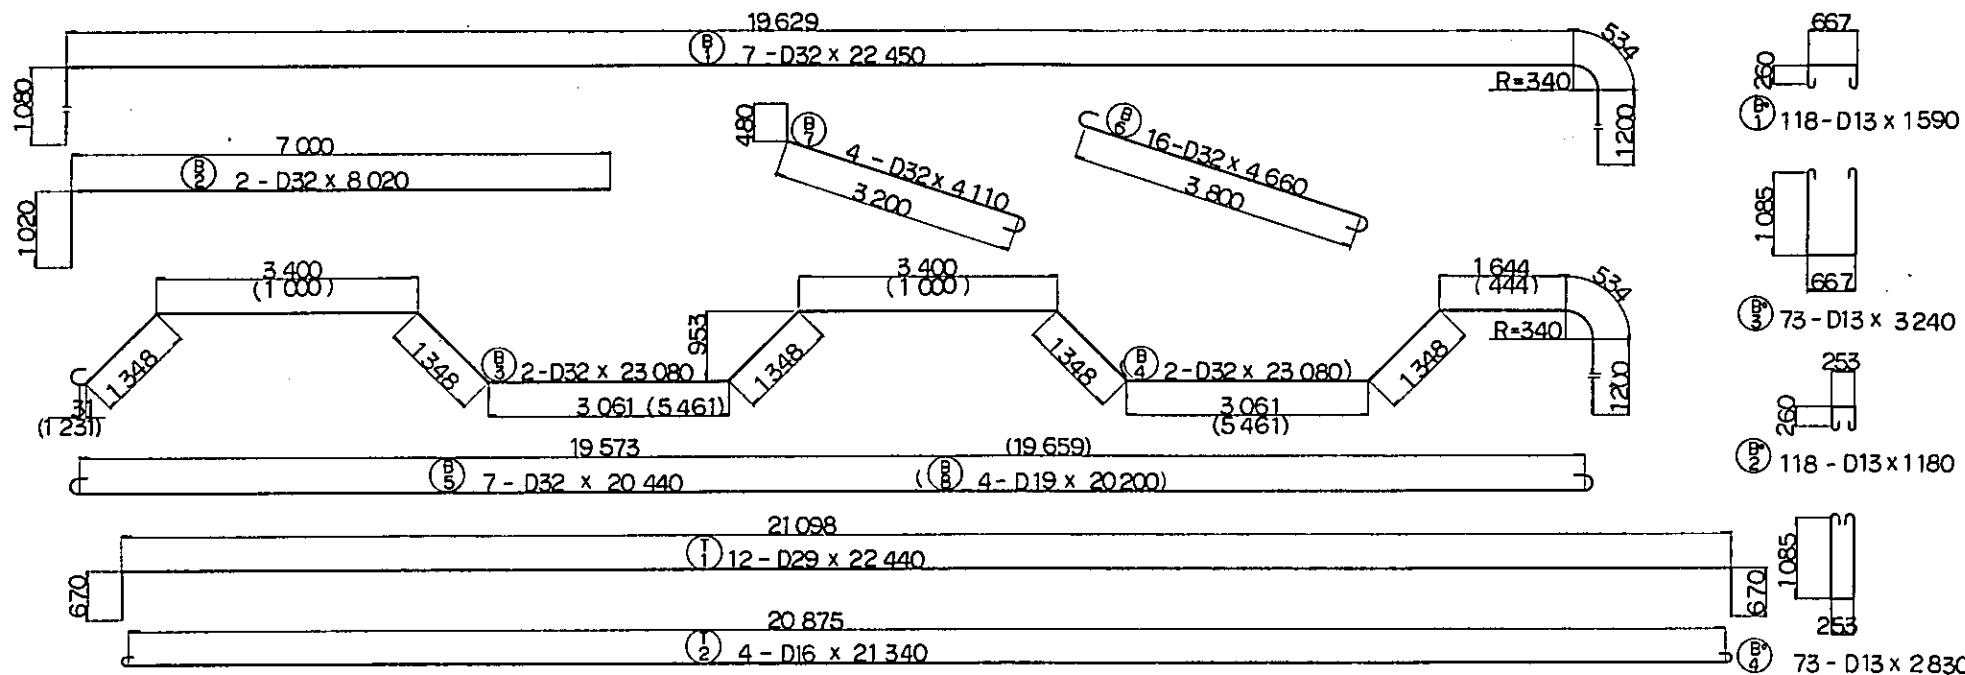


NOTES:  
 1. ALL DIMENSIONS ARE SHOWN IN MILLIMETERS UNLESS OTHERWISE INDICATED  
 2. REFERENCE DRAWING FOR GENERAL VIEW: CS - 256, CS - 257.

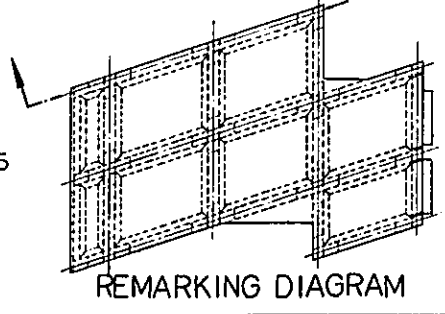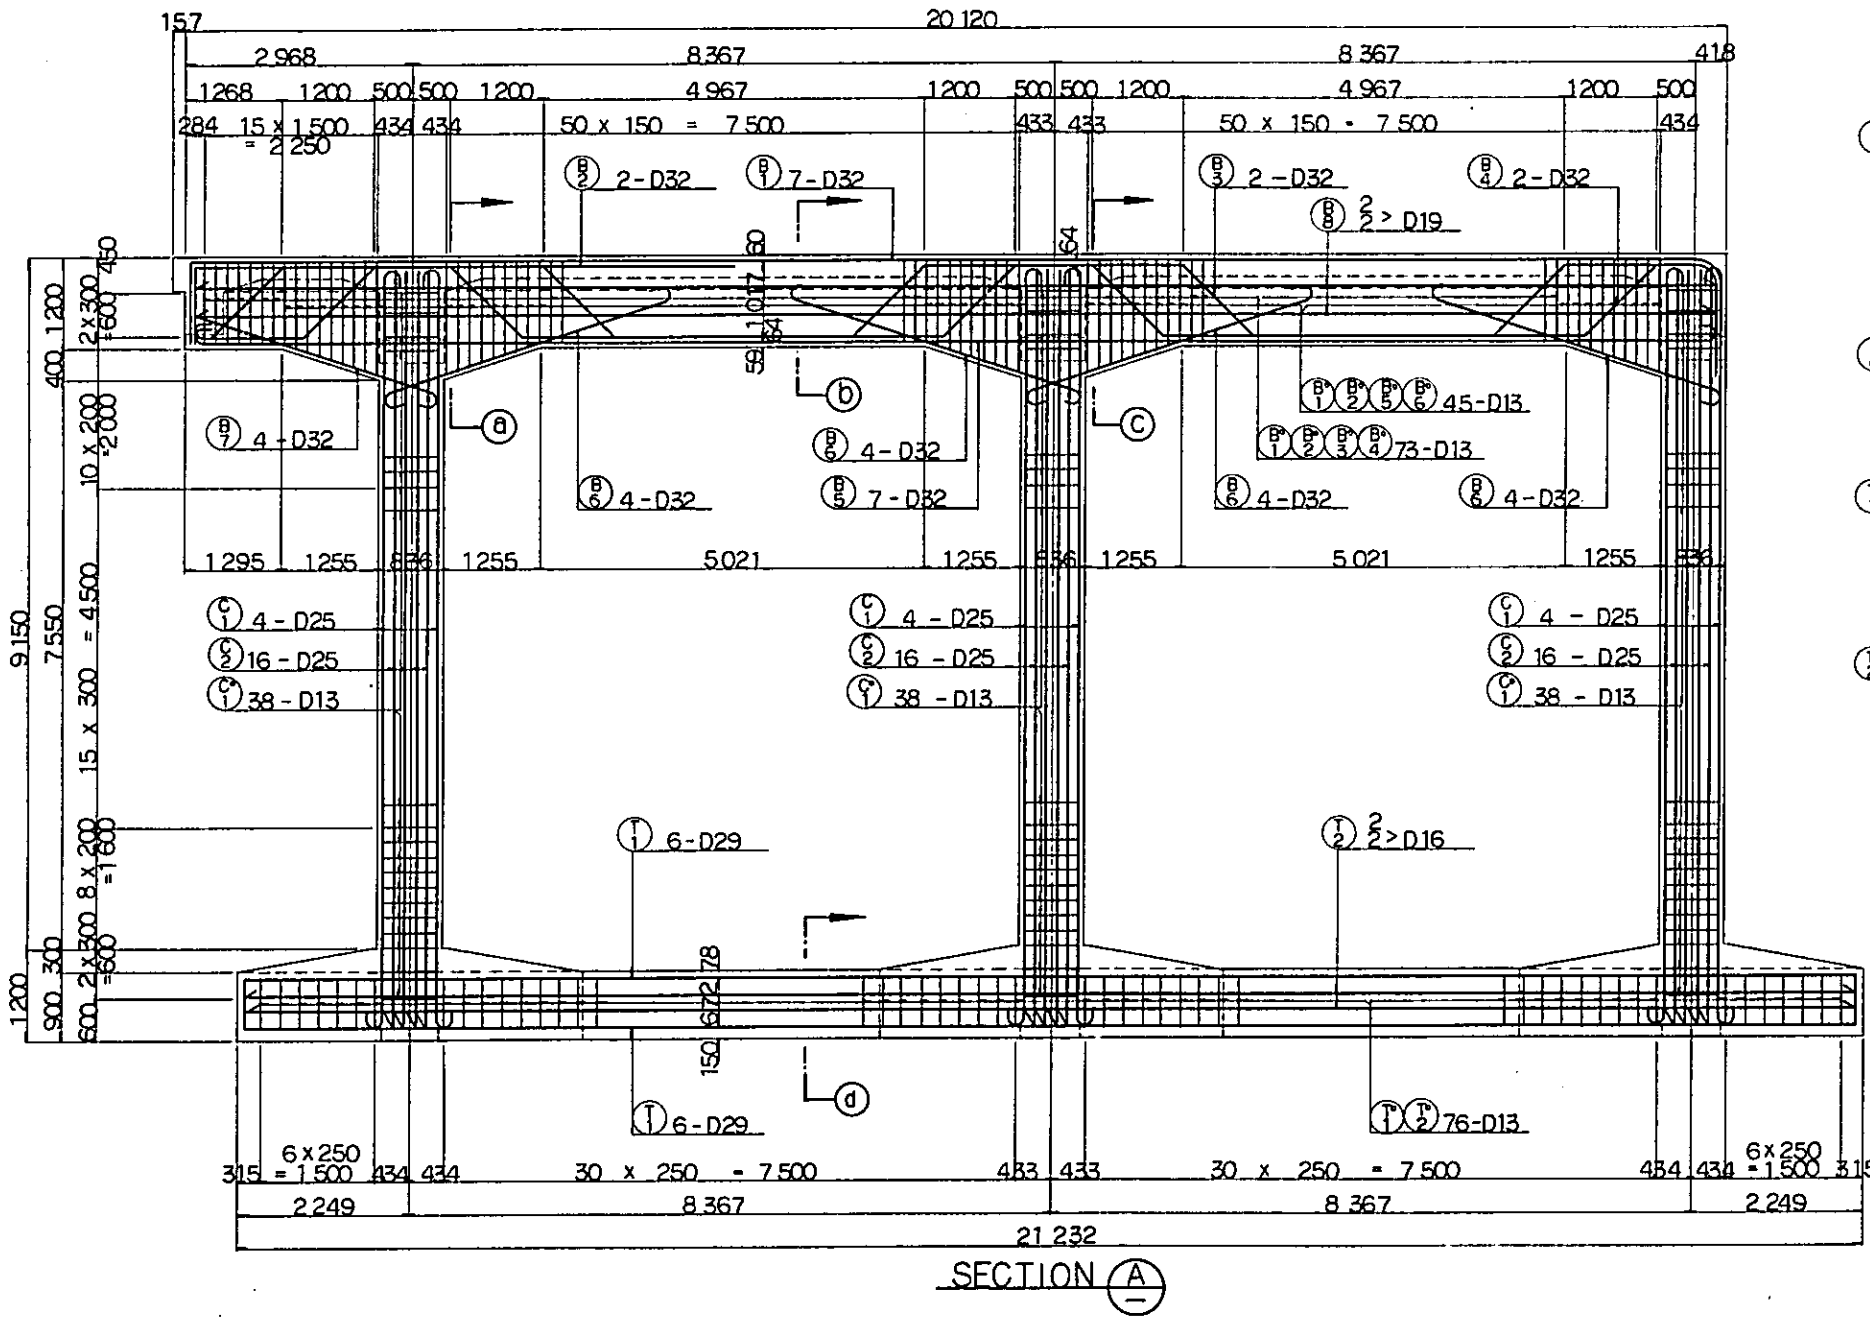

|   |                    |          |       |         |          |
|---|--------------------|----------|-------|---------|----------|
| REPUBLIC OF INDONESIA<br>MINISTRY OF COMMUNICATIONS<br>DIRECTORATE GENERAL OF LAND TRANSPORT AND INLAND WATERWAYS |                    |          |       |         |          |
| NEW RAILWAY LINE FOR CENKARENG AIRPORT<br>CONSTRUCTION PROJECT  |                    |          |       |         |          |
| JAPAN INTERNATIONAL COOPERATION AGENCY<br>(JICA)  |                    |          |       |         |          |
| B   | 1 AUG 84           | TR       | AD    | KM      | AK       |
| A   | 15 FEB 84          | TR       | AD    | KM      | AK       |
| REVISIONS   | DATE               | DESIGNED | DRAWN | CHECKED | REVIEWED |
| VIADUCT V129<br>BAR ARRANGEMENT<br>(SHEET 4 OF 14)  |                    |          |       |         |          |
| PACKAGE: I CIVIL AND ARCHITECTURAL WORK   |                    |          |       |         |          |
| SCALE: 1:50   | DRAWING NO. CS-261 |          |       |         |          |




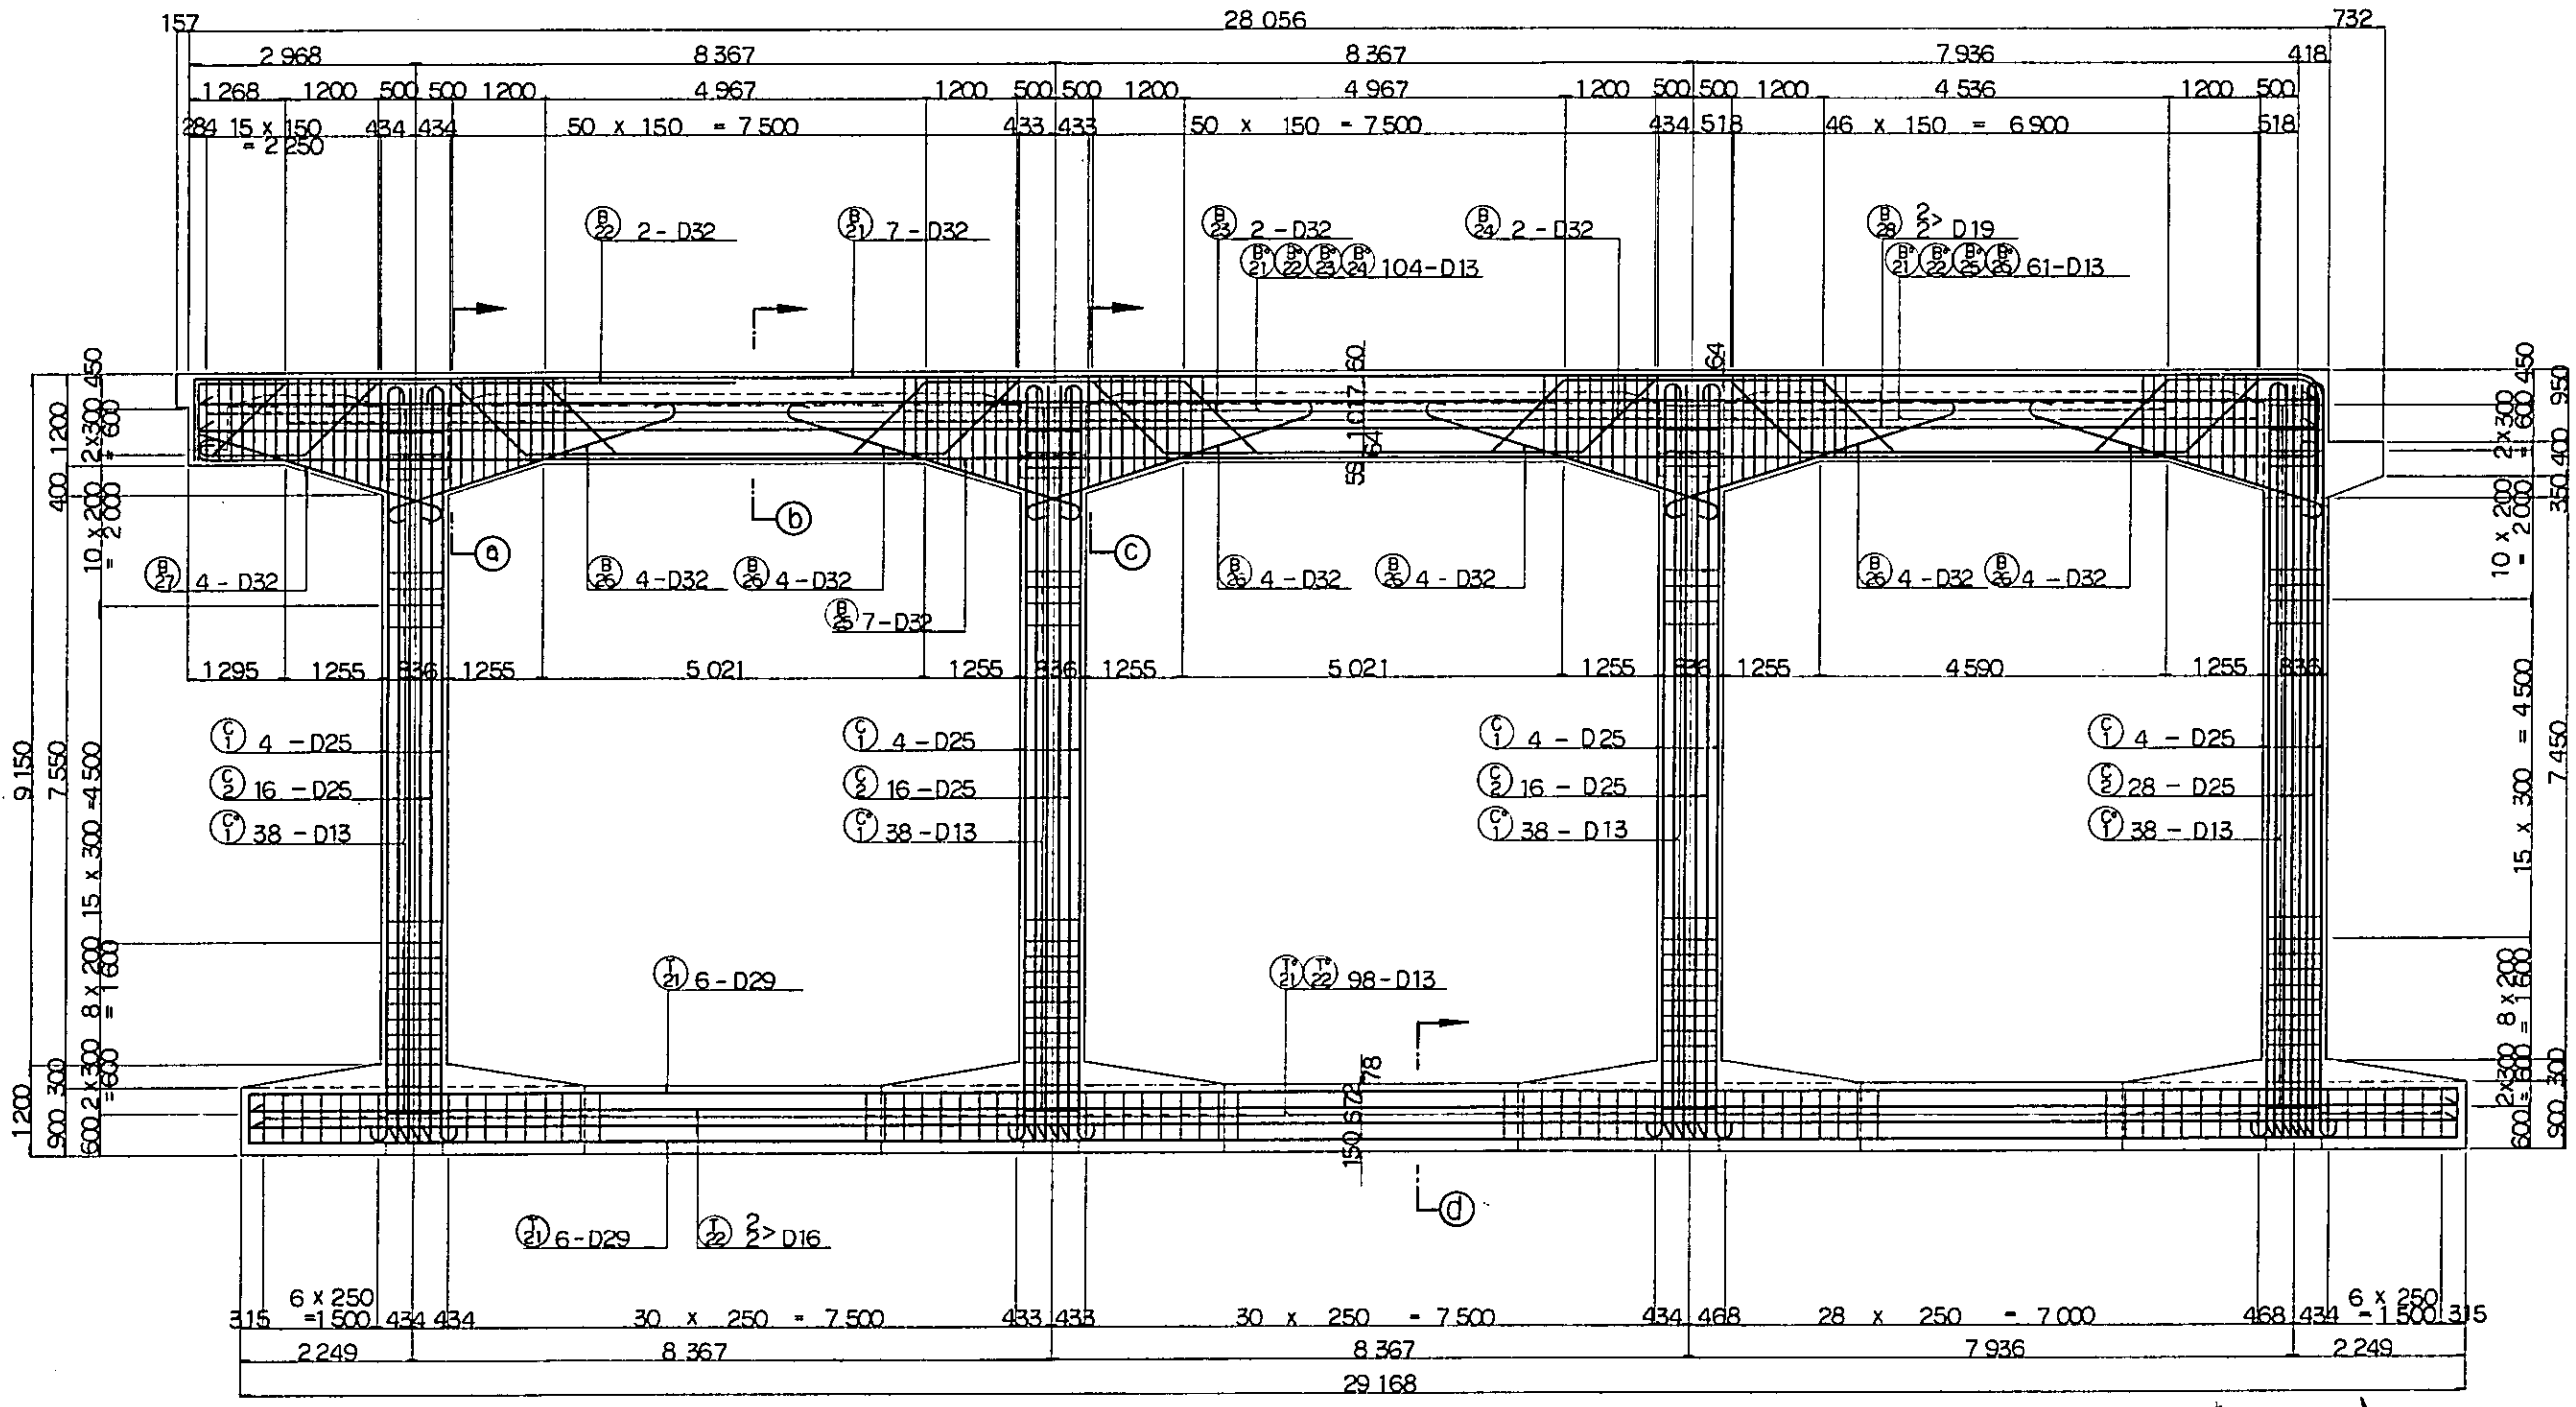


SECTION B


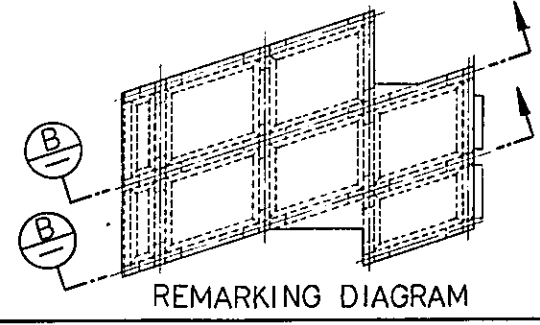


- NOTES:
1. ALL DIMENSIONS ARE SHOWN IN MILLIMETERS UNLESS OTHERWISE INDICATED
  2. REFERENCE DRAWING FOR GENERAL VIEW: CS - 256  
CS - 257.

|   |             |          |       |         |          |
|---|-------------|----------|-------|---------|----------|
| REPUBLIC OF INDONESIA<br>MINISTRY OF COMMUNICATIONS<br>DIRECTORATE GENERAL OF LAND TRANSPORT AND INLAND WATERWAYS |             |          |       |         |          |
| NEW RAILWAY LINE FOR CENGKARENG AIRPORT<br>CONSTRUCTION PROJECT   |             |          |       |         |          |
| JAPAN INTERNATIONAL COOPERATION AGENCY<br>(JICA)  |             |          |       |         |          |
| B   | 1AUG'84     | TK       | AD    | K.K.    | K.M.     |
| A   | 15FEB'84    | TK       | AD    | K.K.    | K.M.     |
| REVISIONS   | DATE        | DESIGNED | DRAWN | CHECKED | REVIEWED |
| VIADUCT VI29<br>BAR ARRANGEMENT<br>(SHEET 5 OF 14)  |             |          |       |         |          |
| PACKAGE: I CIVIL AND ARCHITECTURAL WORK   |             |          |       |         |          |
| SCALE   | DRAWING NO. |          |       |         |          |
| 1:50  | CS-262      |          |       |         |          |




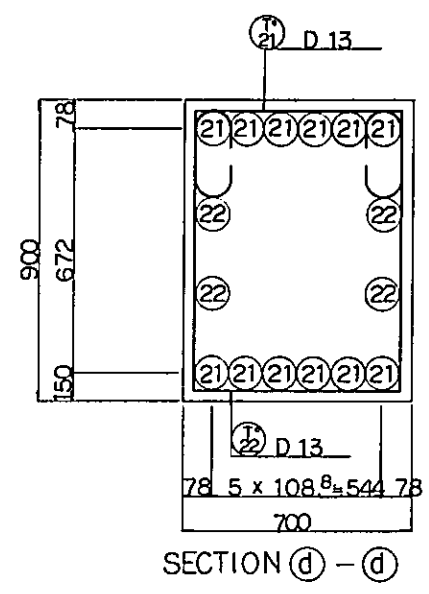
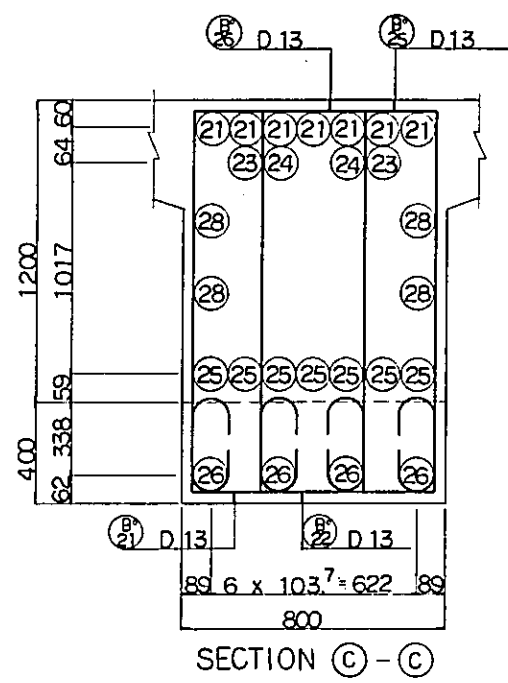
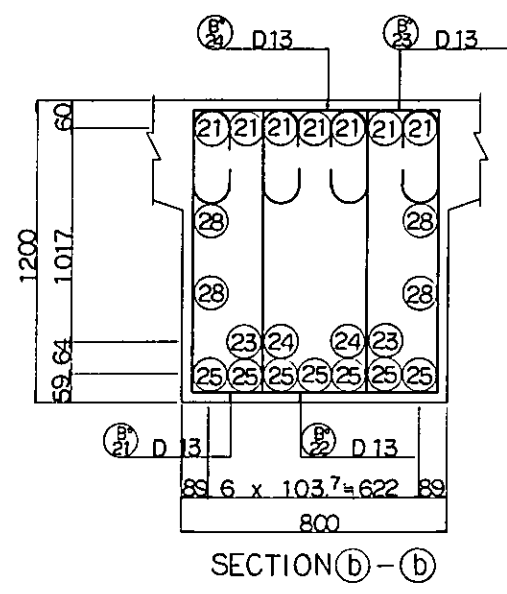
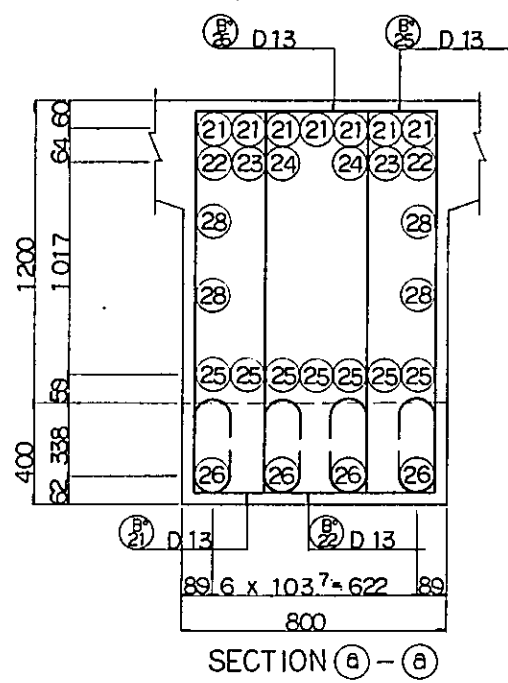


NOTES:  
 1. ALL DIMENSIONS ARE SHOWN IN MILLIMETERS UNLESS OTHERWISE INDICATED  
 2. REFERENCE DRAWING FOR BAR ARRANGEMENT : CS - 257.

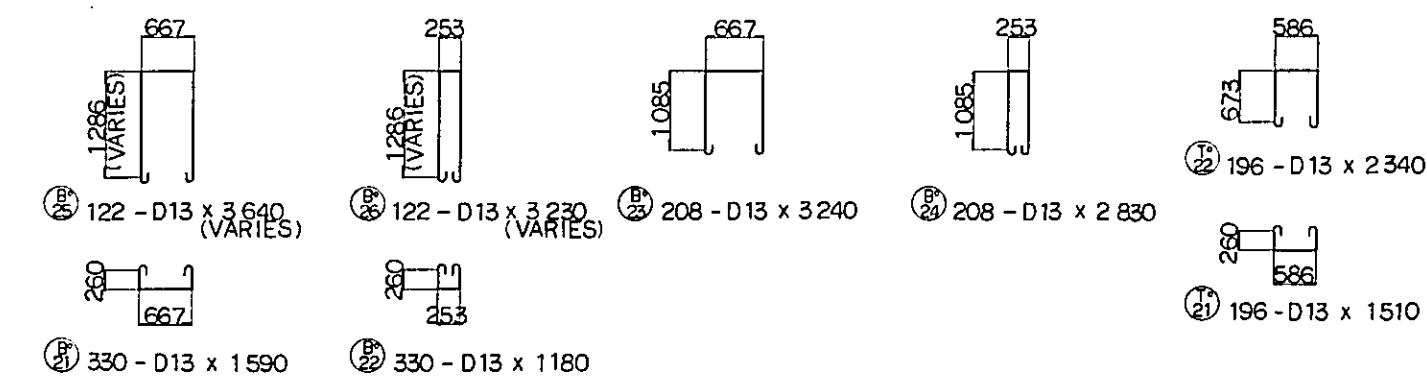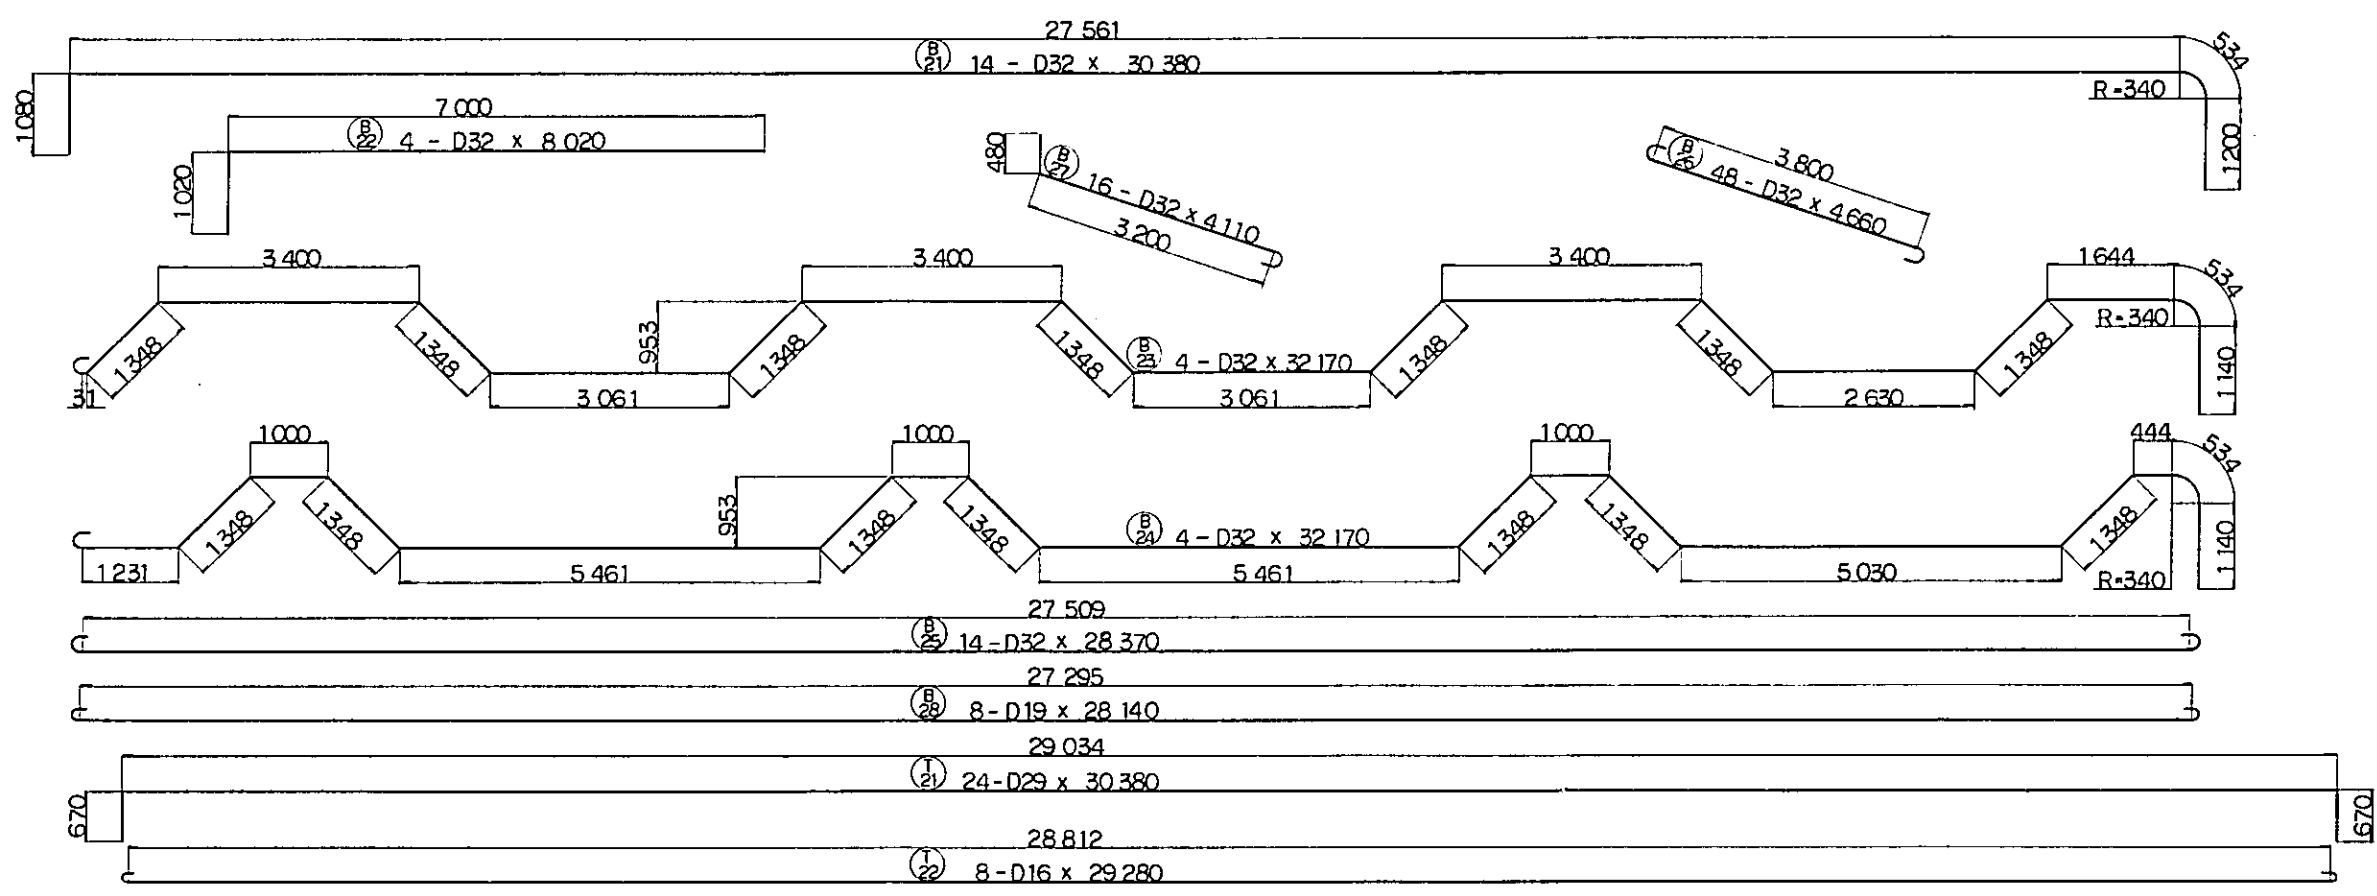



|  |            |                    |       |         |          |
|--|------------|--------------------|-------|---------|----------|
| REPUBLIC OF INDONESIA<br>MINISTRY OF COMMUNICATIONS<br>DIRECTORATE GENERAL OF LAND TRANSPORT<br>AND INLAND WATERWAYS |            |                    |       |         |          |
| NEW RAILWAY LINE FOR CENGKARENG AIRPORT<br>CONSTRUCTION PROJECT  |            |                    |       |         |          |
| JAPAN INTERNATIONAL COOPERATION AGENCY<br>(JICA)   |            |                    |       |         |          |
| B  | 1 AUG '84  | TK-10              | K.A.  | K.M.    | M.K.     |
| A  | 15 FEB '84 | TK-10              | K.A.  | K.M.    | M.K.     |
| REVISIONS  | DATE       | ISSUED             | DRAWN | CHECKED | REVIEWED |
| VIADUCT VI29<br>BAR ARRANGEMENT<br>(SHEET 6 OF 14)   |            |                    |       |         |          |
| PACKAGE: I CIVIL AND ARCHITECTURAL WORK  |            |                    |       |         |          |
| SCALE: 1:50  |            | DRAWING NO: CS-263 |       |         |          |

3.800  
 8 - D32 x 4.660

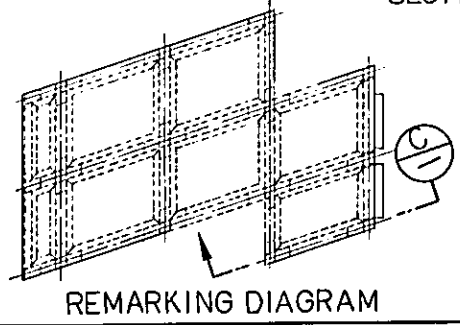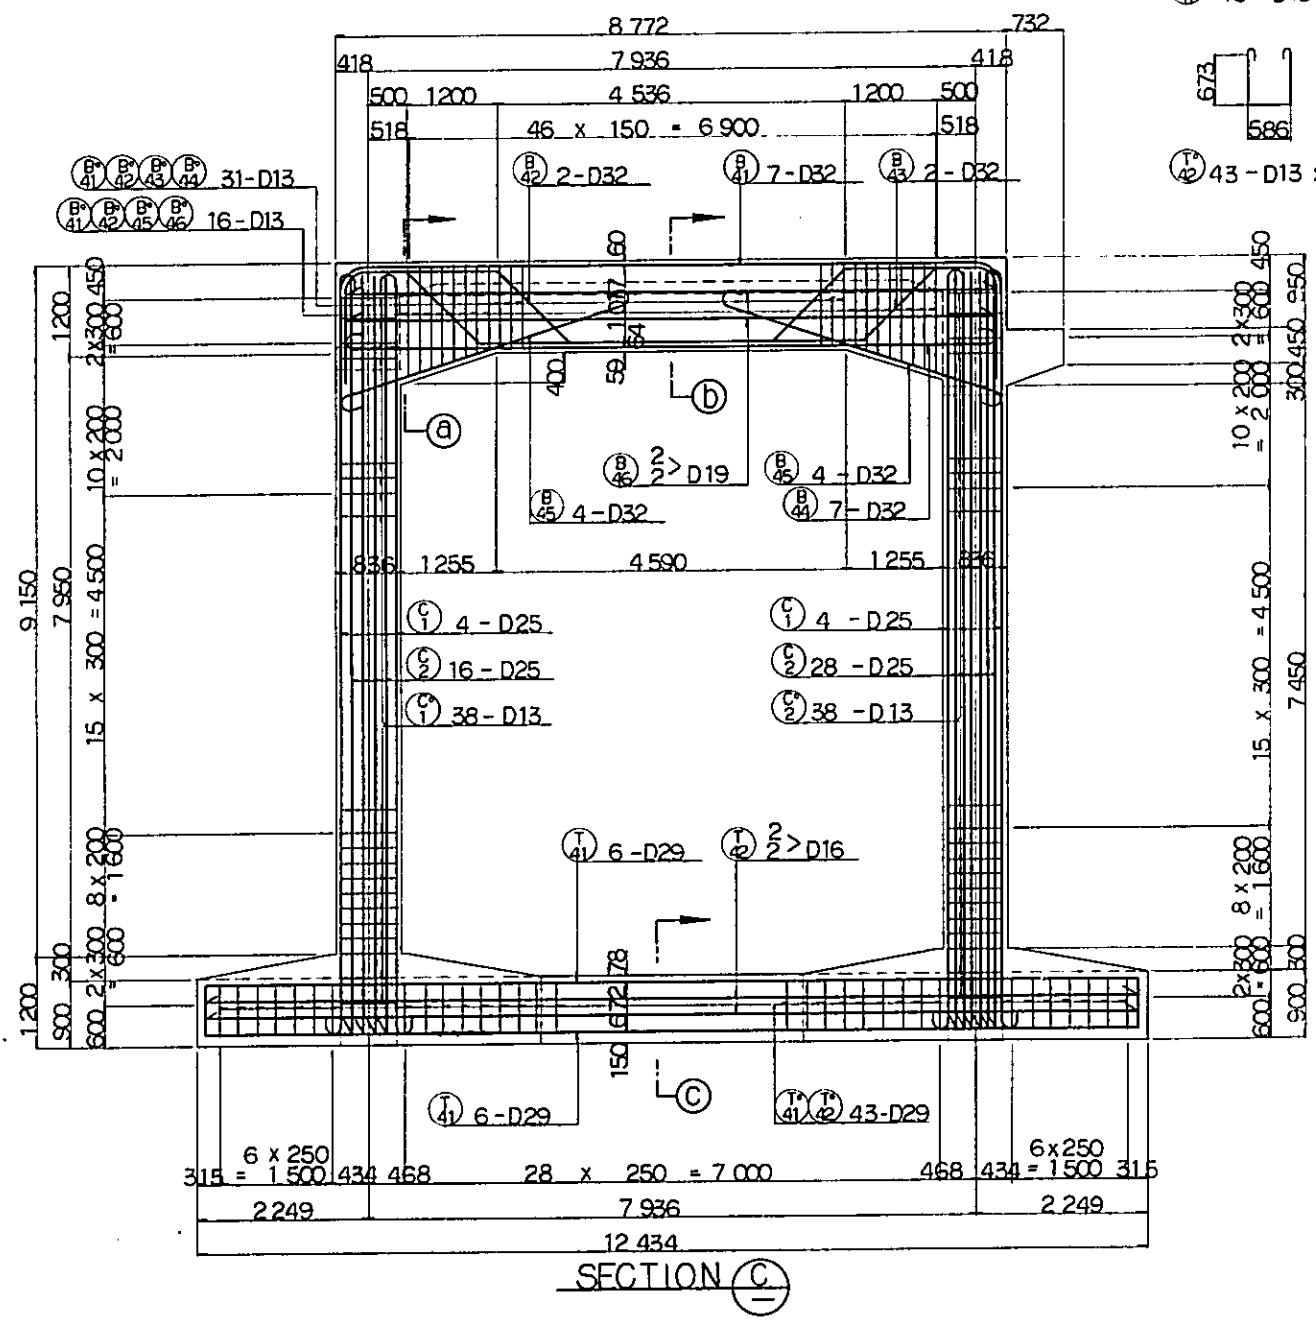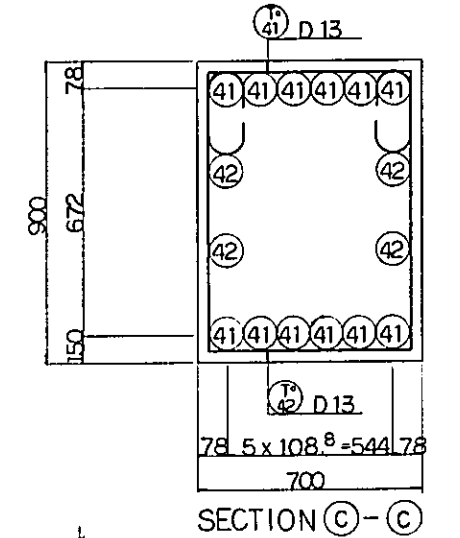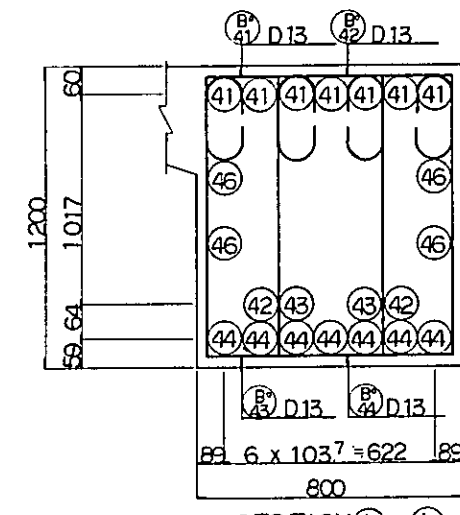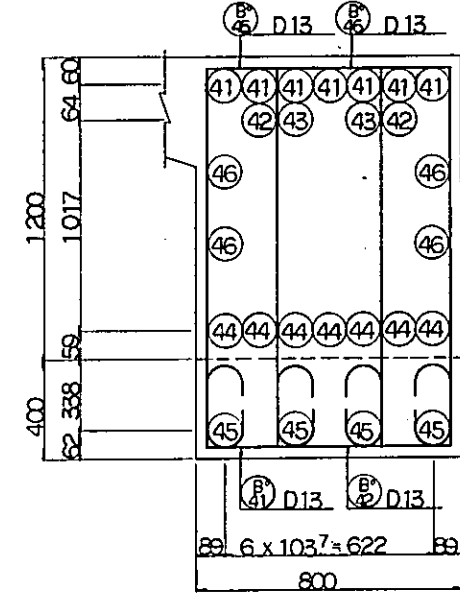
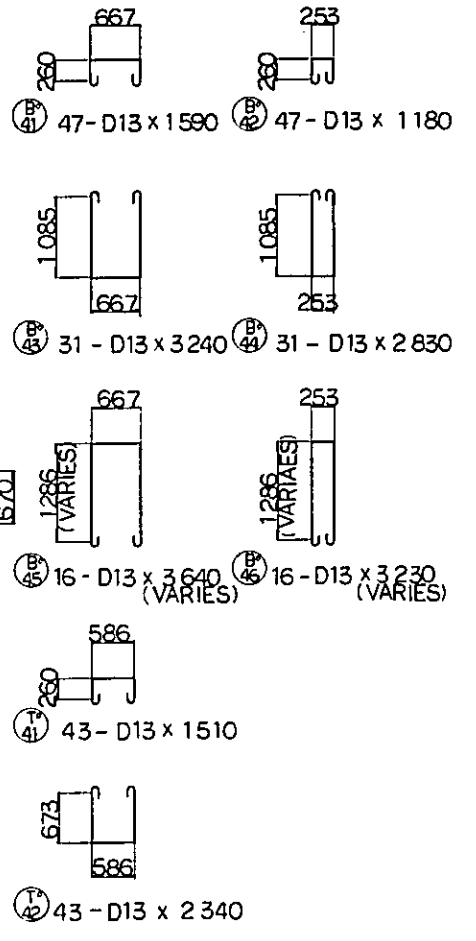
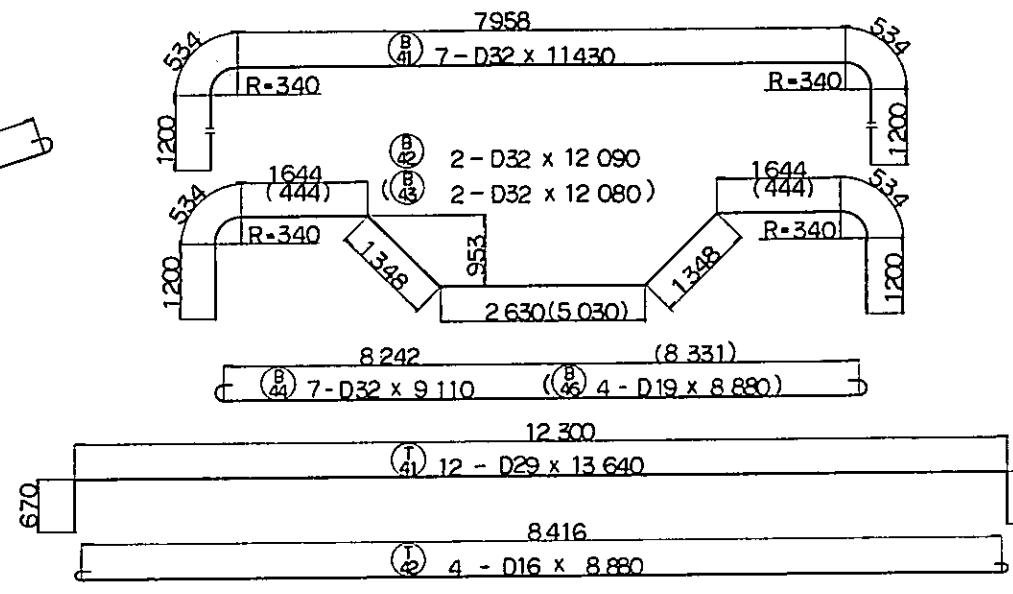


NOTES:  
 1. ALL DIMENSIONS ARE SHOWN IN MILLIMETERS UNLESS OTHERWISE INDICATED  
 2. REFERENCE DRAWING FOR GENERAL VIEW : CS - 256, CS - 257.


|  |                    |          |       |         |          |
|--|--------------------|----------|-------|---------|----------|
| REPUBLIC OF INDONESIA  |                    |          |       |         |          |
| MINISTRY OF COMMUNICATIONS                                   |                    |          |       |         |          |
| DIRECTORATE GENERAL OF LAND TRANSPORT AND INLAND WATERWAYS   |                    |          |       |         |          |
| NEW RAILWAY LINE FOR CENGKARENG AIRPORT CONSTRUCTION PROJECT |                    |          |       |         |          |
| JAPAN INTERNATIONAL COOPERATION AGENCY (JICA)                |                    |          |       |         |          |
| B  | 1 AUG '84          | T.K.     | A.O.  | K.A.    | K.M.     |
| A  | 15 FEB '84         | T.K.     | A.O.  | K.A.    | K.M.     |
| REVISIONS  | DATE               | DESIGNED | DRAWN | CHECKED | REVIEWED |
| VIADUCT V129<br>BAR ARRANGEMENT<br>(SHEET 7 OF 14)           |                    |          |       |         |          |
| PACKAGE: I CIVIL AND ARCHITECTURAL WORK                      |                    |          |       |         |          |
| SCALE  | DRAWING NO. CS-264 |          |       |         |          |
| 1:50   |                    |          |       |         |          |

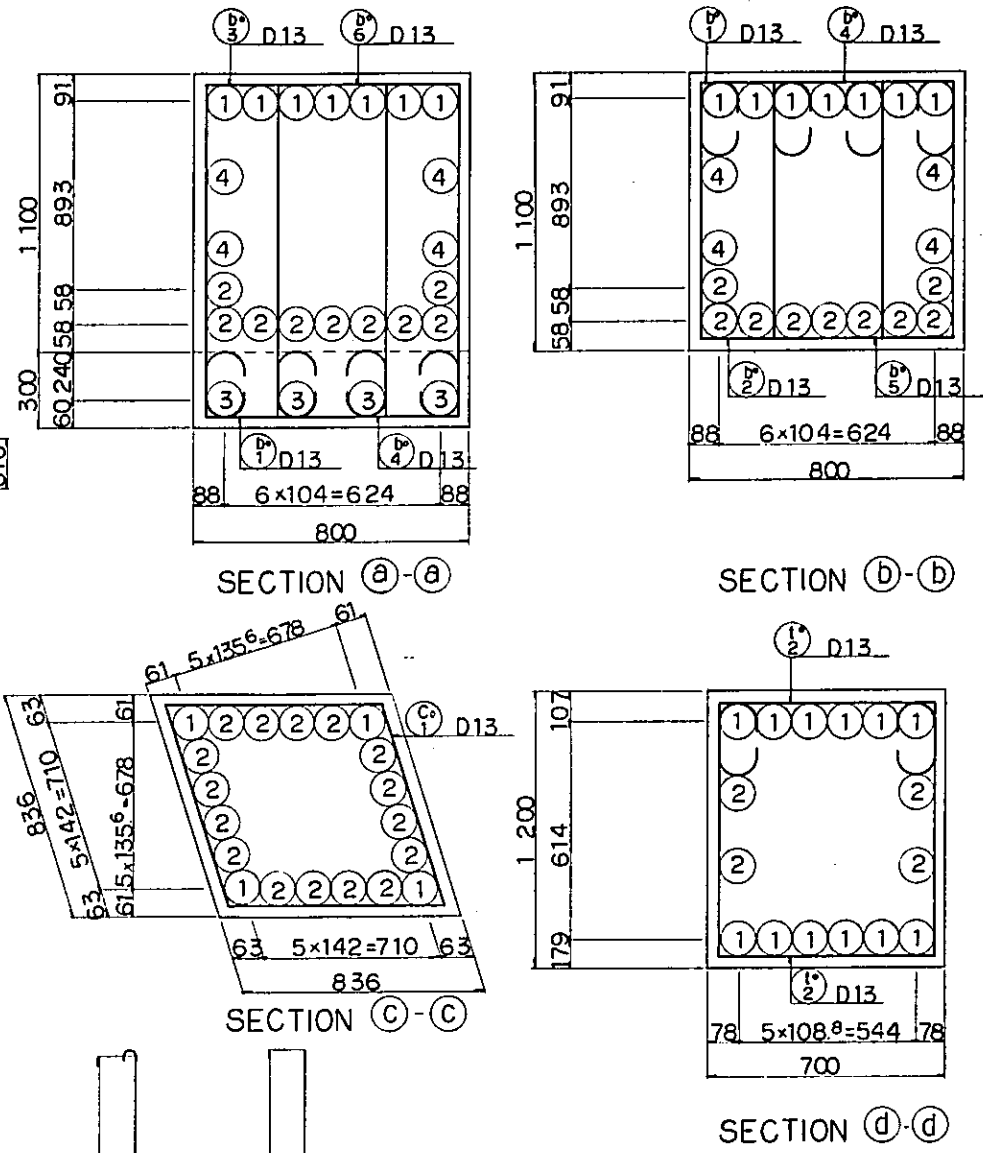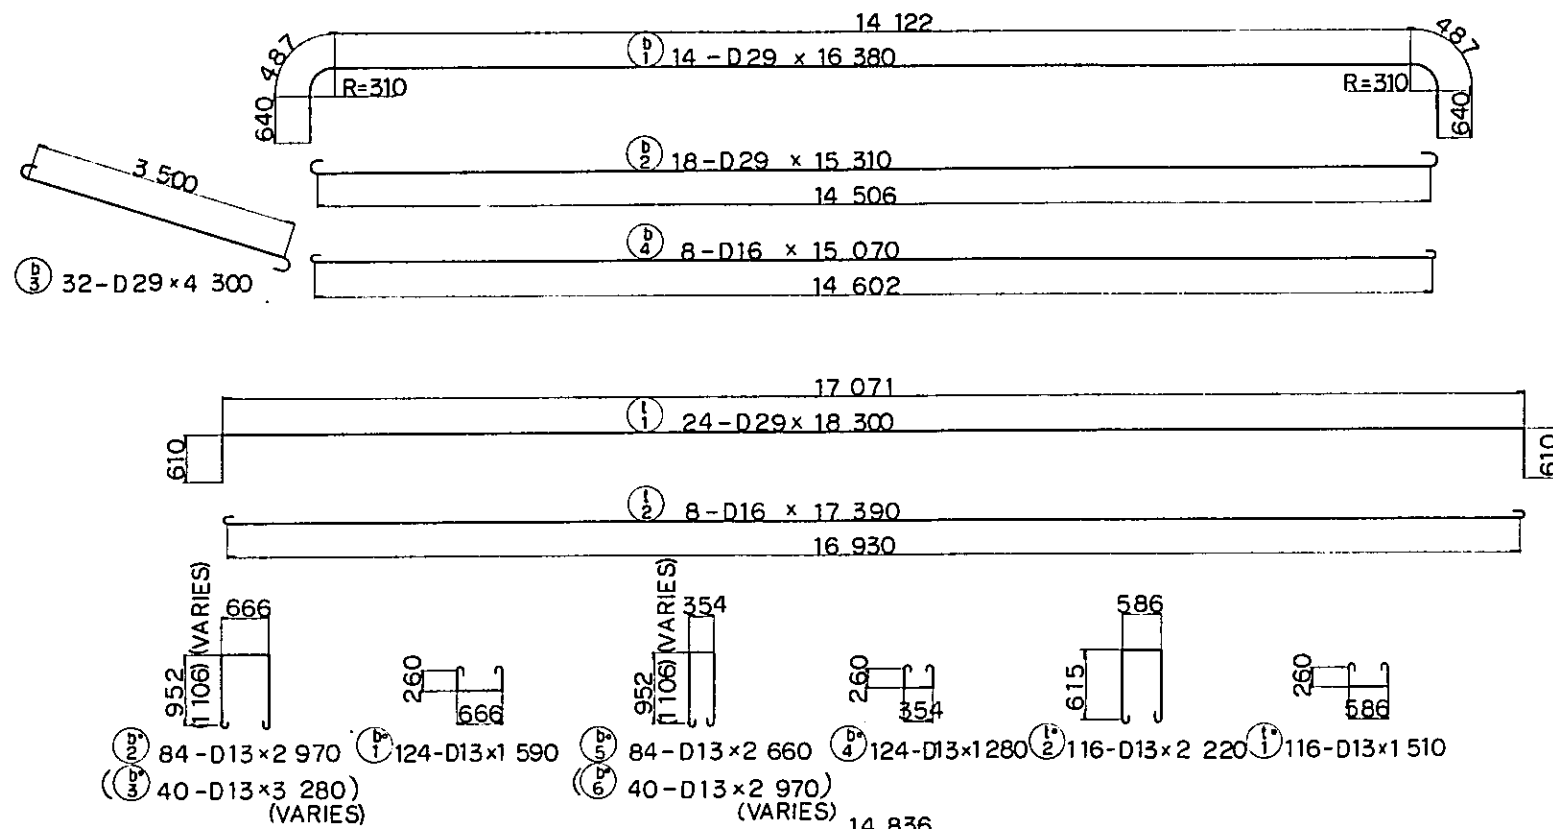


NOTES:  
 1. ALL DIMENSIONS ARE SHOWN IN MILLIMETERS UNLESS OTHERWISE INDICATED  
 2. REFERENCE DRAWING FOR GENERAL VIEW : CS - 256, CS - 257.

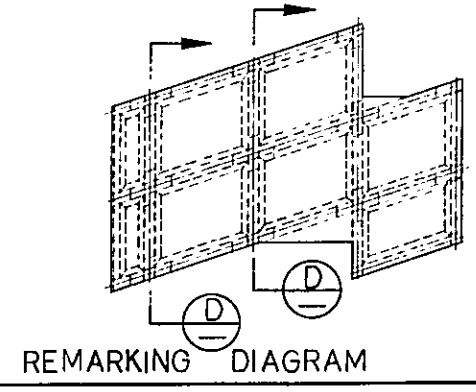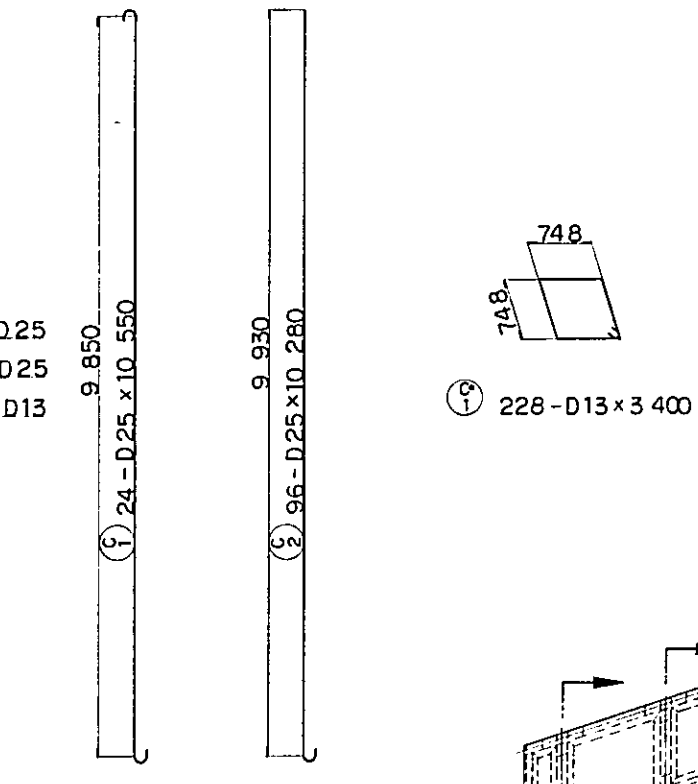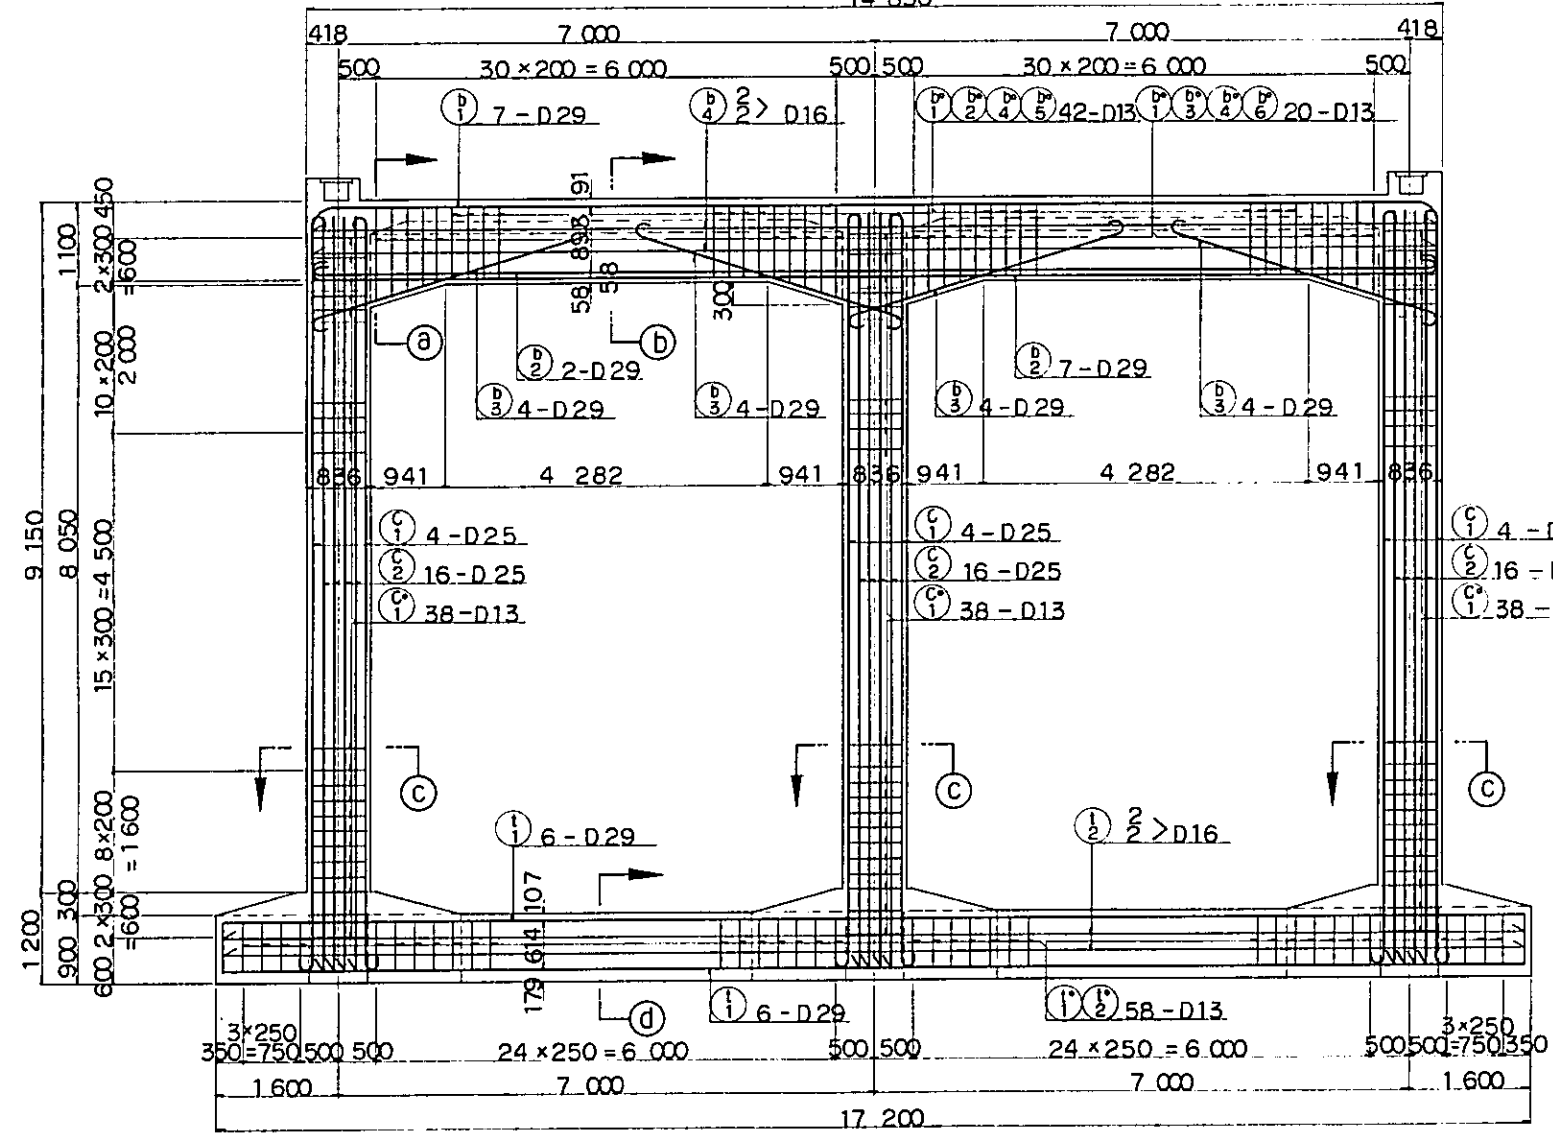

|  |             |          |       |         |          |
|--|-------------|----------|-------|---------|----------|
| REPUBLIC OF INDONESIA<br>MINISTRY OF COMMUNICATIONS<br>DIRECTORATE GENERAL OF LAND TRANSPORT<br>AND INLAND WATERWAYS |             |          |       |         |          |
| NEW RAILWAY LINE FOR CENGKARENG AIRPORT<br>CONSTRUCTION PROJECT  |             |          |       |         |          |
| JAPAN INTERNATIONAL COOPERATION AGENCY<br>(JICA)   |             |          |       |         |          |
| B  | 1AUG'84     | ZK AD    | KA KM | ML      |          |
| A  | 15FEB'84    | ZK AD    | KA KM | ML      |          |
| REVISIONS  | DATE        | DESIGNED | DRAWN | CHECKED | REVIEWED |
| VIADUCT VI29<br>BAR ARRANGEMENT<br>(SHEET 8 OF 14)   |             |          |       |         |          |
| PACKAGE : I CIVIL AND ARCHITECTURAL WORK   |             |          |       |         |          |
| SCALE  | DRAWING NO. |          |       |         |          |
| 1 : 50   | CS - 265    |          |       |         |          |

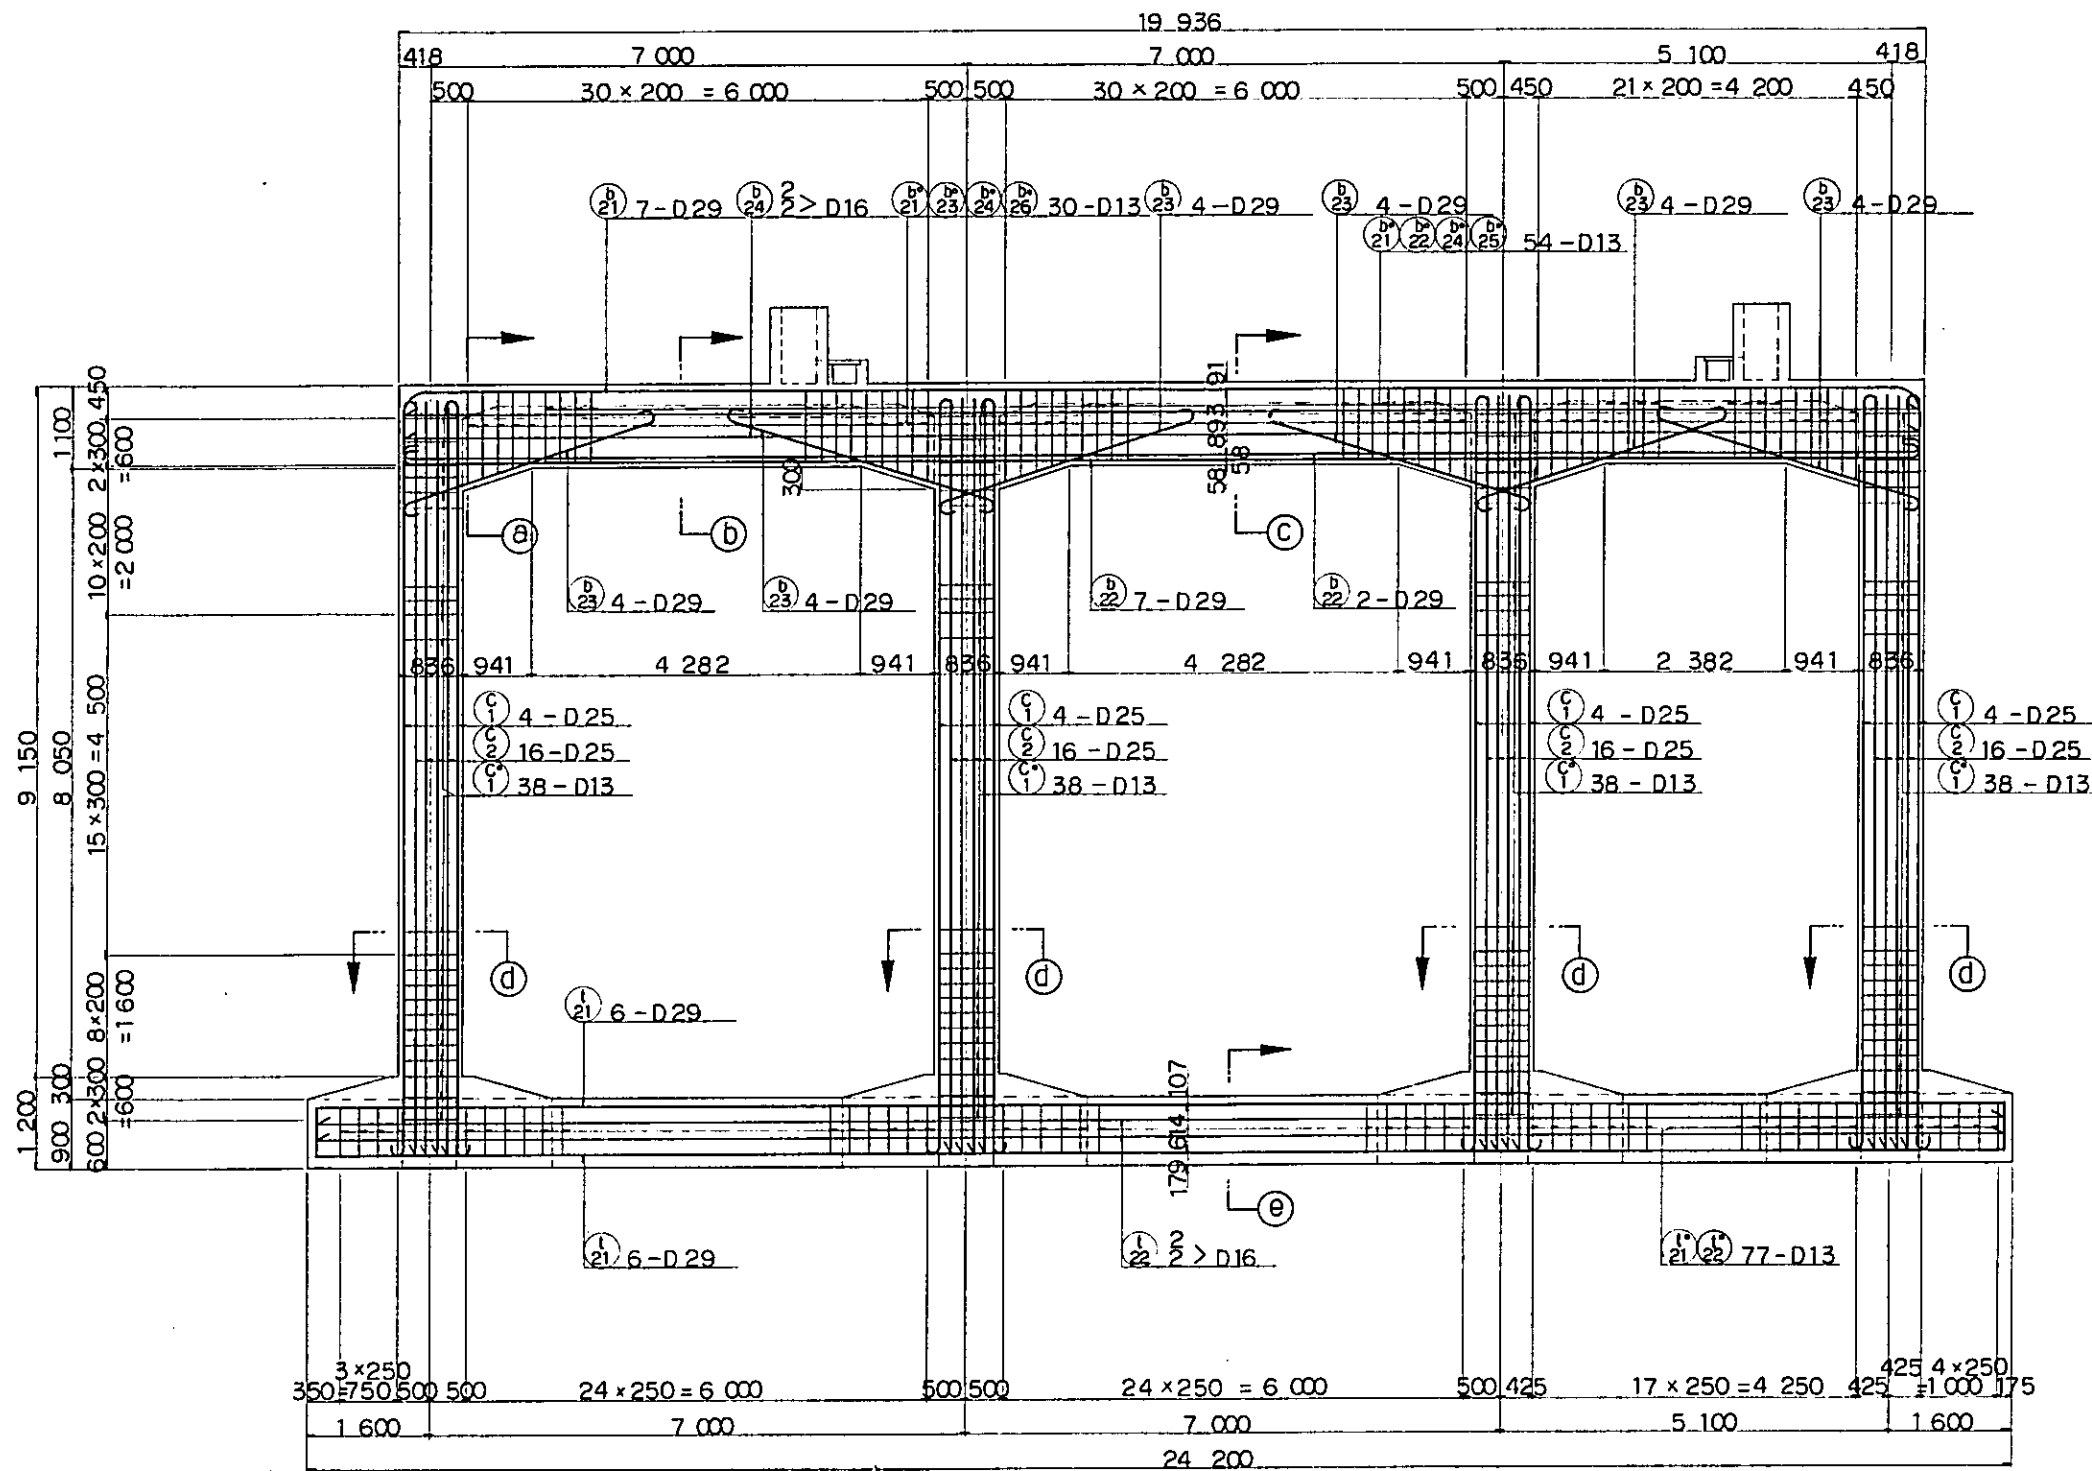


SECTION E

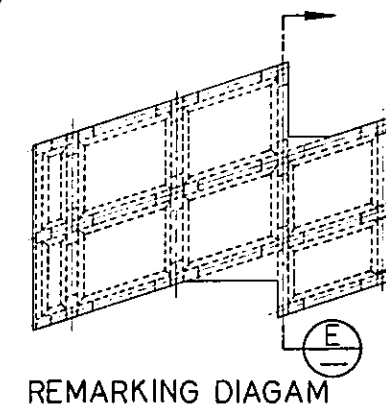


- NOTES:
1. ALL DIMENSIONS ARE SHOWN IN MILLIMETERS UNLESS OTHERWISE INDICATED
  2. REFERENCE DRAWING FOR GENERAL VIEW : CS - 256  
CS - 257.
  3. REFERENCE DRAWING FOR BAR ARRANGEMENT : CS - 184.

|   |            |             |       |         |          |
|---|------------|-------------|-------|---------|----------|
| REPUBLIC OF INDONESIA<br>MINISTRY OF COMMUNICATIONS<br>DIRECTORATE GENERAL OF LAND TRANSPORT AND INLAND WATERWAYS |            |             |       |         |          |
| NEW RAILWAY LINE FOR CENGKARENG AIRPORT<br>CONSTRUCTION PROJECT   |            |             |       |         |          |
| JAPAN INTERNATIONAL COOPERATION AGENCY<br>(JICA)  |            |             |       |         |          |
| REVISIONS   | DATE       | DESIGNED    | DRAWN | CHECKED | REVIEWED |
| B   | 1 AUG. 84  | Z.K.        | A.O.  | K.A.    | K.M.     |
| A   | 15 FEB. 84 | Z.K.        | A.O.  | K.A.    | K.M.     |
| VIADUCT VI29<br>BAR ARRANGEMENT<br>(SHEET 9 OF 14)  |            |             |       |         |          |
| PACKAGE: I CIVIL AND ARCHITECTURAL WORK   |            |             |       |         |          |
| SCALE   | 1:50       | DRAWING NO. |       | CS-266  |          |




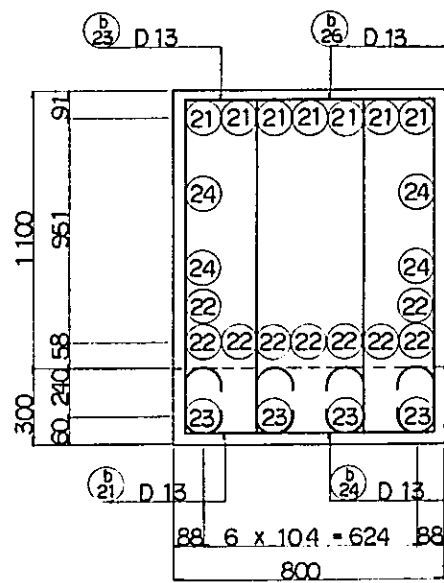


SECTION (a) - (a)

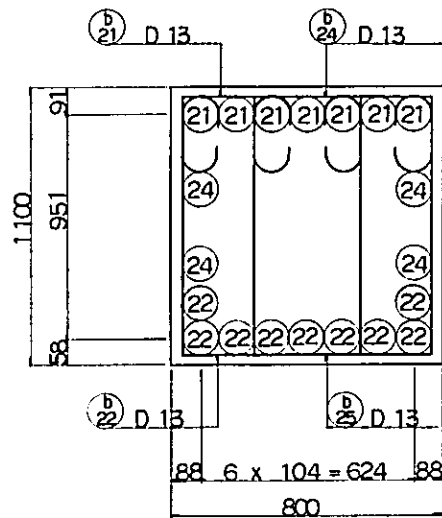


SECTION (b) - (b)

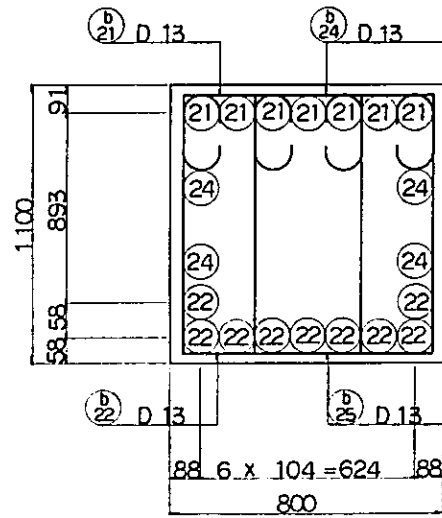










SECTION (c) - (c)

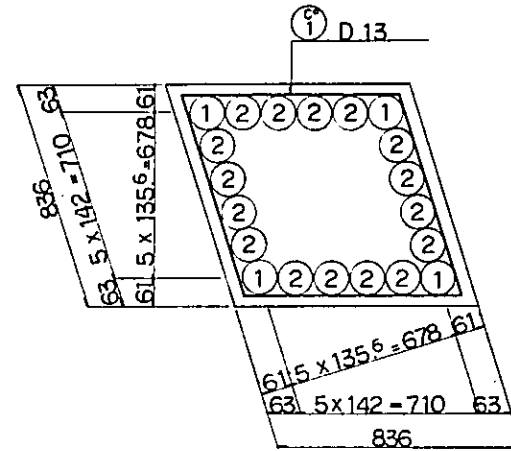

SECTION (d) - (d)



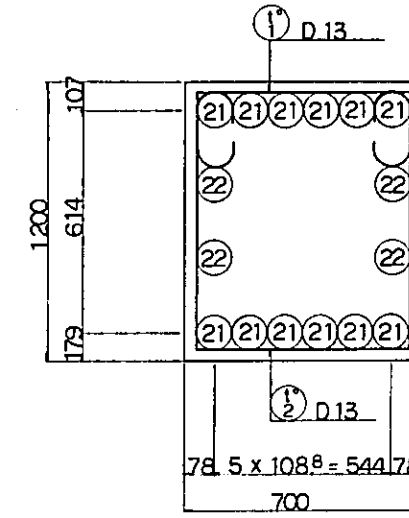


SECTION (e) - (e)

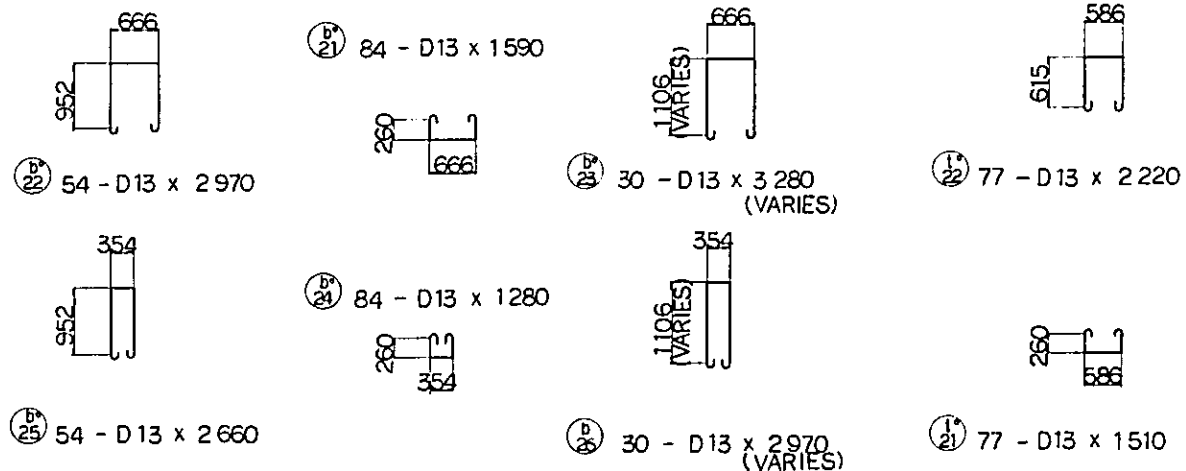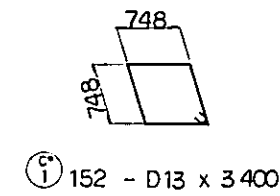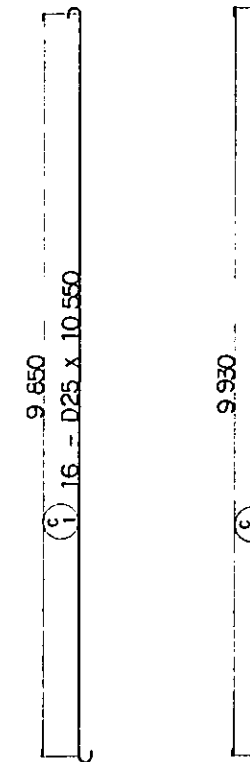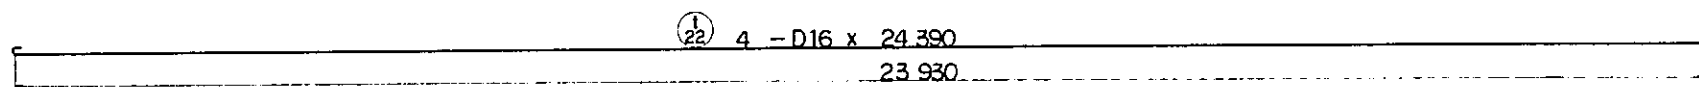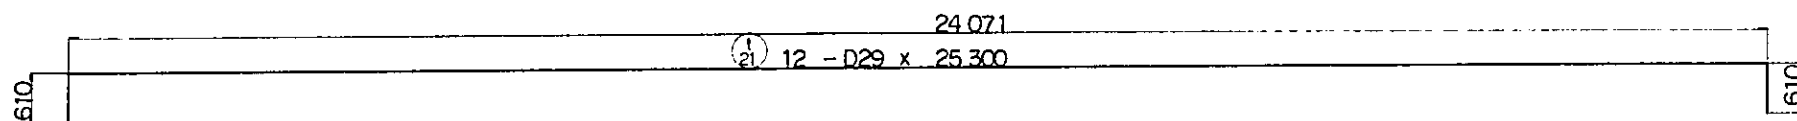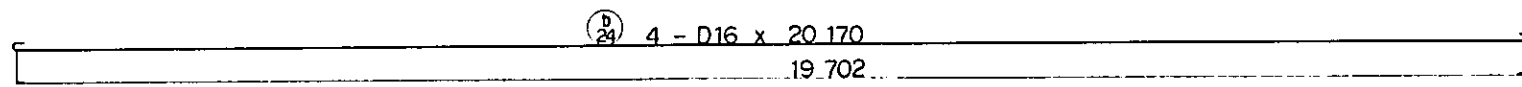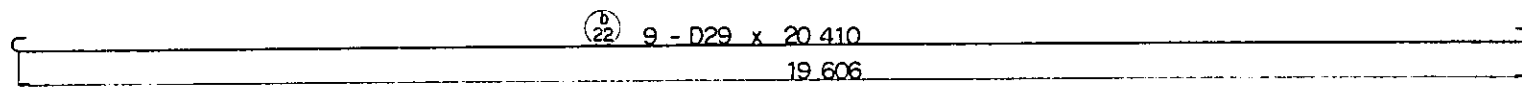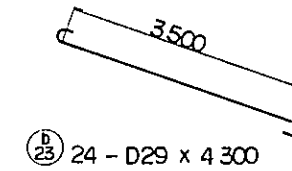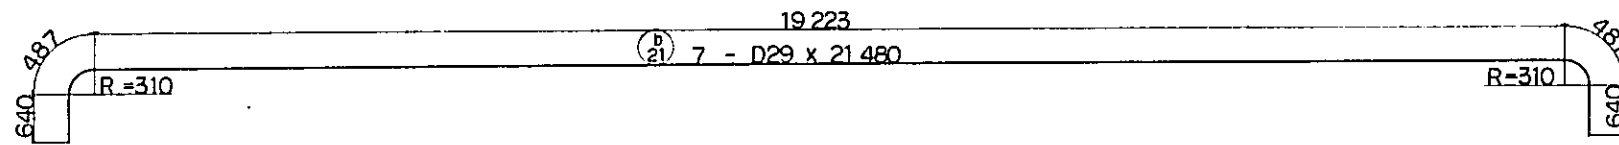


- NOTES:
1. ALL DIMENSIONS ARE SHOWN IN MILLIMETERS UNLESS OTHERWISE INDICATED
  2. REFERENCE DRAWING FOR BAR ARRANGEMENT : CS - 266.


|  |             |          |       |         |          |
|--|-------------|----------|-------|---------|----------|
| REPUBLIC OF INDONESIA<br>MINISTRY OF COMMUNICATIONS<br>DIRECTORATE GENERAL OF LAND TRANSPORT<br>AND INLAND WATERWAYS |             |          |       |         |          |
| NEW RAILWAY LINE FOR CENGKARENG AIRPORT<br>CONSTRUCTION PROJECT  |             |          |       |         |          |
| JAPAN INTERNATIONAL COOPERATION AGENCY<br>(JICA)   |             |          |       |         |          |
| E  | 1 AUG '84   | J.K.     | A.O.  | K.A.    | K.M.     |
| 1  | NOV 84      | J.K.     | A.O.  | K.A.    | K.M.     |
| REVISIONS  | DATE        | DESIGNED | DRAWN | CHECKED | REVIEWED |
| VIADUCT VI29<br>BAR ARRANGEMENT<br>(SHEET 10 OF 14)  |             |          |       |         |          |
| PACKAGE: I CIVIL AND ARCHITECTURAL WORK  |             |          |       |         |          |
| SCALE  | DRAWING NO. |          |       |         |          |
| 1:50   | CS-267      |          |       |         |          |

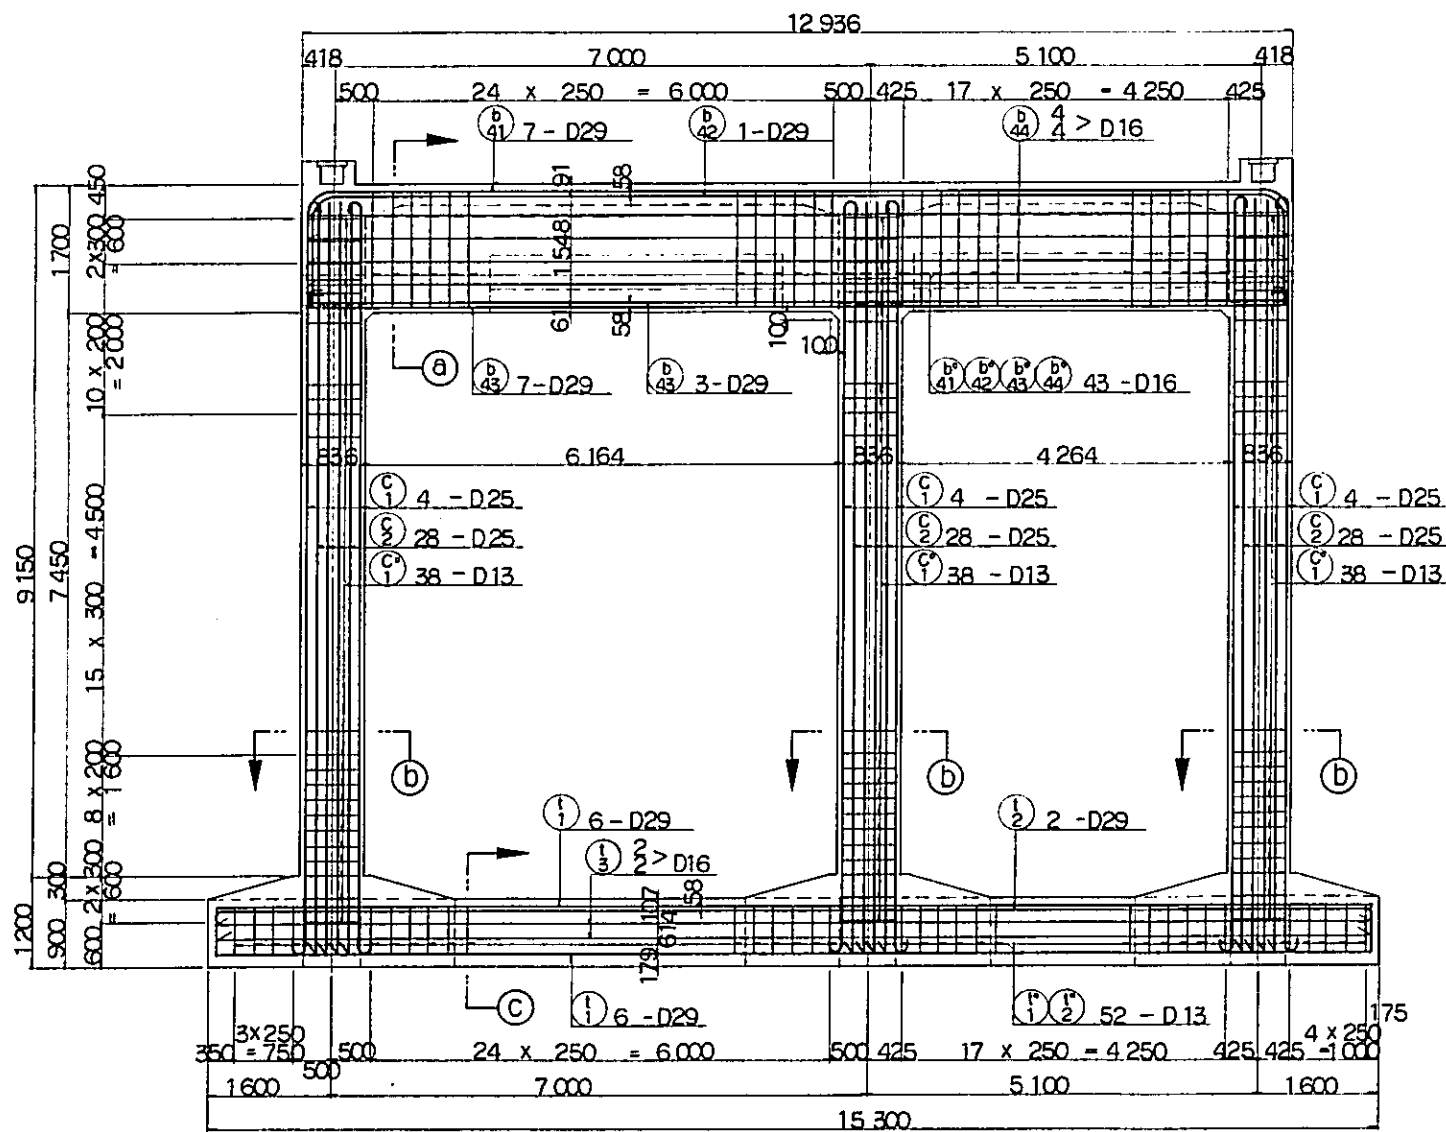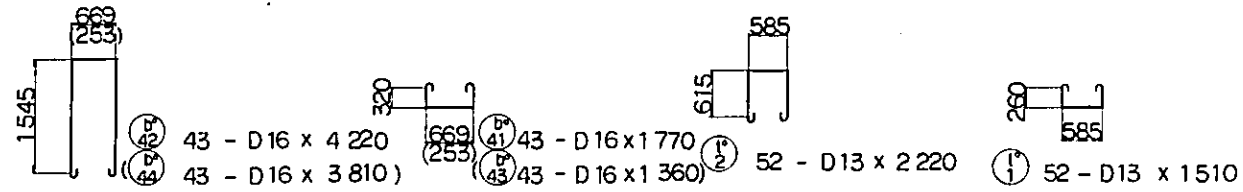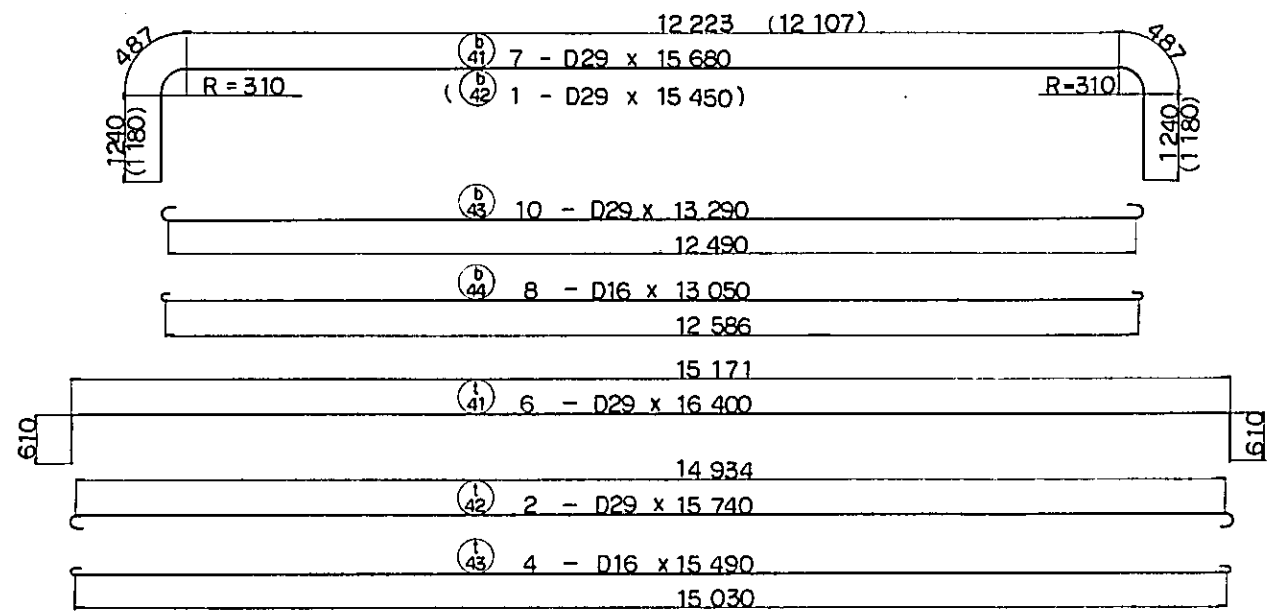

SECTION (F)-(F)


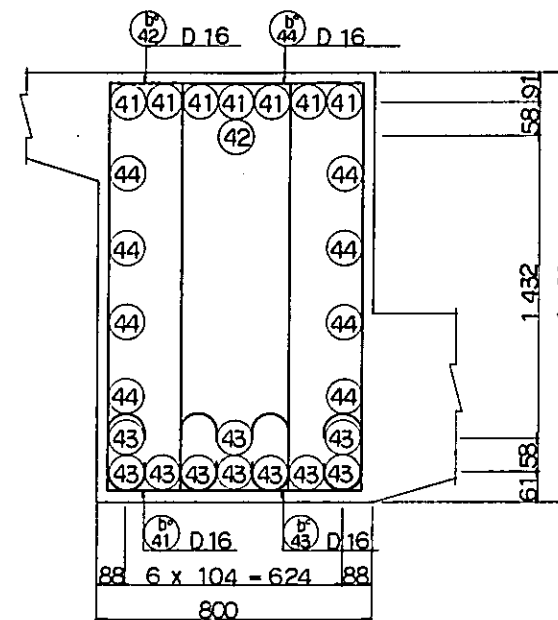


SECTION (A)-(A)

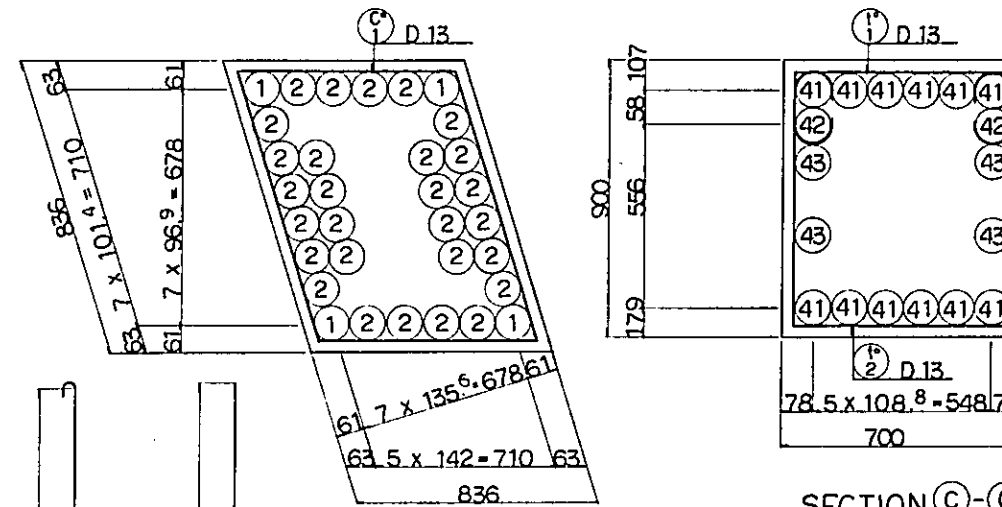


SECTION (B)-(B)

SECTION (C)-(C)

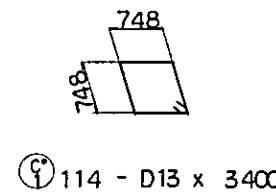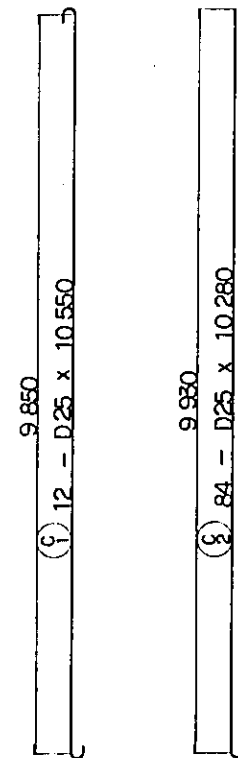

(1) 114 - D13 x 3,400


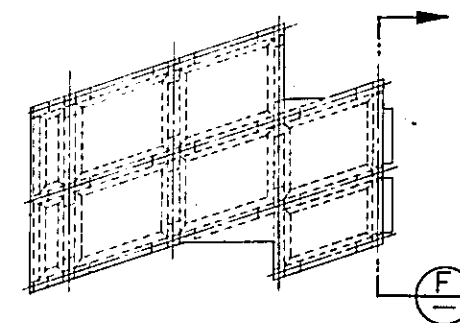


REMARKING DIAGRAM


NOTES:

1. ALL DIMENSIONS ARE SHOWN IN MILLIMETERS UNLESS OTHERWISE INDICATED
2. REFERENCE DRAWING FOR GENERAL VIEW : CS - 256  
CS - 257.
3. REFERENCE DRAWING FOR BAR ARRANGEMENT CS - 156.

|  |             |          |       |         |          |
|--|-------------|----------|-------|---------|----------|
| REPUBLIC OF INDONESIA  |             |          |       |         |          |
| MINISTRY OF COMMUNICATIONS                                   |             |          |       |         |          |
| DIRECTORATE GENERAL OF LAND TRANSPORT AND INLAND WATERWAYS   |             |          |       |         |          |
| NEW RAILWAY LINE FOR CENGKARENG AIRPORT CONSTRUCTION PROJECT |             |          |       |         |          |
| JAPAN INTERNATIONAL COOPERATION AGENCY (JICA)                |             |          |       |         |          |
| B  | 1 AUG. 84   | TK       | TO    | KA      | KM       |
| A  | 1 SEP. 84   | TK       | AD    | KA      | KM       |
| REVISIONS  | DATE        | DESIGNED | DRAWN | CHECKED | REVIEWED |
| VIADUCT VI29<br>BAR ARRANGEMENT<br>(SHEET II OF 14)          |             |          |       |         |          |
| PACKAGE: I CIVIL AND ARCHITECTURAL WORK                      |             |          |       |         |          |
| SCALE  | DRAWING NO. |          |       |         |          |
| 1:50   | CS-268      |          |       |         |          |

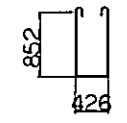
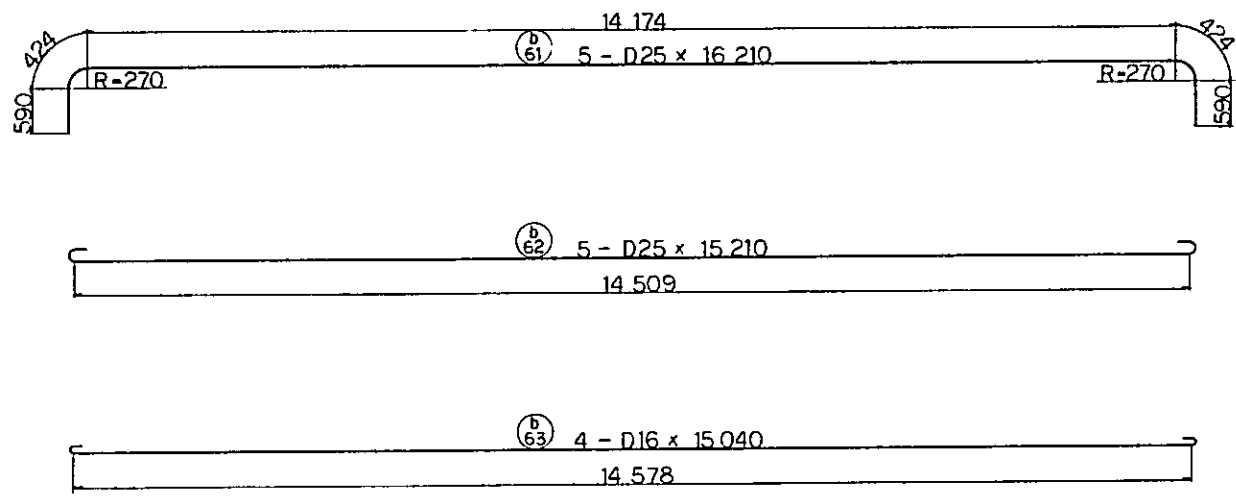


84 - D13 x 2 530

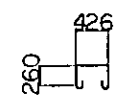


84 - D13 x 890

- NOTES:
1. ALL DIMENSIONS ARE SHOWN IN MILLIMETERS UNLESS OTHERWISE INDICATED
  2. REFERENCE DRAWING FOR GENERAL VIEW : CS - 256. CS - 257.

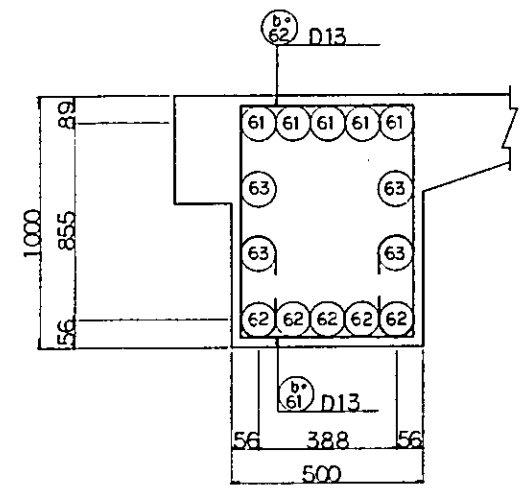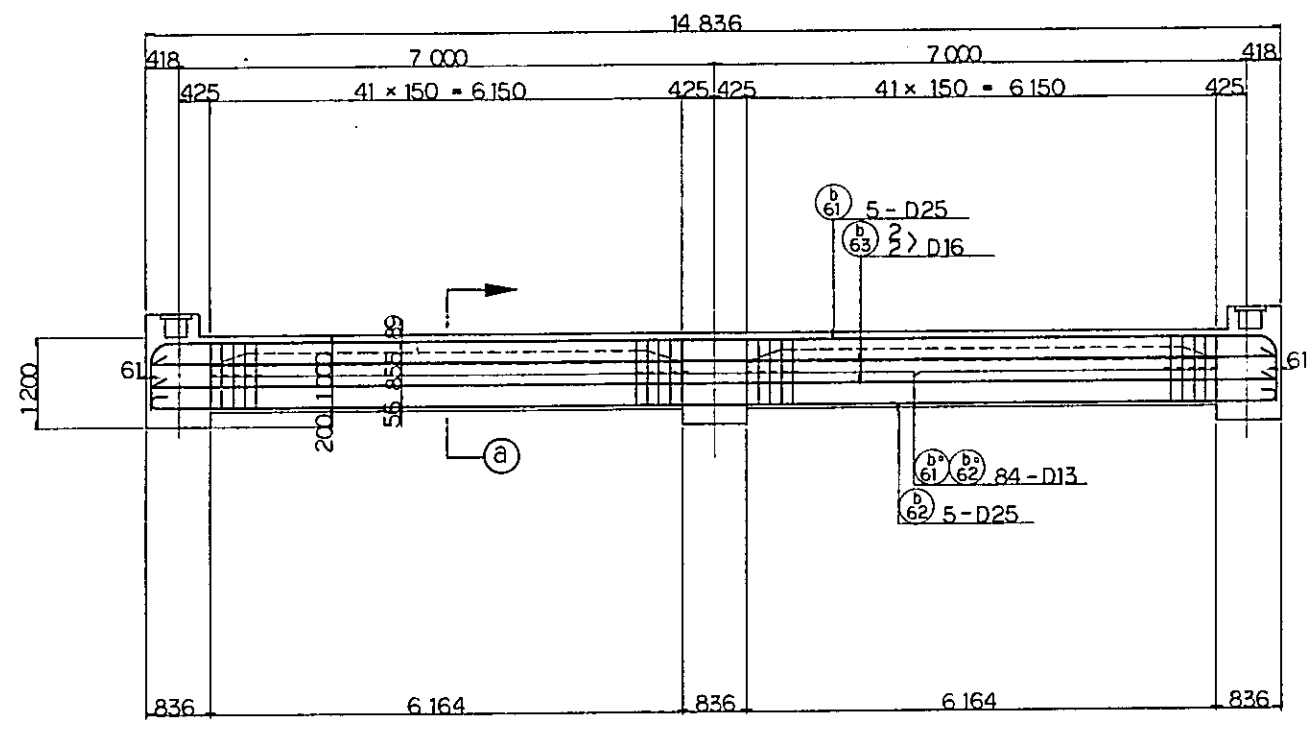


SECTION a - a

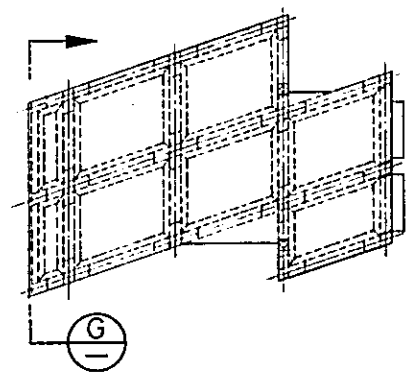


REMARKING DIAGRAM

SECTION G - A


|  |           |          |             |         |          |           |
|--|-----------|----------|-------------|---------|----------|-----------|
| REPUBLIC OF INDONESIA<br>MINISTRY OF COMMUNICATIONS<br>DIRECTORATE GENERAL OF LAND TRANSPORT<br>AND INLAND WATERWAYS |           |          |             |         |          |           |
| NEW RAILWAY LINE FOR CENGKARENG AIRPORT<br>CONSTRUCTION PROJECT  |           |          |             |         |          |           |
| JAPAN INTERNATIONAL COOPERATION AGENCY<br>(JICA)   |           |          |             |         |          |           |
| B  | 1 AUG. 84 | T.K.     | 10          | K.A.    | K.M.     | K.K.      |
| A  | 1 FEB. 84 | T.K.     | 10          | K.A.    | K.M.     | K.K.      |
| REVISIONS  | DATE      | DESIGNED | DRAWN       | CHECKED | REVIEWED | SUBMITTED |
| VIADUCT VI29<br>BAR ARRANGEMENT<br>(SHEET 12 OF 14)  |           |          |             |         |          |           |
| PACKAGE: I CIVIL AND ARCHITECTURAL WORK  |           |          |             |         |          |           |
| SCALE  | 1:50      |          | DRAWING NO. |         | GS-269   |           |

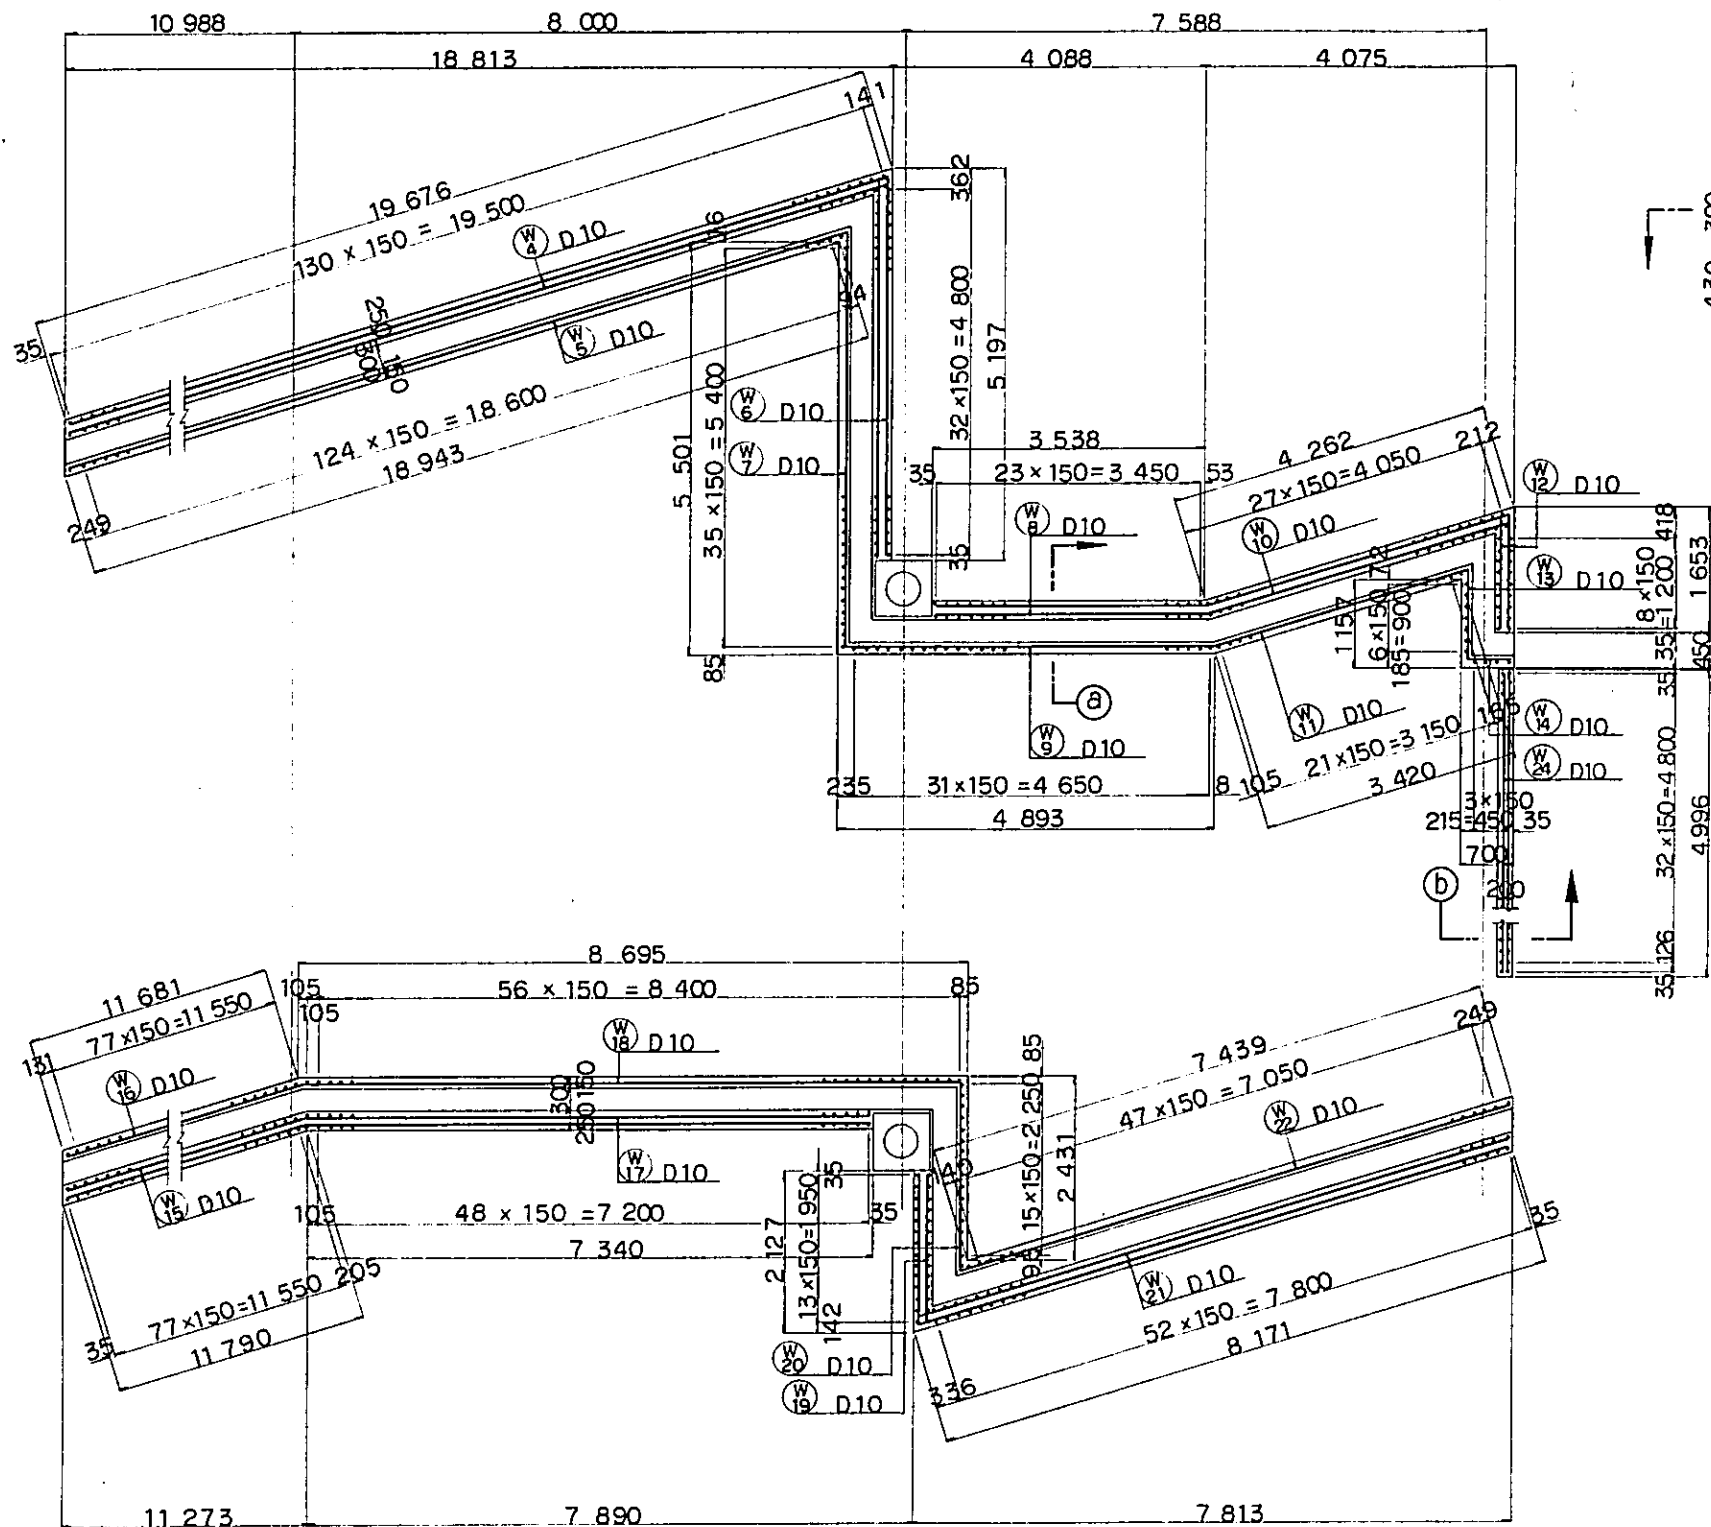


SECTION A-A

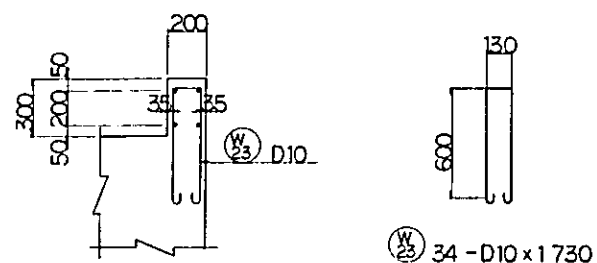

SECTION B-B  
SCALE 1:20

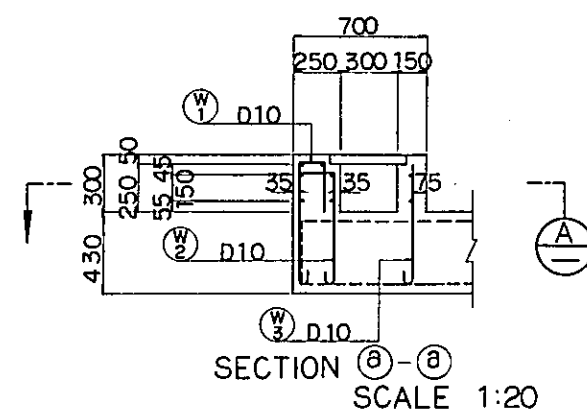




SECTION A-A  
SCALE 1:20

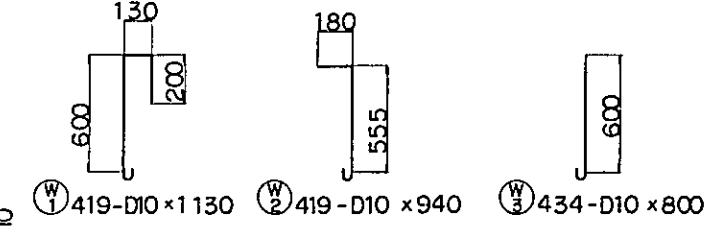





- W 4 4-D10 x 19 600
- W 5 2-D10 x 19 000
- W 6 4-D10 x 5 200
- W 7 2-D10 x 5 600
- W 8 4-D10 x 3 500
- W 9 2-D10 x 4 900
- W 10 4-D10 x 4 300
- W 11 2-D10 x 3 600
- W 12 4-D10 x 1 600
- W 13 2-D10 x 1 300
- W 14 2-D10 x 650
- W 15 4-D10 x 11 800
- W 16 2-D10 x 11 700
- W 17 4-D10 x 7 300
- W 18 2-D10 x 8 700
- W 19 4-D10 x 2 100
- W 20 2-D10 x 2 500
- W 21 4-D10 x 8 100
- W 22 2-D10 x 7 500

NOTES:  
 1. ALL DIMENSIONS ARE SHOWN IN MILLIMETERS UNLESS OTHERWISE INDICATED  
 2. REFERENCE DRAWING FOR GENERAL VIEW : CS - 256, CS - 257.






|   |             |          |        |         |          |           |
|---|-------------|----------|--------|---------|----------|-----------|
| REPUBLIC OF INDONESIA<br>MINISTRY OF COMMUNICATIONS<br>DIRECTORATE GENERAL OF LAND TRANSPORT AND INLAND WATERWAYS |             |          |        |         |          |           |
| NEW RAILWAY LINE FOR CENGKARENG AIRPORT<br>CONSTRUCTION PROJECT   |             |          |        |         |          |           |
| JAPAN INTERNATIONAL COOPERATION AGENCY (JICA)   |             |          |        |         |          |           |
| B   | 1AUG'84     | TK       | AO     | KA      | UM       | AK        |
| A   | 15SEP'84    | TK       | AO     | KA      | UM       | AK        |
| REVISIONS   | DATE        | DESIGNED | DRAWN  | CHECKED | REVIEWED | SUBMITTED |
| VIADUCT V129<br>BAR ARRANGEMENT<br>(SHEET 13 OF 14)   |             |          |        |         |          |           |
| PACKAGE: J CIVIL AND ARCHITECTURAL WORK   |             |          |        |         |          |           |
| SCALE: 1:50   | DRAWING NO. |          | CS-270 |         |          |           |

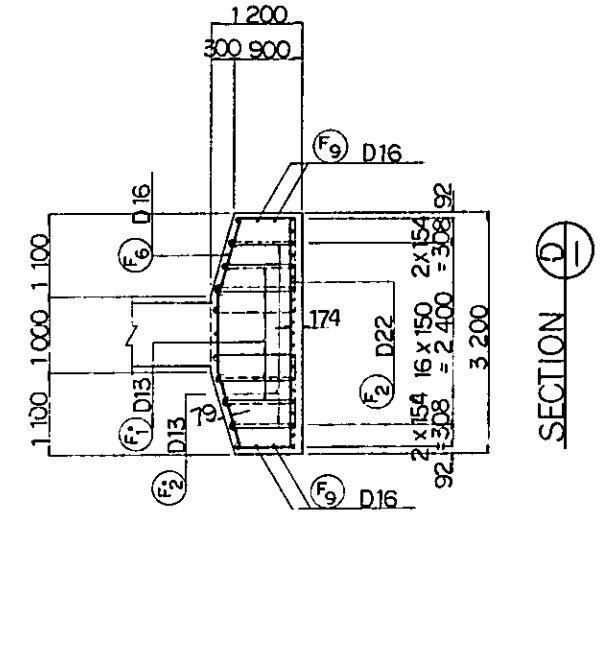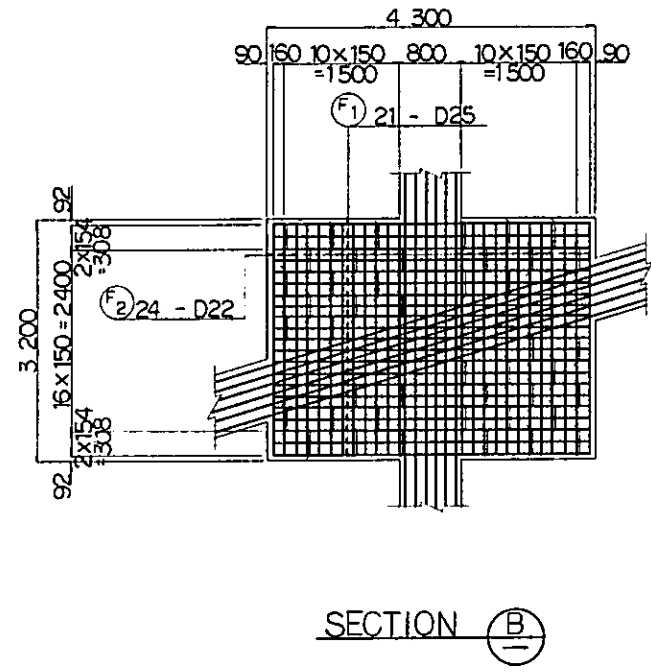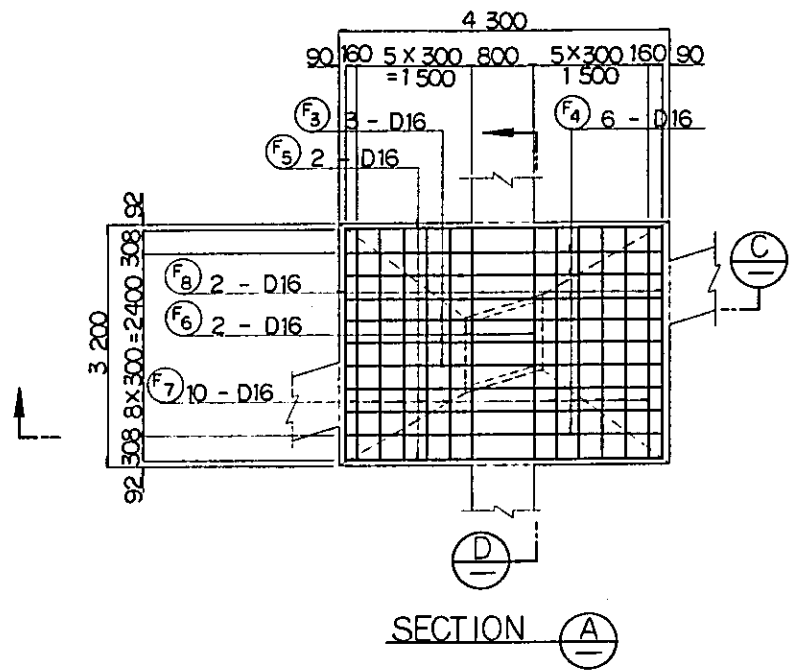

NOTES:  
 1. ALL DIMENSIONS ARE SHOWN IN MILLIMETERS UNLESS OTHERWISE INDICATED  
 2. REFERENCE DRAWING FOR GENERAL VIEW : CS - 256 CS - 257

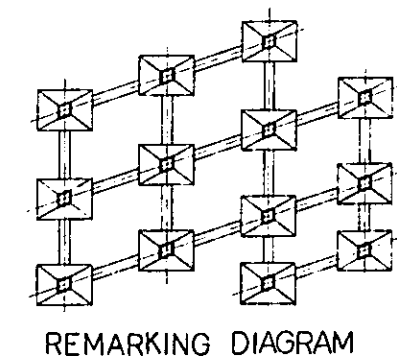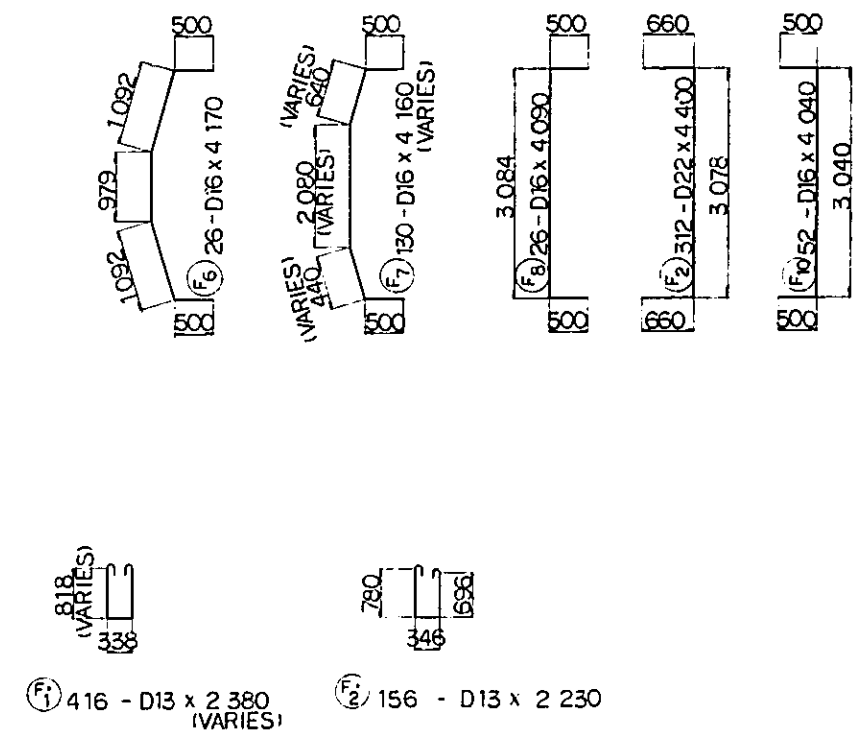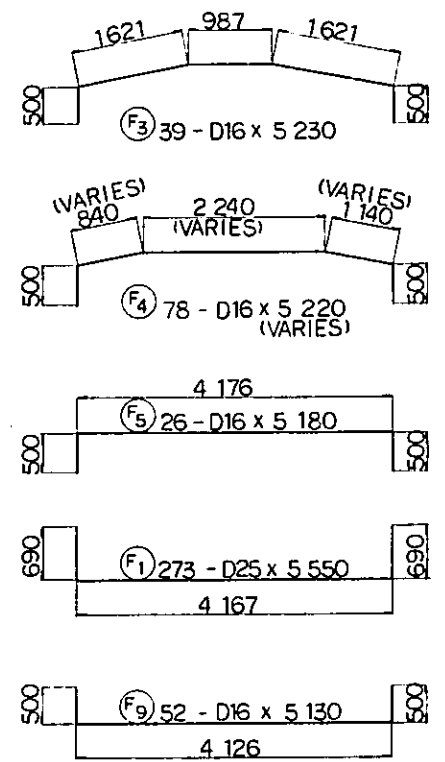
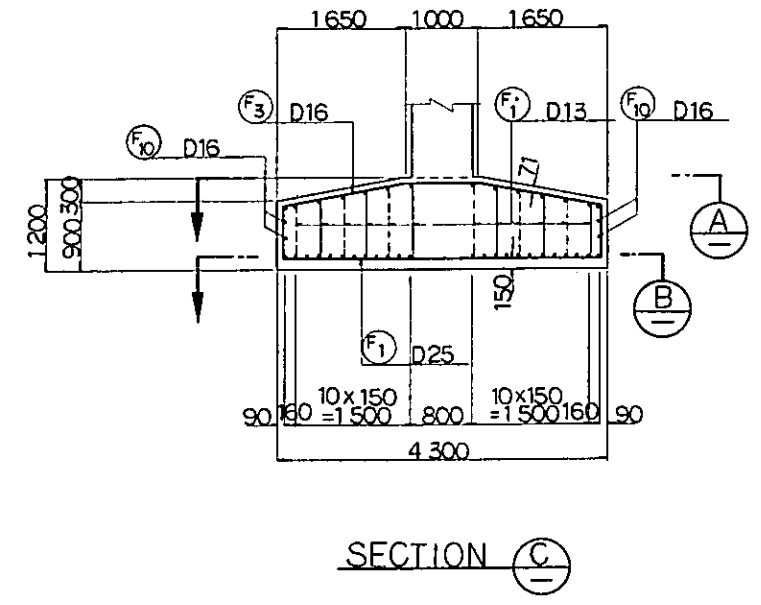


|   |          |          |             |         |          |
|---|----------|----------|-------------|---------|----------|
| REPUBLIC OF INDONESIA<br>MINISTRY OF COMMUNICATIONS<br>DIRECTORATE GENERAL OF LAND TRANSPORT AND INLAND WATERWAYS |          |          |             |         |          |
| NEW RAILWAY LINE FOR CENGKARENG AIRPORT<br>CONSTRUCTION PROJECT   |          |          |             |         |          |
| JAPAN INTERNATIONAL COOPERATION AGENCY<br>(JICA)  |          |          |             |         |          |
| B   | 1AUG'84  | T.K.     | A.D.        | K.A.    | K.M.     |
| A   | 15FEB'84 | T.K.     | A.D.        | K.A.    | K.M.     |
| REVISIONS   | DATE     | DESIGNED | DRAWN       | CHECKED | REVIEWED |
| VIADUCT VI29<br>BAR ARRANGEMENT<br>(SHEET 14 OF 14)   |          |          |             |         |          |
| PACKAGE: I CIVIL AND ARCHITECTURAL WORK   |          |          |             |         |          |
| SCALE   | 1:50     |          | DRAWING NO. | CS-271  |          |

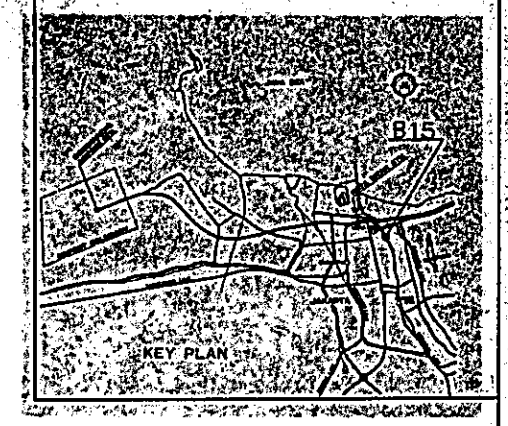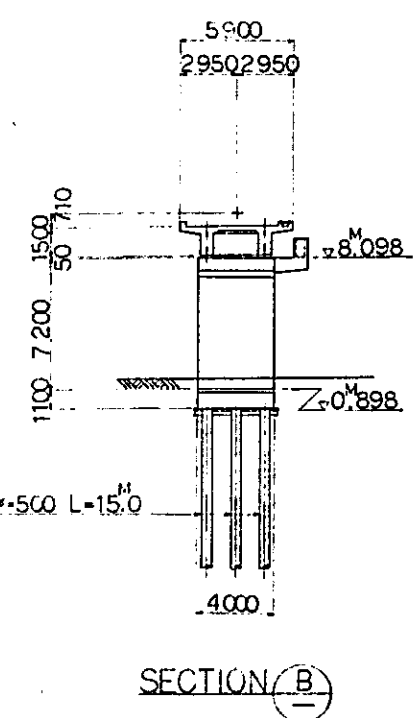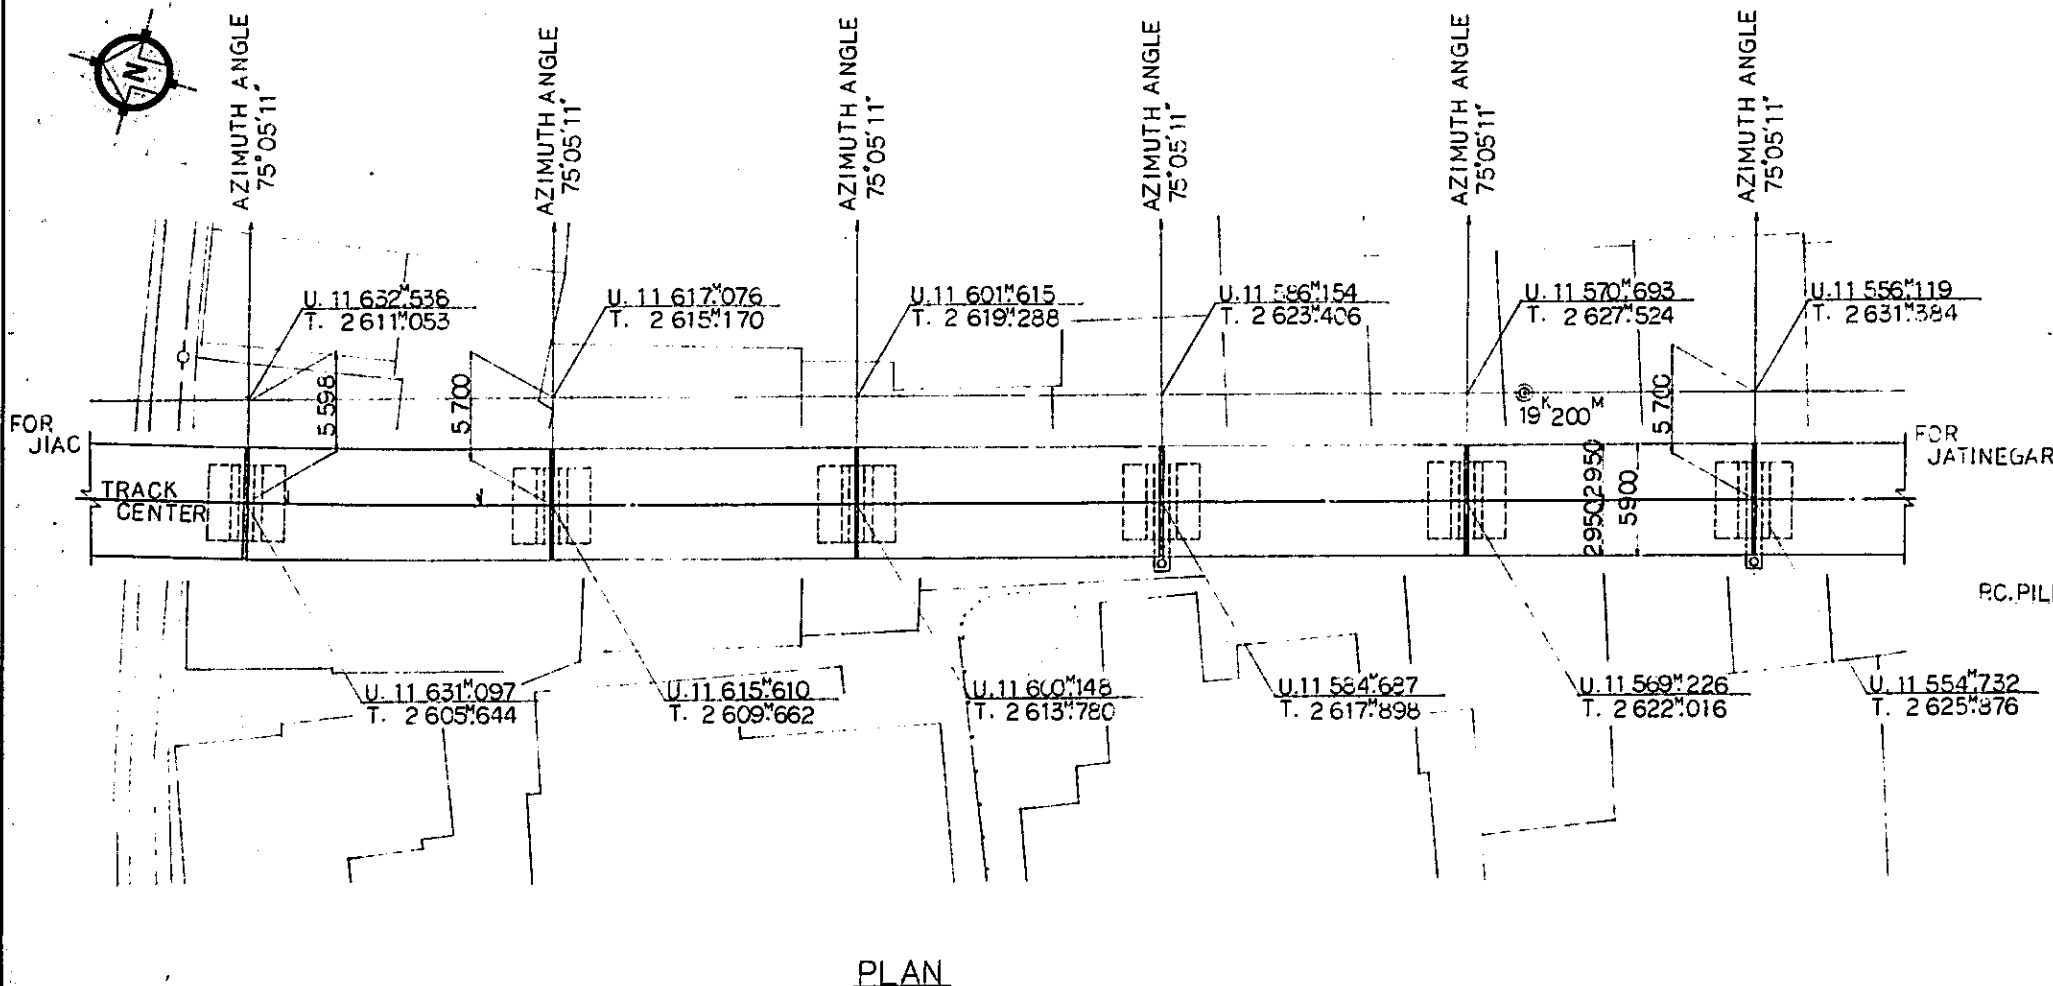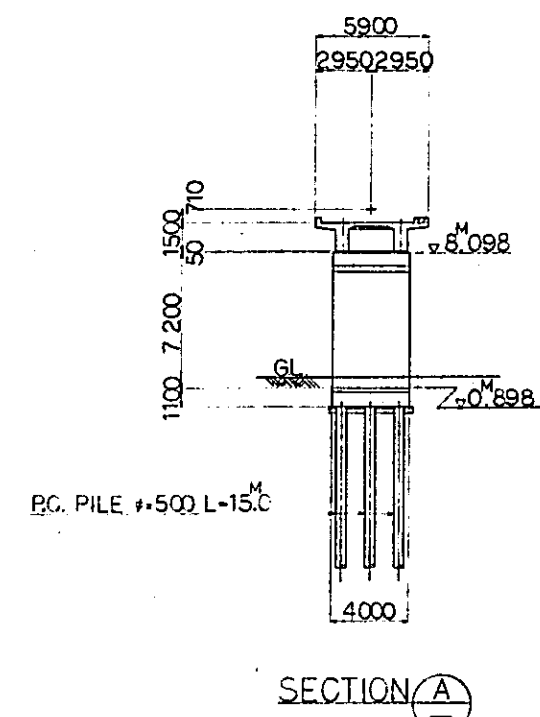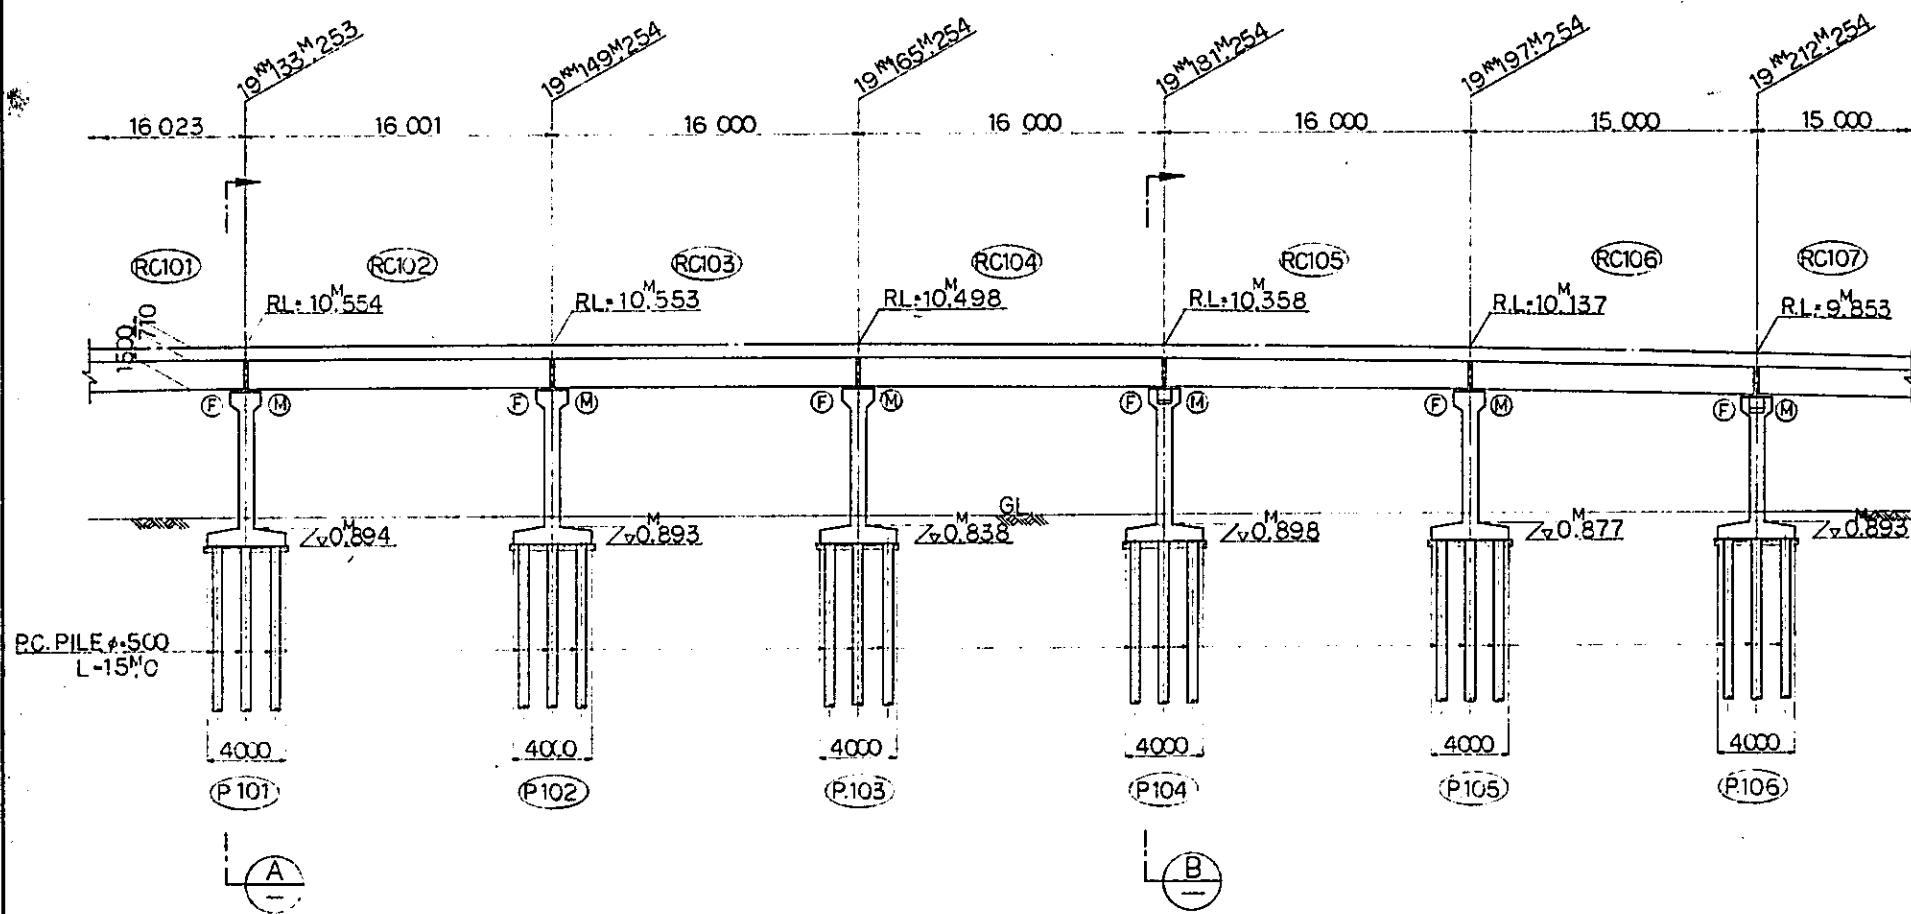


- NOTES:
- ALL DIMENSIONS ARE SHOWN IN MILLIMETERS UNLESS OTHERWISE INDICATED
  - REFERENCE DRAWING FOR GENERAL VIEW: CS-275, CS-276, CS-281.
  - CODE:
    - (F) --- FIXED BEARING
    - (M) --- EXPANSION BEARING

|   |           |      |         |          |       |
|---|-----------|------|---------|----------|-------|
| REPUBLIC OF INDONESIA<br>MINISTRY OF COMMUNICATIONS<br>DIRECTORATE GENERAL OF LAND TRANSPORT AND INLAND WATERWAYS |           |      |         |          |       |
| NEW RAILWAY LINE FOR CENKARENG AIRPORT<br>CONSTRUCTION PROJECT  |           |      |         |          |       |
| JAPAN INTERNATIONAL COOPERATION AGENCY (JICA)   |           |      |         |          |       |
| NO.   | DATE      | BY   | CHECKED | APPROVED | SCALE |
| B-1   | 1 AUG 84  | T.R. | A.O.    | K.M.     | 1:200 |
| A-1   | 25 FEB 84 | T.R. | A.O.    | K.M.     | 1:200 |
| BRIDGE B15<br>GENERAL VIEW<br>(SHEET 1 OF 3)  |           |      |         |          |       |
| CIVIL AND ARCHITECTURAL WORK  |           |      |         |          |       |
| DRAWING NO. CS-272  |           |      |         |          |       |

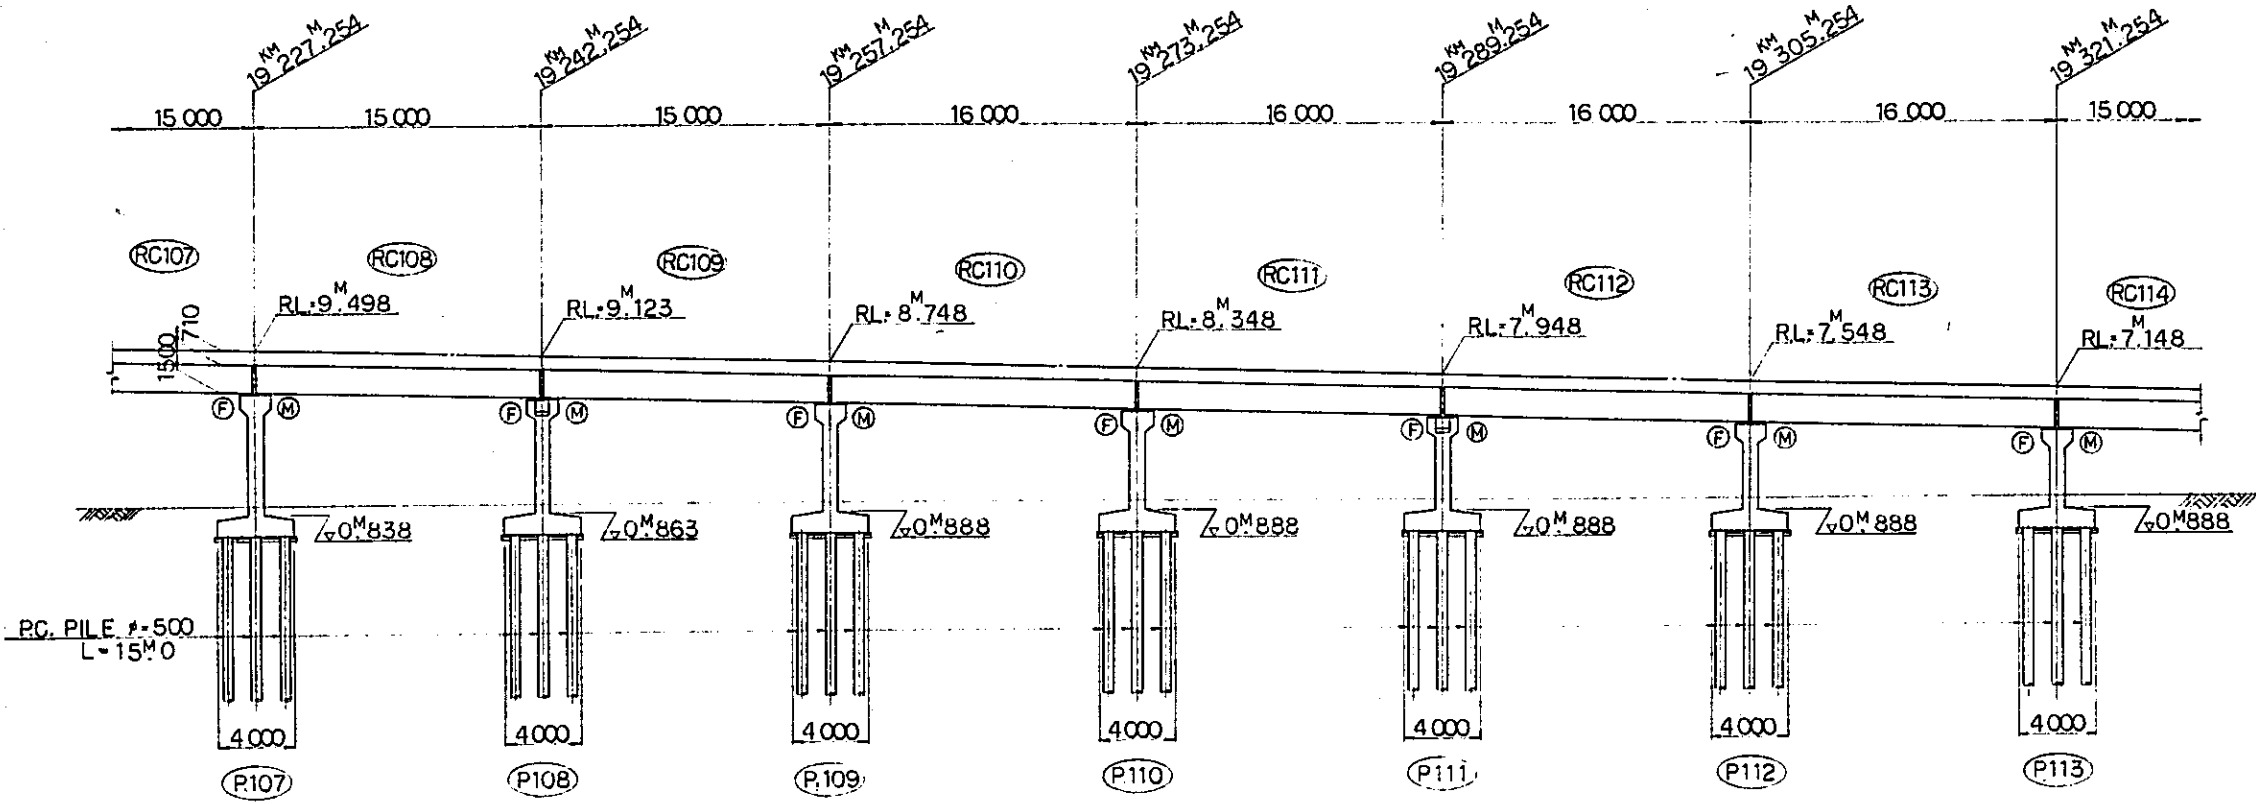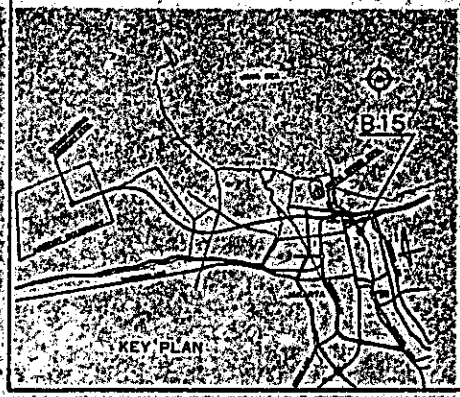



LONGITUDINAL SECTION

- NOTES:
- ALL DIMENSIONS ARE SHOWN IN MILLIMETERS UNLESS OTHERWISE INDICATED
  - REFERENCE DRAWING FOR GENERAL VIEW: CS-276.CS-281.
  - CODE :
    - ⊕ --- FIXED BEARING
    - ⊙ --- EXPANSION BEARING

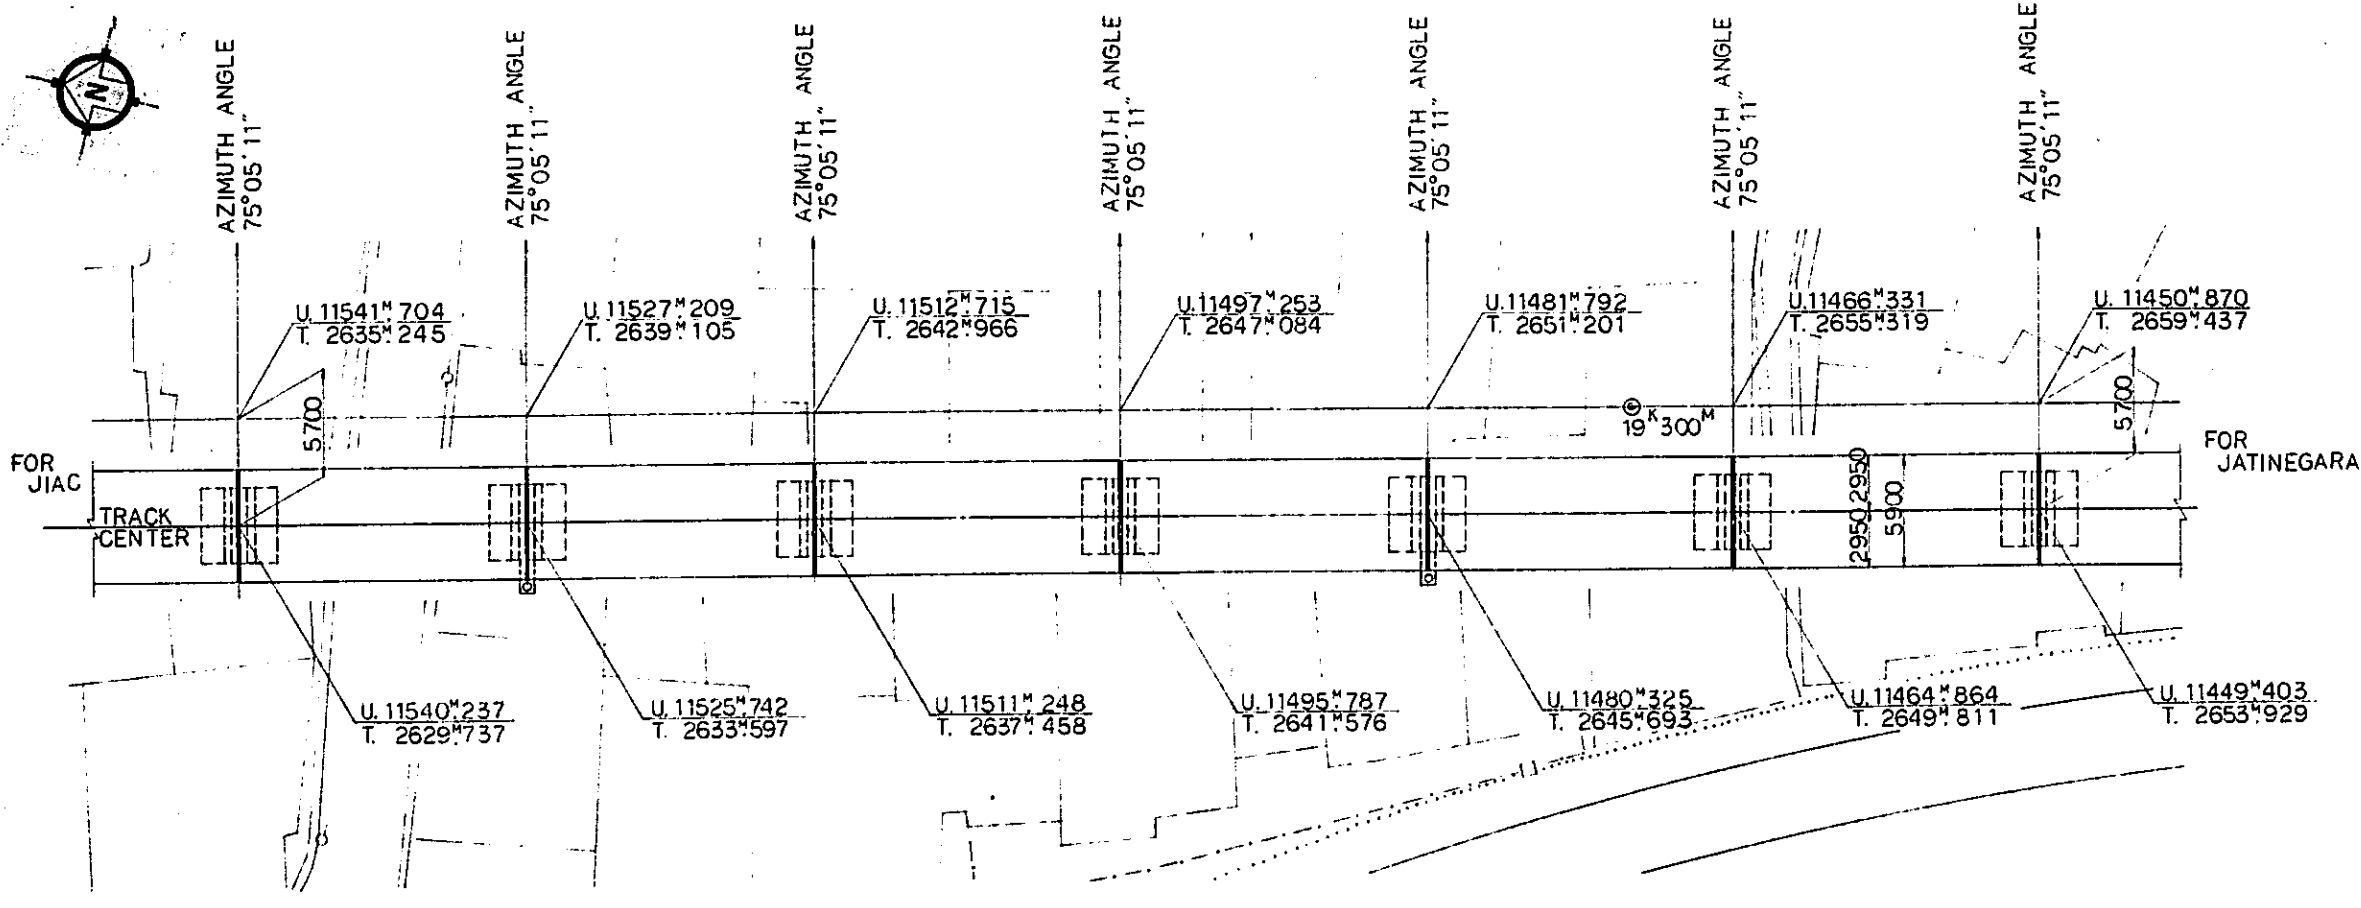


PLAN

|   |                      |
|---|----------------------|
| REPUBLIC OF INDONESIA<br>MINISTRY OF COMMUNICATIONS<br>DIRECTORATE GENERAL OF LAND TRANSPORT AND INLAND WATERWAYS |                      |
| NEW RAILWAY LINE FOR CENGKARENG AIRPORT<br>CONSTRUCTION PROJECT   |                      |
| JAPAN INTERNATIONAL COOPERATION AGENCY (JICA)   |                      |
| B   | 1AUG/84 40 KILOMETER |
| A   | 1FEB/84 40 KILOMETER |
| REVISIONS   | DATE                 |
| BRIDGE B15<br>GENERAL VIEW<br>(SHEET 2 OF 3)  |                      |
| PACKAGE: CIVIL AND ARCHITECTURAL WORK   |                      |
| SCALE: 1:200  | DRAWING NO: CS-273   |

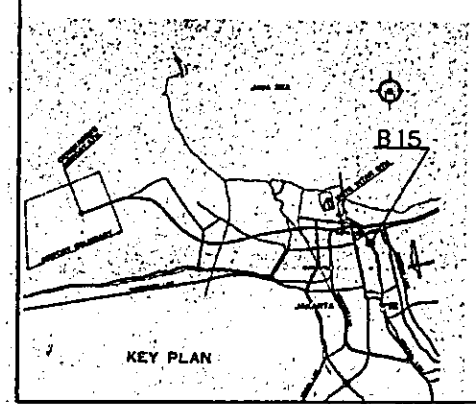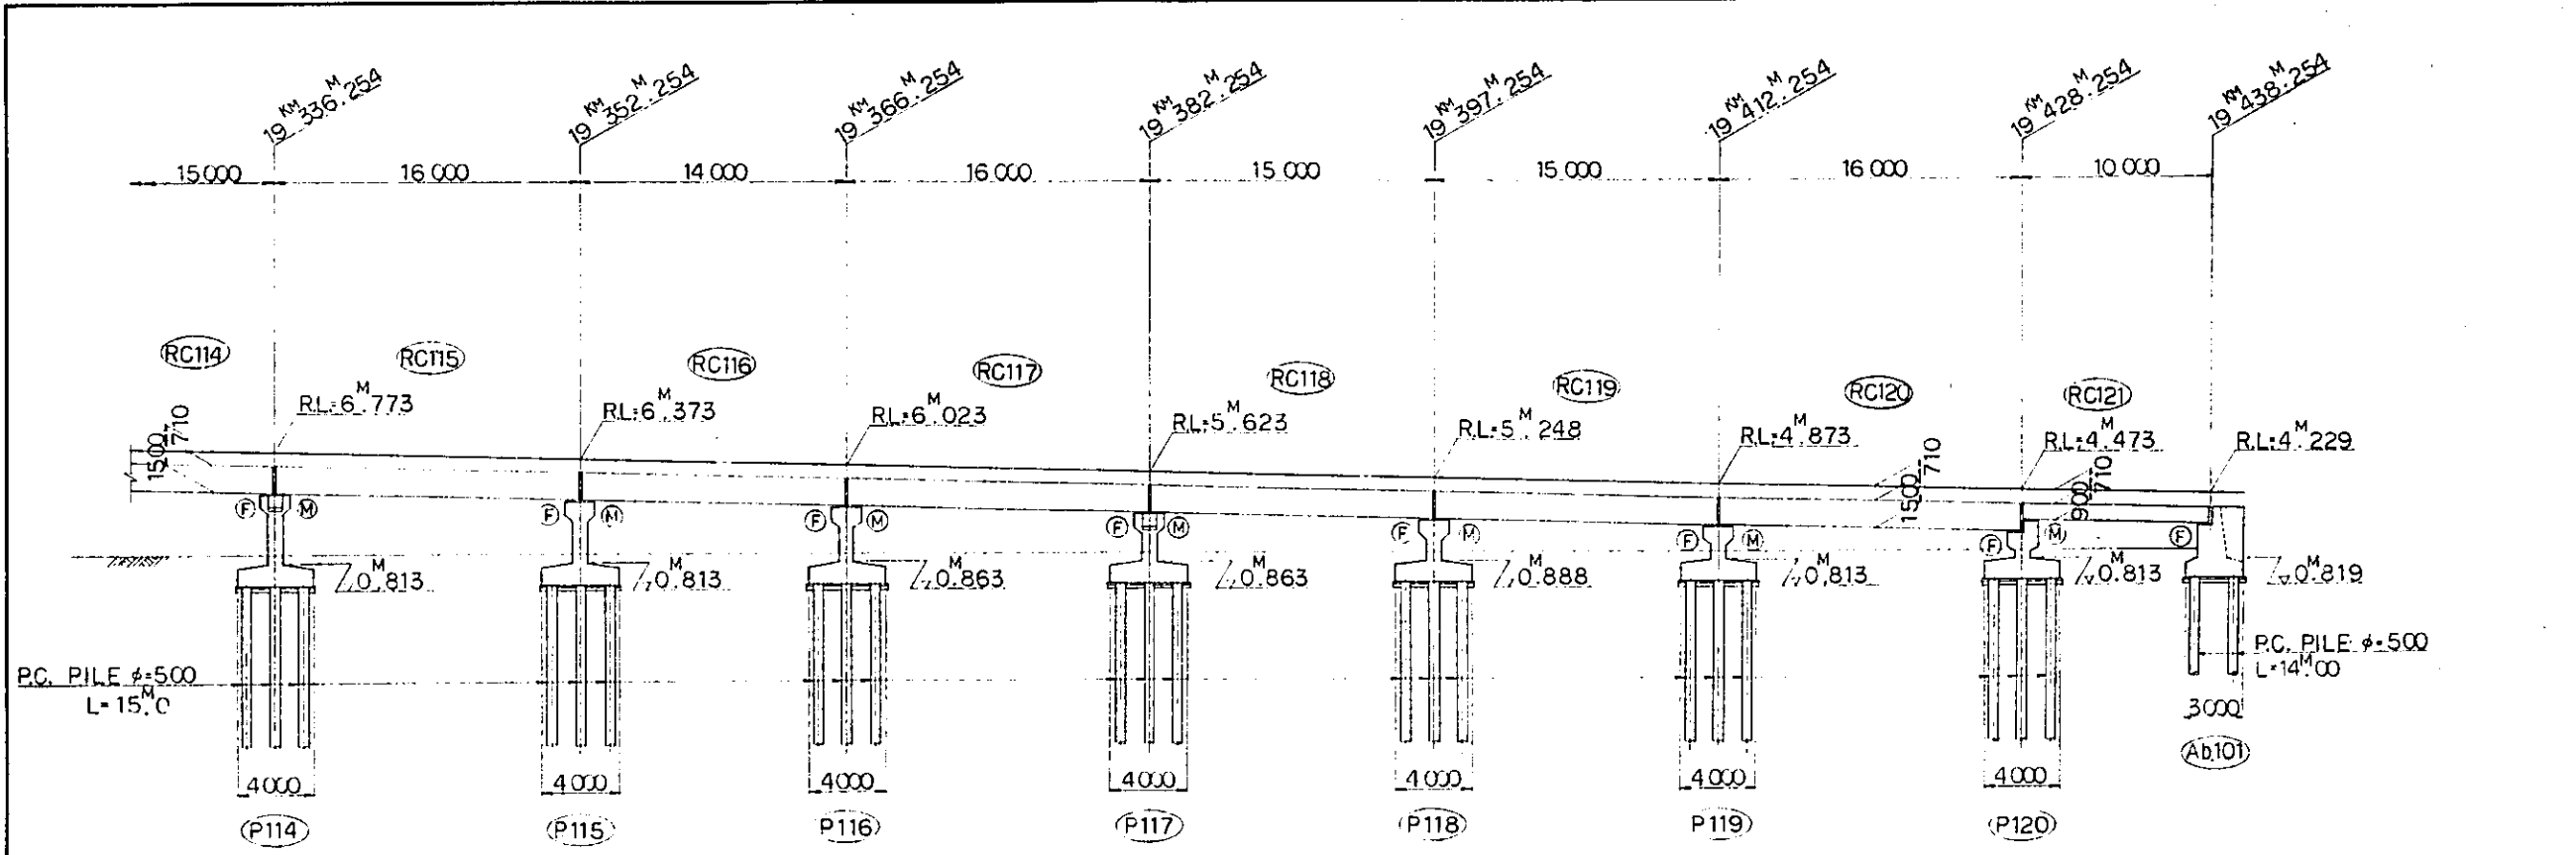


- NOTES:
- ALL DIMENSIONS ARE SHOWN IN MILLIMETERS UNLESS OTHERWISE INDICATED
  - REFERENCE DRAWING FOR GENERAL VIEW: CS-276, CS-185, CS-281, CS-284.
  - CODE :  
 (F) --- FIXED BEARING  
 (M) --- EXPANSION BEARING

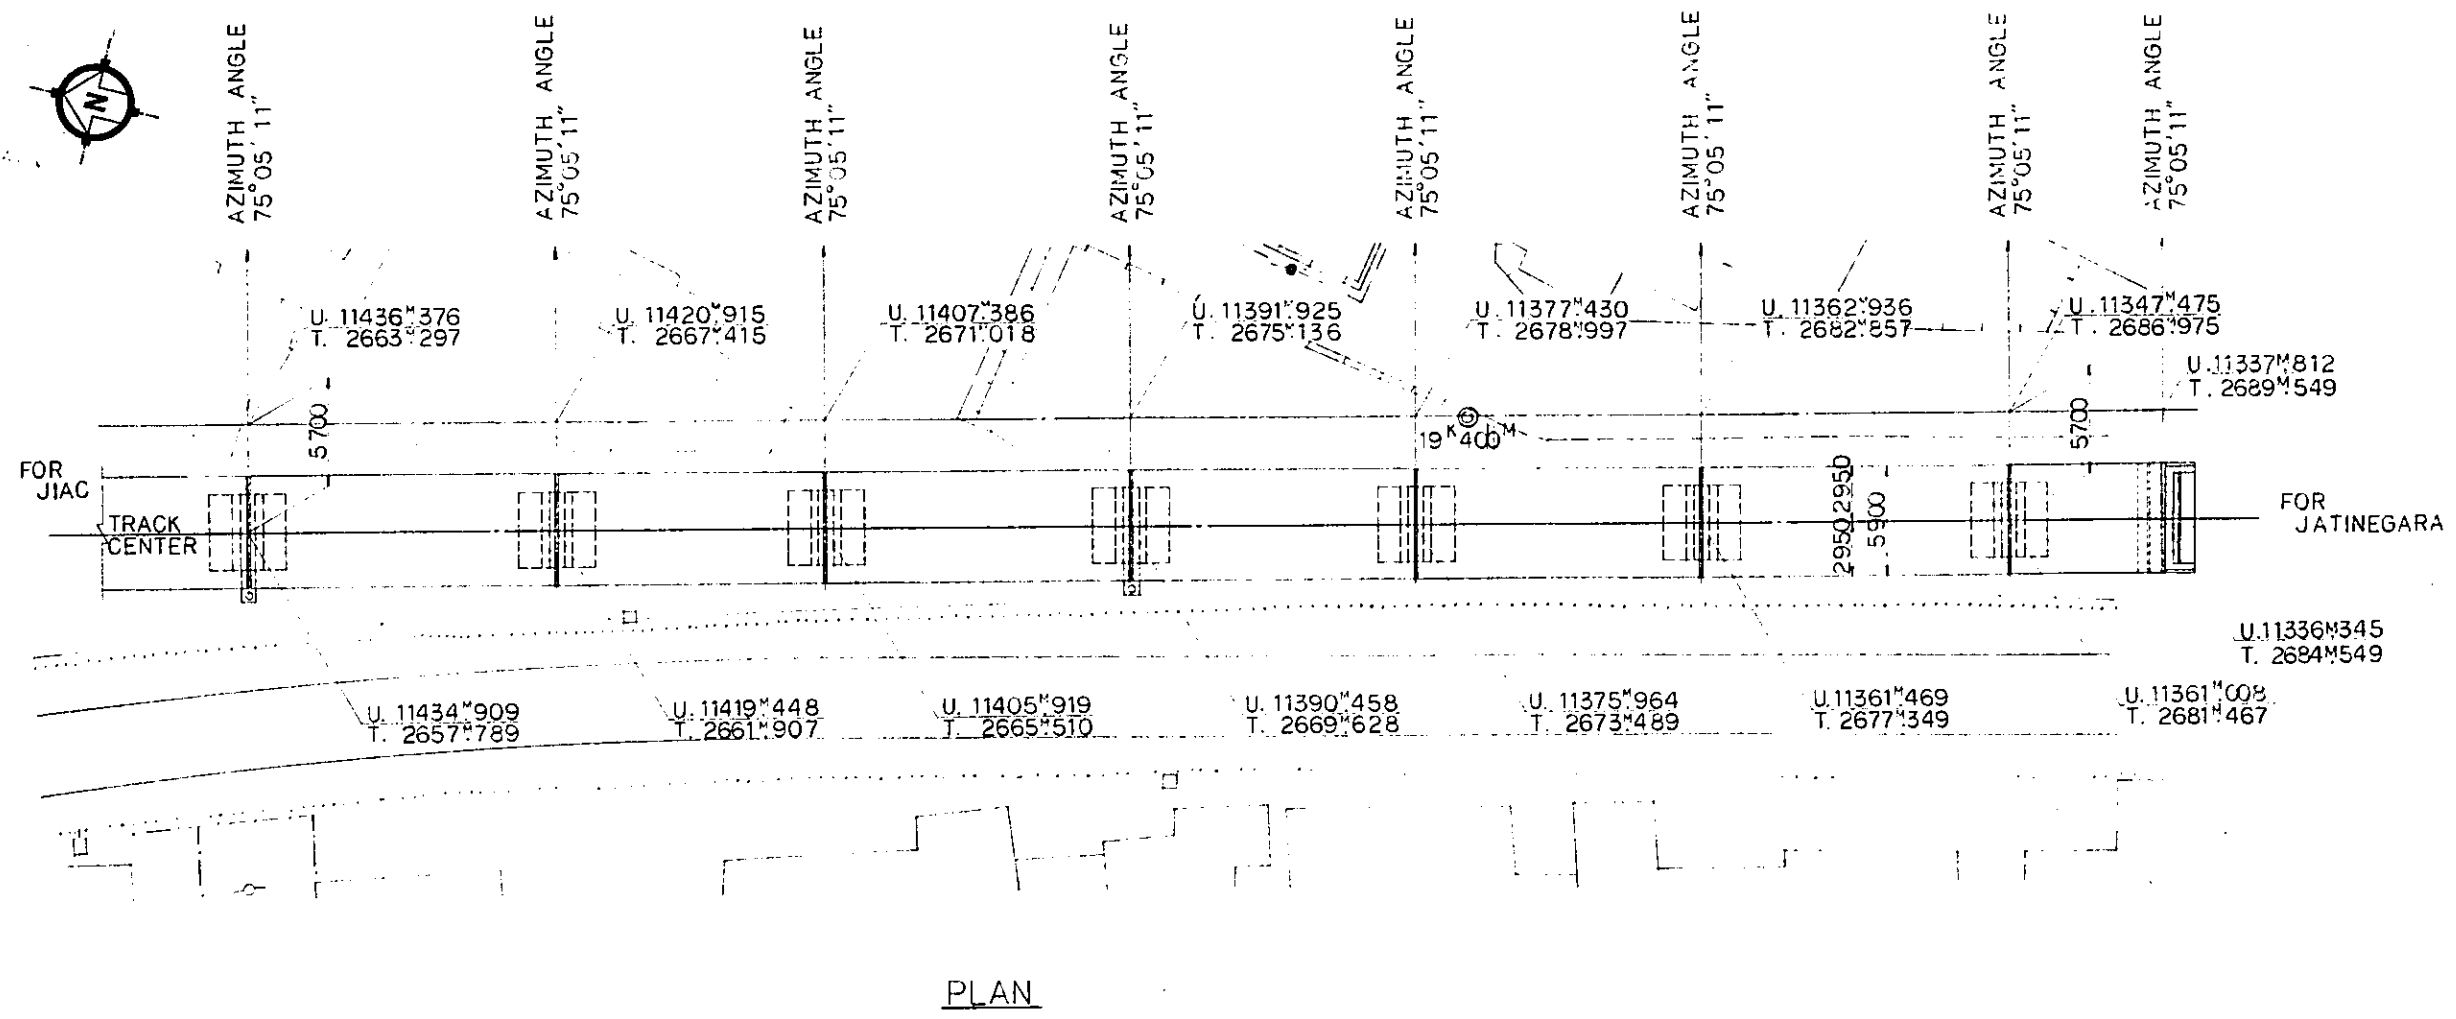


|   |             |          |         |          |          |
|---|-------------|----------|---------|----------|----------|
| REPUBLIC OF INDONESIA<br>MINISTRY OF COMMUNICATIONS<br>DIRECTORATE GENERAL OF LAND TRANSPORT AND INLAND WATERWAYS |             |          |         |          |          |
| NEW RAILWAY LINE FOR CENGKARENG AIRPORT<br>CONSTRUCTION PROJECT   |             |          |         |          |          |
| JAPAN INTERNATIONAL COOPERATION AGENCY<br>(JICA)  |             |          |         |          |          |
| B   | 1 AUG 84    | T.K      | A.O     | K.B      | K.M      |
| A   | 1 FEB 84    | T.K      | A.O     | K.B      | K.M      |
| REVISIONS   | DATE        | DESIGNED | CHECKED | APPROVED | REVIEWED |
| BRIDGE B15<br>GENERAL VIEW<br>(SHEET 3 OF 3)  |             |          |         |          |          |
| PACKAGE: I CIVIL AND ARCHITECTURAL WORK   |             |          |         |          |          |
| SCALE   | DRAWING NO. |          |         |          |          |
| 1:200   | CS-274      |          |         |          |          |



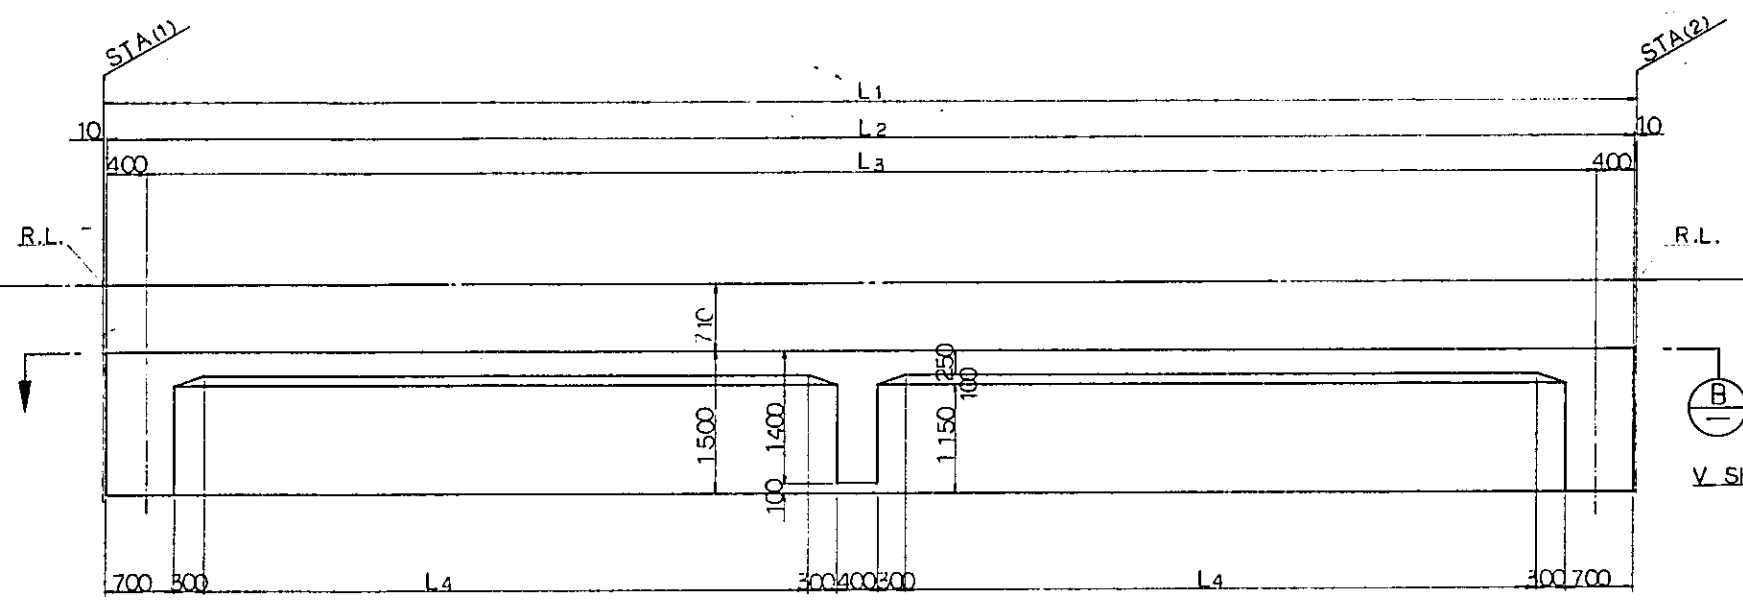


SECTION A

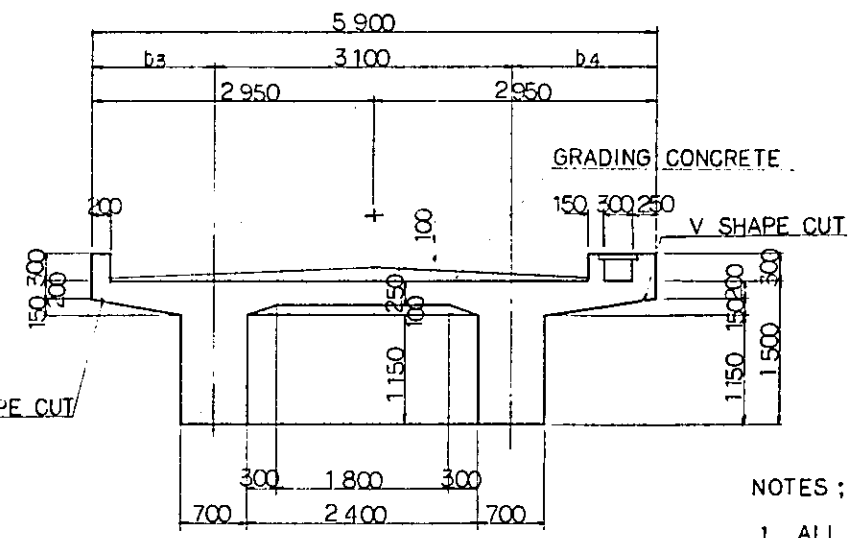

SECTION C

- NOTES :
1. ALL DIMENSIONS ARE SHOWN IN MILLIMETERS UNLESS OTHERWISE INDICATED
  2. REFERENCE DRAWING FOR BAR ARRANGEMENT : CS-278~280.
  3. GRADING CONCRETE SHALL BE SIMULTANEOUSLY PLACED WITH SLAB CONCRETE

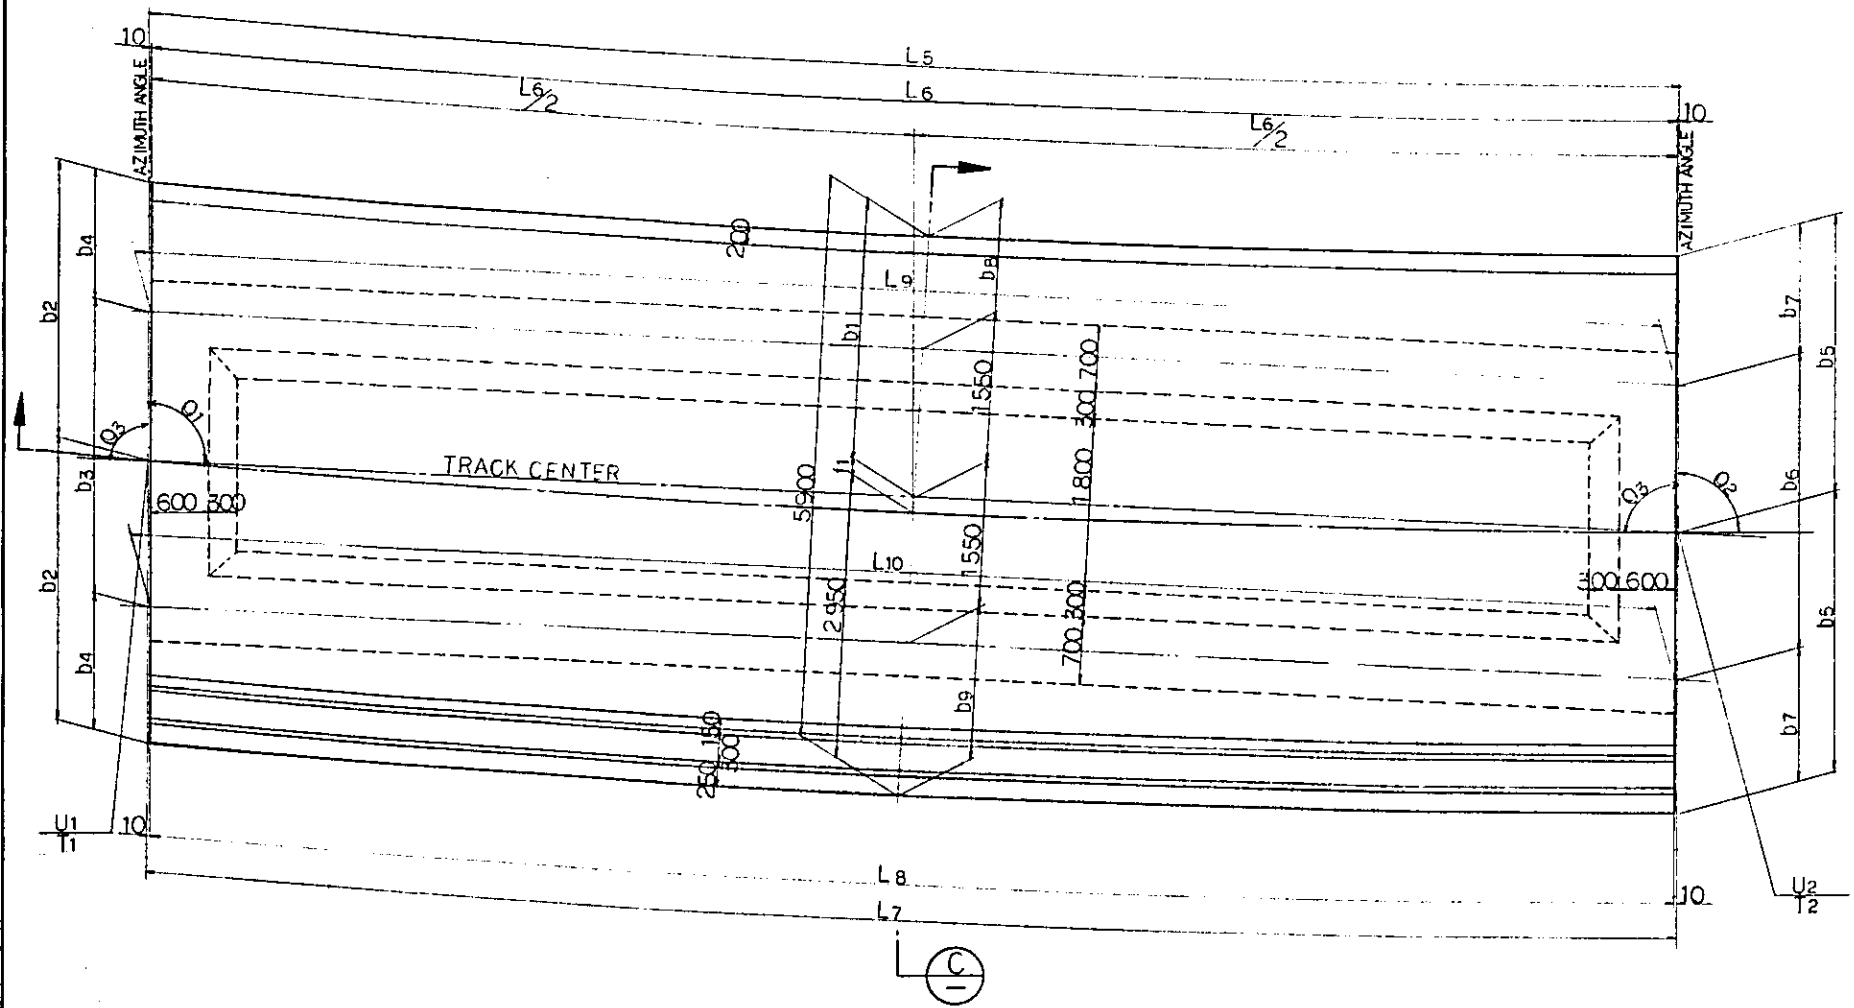

SECTION B

|         | RC 101      | RC 102      |
|---------|-------------|-------------|
| STA (1) | 19°17'23.1  | 19°13'25.3  |
| (2)     | 19°13'25.3  | 19°14'25.4  |
| U 1     | 11°6'46.768 | 11°6'31.097 |
| T 1     | 2°6'02.315  | 2°6'05.644  |
| U 2     | 11°6'31.097 | 11°6'15.610 |
| T 2     | 2°6'05.644  | 2°6'09.662  |
| L 1     | 16 023      | 16 001      |
| L 2     | 16 003      | 15 981      |
| L 3     | 15 323      | 15 301      |
| L 4     | 14 203      | 14 181      |
| f 1     | 107         | 14          |
| b 1     | 2 843       | 2 937       |
| b 2     | 2 953       | 2 950       |
| b 3     | 3 104       | 3 100       |
| b 4     | 1 402       | 1 400       |
| b 5     | 2 953       | 2 950       |
| b 6     | 3 104       | 3 100       |
| b 7     | 1 402       | 1 400       |
| b 8     | 1 293       | 1 387       |
| b 9     | 1 507       | 1 413       |
| Q 1     | 94°27'09.6  | 91°23'33.2  |
| Q 2     | 91°23'33.2  | 90°00'00"   |
| Q 3     | 87°04'38.6  | 89°18'13.4  |

REPUBLIC OF INDONESIA  
 MINISTRY OF COMMUNICATIONS  
 DIRECTORATE GENERAL OF LAND TRANSPORT  
 AND INLAND WATERWAYS

NEW RAILWAY LINE FOR CENGKARENG AIRPORT  
 CONSTRUCTION PROJECT


JAPAN INTERNATIONAL COOPERATION AGENCY  
 (JICA)

|   |            |     |     |     |     |     |
|---|------------|-----|-----|-----|-----|-----|
| B | 1 AUG '84  | M.S | M.Y | K.A | K.M | M.K |
| A | 17 FEB '87 | M.S | M.Y | K.A | K.M | M.K |


REVISIONS DATE DESIGNED DRAWN CHECKED BY REVISED SUBMITTED

R.C. GIRDER  
 RC101, RC102  
 GENERAL VIEW

PACKAGE: I CIVIL AND ARCHITECTURAL WORK  
 SCALE: 1:40 DRAWING NO: CS-275

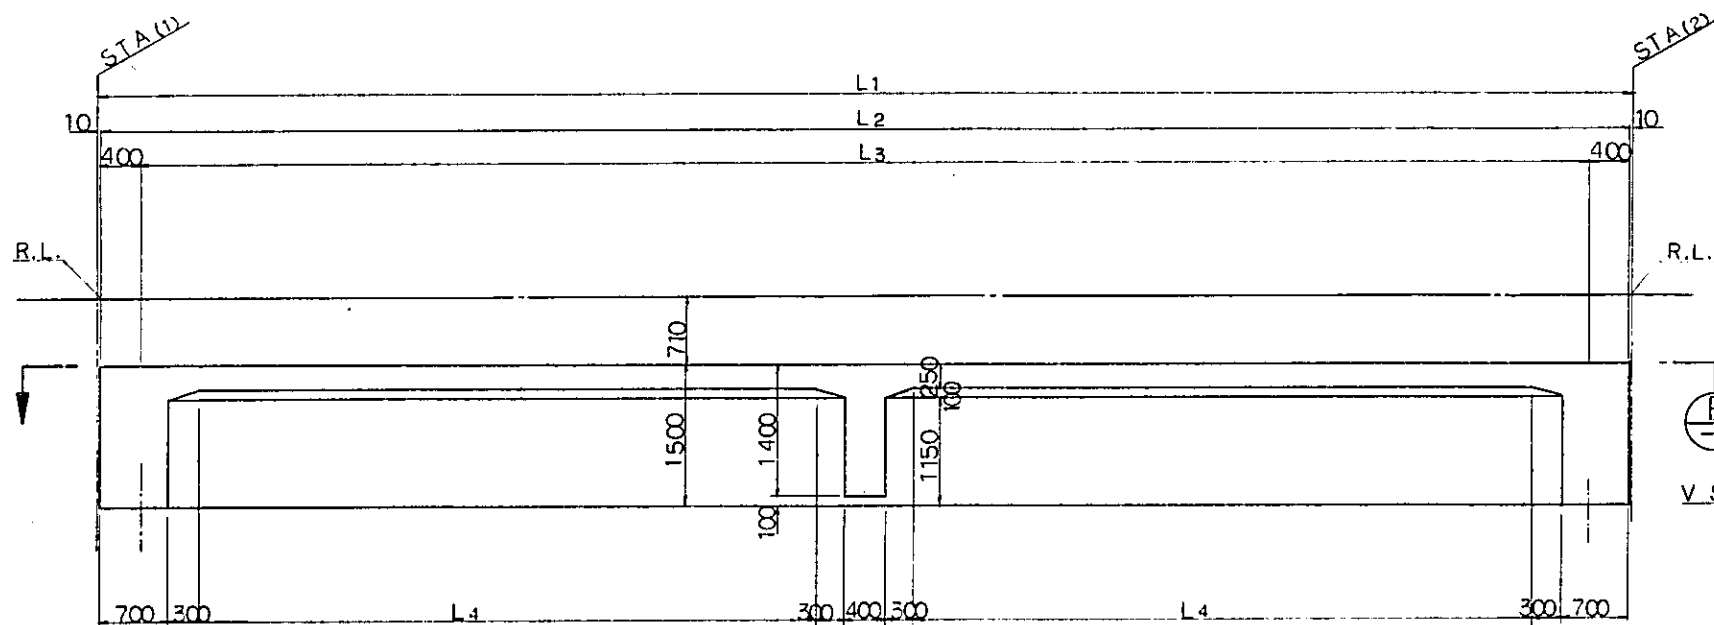


SECTION A

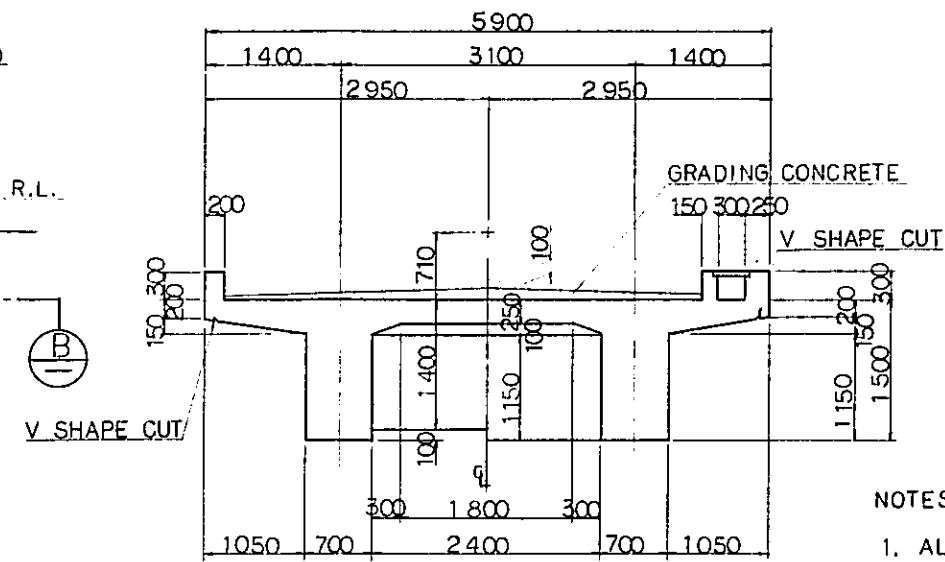

SECTION C SECTION D

- NOTES;
1. ALL DIMENSIONS ARE SHOWN IN MILLIMETERS UNLESS OTHERWISE INDICATED
  2. REFERENCE DRAWING FOR BAR ARRANGEMENT: CS-278~280.
  3. GRADING CONCRETE SHALL BE SIMULTANEOUSLY PLACED WITH SLAB CONCRETE

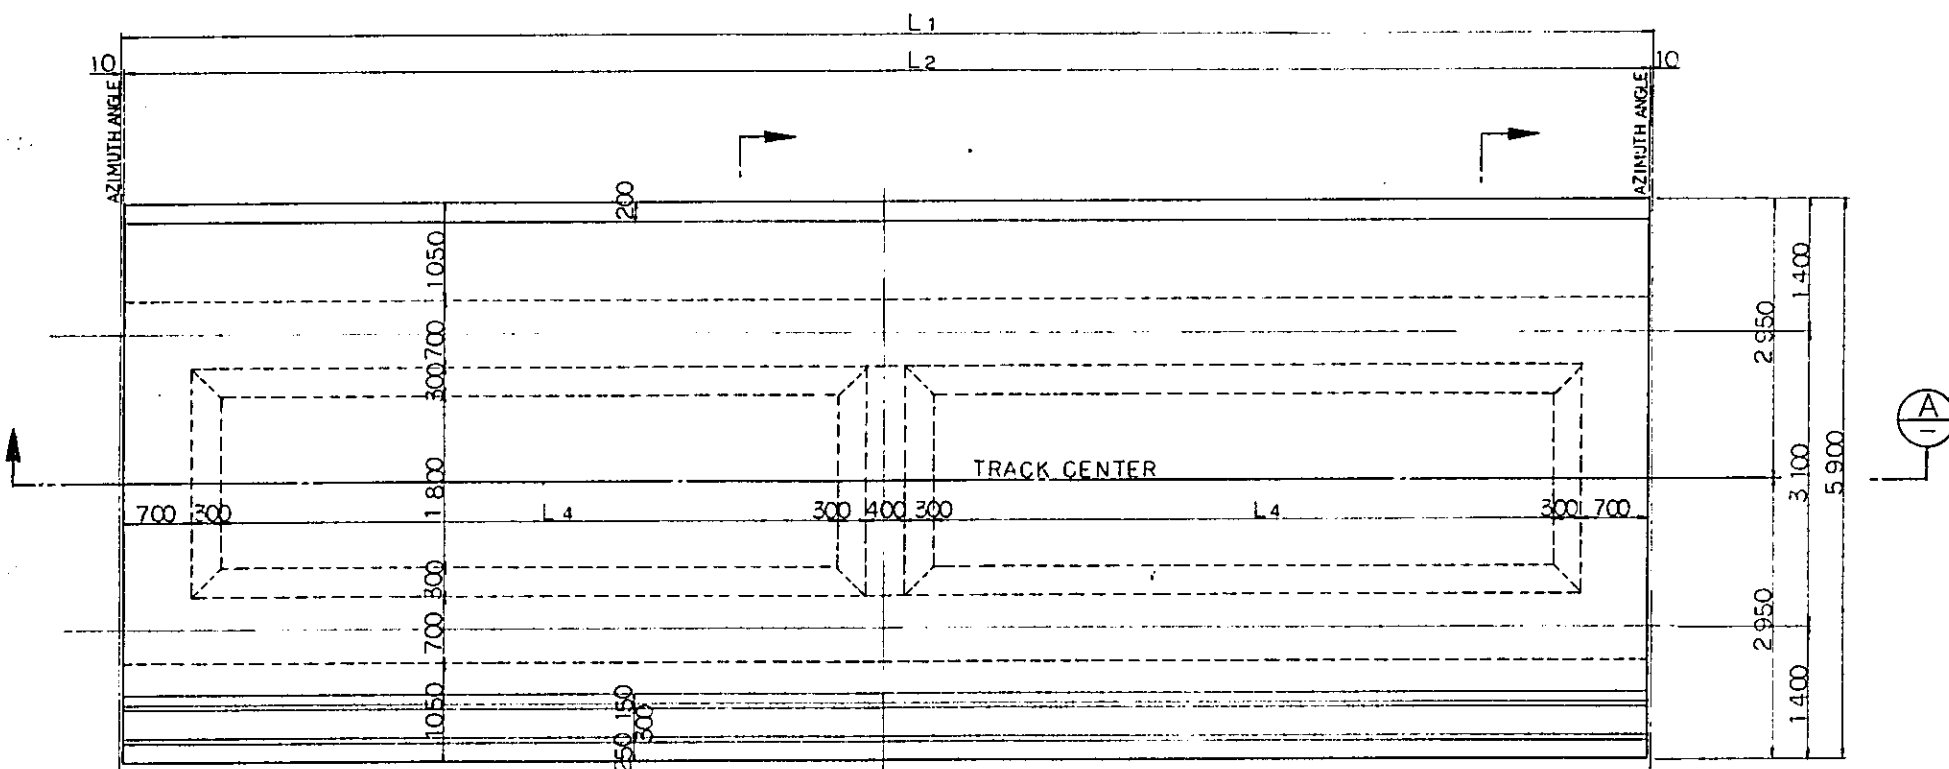

SECTION B

|  |           |          |             |         |          |           |
|--|-----------|----------|-------------|---------|----------|-----------|
| REPUBLIC OF INDONESIA<br>MINISTRY OF COMMUNICATIONS<br>DIRECTORATE GENERAL OF LAND TRANSPORT<br>AND INLAND WATERWAYS |           |          |             |         |          |           |
| NEW RAILWAY LINE FOR CENGKARENG AIRPORT<br>CONSTRUCTION PROJECT  |           |          |             |         |          |           |
| JAPAN INTERNATIONAL COOPERATION AGENCY<br>(JICA)   |           |          |             |         |          |           |
| B  | 1 AUG 84  | M.S.     | M.Y.        | K.A.    | K.M.     | M.R.      |
| A  | 15 FEB 84 | M.S.     | M.Y.        | K.A.    | K.M.     | M.R.      |
| REVISIONS  | DATE      | DESIGNED | DRAWN       | CHECKED | REVIEWED | SUBMITTED |
| R.C. GIRDER<br>RC103~RC120<br>GENERAL VIEW<br>(SHEET 1 OF 2)   |           |          |             |         |          |           |
| PACKAGE: I CIVIL AND ARCHITECTURAL WORK  |           |          |             |         |          |           |
| SCALE  | 1:40      |          | DRAWING NO. | CS-276  |          |           |

DIMENSION SCHEDULE


|                   | RC103                    | RC104                    | RC105                    | RC106                    | RC107                    | RC108                    | RC109                    | RC110                    | RC111                    | RC112                    | RC113                    | RC114                    | RC115                    | RC116                    |
|-------------------|--------------------------|--------------------------|--------------------------|--------------------------|--------------------------|--------------------------|--------------------------|--------------------------|--------------------------|--------------------------|--------------------------|--------------------------|--------------------------|--------------------------|
| STA (1)           | 19 <sup>KM</sup> 149.254 | 19 <sup>KM</sup> 165.254 | 19 <sup>KM</sup> 181.254 | 19 <sup>KM</sup> 197.254 | 19 <sup>KM</sup> 212.254 | 19 <sup>KM</sup> 227.254 | 19 <sup>KM</sup> 242.254 | 19 <sup>KM</sup> 257.254 | 19 <sup>KM</sup> 273.254 | 19 <sup>KM</sup> 289.254 | 19 <sup>KM</sup> 305.254 | 19 <sup>KM</sup> 321.254 | 19 <sup>KM</sup> 336.254 | 19 <sup>KM</sup> 352.254 |
| STA (2)           | 19 <sup>KM</sup> 165.254 | 19 <sup>KM</sup> 181.254 | 19 <sup>KM</sup> 197.254 | 19 <sup>KM</sup> 212.254 | 19 <sup>KM</sup> 227.254 | 19 <sup>KM</sup> 242.254 | 19 <sup>KM</sup> 257.254 | 19 <sup>KM</sup> 273.254 | 19 <sup>KM</sup> 289.254 | 19 <sup>KM</sup> 305.254 | 19 <sup>KM</sup> 321.254 | 19 <sup>KM</sup> 336.254 | 19 <sup>KM</sup> 352.254 | 19 <sup>KM</sup> 366.254 |
| AZIMUTH ANGLE (G) | 75° 05' 10" 71           | 75° 05' 10" 71           | 75° 05' 10" 71           | 75° 05' 10" 71           | 75° 05' 10" 71           | 75° 05' 10" 71           | 75° 05' 10" 71           | 75° 05' 10" 71           | 75° 05' 10" 71           | 75° 05' 10" 71           | 75° 05' 10" 71           | 75° 05' 10" 71           | 75° 05' 10" 71           | 75° 05' 10" 71           |
| DO                | "                        | "                        | "                        | "                        | "                        | "                        | "                        | "                        | "                        | "                        | "                        | "                        | "                        | "                        |
| U 1               | 11 <sup>KM</sup> 615.610 | 11 <sup>KM</sup> 600.148 | 11 <sup>KM</sup> 584.687 | 11 <sup>KM</sup> 569.227 | 11 <sup>KM</sup> 554.732 | 11 <sup>KM</sup> 540.237 | 11 <sup>KM</sup> 525.742 | 11 <sup>KM</sup> 511.248 | 11 <sup>KM</sup> 495.787 | 11 <sup>KM</sup> 480.325 | 11 <sup>KM</sup> 464.864 | 11 <sup>KM</sup> 449.403 | 11 <sup>KM</sup> 434.909 | 11 <sup>KM</sup> 419.448 |
| T 1               | 2 <sup>KM</sup> 609.662  | 2 <sup>KM</sup> 613.780  | 2 <sup>KM</sup> 617.898  | 2 <sup>KM</sup> 622.016  | 2 <sup>KM</sup> 625.876  | 2 <sup>KM</sup> 629.737  | 2 <sup>KM</sup> 633.597  | 2 <sup>KM</sup> 637.458  | 2 <sup>KM</sup> 641.576  | 2 <sup>KM</sup> 645.693  | 2 <sup>KM</sup> 649.811  | 2 <sup>KM</sup> 653.929  | 2 <sup>KM</sup> 657.789  | 2 <sup>KM</sup> 661.907  |
| U 2               | 11 <sup>KM</sup> 600.148 | 11 <sup>KM</sup> 584.687 | 11 <sup>KM</sup> 569.226 | 11 <sup>KM</sup> 554.732 | 11 <sup>KM</sup> 540.237 | 11 <sup>KM</sup> 525.742 | 11 <sup>KM</sup> 511.248 | 11 <sup>KM</sup> 495.787 | 11 <sup>KM</sup> 480.325 | 11 <sup>KM</sup> 464.864 | 11 <sup>KM</sup> 449.403 | 11 <sup>KM</sup> 434.909 | 11 <sup>KM</sup> 419.448 | 11 <sup>KM</sup> 405.919 |
| T 2               | 2 <sup>KM</sup> 613.780  | 2 <sup>KM</sup> 617.898  | 2 <sup>KM</sup> 622.016  | 2 <sup>KM</sup> 625.876  | 2 <sup>KM</sup> 629.737  | 2 <sup>KM</sup> 633.597  | 2 <sup>KM</sup> 637.458  | 2 <sup>KM</sup> 641.576  | 2 <sup>KM</sup> 645.693  | 2 <sup>KM</sup> 649.811  | 2 <sup>KM</sup> 653.929  | 2 <sup>KM</sup> 657.789  | 2 <sup>KM</sup> 661.907  | 2 <sup>KM</sup> 665.510  |
| L 1               | 16000                    | 16000                    | 16000                    | 15000                    | 15000                    | 15000                    | 15000                    | 16000                    | 16000                    | 16000                    | 16000                    | 15000                    | 16000                    | 14000                    |
| L 2               | 15980                    | 15980                    | 15980                    | 14980                    | 14980                    | 14980                    | 14980                    | 15980                    | 15980                    | 15980                    | 15980                    | 14980                    | 15980                    | 13980                    |
| L 3               | 15180                    | 15180                    | 15180                    | 14180                    | 14180                    | 14180                    | 14180                    | 15180                    | 15180                    | 15180                    | 15180                    | 14180                    | 15180                    | 13180                    |
| L 4               | 6490                     | 6490                     | 6490                     | 5990                     | 5990                     | 5990                     | 5990                     | 6490                     | 6490                     | 6490                     | 6490                     | 5990                     | 6490                     | 5490                     |
| θ 1               | 90° 00' 00" 00           | 90° 00' 00" 00           | 90° 00' 00" 00           | 90° 00' 00" 00           | 90° 00' 00" 00           | 90° 00' 00" 00           | 90° 00' 00" 00           | 90° 00' 00" 00           | 90° 00' 00" 00           | 90° 00' 00" 00           | 90° 00' 00" 00           | 90° 00' 00" 00           | 90° 00' 00" 00           | 90° 00' 00" 00           |
| θ 2               | "                        | "                        | "                        | "                        | "                        | "                        | "                        | "                        | "                        | "                        | "                        | "                        | "                        | "                        |

|                   | RC117                    | RC118                    | RC119                    | RC120                    |
|-------------------|--------------------------|--------------------------|--------------------------|--------------------------|
| STA (1)           | 19 <sup>KM</sup> 366.254 | 19 <sup>KM</sup> 382.254 | 19 <sup>KM</sup> 397.254 | 19 <sup>KM</sup> 412.254 |
| STA (2)           | 19 <sup>KM</sup> 382.254 | 19 <sup>KM</sup> 397.254 | 19 <sup>KM</sup> 412.254 | 19 <sup>KM</sup> 428.254 |
| AZIMUTH ANGLE (G) | 75° 05' 10" 71           | 75° 05' 10" 71           | 75° 05' 10" 71           | 75° 05' 10" 71           |
| DO                | "                        | "                        | "                        | "                        |
| U 1               | 11 <sup>KM</sup> 405.919 | 11 <sup>KM</sup> 390.458 | 11 <sup>KM</sup> 375.964 | 11 <sup>KM</sup> 361.469 |
| T 1               | 2 <sup>KM</sup> 665.510  | 2 <sup>KM</sup> 669.628  | 2 <sup>KM</sup> 673.749  | 2 <sup>KM</sup> 677.349  |
| U 2               | 11 <sup>KM</sup> 390.458 | 11 <sup>KM</sup> 375.964 | 11 <sup>KM</sup> 361.469 | 11 <sup>KM</sup> 346.008 |
| T 2               | 2 <sup>KM</sup> 669.628  | 2 <sup>KM</sup> 673.749  | 2 <sup>KM</sup> 677.349  | 2 <sup>KM</sup> 681.467  |
| L 1               | 16000                    | 15000                    | 15000                    | 16000                    |
| L 2               | 15980                    | 14980                    | 14980                    | 15980                    |
| L 3               | 15180                    | 14180                    | 14180                    | 15180                    |
| L 4               | 6490                     | 5990                     | 5990                     | 6490                     |
| θ 1               | 90° 00' 00" 00           | 90° 00' 00" 00           | 90° 00' 00" 00           | 90° 00' 00" 00           |
| θ 2               | "                        | "                        | "                        | "                        |


NOTES :

1. ALL DIMENSIONS ARE SHOWN IN MILLIMETERS UNLESS OTHERWISE INDICATED
2. REFERENCE DRAWING FOR GENERAL VIEW : CS-276.

|   |                    |          |       |         |           |
|---|--------------------|----------|-------|---------|-----------|
| REPUBLIC OF INDONESIA<br>MINISTRY OF COMMUNICATIONS<br>DIRECTORATE GENERAL OF LAND TRANSPORT AND INLAND WATERWAYS |                    |          |       |         |           |
| NEW RAILWAY LINE FOR CENGKARENG AIRPORT<br>CONSTRUCTION PROJECT   |                    |          |       |         |           |
| JAPAN INTERNATIONAL COOPERATION AGENCY<br>(JICA)  |                    |          |       |         |           |
| B   | 1AUG.84            | M.S      | M.Y   | K.S     | K.M       |
| A   | 15FEB.84           | M.S      | M.Y   | K.S     | K.M       |
| REVISIONS   | DATE               | DESIGNED | DRAWN | CHECKED | SUBMITTED |
| R.C. GIRDER<br>RC103~RC120<br>GENERAL VIEW<br>(SHEET 2 OF 2)  |                    |          |       |         |           |
| PACKAGE: I CIVIL AND ARCHITECTURAL WORK   |                    |          |       |         |           |
| SCALE   | DRAWING NO. CS-277 |          |       |         |           |

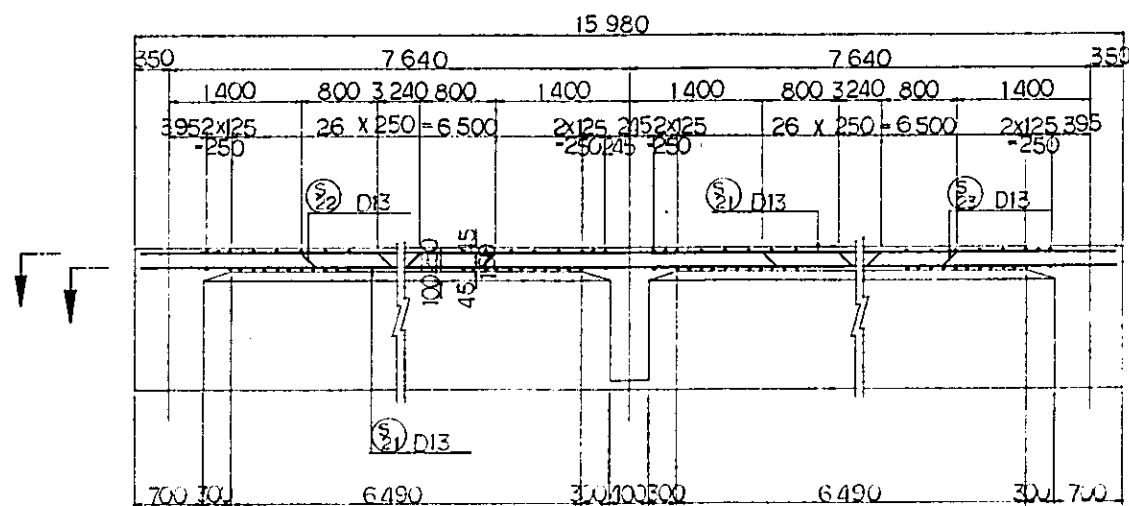


SECTION C

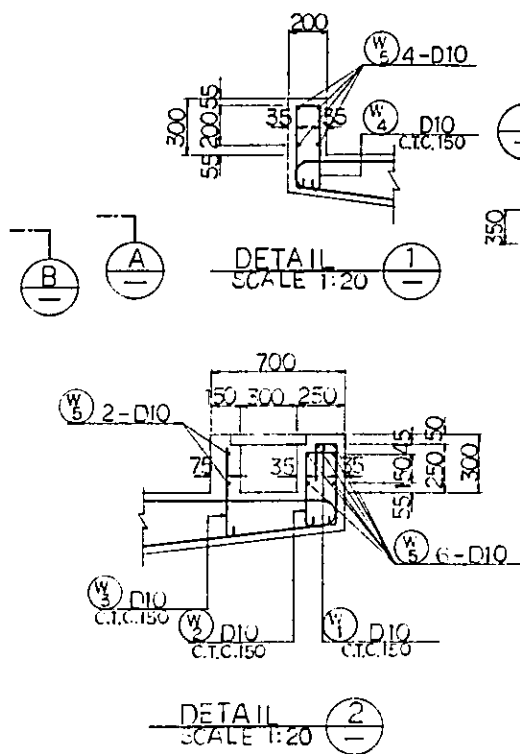


DETAIL 1  
SCALE 1:20


DETAIL 2  
SCALE 1:20

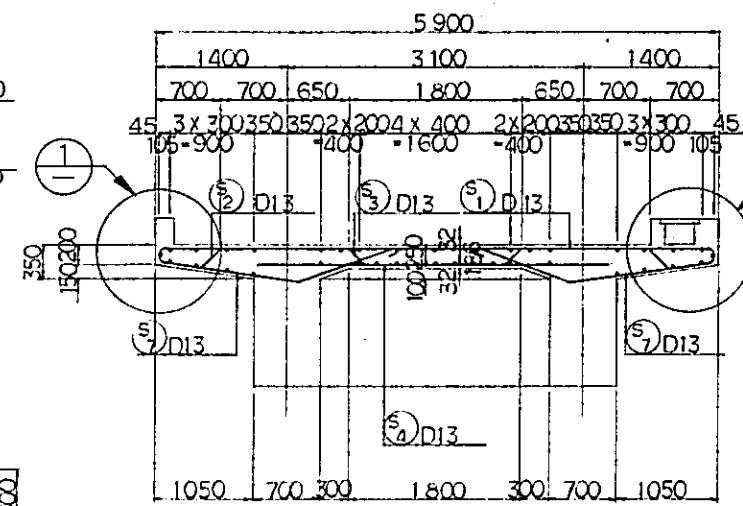

SECTION D

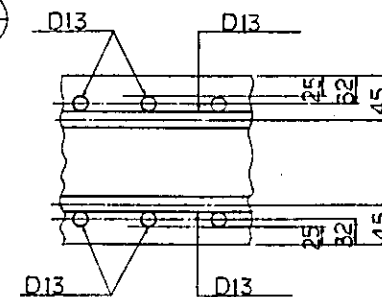


CONCRETE COVER

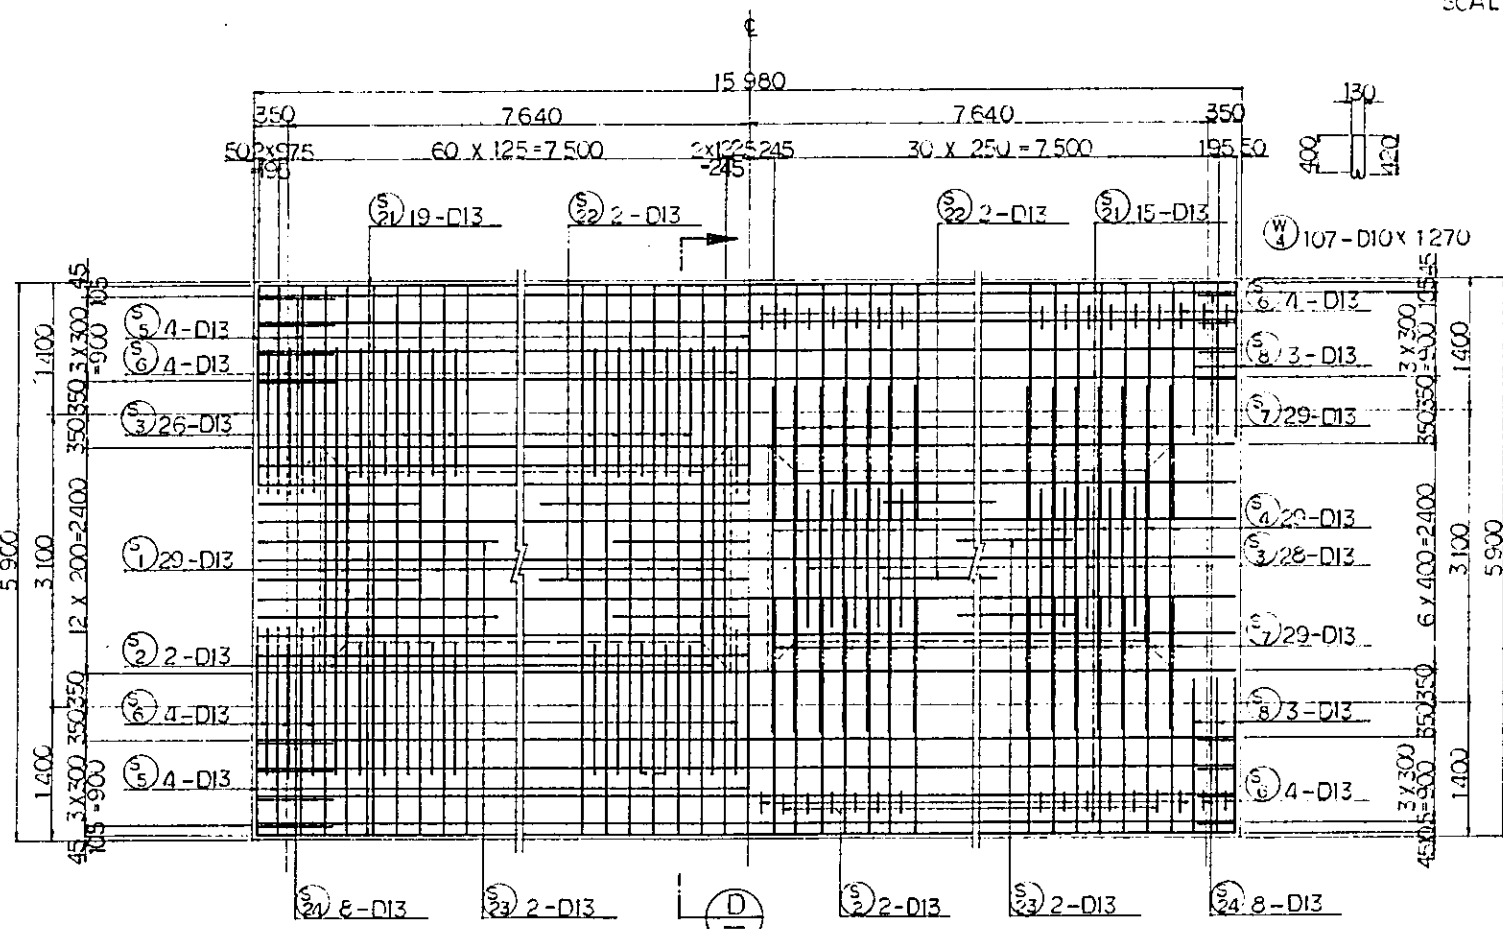

SECTION A









SECTION B

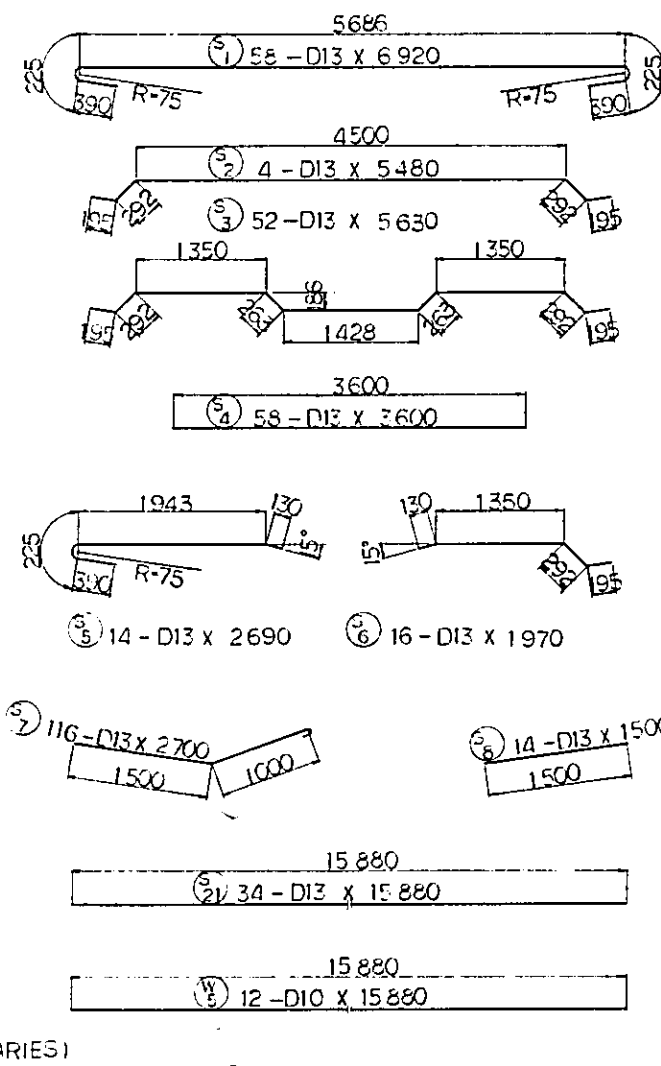





NOTES :

1. ALL DIMENSIONS ARE SHOWN IN MILLIMETERS UNLESS OTHERWISE INDICATED
2. REFERENCE DRAWING FOR GENERAL VIEW : CS-276.


|   |            |                    |       |         |          |           |
|---|------------|--------------------|-------|---------|----------|-----------|
| REPUBLIC OF INDONESIA<br>MINISTRY OF COMMUNICATIONS<br>DIRECTORATE GENERAL OF LAND TRANSPORT AND INLAND WATERWAYS |            |                    |       |         |          |           |
| NEW RAILWAY LINE FOR CENGKARENG AIRPORT<br>CONSTRUCTION PROJECT   |            |                    |       |         |          |           |
| JAPAN INTERNATIONAL COOPERATION AGENCY<br>(JICA)  |            |                    |       |         |          |           |
| B   | 1 AUG. 84  | M.S.               | M.Y.  | K.A.    | U.M.     | M.K.      |
| A   | 15 FEB. 84 | M.S.               | M.Y.  | K.A.    | K.M.     | M.K.      |
| REVISIONS   | DATE       | DESIGNED           | DRAWN | CHECKED | REVIEWED | SUBMITTED |
| R.C. GIRDER RC103<br>BAR ARRANGEMENT<br>(SHEET 1 OF 3)  |            |                    |       |         |          |           |
| PACKAGE: I CIVIL AND ARCHITECTURAL WORK   |            |                    |       |         |          |           |
| SCALE: 1:40,20  |            | DRAWING NO: CS-278 |       |         |          |           |

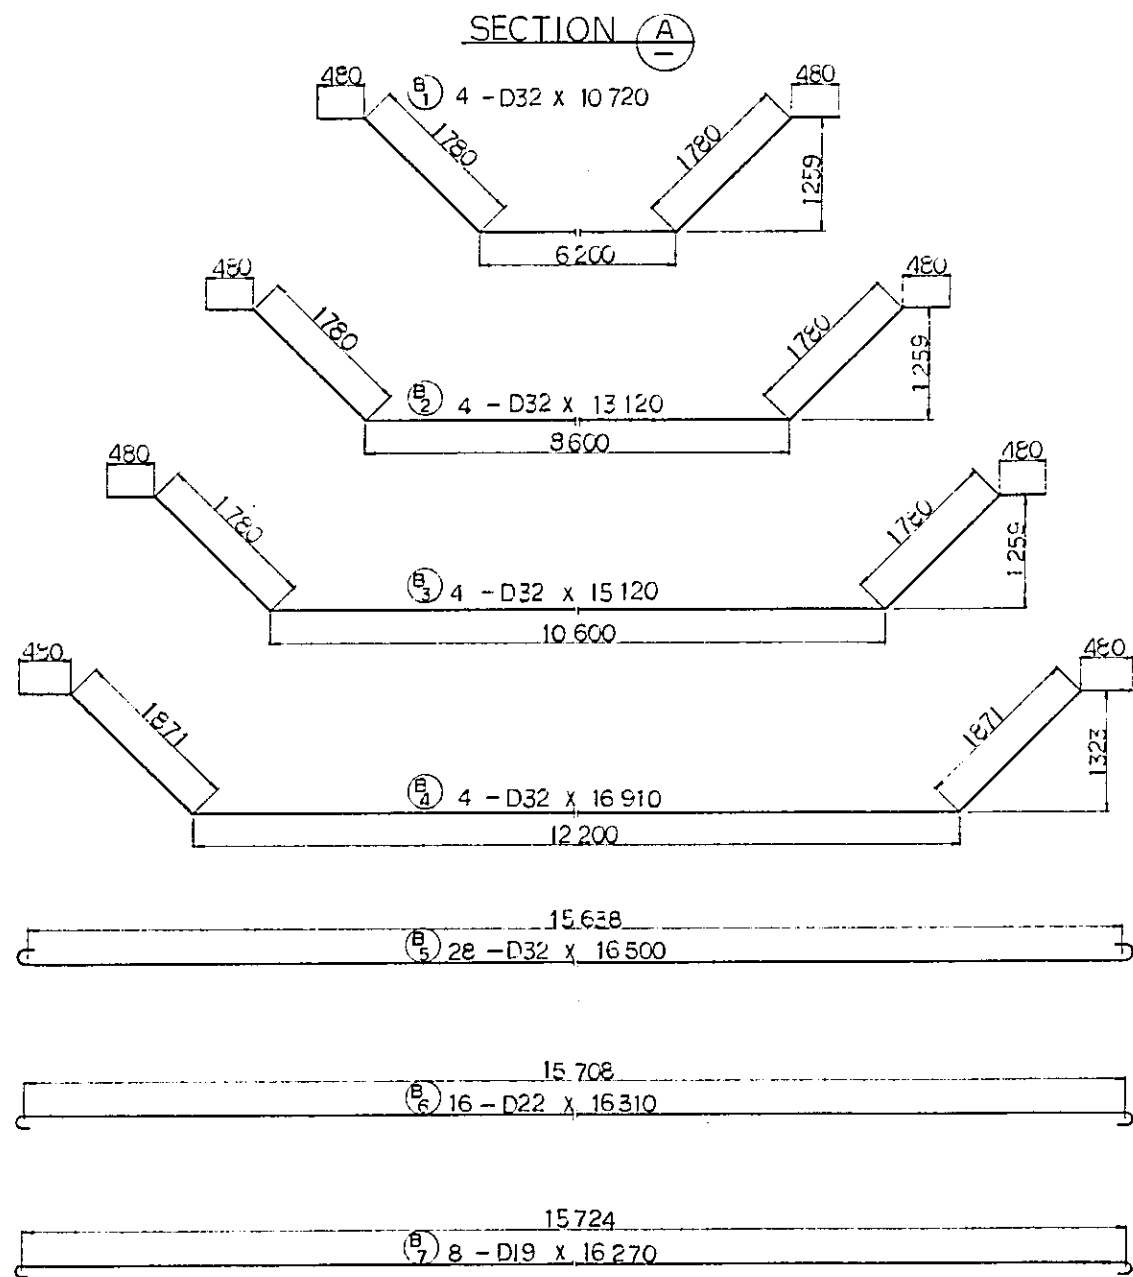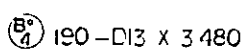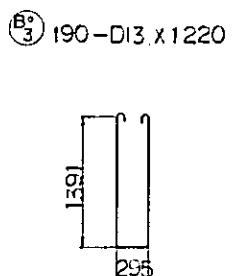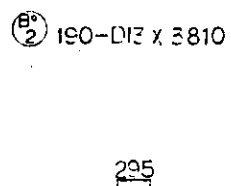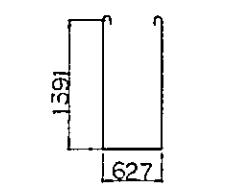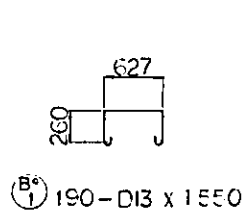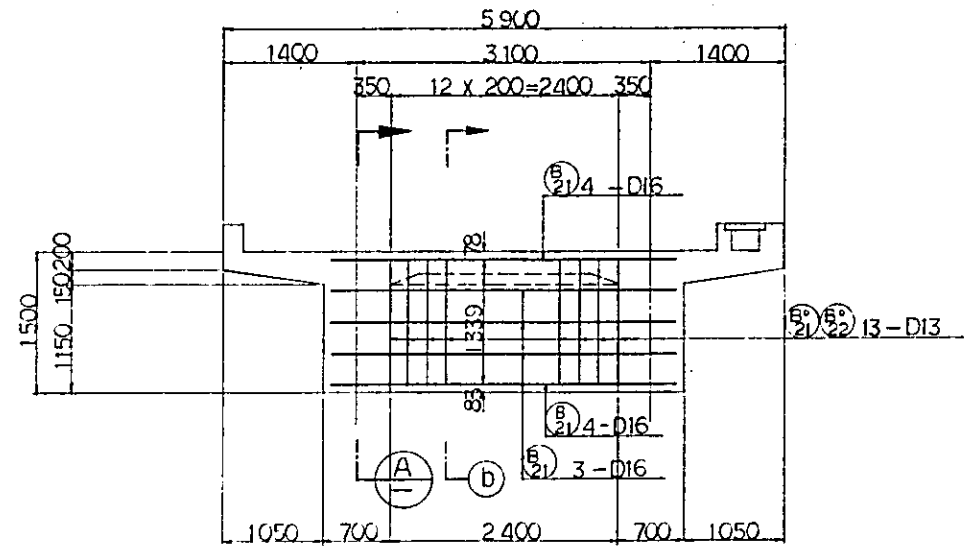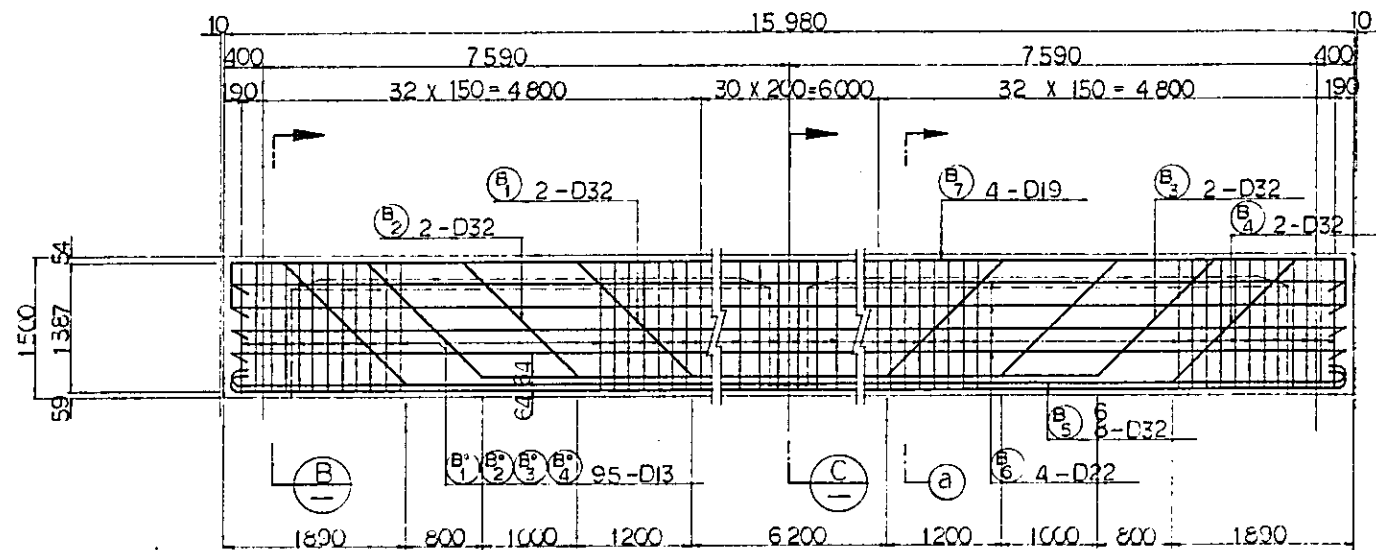

SECTION B-B

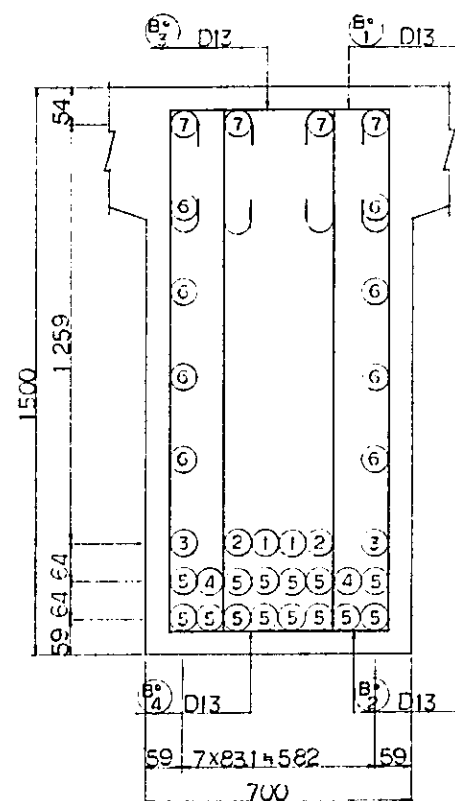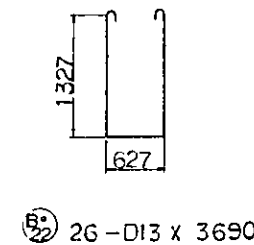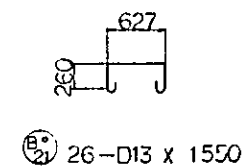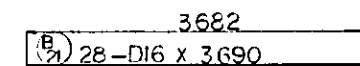

SECTION (a) - (a)

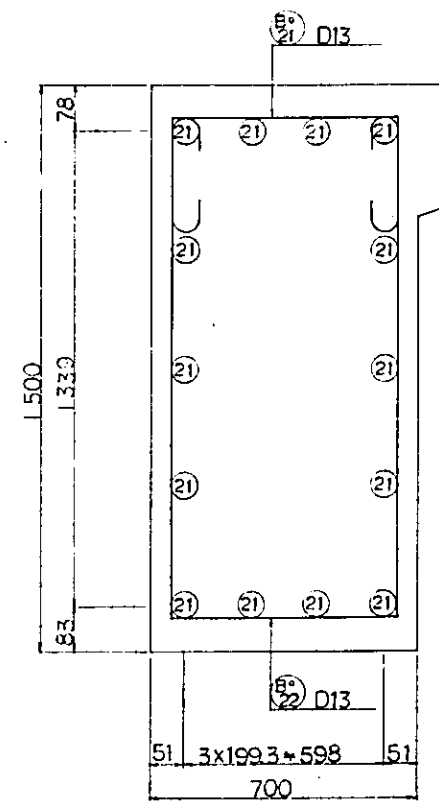


SECTION (b) - (b)


NOTES

- ALL DIMENSIONS ARE SHOWN IN MILLIMETERS UNLESS OTHERWISE INDICATED
- REFERENCE DRAWING FOR GENERAL VIEW: CS-276.

|  |          |          |             |         |          |           |
|--|----------|----------|-------------|---------|----------|-----------|
| REPUBLIC OF INDONESIA<br>MINISTRY OF COMMUNICATIONS<br>DIRECTORATE GENERAL OF LAND TRANSPORT<br>AND INLAND WATERWAYS |          |          |             |         |          |           |
| NEW RAILWAY LINE FOR CENKARENG AIRPORT<br>CONSTRUCTION PROJECT   |          |          |             |         |          |           |
| JAPAN INTERNATIONAL COOPERATION AGENCY<br>(JICA)   |          |          |             |         |          |           |
| B  | 1AUG/84  | H.S.     | M.Y.        | K.A.    | K.M.     | K.K.      |
| A  | 15FEB/84 | H.S.     | M.Y.        | K.A.    | K.M.     | K.K.      |
| REVISIONS  | DATE     | DESIGNED | DRAWN       | CHECKED | REVIEWED | SUBMITTED |
| R.C. GIRDER RC103<br>BAR ARRANGEMENT<br>(SHEET 2 OF 3)   |          |          |             |         |          |           |
| PACKAGE: I CIVIL AND ARCHITECTURAL WORK  |          |          |             |         |          |           |
| SCALE  | 1:40     |          | DRAWING NO. |         | CS-279   |           |

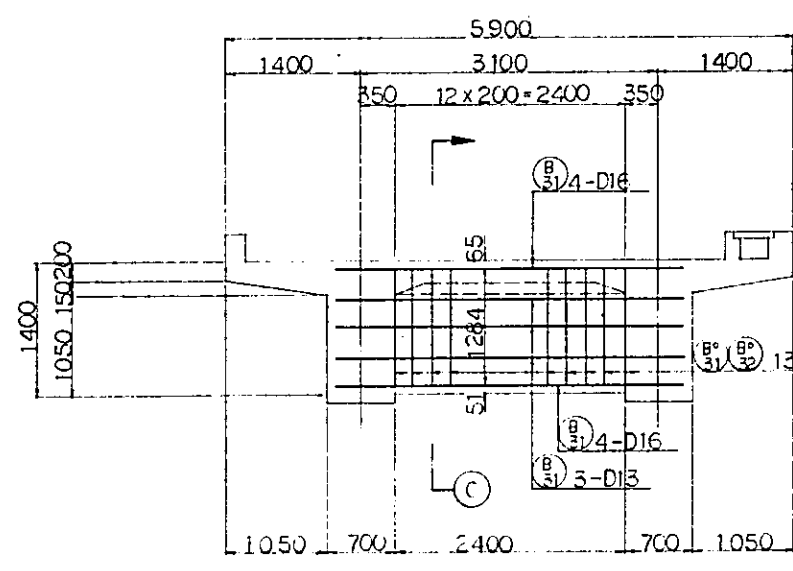


SECTION C-C

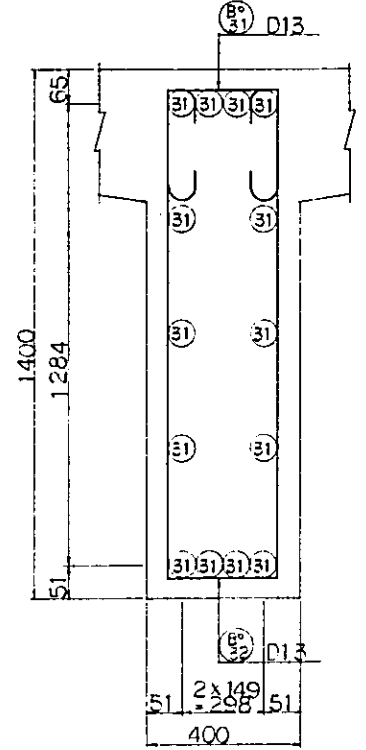


(B) 13 - D13 x 1 250


(B) 14 - D16 x 3 682

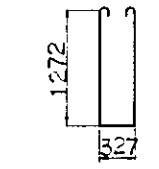


(B) 13 - D13 x 3 280

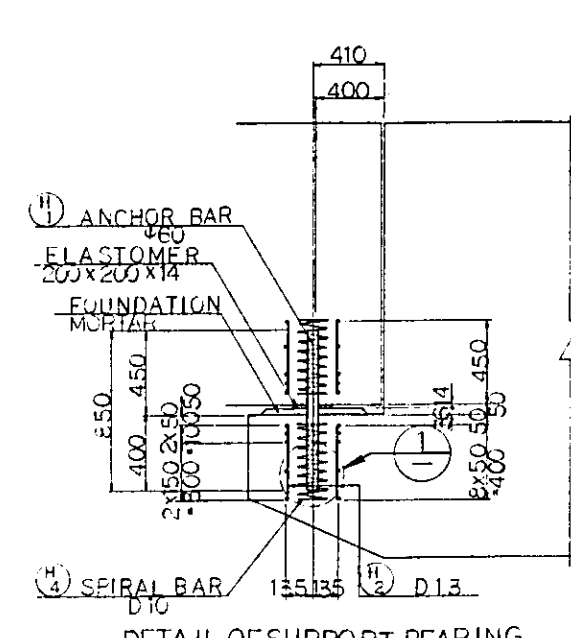

DETAIL OF SUPPORT BEARING SCALE 1:20

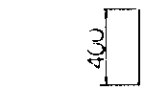


(H) 24 - D13 x 400

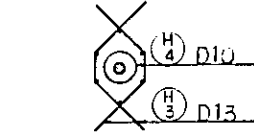


DETAIL 1 SCALE 1:20


FIXED END

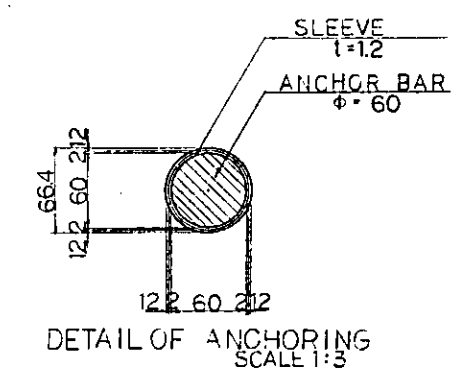


DETAIL OF ANCHORING SCALE 1:3

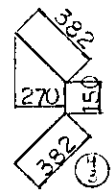


(H) 40 - D13 x 920

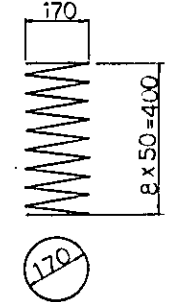


(H) 4 - D10 x 5 370  
DETAIL OF SPIRAL BAR SCALE 1:10

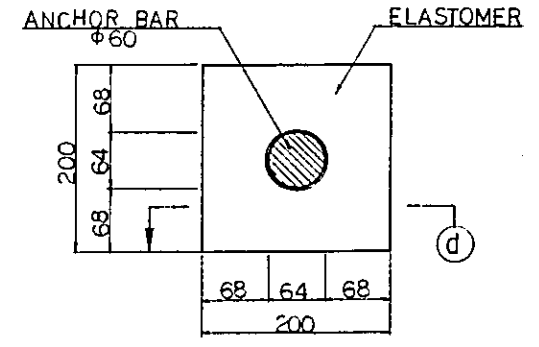

DETAIL OF DECK PAD SCALE 1:4

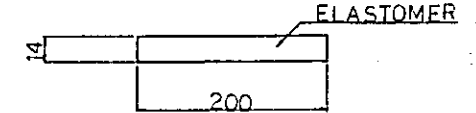


SECTION (d) - (d)

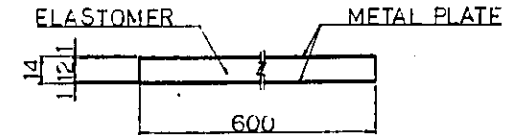


DETAIL OF BEARING PAD SCALE 1:2

- NOTES :
- ALL DIMENSIONS ARE SHOWN IN MILLIMETERS UNLESS OTHERWISE INDICATED
  - REFERENCE DRAWING FOR GENERAL VIEW : CS-276.

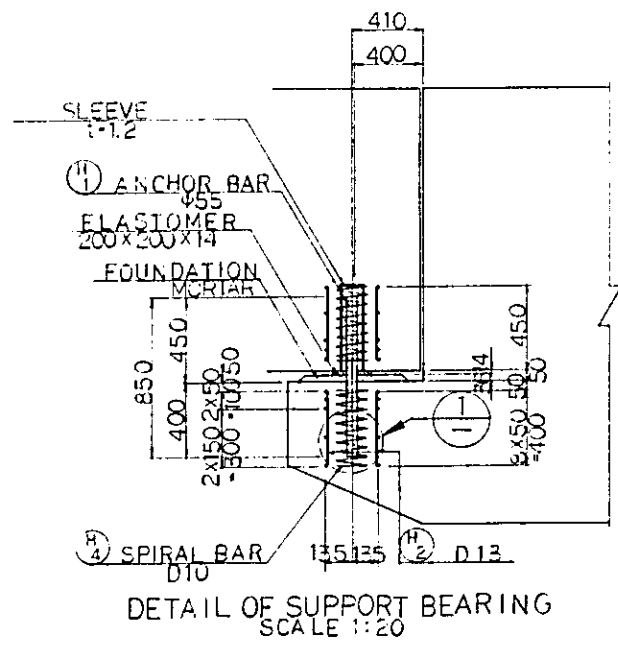


DETAIL OF SUPPORT BEARING SCALE 1:20


MOVABLE SHOE

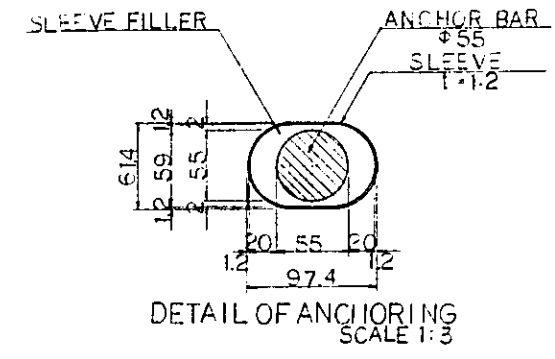


DETAIL OF ANCHORING SCALE 1:3

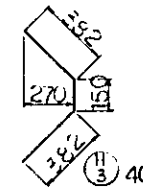


(H) 3 - 40 - D13 x 920

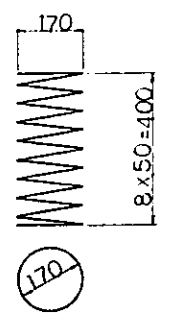


(H) 4 - D10 x 5 370  
DETAIL OF SPIRAL BAR SCALE 1:10

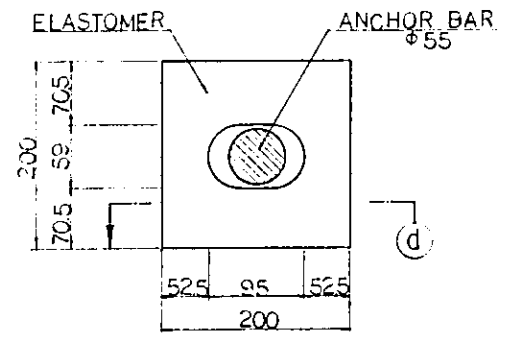

DETAIL OF DECK PAD SCALE 1:4

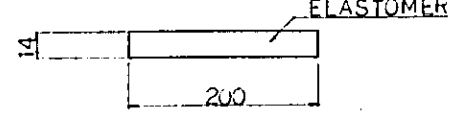


SECTION (d) - (d)

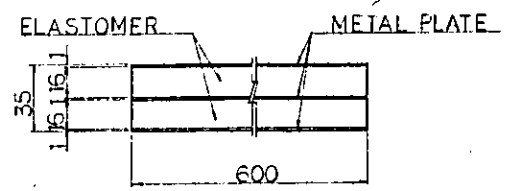


DETAIL OF BEARING PAD SCALE 1:2


|  |            |                    |       |         |          |           |
|--|------------|--------------------|-------|---------|----------|-----------|
| REPUBLIC OF INDONESIA<br>MINISTRY OF COMMUNICATIONS<br>DIRECTORATE GENERAL OF LAND TRANSPORT<br>AND INLAND WATERWAYS |            |                    |       |         |          |           |
| NEW RAILWAY LINE FOR CENGKARENG AIRPORT<br>CONSTRUCTION PROJECT  |            |                    |       |         |          |           |
| JAPAN INTERNATIONAL COOPERATION AGENCY<br>(JICA)   |            |                    |       |         |          |           |
| B  | 1 AUG '84  | M.S.M.Y.           | K.A.  | K.M.    | M.K.     |           |
| A  | 15 FEB '84 | M.S.               | M.Y.  | K.A.    | K.M.     | M.K.      |
| REVISIONS  | DATE       | DESIGNED           | DRAWN | CHECKED | REVIEWED | SUBMITTED |
| R.C. GIRDER RC103<br>BAR ARRANGEMENT<br>(SHEET 3 OF 3)   |            |                    |       |         |          |           |
| PACKAGE : I. CIVIL AND ARCHITECTURAL WORK.   |            |                    |       |         |          |           |
| SCALE AS NOTED   |            | DRAWING NO. CS-280 |       |         |          |           |

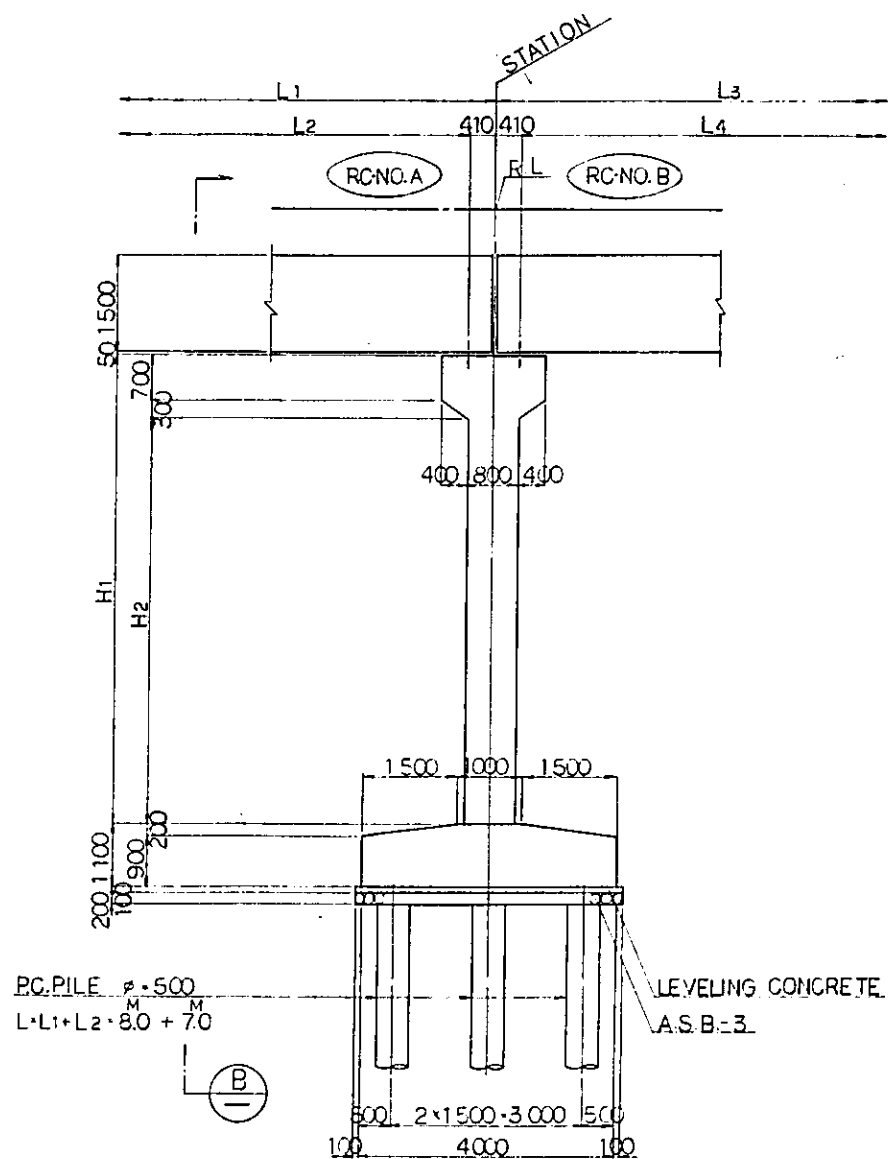


SECTION A-A

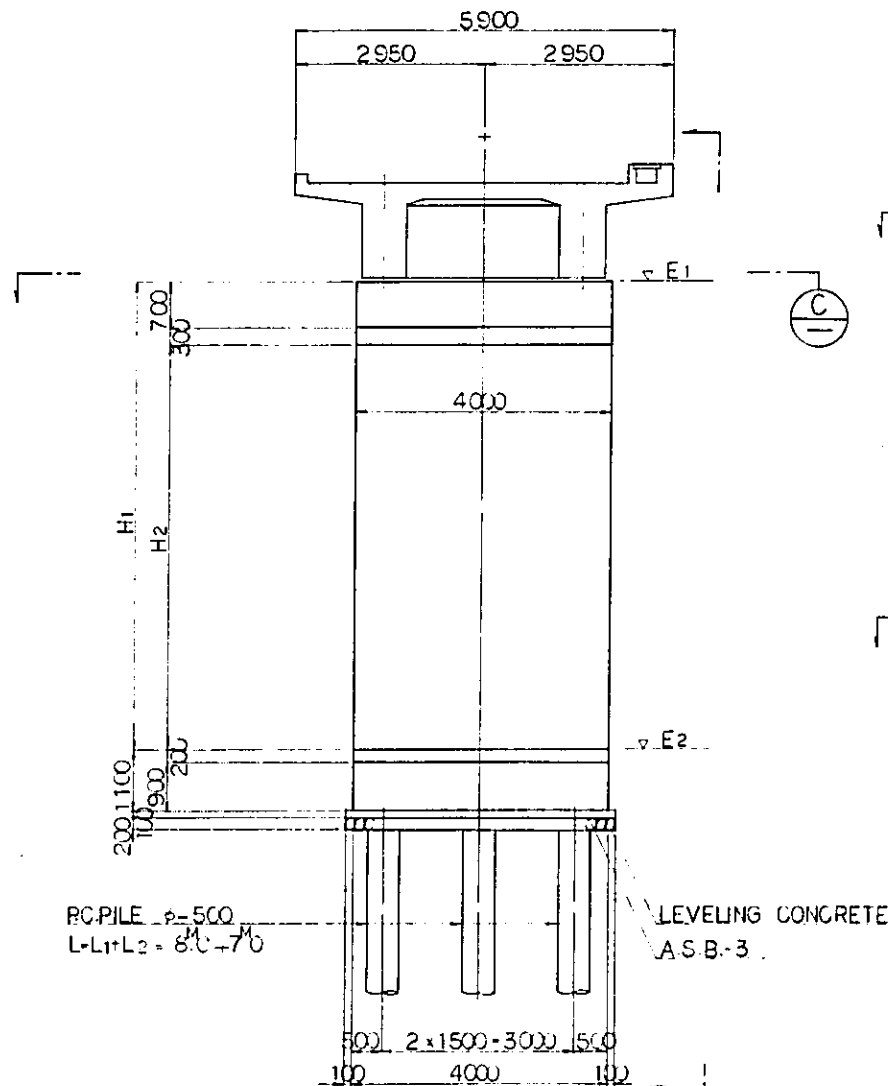


SECTION B-B

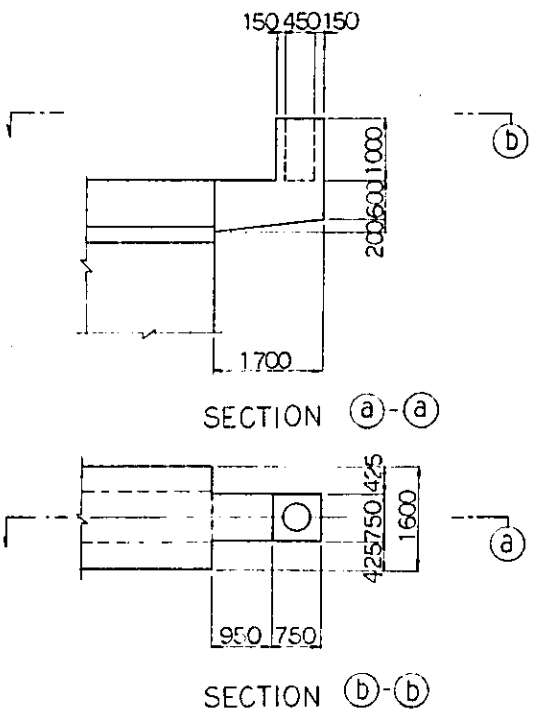

BEAM OF CATENARY POLE  
FOR P-104, P-106, P-108, P-111  
P-114, P-117 ONLY

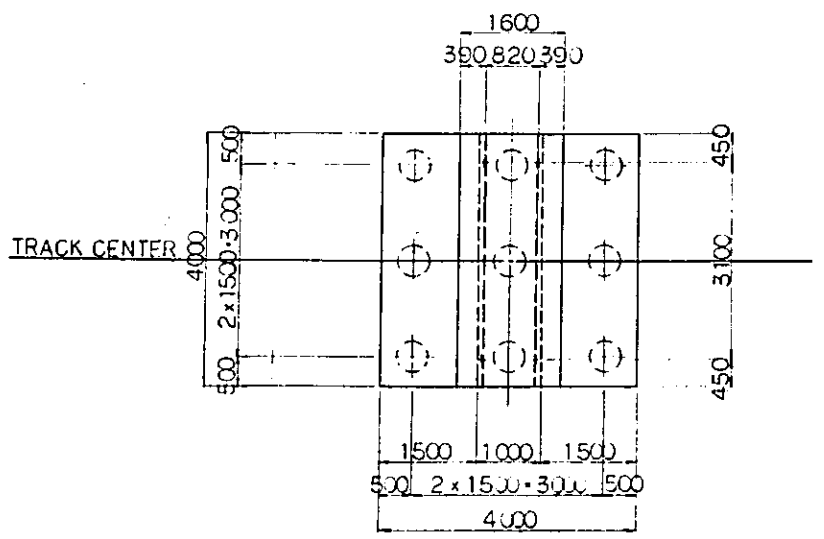

SECTION C-C

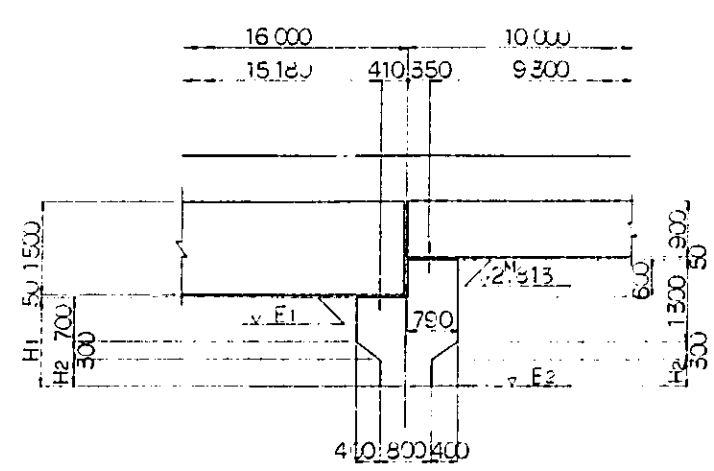

BEAM OF P-120

DIMENSION SCHEDULE

| PIER NO | STATION              | RC-NO.A | RC-NO.B | R.L.   | E1    | E2    | L1     | L2     | L3     | L4     | H1   | H2   |
|---------|----------------------|---------|---------|--------|-------|-------|--------|--------|--------|--------|------|------|
| P101    | 193 <sup>M</sup> 253 | 101     | 102     | 10.554 | 8.294 | 0.894 | 16.023 | 15.203 | 16.001 | 15.181 | 7400 | 6400 |
| P102    | 149 <sup>M</sup> 254 | 102     | 103     | 10.553 | 8.293 | 0.893 | 16.001 | 15.181 | 16.000 | 15.180 | 7400 | 6400 |
| P103    | 165 <sup>M</sup> 254 | 103     | 104     | 10.498 | 8.238 | 0.838 | 16.000 | 15.180 | -      | -      | 7400 | 6400 |
| P104    | 181 <sup>M</sup> 254 | 104     | 105     | 10.358 | 8.098 | 0.898 | -      | -      | -      | -      | 7200 | 6200 |
| P105    | 197 <sup>M</sup> 254 | 105     | 106     | 10.137 | 7.877 | 0.877 | -      | -      | 15.000 | 14.180 | 7000 | 6000 |
| P106    | 212 <sup>M</sup> 254 | 106     | 107     | 9.853  | 7.593 | 0.893 | 15.000 | 14.180 | -      | -      | 6700 | 5700 |
| P107    | 227 <sup>M</sup> 254 | 107     | 108     | 9.498  | 7.238 | 0.838 | -      | -      | -      | -      | 6400 | 5400 |
| P108    | 242 <sup>M</sup> 254 | 108     | 109     | 9.123  | 6.863 | 0.863 | -      | -      | -      | -      | 6000 | 5000 |
| P109    | 257 <sup>M</sup> 254 | 109     | 110     | 8.748  | 6.488 | 0.888 | -      | -      | 16.000 | 15.180 | 5600 | 4600 |
| P110    | 273 <sup>M</sup> 254 | 110     | 111     | 8.348  | 6.088 | 0.888 | 16.000 | 15.180 | -      | -      | 5200 | 4200 |
| P111    | 289 <sup>M</sup> 254 | 111     | 112     | 7.948  | 5.688 | 0.888 | -      | -      | -      | -      | 4800 | 3800 |
| P112    | 305 <sup>M</sup> 254 | 112     | 113     | 7.548  | 5.288 | 0.888 | -      | -      | -      | -      | 4400 | 3400 |
| P113    | 321 <sup>M</sup> 254 | 113     | 114     | 7.148  | 4.888 | 0.888 | -      | -      | 15.000 | 14.180 | 4000 | 3000 |
| P114    | 336 <sup>M</sup> 254 | 114     | 115     | 6.773  | 4.513 | 0.813 | 15.000 | 14.180 | 16.000 | 15.180 | 3700 | 2700 |
| P115    | 352 <sup>M</sup> 254 | 115     | 116     | 6.373  | 4.113 | 0.813 | 16.000 | 15.180 | 14.000 | 13.180 | 3300 | 2300 |
| P116    | 366 <sup>M</sup> 254 | 116     | 117     | 6.023  | 3.763 | 0.863 | 14.000 | 13.180 | 16.000 | 15.180 | 2900 | 1900 |
| P117    | 382 <sup>M</sup> 254 | 117     | 118     | 5.623  | 3.363 | 0.863 | 16.000 | 15.180 | 15.000 | 14.180 | 2500 | 1500 |
| P118    | 397 <sup>M</sup> 254 | 118     | 119     | 5.248  | 2.988 | 0.888 | 15.000 | 14.180 | -      | -      | 2100 | 1100 |
| P119    | 412 <sup>M</sup> 254 | 119     | 120     | 4.873  | 2.613 | 0.813 | -      | -      | 16.000 | 15.180 | 1800 | 800  |
| P120    | 428 <sup>M</sup> 254 | 120     | 121     | 4.473  | 2.213 | 0.813 | 16.000 | 15.180 | 10.000 | 9.300  | 1400 | 400  |

GENERAL VIEW OF P-101 ~ P-120 SCALE 1:60

- NOTES:
- ALL DIMENSIONS ARE SHOWN MILLIMETERS UNLESS OTHERWISE INDICATED
  - REFERENCE DRAWING FOR BAR ARRANGEMENT: CS282.03.283
  - TYPES OF PC PILE
    - PC PILE CLASS B
    - PC PILE CLASS A

REPUBLIC OF INDONESIA  
MINISTRY OF COMMUNICATIONS  
DIRECTORATE GENERAL OF LAND TRANSPORT AND INLAND WATERWAYS






NEW RAILWAY LINE FOR GENGKARANG AIRPORT CONSTRUCTION PROJECT

JAPAN INTERNATIONAL COOPERATION AGENCY (JICA)

|   |           |          |      |      |      |
|---|-----------|----------|------|------|------|
| B | 1 AUG '84 | S.S.M.Y. | K.R. | K.M. | M.K. |
| A | 1 FEB '84 | S.S.M.Y. | K.R. | K.M. | M.K. |

PIER P101~P120  
GENERAL VIEW









PACKAGE: I CIVIL AND ARCHITECTURAL WORK  
SCALE: 1:60  
DRAWING NO: CS-281

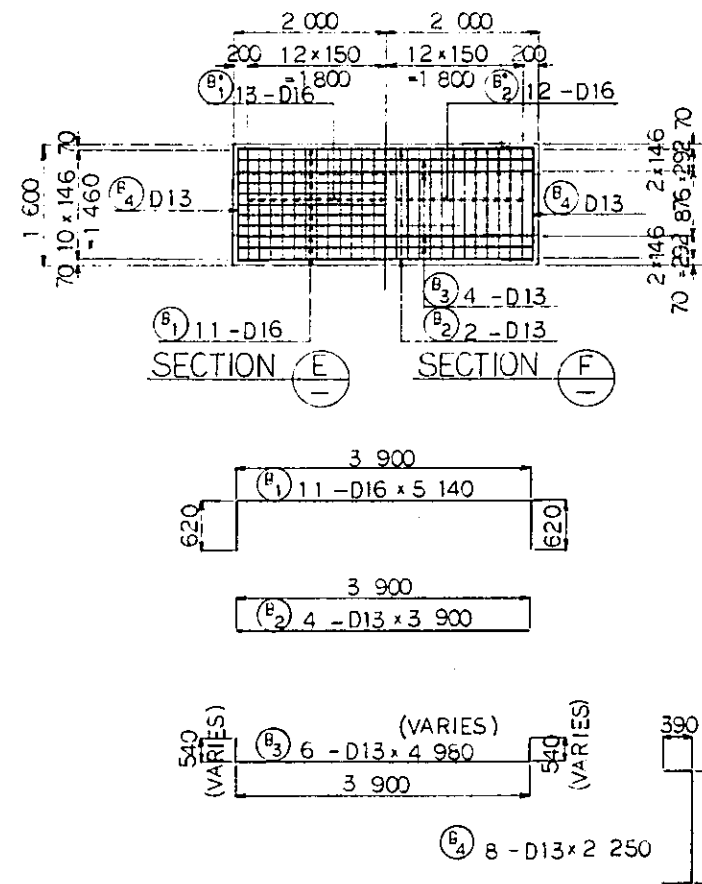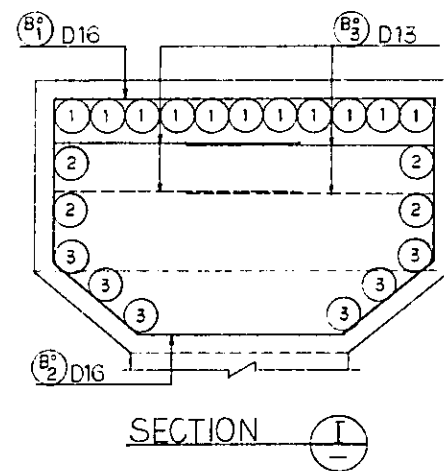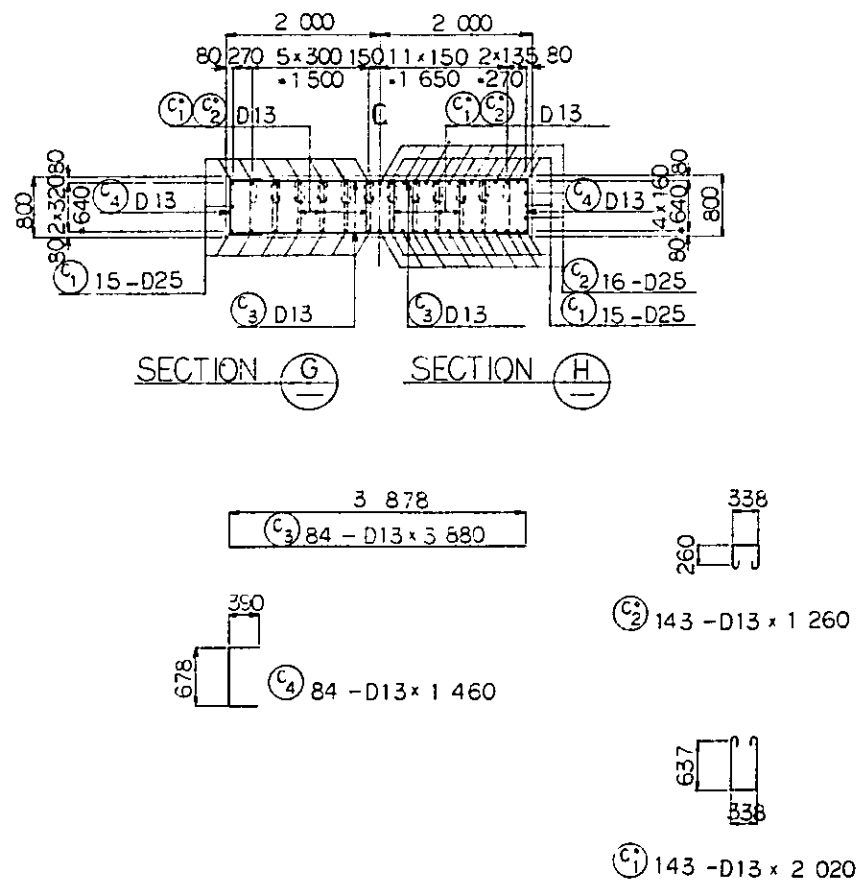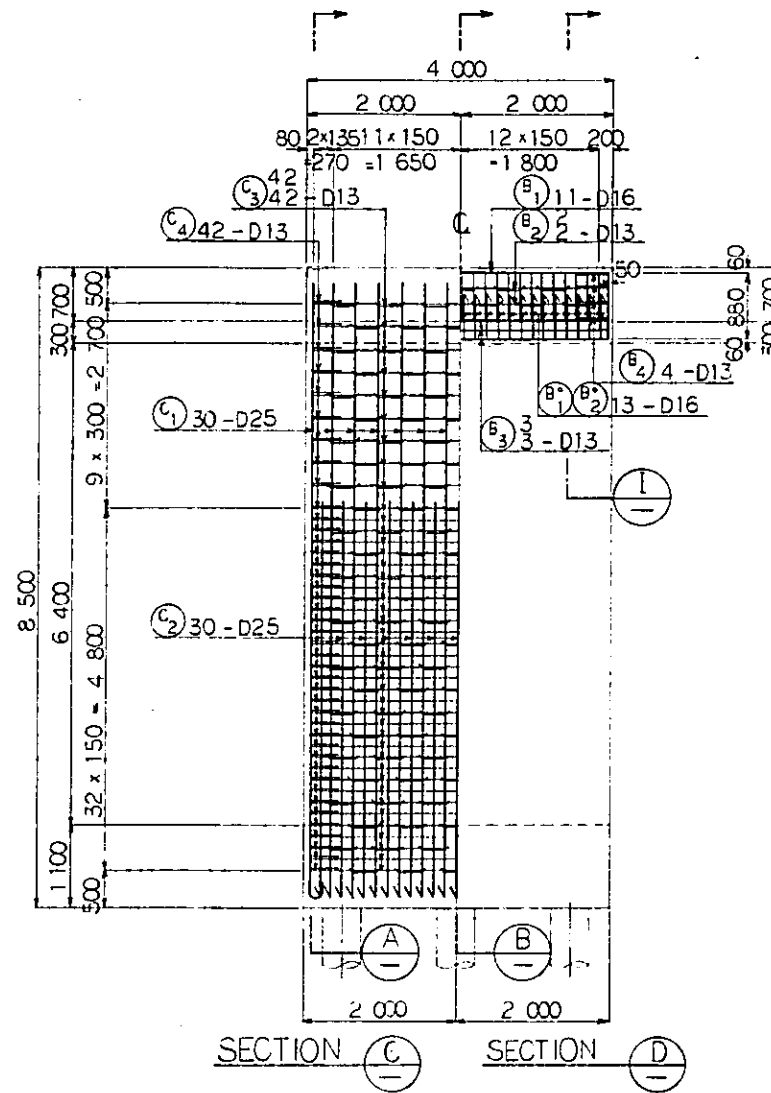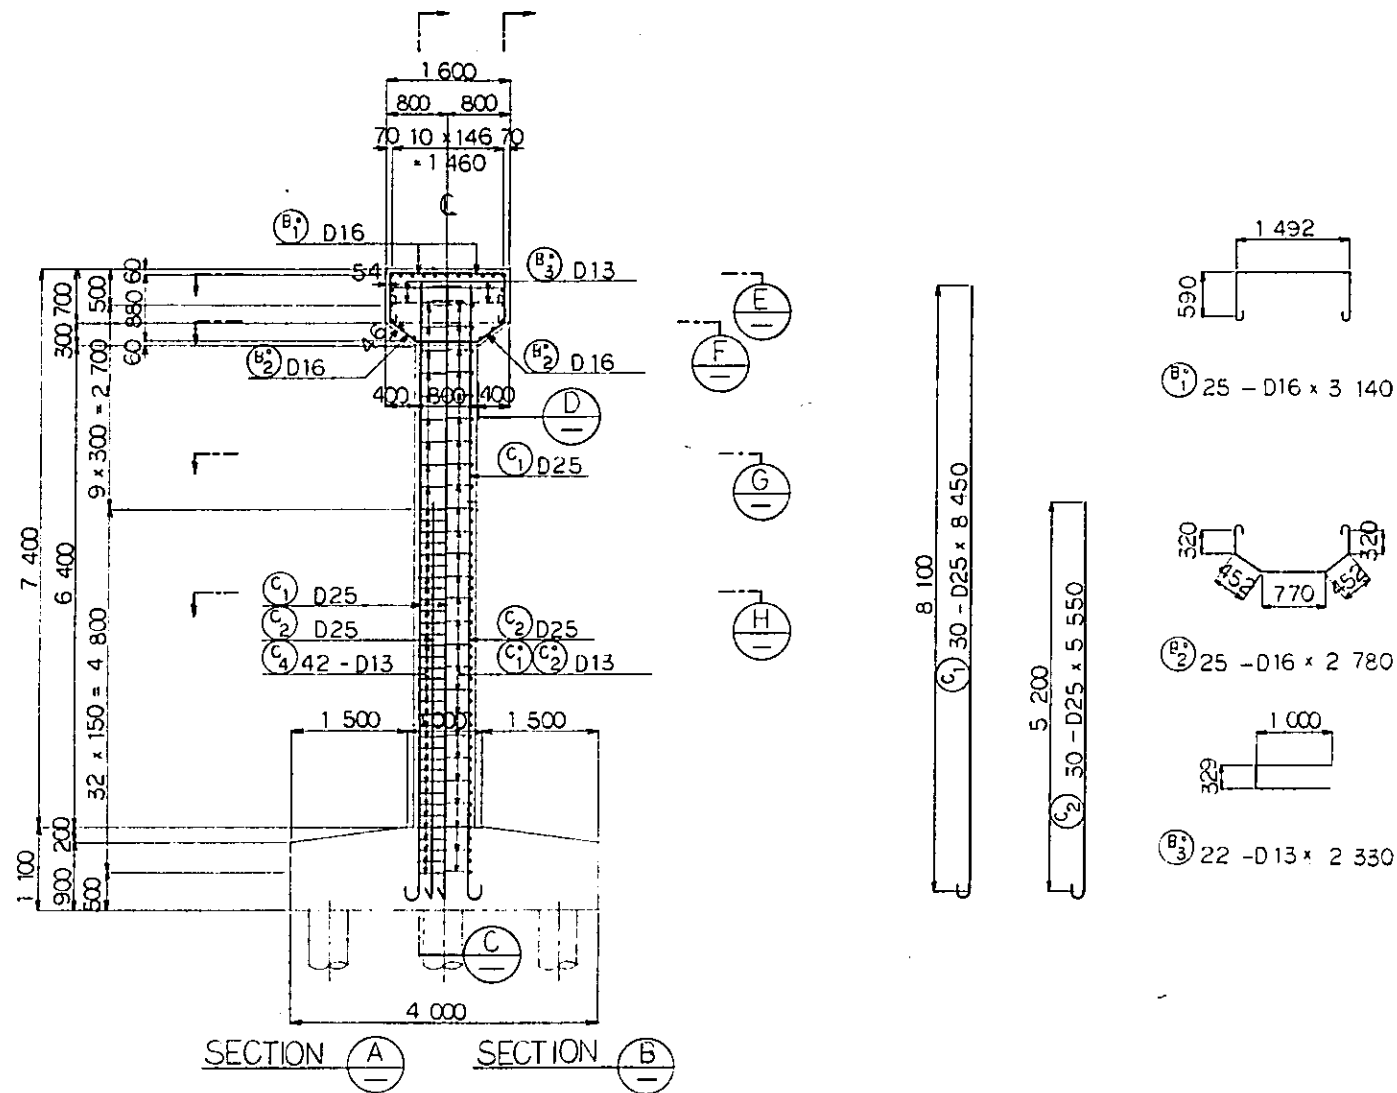





NOTES:  
 1 ALL DIMENSIONS ARE SHOWN IN MILLIMETERS UNLESS OTHERWISE INDICATED  
 2 REFERENCE DRAWING FOR GENERAL VIEW : CS281.

|   |          |                    |       |         |          |          |
|---|----------|--------------------|-------|---------|----------|----------|
| REPUBLIC OF INDONESIA<br>MINISTRY OF COMMUNICATIONS<br>DIRECTORATE GENERAL OF LAND TRANSPORT AND INLAND WATERWAYS |          |                    |       |         |          |          |
| NEW RAILWAY LINE FOR CENGKARENG AIRPORT<br>CONSTRUCTION PROJECT   |          |                    |       |         |          |          |
| JAPAN INTERNATIONAL COOPERATION AGENCY<br>(JICA)  |          |                    |       |         |          |          |
| B   | 1AUG.84  | S.S                | M.Y   | K.A     | K.M      | M.K      |
| A   | 15FEB.84 | S.S                | M.Y   | K.A     | K.M      | M.K      |
| REVISIONS   | DATE     | DESIGNED           | DRAWN | CHECKED | REVIEWED | APPROVED |
| PIER P101<br>BAR ARRANGEMENT<br>(SHEET 1 OF 2)  |          |                    |       |         |          |          |
| PACKAGE: I CIVIL AND ARCHITECTURAL WORK   |          |                    |       |         |          |          |
| SCALE: 1:50   |          | DRAWING NO: CS-282 |       |         |          |          |



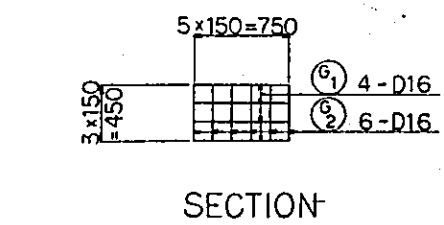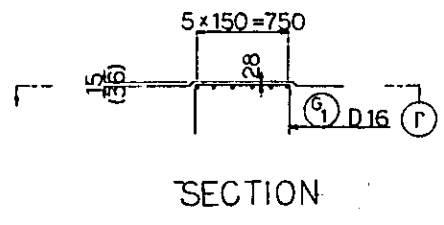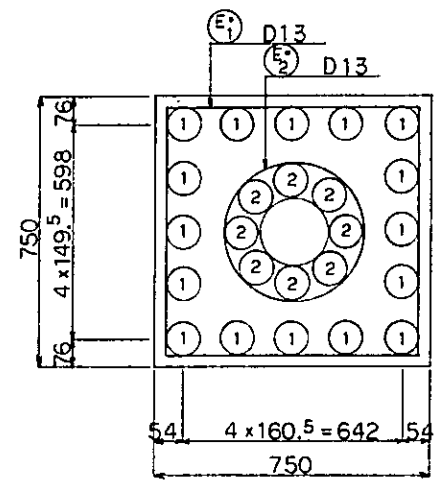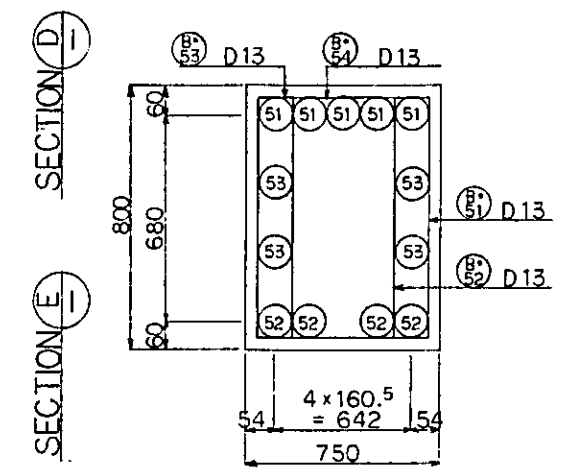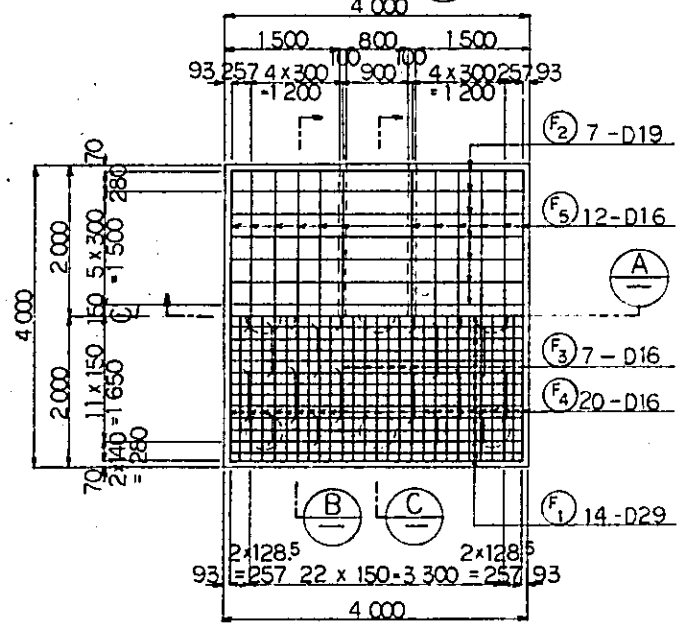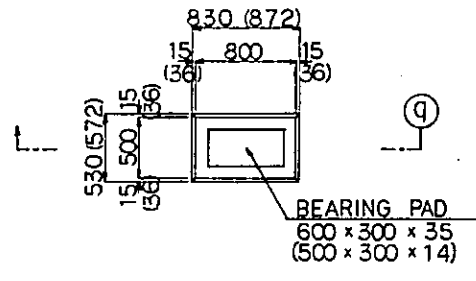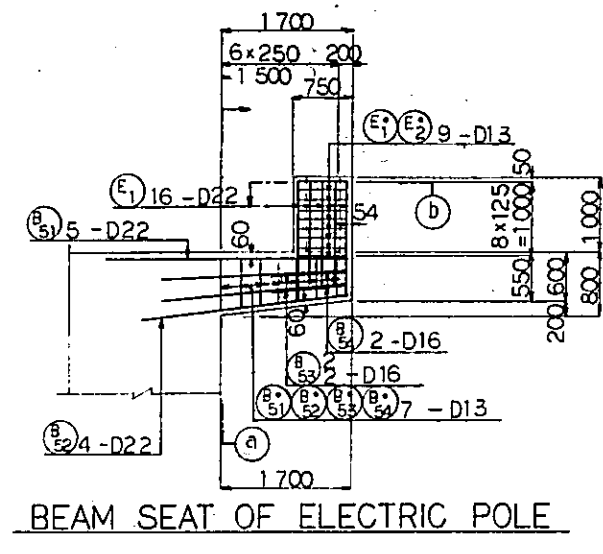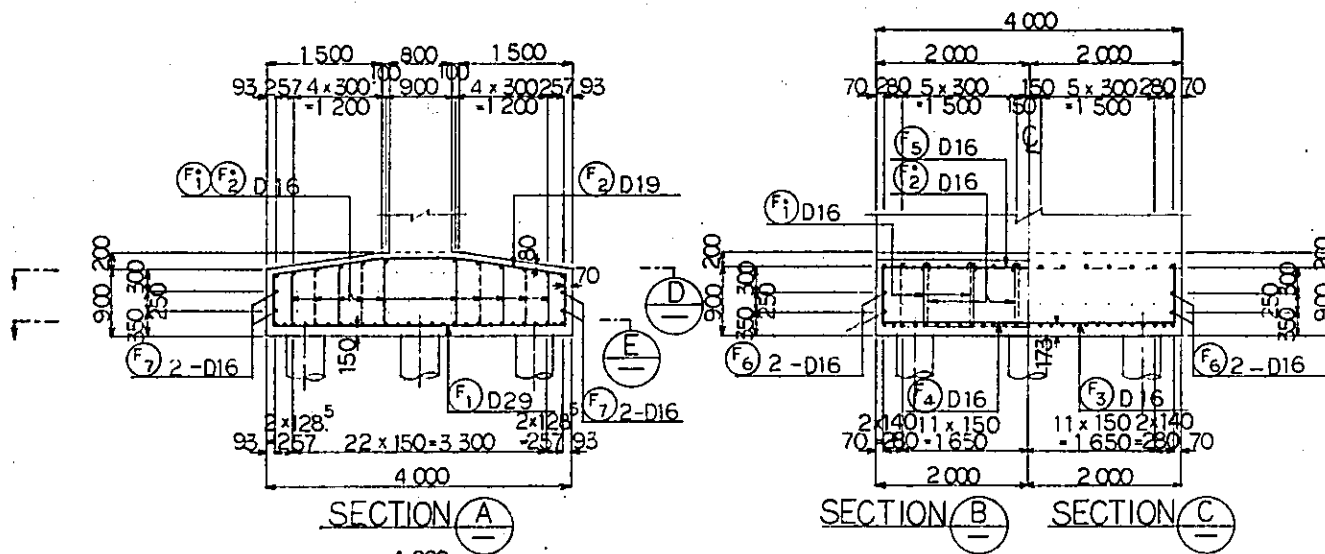


NOTES:  
 1. ALL DIMENSIONS ARE SHOWN IN MILLIMETERS UNLESS OTHERWISE INDICATED  
 2. REFERENCE DRAWING FOR GENERAL VIEW: CS281.

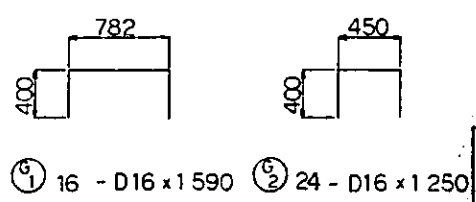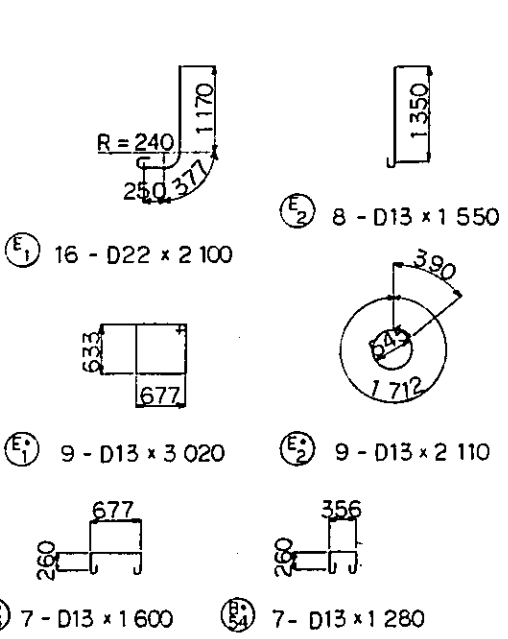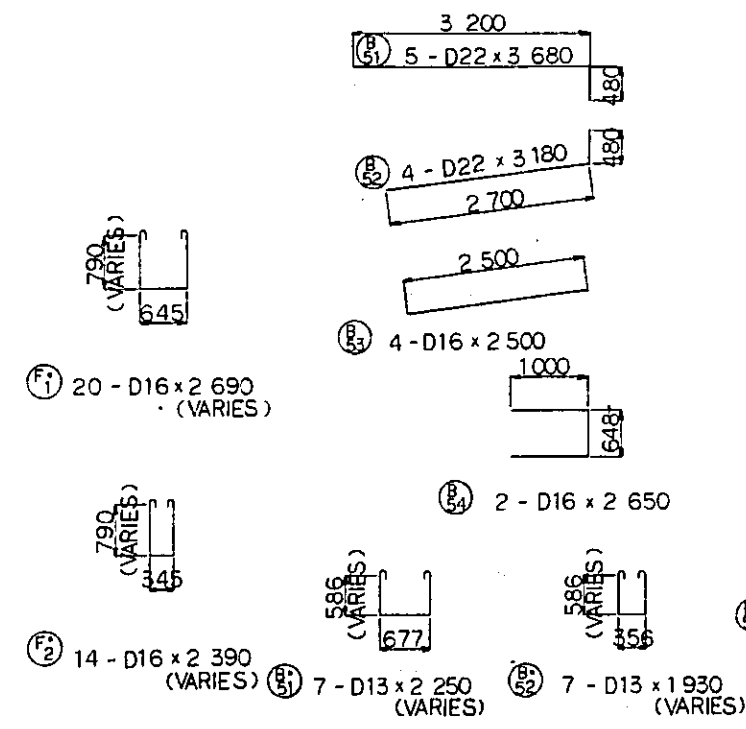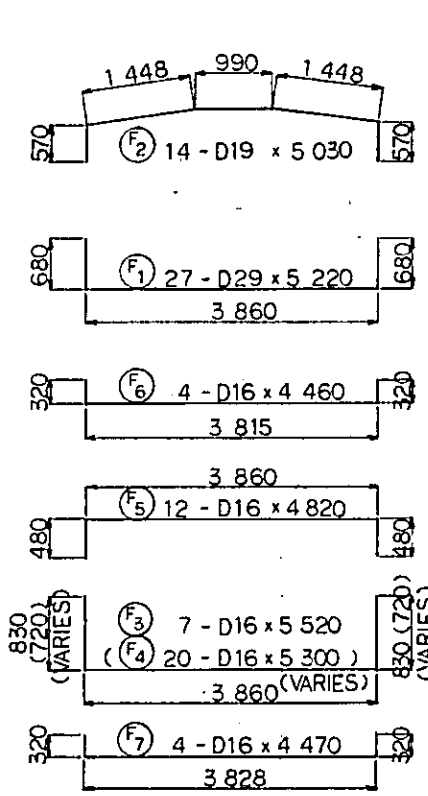


BEARING BASE SCALE 1:30  
 ( ) - TERMINAL SIDE OF P.120


|  |          |          |       |         |          |
|--|----------|----------|-------|---------|----------|
| REPUBLIC OF INDONESIA<br>MINISTRY OF COMMUNICATIONS<br>DIRECTORATE GENERAL OF LAND TRANSPORT<br>AND INLAND WATERWAYS |          |          |       |         |          |
| NEW RAILWAY LINE FOR CENGKARENG AIRPORT<br>CONSTRUCTION PROJECT  |          |          |       |         |          |
| JAPAN INTERNATIONAL COOPERATION AGENCY<br>(JICA)   |          |          |       |         |          |
| B  | 1AUG/84  | S.S      | M.Y   | K.A     | K.M      |
| A  | 15FEB/84 | S.S      | M.Y   | K.A     | K.M      |
| REVISIONS  | DATE     | DESIGNED | DRAWN | CHECKED | REVIEWED |
| PIER PI01<br>BAR ARRANGEMENT<br>(SHEET 2 OF 2)   |          |          |       |         |          |
| PACKAGE: CIVIL AND ARCHITECTURAL WORK  |          |          |       |         |          |
| SCALE: 1:50, 30. DRAWING NO: CS-283  |          |          |       |         |          |

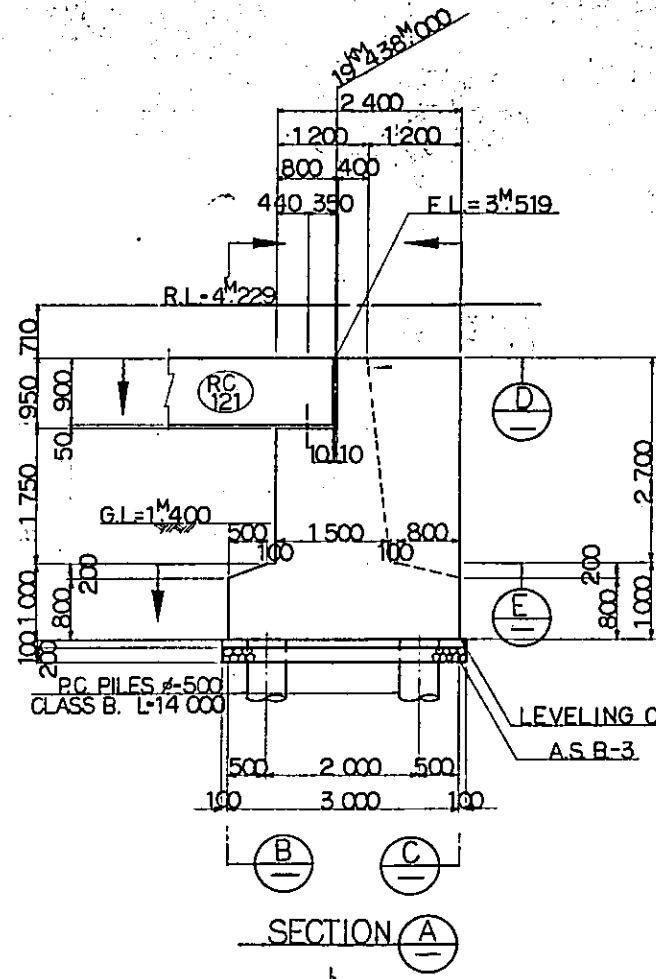


SECTION A

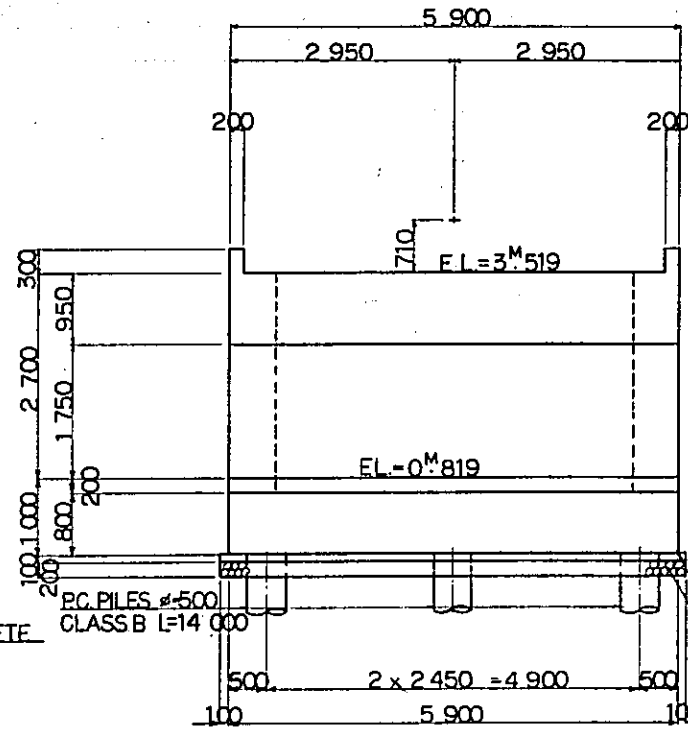


SECTION B

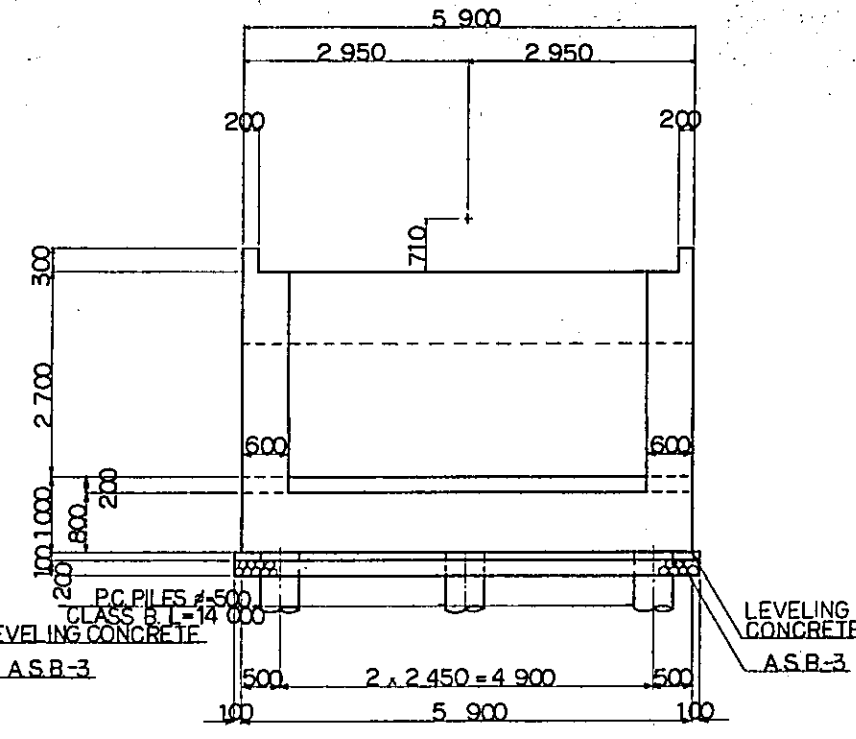

SECTION C

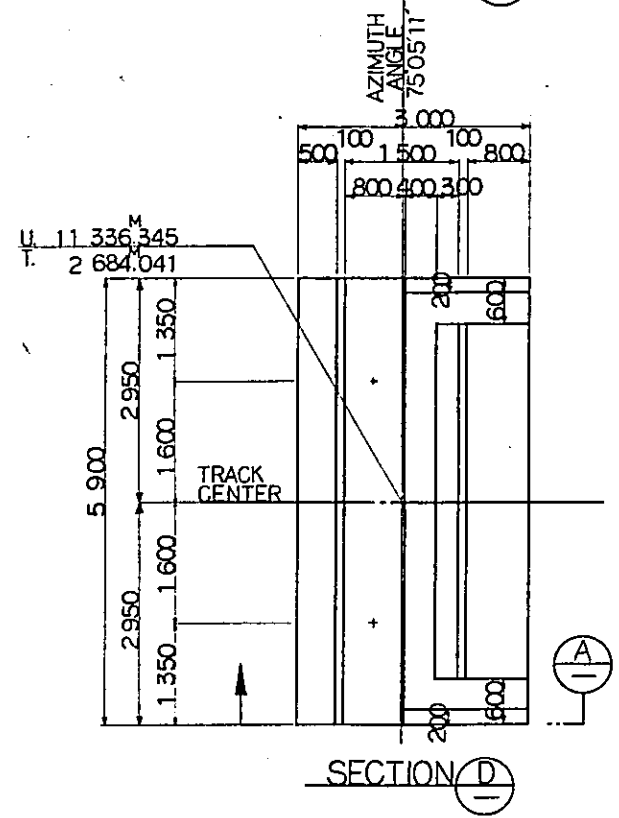





SECTION D

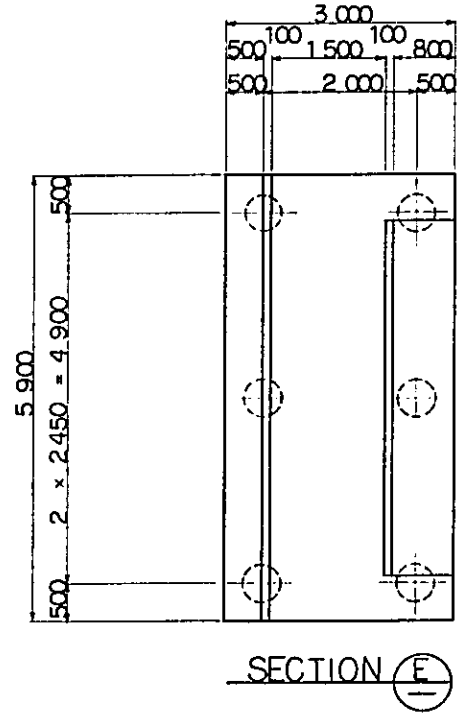


SECTION E

- NOTES:
1. ALL DIMENSIONS ARE SHOWN IN MILLIMETERS UNLESS OTHERWISE INDICATED
  2. REFERENCE DRAWING FOR BAR ARRANGEMENT : CS - 142.  
CS - 143.  
CS - 144.

|  |            |                    |       |         |          |
|--|------------|--------------------|-------|---------|----------|
| REPUBLIC OF INDONESIA<br>MINISTRY OF COMMUNICATIONS<br>DIRECTORATE GENERAL OF LAND TRANSPORT<br>AND INLAND WATERWAYS |            |                    |       |         |          |
| NEW RAILWAY LINE FOR CENGKARENG AIRPORT<br>CONSTRUCTION PROJECT  |            |                    |       |         |          |
| JAPAN INTERNATIONAL COOPERATION AGENCY<br>(JICA)   |            |                    |       |         |          |
| B  | 1 AUG. 84  | S.S.               | M.Y.  | K.R.    | M.A.K.   |
| A  | 15 FEB. 84 | S.S.               | M.Y.  | K.R.    | M.A.K.   |
| REVISIONS  | DATE       | DESIGNED           | DRAWN | CHECKED | REVIEWED |
| ABUTMENT Ab101<br>GENERAL VIEW   |            |                    |       |         |          |
| PACKAGE: I CIVIL AND ARCHITECTURAL WORK  |            |                    |       |         |          |
| SCALE  | 50         | DRAWING NO. CS-284 |       |         |          |

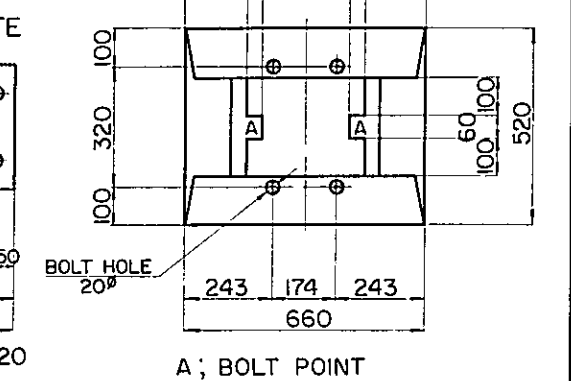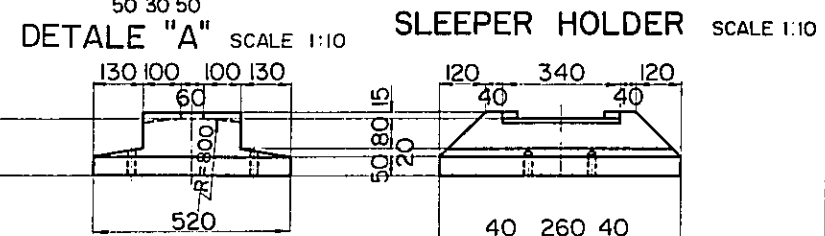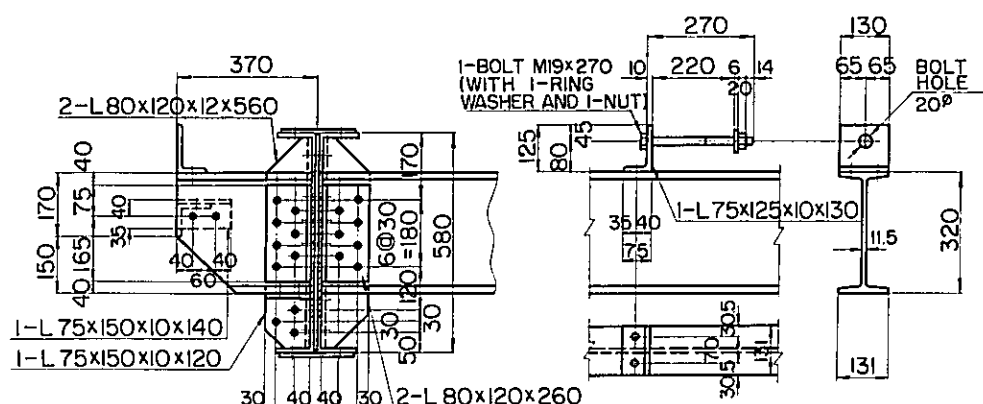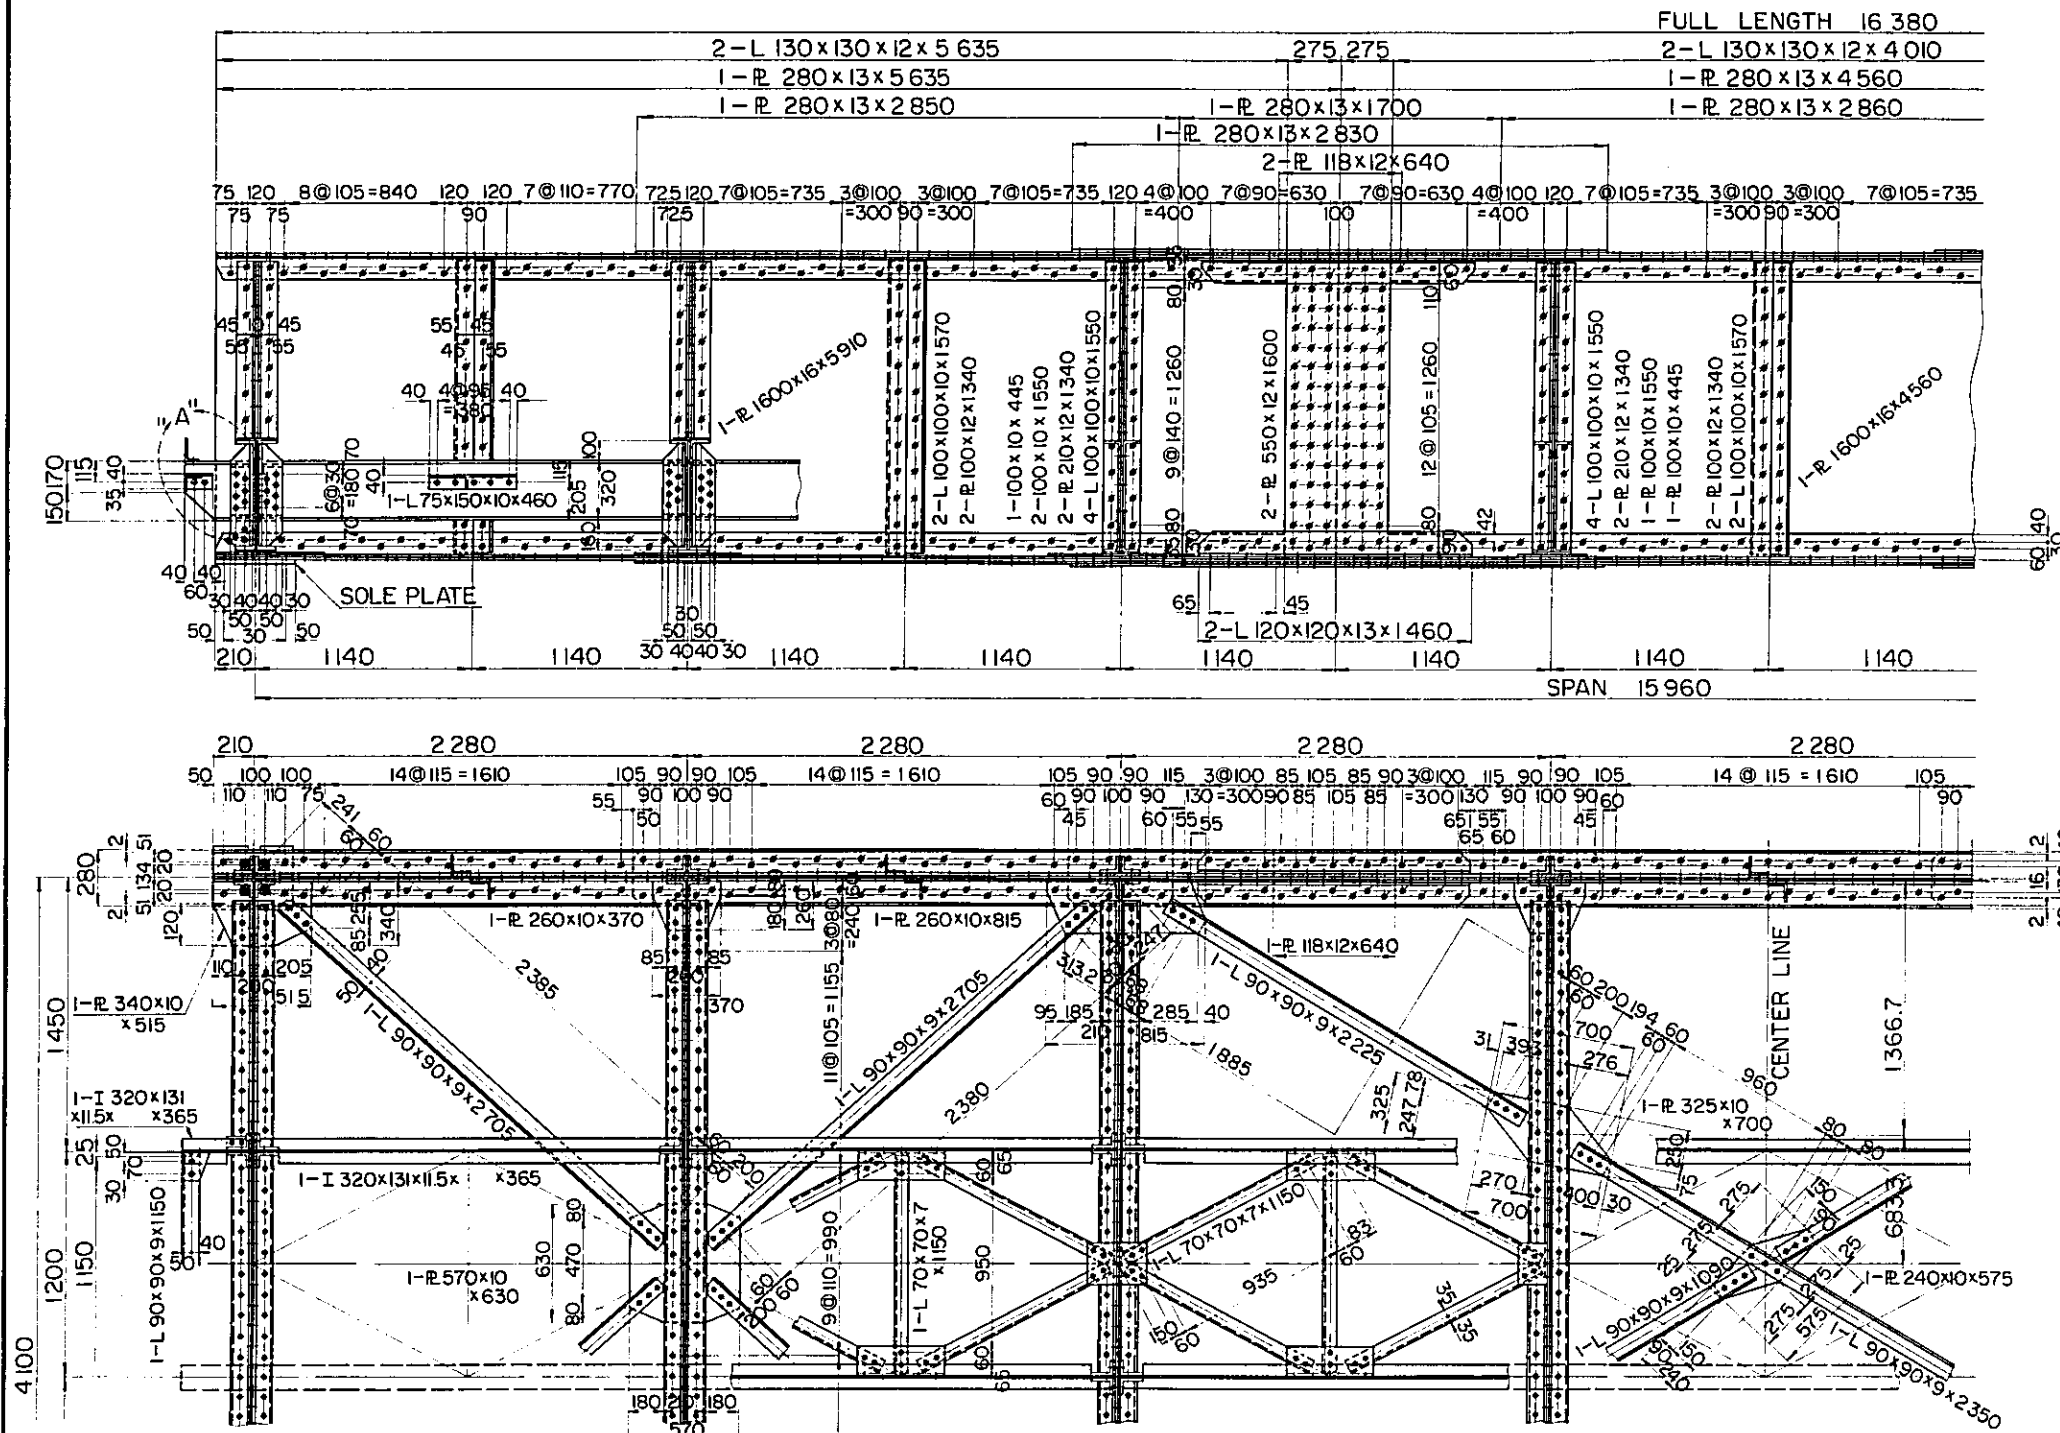


NOTE:  
ALL DIMENSIONS ARE SHOWN IN MILLIMETERS UNLESS OTHERWISE INDICATED.

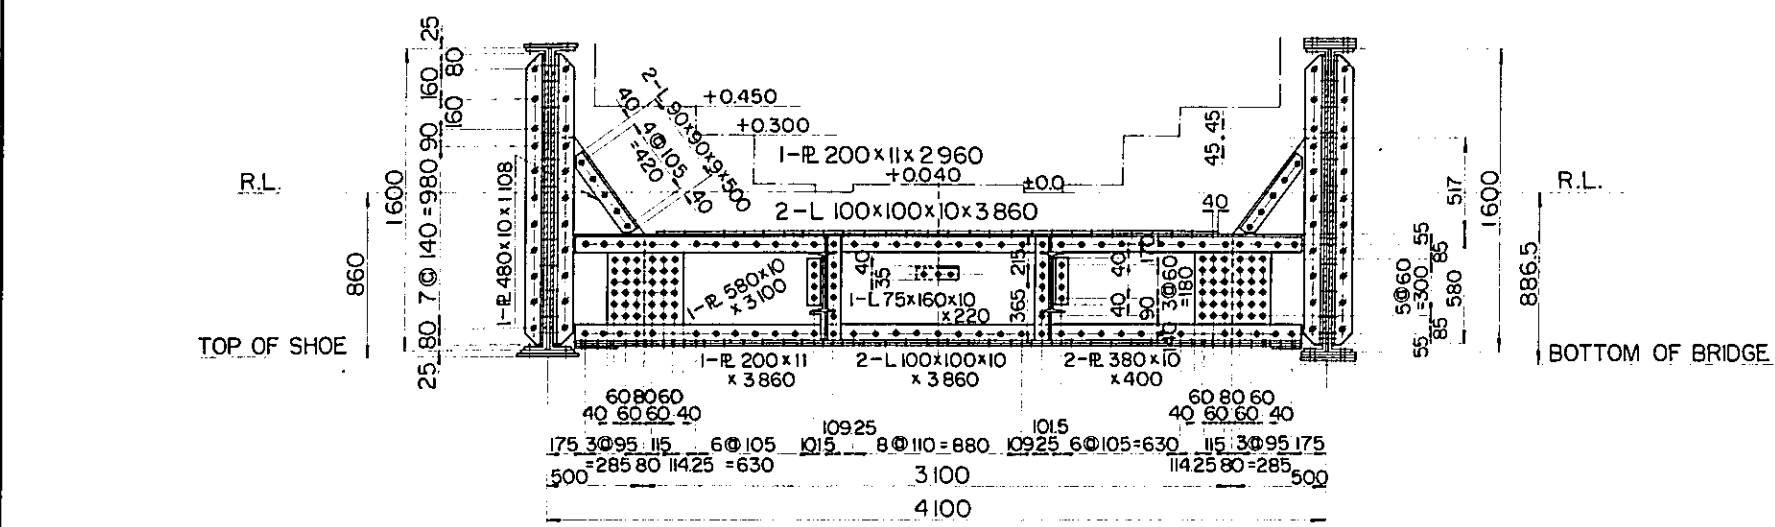


- NOTATION
- ⊕ : 20<sup>MM</sup> DIA RIVET HOLE, SHOP RIVETED
  - ⊙ : 23<sup>MM</sup> " " " "
  - ⊙ : 20<sup>MM</sup> " " FIELD RIVETED
  - ⊙ : 23<sup>MM</sup> " " " "
  - ⊙ : 23<sup>MM</sup> " " FIELD RIVETED
- WITH BOTTOM SIDE SUNKEN


|  |             |          |       |         |          |
|--|-------------|----------|-------|---------|----------|
| REPUBLIC OF INDONESIA<br>MINISTRY OF COMMUNICATIONS<br>DIRECTORATE GENERAL OF LAND TRANSPORT<br>AND INLAND WATERWAYS |             |          |       |         |          |
| NEW RAILWAY LINE FOR CENGKARENG AIRPORT<br>CONSTRUCTION PROJECT  |             |          |       |         |          |
| JAPAN INTERNATIONAL COOPERATION AGENCY<br>(JICA)   |             |          |       |         |          |
| B  | 1 AUG 84    | ✓        | MY    | KA      | KM       |
| A  | 15 FEB 84   | ✓        | MY    | KA      | KM       |
| REVISIONS  | DATE        | DESIGNED | DRAWN | CHECKED | REVIEWED |
| BRIDGE B16 DETAILS<br>OF<br>THROUGH PLATE GIRDER   |             |          |       |         |          |
| PACKAGE: I CIVIL AND ARCHITECTURAL WORK  |             |          |       |         |          |
| SCALE  | DRAWING NO. |          |       |         |          |
| 1:20,10  | CS-285      |          |       |         |          |

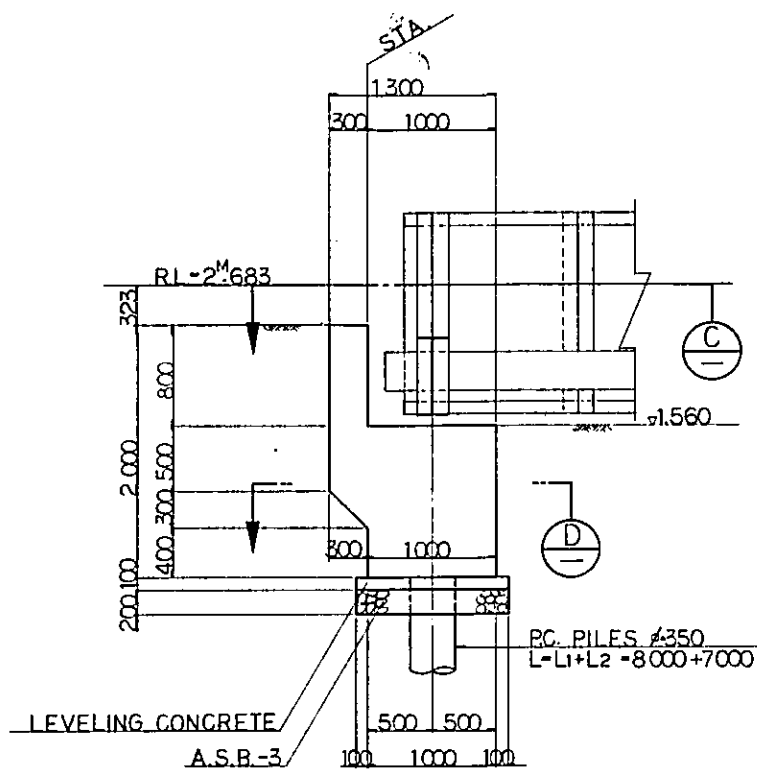


SECTION A

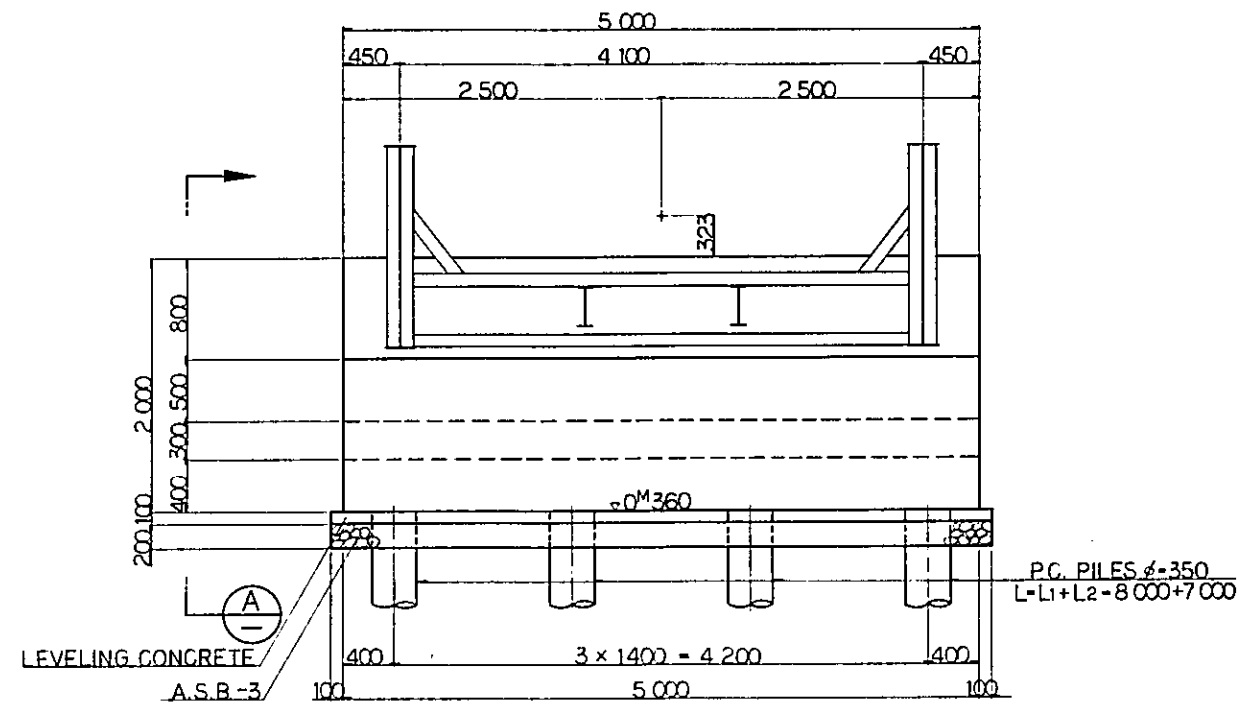

SECTION B

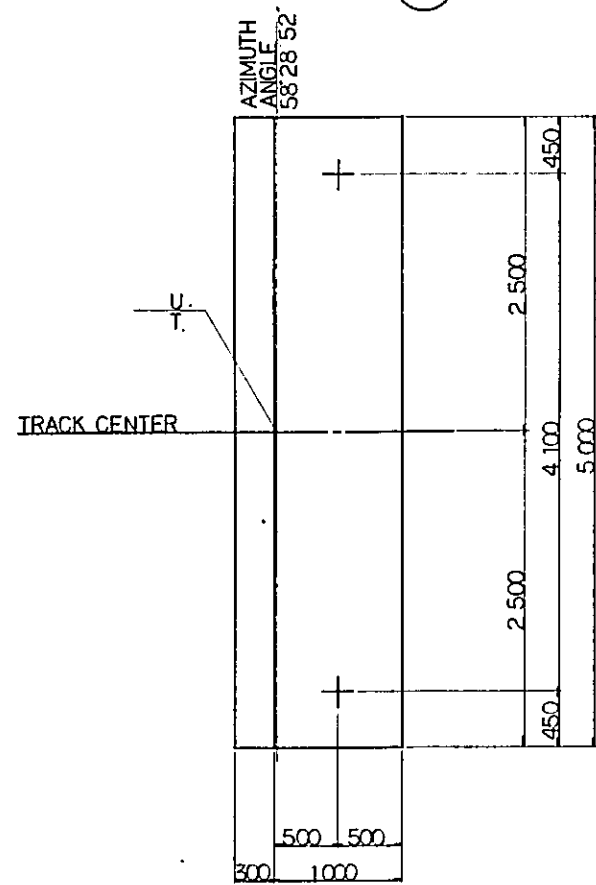

SECTION C

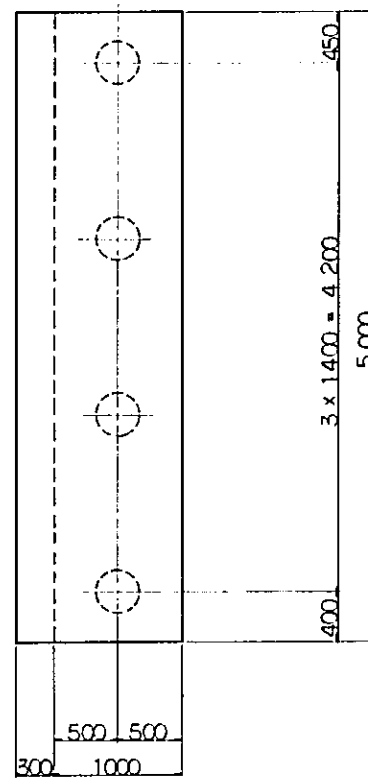

SECTION D

DIMENSION SCHEDULE

| NO.   | STA.       | U.         | T.        |
|-------|------------|------------|-----------|
| Ab102 | 19+922.520 | 10+596.038 | 2+876.726 |
| Ab103 | 19+939.480 | 10+611.580 | 2+885.592 |

NOTES:

1. ALL DIMENSIONS ARE SHOWN IN MILLIMETERS UNLESS OTHERWISE INDICATED
2. TYPES OF P.C. PILE
  - 1. BOTTOM SURFACE OF FOOTING
  - 2. P.C. PILE CLASS A.
  - 3. P.C. PILE CLASS A.
3. REFERENCE DRAWING FOR BAR ARRANGEMENT : CS - 287.

REPUBLIC OF INDONESIA  
 MINISTRY OF COMMUNICATIONS  
 DIRECTORATE GENERAL OF LAND TRANSPORT AND INLAND WATERWAYS


NEW RAILWAY LINE FOR CENGKARENG AIRPORT  
 CONSTRUCTION PROJECT

JAPAN INTERNATIONAL COOPERATION AGENCY (JICA)


| REVISIONS | DATE     | DESIGNED | DRAWN    | CHECKED | REVIEWED | SUBMITTED |
|-----------|----------|----------|----------|---------|----------|-----------|
| B         | 1AUG'84  | S.S.     | M.Y.K.A. | K.M.    | M.K.     |           |
| A         | 15FEB'84 | S.S.     | M.Y.K.A. | K.M.    | M.K.     |           |

ABUTMENT Ab 102 , Ab 103  
 GENERAL VIEW


PACKAGE: I CIVIL AND ARCHITECTURAL WORK  
 SCALE: 1:30  
 DRAWING NO: CS-286

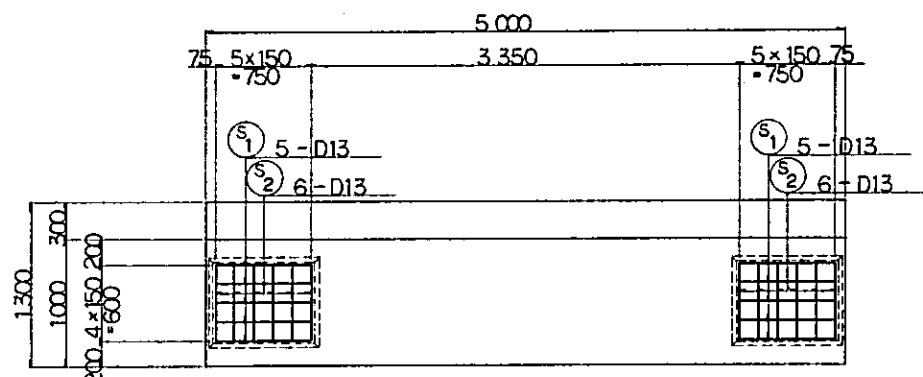


SECTION A

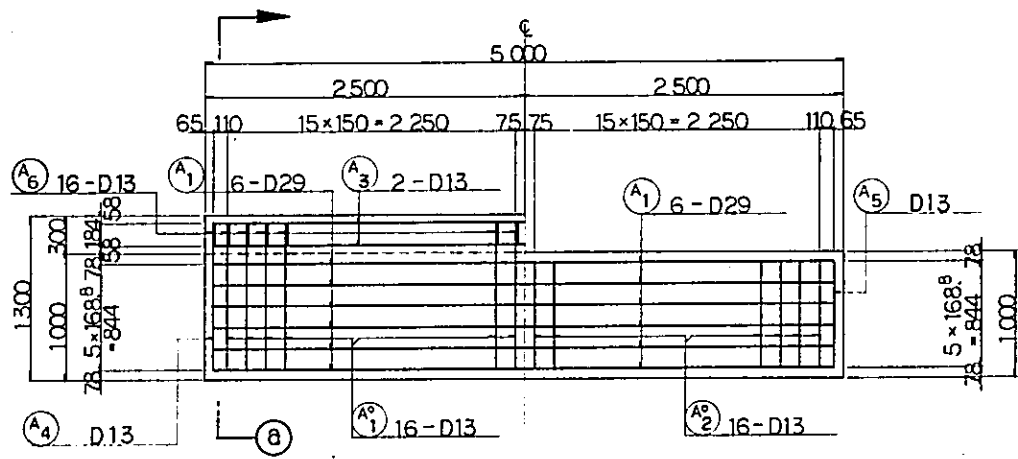


SECTION B SECTION C

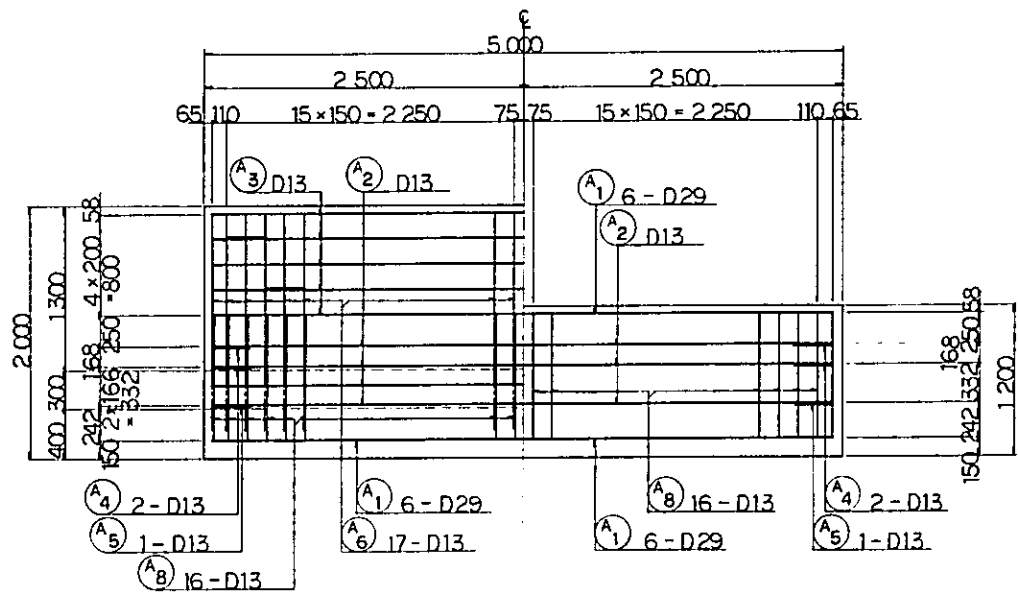


SECTION D SECTION E

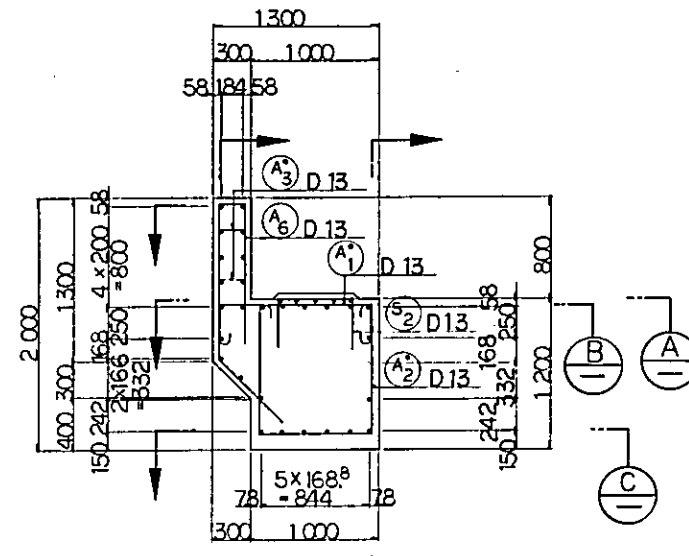


SECTION B - B

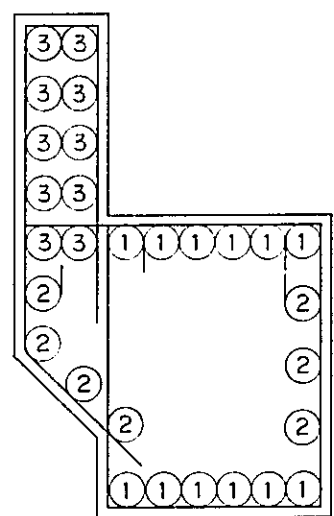


SECTION a - a

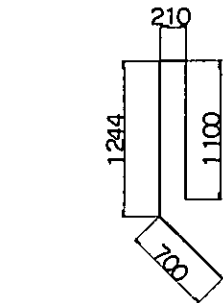


A6 34 - D13 x 3 260

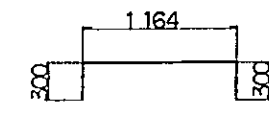


A4 4 - D13 x 1 770

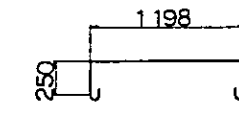


A1 32 - D13 x 2 100

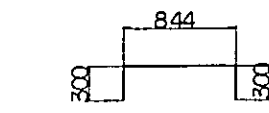


A5 2 - D13 x 1 450

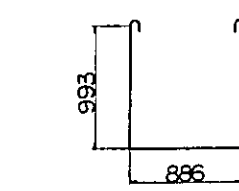


A2 32 - D13 x 3 280

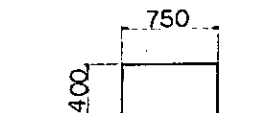


S1 10 - D13 x 1 550

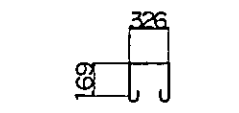


A3 13 - D13 x 1 070

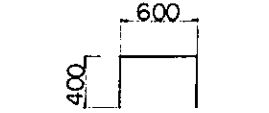


S2 12 - D13 x 1 400

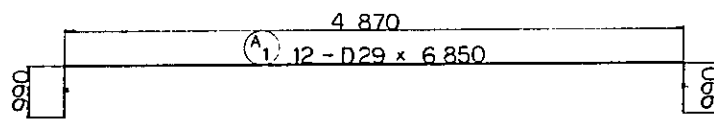

A1 12 - D29 x 6 850

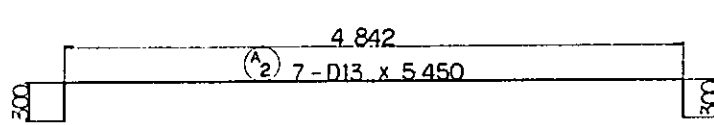


A2 7 - D13 x 5 450

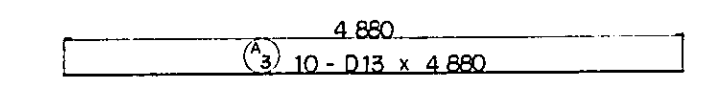


A3 10 - D13 x 4 880

NOTES:  
 1. ALL DIMENSIONS ARE SHOWN IN MILLIMETERS UNLESS OTHERWISE INDICATED  
 2. REFERENCE DRAWING FOR GENERAL VIEW : CS - 286.


|   |                    |          |       |         |           |
|---|--------------------|----------|-------|---------|-----------|
| REPUBLIC OF INDONESIA<br>MINISTRY OF COMMUNICATIONS<br>DIRECTORATE GENERAL OF LAND TRANSPORT AND INLAND WATERWAYS |                    |          |       |         |           |
| NEW RAILWAY LINE FOR CENGKARENG AIRPORT<br>CONSTRUCTION PROJECT   |                    |          |       |         |           |
| JAPAN INTERNATIONAL COOPERATION AGENCY<br>(JICA)  |                    |          |       |         |           |
| B   | 1 AUG 84           | SS       | M.Y.  | K.d     | K.M       |
| A   | 15 FEB 84          | SS       | M.Y.  | K.A     | K.M       |
| REVISIONS   | DATE               | DESIGNED | DRAWN | CHECKED | SUBMITTED |
| ABUTMENT Ab102<br>BAR ARRANGEMENT   |                    |          |       |         |           |
| PACKAGE: I - CIVIL AND ARCHITECTURAL WORK   |                    |          |       |         |           |
| SCALE: 1:30   | DRAWING NO: CS-287 |          |       |         |           |

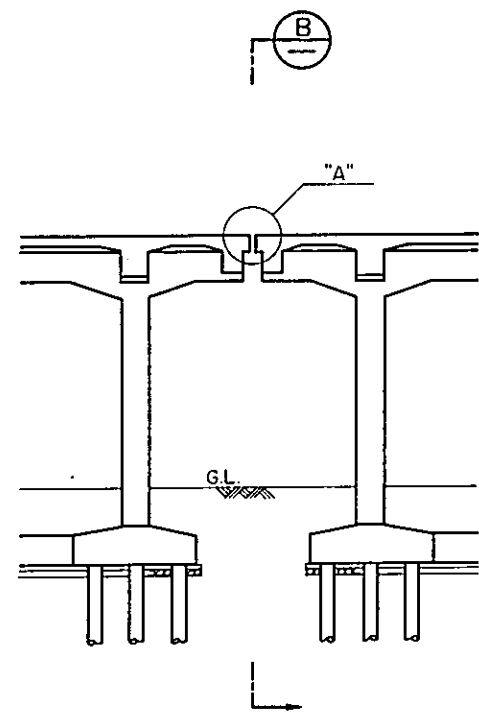


SECTION A

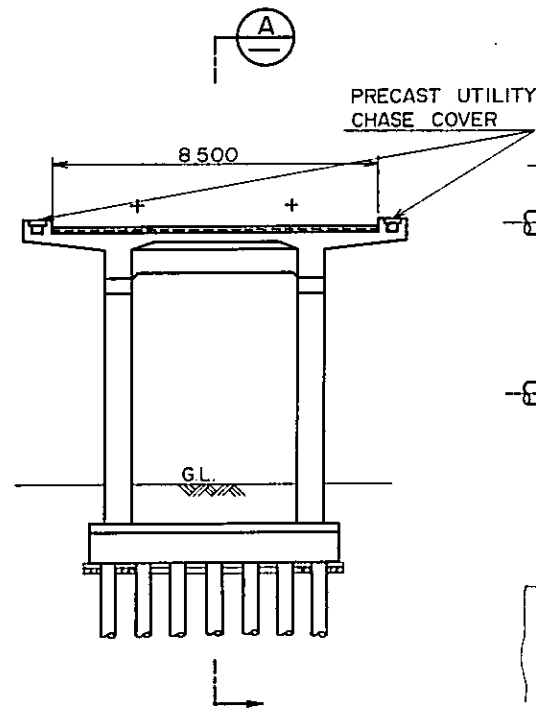


SECTION B

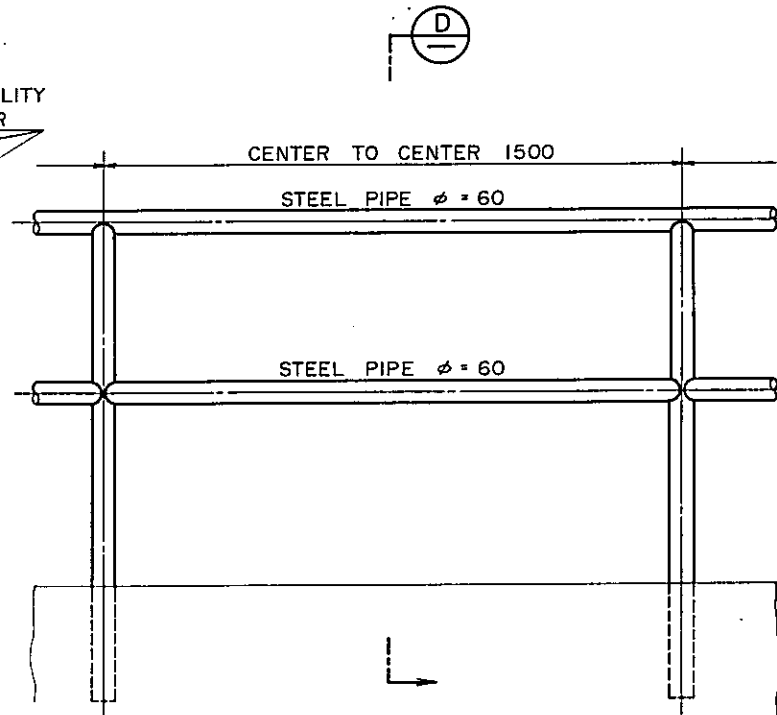


SECTION C

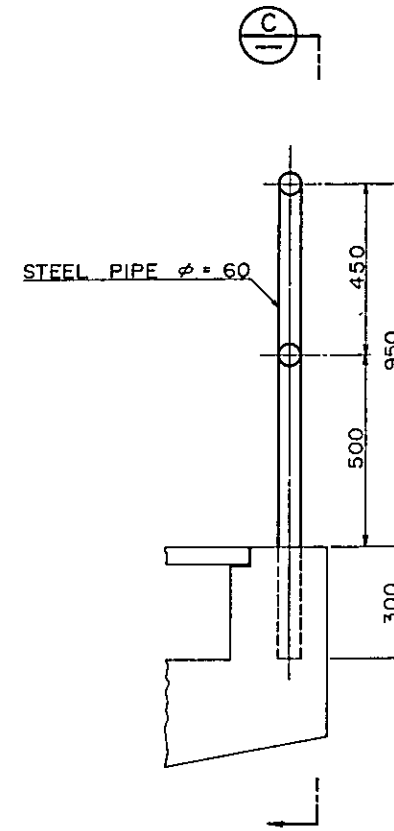


SECTION D

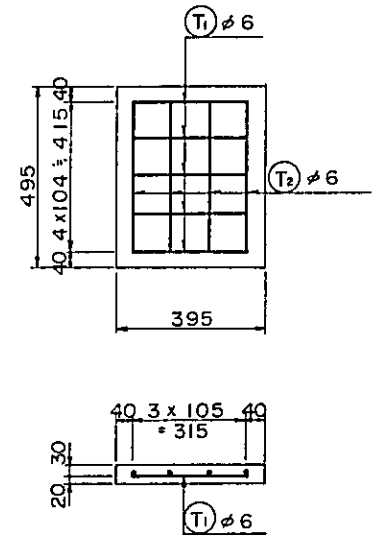

DETAIL OF PRECAST UTILITY CHASE COVER  
SCALE 1:10

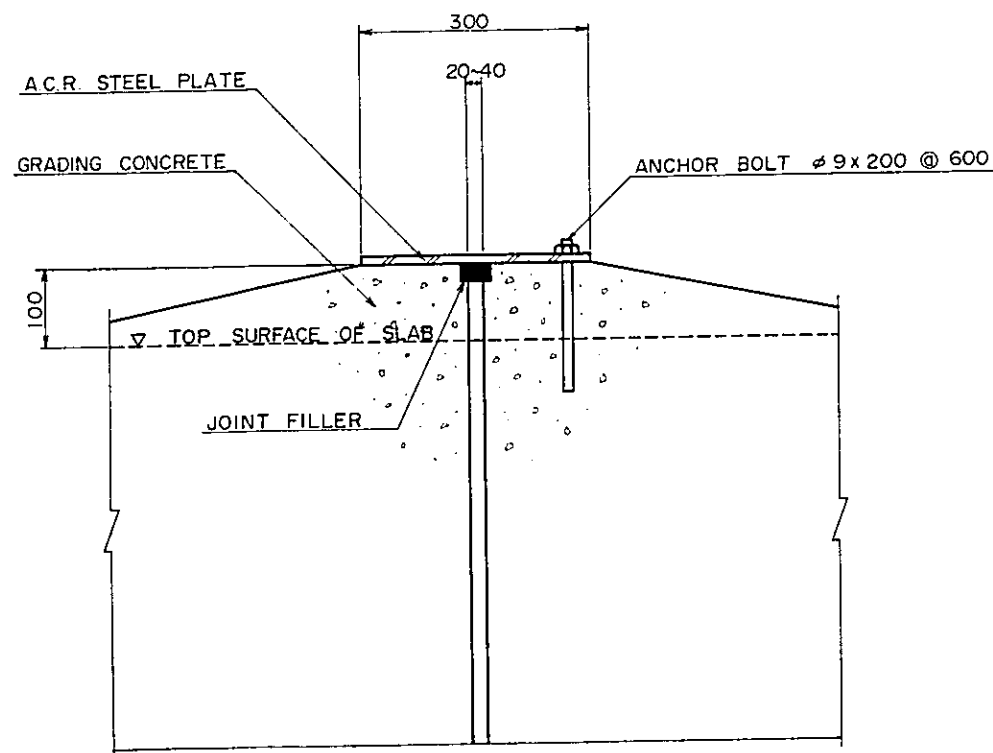


DETAIL "A"  
DETAIL OF EXPANSION JOINT SCALE 1:5

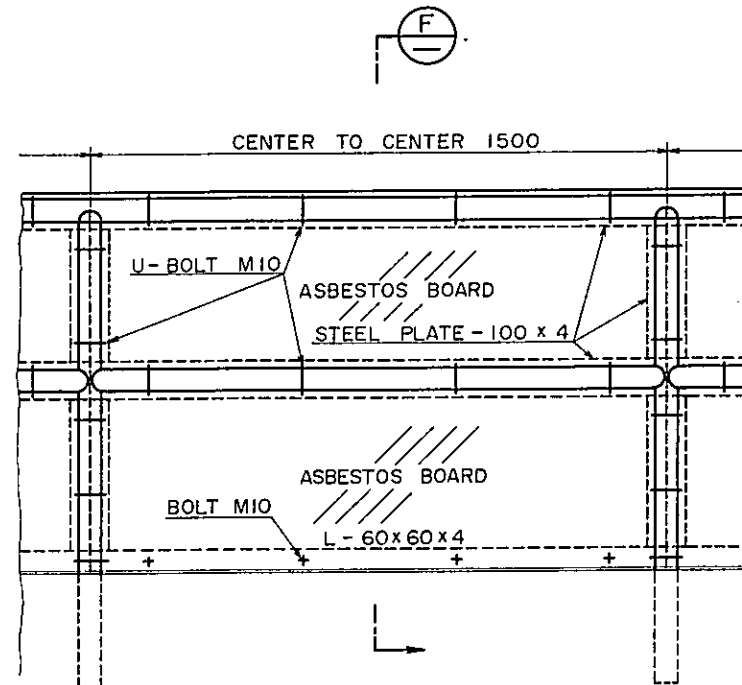

SECTION E

DETAIL OF RAILING SCALE 1:10

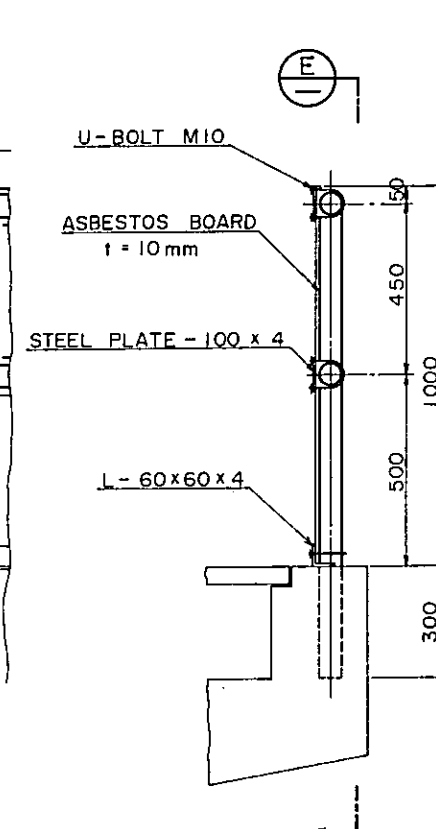

SECTION F



NOTES:

1. ALL DIMENSIONS ARE SHOWN IN MILLIMETERS UNLESS OTHERWISE INDICATED
2. RAILINGS WITH ASBESTOS BOARDS WILL BE INSTALLED AT LOCATIONS OF OVER-ROAD BRIDGES AND ALONG THE TRACK AT DENSED HOUSING AREAS.


ABBREVIATIONS:

- A.C.R. STEEL PLATE
- ..... ATMOSPHERIC CORROSION RESISTING STEEL PLATE.


|   |           |             |       |         |           |
|---|-----------|-------------|-------|---------|-----------|
| REPUBLIC OF INDONESIA<br>MINISTRY OF COMMUNICATIONS<br>DIRECTORATE GENERAL OF LAND TRANSPORT AND INLAND WATERWAYS |           |             |       |         |           |
| NEW RAILWAY LINE FOR CENGKARENG AIRPORT<br>CONSTRUCTION PROJECT   |           |             |       |         |           |
| JAPAN INTERNATIONAL COOPERATION AGENCY (JICA)   |           |             |       |         |           |
| F   | 1 AUG 84  | K.M.        | K.A.  | K.M.    | K.A.      |
| A   | 15 FEB 84 | K.M.        | K.A.  | K.M.    | K.A.      |
| REVISIONS   | DATE      | DESIGNED    | DRAWN | CHECKED | SUBMITTED |
| DETAILS OF MISCELLANEOUS WORKS FOR VIADUCTS AND BRIDGE SUPERSTRUCTURES  |           |             |       |         |           |
| PACKAGE: I CIVIL AND ARCHITECTURAL WORK   |           |             |       |         |           |
| SCALE   | 1:10, 5   | DRAWING NO. |       | CS-288  |           |

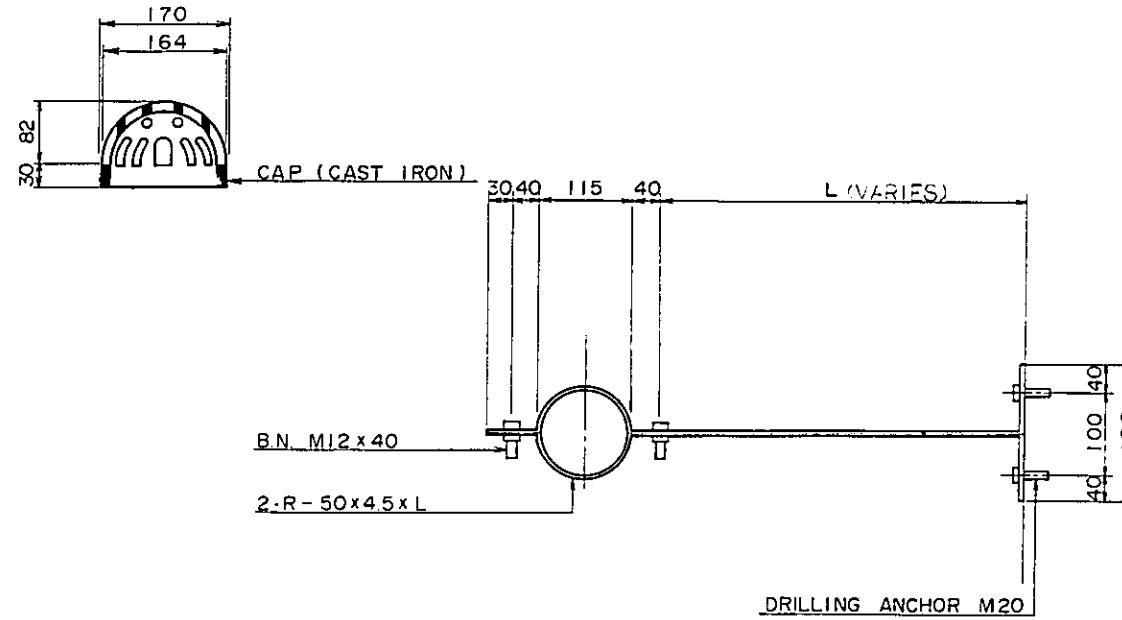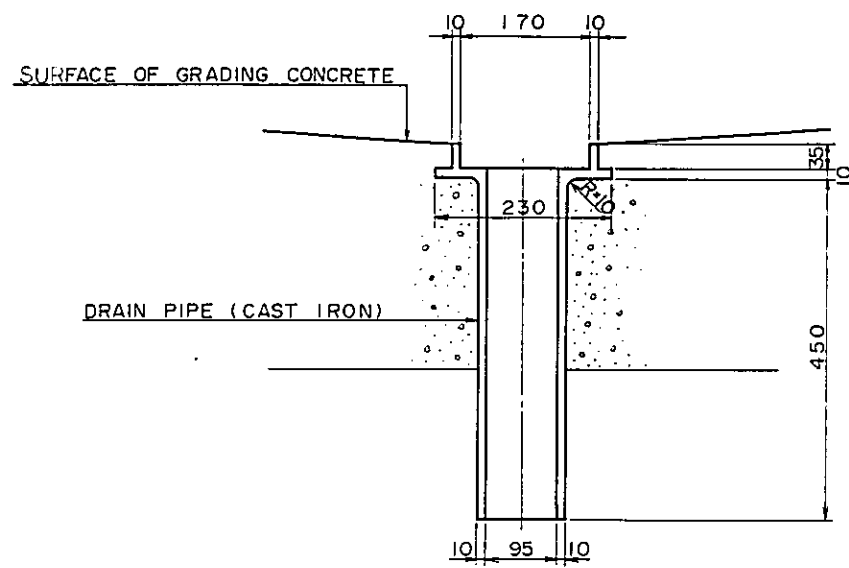

SUPPORT SCALE 1:5

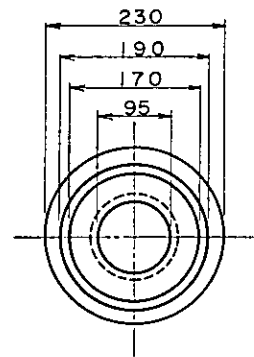

DRAIN PIPE

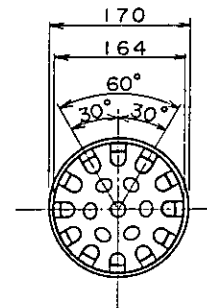


CAP

NOTES:


- ALL DIMENSIONS ARE SHOWN IN MILLIMETERS UNLESS INDICATED OTHERWISE

2. ABBREVIATIONS:


- A.C.R STEEL PLATE
- ..... ATMOSPHERIC CORROSION
- RESISTING STEEL PLATE

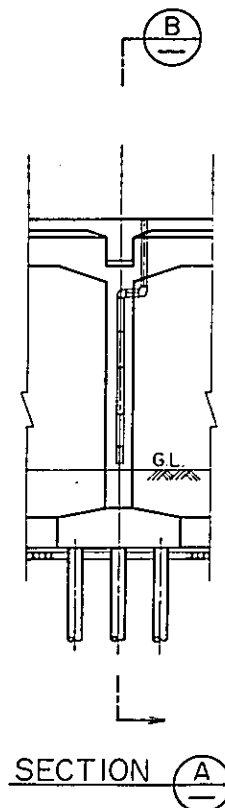


SECTION A

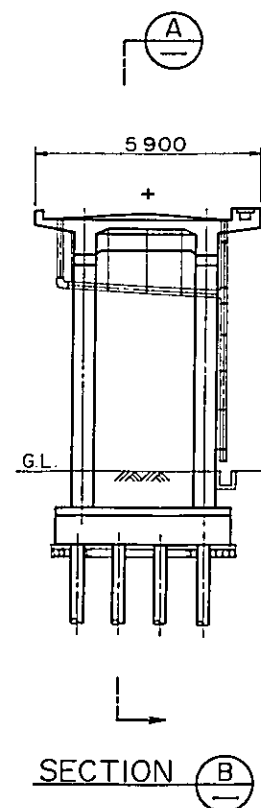


SECTION B

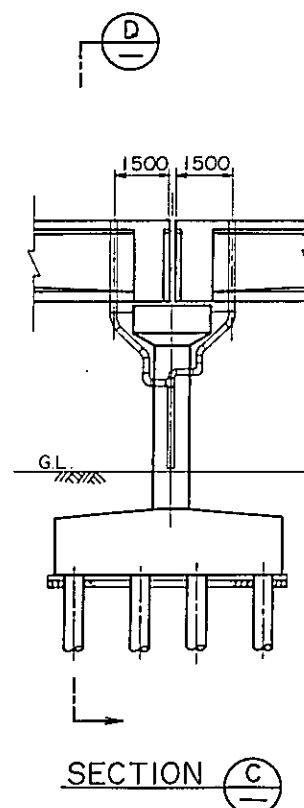

SECTION C

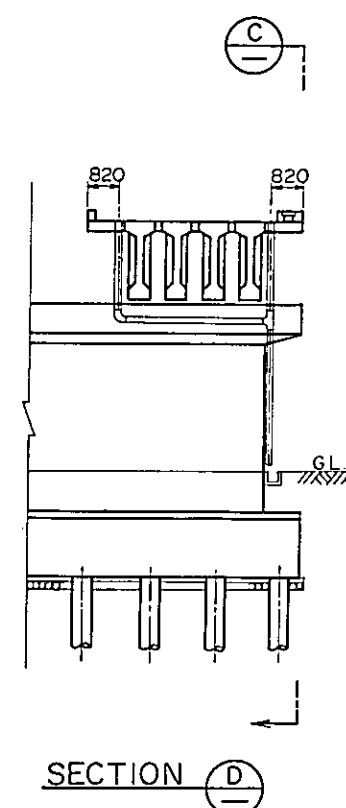


SECTION D

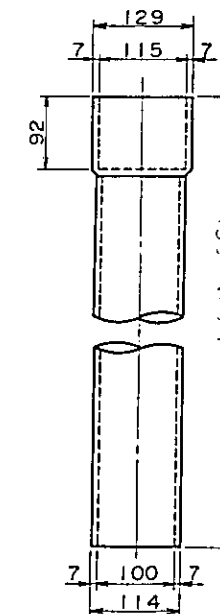



U.P.V.C. PIPE SCALE 1:5

|  |           |                       |       |         |          |           |
|--|-----------|-----------------------|-------|---------|----------|-----------|
| REPUBLIC OF INDONESIA<br>MINISTRY OF COMMUNICATIONS<br>DIRECTORATE GENERAL OF LAND TRANSPORT<br>AND INLAND WATERWAYS |           |                       |       |         |          |           |
| NEW RAILWAY LINE FOR CENGKARENG AIRPORT<br>CONSTRUCTION PROJECT  |           |                       |       |         |          |           |
| JAPAN INTERNATIONAL COOPERATION AGENCY<br>(JICA)   |           |                       |       |         |          |           |
| E  | 1 AUG 84  | K                     | M     | S       | K        | M         |
| A  | 15 FEB 84 | K                     | M     | S       | K        | M         |
| REVISIONS  | DATE      | DESIGNED              | DRAWN | CHECKED | REVIEWED | SUBMITTED |
| DETAILS OF DRAIN<br>FOR VIADUCTS AND BRIDGE<br>SUPERSTRUCTURES   |           |                       |       |         |          |           |
| PACKAGE: I CIVIL AND ARCHITECTURAL WORK  |           |                       |       |         |          |           |
| SCALE<br>1:100,5   |           | DRAWING NO.<br>CS-289 |       |         |          |           |

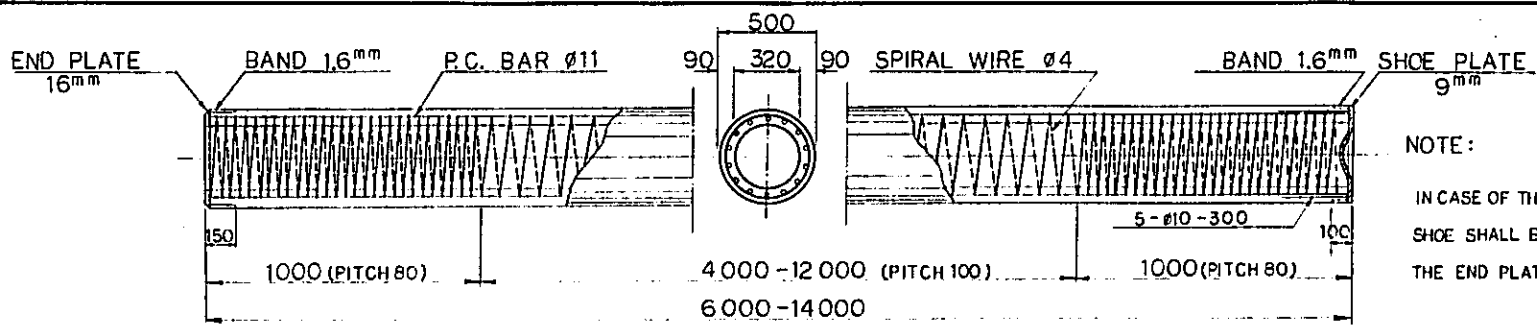


NOTE:  
IN CASE OF THE UPPER PILE, THIS SHOE SHALL BE REPLACED TO THE END PLATE.


P.C. PILE CLASS B

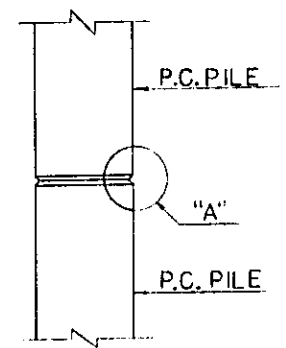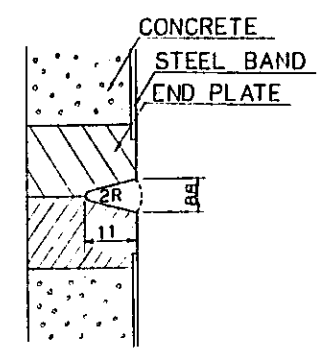

DETAIL OF "A"

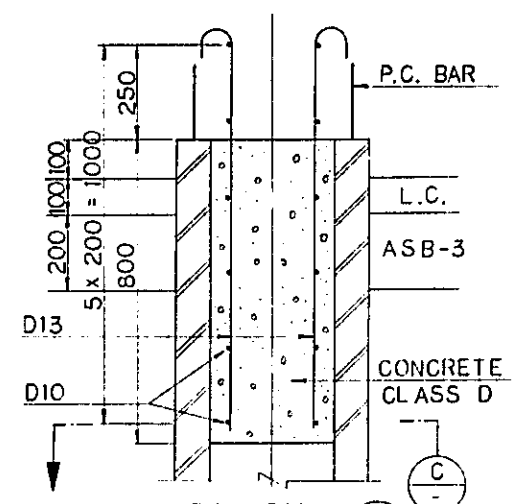


SECTION B

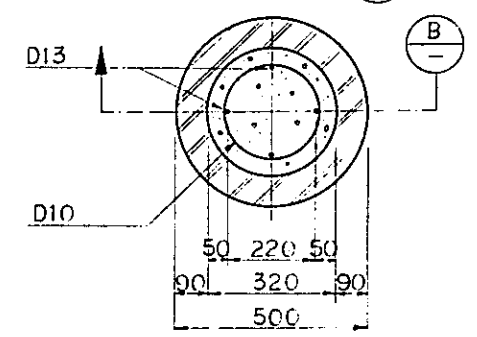


SECTION C

PILE HEAD

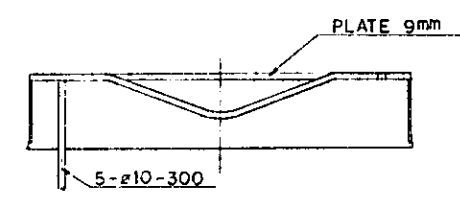




CLASS B

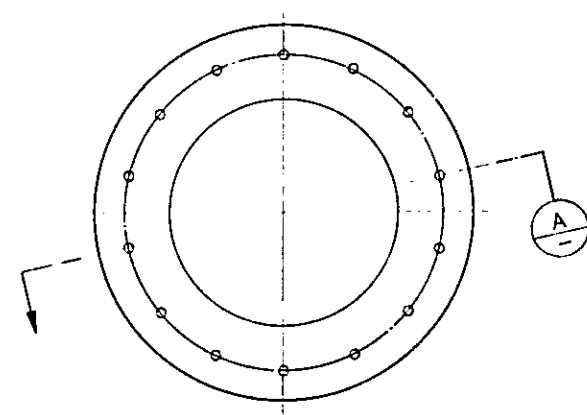


CLASS A

SECTION A


SHOE

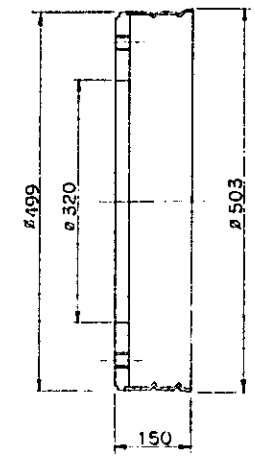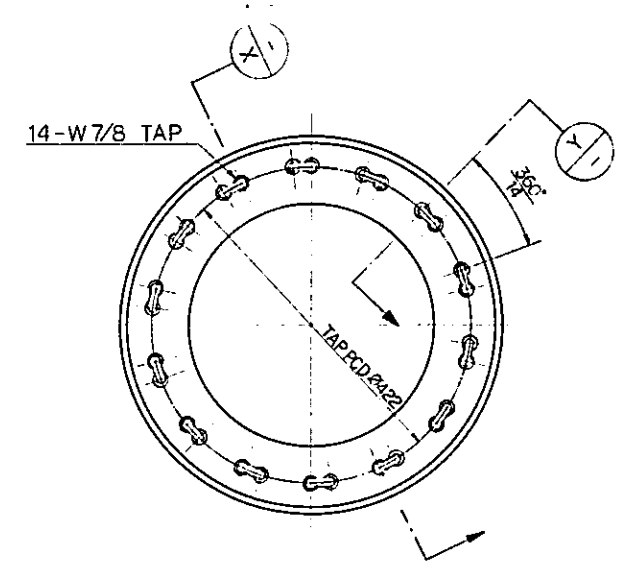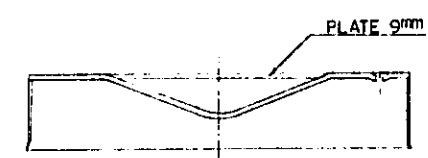



SECTION X-X

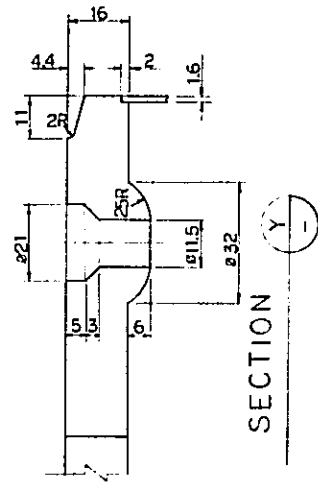


SECTION Y-Y

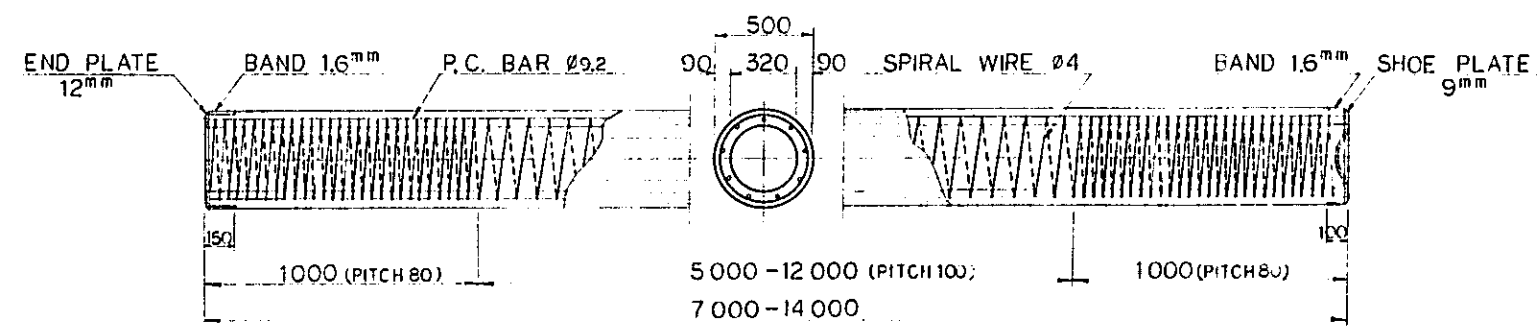

P.C. PILE CLASS A

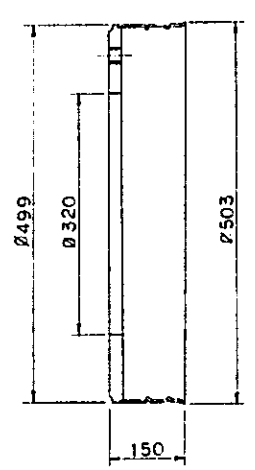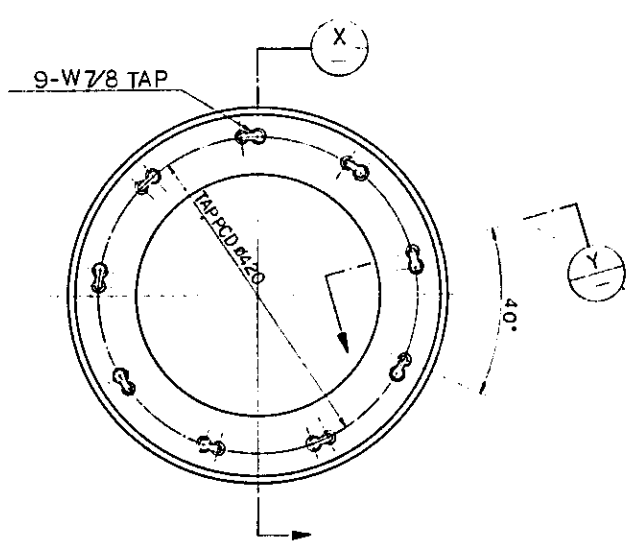

SECTION X-X

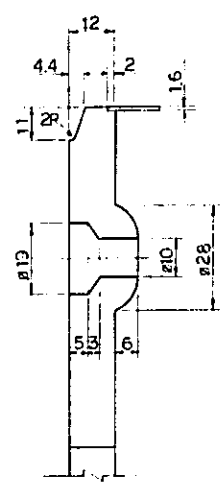


SECTION Y-Y

NOTE:  
ALL DIMENSIONS ARE SHOWN IN MILLIMETERS UNLESS OTHERWISE INDICATED.



|   |         |                    |       |         |          |           |
|---|---------|--------------------|-------|---------|----------|-----------|
| REPUBLIC OF INDONESIA<br>MINISTRY OF COMMUNICATIONS<br>DIRECTORATE GENERAL OF LAND TRANSPORT AND INLAND WATERWAYS |         |                    |       |         |          |           |
| NEW RAILWAY LINE FOR CENGKARENG AIRPORT CONSTRUCTION PROJECT  |         |                    |       |         |          |           |
| JAPAN INTERNATIONAL COOPERATION AGENCY (JICA)   |         |                    |       |         |          |           |
| REVISIONS   | DATE    | DESIGNED           | DRAWN | CHECKED | REVIEWED | SUBMITTED |
| A   | 1AUG'84 | K.V.               | K.S.  | K.A.    | K.M.     | M.K.      |
| DETAILS OF PRESTRESSED CONCRETE PILES (SHEET 1 OF 2)  |         |                    |       |         |          |           |
| PACKAGE: I CIVIL AND ARCHITECTURAL WORK.  |         |                    |       |         |          |           |
| SCALE: NOT IN SCALE   |         | DRAWING NO: CS-290 |       |         |          |           |



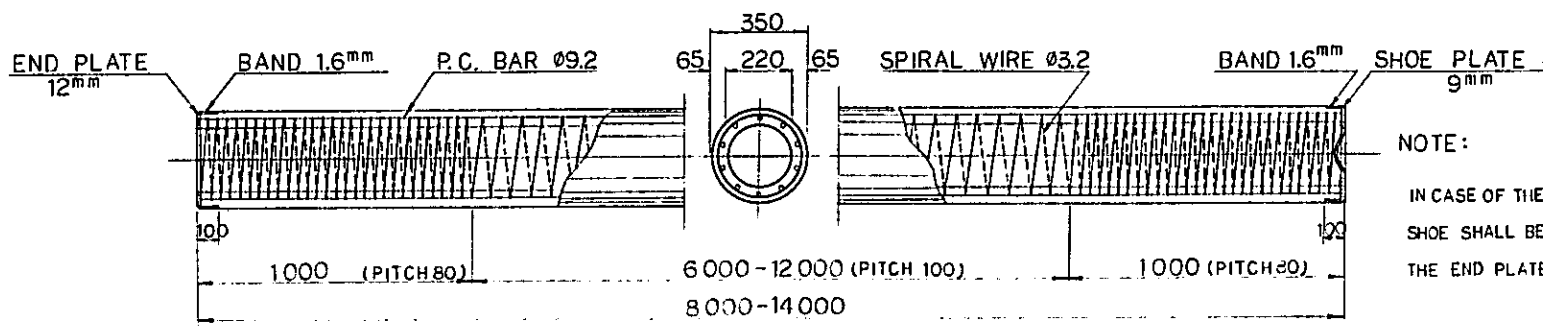


NOTE:  
IN CASE OF THE UPPER PILE, THIS SHOE SHALL BE REPLACED TO THE END PLATE.


P.C. PILE CLASS B

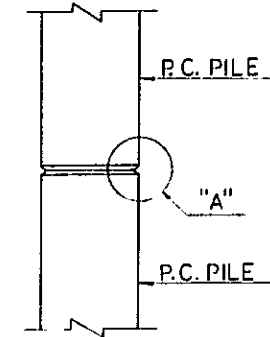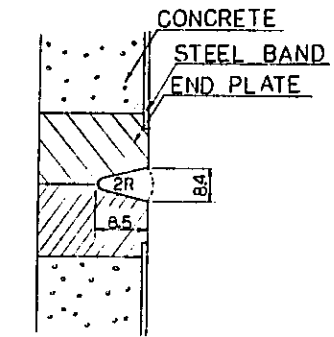



DETAIL OF "A"

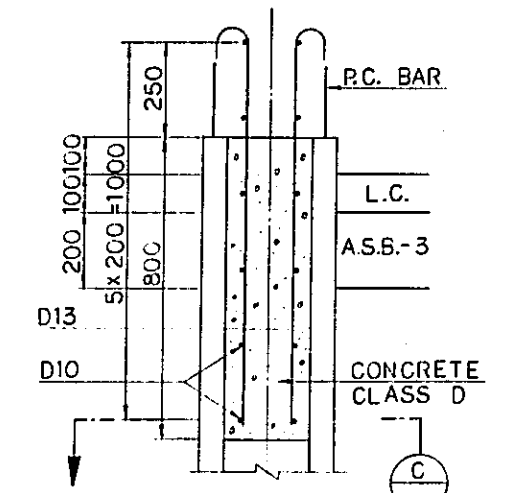


SECTION B-C

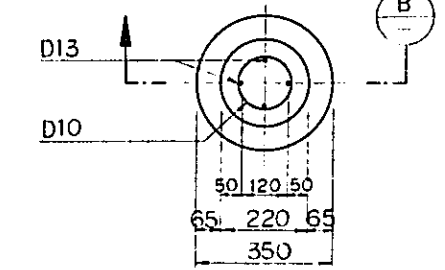


SECTION C  
PILE HEAD

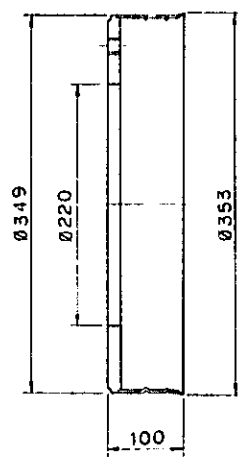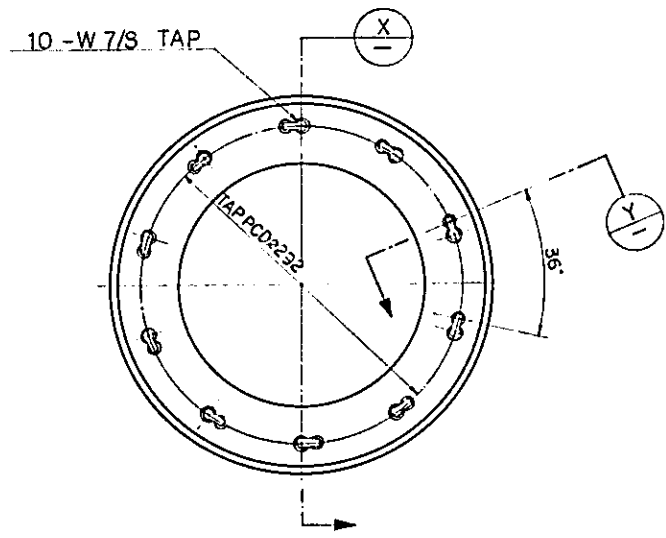


SECTION X-X

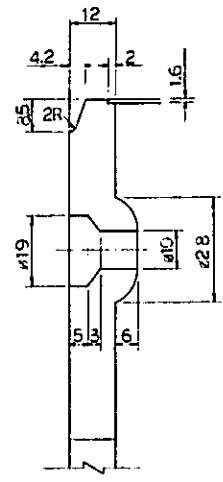



SECTION Y-Y

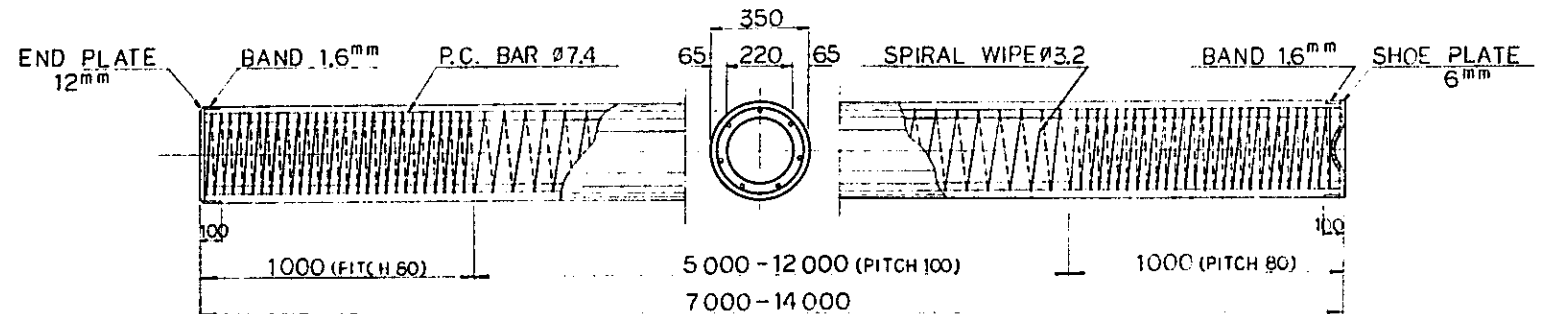


P.C. PILE CLASS A

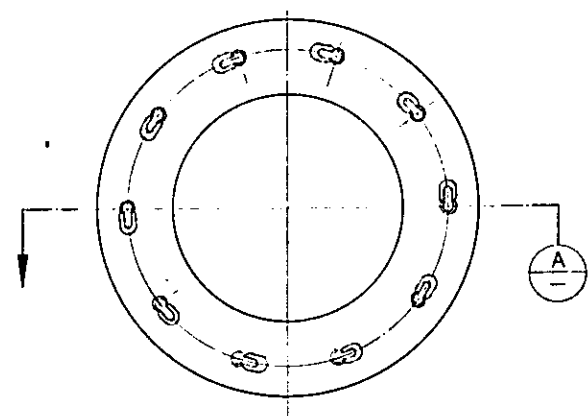


SECTION A-A

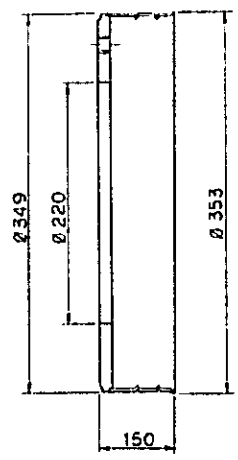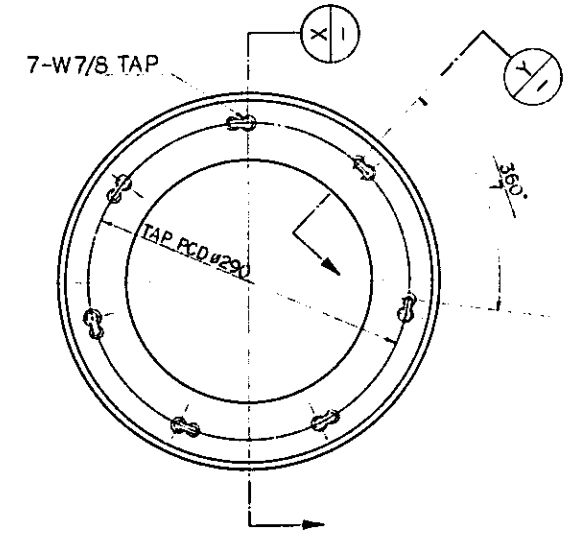

SECTION X-X

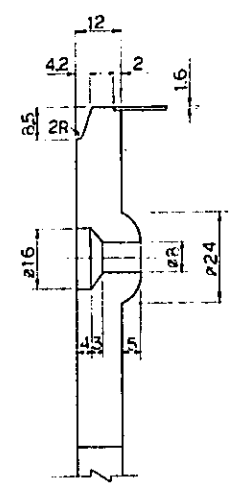


SECTION Y-Y

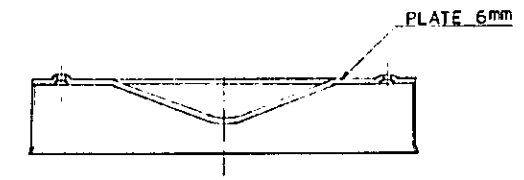


SECTION A-A  
SHOE

NOTE:  
ALL DIMENSIONS ARE SHOWN IN MILLIMETERS UNLESS OTHERWISE INDICATED.

|   |           |       |         |          |          |
|---|-----------|-------|---------|----------|----------|
| REPUBLIC OF INDONESIA<br>MINISTRY OF COMMUNICATIONS<br>DIRECTORATE GENERAL OF LAND TRANSPORT AND INLAND WATERWAYS |           |       |         |          |          |
| NEW RAILWAY LINE FOR CENGKARENG AIRPORT<br>CONSTRUCTION PROJECT   |           |       |         |          |          |
| JAPAN INTERNATIONAL COOPERATION AGENCY (JICA)   |           |       |         |          |          |
| A   | 1 AUG. 84 | K. J. | K. B.   | K. A.    | K. M.    |
| REVISIONS   | DATE      | DRAWN | CHECKED | REVIEWED | APPROVED |
| DETAILS OF PRESTRESSED CONCRETE PILES<br>(SHEET 2 OF 2)   |           |       |         |          |          |
| PACKAGE: I CIVIL AND ARCHITECTURAL WORK   |           |       |         |          |          |
| SCALE: NOT IN SCALE DRAWING NO: CS - 291  |           |       |         |          |          |

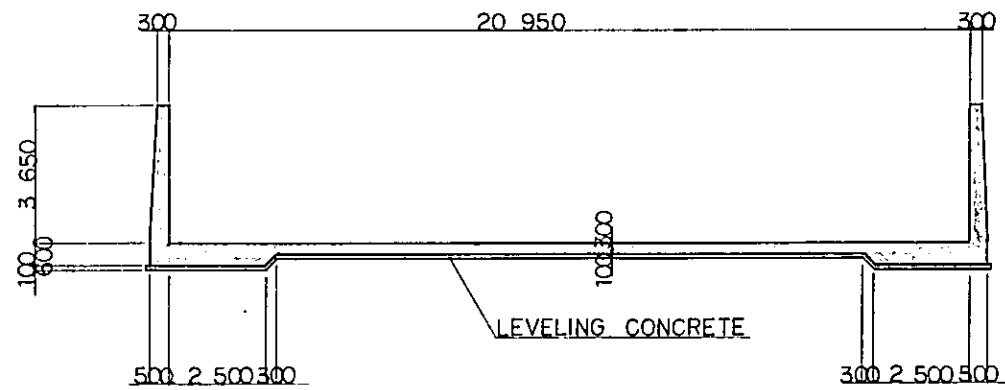


SECTION A

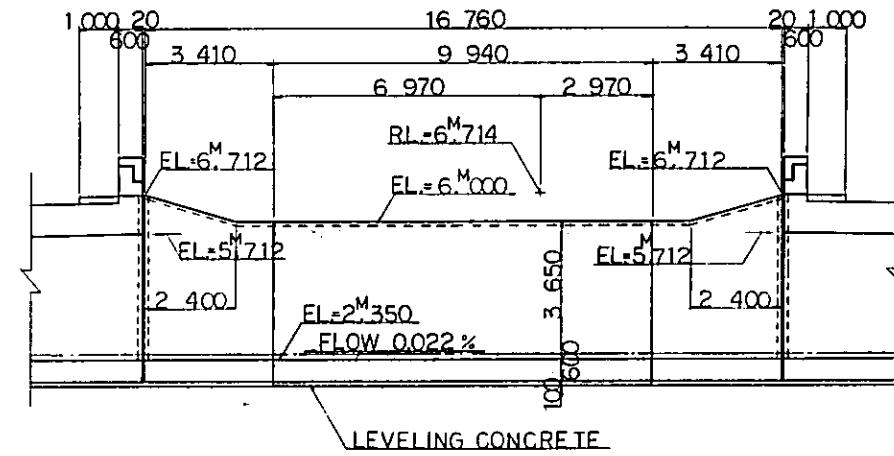

SECTION B




NOTE :

1. ALL DIMENSIONS ARE SHOWN IN MILLIMETERS UNLESS OTHERWISE INDICATED

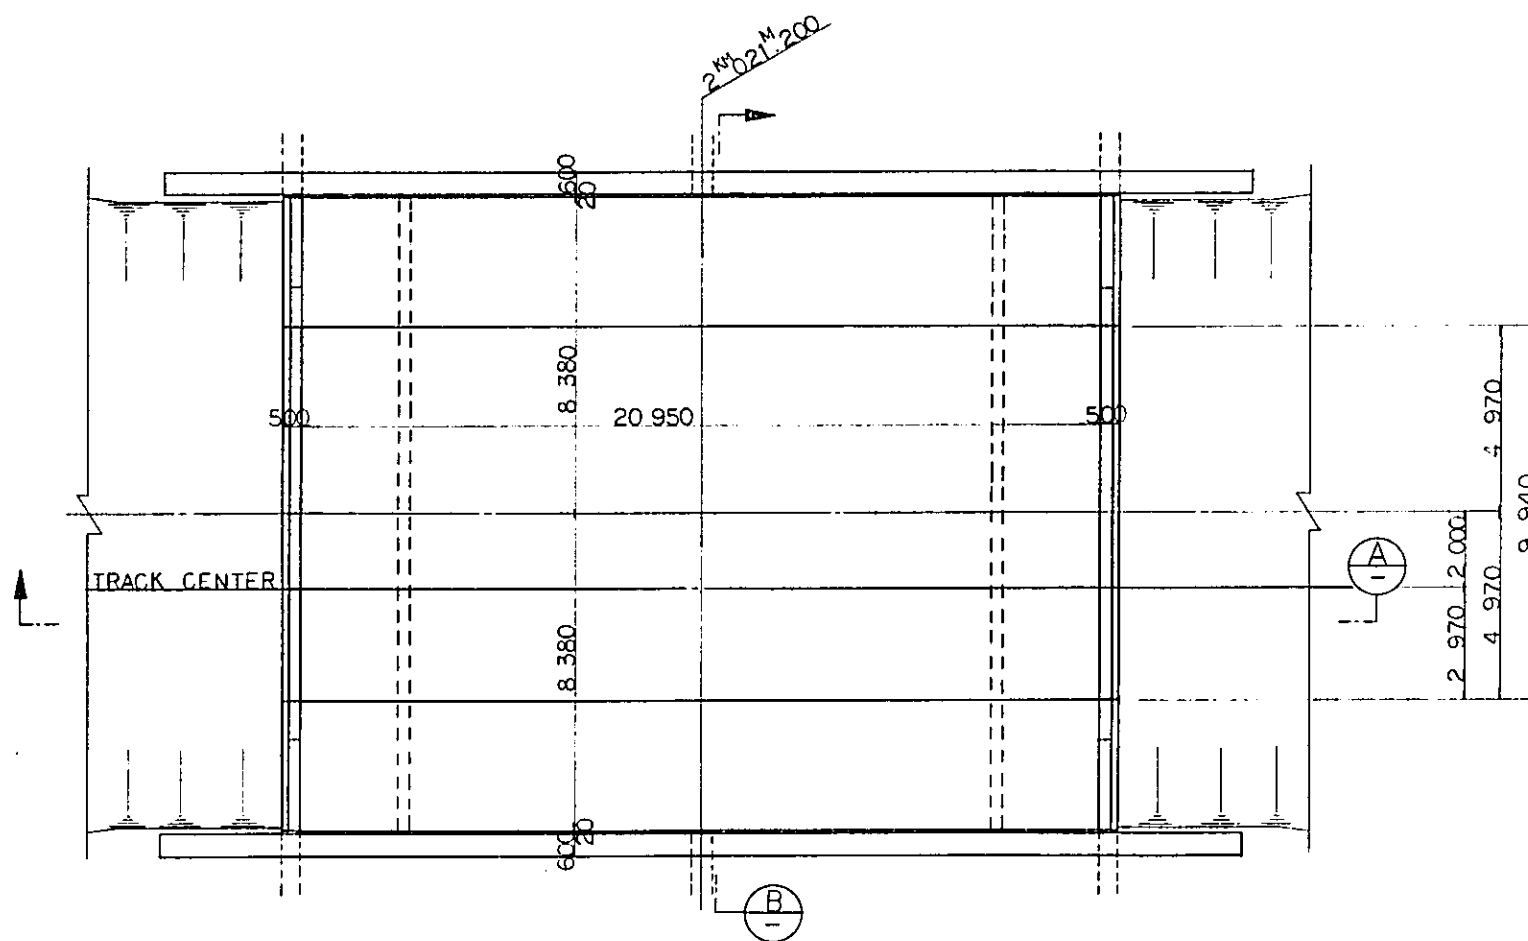

PLAN

|  |            |          |       |         |          |           |
|--|------------|----------|-------|---------|----------|-----------|
| REPUBLIC OF INDONESIA<br>MINISTRY OF COMMUNICATIONS<br>DIRECTORATE GENERAL OF LAND TRANSPORT<br>AND INLAND WATERWAYS |            |          |       |         |          |           |
| NEW RAILWAY LINE FOR CENGKARENG AIRPORT<br>CONSTRUCTION PROJECT  |            |          |       |         |          |           |
| JAPAN INTERNATIONAL COOPERATION AGENCY<br>(JICA)   |            |          |       |         |          |           |
| E  | 1 AUG. 84  | K.M.     | M.Y.  | K.A.    | K.M.     | M.K.      |
| A  | 15 FEB. 84 | K.M.     | M.Y.  | K.A.    | K.M.     | M.K.      |
| REVISIONS  | DATE       | DESIGNED | DRAWN | CHECKED | REVIEWED | SUBMITTED |
| DEMOLITION OF U SHAPED<br>REINFORCED CONCRETE DITCH<br>AT STA. 2+021.200   |            |          |       |         |          |           |
| PACKAGE: I CIVIL AND ARCHITECTURAL WORK  |            |          |       |         |          |           |
| SCALE: DRAWING NO.: CS-292   |            |          |       |         |          |           |

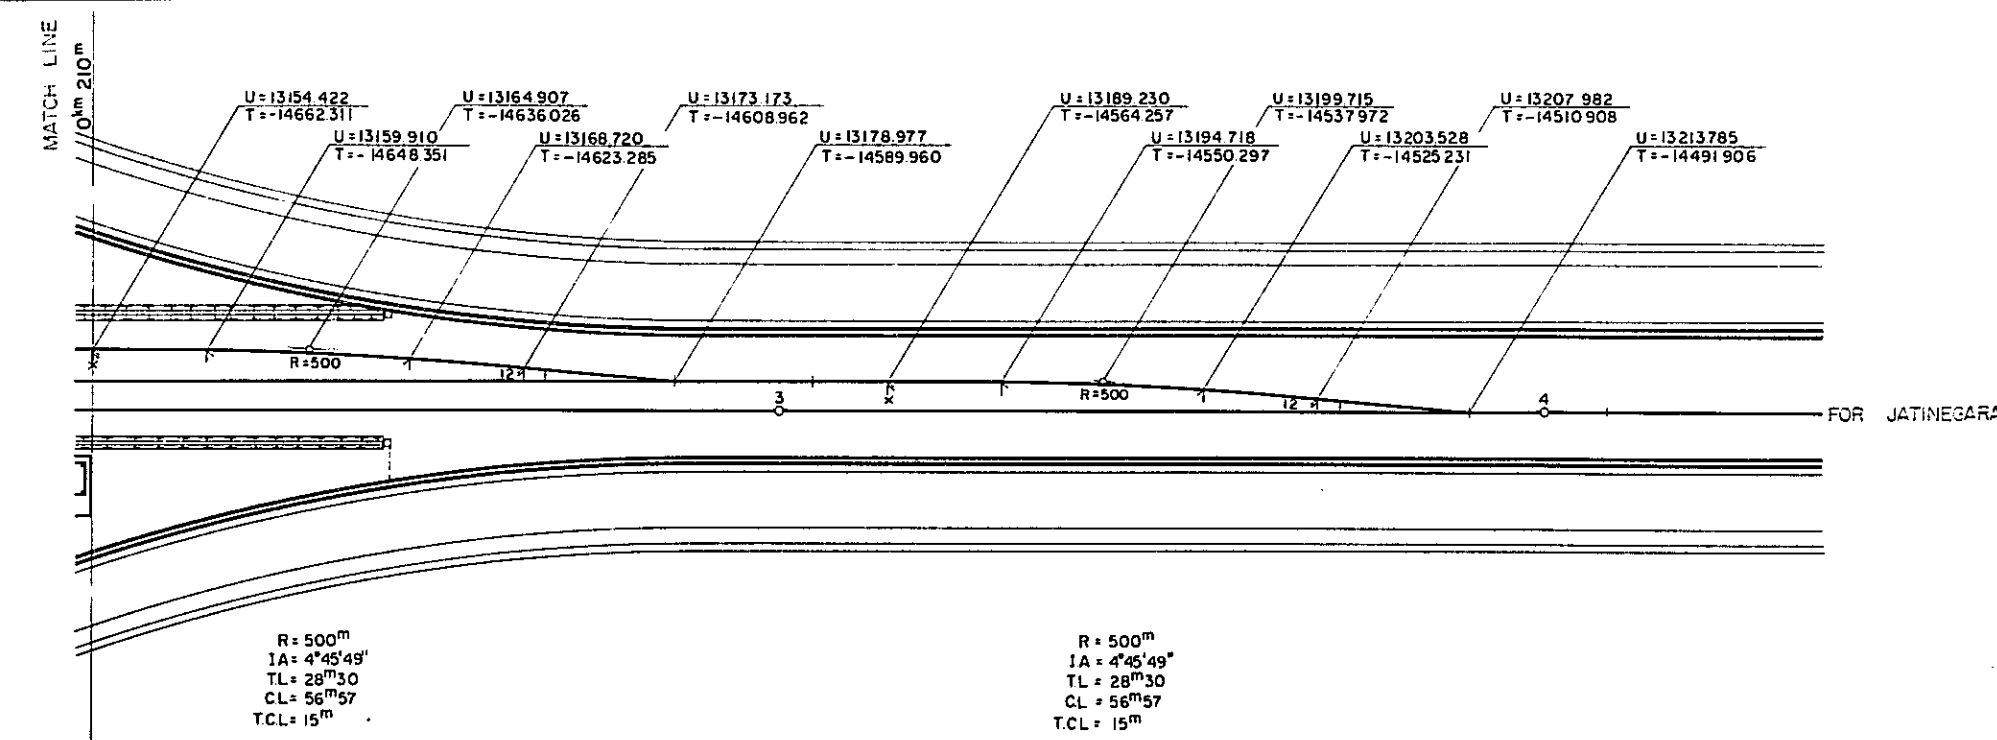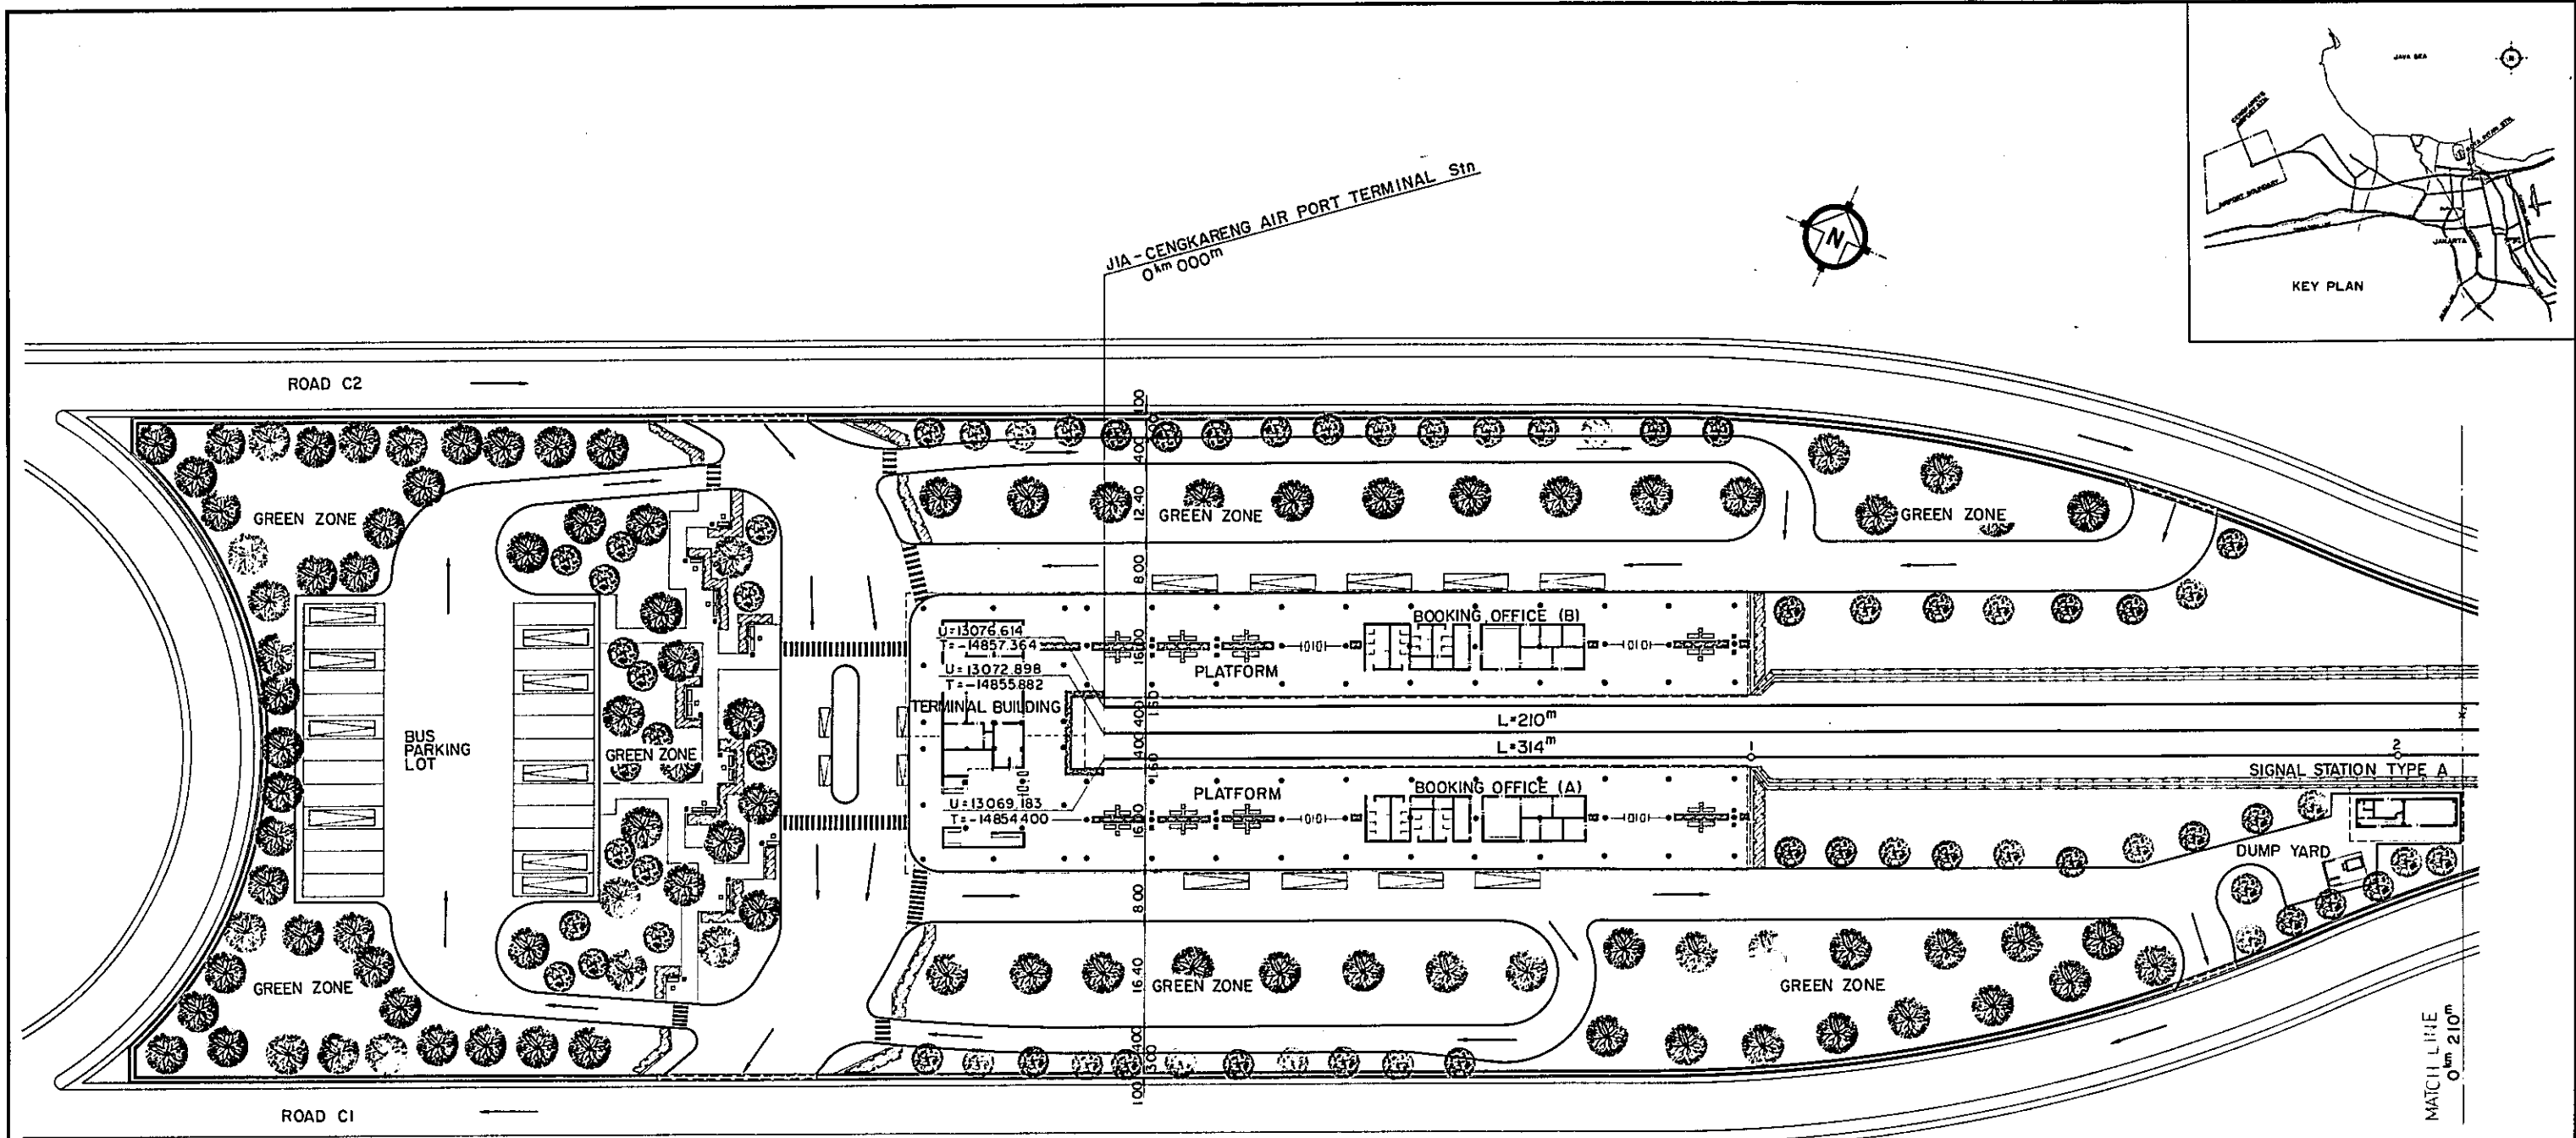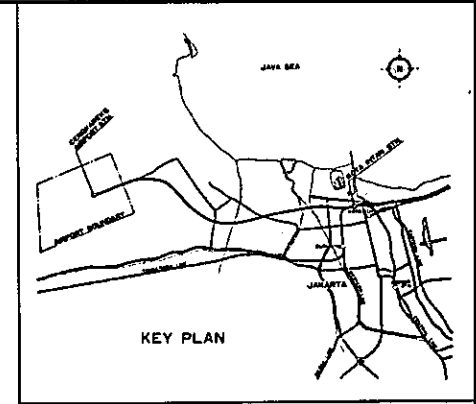

NOTE:  
ALL DIMENSIONS ARE SHOWN IN METERS UNLESS OTHERWISE INDICATED.

REPUBLIC OF INDONESIA  
MINISTRY OF COMMUNICATIONS  
DIRECTORATE GENERAL OF LAND TRANSPORT AND INLAND WATERWAYS

NEW RAILWAY LINE FOR CENGKARENG AIRPORT CONSTRUCTION PROJECT


JAPAN INTERNATIONAL COOPERATION AGENCY (JICA)

|   |             |    |    |    |    |    |    |    |    |
|---|-------------|----|----|----|----|----|----|----|----|
| B | 1. Aug. 04  | JJ | JJ | JJ | JJ | JJ | JJ | JJ | JJ |
| A | 15. Feb. 07 | JJ | JJ | JJ | JJ | JJ | JJ | JJ | JJ |


REVISIONS    DATE    DESIGNED    DRAWING    CHECKED    REVIEWED    SUBMITTED

PLAN OF JIAC


PACKAGE: 1 CIVIL AND ARCHITECTURAL WORK  
SCALE: 1:500    DRAWING NO: CA-001

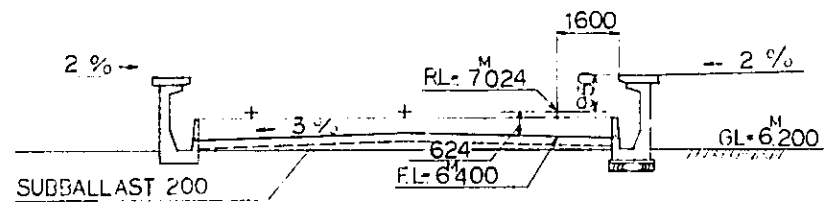


SECTION A-A  
SCALE 1:100

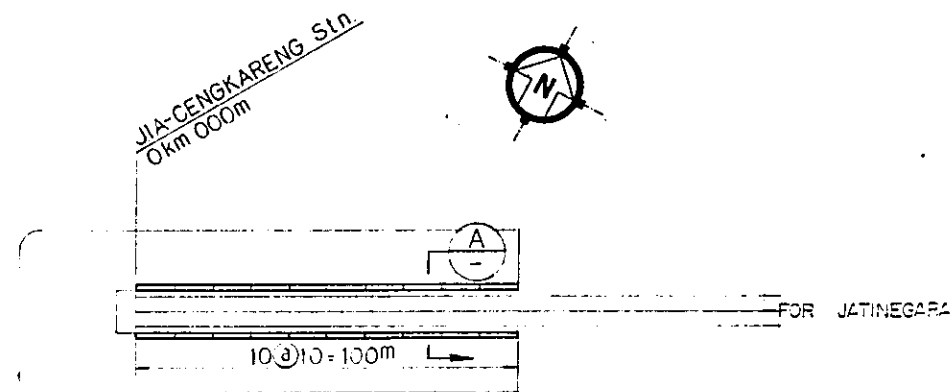


PLAN  
SCALE 1:1000

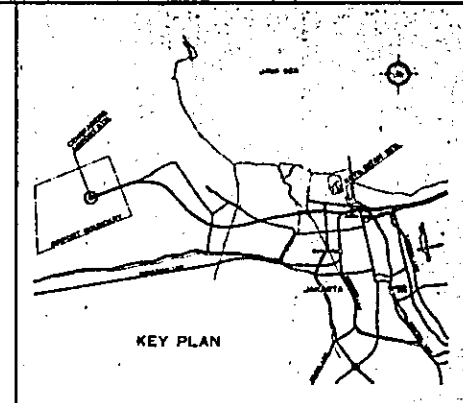


NOTE:  
ALL DIMENSIONS ARE SHOWN  
IN MILLIMETERS UNLESS  
OTHERWISE INDICATED.

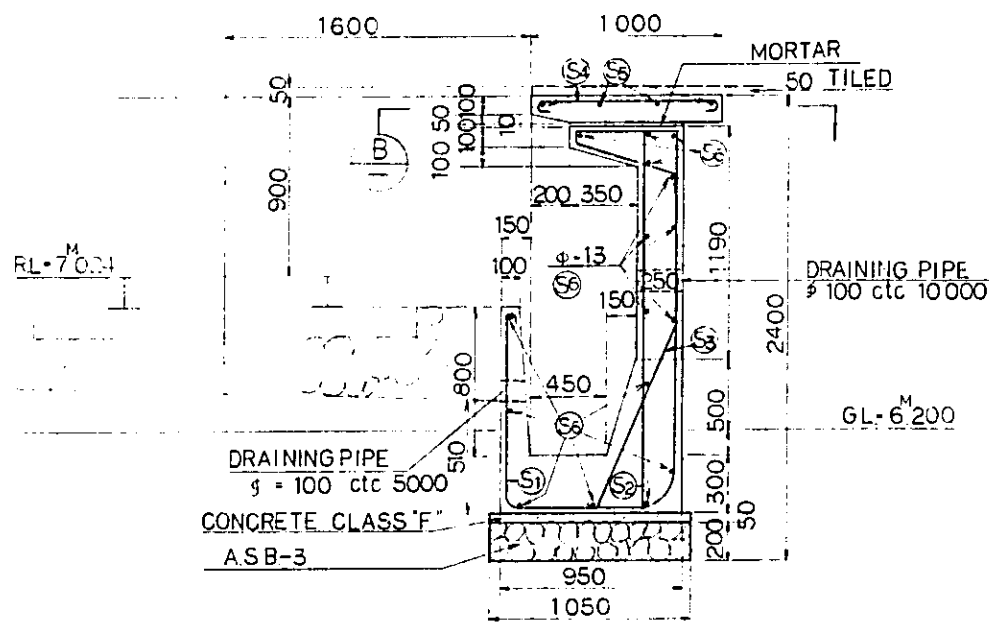

SECTION A-A  
SCALE 1:20

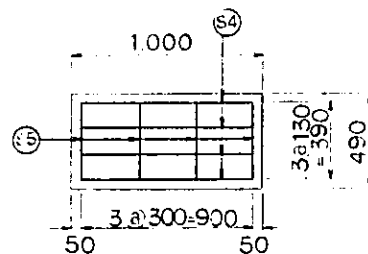

PLAN B-B  
SCALE 1:20

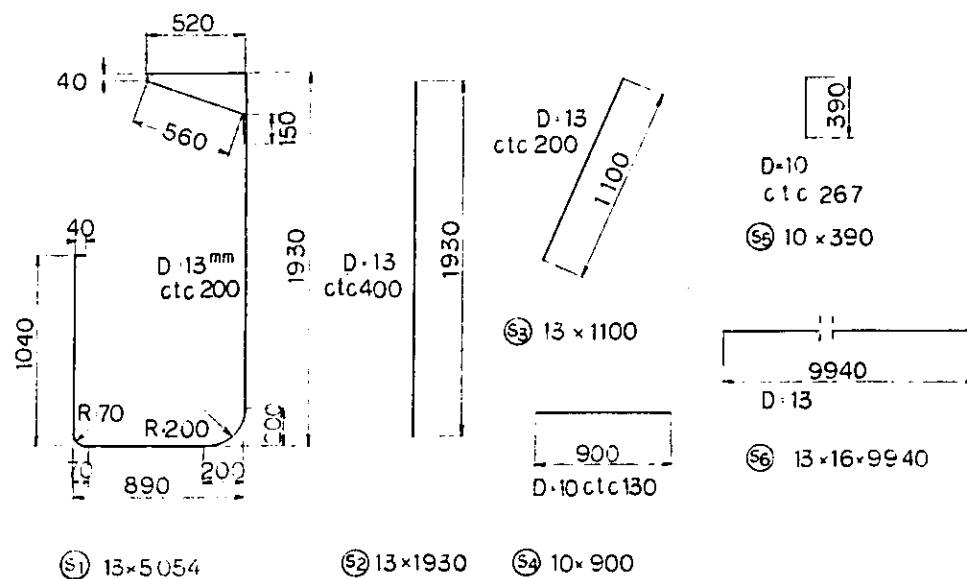

BAR SCHEDULE  
PASSENGER PLATFORM RETAINING WALL

| REIN. NO. | DIA. mm | LENGTH mm | NUMBER | UWEIGHT kg/m | WEIGHT kg | REMARKS |
|-----------|---------|-----------|--------|--------------|-----------|---------|
| S1        | 13      | 5054      | 50     | 0.995        | 251.4     | 10 m    |
| S2        | 13      | 1930      | 25     |              | 43.0      |         |
| S3        | 13      | 1100      | 50     |              | 54.7      |         |
| S4        | 9       | 800       | 80     | 0.560        | 35.8      |         |
| S5        | 9       | 390       | 80     |              | 17.5      |         |
| S6        | 13      | 9940      | 16     | 0.995        | 158.2     |         |
| TOTAL     |         |           |        |              | 565.6     |         |

REPUBLIC OF INDONESIA  
MINISTRY OF COMMUNICATIONS  
DIRECTORATE GENERAL OF LAND TRANSPORT  
AND INLAND WATERWAYS

NEW RAILWAY LINE FOR CENGKARENG AIRPORT  
CONSTRUCTION PROJECT

JAPAN INTERNATIONAL COOPERATION AGENCY  
(JICA)


|   |           |      |      |      |      |      |
|---|-----------|------|------|------|------|------|
| B | 1 Aug 82  | J.J. | S.J. | I.H. | K.M. | A.K. |
| A | 16 Feb 82 | J.J. | J.J. | K.A. | K.M. | A.K. |

REVISIONS DATE DESIGNED DRAWN CHECKED REVISIONS



PLATFORM WALL  
GENERAL VIEW  
AND  
BAR ARRANGEMENT

PACKAGE: I CIVIL AND ARCHITECTURAL WORK  
SCALE AS NOTED DRAWING NO. CA-002



# HYDRAULIC TRAIN STOPPER CONCRETE STRUCTURE

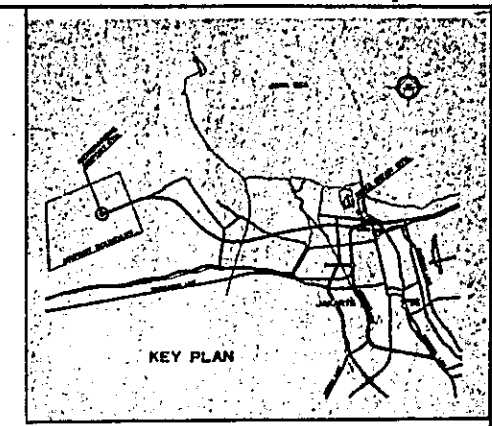

NOTE:  
ALL DIMENSIONS ARE SHOWN  
IN MILLIMETERS UNLESS  
OTHERWISE INDICATED.

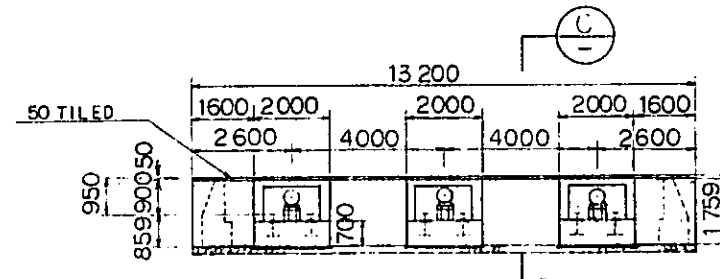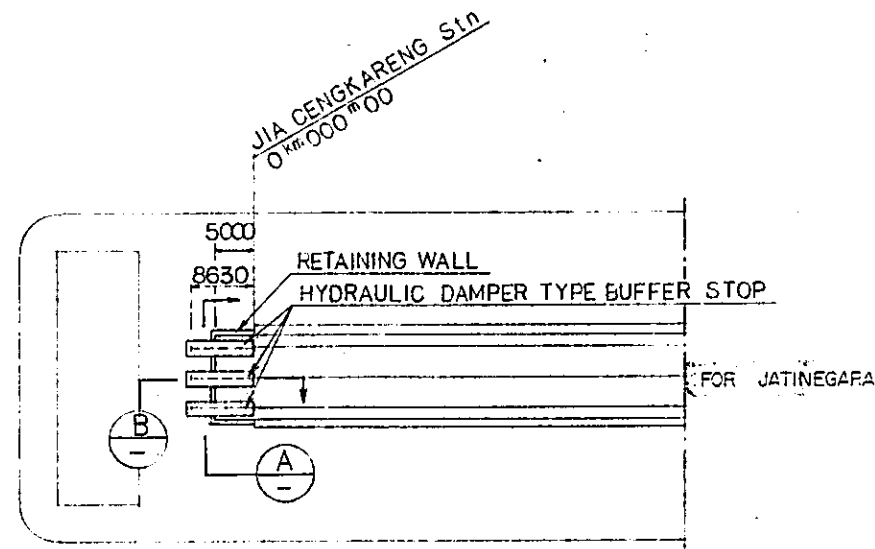


PLAN  
SCALE 1:500


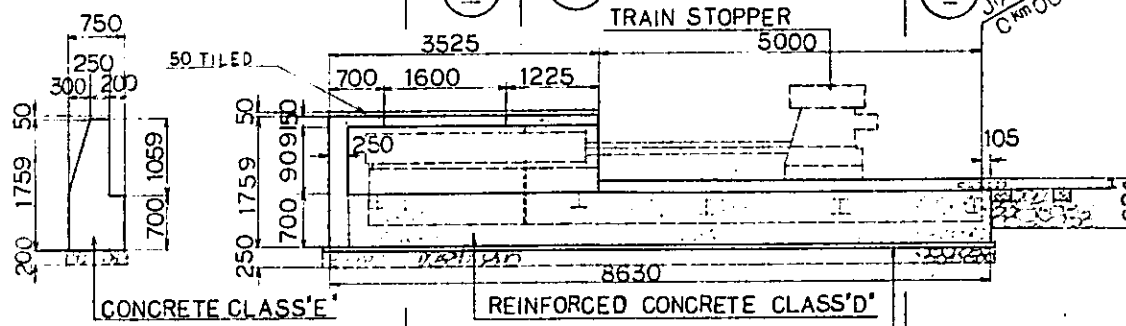
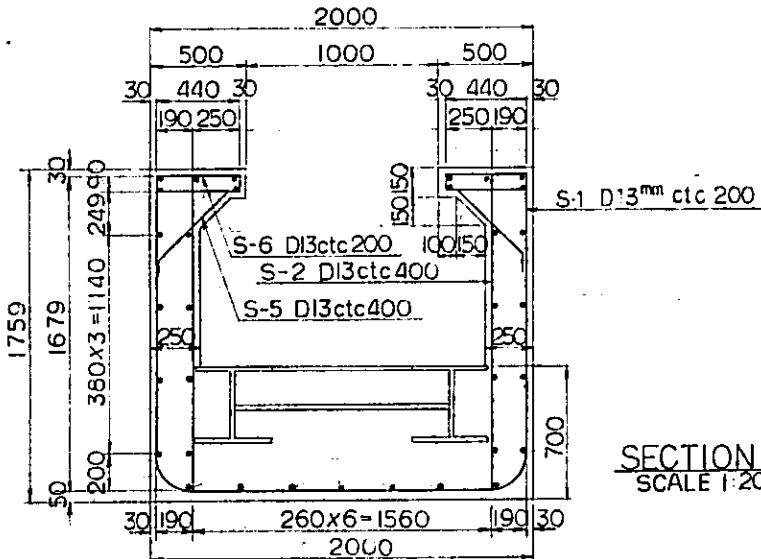


RETAINING WALL  
SECTION C  
SCALE 1:50

SECTION B  
SCALE 1:50


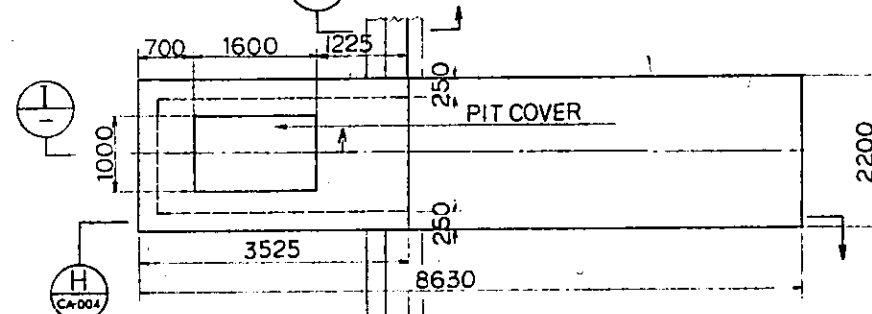


PLAN  
SCALE 1:50

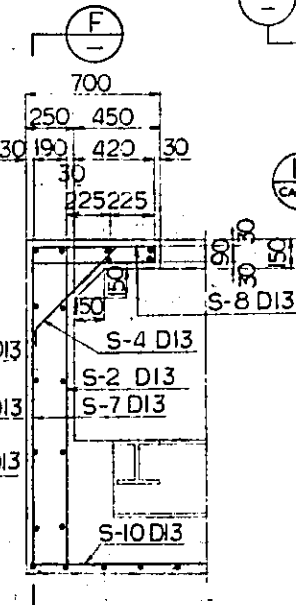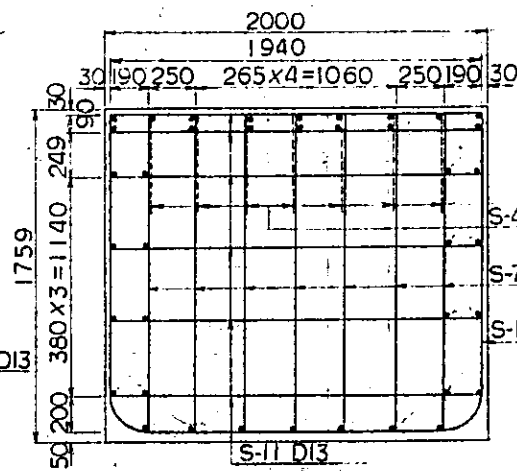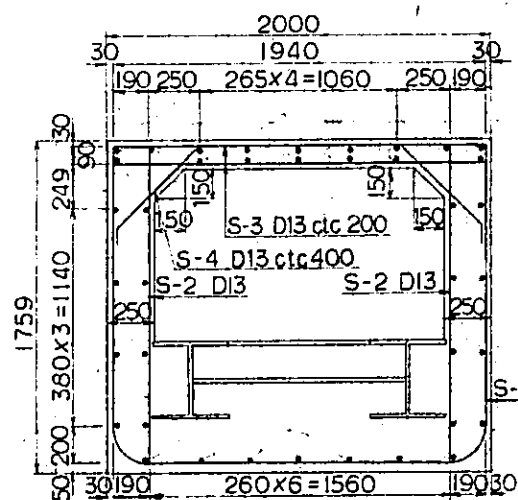


SECTION G  
SCALE 1:20

|   |                    |          |       |         |          |
|---|--------------------|----------|-------|---------|----------|
| REPUBLIC OF INDONESIA<br>MINISTRY OF COMMUNICATIONS,<br>DIRECTORATE GENERAL OF LAND TRANSPORT<br>AND INLAND WATERWAYS |                    |          |       |         |          |
| NEW RAILWAY LINE FOR CENGKARENG AIRPORT<br>CONSTRUCTION PROJECT   |                    |          |       |         |          |
| JAPAN INTERNATIONAL COOPERATION AGENCY<br>(JICA)  |                    |          |       |         |          |
| B   | 1. AUG. 01         | J.J.     | J.J.  | I.M.    | K.M.     |
| A   | 15. FEB. 04        | J.J.     | J.J.  | K.J.    | K.M.     |
| REVISIONS   | DATE               | DESIGNED | DRAWN | CHECKED | APPROVED |
| CONCRETE STRUCTURE FOR<br>HYDRAULIC DAMPER TYPE<br>BUFFER STOP<br>(SHEET 1 OF 2)                                      |                    |          |       |         |          |
| PACKAGE: I CIVIL AND ARCHITECTURAL WORK   |                    |          |       |         |          |
| SCALE: AS NOTED   | DRAWING NO: CA-003 |          |       |         |          |

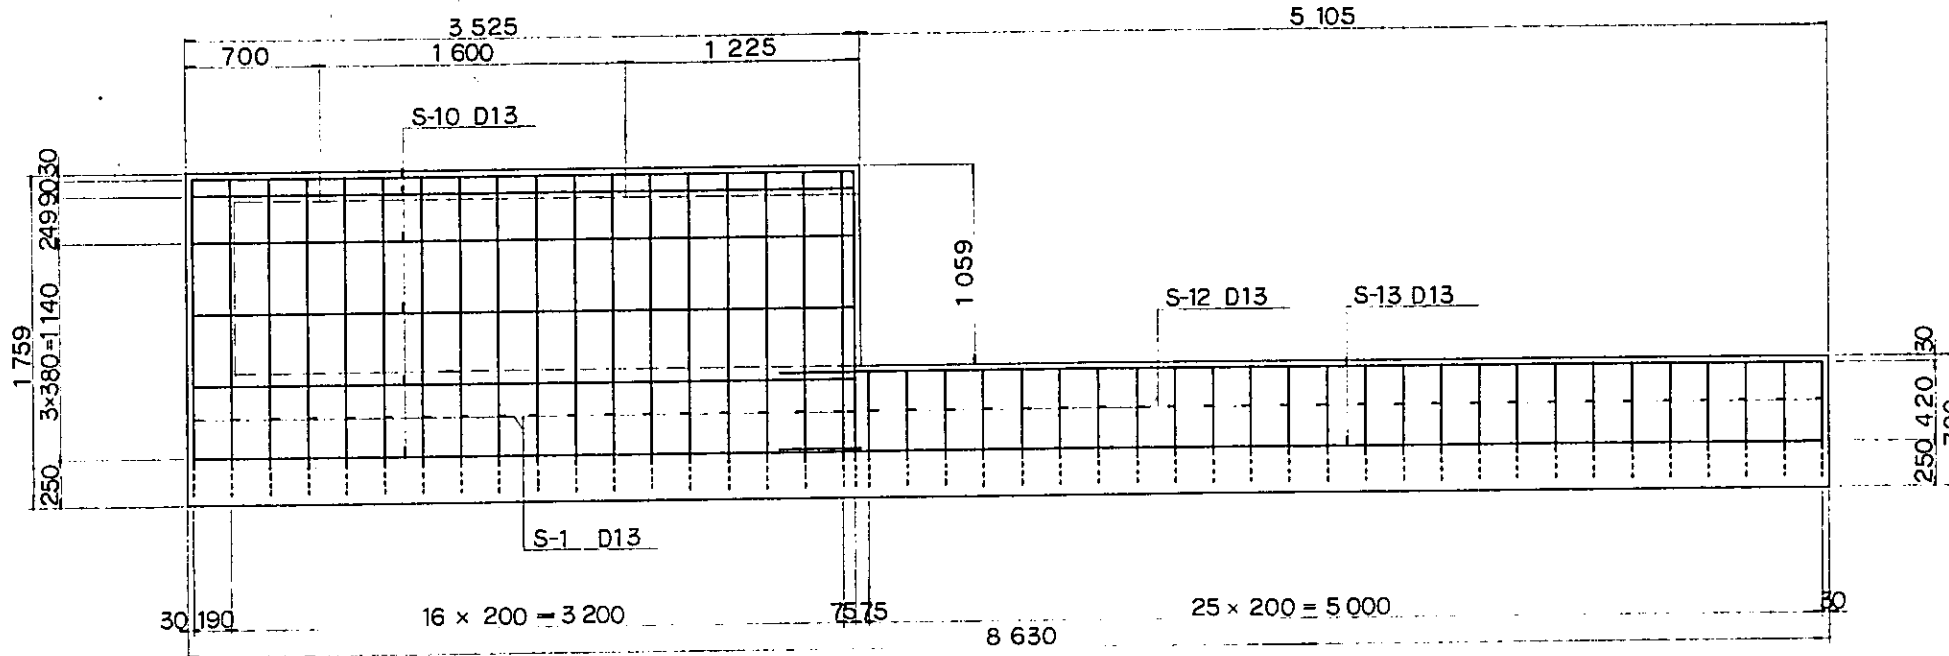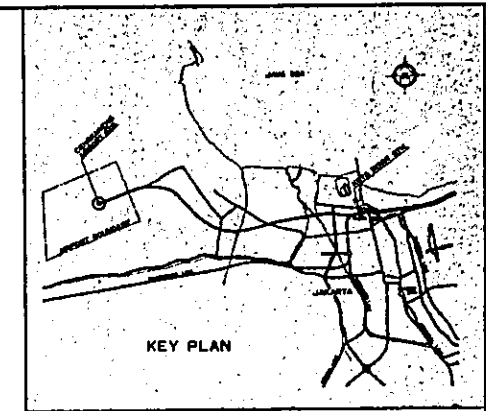

NOTE:  
ALL DIMENSIONS ARE SHOWN  
IN MILLIMETERS UNLESS  
OTHERWISE INDICATED.

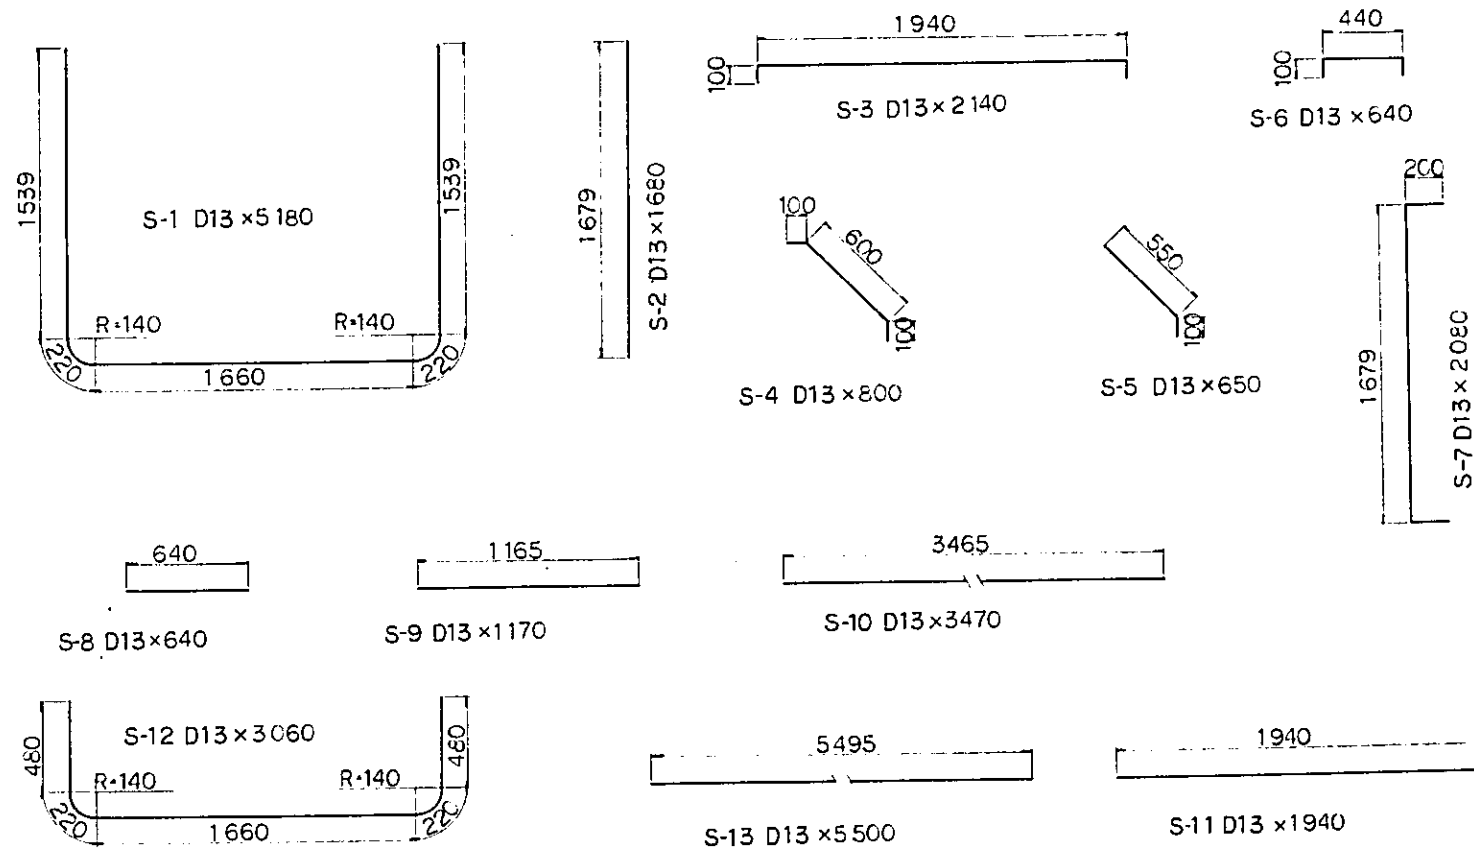

BAR SCHEDULE (PER EACH)

| REINF. NO | DIA. mm | LENGTH mm | NUMBER | U.WEIGHT kg/m | WEIGHT kg | REMARKS |
|-----------|---------|-----------|--------|---------------|-----------|---------|
| S 1       | D13     | 5180      | 19     | 0.995         | 979       |         |
| 2         |         | 1680      | 26     |               | 43.5      |         |
| 3         |         | 2140      | 20     |               | 42.6      |         |
| 4         |         | 800       | 12     |               | 9.6       |         |
| 5         |         | 650       | 8      |               | 5.2       |         |
| 6         |         | 640       | 32     |               | 20.4      |         |
| 7         |         | 2080      | 6      |               | 12.4      |         |
| 8         |         | 640       | 4      |               | 2.5       |         |
| 9         |         | 1170      | 4      |               | 4.7       |         |
| 10        |         | 3470      | 31     |               | 107.0     |         |
| 11        |         | 1940      | 6      |               | 11.6      |         |
| 12        |         | 3060      | 26     |               | 79.2      |         |
| 13        |         | 5500      | 11     |               | 60.2      |         |
| TOTAL     |         |           |        |               | 496.8     |         |

CONCRETE CLASS D 14.8 M<sup>3</sup>  
F 0.9  
SUBBALLAST 3.6

RETAINING WALL (PER METER)

|                  |                     |
|------------------|---------------------|
| CONCRETE CLASS E | 16.2 M <sup>3</sup> |
| SUBBALLAST       | 2.9                 |

REPUBLIC OF INDONESIA  
MINISTRY OF COMMUNICATIONS  
DIRECTORATE GENERAL OF LAND TRANSPORT  
AND INLAND WATERWAYS

NEW RAILWAY LINE FOR CENGKARENG AIRPORT  
CONSTRUCTION PROJECT


JAPAN INTERNATIONAL COOPERATION AGENCY  
(JICA)

| REVISIONS | DATE       | DESIGNED | DRAWN | CHECKED | APPROVED | SUBMITTED |
|-----------|------------|----------|-------|---------|----------|-----------|
| B         | 1 Aug. 89  | J.J      | J.J   | I.H     | K.M      | M.K       |
| A         | 15 Feb. 89 | J.J      | J.J   | K.W     | V.M      | M.K       |


CONCRETE STRUCTURE FOR  
HYDRAULIC DAMPER TYPE  
BUFFER STOP  
(SHEET 2 OF 2)

PACKAGE: I - CIVIL AND ARCHITECTURAL WORK


SCALE: AS NOTED DRAWING NO: CA-004

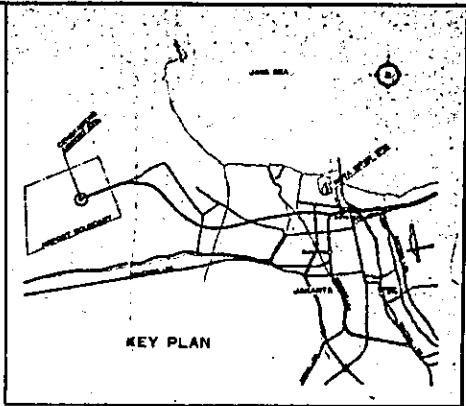


NOTE:  
ALL DIMENSIONS ARE SHOWN  
IN MILLIMETERS UNLESS  
OTHERWISE INDICATED.

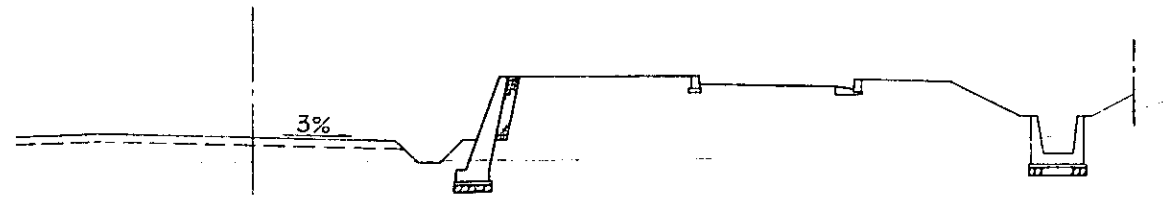


SECTION A  
SCALE 1:100

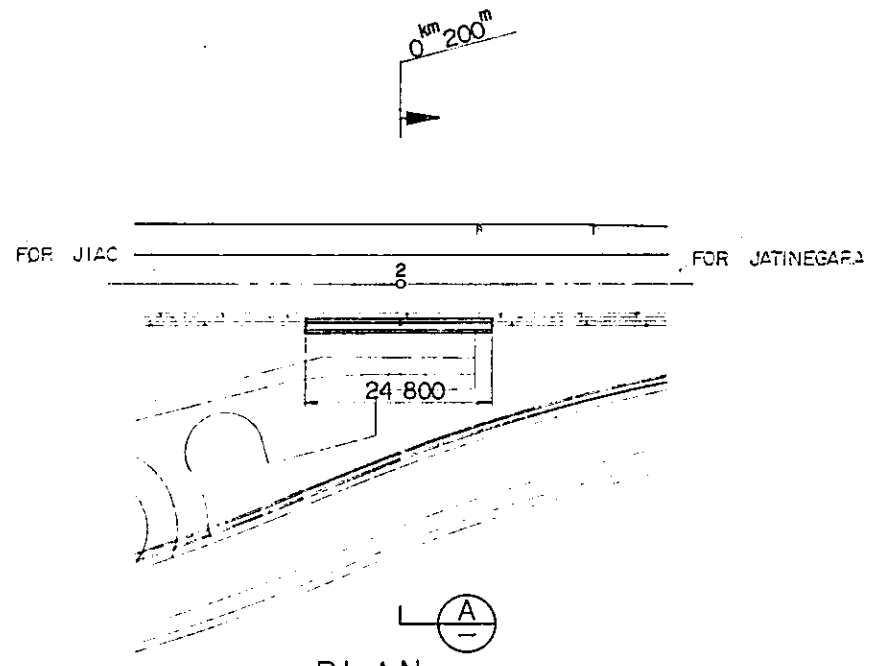

PLAN  
SCALE 1:500

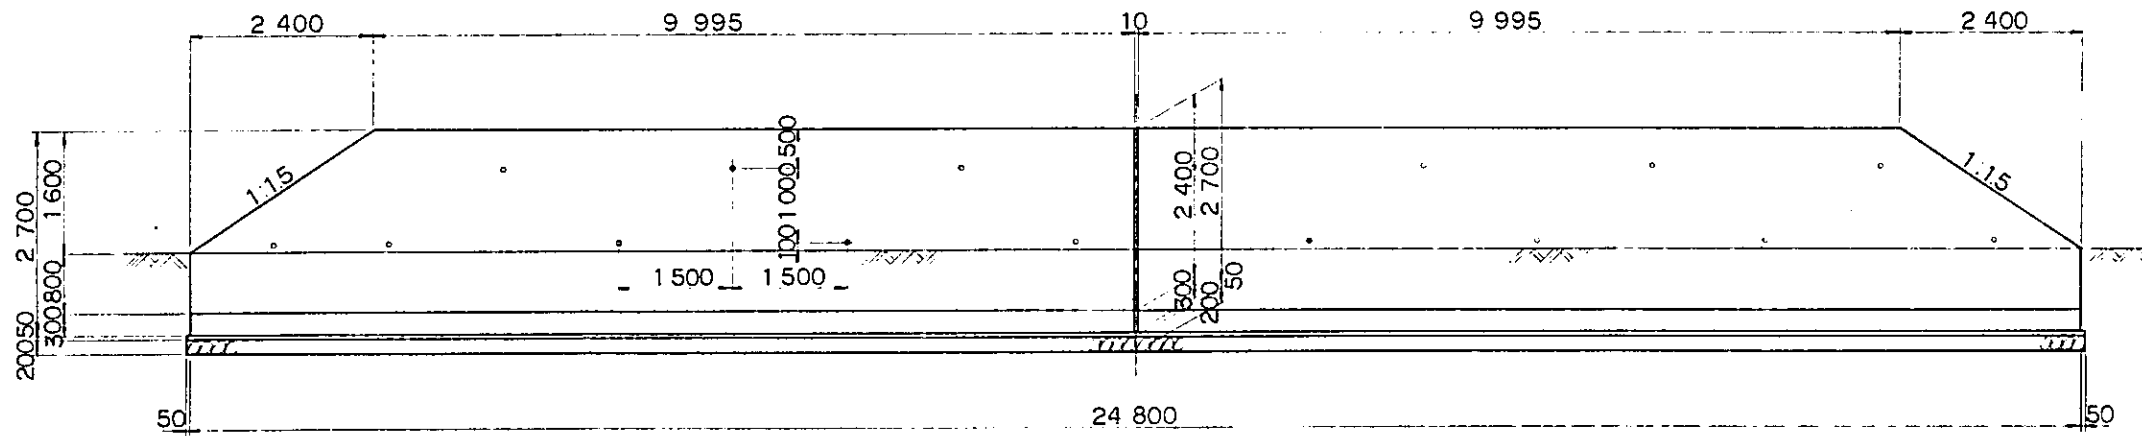

SIDE ELEVATION  
SCALE 1:50

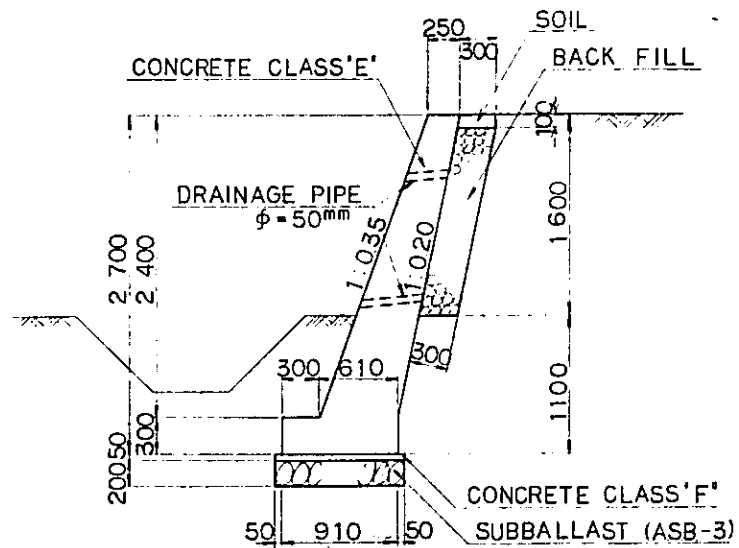

SECTION  
SCALE 1:30

MATERIAL LIST (PER EACH)

| DESCRIPTION   | UNIT           | QUANTITIES | REMARKS  |
|---------------|----------------|------------|----------|
| CONCRETE      | M <sup>3</sup> | 33.0       | CLASS E  |
|               |                | 0.8        | F        |
| SUBBALLAST    |                | 5.0        | ASB-3    |
| BACK FILL     |                | 10.4       |          |
| DRAINAGE PIPE | M              | 6.6        | φ = 50mm |

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NEW RAILWAY LINE FOR CENGKARENG AIRPORT  
CONSTRUCTION PROJECT

JAPAN INTERNATIONAL COOPERATION AGENCY  
(JICA)

|   |            |    |    |      |      |      |
|---|------------|----|----|------|------|------|
| B | 1. Aug 84  | JJ | JJ | IM   | K.M. | M.K. |
| A | 16. Feb 84 | JJ | JJ | K.G. | K.M. | M.K. |


REVISIONS    DATE    DESIGNED    DRAWN    CHECKED    REVIEWED    SUBMITTED

SEMI-GRAVITY TYPE  
RETAINING WALL  
FOR SIGNAL STATION  
AT STA. 0+200<sup>M</sup>

PACKAGE: I CIVIL AND ARCHITECTURAL WORK


SCALE: AS NOTED    DRAWING NO.: CA-005

CENKARENG AIRPORT Sth  
0km000m

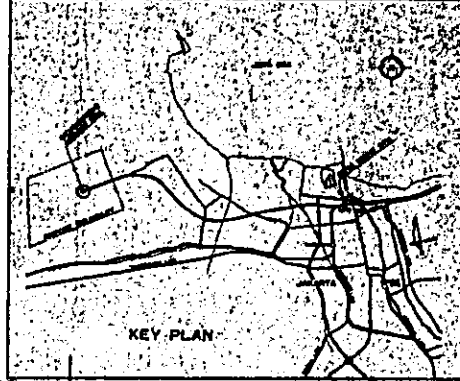


KEY PLAN

FOR JATINEGARA

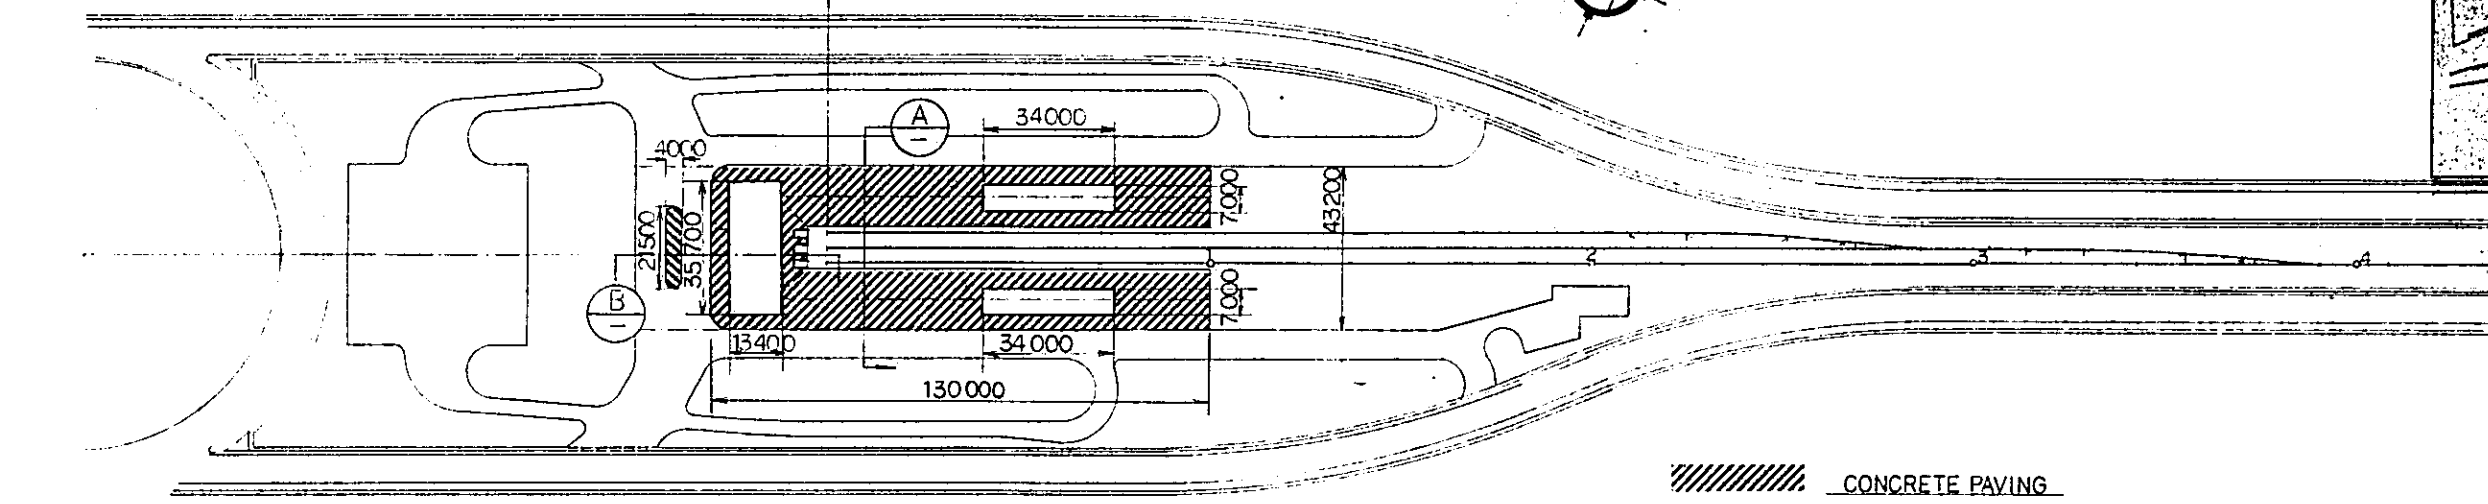


PLAN  
S-1:1000

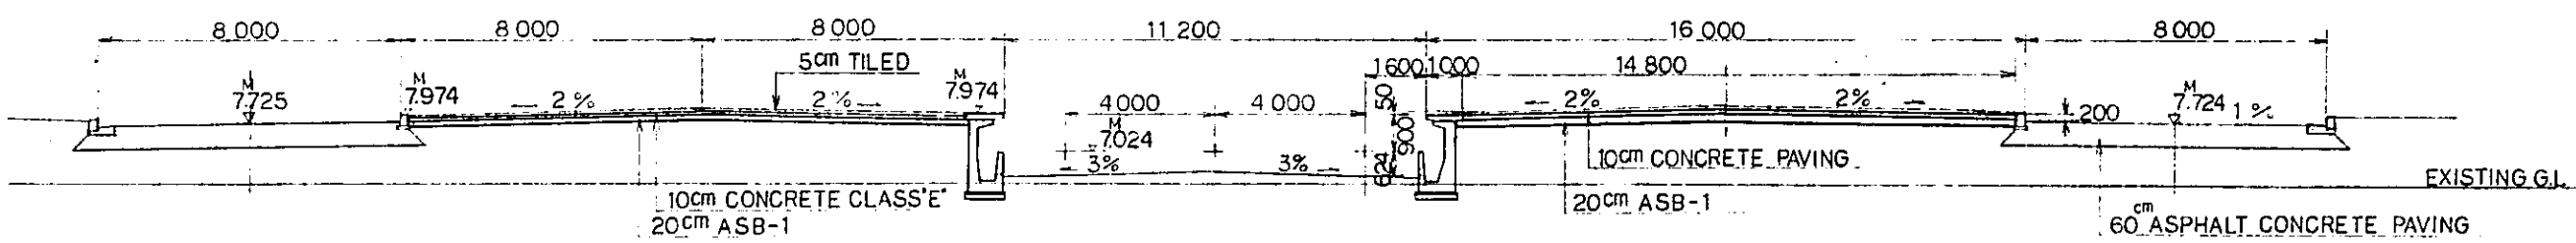

SECTION  
SCALE 1:100

NOTE:  
ALL DIMENSIONS ARE SHOWN  
IN MILLIMETERS UNLESS  
OTHERWISE INDICATED.


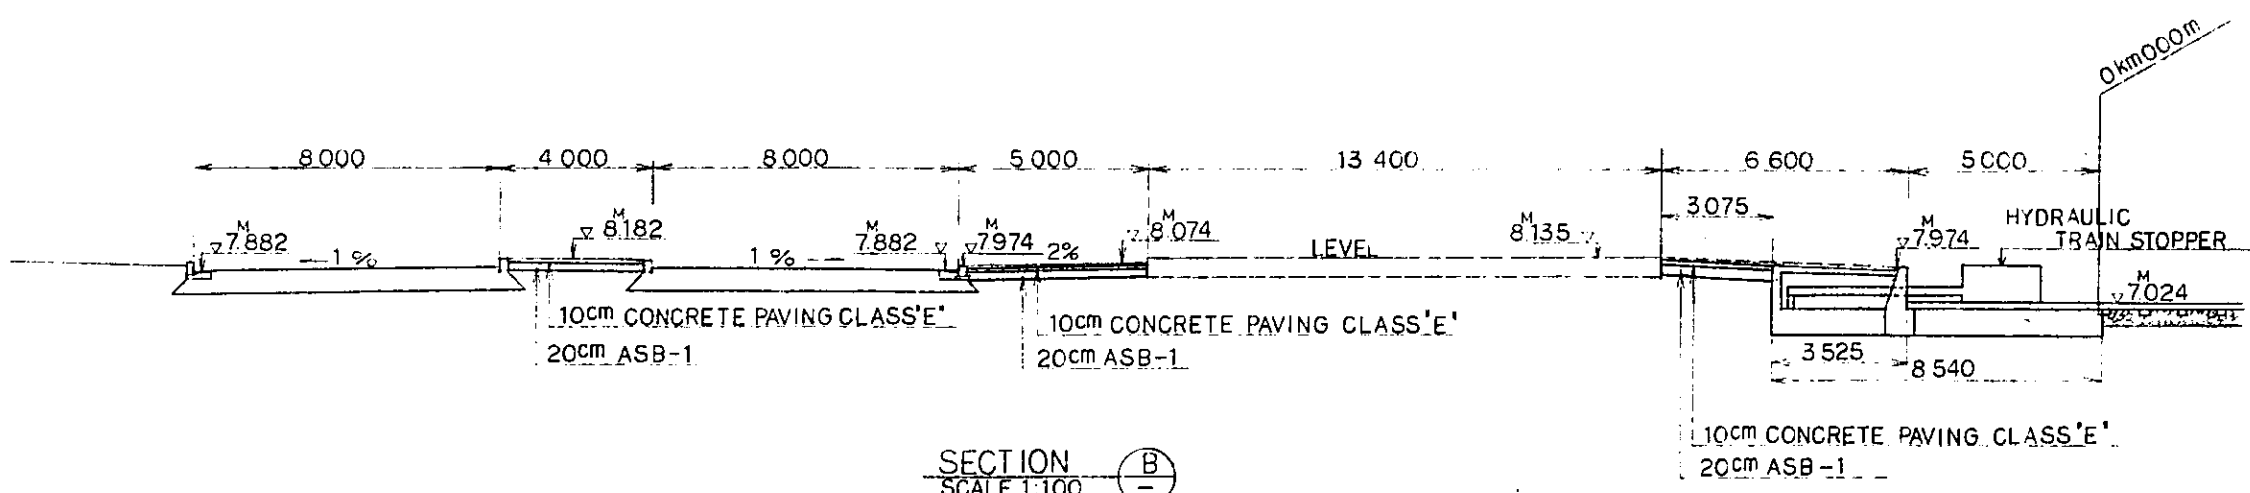


SECTION  
SCALE 1:100


|  |             |          |       |         |           |
|--|-------------|----------|-------|---------|-----------|
| REPUBLIC OF INDONESIA<br>MINISTRY OF COMMUNICATIONS<br>DIRECTORATE GENERAL OF LAND TRANSPORT<br>AND INLAND WATERWAYS |             |          |       |         |           |
| NEW RAILWAY LINE FOR CENKARENG AIRPORT<br>CONSTRUCTION PROJECT   |             |          |       |         |           |
| JAPAN INTERNATIONAL COOPERATION AGENCY<br>(JICA)   |             |          |       |         |           |
| B  | 1. Aug. 82  | J.J.     | J.J.  | I.M.    | R.M. A.K. |
| A  | 13. Feb. 79 | J.J.     | J.J.  | K.S.    | R.M. A.K. |
| REVISIONS  | DATE        | DESIGNED | DRAWN | CHECKED | APPROVED  |
| CONCRETE PAVING<br>IN<br>AIRPORT STATION YARD  |             |          |       |         |           |
| PACKAGE: I CIVIL AND ARCHITECTURAL WORK  |             |          |       |         |           |
| SCALE  | DRAWING NO. |          |       |         |           |
| AS NOTED   | CA-006      |          |       |         |           |



# CENKARENG AIRPORT STATION

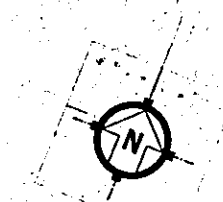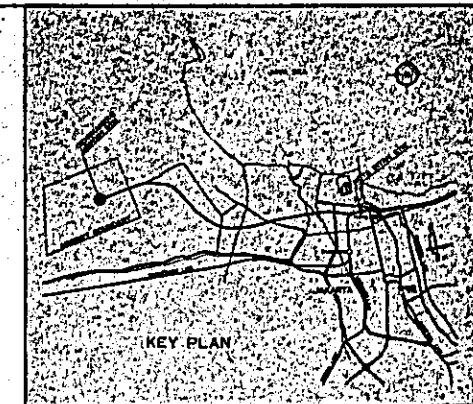

NOTE:  
ALL DIMENSIONS ARE SHOWN IN METERS, UNLESS OTHERWISE INDICATED.

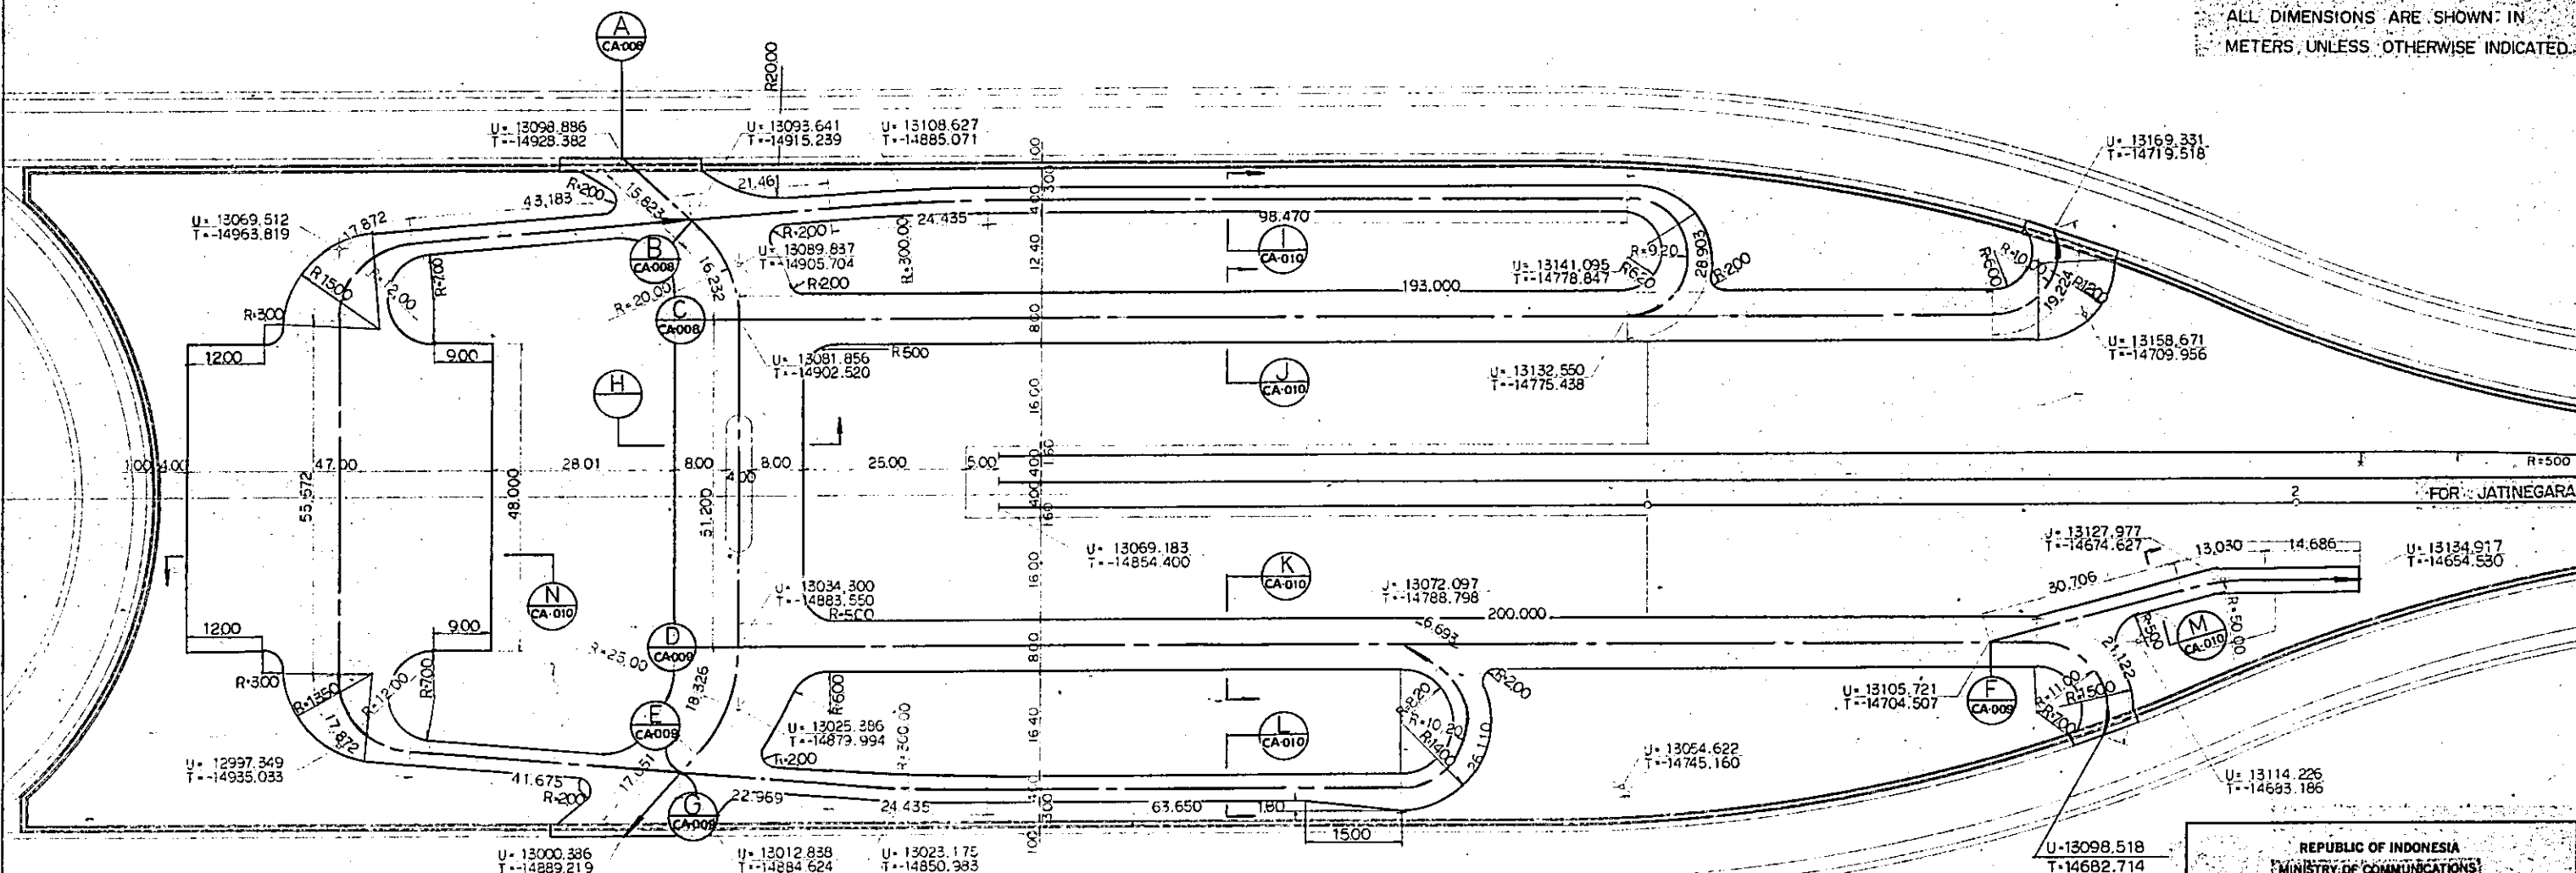

| ROAD LENGTH         |         |         |         |         |         |        |         | UNIT, m, m <sup>2</sup> |
|---------------------|---------|---------|---------|---------|---------|--------|---------|-------------------------|
| SECTION             | A       | B       | C       | D       | E       | F      | G       | TOTAL                   |
| LENGTH              | 118.632 | 173.269 | 212.224 | 221.122 | 143.857 | 58.422 | 176.174 | 1103.700                |
| ASPHALT PAVING AREA | 1724.8  | 1615.2  | 1608.1  | 666.5   | 485.7   | 183.0  | 2986.1  | 4321.3                  |

REPUBLIC OF INDONESIA  
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DIRECTORATE GENERAL OF LAND TRANSPORT AND INLAND WATERWAYS

NEW RAILWAY LINE FOR CENKARENG AIRPORT CONSTRUCTION PROJECT

JAPAN INTERNATIONAL COOPERATION AGENCY (JICA)


|   |             |     |     |     |      |     |
|---|-------------|-----|-----|-----|------|-----|
| B | 1. Nov. 89  | J.J | J.J | I.H | K.Y. | M.K |
| A | 15. Feb. 86 | J.J | J.J | K.S | U.Y. | M.R |

REVISIONS DATE DESIGNED DRAWN CHECKED REVIEWED SUBMITTED


INTERNAL ROADS DETAIL IN AIRPORT STATION AREA

PACKAGE: I CIVIL AND ARCHITECTURAL WORK


SCALE: AS NOTED DRAWING NO: CA-007

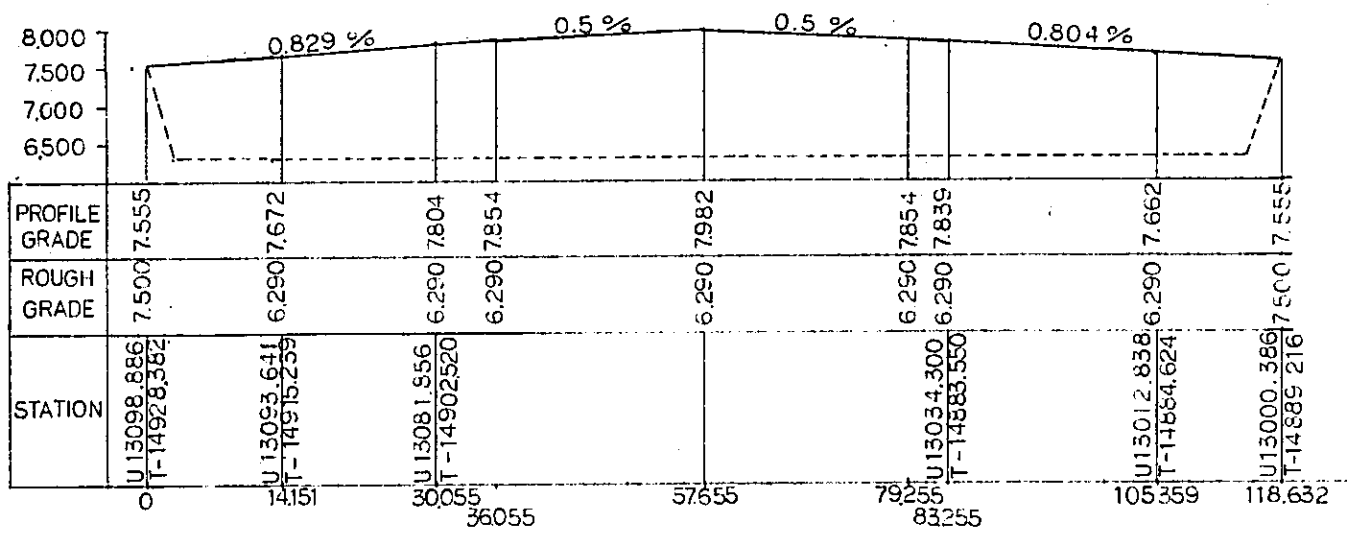


SECTION A  
SCALE V:1:50  
H:1:400

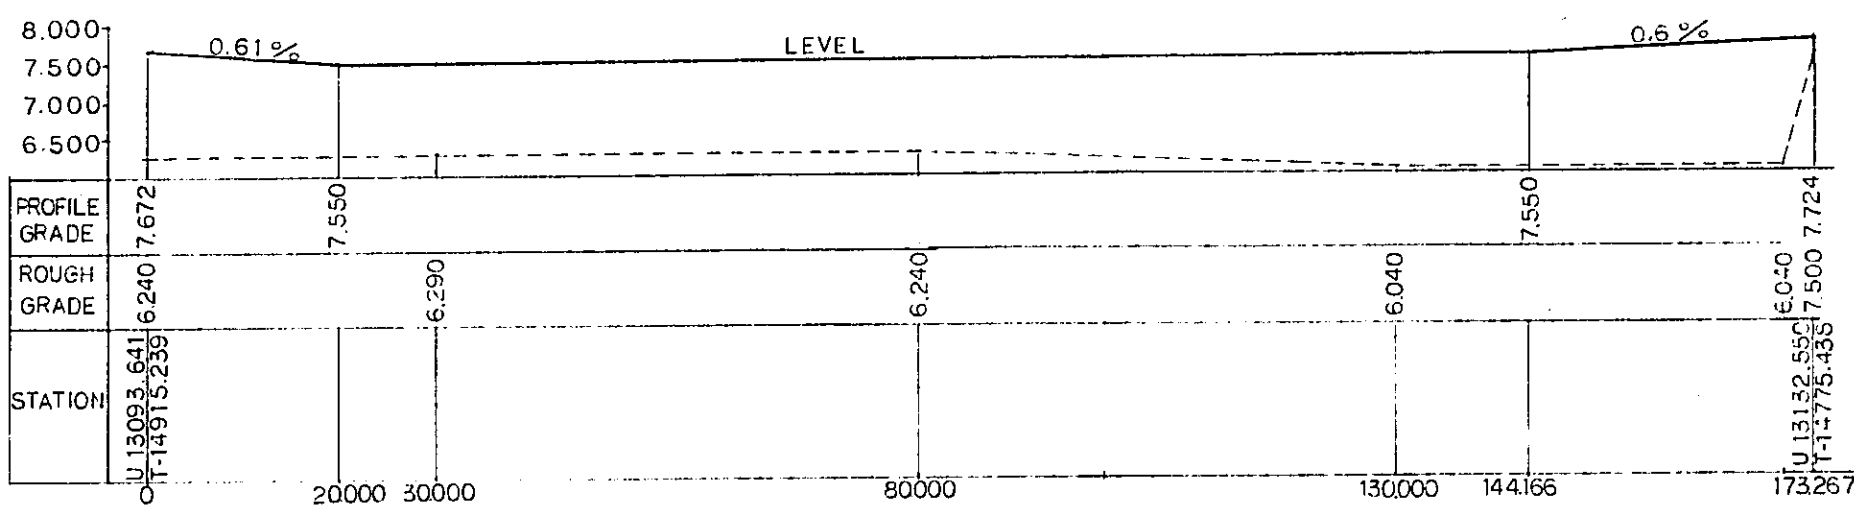

SECTION B  
SCALE V:1:50  
H:1:400

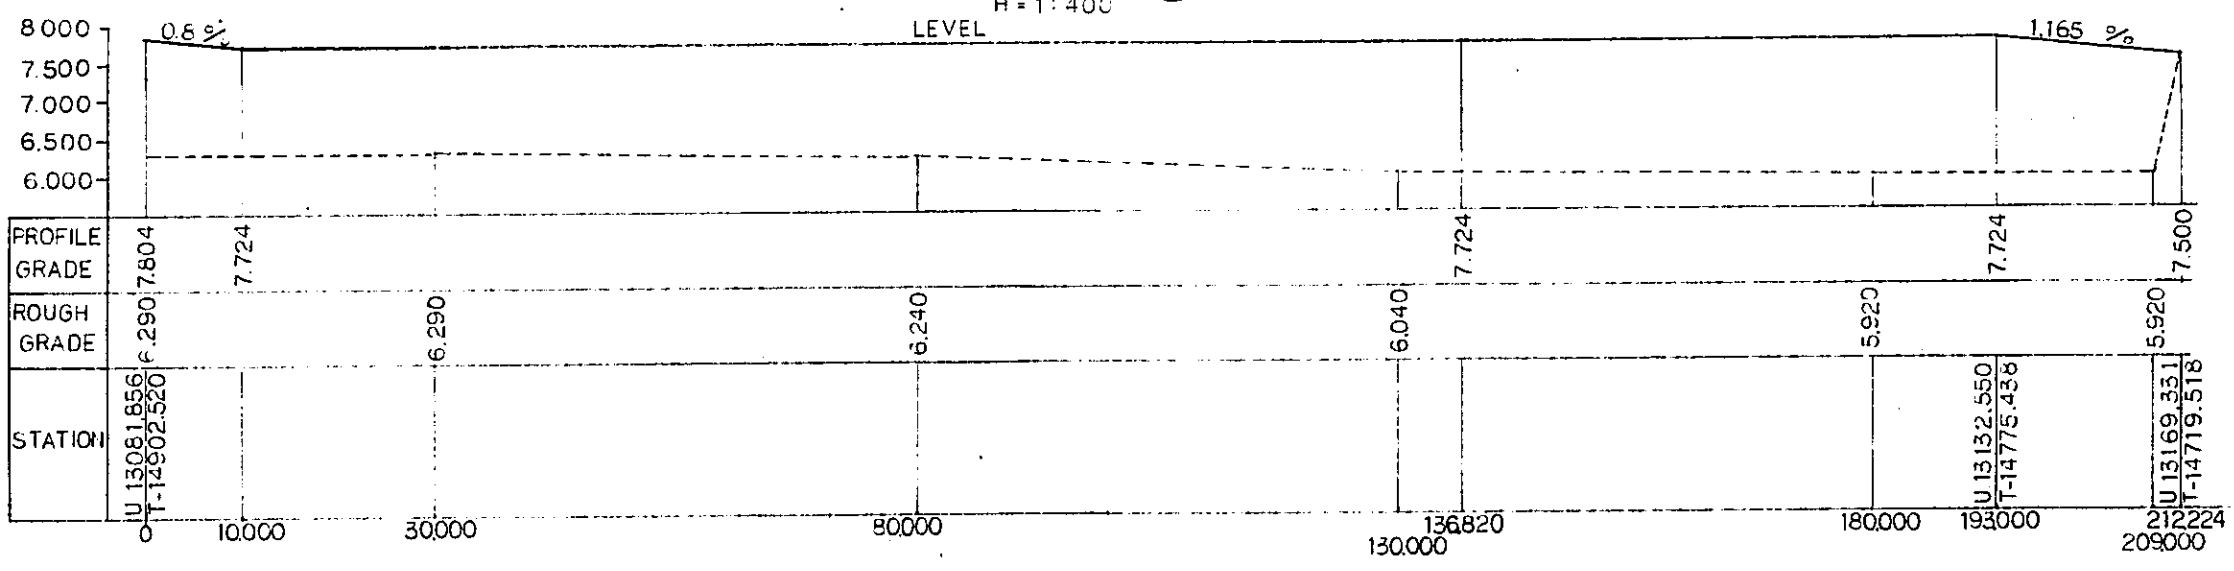

SECTION C  
SCALE V:1:50  
H:1:400

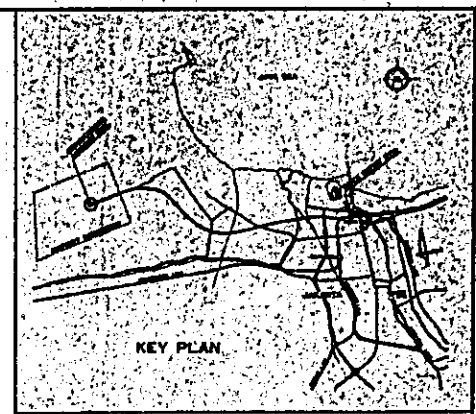

NOTE:  
ALL DIMENSIONS ARE SHOWN IN METERS UNLESS OTHERWISE INDICATED.

REPUBLIC OF INDONESIA  
MINISTRY OF COMMUNICATIONS  
DIRECTORATE GENERAL OF LAND TRANSPORT AND INLAND WATERWAYS


NEW RAILWAY LINE FOR CENGKARENG AIRPORT  
CONSTRUCTION PROJECT

JAPAN INTERNATIONAL COOPERATION AGENCY (JICA)


|           |             |          |       |         |          |          |
|-----------|-------------|----------|-------|---------|----------|----------|
| REVISIONS | DATE        | DESIGNED | DRAWN | CHECKED | REVIEWED | APPROVED |
| B         | 1. Aug. 09  | J.J      | J.J   | J.U     | K.M      | M.K      |
| A         | 15. Feb. 09 | J.J      | J.J   | K.U     | K.M      | M.K      |

PROFILE OF INTERNAL ROADS (SHEET 1 OF 2)


PACKAGE: I CIVIL AND ARCHITECTURAL WORK  
SCALE: AS NOTED DRAWING NO: CA-008

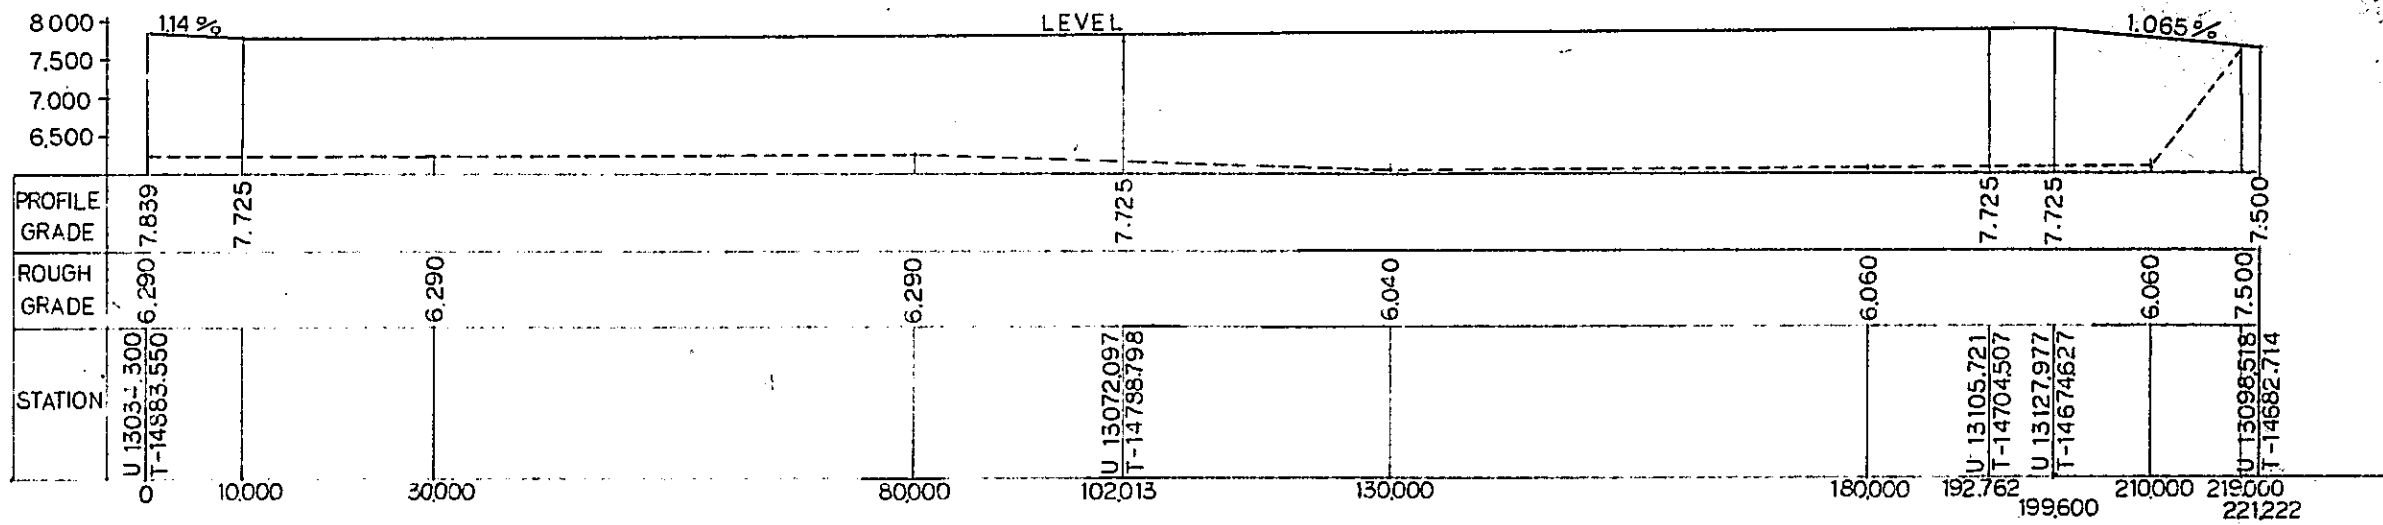


SECTION D  
SCALE V = 1:50  
H = 1:400

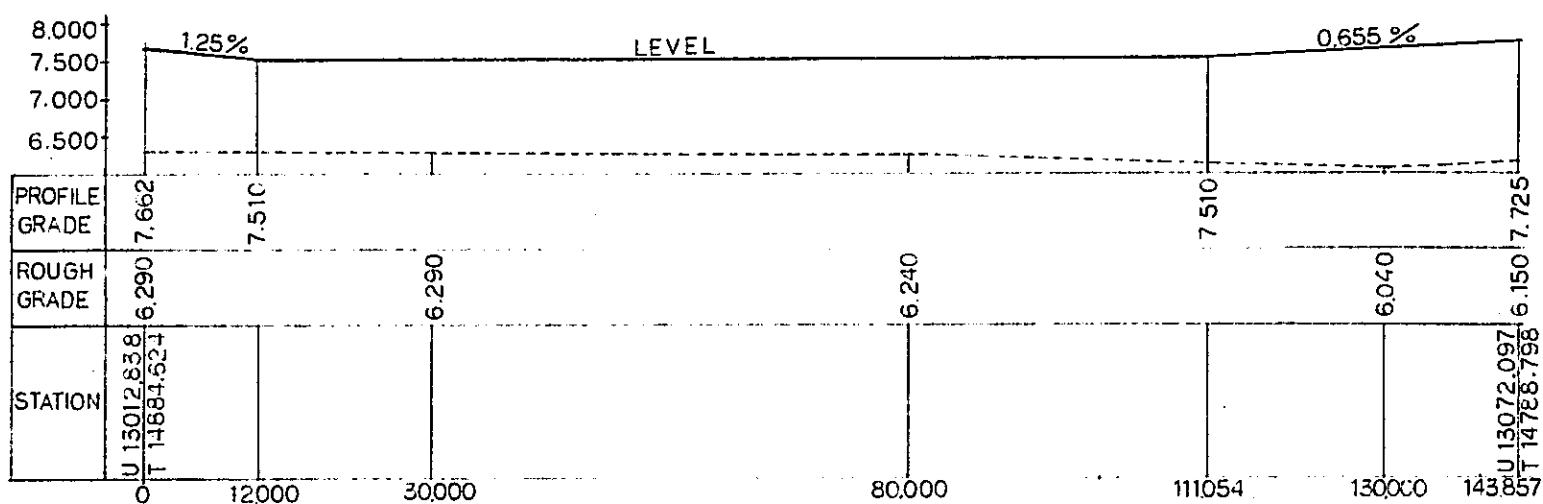


SECTION E  
SCALE V = 1:50  
H = 1:400

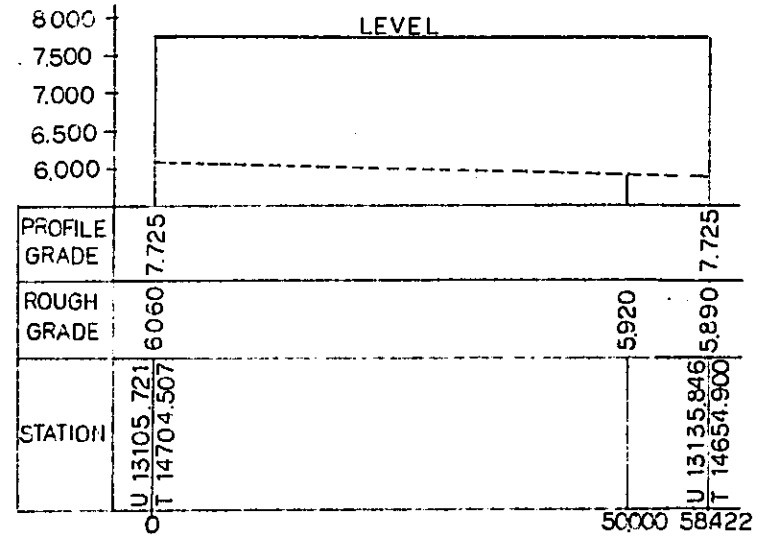

SECTION F  
SCALE V = 1:50  
H = 1:400

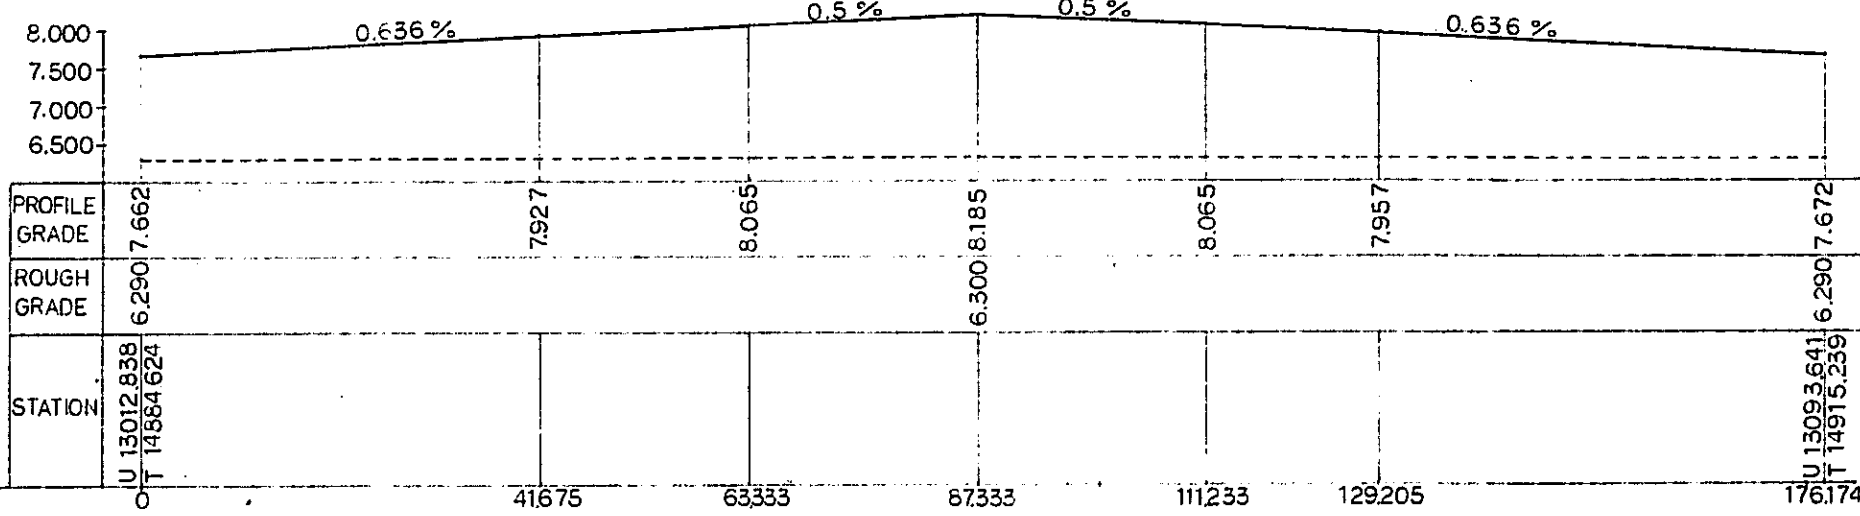

SECTION G  
SCALE V = 1:50  
H = 1:400

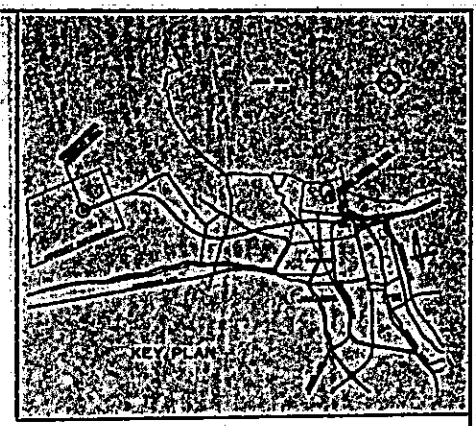

NOTE:  
ALL DIMENSIONS ARE SHOWN IN METERS UNLESS OTHERWISE INDICATED.

REPUBLIC OF INDONESIA  
MINISTRY OF COMMUNICATIONS  
DIRECTORATE GENERAL OF LAND, TRANSPORT AND INLAND WATERWAYS

NEW RAILWAY LINE FOR CENGKARENG AIRPORT  
CONSTRUCTION PROJECT

JAPAN INTERNATIONAL COOPERATION AGENCY (JICA)


|   |             |      |      |      |      |      |
|---|-------------|------|------|------|------|------|
| B | 1. Nov. 69  | J.T. | J.T. | 1.4  | K.W. | A.K. |
| A | 18. Feb. 69 | J.T. | J.T. | K.O. | K.W. | A.K. |

REVISIONS


PROFILE OF INTERNAL ROADS (SHEET 2 OF 2)

PACKAGE: CIVIL AND ARCHITECTURAL WORK


SCALE: AS NOTED DRAWING NO: CA-009

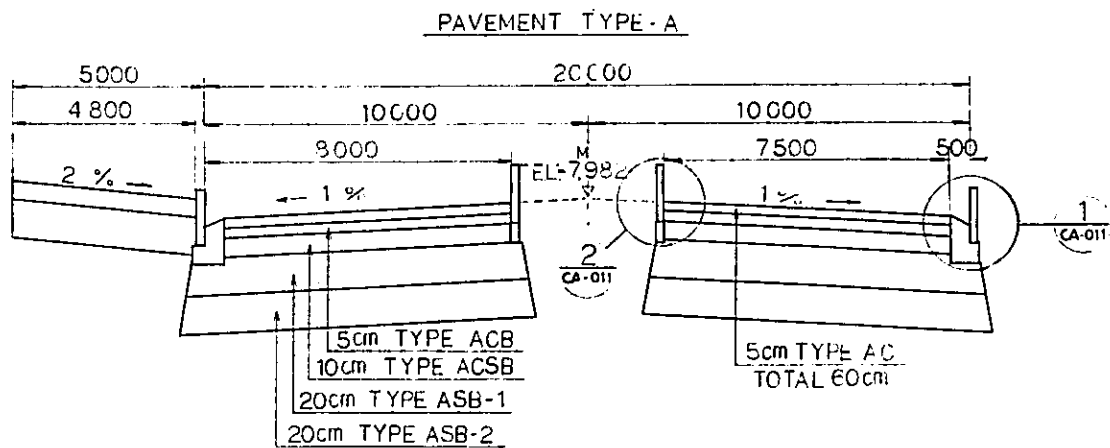


SECTION H  
SCALE H:1:100 V:1:20 CA-011

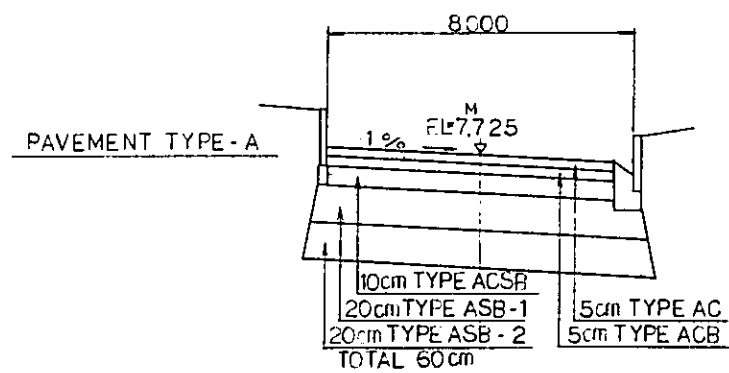


SECTION K  
SCALE H:1:100 V:1:20 CA-007

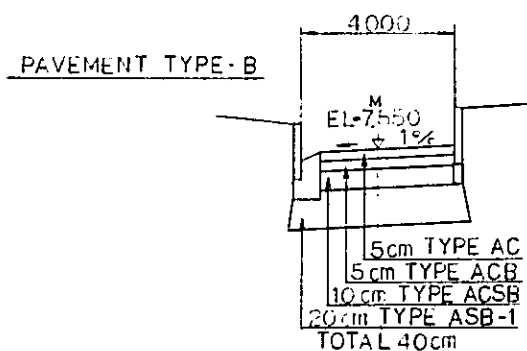


SECTION I  
SCALE H:1:100 V:1:20 CA-007

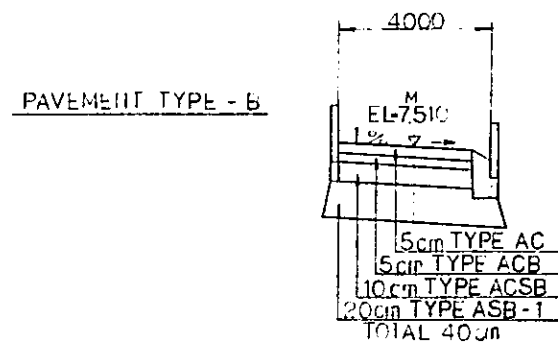


SECTION L  
SCALE H:1:100 V:1:20 CA-007

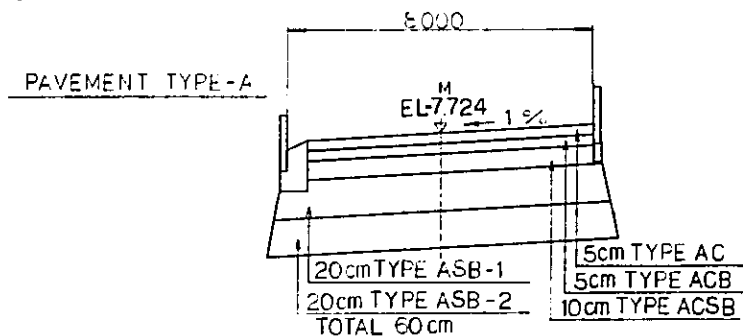


SECTION J  
SCALE H:1:100 V:1:20 CA-007

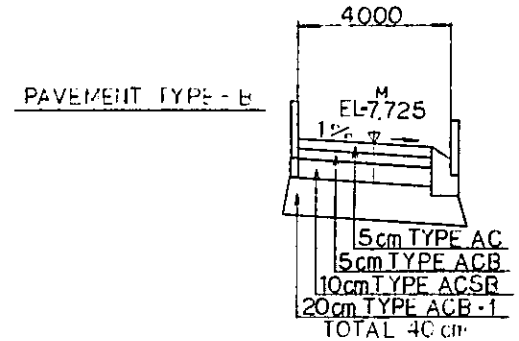

SECTION M  
SCALE H:1:100 V:1:20 CA-007


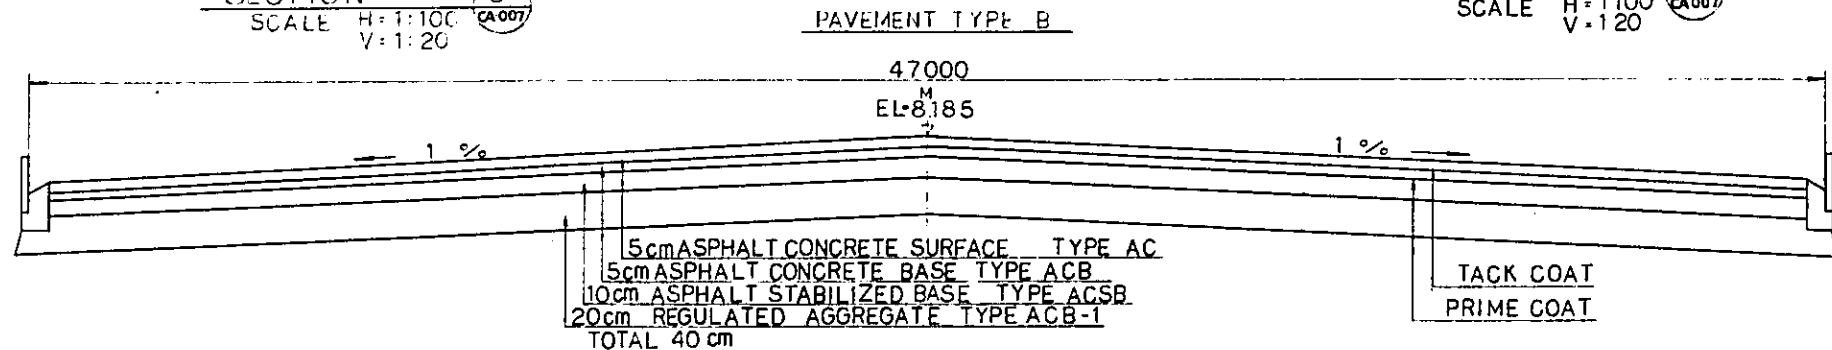


SECTION N  
SCALE H:1:100 V:1:20 CA-007

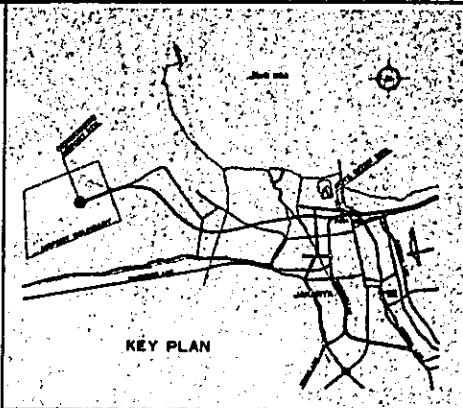


NOTE:  
1. THE PRIME COAT AND THE TACK COAT WILL BE APPLIED ON THE FINISHED SURFACE OF THE ACSB AND THE ACB RESPECTIVELY. FOR THE EACH PAVEMENT TYPE IN ACCORDANCE WITH THE SPECIFICATION.  
2. ALL DIMENSIONS ARE SHOWN IN MILLIMETERS UNLESS OTHERWISE INDICATED.

|   |             |          |       |         |          |
|---|-------------|----------|-------|---------|----------|
| REPUBLIC OF INDONESIA<br>MINISTRY OF COMMUNICATIONS<br>DIRECTORATE GENERAL OF LAND TRANSPORT AND INLAND WATERWAYS |             |          |       |         |          |
| NEW RAILWAY LINE FOR CENGKARENG AIRPORT<br>CONSTRUCTION PROJECT   |             |          |       |         |          |
| JAPAN INTERNATIONAL COOPERATION AGENCY<br>(JICA)  |             |          |       |         |          |
| B   | 1. Aug. 89  | J.J.     | J.J.  | I.M.    | K.M.     |
| A   | 15. Feb. 88 | J.J.     | J.J.  | K.U.    | K.M.     |
| REVISIONS   | DATE        | DESIGNED | DRAWN | CHECKED | REVIEWED |
| CROSS SECTIONS OF INTERNAL ROADS  |             |          |       |         |          |
| PACKAGE: I CIVIL AND ARCHITECTURAL WORK   |             |          |       |         |          |
| SCALE   | DRAWING NO. |          |       |         |          |
| AS NOTED  | CA-010      |          |       |         |          |

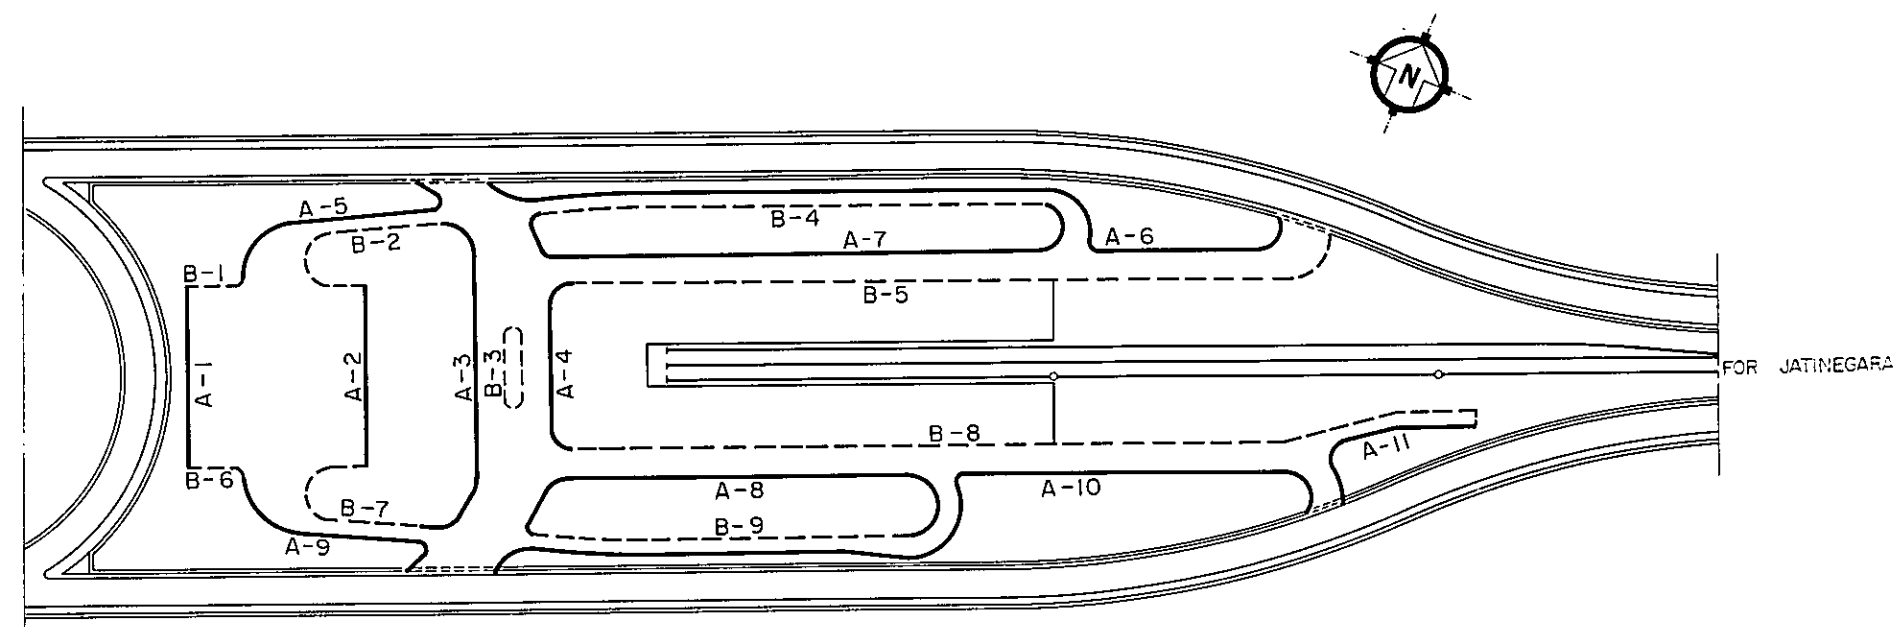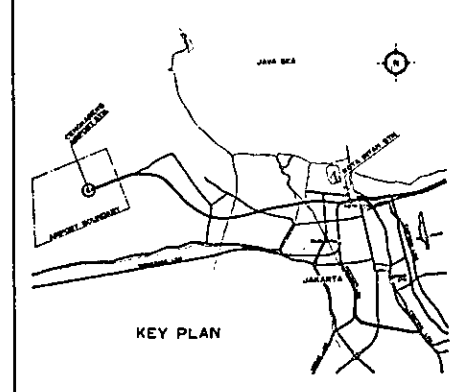

NOTE:  
ALL DIMENSIONS ARE SHOWN  
IN MILLIMETERS UNLESS  
OTHERWISE INDICATED.


PLAN  
SCALE 1:1000

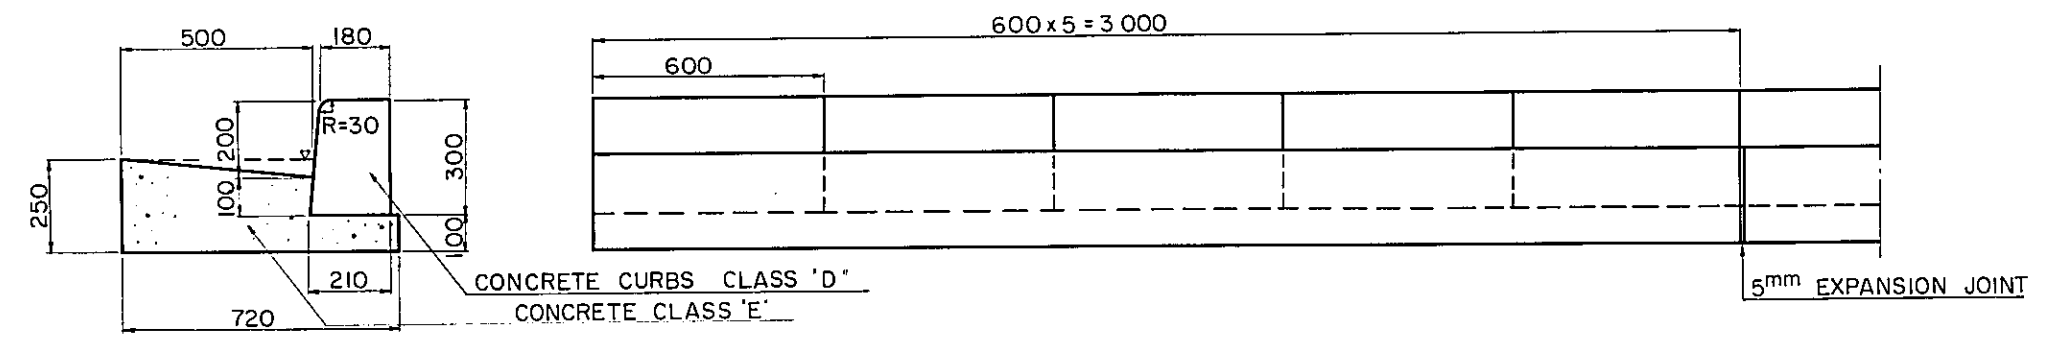

CONCRETE CURBS CLASS 'D'  
CONCRETE CLASS 'E'

5mm EXPANSION JOINT

TYPE A  
SCALE 1:10

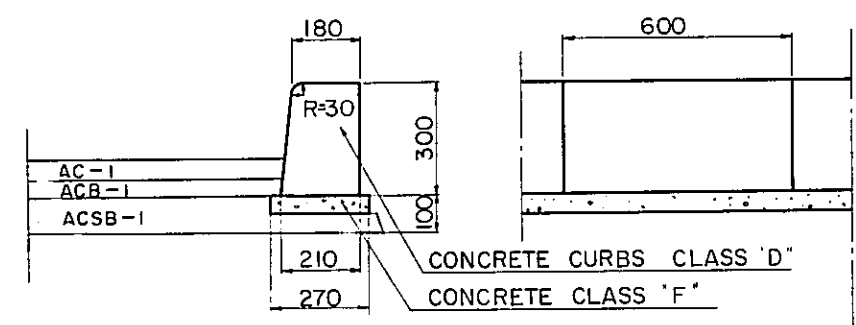

CONCRETE CURBS CLASS 'D'  
CONCRETE CLASS 'F'

TYPE B  
SCALE 1:10

| TYPE A   |                       | TYPE B   |                    |
|----------|-----------------------|----------|--------------------|
| LINE NO. | LENGTH                | LINE NO. | LENGTH             |
| A 1      | 48 <sup>m</sup> 00    | B 1      | 12 <sup>m</sup> 00 |
| A 2      | 48.00                 | B 2      | 59.39              |
| A 3      | 93.23                 | B 3      | 46.57              |
| A 4      | 48.91                 | B 4      | 129.20             |
| A 5      | 68.78                 | B 5      | 204.35             |
| A 6      | 221.88                | B 6      | 12.00              |
| A 7      | 158.87                | B 7      | 56.39              |
| A 8      | 133.88                | B 8      | 240.50             |
| A 9      | 65.06                 | B 9      | 96.50              |
| A 10     | 226.88                |          |                    |
| A 11     | 50.90                 |          |                    |
| A TOTAL  | 1 164.39              | B TOTAL  | 856.90             |
| TOTAL    | 2 021 <sup>m</sup> 29 |          |                    |

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MINISTRY OF COMMUNICATIONS  
DIRECTORATE GENERAL OF LAND TRANSPORT  
AND INLAND WATERWAYS

NEW RAILWAY LINE FOR CENGKARENG AIRPORT  
CONSTRUCTION PROJECT









JAPAN INTERNATIONAL COOPERATION AGENCY  
(JICA)

|           |            |          |       |         |          |           |
|-----------|------------|----------|-------|---------|----------|-----------|
| B         | 1. Aug 89  | JJ       | JJ    | I H     | K M      | M K       |
| A         | 15. Feb 88 | JJ       | JJ    | K S     | K M      | M K       |
| REVISIONS | DATE       | DESIGNED | DRAWN | CHECKED | REVIEWED | SUBMITTED |

ALLOCATION AND DETAIL  
OF  
CONCRETE CURBING.

PACKAGE: 1 CIVIL AND ARCHITECTURAL WORK

SCALE: AS NOTED      DRAWING NO: CA - 011

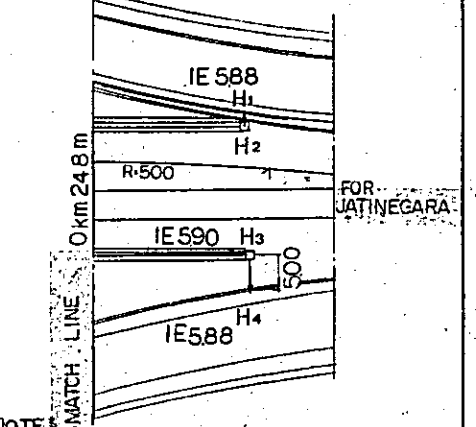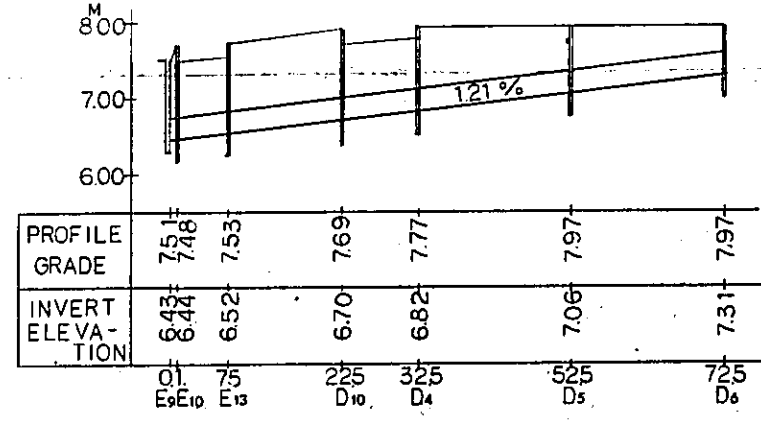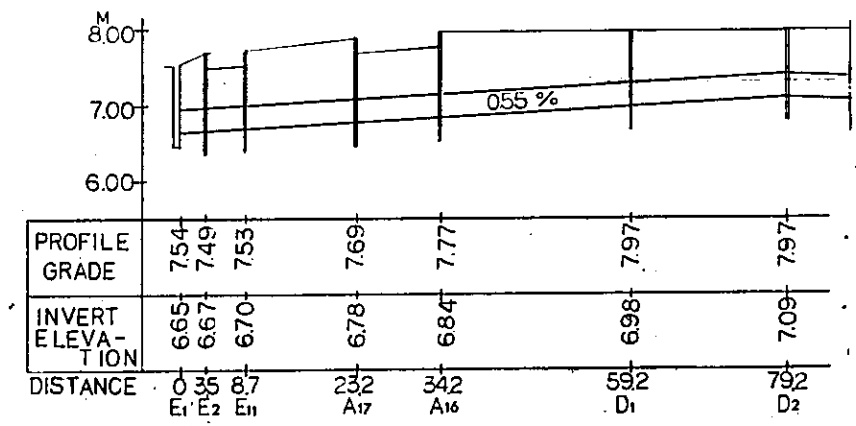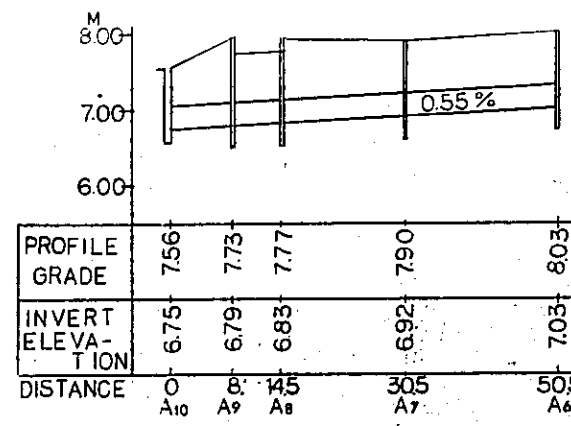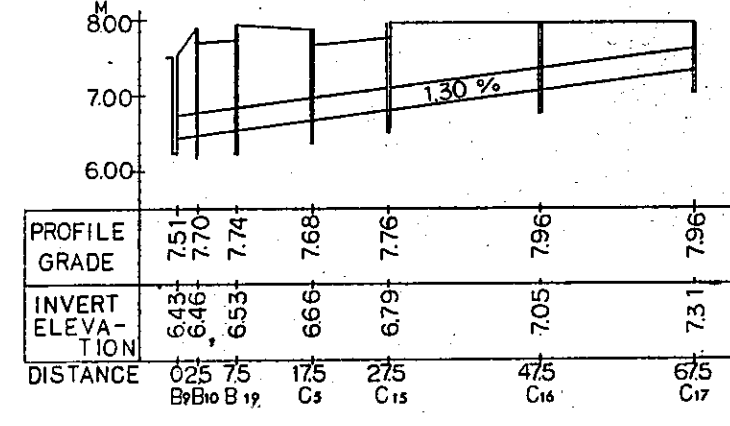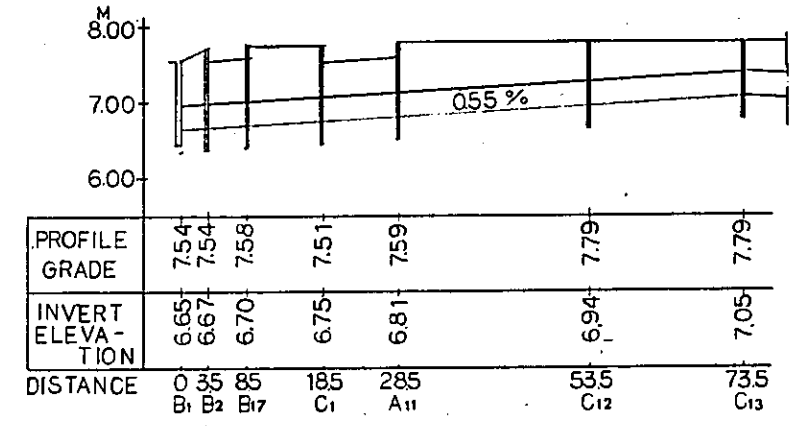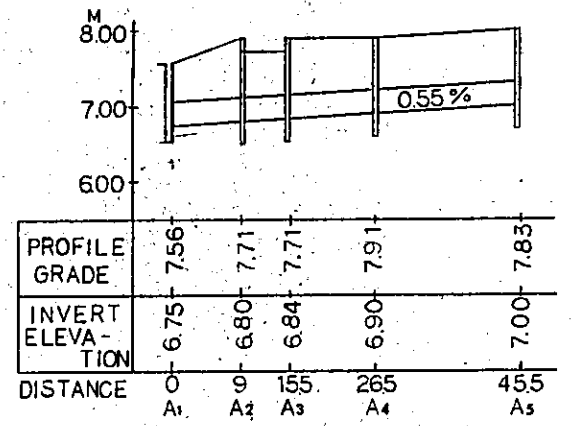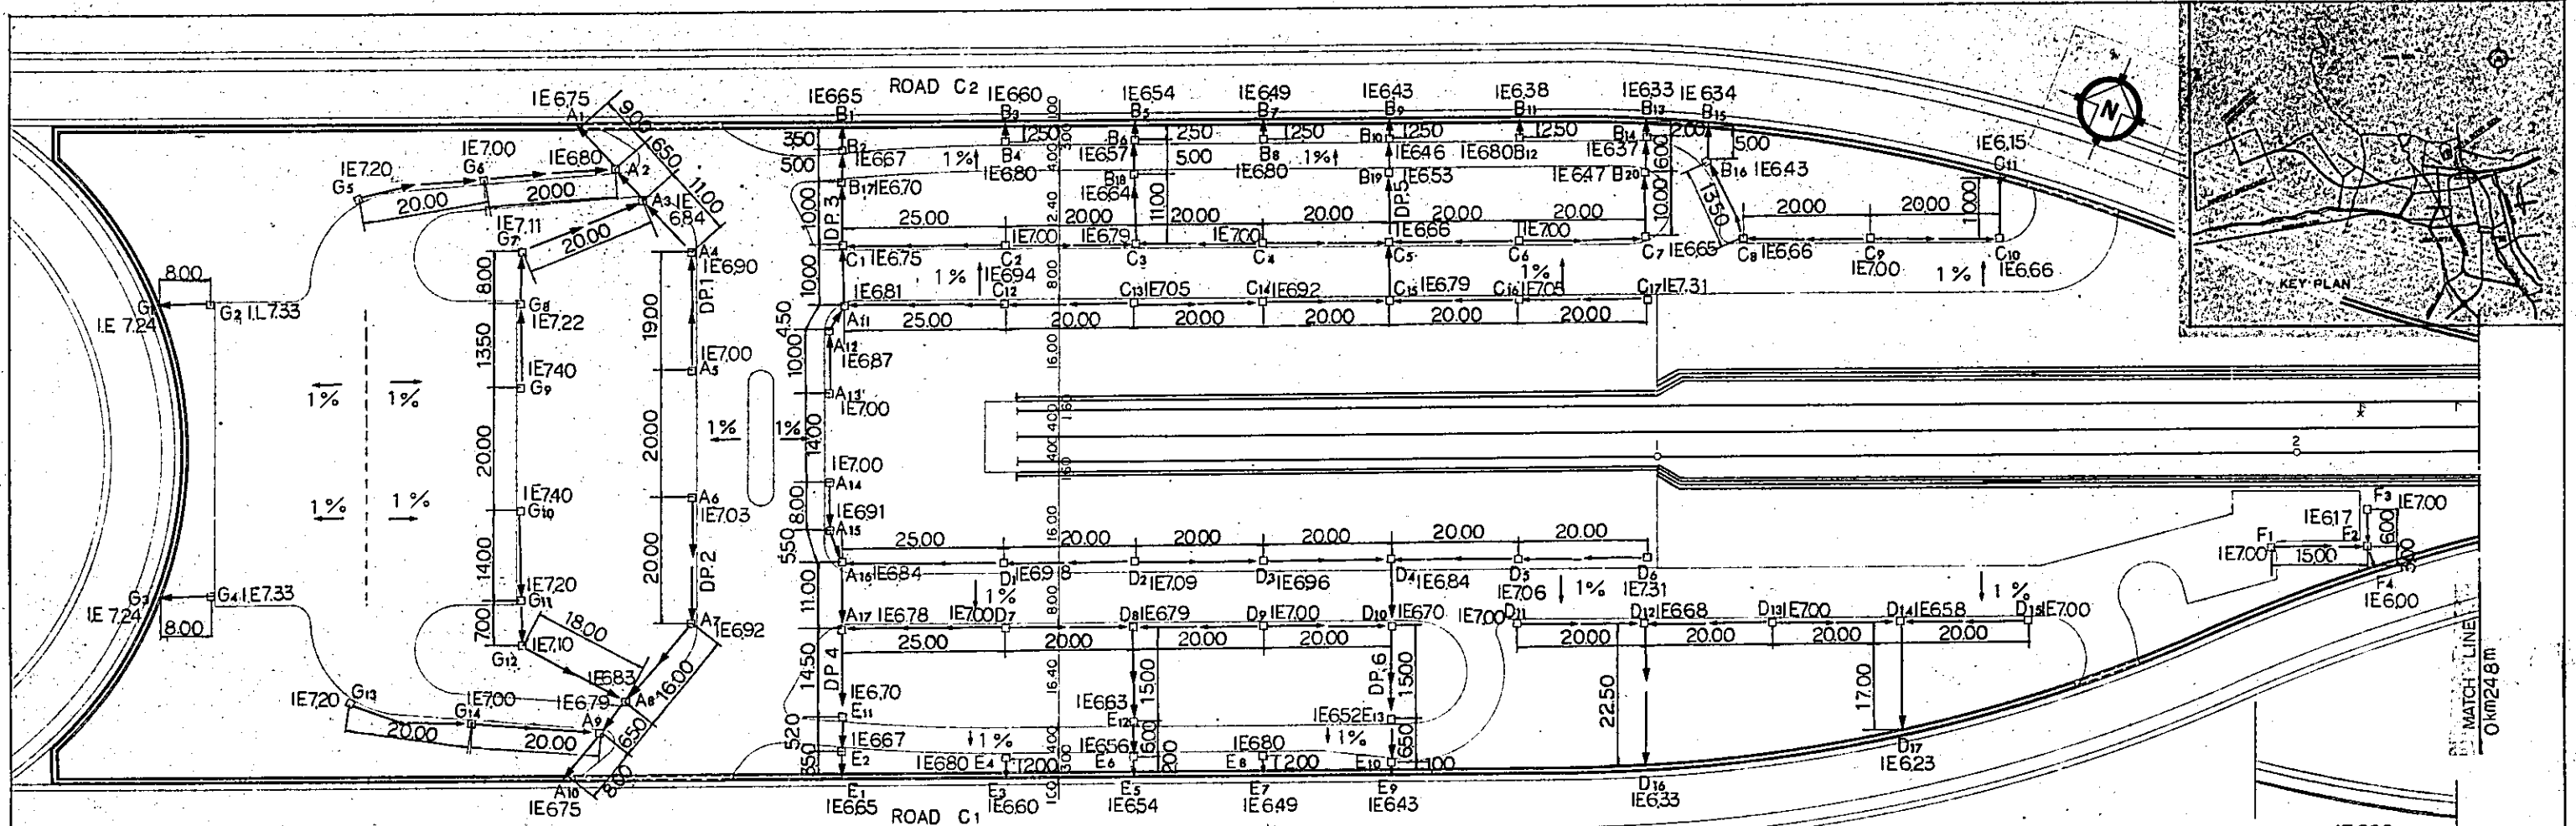

NOTE: ALL DIMENSIONS ARE SHOWN IN METERS, UNLESS OTHERWISE INDICATED.

REPUBLIC OF INDONESIA  
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NEW RAILWAY LINE FOR CENKARENG AIRPORT  
CONSTRUCTION PROJECT


JAPAN INTERNATIONAL COOPERATION AGENCY (JICA)

| B         | 1. Aug. 87  | J.J.     | J.J.  | J.M.    | K.M.     | M.K.      |
|-----------|-------------|----------|-------|---------|----------|-----------|
| A         | 15. Feb. 88 | J.J.     | J.J.  | R.H.    | K.M.     | M.K.      |
| REVISIONS | DATE        | DESIGNED | DRAWN | CHECKED | REVIEWED | SUBMITTED |


ALLOCATION AND PROFILE OF DRAINAGE PIPES

PACKAGE: I CIVIL AND ARCHITECTURAL WORK

SCALE: AS NOTED DRAWING NO: CA-012

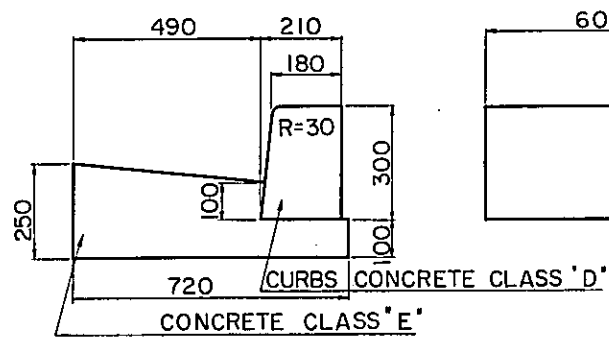


**TYPE A**  
CONCRETE VOLUME 0.035m<sup>3</sup>/NO.

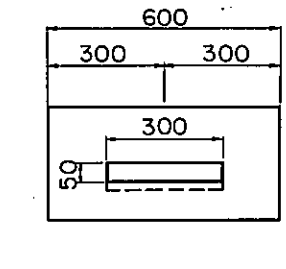

**TYPE C**  
CONCRETE VOLUME 0.032m<sup>3</sup>/NO.

**MATERIAL SCHEDULE**

| TYPE  | CONCRETE CLASS | UNIT | QUANTITY | REMARKS       |
|-------|----------------|------|----------|---------------|
| A     | D              | m    | 0.058    | PER METER     |
|       | E              | '    | 0.133    |               |
|       | TOTAL          | '    | 0.192    |               |
| C     | D              | '    | 0.032    | PER 0.6 METER |
|       | E              | '    | 0.080    |               |
|       | TOTAL          | '    | 0.112    |               |
| B     | D              | '    | 0.058    | PER METER     |
|       | F              | '    | 0.014    |               |
| TOTAL |                |      | 0.072    |               |

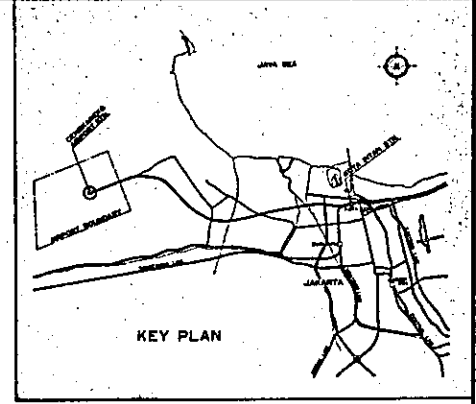

**REINFORCED CONCRETE PIPE SCHEDULE**


| REINF. NO.      | DIA mm | LENGTH mm | NUMBER | U. WEIGHT m/kg | WEIGHT kg            | REMARKS |
|-----------------|--------|-----------|--------|----------------|----------------------|---------|
| S1              | 4      | 1017      | 6      | 10.1           | 0.604                |         |
| S2              | 3.2    | 1146      | 9      | 15.8           | 0.653                |         |
| S3              | 3.2    | 1451      | 2      | 15.8           | 0.184                |         |
| TOTAL           |        |           |        |                | 1.441                |         |
| CONCRETE VOLUME |        |           |        |                | 0.078 m <sup>3</sup> |         |

**NOTE:**  
TYPE C WILL BE USED ONLY AT LOCATIONS CONNECTING TO CATCH BASINS  
CONCRETE CURBS, REINFORCED CONCRETE PIPES, AND UTILITY CHASE COVERS SHALL BE OF PLANT PRECAST PRODUCTS.

**BAR SCHEDULE PER EACH CATCH BASIN**


| REINF. NO.      | DIA mm | LENGTH mm | NUMBER | U. WEIGHT kg/m | WEIGHT kg          | REMARKS |
|-----------------|--------|-----------|--------|----------------|--------------------|---------|
| A1              | 10     | 2140      | 1      | 0.560          | 0.560              |         |
| A2              | '      | 710       | 3      | '              | 1.193              |         |
| A3              | '      | 1030      | 6      | '              | 3.461              |         |
| A4              | '      | 840       | 2      | '              | 0.941              |         |
| A5              | '      | 530       | 4      | '              | 1.187              |         |
| A6              | '      | 840       | 2      | '              | 0.941              |         |
| A7              | '      | 2760      | 4      | '              | 6.182              |         |
| A8              | '      | 900       | 2      | '              | 1.008              |         |
| A9              | '      | 840       | 2      | '              | 0.941              |         |
| A10             | '      | 200       | 2      | '              | 0.224              |         |
| A11             | '      | 1614      | 2      | '              | 1.808              |         |
| A12             | '      | 640       | 2      | '              | 0.717              |         |
| TOTAL           |        |           |        |                | 19.163             |         |
| CONCRETE VOLUME |        |           |        |                | 0.33m <sup>3</sup> |         |

ALL DIMENSIONS ARE SHOWN IN MILLIMETERS UNLESS OTHERWISE INDICATED.

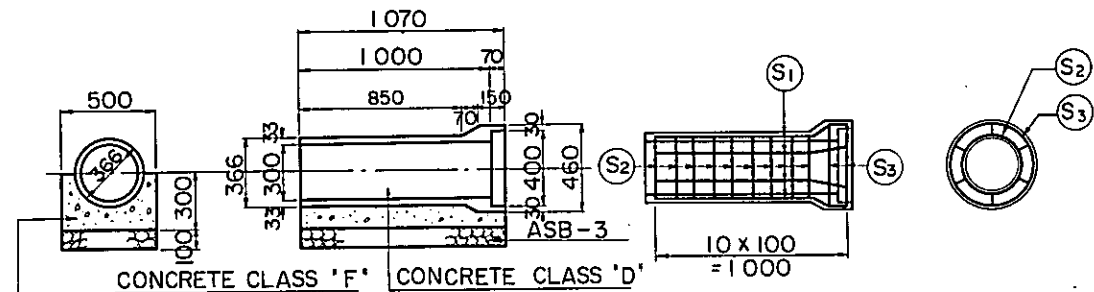


**SECTION B**  
SCALE 1:20


**DETAILS OF REINFORCED CONCRETE PIPE**  
SCALE 1:20

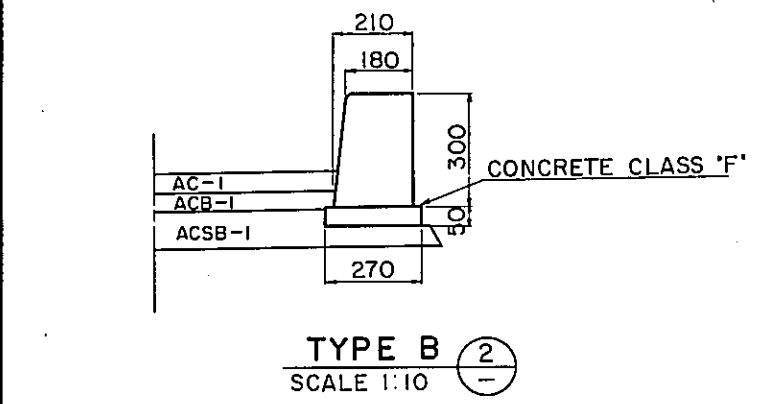


**TYPE B**  
SCALE 1:10

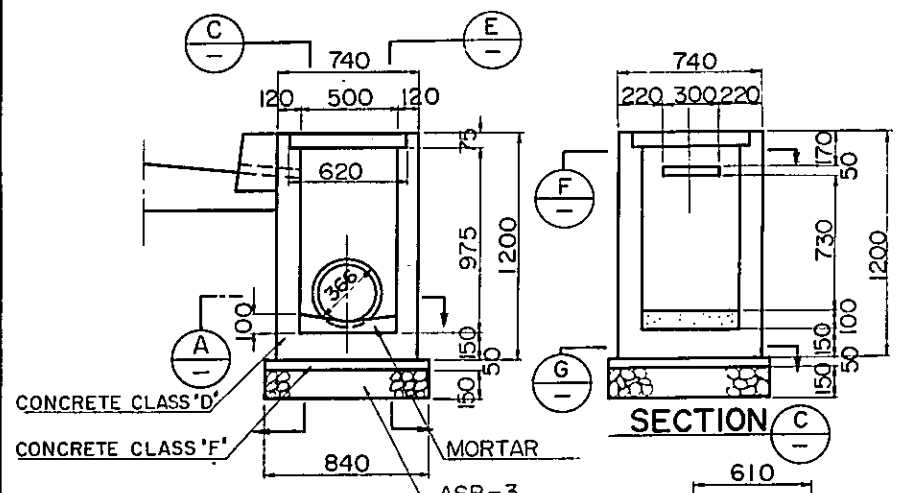


**SECTION C**

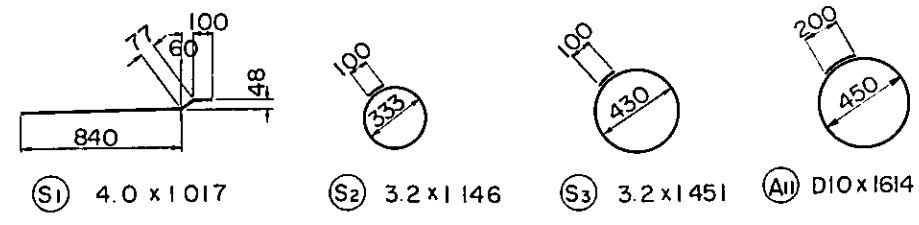


**SECTION E**

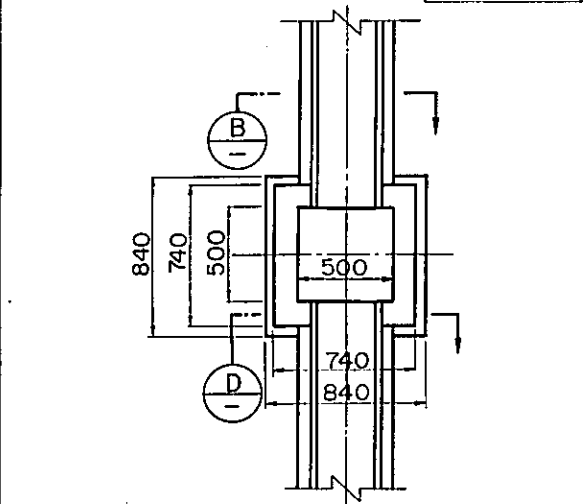

**SECTION A**  
SCALE 1:20

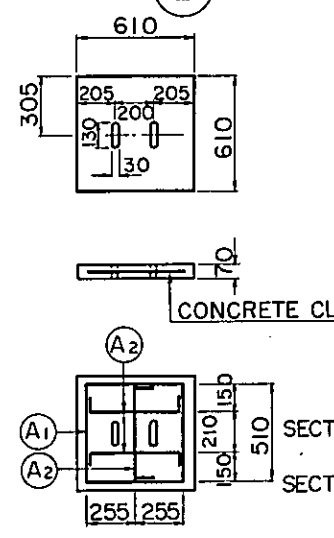


**DETAILS OF COVER**

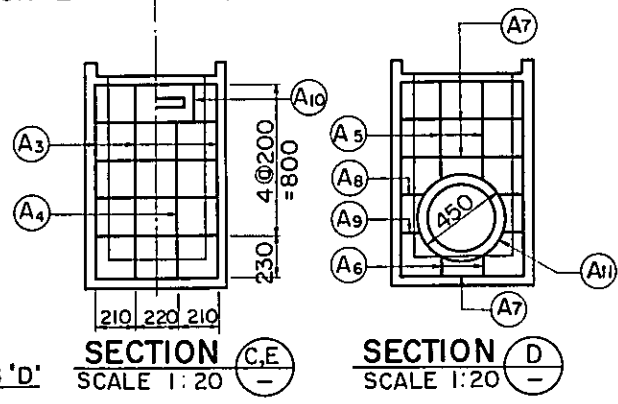

**SECTION C, E**  
SCALE 1:20

**SECTION D**  
SCALE 1:20

**SECTION F, G**  
SCALE 1:20

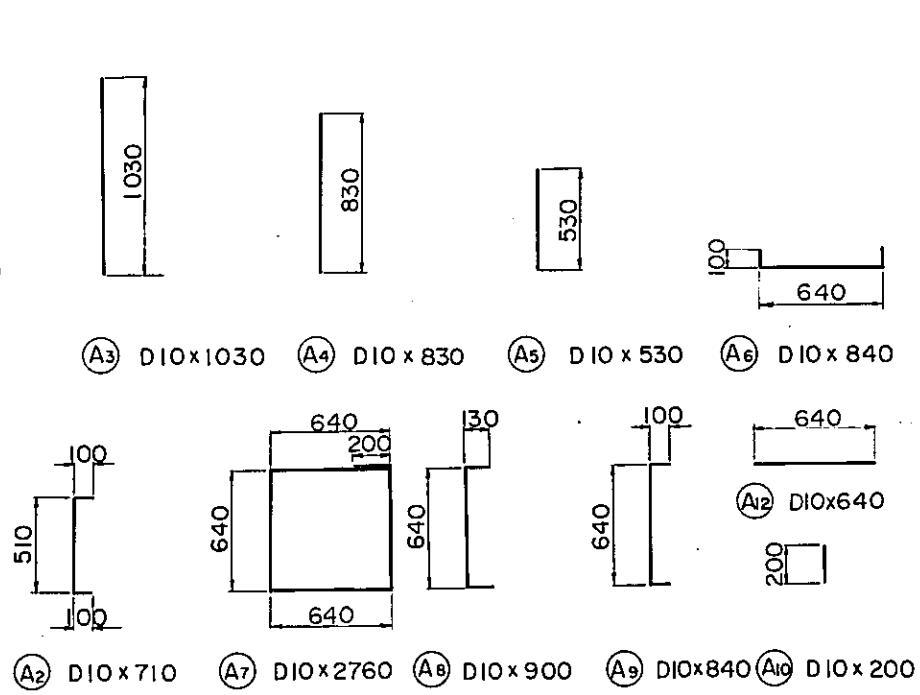

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DIRECTORATE GENERAL OF LAND TRANSPORT AND INLAND WATERWAYS


NEW RAILWAY LINE FOR GENGKARENG AIRPORT CONSTRUCTION PROJECT

JAPAN INTERNATIONAL COOPERATION AGENCY (JICA)

| REVISIONS | DATE       | DESIGNED | DRAWN | CHECKED | REVIEWED | SUBMITTED |
|-----------|------------|----------|-------|---------|----------|-----------|
| B         | 1. Aug. 89 | J.J.     | J.J.  | I.M.    | K.M.     | M.K.      |
| A         | 15 Feb. 89 | J.J.     | J.J.  | K.S.    | K.M.     | M.K.      |

DETAILS OF DRAINAGE PIPE AND CATCH BASIN


PACKAGE: I CIVIL AND ARCHITECTURAL WORK  
SCALE: AS NOTED  
DRAWING NO: CA-013

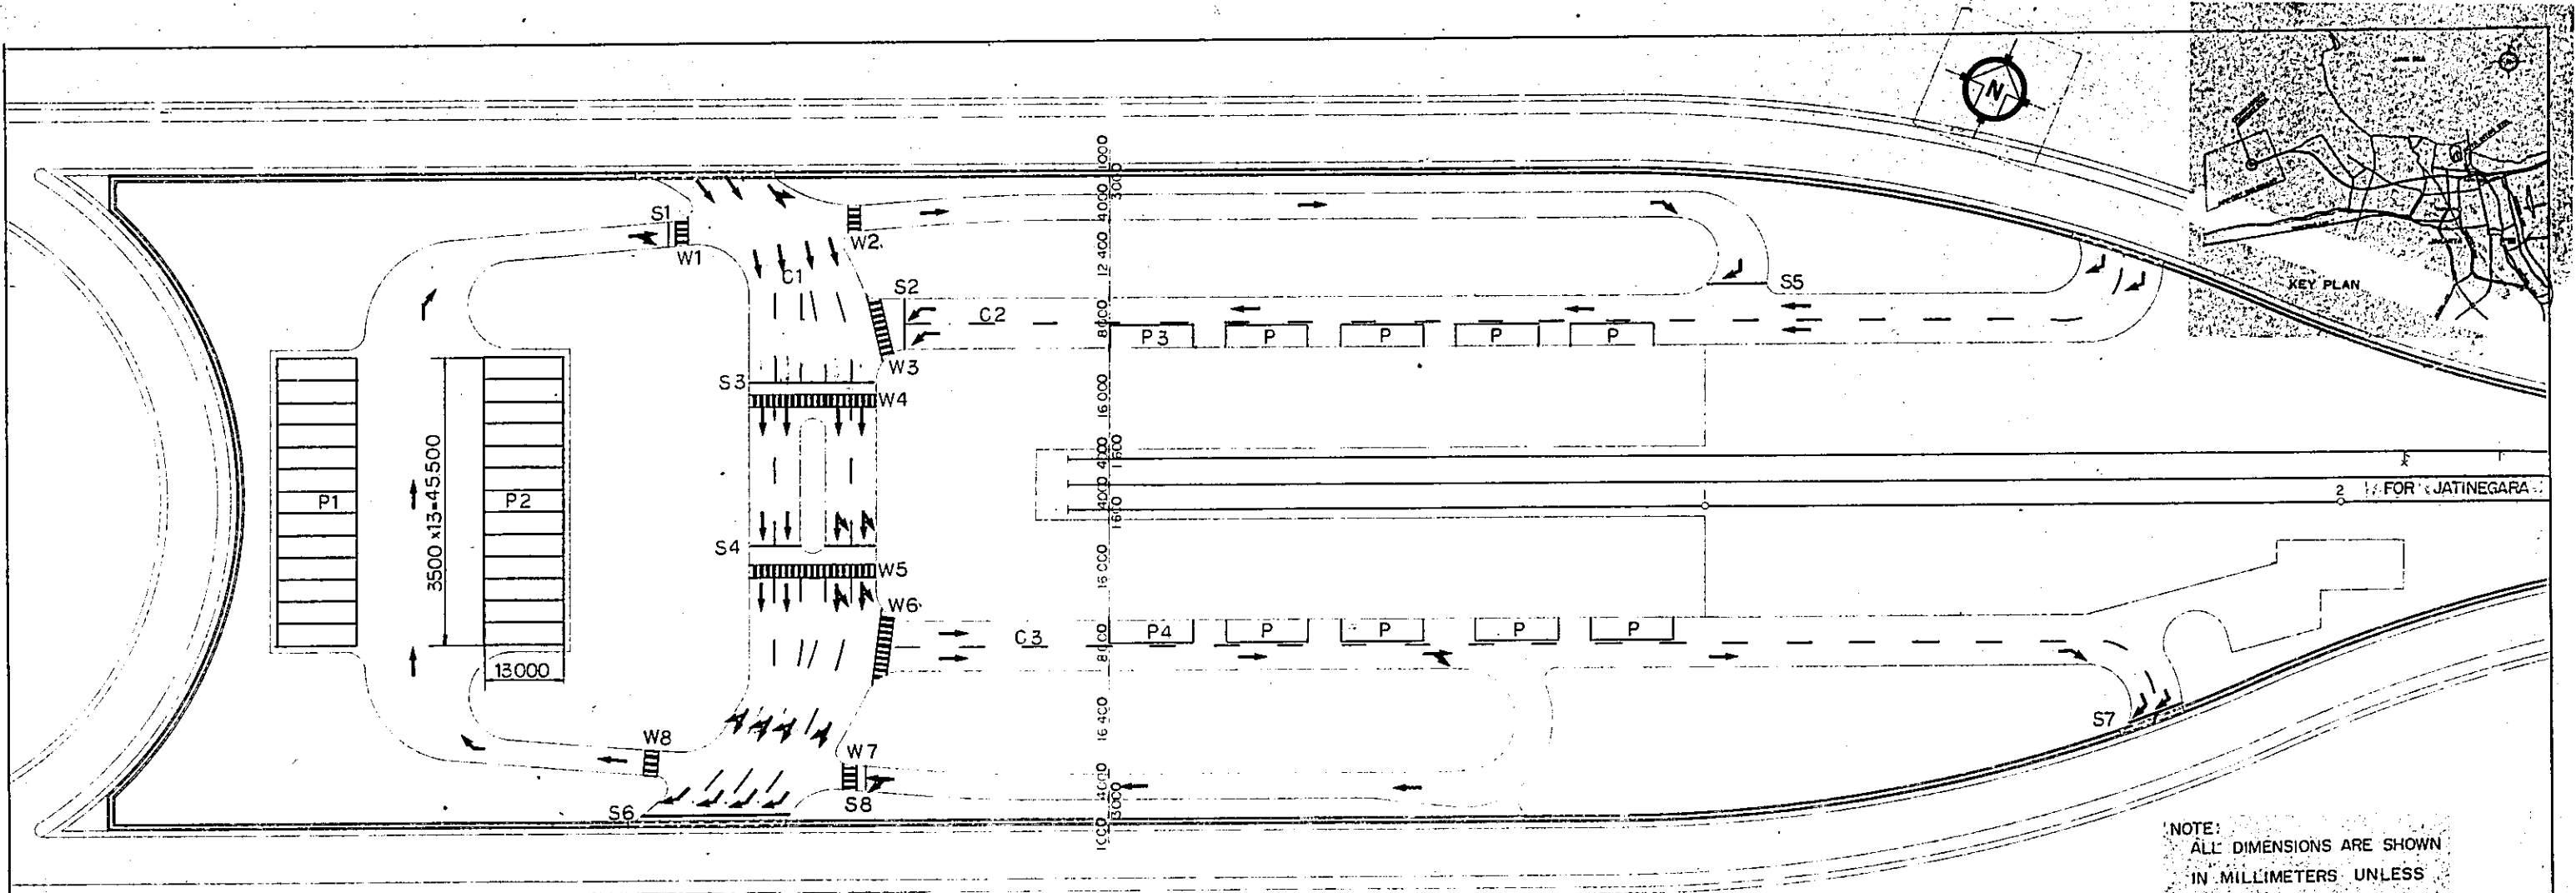


NOTE:  
ALL DIMENSIONS ARE SHOWN  
IN MILLIMETERS UNLESS  
OTHERWISE INDICATED.

LEGEND:  
 TRAFFIC ARROWS T.1  
 T.2  
 T.3  
 P PARKING LINE  
 W WALKER LINE  
 S STOP LINE  
 C CENTER LINE


PLAN SCALE 1:500

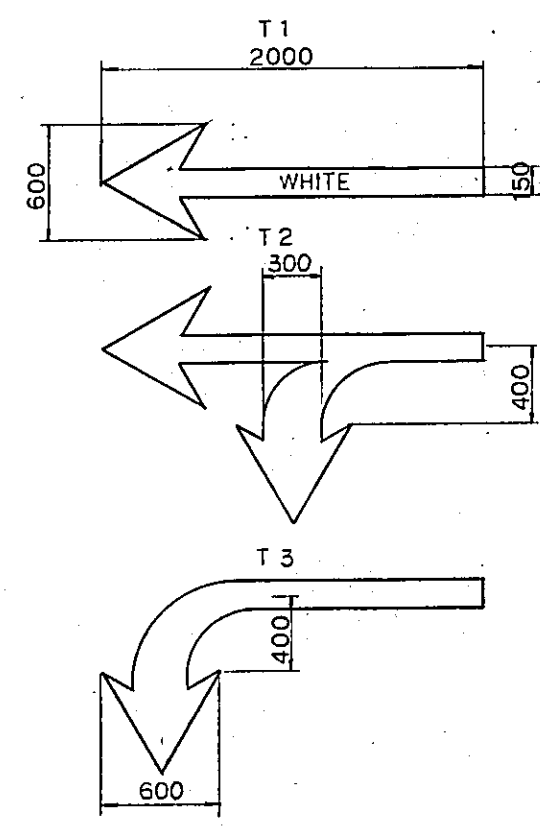


TRAFFIC ARROWS  
SCALE 1:20

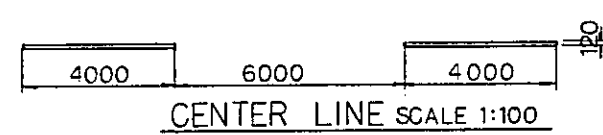


CENTER LINE SCALE 1:100

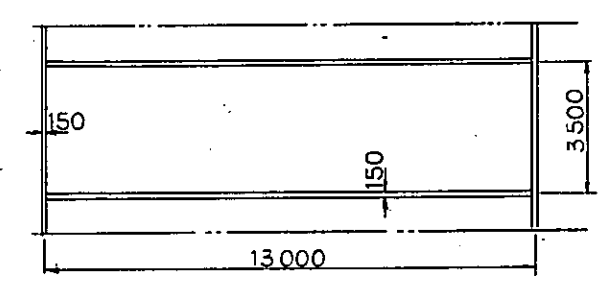

PARKING LINE SCALE 1:100

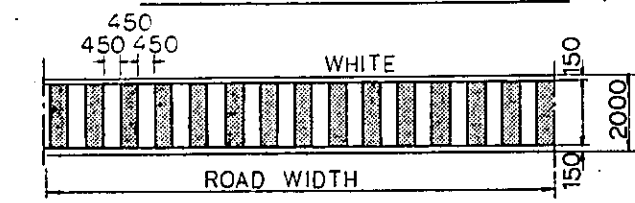

WALKER LINE SCALE 1:100

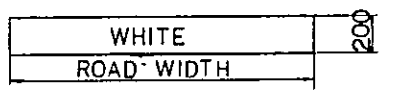

STOP LINE SCALE 1:20

| STOP LINE | m  | CENTER LINE | m   | TRAFFIC ARROWS |
|-----------|----|-------------|-----|----------------|
| S1        | 4  | C1          | 124 | T 1 29 NO      |
| S2        | 8  | C2          | 80  | T 2 12 NO      |
| S3        | 20 | C3          | 84  | T 3 15 NO      |
| S4        | 16 | TOTAL       | 288 | TOTAL 56 NO    |
| S5        | 10 | WALKER LINE | m   | PARKING LINE   |
| S6        | 23 | W.1         | 4   | P 1 273        |
| S7        | 8  | W2          | 4   | P 2 273        |
| S8        | 4  | W3          | 10  | P 3 100        |
| TOTAL     | 93 | W4          | 20  | P 4 100        |
|           |    | W5          | 20  | TOTAL 746      |
|           |    | W6          | 10  |                |
|           |    | W7          | 4   |                |
|           |    | W8          | 4   |                |
|           |    | TOTAL       | 76  |                |

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 AND INLAND WATERWAYS

NEW RAILWAY LINE FOR CENGKARENG AIRPORT  
 CONSTRUCTION PROJECT

JAPAN INTERNATIONAL COOPERATION AGENCY  
 (JICA)


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|---|-----------|-----|-----|-----|------|------|
| 0 | 1 AUG 88  | J.J | J.J | 1.4 | K.M. | M.R. |
| A | 15 FEB 88 | J.J | J.J | R.O | K.M. | M.R. |

REVISIONS / DATE / DESIGNED / DRAWN / CHECKED / REVIEWED / SUBMITTED

ROAD MARKINGS

PACKAGE: I CIVIL AND ARCHITECTURAL WORK  
 SCALE: AS NOTED / DRAWING NO: CA-014




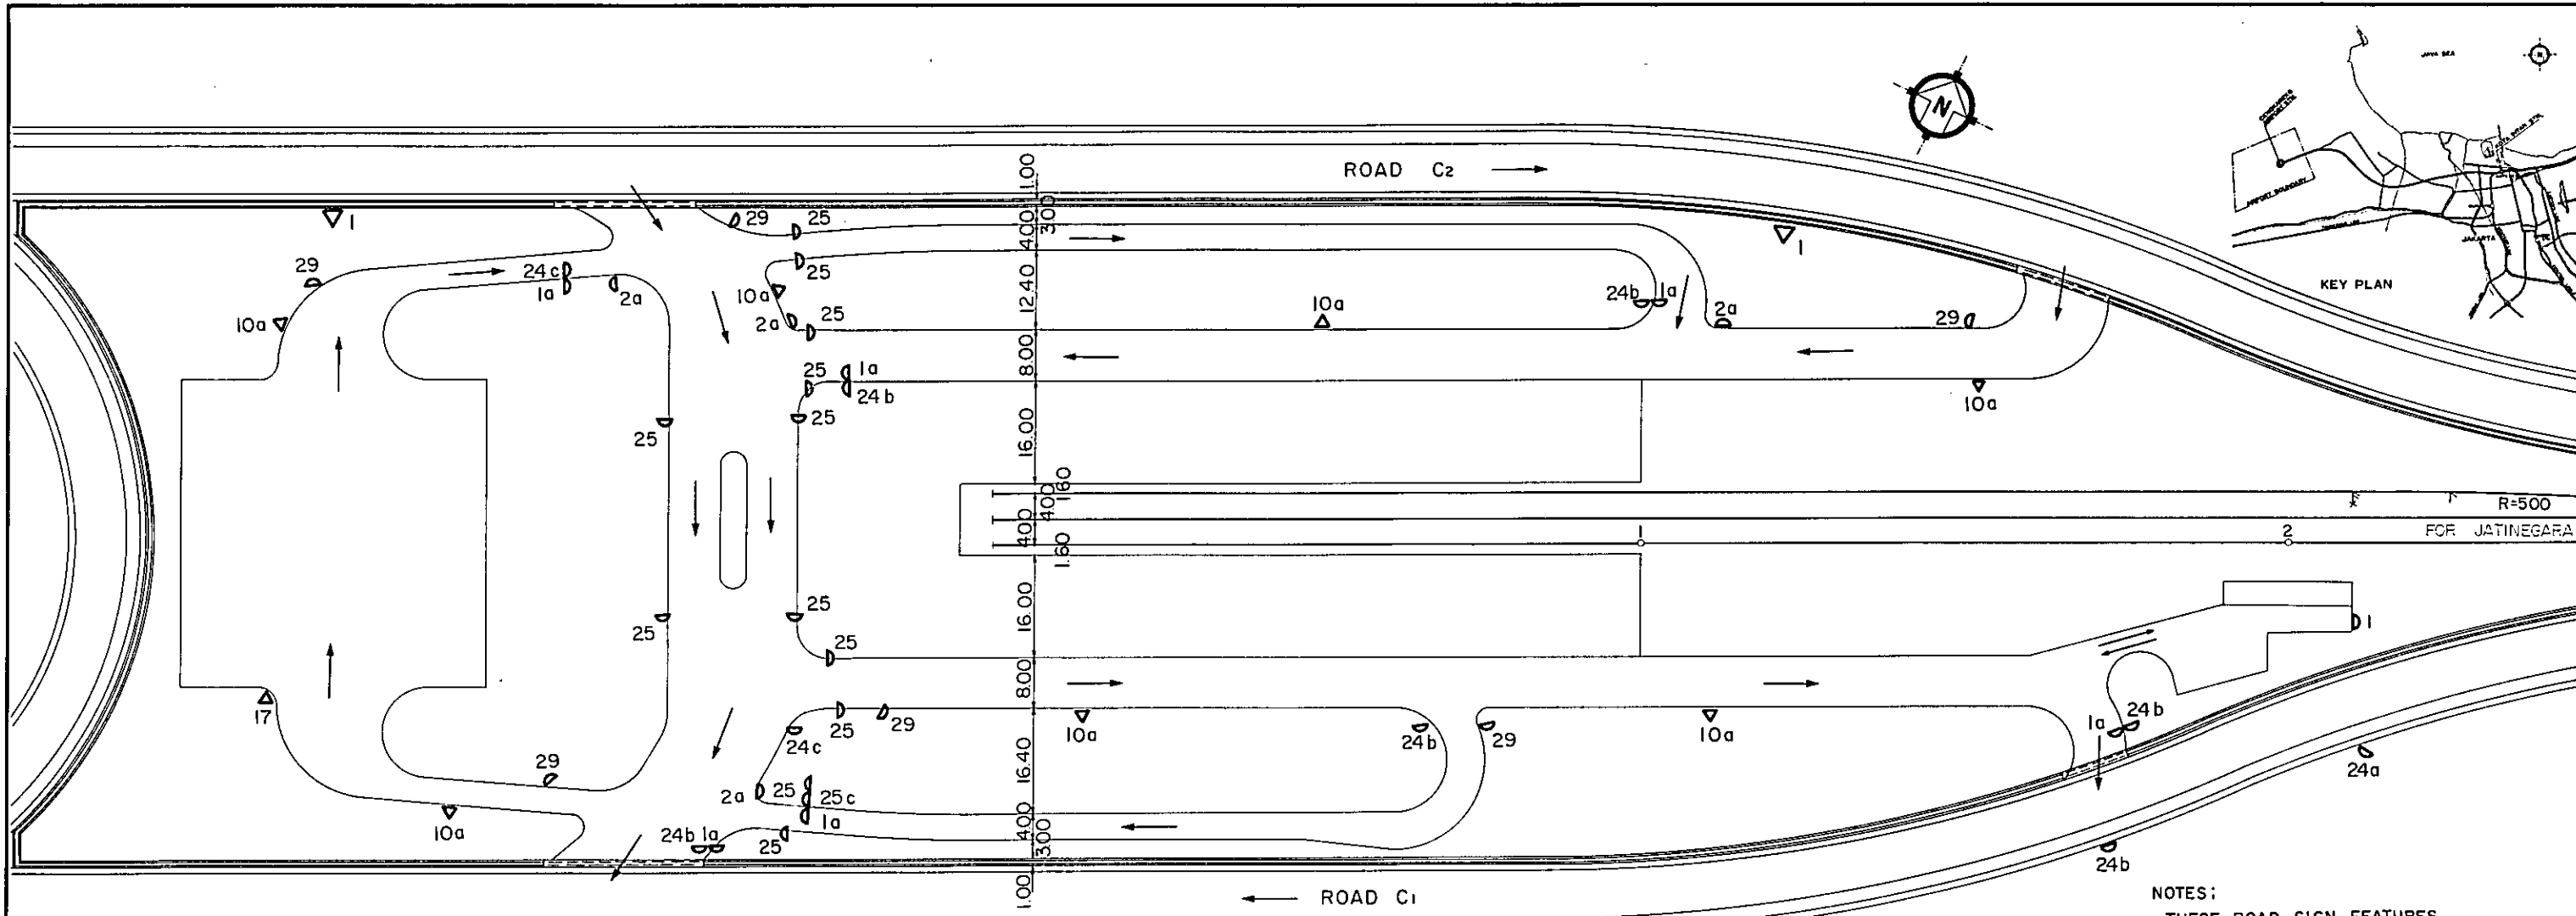

**SIGN LOCATION PLAN**  
SCALE 1 : 500

NOTES:  
THESE ROAD SIGN FEATURES SHALL CONFORM TO THE STANDARDS OF THE DIREKTORAT JENDERAL PERHUBUNGAN DARAT.


▽ TABLE II SIGN  
▽ TABLE III SIGN  
ALL DIMENSIONS ARE SHOWN IN MILLIMETERS UNLESS OTHERWISE INDICATED.

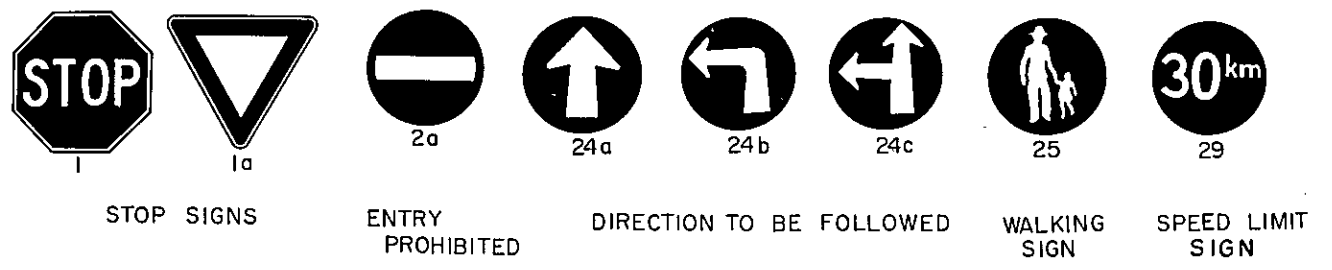


**TABLE II SIGN LOCATION**

**SIGN TABULATION TABLE**

| DESCRIPTION | QUANTITY | REMARKS    |
|-------------|----------|------------|
| TABLE II 1  | 1        |            |
| 1 a         | 6        |            |
| 2 a         | 4        |            |
| 24 a        | 2        |            |
| 24 b        | 7        |            |
| 24 c        | 2        |            |
| 25          | 12       |            |
| 29          | 6        |            |
| TABLE III 1 | 2        | GUIDE SIGN |
| 10 a        | 7        |            |
| 17          | 1        |            |
| TOTAL       | 50       |            |

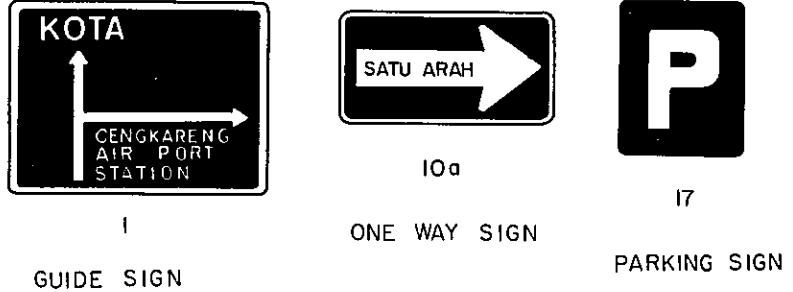

**TABLE III SIGN LOCATION**

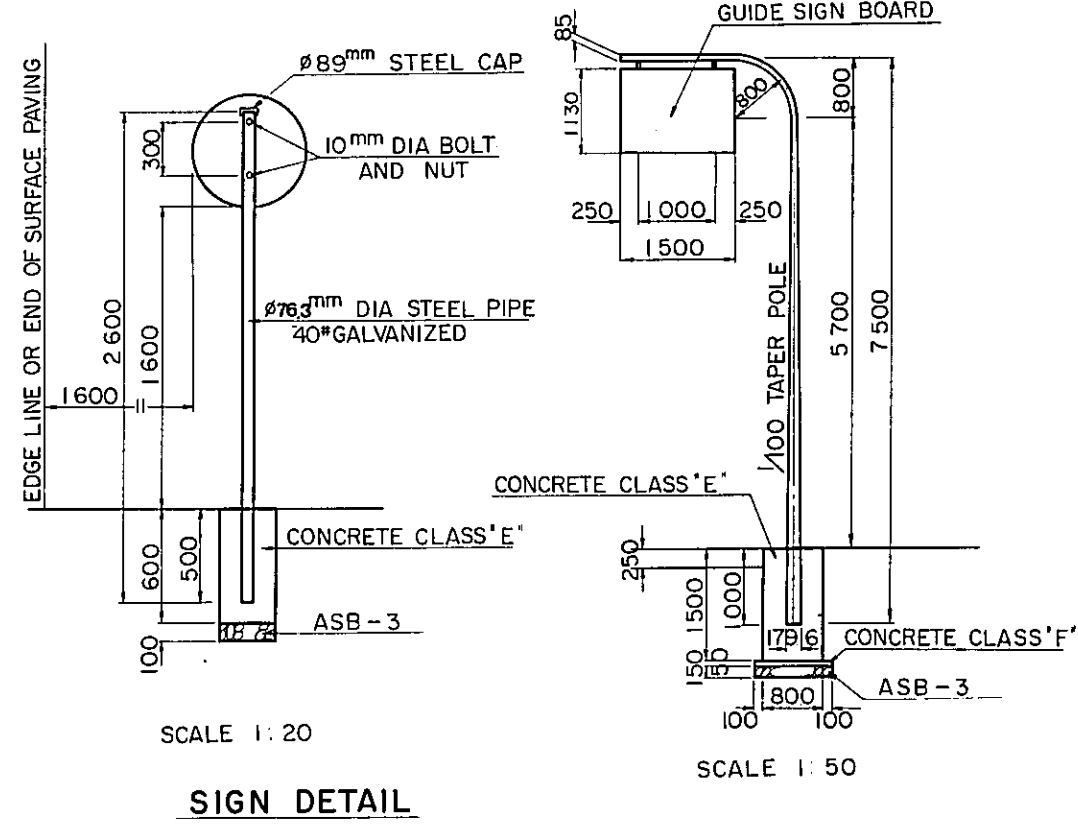

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DIRECTORATE GENERAL OF LAND TRANSPORT AND INLAND WATERWAYS



NEW RAILWAY LINE FOR CENGKARENG AIRPORT CONSTRUCTION PROJECT

JAPAN INTERNATIONAL COOPERATION AGENCY (JICA)


|   |             |      |      |            |       |
|---|-------------|------|------|------------|-------|
| B | 1 Aug. 89   | J.J. | J.J. | I. M. K.M. | M. K. |
| A | 15. Feb. 84 | J.J. | J.J. | K.S. K.M.  | M. K. |

ROADWAY SIGNS

PACKAGE: 1- CIVIL AND ARCHITECTURAL WORK  
SCALE: AS NOTED DRAWING NO: CA-015

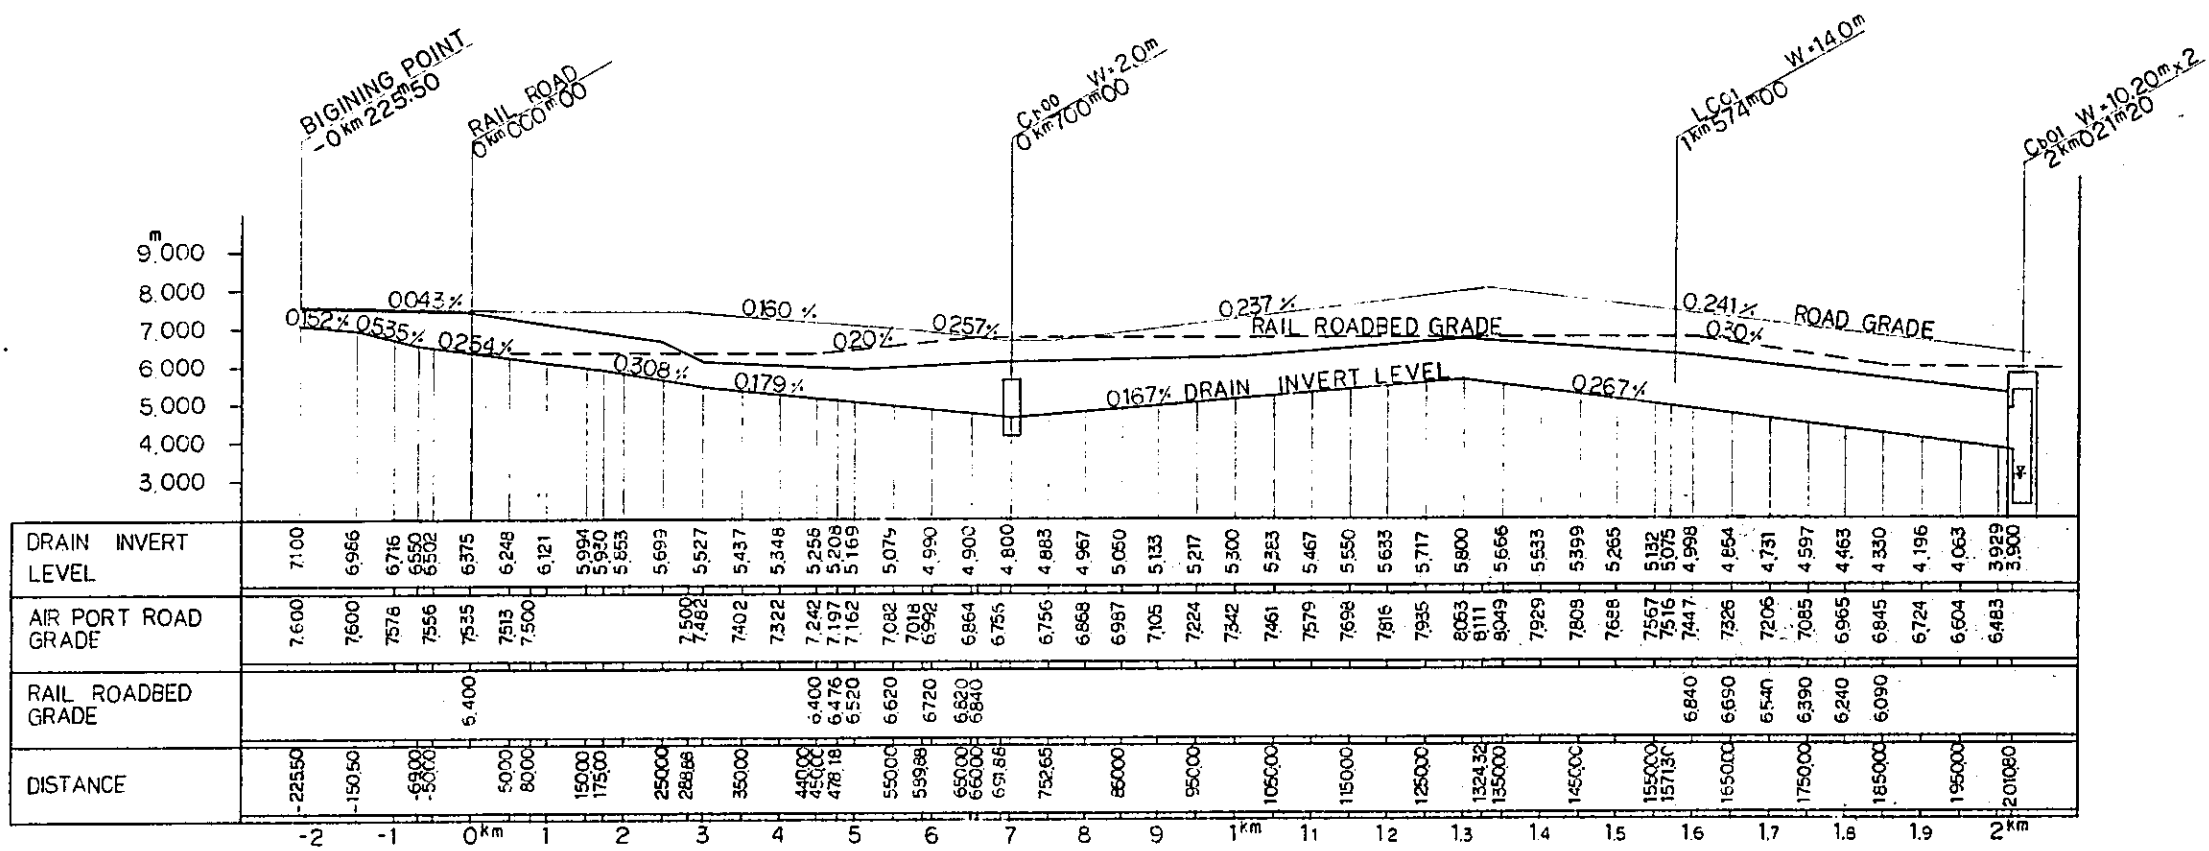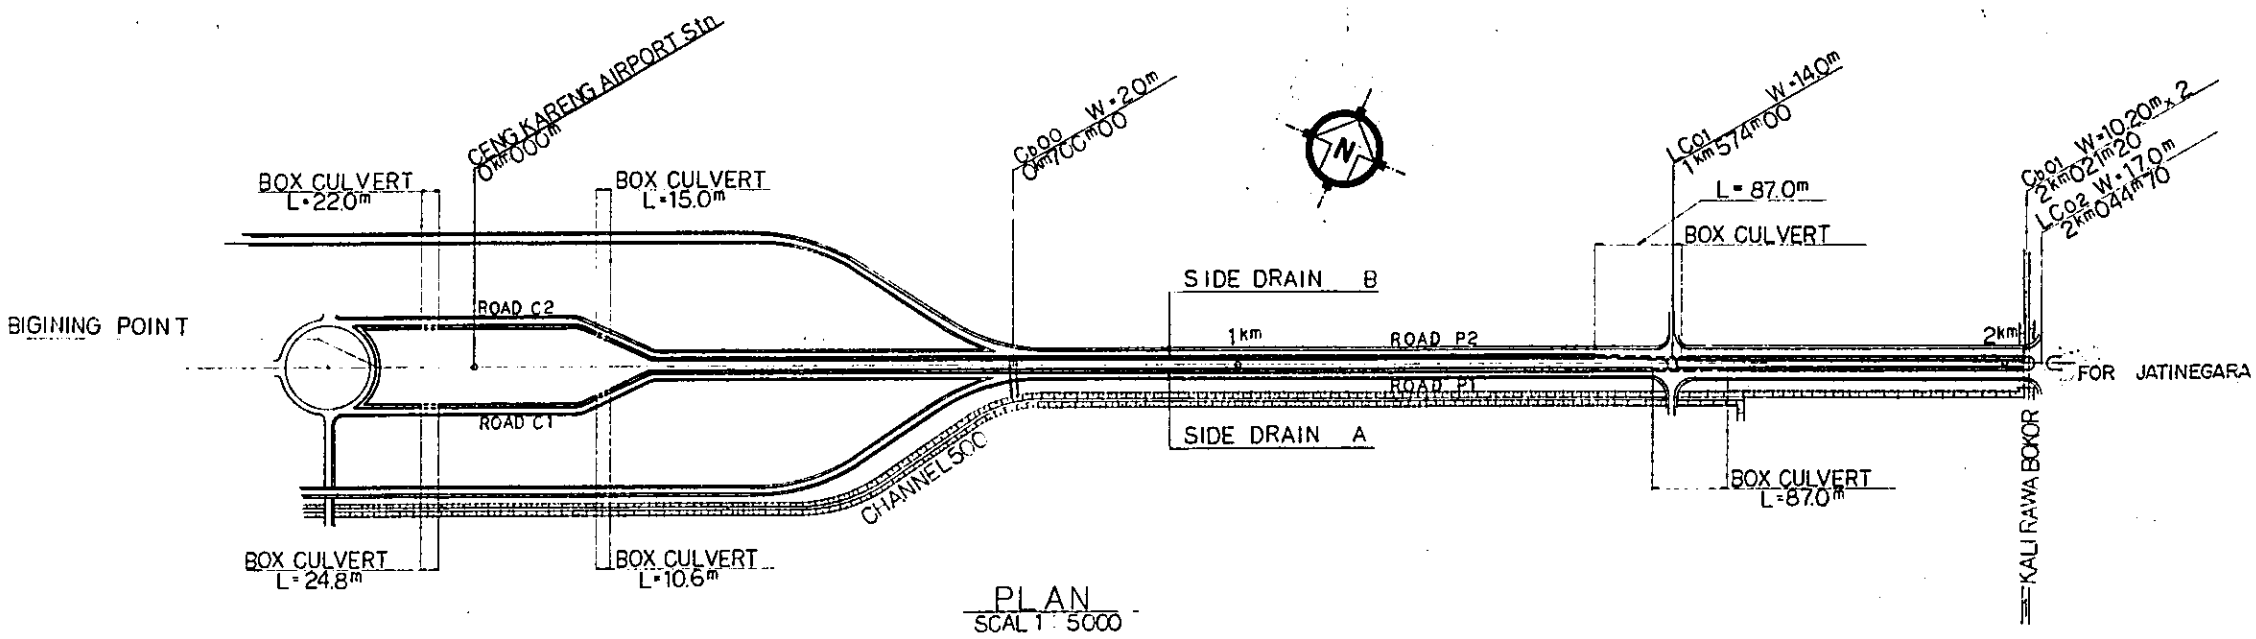

SIDE DRAIN A AND B PROFILE  
SCALE H:1:5000 V:1:100

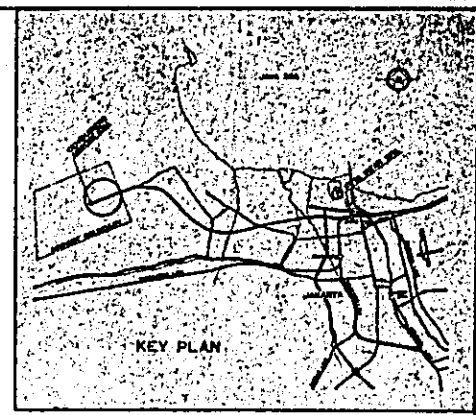

NOTE:  
ALL DIMENSIONS ARE SHOWN IN METERS UNLESS OTHERWISE INDICATED.

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NEW RAILWAY LINE FOR GENGKARENG AIRPORT  
CONSTRUCTION PROJECT

JAPAN INTERNATIONAL COOPERATION AGENCY (JICA)



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|---|-----------|-----|-----|-----|-----|-----|
| B | 1 Aug 89  | J.J | J.J | I.M | K.M | a.k |
| A | 15 Feb 89 | J.J | J.J | K.S | K.M | a.k |

|           |      |          |         |          |           |
|-----------|------|----------|---------|----------|-----------|
| REVISIONS | DATE | DESIGNED | CHECKED | APPROVED | SUBMITTED |
|-----------|------|----------|---------|----------|-----------|

PLAN AND PROFILE OF SIDE DITCHES

PACKAGE: I CIVIL AND ARCHITECTURAL WORK


SCALE: AS NOTED DRAWING NO: CA-016

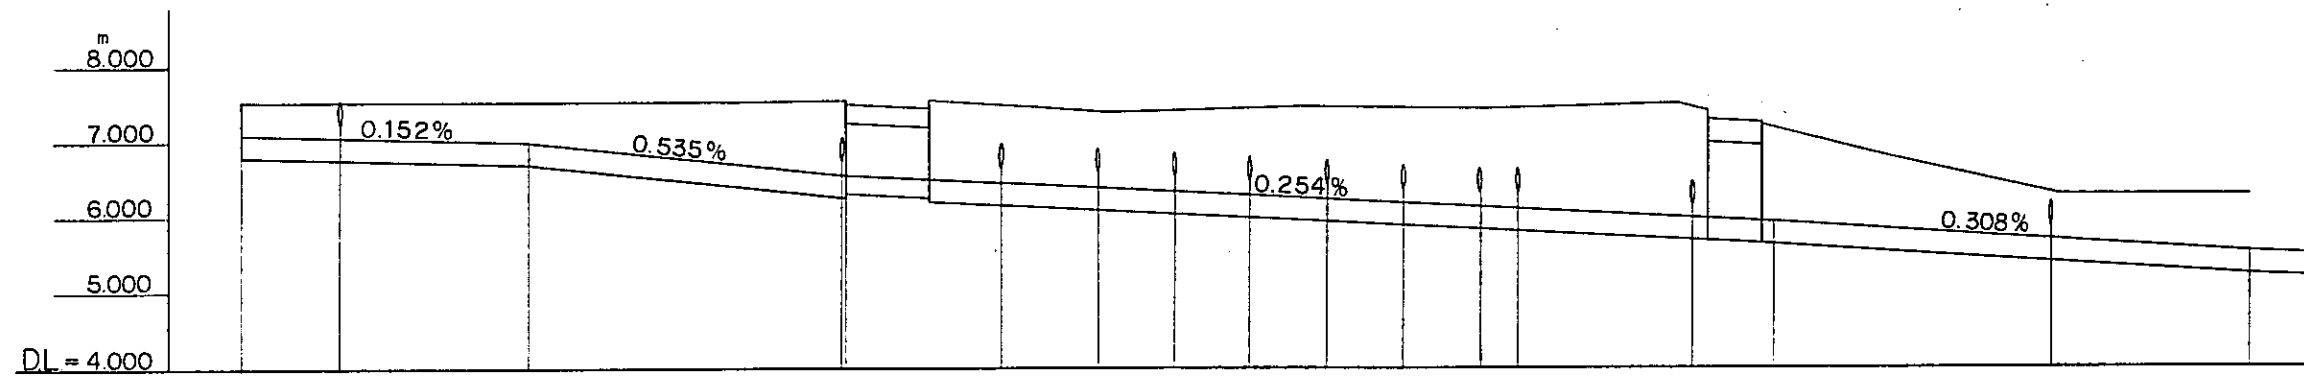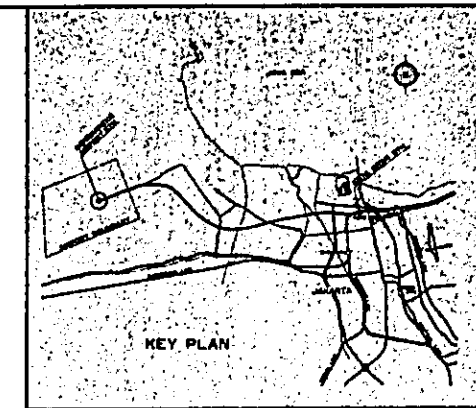

|                       |  |         |               |       |                        |              |             |             |             |             |             |                       |  |              |  |              |  |        |
|-----------------------|--|---------|---------------|-------|------------------------|--------------|-------------|-------------|-------------|-------------|-------------|-----------------------|--|--------------|--|--------------|--|--------|
| PIPE INVERT LEVEL     |  | 7.24    |               | 6.75  | 6.65                   | 6.60         | 6.54        | 6.49        | 6.43        | 6.38        | 6.33        | 6.34                  |  | 6.15         |  | 5.88         |  |        |
| DRAINING INVERT LEVEL |  | 7.100   |               | 6.550 |                        |              |             |             |             |             |             |                       |  | 5.930        |  | 5.527        |  |        |
| DISTANCE              |  | -225.50 | G1<br>-200.00 |       | A1<br>-70.00<br>-69.00 | B1<br>-27.00 | B2<br>-2.00 | B3<br>18.00 | B4<br>38.00 | B5<br>58.00 | B6<br>78.00 | B7<br>98.00<br>108.00 |  | C1<br>154.00 |  | H1<br>248.00 |  | 300.00 |

PROFILE (SIDE DRAIN A)  
SCALE H=1:1000  
V=1:50

NOTE:  
ALL DIMENSIONS ARE SHOWN IN METERS UNLESS OTHERWISE INDICATED.

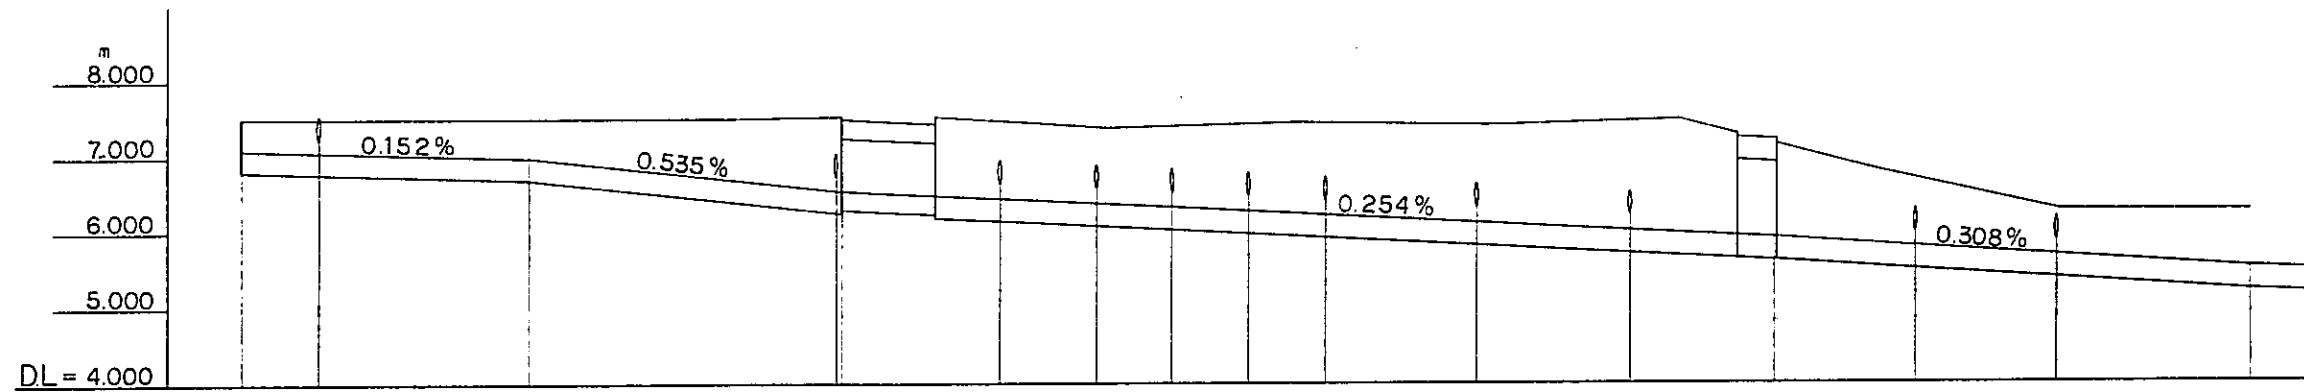

|                    |  |         |               |       |                         |              |             |             |             |             |              |               |       |              |       |              |  |        |
|--------------------|--|---------|---------------|-------|-------------------------|--------------|-------------|-------------|-------------|-------------|--------------|---------------|-------|--------------|-------|--------------|--|--------|
| PIPE INVERT LEVEL  |  | 7.24    |               | 6.75  | 6.65                    | 6.60         | 6.54        | 6.49        | 6.43        | 6.33        | 6.23         |               | 6.00  |              | 5.88  |              |  |        |
| DRAIN INVERT LEVEL |  | 7.100   |               | 6.550 |                         |              |             |             |             |             |              |               | 5.930 |              | 5.527 |              |  |        |
| DISTANCE           |  | -225.50 | G3<br>-206.00 |       | A10<br>-70.00<br>-69.00 | E1<br>-27.00 | E2<br>-2.00 | E3<br>17.00 | E4<br>37.00 | E5<br>57.00 | D16<br>97.00 | D17<br>137.00 |       | F4<br>212.00 |       | H4<br>249.00 |  | 300.00 |

PROFILE (SIDE DRAIN B)  
SCALE H=1:1000  
V=1:50

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DIRECTORATE GENERAL OF LAND TRANSPORT AND INLAND WATERWAYS

NEW RAILWAY LINE FOR CENGKARENG AIRPORT CONSTRUCTION PROJECT

JAPAN INTERNATIONAL COOPERATION AGENCY (JICA)


|   |             |     |     |     |     |      |     |
|---|-------------|-----|-----|-----|-----|------|-----|
| B | 1. Aug. 89  | J.J | J.J | J.J | I.H | K.M. | K   |
| A | 15. Feb. 89 | J.J | J.J | J.J | K.J | K.H  | K.H |

REVISIONS DATE DESIGNED CHECKED REVISIONS SUBMITTED


PROFILE OF SIDE DITCHES IN AIRPORT STATION YARD

PACKAGE: I CIVIL AND ARCHITECTURAL WORK


SCALE AS NOTED DRAWING NO. CA-017

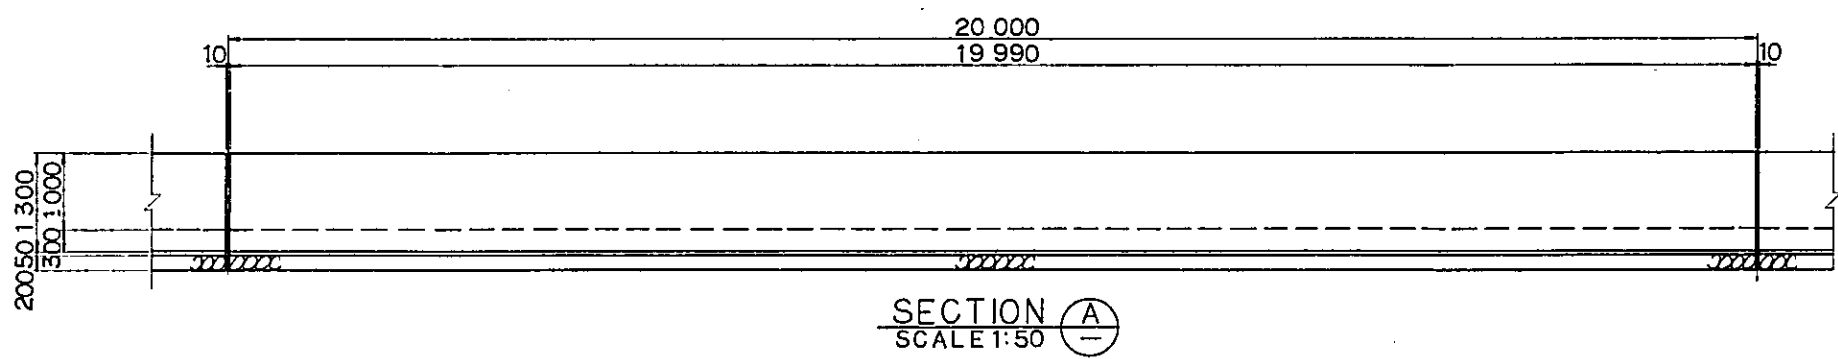


SECTION A  
SCALE 1:50

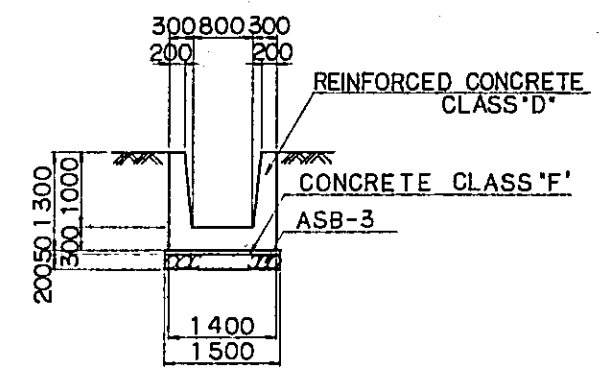


SECTION  
SCALE 1:50

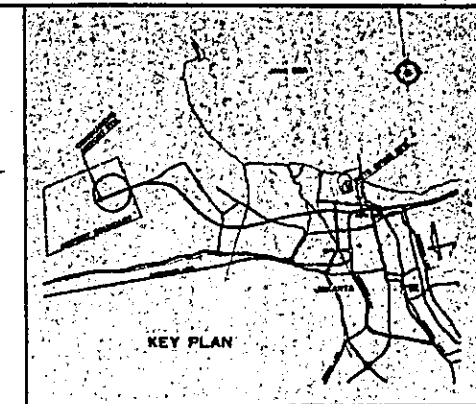


NOTE:  
ALL DIMENSIONS ARE SHOWN  
IN MILLIMETERS UNLESS  
OTHERWISE INDICATED.

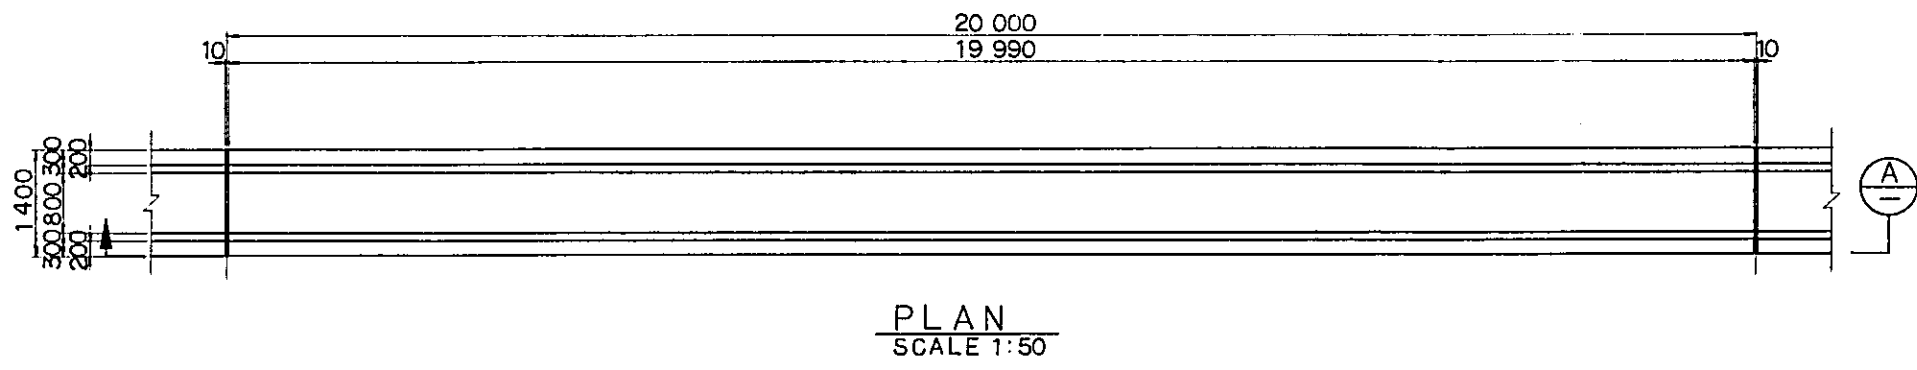


PLAN  
SCALE 1:50

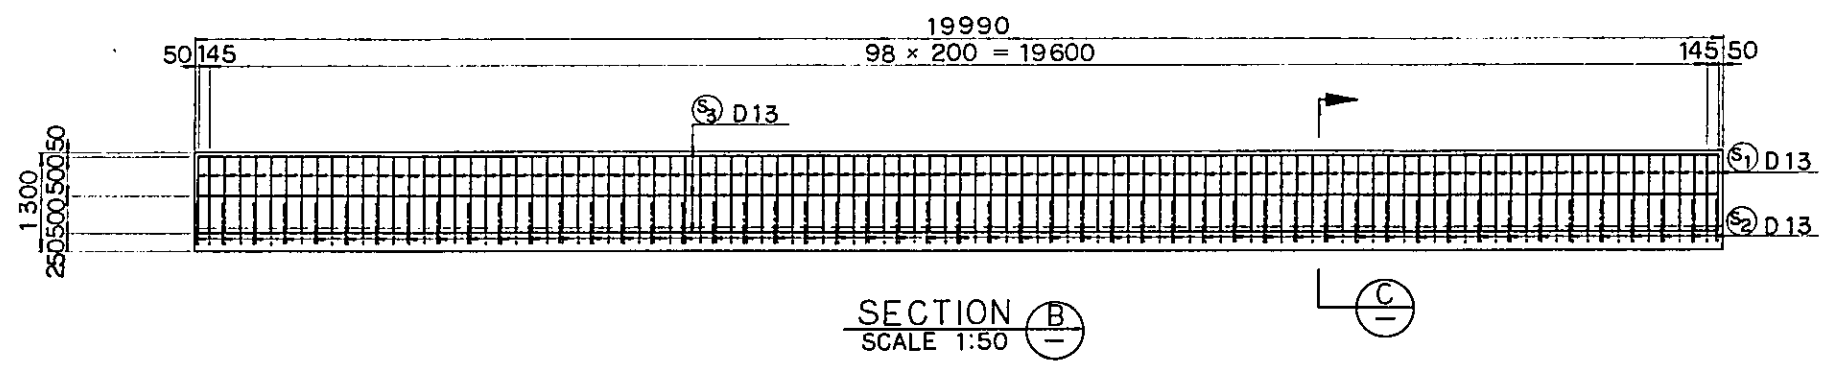

SECTION B  
SCALE 1:50

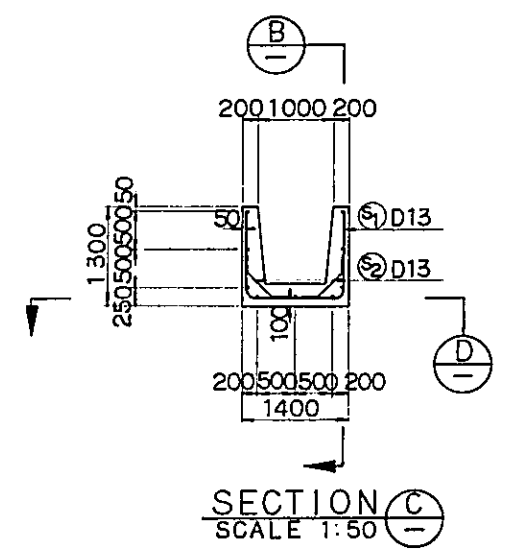

SECTION C  
SCALE 1:50

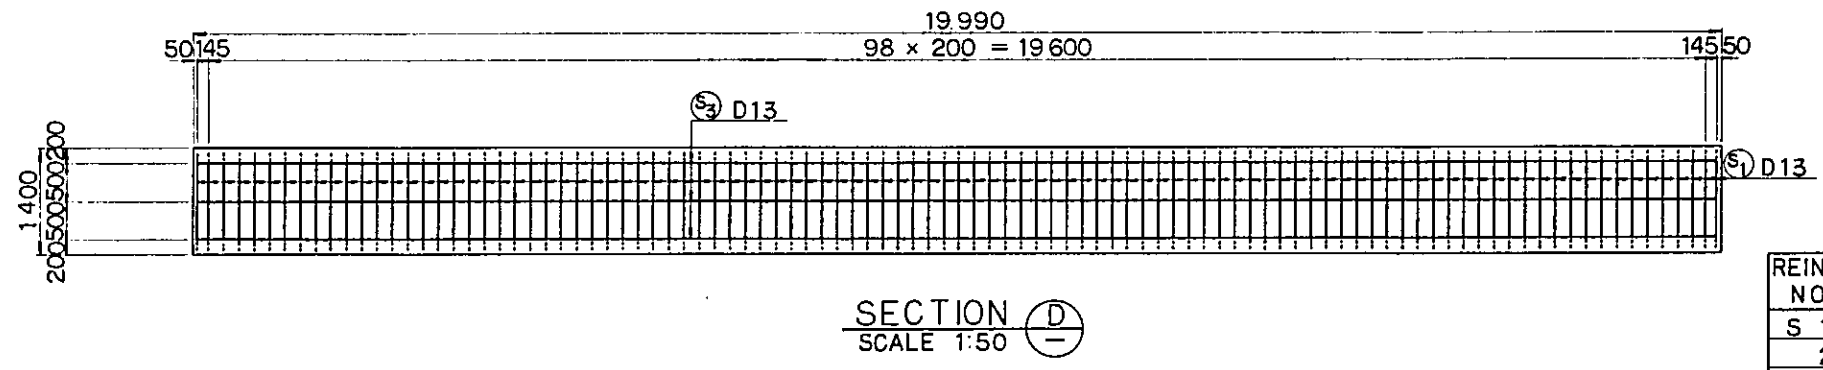


SECTION D  
SCALE 1:50

**BAR SCHEDULE (PER EACH)**

| REINF. NO.   | DIA. mm | LENGTH mm | NUMBER | U.WEIGHT kg/m | WEIGHT kg    | REMARKS |
|--------------|---------|-----------|--------|---------------|--------------|---------|
| S 1          | D13     | 3,480     | 101    | 0.995         | 349.8        |         |
| 2            | "       | 900       | 102    | "             | 91.4         |         |
| 3            | "       | 19,990    | 9      | "             | 179.0        |         |
| <b>TOTAL</b> |         |           |        |               | <b>620.2</b> |         |

|                    |                     |
|--------------------|---------------------|
| CONCRETE CLASS D   | 18.4 M <sup>3</sup> |
| F                  | 1.5                 |
| SUBBALLAST (ASB-3) | 6.0                 |

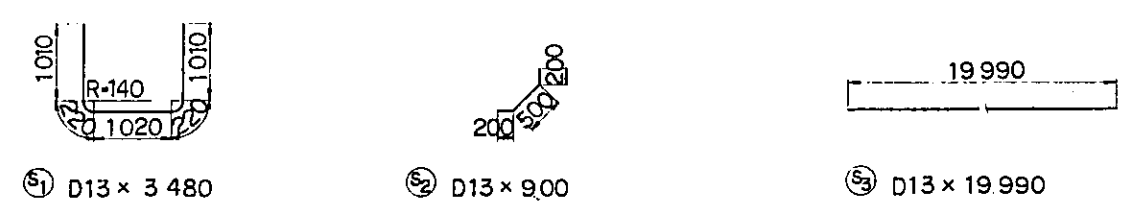

REPUBLIC OF INDONESIA  
MINISTRY OF COMMUNICATIONS  
DIRECTORATE GENERAL OF LAND TRANSPORT  
AND INLAND WATERWAYS

NEW RAILWAY LINE FOR CENGKARENG AIRPORT  
CONSTRUCTION PROJECT


JAPAN INTERNATIONAL COOPERATION AGENCY  
(JICA)

|   |             |      |      |      |      |      |      |      |      |
|---|-------------|------|------|------|------|------|------|------|------|
| B | 1. Aug. 99  | J.J. | J.J. | J.J. | J.J. | J.J. | J.J. | J.J. | J.J. |
| A | 15. Feb. 99 | J.J. | J.J. | J.J. | J.J. | J.J. | J.J. | J.J. | J.J. |


DETAIL  
OF  
SIDE DITCH

PACKAGE: I. CIVIL AND ARCHITECTURAL WORK


SCALE: AS NOTED      DRAWING NO: CA-018

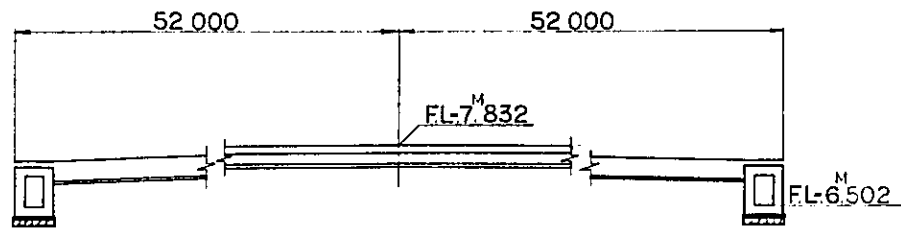


SECTION A  
SCALE 1:100

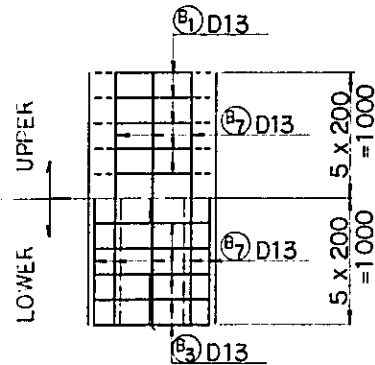


SECTION B  
SCALE 1:30

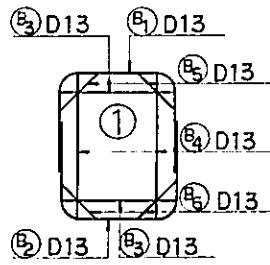

SECTION C  
SCALE 1:30

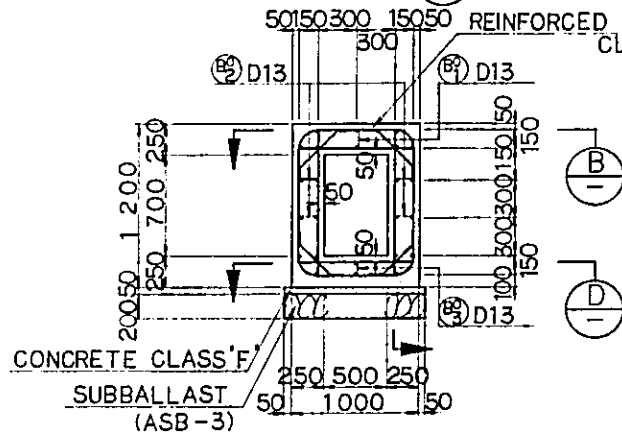


SECTION D  
SCALE 1:30


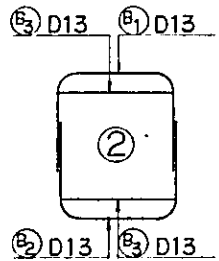


SECTION E  
SCALE 1:30


COMBINATION OF REINFORCEMENT c/c 200 mm

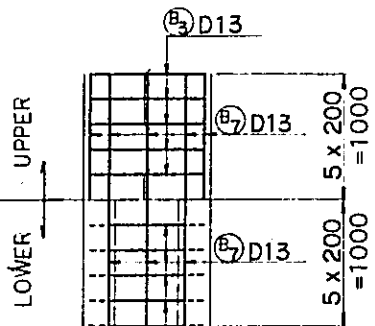

SECTION F  
SCALE 1:30

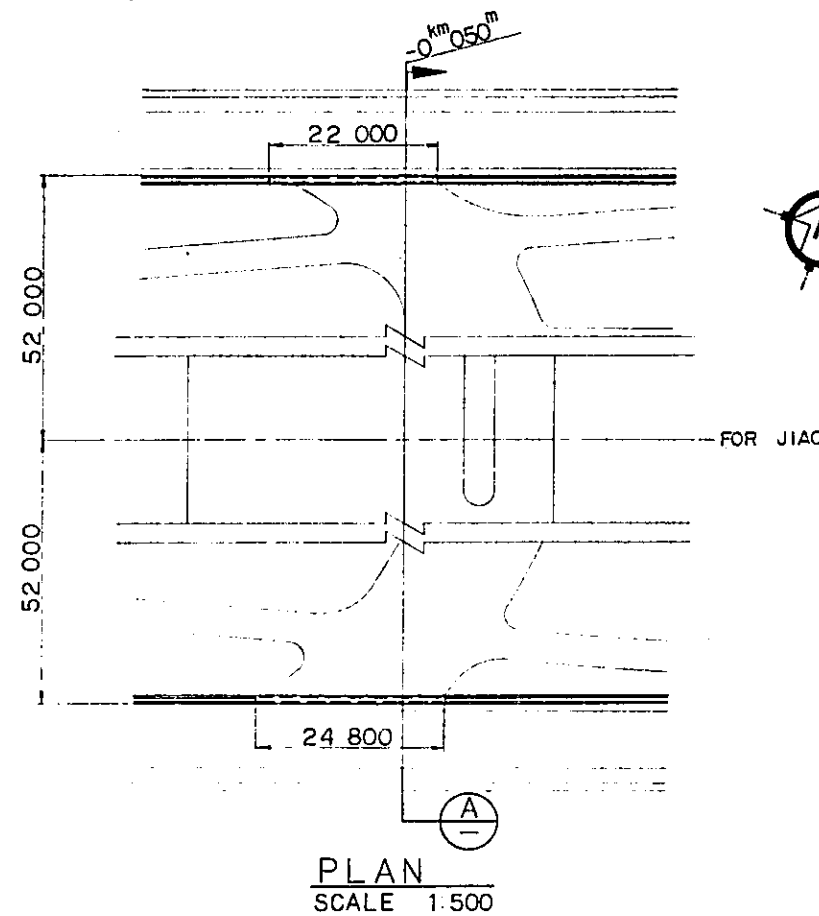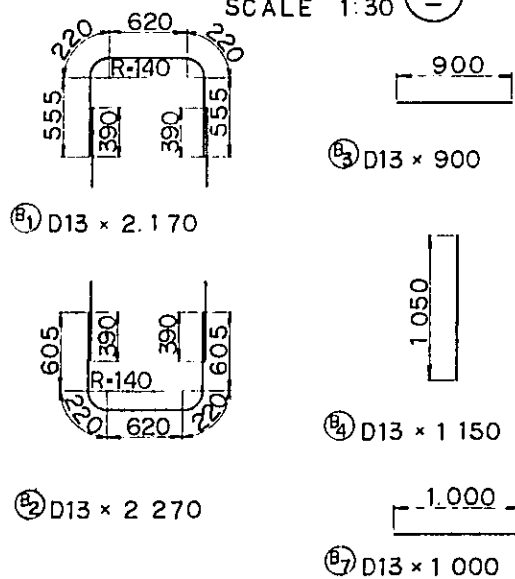

PLAN  
SCALE 1:500

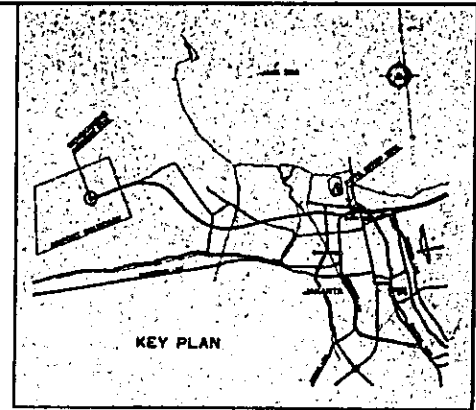

NOTE:  
ALL DIMENSIONS ARE SHOWN  
IN MILLIMETERS UNLESS  
OTHERWISE INDICATED.

BAR SCHEDULE (PER METER)

| REINF. NO. | DIA. mm | LENGTH mm | NUMBER | U.WEIGHT kg/m | WEIGHT kg | REMARKS |
|------------|---------|-----------|--------|---------------|-----------|---------|
| B 1        | D13     | 2,170     | 5      | 0.995         | 10.8      |         |
| 2          | "       | 2,270     | 5      | "             | 11.3      |         |
| 3          | "       | 900       | 10     | "             | 9.0       |         |
| 4          | "       | 1,050     | 5      | "             | 5.2       |         |
| 5          | "       | 600       | 5      | "             | 3.0       |         |
| 6          | "       | 550       | 5      | "             | 2.7       |         |
| 7          | "       | 1,000     | 24     | "             | 23.9      |         |
| B° 1       | "       | 980       | 1.5    | "             | 1.5       |         |
| 2          | "       | 380       | 5      | "             | 1.9       |         |
| 3          | "       | 880       | 1.5    | "             | 1.3       |         |
| TOTAL      |         |           |        |               | 70.6      |         |

CONCRETE CLASS D 0.9 M<sup>3</sup>

SUBBALLAST (ASB-3) 0.2

REPUBLIC OF INDONESIA  
MINISTRY OF COMMUNICATIONS  
DIRECTORATE GENERAL OF LAND TRANSPORT  
AND INLAND WATERWAYS

NEW RAILWAY LINE FOR CENKARENG AIRPORT  
CONSTRUCTION PROJECT


JAPAN INTERNATIONAL COOPERATION AGENCY  
(JICA)

| REVISIONS | DATE         | SKETCH | DRAWN | CHECKED | REVIEWED | SUBMITTED |
|-----------|--------------|--------|-------|---------|----------|-----------|
| B         | 1. Aug. '99  | J.J.   | J.J.  | I.M.    | K.M.     | A.K.      |
| A         | 15. Feb. '98 | J.J.   | J.J.  | K.S.    | K.M.     | A.K.      |


PLAN AND DETAILS  
OF  
BOX CULVERT  
AT STA. 0+050.00

PACKAGE: I CIVIL AND ARCHITECTURAL WORK


SCALE: AS NOTED  
DRAWING NO.: CA-019

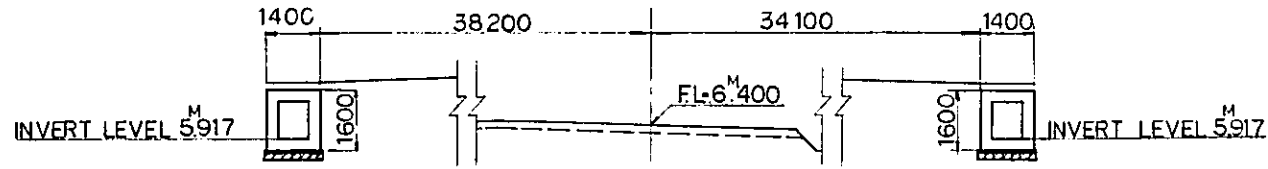


SECTION A  
SCALE 1:100

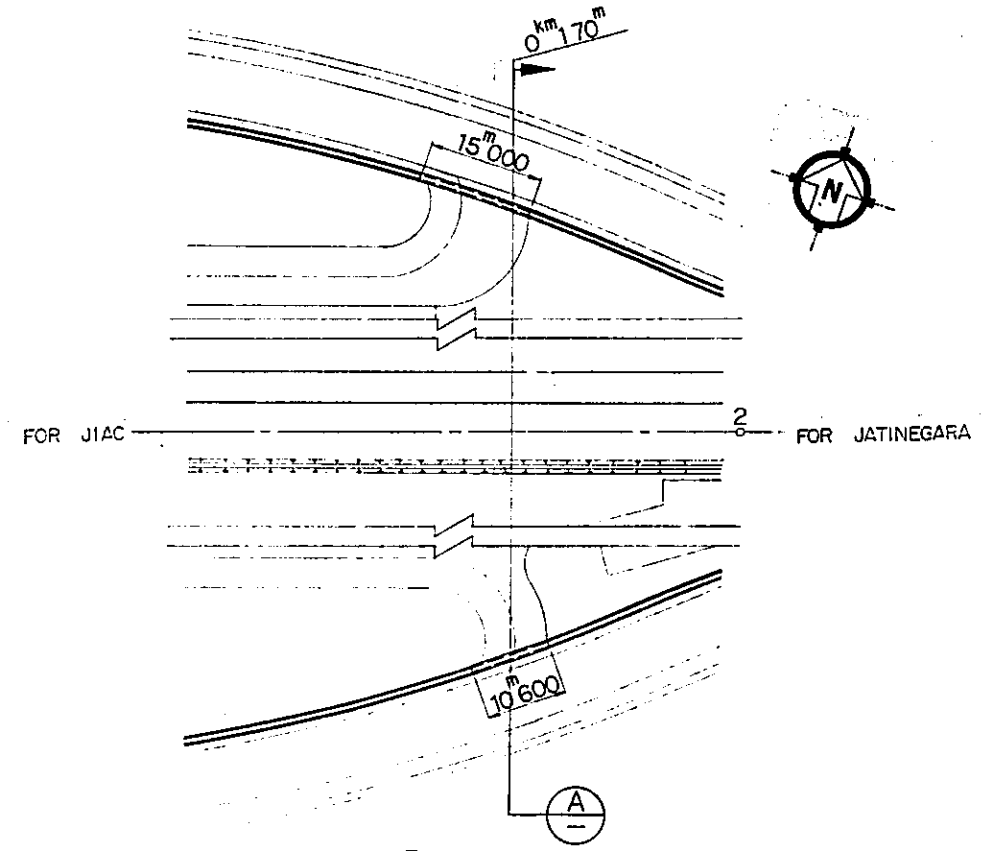


PLAN  
SCALE 1:500

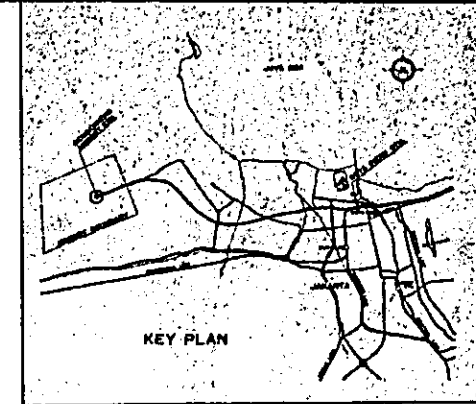


NOTE:  
ALL DIMENSIONS ARE SHOWN  
IN MILLIMETERS UNLESS  
OTHERWISE INDICATED.

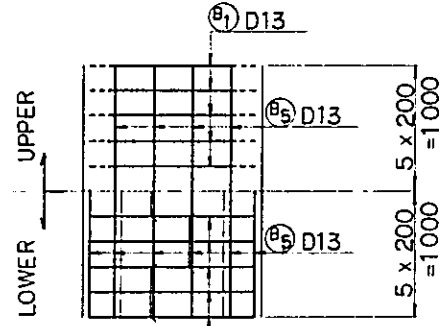


SECTION B  
SCALE 1:30

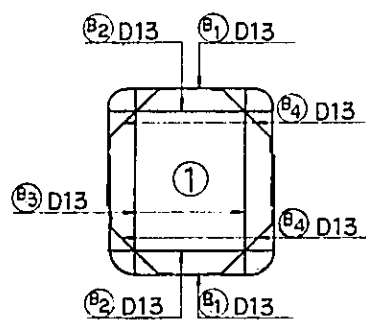

COMBINATION  
OF REINFORCEMENT  
etc 200mm

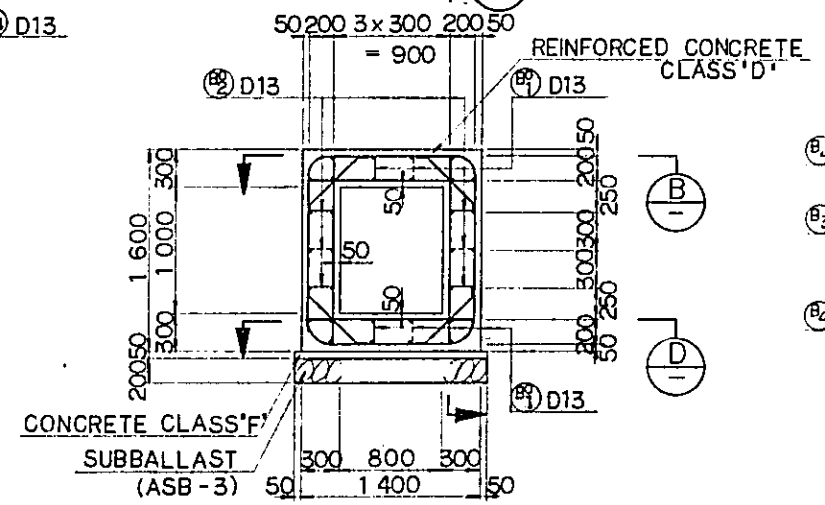

SECTION A  
SCALE 1:30

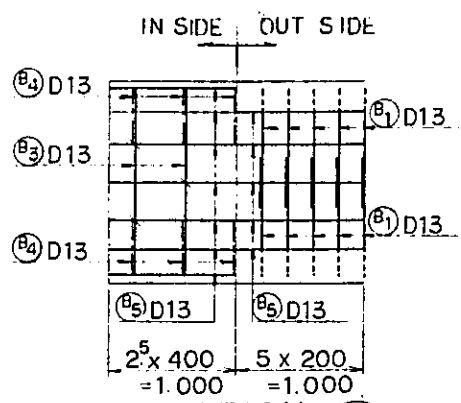


SECTION C  
SCALE 1:30


BAR SCHEDULE (PER METER)

| REINF. NO | DIA mm | LENGTH mm | NUMBER | U.WEIGHT kg/m | WEIGHT kg | REMARKS |
|-----------|--------|-----------|--------|---------------|-----------|---------|
| B 1       | D13    | 3,070     | 10     | 0.995         | 30.5      |         |
| 2         | "      | 1,300     | 10     | "             | 12.9      |         |
| 3         | "      | 1,450     | 5      | "             | 7.2       |         |
| 4         | "      | 750       | 10     | "             | 7.5       |         |
| 5         | "      | 1,000     | 32     | "             | 31.8      |         |
| B° 1      | "      | 1,080     | 5      | "             | 5.4       |         |
| 2         | "      | 430       | 6      | "             | 2.6       |         |
| TOTAL     |        |           |        |               | 97.9      |         |

CONCRETE CLASS D 1.4M<sup>3</sup>  
F 0.1  
SUBBALLAST (ASB-3) 0.3

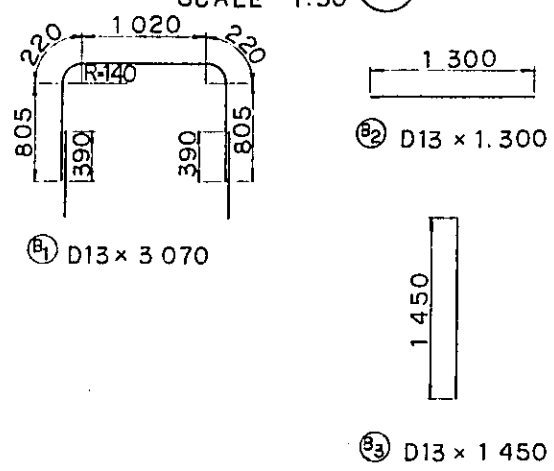

SECTION D  
SCALE 1:30

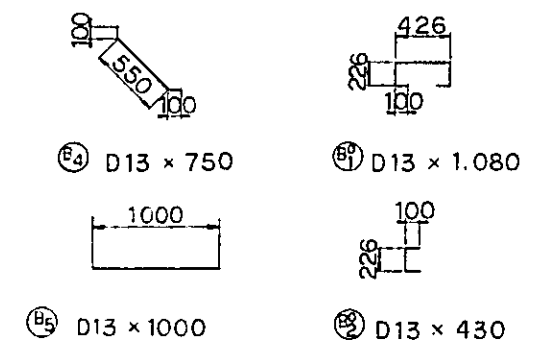

REPUBLIC OF INDONESIA  
MINISTRY OF COMMUNICATIONS  
DIRECTORATE GENERAL OF LAND TRANSPORT  
AND INLAND WATERWAYS


NEW RAILWAY LINE FOR CENGKARENG AIRPORT  
CONSTRUCTION PROJECT

JAPAN INTERNATIONAL COOPERATION AGENCY  
(JICA)


| REVISIONS | DATE        | DESIGNED | DRAWN | CHECKED | REVIEWED | SUBMITTED |
|-----------|-------------|----------|-------|---------|----------|-----------|
| B         | 1. April 89 | J.J.     | J.J.  | J.H.    | V.M.     | M.K.      |
| A         | 15. Feb 89  | J.J.     | J.J.  | K.S.    | K.H.     | M.L.      |

PLAN AND DETAILS  
OF  
BOX CULVERT  
AT STA. 0+170










PACKAGE: I CIVIL AND ARCHITECTURAL WORK  
SCALE: AS-NOTED DRAWING NO.: CA-020

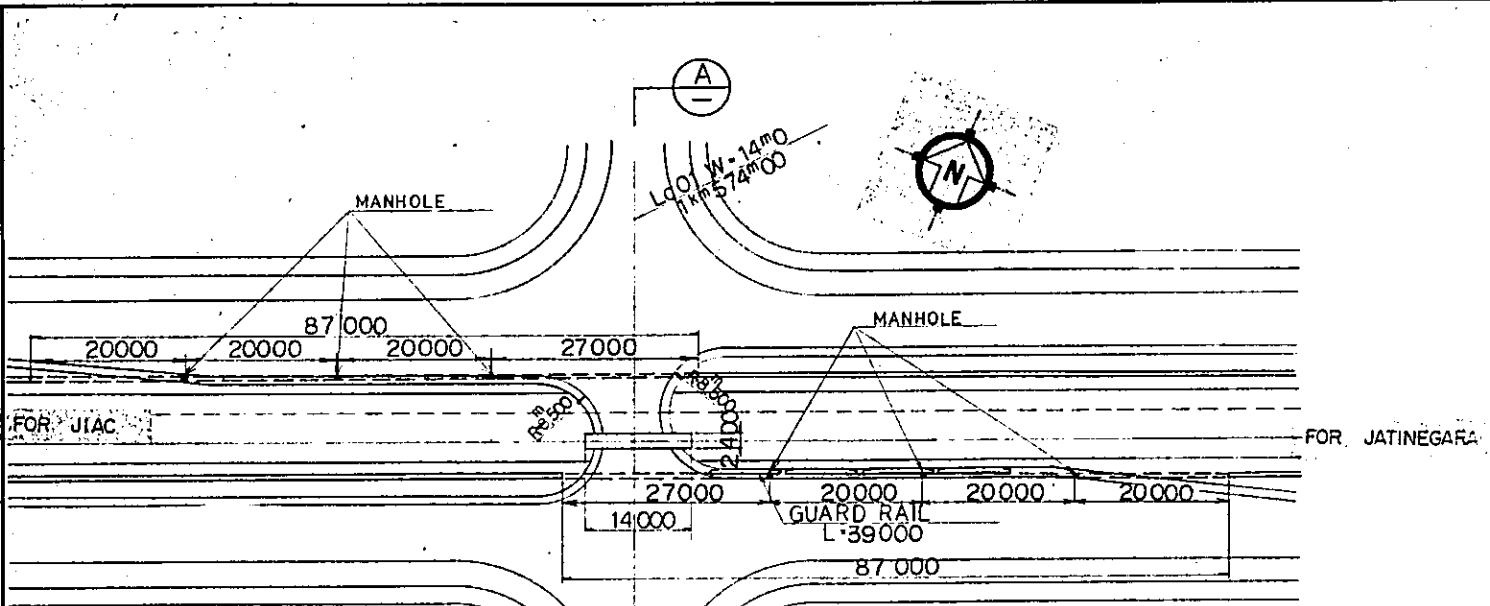









|               |                          |       |       |        |        |
|---------------|--------------------------|-------|-------|--------|--------|
| M             | 8.000                    |       |       |        |        |
|               | 7.000                    |       |       |        |        |
|               | 6.000                    |       |       |        |        |
|               | 5.000                    |       |       |        |        |
|               | 4.000                    |       |       |        |        |
|               | DRAIN INVERT LEVEL 5.068 |       |       |        |        |
| GRADIENT      | M                        | 7.516 | 7.516 | 7.516  | 7.516  |
| PROFILE GRADE | M                        | 7.516 | 7.516 | 7.516  | 7.516  |
| METERAGE      |                          | 0.000 | 3.800 | 12.000 | 16.075 |
|               |                          |       |       | 18.000 | 20.000 |

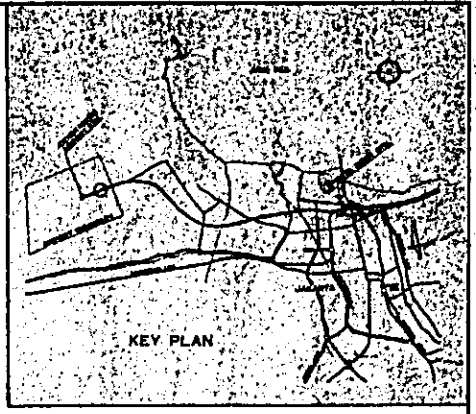

NOTE:  
ALL DIMENSIONS ARE SHOWN  
IN MILLIMETERS UNLESS  
OTHERWISE INDICATED.

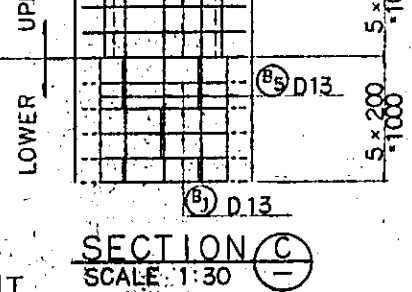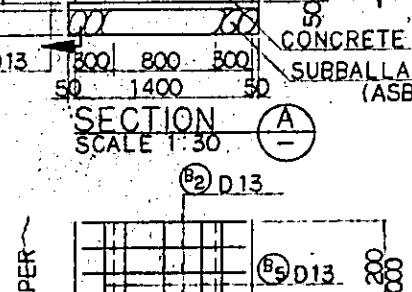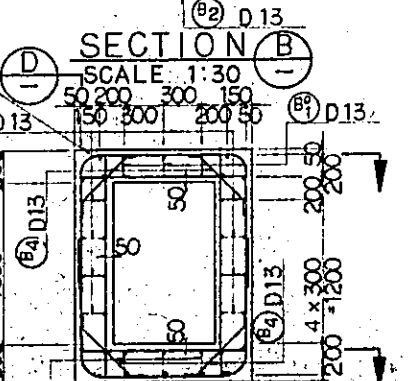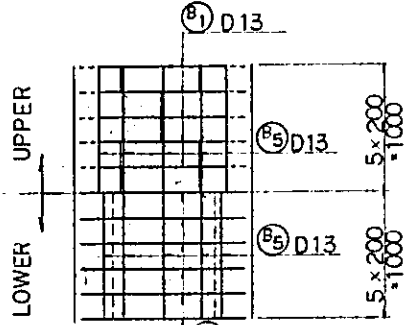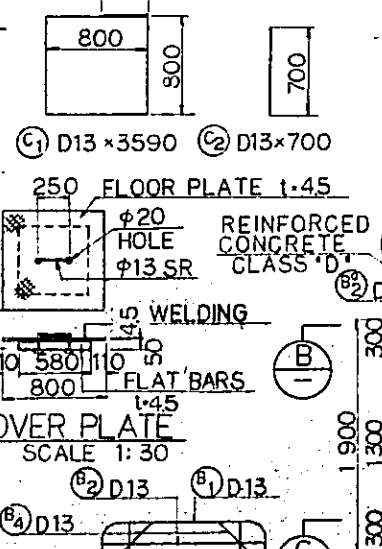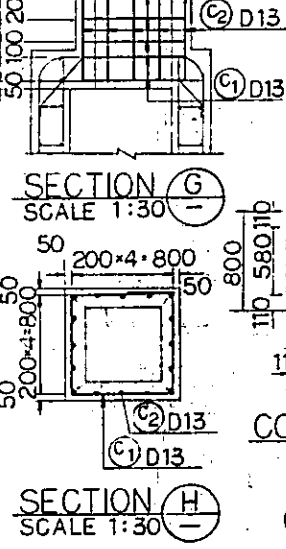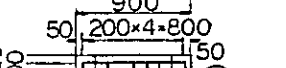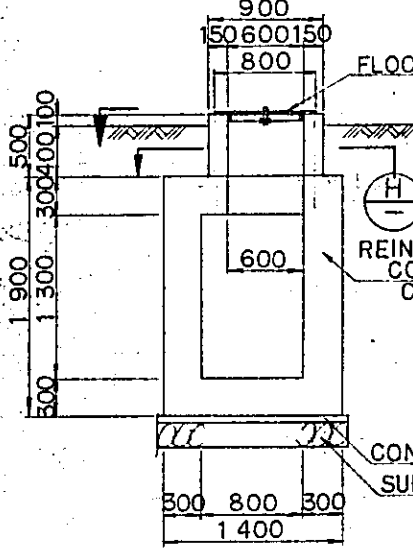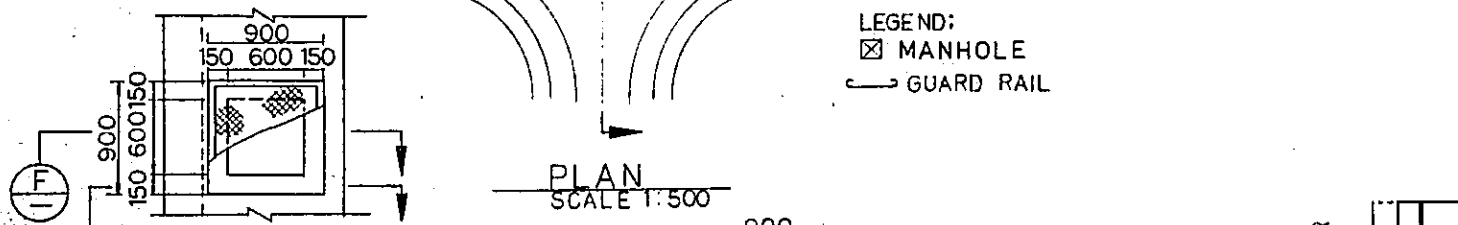

SECTION A  
SCALE H:1:250  
V:1:100

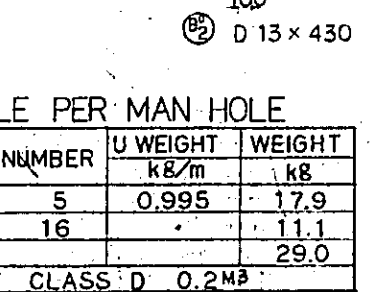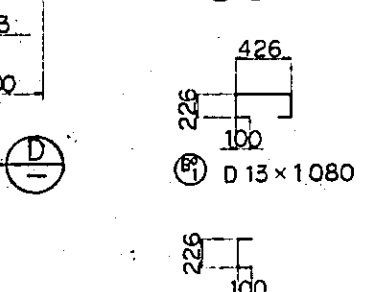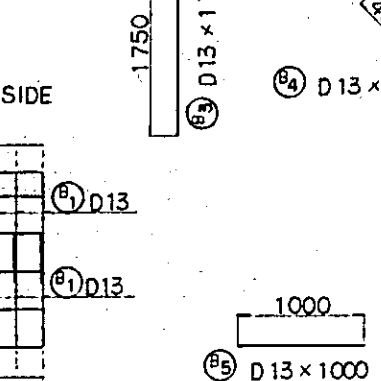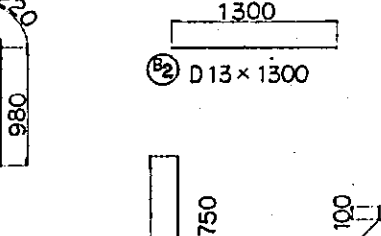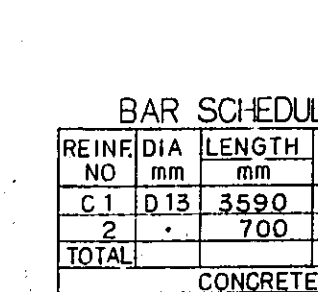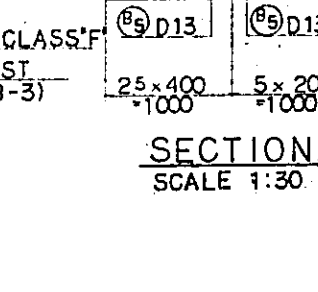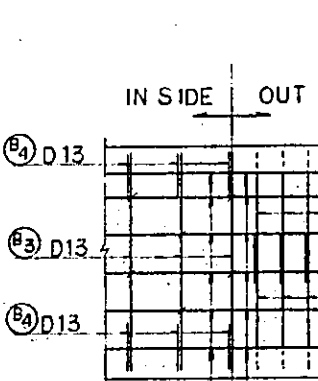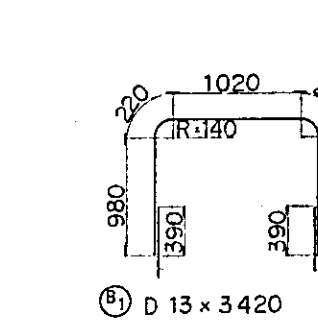

DETAIL OF MANHOLE  
SCALE 1:30 (ONE/20M)

BAR SCHEDULE (PER METER)

| REINF. NO | DIA. mm | LENGTH mm | NUMBER | U. WEIGHT kg/m     | WEIGHT kg          | REMARKS |
|-----------|---------|-----------|--------|--------------------|--------------------|---------|
| B 1       | D13     | 3 420     | 5      | 0.995              | 17.0               |         |
| 2         | "       | 1 300     | 10     | "                  | 12.9               |         |
| 3         | "       | 1 750     | 5      | "                  | 8.7                |         |
| 4         | "       | 700       | 10     | "                  | 7.0                |         |
| 5         | "       | 1 000     | 40     | "                  | 39.8               |         |
| B' 1      | "       | 1 080     | 8      | "                  | 8.6                |         |
| 2         | "       | 430       | 10     | "                  | 4.3                |         |
| TOTAL     |         |           |        |                    | 115.3              |         |
|           |         |           |        | CONCRETE CLASS D   | 1.6 M <sup>3</sup> |         |
|           |         |           |        | F                  | 0.1                |         |
|           |         |           |        | SUBBALLAST (ASB-3) | 0.3                |         |

COMBINATION OF REINFORCEMENT  
c.t.c 200

BAR SCHEDULE PER MAN HOLE

| REINF. NO | DIA. mm | LENGTH mm | NUMBER | U. WEIGHT kg/m   | WEIGHT kg          |
|-----------|---------|-----------|--------|------------------|--------------------|
| C 1       | D13     | 3 590     | 5      | 0.995            | 17.9               |
| 2         | "       | 700       | 16     | "                | 11.1               |
| TOTAL     |         |           |        |                  | 29.0               |
|           |         |           |        | CONCRETE CLASS D | 0.2 M <sup>3</sup> |

REPUBLIC OF INDONESIA  
MINISTRY OF COMMUNICATIONS  
DIRECTORATE GENERAL OF LAND TRANSPORT  
AND INLAND WATERWAYS

NEW RAILWAY LINE FOR CENGKARENG AIRPORT  
CONSTRUCTION PROJECT


JAPAN INTERNATIONAL COOPERATION AGENCY  
(JICA)

|   |             |      |      |      |      |      |
|---|-------------|------|------|------|------|------|
| B | 1. Aug. 84  | J.T. | J.T. | J.H. | K.M. | M.K. |
| A | 15. Feb. 84 | J.T. | J.T. | K.U. | K.M. | M.K. |

REVISORS DATE DESIGNED DRAWN CHECKED REVIEWED


PLAN AND DETAILS OF  
BOX CULVERT  
AT STA. 2+044

PACKAGE: I - CIVIL AND ARCHITECTURAL WORK  
SCALE: AS NOTED DRAWING NO: CA-021

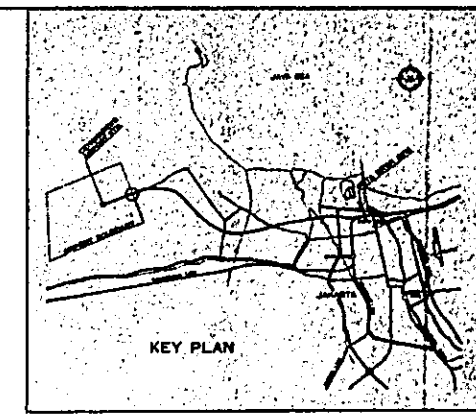

NOTE:  
ALL DIMENSIONS ARE SHOWN  
IN MILLIMETERS UNLESS  
OTHERWISE INDICATED.


LEGEND:  
--- TELECOMMUNICATION  
P12 ----- SYSTEM PRIMARY  
CABLE AND NUMBER  
OF CONDUITS

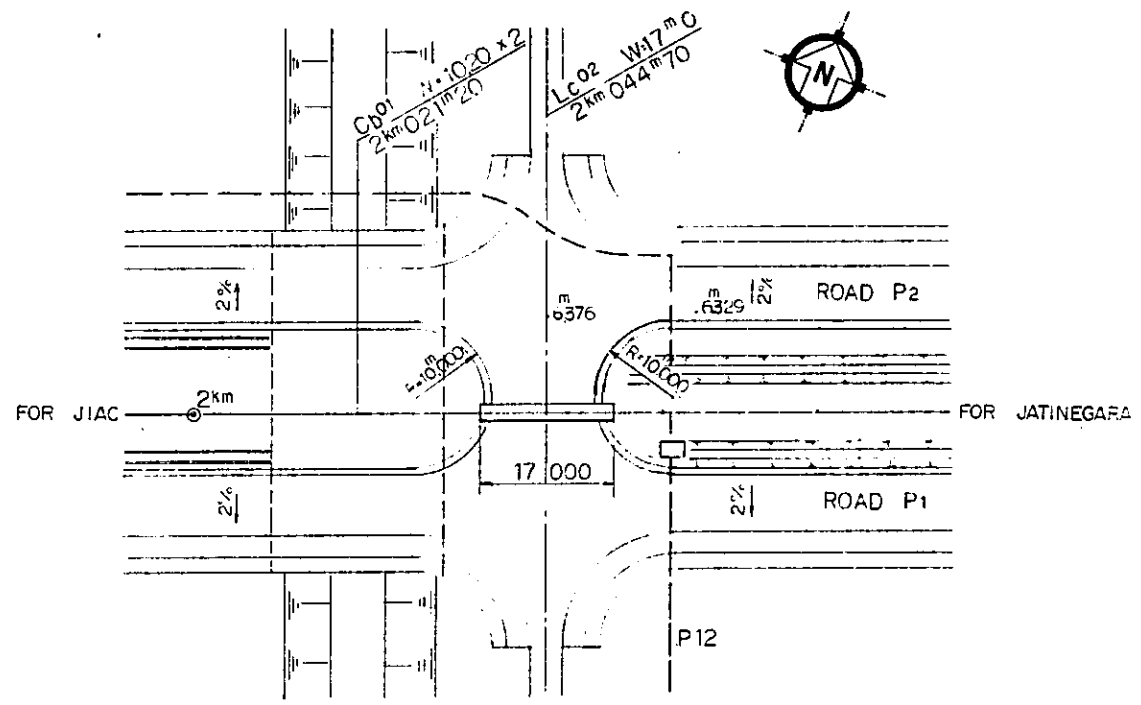


PLAN  
SCALE 1:500

|               |        |       |       |       |       |
|---------------|--------|-------|-------|-------|-------|
|               | M 7000 |       |       |       |       |
|               | 6000   | 3.56% | L     | L     | 6.15% |
| GRADIENT      | M 638  |       | 6.71  | 6.71  | 6.38  |
| PROFILE GRADE | M 638  | 6.36  | 6.38  | 6.38  | 6.38  |
| METERAGE      | 0.00   | 9.50  | 11.00 | 13.00 | 14.50 |
|               |        |       |       |       | 2000  |

SECTION A  
SCALE H: 1:250  
V: 1:100

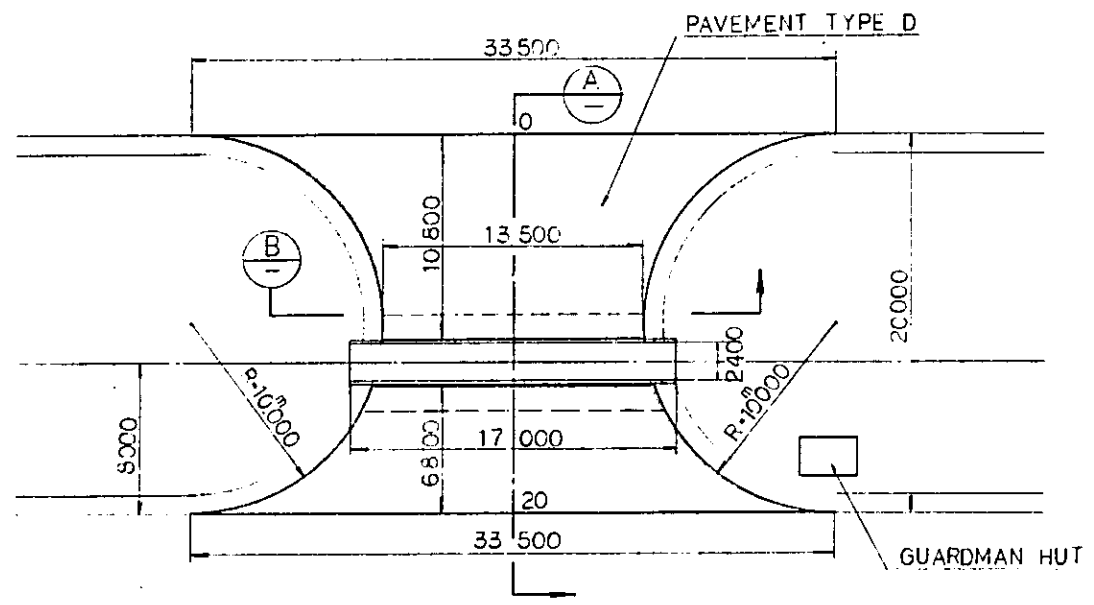

Lc 02 PLAN  
SCALE 1:200

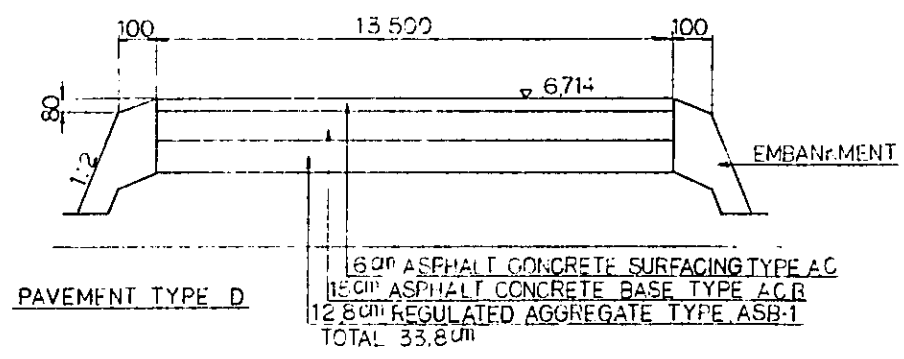

SECTION B  
SCALE H: 1:250  
V: 1:20

|  |             |          |       |         |          |
|--|-------------|----------|-------|---------|----------|
| REPUBLIC OF INDONESIA<br>MINISTRY OF COMMUNICATIONS<br>DIRECTORATE GENERAL OF LAND TRANSPORT<br>AND INLAND WATERWAYS |             |          |       |         |          |
| NEW RAILWAY LINE FOR CENGKARENG AIRPORT<br>CONSTRUCTION PROJECT  |             |          |       |         |          |
| JAPAN INTERNATIONAL COOPERATION AGENCY<br>(JICA)   |             |          |       |         |          |
| B  | 1. Aug. 88  | J.J      | J.J   | 1.11    | K.M      |
| A  | 15. Feb. 88 | J.J      | J.J   | K.S     | K.M      |
| REVISIONS  | DATE        | DESIGNED | DRAWN | CHECKED | APPROVED |
| PAVEMENT DETAIL<br>OF<br>LEVEL CROSSING<br>AT STA. 2 <sup>K</sup> 044 <sup>M</sup>                                   |             |          |       |         |          |
| PACKAGE: I CIVIL AND ARCHITECTURAL WORK.   |             |          |       |         |          |
| SCALE  | DRAWING NO. |          |       |         |          |
| AS NOTED   | CA-022      |          |       |         |          |



## GENERAL NOTES

### ARCHITECTURAL

1. ALL DRAWING MEASUREMENTS ARE IN MILLIMETERS, UNLESS OTHERWISE NOTED.
2. DRAWINGS SHALL BE ORIENTED TO AN ARBITRARY REFERENCE NORTH.
3. STRUCTURAL, MECHANICAL AND ELECTRICAL DRAWINGS SHALL BE COORDINATED WITH THE ARCHITECTURAL DRAWINGS.

### MECHANICAL

- A. VAC (VENTILATING AND AIR CONDITIONING)**
1. DESIGN CONDITIONS SHALL BE AS FOLLOWS:
    - a. AIR CONDITIONING (COOLING):
      - OUTDOOR 32.5°C DB, 65% RH
      - INDOOR 26°C DB, 50% RH
    - b. VENTILATION:
      - LAVATORY (FOR STAFF) 15 AIR CHANGES/H
      - LAVATORY (FOR PASSENGERS) 20 AIR CHANGES/H
      - KITCHEN 30 AIR CHANGES/H
      - OTHER ROOMS 10 AIR CHANGES/H
  2. SCOPE OF WORK
    - a. WORK SHALL INCLUDE ALL VAC WORK FOR THE FOLLOWING BUILDINGS:
      - 1) AIRPORT TERMINAL STATION
        - a) TERMINAL BUILDING
        - b) BOOKING OFFICE (A)
        - c) BOOKING OFFICE (B)
      - 2) KOTA INTAN STATION
      - 3) SIGNAL CABIN A
      - 4) SIGNAL CABIN B
- B. PLUMBING**
1. PLUMBING SHALL INCLUDE ALL WORK FOR THE PLUMBING SYSTEM
    - a. WATER SUPPLY PIPING
    - b. PLUMBING FIXTURES, SOIL, SEWER AND VENT PIPING
  2. PLUMBING SHALL INCLUDE ALL WORK FOR THE FOLLOWING BUILDINGS:
    - a. AIRPORT TERMINAL STATION
      - 1) TERMINAL BUILDING
      - 2) BOOKING OFFICE (A)
      - 3) BOOKING OFFICE (B)
    - b. KOTA INTAN STATION
    - c. SIGNAL CABIN A
    - d. SIGNAL CABIN B

### ELECTRICAL

- A. STATION PLAZA LIGHTING**
1. PLAZA LIGHTING SHALL BE CONTROLLED BY BUILT-IN PHOTOCELLS.
  2. CABLE SHALL BE COMPLETED BY 600-V/1000-V PVC/SWA/PVC INSTALLED DIRECTLY IN THE GROUND.
  3. CABLE SHALL NOT BE INSTALLED AT A DEPTH OF LESS THAN 600 MM OR A DEPTH OF MORE THAN 1000 MM.
  4. THE ARMOR OF ARMORED CABLE SHALL BE CONNECTED TO THE GROUND SYSTEM.
- B. DISTRIBUTION BOARDS**
1. ALL DISTRIBUTION BOARDS SHALL BE ENCLOSED IN METAL ENCLOSURES. METAL ENCLOSURES SHALL BE CONSTRUCTED OF HOT-DIP GALVANIZED SHEET STEEL.
  2. DISTRIBUTION BOARDS INSTALLED IN OPEN PLACES SUBJECT TO WIND, RAIN AND DUST SHALL BE OF A WATER- AND DUST-PROOF TYPE.
  3. ALL LIGHTING FITTINGS, ETC. SHALL BE CONNECTED TO CIRCUITS AS PHASE-BALANCED.
- C. CONSIDERATION SHALL BE GIVEN TO DERATING FACTORS DUE TO HIGH AMBIENT TEMPERATURE AFFECTING CIRCUIT BREAKERS, CURRENT-CARRYING CAPACITY OF CABLES, ETC.**
- D. LOCATION OF LIGHTING FITTINGS, SOCKET OUTLETS, ETC. SHALL BE FINALIZED IN ACCORDANCE WITH ARCHITECTURAL AND CIVIL PLANS AT THE CONSTRUCTION STAGE.**
- E. THE ELECTRICAL CONTRACTOR SHALL BE REQUESTED TO COORDINATE WITH ARCHITECTURAL, CIVIL AND MECHANICAL WORK.**

|  |            |             |       |         |          |           |
|--|------------|-------------|-------|---------|----------|-----------|
| REPUBLIC OF INDONESIA<br>MINISTRY OF COMMUNICATIONS<br>DIRECTORATE GENERAL OF LAND TRANSPORT<br>AND INLAND WATERWAYS |            |             |       |         |          |           |
| NEW RAILWAY LINE FOR CENGKARENG AIRPORT<br>CONSTRUCTION PROJECT  |            |             |       |         |          |           |
| JAPAN INTERNATIONAL COOPERATION AGENCY<br>(JICA)   |            |             |       |         |          |           |
| B  | 1. AUG '89 | T. Syah     | A. S. | T. Syah | K. M.    | K.        |
| A  | 15 FEB '89 | T. Syah     | R. J. | T. Syah | K. M.    | K.        |
| REVISIONS  | DATE       | DESIGNED    | DRAWN | CHECKED | REVIEWED | SUBMITTED |
| GENERAL NOTES  |            |             |       |         |          |           |
| PACKAGE: I CIVIL AND ARCHITECTURAL WORK  |            |             |       |         |          |           |
| SCALE  |            | DRAWING NO. |       |         |          |           |
| NONE   |            | AG - 001    |       |         |          |           |



# LEGEND

## ARCHITECTURAL

| SYMBOL | DESCRIPTION                         |
|--------|-------------------------------------|
|        | EARTH                               |
|        | BRICK / TERRAZZO TILE / MARBLE TILE |
|        | MORTAR / SAND GRAVEL CEMENT         |
|        | GRAVEL                              |
|        | INSULATION                          |
|        | STRUCTURAL STEEL                    |
|        | WOOD                                |
|        | CONCRETE                            |
|        | LIGHTWEIGHT CONCRETE                |

|  |                               |
|--|-------------------------------|
|  | SUPPLY AIR DUCT               |
|  | RETURN AIR & VENTILATING DUCT |
|  | SOUND-ABSORBENT CHAMBER       |
|  | VOLUME DAMPER                 |
|  | WALL EXHAUST FAN W/EAG        |
|  | PIPE EXHAUST FAN              |
|  | DOOR LOUVER                   |

|  |  |
|--|--|
|  | EMERGENCY LIGHTING FITTING WITH ARROW ENGRAVED ON THE DIFFUSER (20 W)            |
|  | EMERGENCY LIGHTING FITTING WITH "EXIT" ENGRAVED ON THE DIFFUSER (20 W)           |
|  | MERCURY-VAPOR LIGHTING FITTING, POLE, 15 M HIGH (700 W x 6)                      |
|  | MERCURY-VAPOR LIGHTING FITTING, POLE, 8 M HIGH (250 W x 2)                       |
|  | MERCURY-VAPOR LIGHTING FITTING, POLE, 8 M HIGH (250 W)                           |
|  | MERCURY-VAPOR LIGHTING FITTING, POLE 3.5M HIGH WITH INSECT KILLER (200 W)        |
|  | MERCURY-VAPOR LIGHTING FITTING, POLE, 1.2 M HIGH APPROACH LIGHT (40 W)           |
|  | 15-A, SINGLE-PHASE, DUPLEX-SOCKET OUTLET WITH GROUNDING POLE                     |
|  | 15-A, SINGLE-PHASE, SINGLE-SOCKET OUTLET WITH GROUNDING POLE FOR EXHAUST FAN     |
|  | 20-A, SINGLE-PHASE, SINGLE-SOCKET OUTLET WITH GROUNDING POLE FOR AIR CONDITIONER |
|  | 5-A, ONE-WAY TUMBLER SWITCH  |
|  | 5-A, THREE-WAY TUMBLER SWITCH  |
|  | PUSH-BUTTON STATION  |
|  | MOTOR (FURNISHED BY MECHANICAL WORK)   |
|  | DISTRIBUTION BOARD   |
|  | CONTROL PANEL (FURNISHED BY MECHANICAL WORK)                                     |
|  | MOULDED-CASE CIRCUIT BREAKER   |
|  | MOULDED-CASE CIRCUIT BREAKER, WITH EARTH-LEAKAGE DETECTING DEVICE                |
|  | GROUND   |
|  | ISOLATING SWITCH-FUSE, METAL-ENCLOSED, TRIPLE-POLE AND NEUTRAL                   |

## MECHANICAL

| SYMBOL | DESCRIPTION                                  |
|--------|--|
|        | POTABLE WATER PIPE AND IRRIGATION WATER PIPE |
|        | RAIN WATER PIPE                              |
|        | SOIL & WASTE PIPE                            |
|        | VENT PIPE                                    |
|        | CONDENSATE DRAIN PIPE                        |
|        | TANK DRAIN                                   |
|        | POTABLE WATER FAUCET                         |
|        | IRRIGATION VALVE                             |
|        | FLUSH VALVE                                  |
|        | GATE VALVE                                   |
|        | CHECK VALVE                                  |
|        | FLEXIBLE JOINT                               |
|        | FLOAT VALVE                                  |
|        | STRAINER (Y TYPE)                            |
|        | FLOOR CLEAN OUT                              |
|        | FLOOR DRAIN & ROUND STRAINER                 |
|        | VENT CAP                                     |
|        | SANITARY SEWER (INVERTED MANHOLE)            |
|        | CATCH BASIN                                  |

## ELECTRICAL

| SYMBOL | DESCRIPTION  |
|--------|--|
|        | INCANDESCENT LIGHTING FITTING, WITH DIFFUSER, FIXED DIRECTLY TO CEILING (100 W)                |
|        | INCANDESCENT LIGHTING FITTING, WITH DIFFUSER, FIXED DIRECTLY TO WALL (100 W)                   |
|        | INCANDESCENT LIGHTING FITTING, RECESSED IN FALSE CEILING (100 W)                               |
|        | INCANDESCENT LIGHTING FITTING, CHANDELIER (40 W x 5)   |
|        | FLUORESCENT LIGHTING FITTING, RECESSED IN FALSE CEILING (40 W)                                 |
|        | FLUORESCENT LIGHTING FITTING, WITH REFLECTOR, FIXED DIRECTLY TO CEILING (40 W)                 |
|        | FLUORESCENT LIGHTING FITTING, RECESSED IN FALSE CEILING (40 W x 2)                             |
|        | FLUORESCENT LIGHTING FITTING, WITH REFLECTOR, FIXED DIRECTLY TO CEILING (40 W x 2)             |
|        | FLUORESCENT LIGHTING FITTING, WITH COVER, FIXED DIRECTLY TO WALL (40 W)                        |
|        | FLUORESCENT LIGHTING FITTING, WITH REFLECTOR, FIXED DIRECTLY TO CEILING OR RACEWAY (110 W)     |
|        | FLUORESCENT LIGHTING FITTING, WITH REFLECTOR, FIXED DIRECTLY TO WALL (110 W)                   |
|        | FLUORESCENT LIGHTING FITTING, WITH REFLECTOR, FIXED DIRECTLY TO CEILING OR RACEWAY (110 W x 2) |
|        | FLUORESCENT LIGHTING FITTING, WITH REFLECTOR, FIXED DIRECTLY TO WALL (110 W x 2)               |
|        | HIGH-PRESSURE SODIUM LIGHTING FITTING, FIXED DIRECTLY TO CEILING (150 W)                       |
|        | HIGH-PRESSURE SODIUM LIGHTING FITTING, FIXED DIRECTLY TO CEILING (250 W)                       |
|        | METAL-HALIDE LIGHTING FITTING, FIXED DIRECTLY TO CEILING (300 W)                               |
|        | METAL-HALIDE LIGHTING FITTING, FIXED DIRECTLY TO CEILING (400 W)                               |

|   |           |                      |       |         |          |           |
|---|-----------|----------------------|-------|---------|----------|-----------|
| <b>REPUBLIC OF INDONESIA</b><br>MINISTRY OF COMMUNICATIONS<br>DIRECTORATE GENERAL OF LAND TRANSPORT<br>AND INLAND WATERWAYS |           |                      |       |         |          |           |
| <b>NEW RAILWAY LINE FOR CENGKARENG AIRPORT<br/>                     CONSTRUCTION PROJECT</b>                                |           |                      |       |         |          |           |
| JAPAN INTERNATIONAL COOPERATION AGENCY<br>(JICA)  |           |                      |       |         |          |           |
| B   | 1 AUG 84  | 15-16                | 2-5   | 2-5     | K.M.     | ink       |
| A   | 15 FEB 84 | 15-16                | 2-5   | 2-5     | K.M.     | ink       |
| REVISIONS   | DATE      | DESIGNED             | DRAWN | CHECKED | REVIEWED | SUBMITTED |
| <b>LEGEND</b>   |           |                      |       |         |          |           |
| PACKAGE: I CIVIL AND ARCHITECTURAL WORK   |           |                      |       |         |          |           |
| SCALE: NONE   |           | DRAWING NO: AG - 003 |       |         |          |           |

EXTERNAL FINISH SCHEDULE

| DESCRIPTIONS                                   | ROOF              |                                  | FASCIA                       |                              | SOFFIT           |                               | WALL       |                      | COLUMN                        |                     | BEAM   |      | FLOOR         |                               | REMARKS |       |       |             |                  |                            |
|--|-------------------|----------------------------------|------------------------------|------------------------------|------------------|-------------------------------|------------|----------------------|-------------------------------|---------------------|--|------|---------------|-------------------------------|---------|-------|-------|-------------|------------------|----------------------------|
|  | CLAY ROOFING TILE | CORRUGATED ASBESTOS CEMENT SHEET | MORTAR STEEL TROWEL (TYPE 1) | MORTAR STEEL TROWEL (TYPE 2) | BUILT-UP ROOFING | FIBERGLASS REINFORCED PLASTIC | WIRE GLASS | PAINT ON METAL PLATE | SPRAYED ACRYLIC RESIN COATING | FAIR FACED CONCRETE | SPRAYED ACRYLIC RESIN COATING ON ASBESTOS CEMENT BOARD | WOOD | BRICK MASONRY | SPRAYED ACRYLIC RESIN COATING |         | PAINT | PAINT | QUARRY TILE | ASPHALT CONCRETE | MORTAR STEEL TROWEL FINISH |
| <b>AIRPORT TERMINAL STATION</b>                |                   |                                  | TERMINAL BUILDING                              |                   |                                  | TERMINAL BUILDING (DECORATIVE ROOF)            |                   |                                  |                              |                              |                  |                               |            |                      |                               |                     |  |      |               |                               |         |       |       |             |                  | EXCEPT CONCOURSE FLOOR     |
| BOOKING OFFICE                                 |                   |                                  | PLATFORM                                       |                   |                                  | <b>KOTA INTAN STATION</b>                      |                   |                                  | PLATFORM                                       |                   |                                  | STATION BUILDING                               |                   |                                  | SIGNAL TELECOM DEVICE ROOM AND STORAGE         |                   |                                  | TRAIN CONTROL OFFICE AND SIGNAL TELECOM OFFICE |                   |                                  | STATION PLAZA                                  |                   |                                  |                              |                              |                  |                               |            |                      |                               |                     |  |      |               |                               |         |       |       |             |                  | EXCEPT CONCOURSE FLOOR     |
| BUS STOP SHELTER                               |                   |                                  | <b>SIGNAL CABIN</b>                            |                   |                                  | A  |                   |                                  | B  |                   |                                  | <b>CROSSING WATCHMAN'S BOX</b>                 |                   |                                  | DUMP YARD                                      |                   |                                  
(TYPE 1) WITHOUT INSULATION  
 (TYPE 2) WITH RIGID INSULATION 50mm THK.

REPUBLIC OF INDONESIA  
 MINISTRY OF COMMUNICATIONS  
 DIRECTORATE GENERAL OF LAND TRANSPORT AND INLAND WATERWAYS

NEW RAILWAY LINE FOR CENKARENG AIRPORT CONSTRUCTION PROJECT

JAPAN INTERNATIONAL COOPERATION AGENCY (JICA)

|           |           |          |       |         |          |           |    |    |    |    |    |    |    |    |    |    |    |    |    |    |
|-----------|-----------|----------|-------|---------|----------|-----------|----|----|----|----|----|----|----|----|----|----|----|----|----|----|
| B         | 1 AUG 89  | TS       | TS    | TS      | TS       | TS        | TS | TS | TS | TS | TS | TS | TS | TS | TS | TS | TS | TS | TS | TS |
| A         | 15 FEB 89 | TS       | TS    | TS      | TS       | TS        | TS | TS | TS | TS | TS | TS | TS | TS | TS | TS | TS | TS | TS | TS |
| REVISIONS | DATE      | DESIGNED | DRAWN | CHECKED | REVIEWED | SUBMITTED |    |    |    |    |    |    |    |    |    |    |    |    |    |    |

EXTERNAL FINISH SCHEDULE

PACKAGE: I CIVIL AND ARCHITECTURAL WORK  
 SCALE: NONE DRAWING NO: AA - 001



KOTA INTAN STATION

INTERNAL FINISH SCHEDULE - 2

| DESCRIPTIONS                                   |                                   | FINISHED FLOOR LEVEL FROM GL.±0 | FLOOR       |               |             |                      |                              |        |                            |                  | SKIRTING                          |                       |                             | WALL                  |                                    |   |                                     | CEILING                    |                 |                                |               | REMARKS |                               |                        |                                |                   |                     |                |  |  |  |  |  |                                |                                |
|--|-----------------------------------|---------------------------------|-------------|---------------|-------------|----------------------|------------------------------|--------|----------------------------|------------------|-----------------------------------|-----------------------|-----------------------------|-----------------------|------------------------------------|---|-------------------------------------|----------------------------|-----------------|--------------------------------|---------------|---------|-------------------------------|------------------------|--------------------------------|-------------------|---------------------|----------------|--|--|--|--|--|--------------------------------|--------------------------------|
| BUILDING                                       | ROOM NAME                         |                                 | MARBLE TILE | TERRAZZO TILE | QUARRY TILE | RESILIENT FLOOR TILE | UNGLAZED CERAMIC MOSAIC TILE | CARPET | MORTAR STEEL TROWEL FINISH | ASPHALT CONCRETE | PRECAST CONCRETE PAVER W/NON-SLIP | TERRAZZO TILE H=100mm | RESILIENT COVE BASE H=100mm | PRINT ON WOOD H=100mm | MORTAR STEEL TROWEL FINISH H=100mm | MATTE GLAZED COVE BASE CERAMIC TILE H=100mm | PAINT ON MORTAR STEEL TROWEL FINISH | MORTAR STEEL TROWEL FINISH | GYPSPUM PLASTER | MATTE GLAZED CERAMIC WALL TILE | BRICK MASONRY |         | SPRAYED ACRYLIC RESIN COATING | MINERAL ACOUSTIC BOARD | PAINT ON ASBESTOS CEMENT BOARD | PAINT ON CONCRETE | FAIR FACED CONCRETE | CEILING HEIGHT |  |  |  |  |  |                                |                                |
| PLATFORM                                       | STAIRCASE                         | -                               |             |               |  |                                   | STATION BLDG.                                  | CONCOURSE                         | 0                               |             | ○             |             |                      |                              |        |                            |                  |                                   |                       |                             |                       |                                    | ○   | ○                                   |                            |                 |                                |               |         |                               | ○                      |                                |                   | 6000                |                |  |  |  |  |  |                                |                                |
|  | PASSENGERS' WAITING AND CAFETERIA | 0                               |             | ○             |             |                      |                              |        |                            |                  |                                   |                       |                             |                       |                                    | ○   | ○                                   |                            |                 |                                |               |         |                               | ○                      |                                |                   | 2500                |                |  |  |  |  |  |                                |                                |
|  | PASSENGERS' LAVATORY              | 0                               |             |               | ○           |                      |                              |        |                            |                  |                                   |                       |                             |                       |                                    |   |                                     |                            | ○               |                                |               |         |                               | ○                      |                                |                   | 2500                |                |  |  |  |  |  |                                |                                |
|  | PORTER                            | 0                               |             |               | ○           |                      |                              |        |                            |                  |                                   |                       | ○                           |                       |                                    |   | ○                                   | ○                          |                 |                                |               |         |                               |                        | ○                              |                   | 2500                |                |  |  |  |  |  |                                |                                |
|  | MAINTENANCE AND JANITORS' ROOM    | 0                               |             |               | ○           |                      |                              |        |                            |                  |                                   | ○                     | ○                           |                       |                                    |   | ○                                   | ○                          |                 |                                |               |         |                               |                        | ○                              |                   | 2500                |                |  |  |  |  |  |                                |                                |
|  | STATION OFFICE                    | 0                               |             |               | ○           |                      |                              |        |                            |                  |                                   | ○                     | ○                           |                       |                                    |   | ○                                   | ○                          |                 |                                |               |         |                               |                        | ○                              |                   | 6000<br>2500        |                |  |  |  |  |  |                                |                                |
|  | TICKET CHECK                      | 0                               |             |               | ○           |                      |                              |        |                            |                  |                                   | ○                     | ○                           |                       |                                    |   | ○                                   | ○                          |                 |                                |               |         |                               |                        |                                |                   | -                   |                |  |  |  |  |  |                                |                                |
|  | STATION MASTER'S ROOM             | 0                               |             |               | ○           |                      |                              |        |                            |                  |                                   | ○                     | ○                           |                       |                                    |   |                                     | ○                          |                 |                                |               |         |                               |                        | ○                              |                   | 2500                |                |  |  |  |  |  |                                |                                |
|  | MEETING ROOM                      | 0                               |             |               | ○           |                      |                              |        |                            |                  |                                   | ○                     | ○                           |                       |                                    |   |                                     | ○                          |                 |                                |               |         |                               |                        | ○                              |                   | 2500                |                |  |  |  |  |  |                                |                                |
|  | SECURITY                          | 0                               |             |               | ○           |                      |                              |        |                            |                  |                                   | ○                     | ○                           |                       |                                    |   |                                     | ○                          |                 |                                |               |         |                               |                        | ○                              |                   | 2500                |                |  |  |  |  |  |                                |                                |
|  | STAFF LAVATORY                    | 0                               |             |               | ○           |                      |                              |        |                            |                  |                                   |                       | ○                           |                       |                                    |   |                                     | ○                          |                 |                                |               |         |                               |                        | ○                              |                   | 2500                |                |  |  |  |  |  |                                |                                |
|  | STAFF LOCKER ROOM                 | 0                               |             |               | ○           |                      |                              |        |                            |                  |                                   | ○                     | ○                           |                       |                                    |   |                                     | ○                          |                 |                                |               |         |                               |                        | ○                              |                   | 2500                |                |  |  |  |  |  |                                |                                |
|  | STORAGE                           | 0                               |             |               |             |                      |                              |        |                            |                  |                                   |                       | ○                           |                       |                                    |   |                                     | ○                          |                 |                                |               |         |                               |                        | ○                              |                   | -                   |                |  |  |  |  |  |                                |                                |
|  | POWER ROOM                        | 0                               |             |               |             |                      |                              |        |                            |                  |                                   |                       | ○                           |                       |                                    |   |                                     | ○                          |                 |                                |               |         |                               |                        | ○                              |                   | -                   |                |  |  |  |  |  |                                | CABLE TRENCH W/CHECKERED PLATE |
|  | MECHANICAL ROOM                   | 0                               |             |               |             |                      |                              |        |                            |                  |                                   |                       | ○                           |                       |                                    |   |                                     | ○                          |                 |                                |               |         |                               |                        | ○                              |                   | -                   |                |  |  |  |  |  |                                |                                |
| CORRIDOR                                       | 0                                 |                                 |             |               |             |                      |                              |        |                            |                  |                                   | ○                     |                             |                       |                                    |   | ○                                   |                            |                 |                                |               |         |                               | ○                      |                                | -                 |                     |                |  |  |  |  |  |                                |                                |
| COVERED SERVICE AREA                           | 0                                 |                                 |             | ○             |             |                      |                              |        |                            |                  |                                   | ○                     |                             |                       |                                    |   | ○                                   |                            |                 |                                |               |         |                               | ○                      |                                | -                 |                     |                |  |  |  |  |  |                                |                                |
| STAIRCASE                                      | -                                 |                                 |             | ○             |             |                      |                              |        |                            |                  |                                   | ○                     |                             |                       |                                    |   |                                     |                            |                 |                                |               |         |                               |                        |                                | -                 |                     |                |  |  |  |  |  | W/NON-SLIP                     |                                |
| 2F   | DINING ROOM                       | 3500                            |             | ○             |             |                      |                              |        |                            |                  |                                   | ○                     |                             |                       |                                    |   | ○                                   |                            |                 |                                |               |         |                               | ○                      |                                | 2500              |                     |                |  |  |  |  |  |                                |                                |
|  | KITCHEN                           | 3500                            |             | ○             |             |                      |                              |        |                            |                  |                                   | ○                     |                             |                       |                                    |   | ○                                   |                            |                 |                                |               |         |                               | ○                      |                                | 2500              |                     |                |  |  |  |  |  |                                |                                |
|  | ABLUTION ROOM                     | 3400                            |             | ○             |             |                      |                              |        |                            |                  |                                   | ○                     |                             |                       |                                    |   | ○                                   |                            |                 |                                |               |         |                               | ○                      |                                | 2500              |                     |                |  |  |  |  |  |                                |                                |
|  | MUSHOLLA                          | 3500                            |             | ○             |             |                      |                              |        |                            |                  |                                   | ○                     |                             |                       |                                    |   |                                     | ○                          |                 |                                |               |         |                               | ○                      |                                | 2500              |                     |                |  |  |  |  |  |                                |                                |
|  | REST ROOM                         | 3500                            |             | ○             |             |                      |                              |        |                            |                  |                                   | ○                     |                             |                       |                                    |   |                                     | ○                          |                 |                                |               |         |                               | ○                      |                                | 2500              |                     |                |  |  |  |  |  |                                |                                |
|  | LAVATORY                          | 3400                            |             |               | ○           |                      |                              |        |                            |                  |                                   |                       | ○                           |                       |                                    |   |                                     |                            | ○               |                                |               |         |                               |                        | ○                              |                   | 2500                |                |  |  |  |  |  |                                |                                |
| STAIRCASE                                      | -                                 |                                 |             | ○             |             |                      |                              |        |                            |                  |                                   | ○                     |                             |                       |                                    |   |                                     |                            |                 |                                |               |         |                               |                        | -                              |                   |                     |                |  |  |  |  |  | W/NON-SLIP                     |                                |
| SIGNAL TELECOM DEVICE ROOM AND STORAGE         | SIGNAL TELECOM DEVICE ROOM        | 1000                            |             |               ○                      |                                | 2500              |                     |                |  |  |  |  |  | CABLE TRENCH W/CHECKERED PLATE |                                |
|  | STORAGE                           | 0                               |             |               ○                      |                                | 3500              |                     |                |  |  |  |  |  |                                |                                |
| TRAIN CONTROL OFFICE AND SIGNAL TELECOM OFFICE | TRAIN CONTROL OFFICE              | 8304                            |             |               ○                      |                                | 2500              |                     |                |  |  |  |  |  |                                |                                |
|  | SIGNAL TELECOM OFFICE             | 8304                            |             |               ○                      |                                | 2500              |                     |                |  |  |  |  |  |                                |                                |

REPUBLIC OF INDONESIA  
MINISTRY OF COMMUNICATIONS  
DIRECTORATE GENERAL OF LAND TRANSPORT  
AND INLAND WATERWAYS

NEW RAILWAY LINE FOR CENGKARENG AIRPORT  
CONSTRUCTION PROJECT

JAPAN INTERNATIONAL COOPERATION AGENCY  
(JICA)

|           |            |                    |                    |                    |                    |                    |
|-----------|------------|--------------------|--------------------|--------------------|--------------------|--------------------|
| REVISIONS | DATE       | DESIGNED           | DRAWN              | CHECKED            | REVIEWED           | SUBMITTED          |
| B         | 1 AUG. 89  | <i>[Signature]</i> | <i>[Signature]</i> | <i>[Signature]</i> | <i>[Signature]</i> | <i>[Signature]</i> |
| A         | 15 FEB. 89 | <i>[Signature]</i> | <i>[Signature]</i> | <i>[Signature]</i> | <i>[Signature]</i> | <i>[Signature]</i> |

INTERNAL FINISH SCHEDULE  
( SHEET 2 OF 3 )

PACKAGE: I CIVIL AND ARCHITECTURAL WORK  
SCALE: NONE DRAWING NO: AA - 003

INTERNAL FINISH SCHEDULE - 3

| BUILDING                | ROOM NAME                  | FINISHED FLOOR LEVEL FROM G.L.:0 | FLOOR       |               |             |                      |                              | SKIRTING |                            |                       |                             |                       | WALL                               |   |                                     |                            |                | CEILING                               |               |             |                        |                                | REMARKS    |                                |                                |                |
|-------------------------|----------------------------|----------------------------------|-------------|---------------|-------------|----------------------|------------------------------|----------|----------------------------|-----------------------|-----------------------------|-----------------------|------------------------------------|---|-------------------------------------|----------------------------|----------------|---------------------------------------|---------------|-------------|------------------------|--------------------------------|------------|--------------------------------|--------------------------------|----------------|
|                         |                            |                                  | MARBLE TILE | TERRAZZO TILE | QUARRY TILE | RESILIENT FLOOR TILE | UNGLAZED CERAMIC MOSAIC TILE | CARPET   | MORTAR STEEL TROWEL FINISH | TERRAZZO TILE H:100mm | RESILIENT COVE BASE H:100mm | PAINT ON WOOD H:100mm | MORTAR STEEL TROWEL FINISH H:100mm | MATTE GLAZED COVE BASE CERAMIC TILE H:100mm | PAINT ON MORTAR STEEL TROWEL FINISH | MORTAR STEEL TROWEL FINISH | GYPSUM PLASTER | MATTE GLAZED CERAMIC WALL TILE H:2100 | BRICK MASONRY | MARBLE TILE | MINERAL ACOUSTIC BOARD | PAINT ON ASBESTOS CEMENT BOARD |            | PAINT ON CONCRETE              | FAIR FACED CONCRETE            | CEILING HEIGHT |
|                         |                            | SIGNAL CABIN A          | SIGNAL DEVICE ROOM         | 150                              |             |               |             |                      | ○                            |          |                            |                       |                             |                       |                                    | ○   |                                     |                            |                |                                       |               |             |                        |                                | ○          | —                              | CABLE TRENCH W/CHECKERED PLATE |                |
|                         | POWER ROOM                 | 150                              |             |               |             |                      | ○                            |          |                            |                       |                             |                       |                                    | ○   |                                     |                            |                |                                       |               |             |                        |                                | ○          | —                              | DO                             |                |
|                         | LAVATORY                   | 50                               |             |               |             | ○                    |                              |          |                            |                       |                             |                       | ○                                  |   |                                     |                            |                |                                       |               |             |                        | ○                              | 2500       |                                |                                |                |
|                         | STAIRCASE                  | -                                |             |               |             | ○                    |                              |          |                            |                       |                             |                       | ○                                  |   |                                     |                            |                |                                       |               |             |                        | ○                              | —          | W/NON-SLIP                     |                                |                |
|                         | SIGNAL CONTROL             | 4650                             |             |               |             | ○                    |                              |          |                            |                       |                             |                       | ○                                  |   |                                     |                            |                |                                       |               |             |                        | ○                              | 3800       |                                |                                |                |
|                         | STAFF ROOM                 | 4650                             |             |               |             | ○                    |                              |          |                            |                       |                             |                       | ○                                  |   |                                     |                            |                |                                       |               |             |                        | ○                              | 2500       |                                |                                |                |
|                         | DRESSING ROOM              | 4650                             |             |               |             | ○                    |                              |          |                            |                       |                             |                       | ○                                  |   |                                     |                            |                |                                       |               |             |                        | ○                              | 2500       |                                |                                |                |
|                         | INSPECTORS' ROOM           | 4650                             |             |               |             | ○                    |                              |          |                            |                       |                             |                       | ○                                  |   |                                     |                            |                |                                       |               |             |                        | ○                              | 3800       |                                |                                |                |
|                         | STAIRCASE                  | -                                |             |               |             | ○                    |                              |          |                            |                       |                             |                       | ○                                  |   |                                     |                            |                |                                       |               |             |                        | ○                              | —          | W/NON-SLIP                     |                                |                |
|                         |                            | SIGNAL CABIN B          | RELAY EQUIPMENT ROOM       | 150                              |             |               |             |                      | ○                            |          |                            |                       |                             |                       | ○                                  |   |                                     |                            |                |                                       |               |             |                        | ○                              | —          | CABLE TRENCH W/CHECKERED PLATE |                                |                |
|                         | LAVATORY                   | 50                               |             |               |             | ○                    |                              |          |                            |                       |                             |                       | ○                                  |   |                                     |                            |                |                                       |               |             |                        | ○                              | 2500       |                                |                                |                |
|                         | WAREHOUSE                  | 150                              |             |               |             |                      | ○                            |          |                            |                       |                             |                       | ○                                  |   |                                     |                            |                |                                       |               |             |                        | ○                              | —          |                                |                                |                |
|                         | STAIRCASE                  | -                                |             |               |             | ○                    |                              |          |                            |                       |                             |                       | ○                                  |   |                                     |                            |                |                                       |               |             |                        | ○                              | —          | W/NON-SLIP                     |                                |                |
|                         | SIGNAL HANDLING STAFF ROOM | 4650                             |             |               |             | ○                    |                              |          |                            |                       |                             |                       | ○                                  |   |                                     |                            |                |                                       |               |             |                        | ○                              | 2500       |                                |                                |                |
|                         | STAFF ROOM                 | 4650                             |             |               |             | ○                    |                              |          |                            |                       |                             |                       | ○                                  |   |                                     |                            |                |                                       |               |             |                        | ○                              | 2500       |                                |                                |                |
| STAIRCASE               | -                          |                                  |             |               | ○           |                      |                              |          |                            |                       |                             | ○                     |                                    |   |                                     |                            |                |                                       |               |             | ○                      | —                              | W/NON-SLIP |                                |                                |                |
| CROSSING WATCHMAN'S BOX | WATCHING ROOM              | 150                              |             |               |             |                      | ○                            |          |                            |                       |                             |                       | ○                                  |   |                                     |                            |                |                                       |               |             |                        | ○                              | 2150       |                                |                                |                |
|                         |                            
REPUBLIC OF INDONESIA  
 MINISTRY OF COMMUNICATIONS  
 DIRECTORATE GENERAL OF LAND TRANSPORT AND INLAND WATERWAYS


NEW RAILWAY LINE FOR CENGKARENG AIRPORT CONSTRUCTION PROJECT

JAPAN INTERNATIONAL COOPERATION AGENCY (JICA)

|           |           |             |             |             |             |             |
|-----------|-----------|-------------|-------------|-------------|-------------|-------------|
| REVISIONS | DATE      | DESIGNED    | DRAWN       | CHECKED     | REVIEWED    | SUBMITTED   |
| B         | 1.19.88   | [Signature] | [Signature] | [Signature] | [Signature] | [Signature] |
| A         | 15.FEB.89 | [Signature] | [Signature] | [Signature] | [Signature] | [Signature] |

INTERNAL FINISH SCHEDULE  
 ( SHEET 3 OF 3 )

PACKAGE: I CIVIL AND ARCHITECTURAL WORK  
 SCALE: NONE DRAWING NO: AA - 004

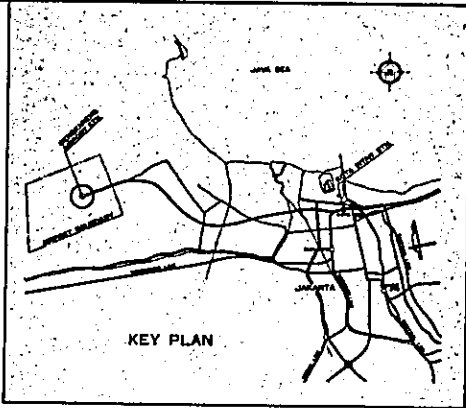

ROAD C2

GREEN ZONE

BUS PARKING LOT

TERMINAL BUILDING

BOOKING OFFICE (B)

PLATFORM

PLATFORM

BOOKING OFFICE (A)

SIGNAL CABIN A

DUMP YARD

GREEN ZONE

GREEN ZONE

GREEN ZONE

ROAD C1

125.5m

LEGEND (OUTDOOR FURNITURE)

GREEN ZONE

- BENCH TYPE A (WOODEN) 16 sets
- SMOKING STAND TYPE A 10 sets
- WASTEBASKET TYPE A 10 sets

PLATFORM

- BENCH TYPE B (FRP) 32 sets
- SMOKING STAND TYPE B 16 sets
- WASTEBASKET TYPE B 12 sets

SITE PLAN  
SCALE 1:500

REPUBLIC OF INDONESIA  
MINISTRY OF COMMUNICATIONS  
DIRECTORATE GENERAL OF LAND TRANSPORT AND INLAND WATERWAYS

NEW RAILWAY LINE FOR CENGKARENG AIRPORT CONSTRUCTION PROJECT

JAPAN INTERNATIONAL COOPERATION AGENCY (JICA)

|   |            |        |         |        |     |     |
|---|------------|--------|---------|--------|-----|-----|
| B | 1 AUG '84  | Sujudi | Sudhono | L.H    | K.M | m.c |
| A | 15 FEB '84 | Sujudi | Sudhono | Sujudi | K.M | A.K |



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|-----------|------|----------|-------|---------|----------|-----------|
| REVISIONS | DATE | DESIGNED | DRAWN | CHECKED | REVIEWED | SUBMITTED |
|-----------|------|----------|-------|---------|----------|-----------|

AIRPORT TERMINAL STATION  
SITE PLAN

PACKAGE: I CIVIL AND ARCHITECTURAL WORK



SCALE: 1:500 DRAWING NO: AA - 005



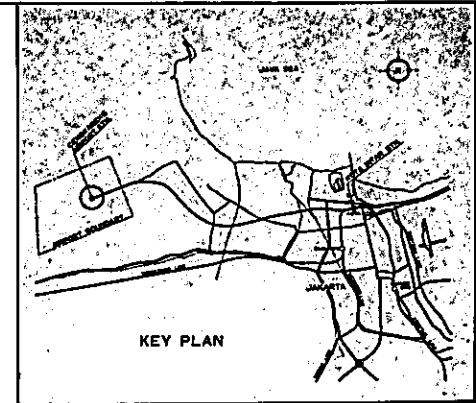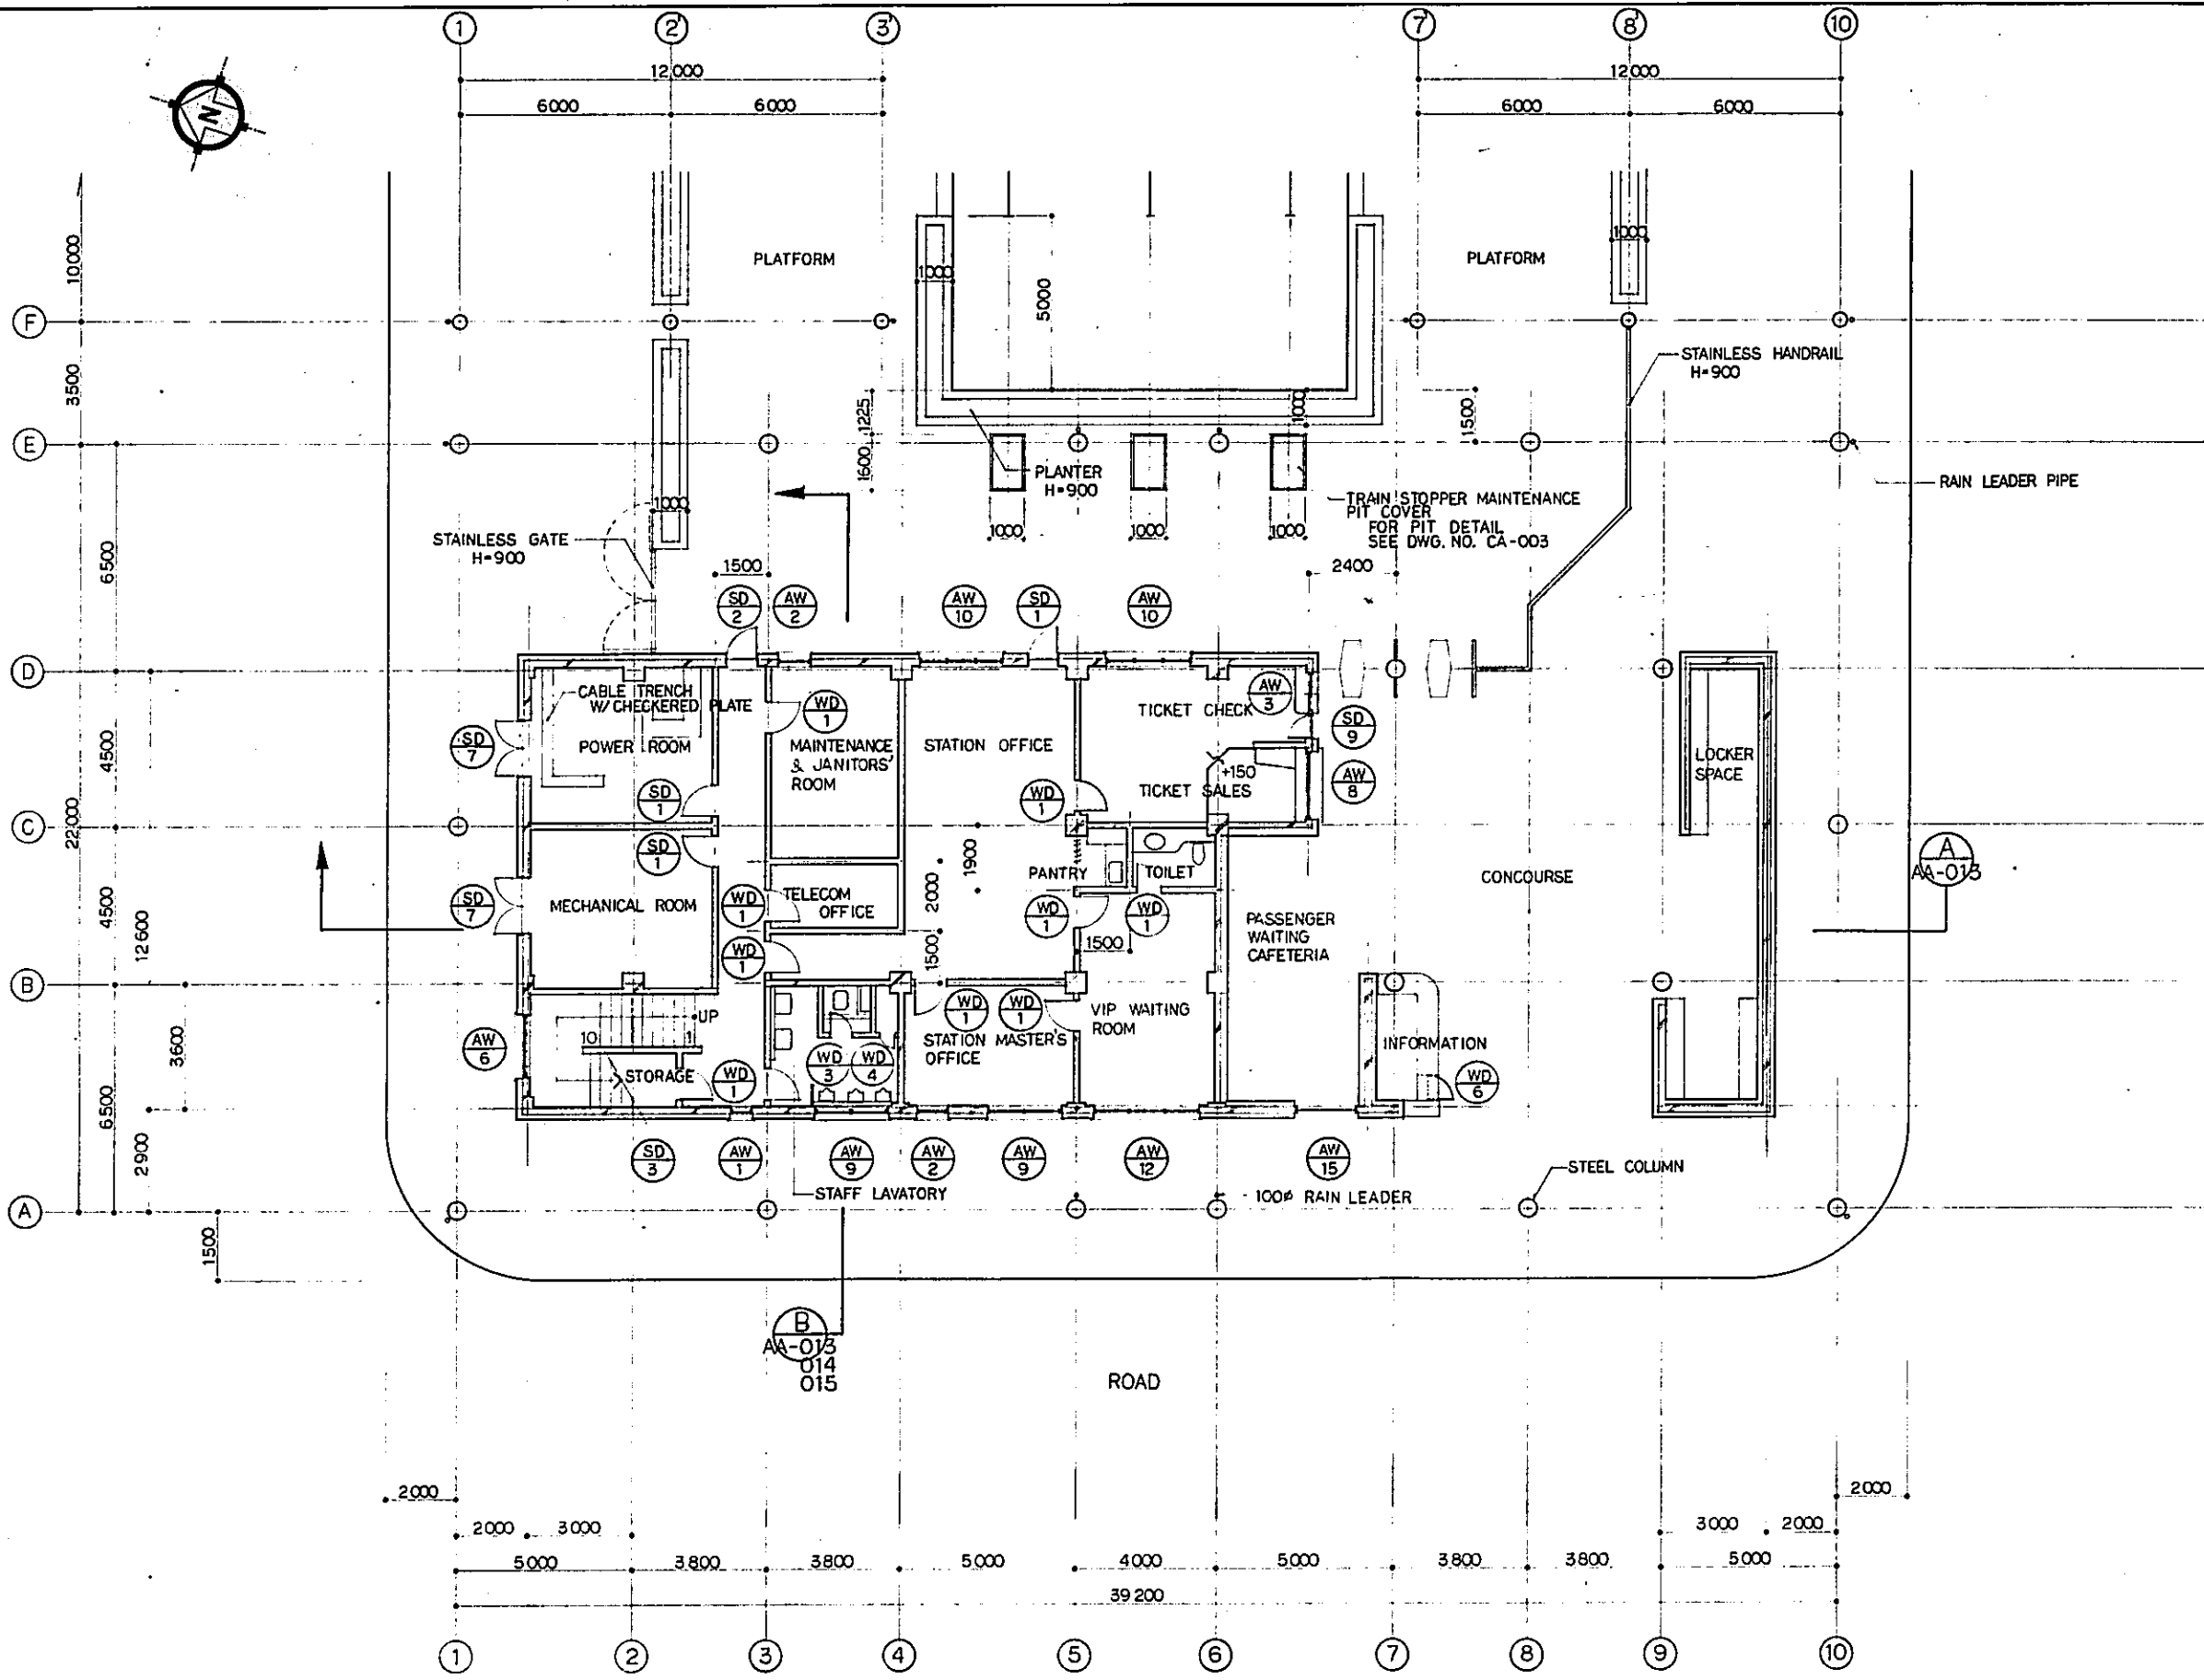

1st FLOOR PLAN  
SCALE 1:100

|  |           |                      |       |         |          |           |
|--|-----------|----------------------|-------|---------|----------|-----------|
| REPUBLIC OF INDONESIA<br>MINISTRY OF COMMUNICATIONS<br>DIRECTORATE GENERAL OF LAND TRANSPORT<br>AND INLAND WATERWAYS |           |                      |       |         |          |           |
| NEW RAILWAY LINE FOR CENGKARENG AIRPORT<br>CONSTRUCTION PROJECT  |           |                      |       |         |          |           |
| JAPAN INTERNATIONAL COOPERATION AGENCY<br>(JICA)   |           |                      |       |         |          |           |
| B  | 1 AUG. 87 | DESIGNED             | BY    | SAKUMI  | REVIEWED | SAKUMI    |
| A  | K.F.B.    | DESIGNED             | BY    | SAKUMI  | REVIEWED | SAKUMI    |
| REVISIONS  | DATE      | DESIGNED             | DRAWN | CHECKED | REVIEWED | SUBMITTED |
| AIRPORT TERMINAL STATION<br>TERMINAL BLDG.<br>1F PLAN  |           |                      |       |         |          |           |
| PACKAGE: I CIVIL AND ARCHITECTURAL WORK  |           |                      |       |         |          |           |
| SCALE: 1:100   |           | DRAWING NO: AA - 006 |       |         |          |           |

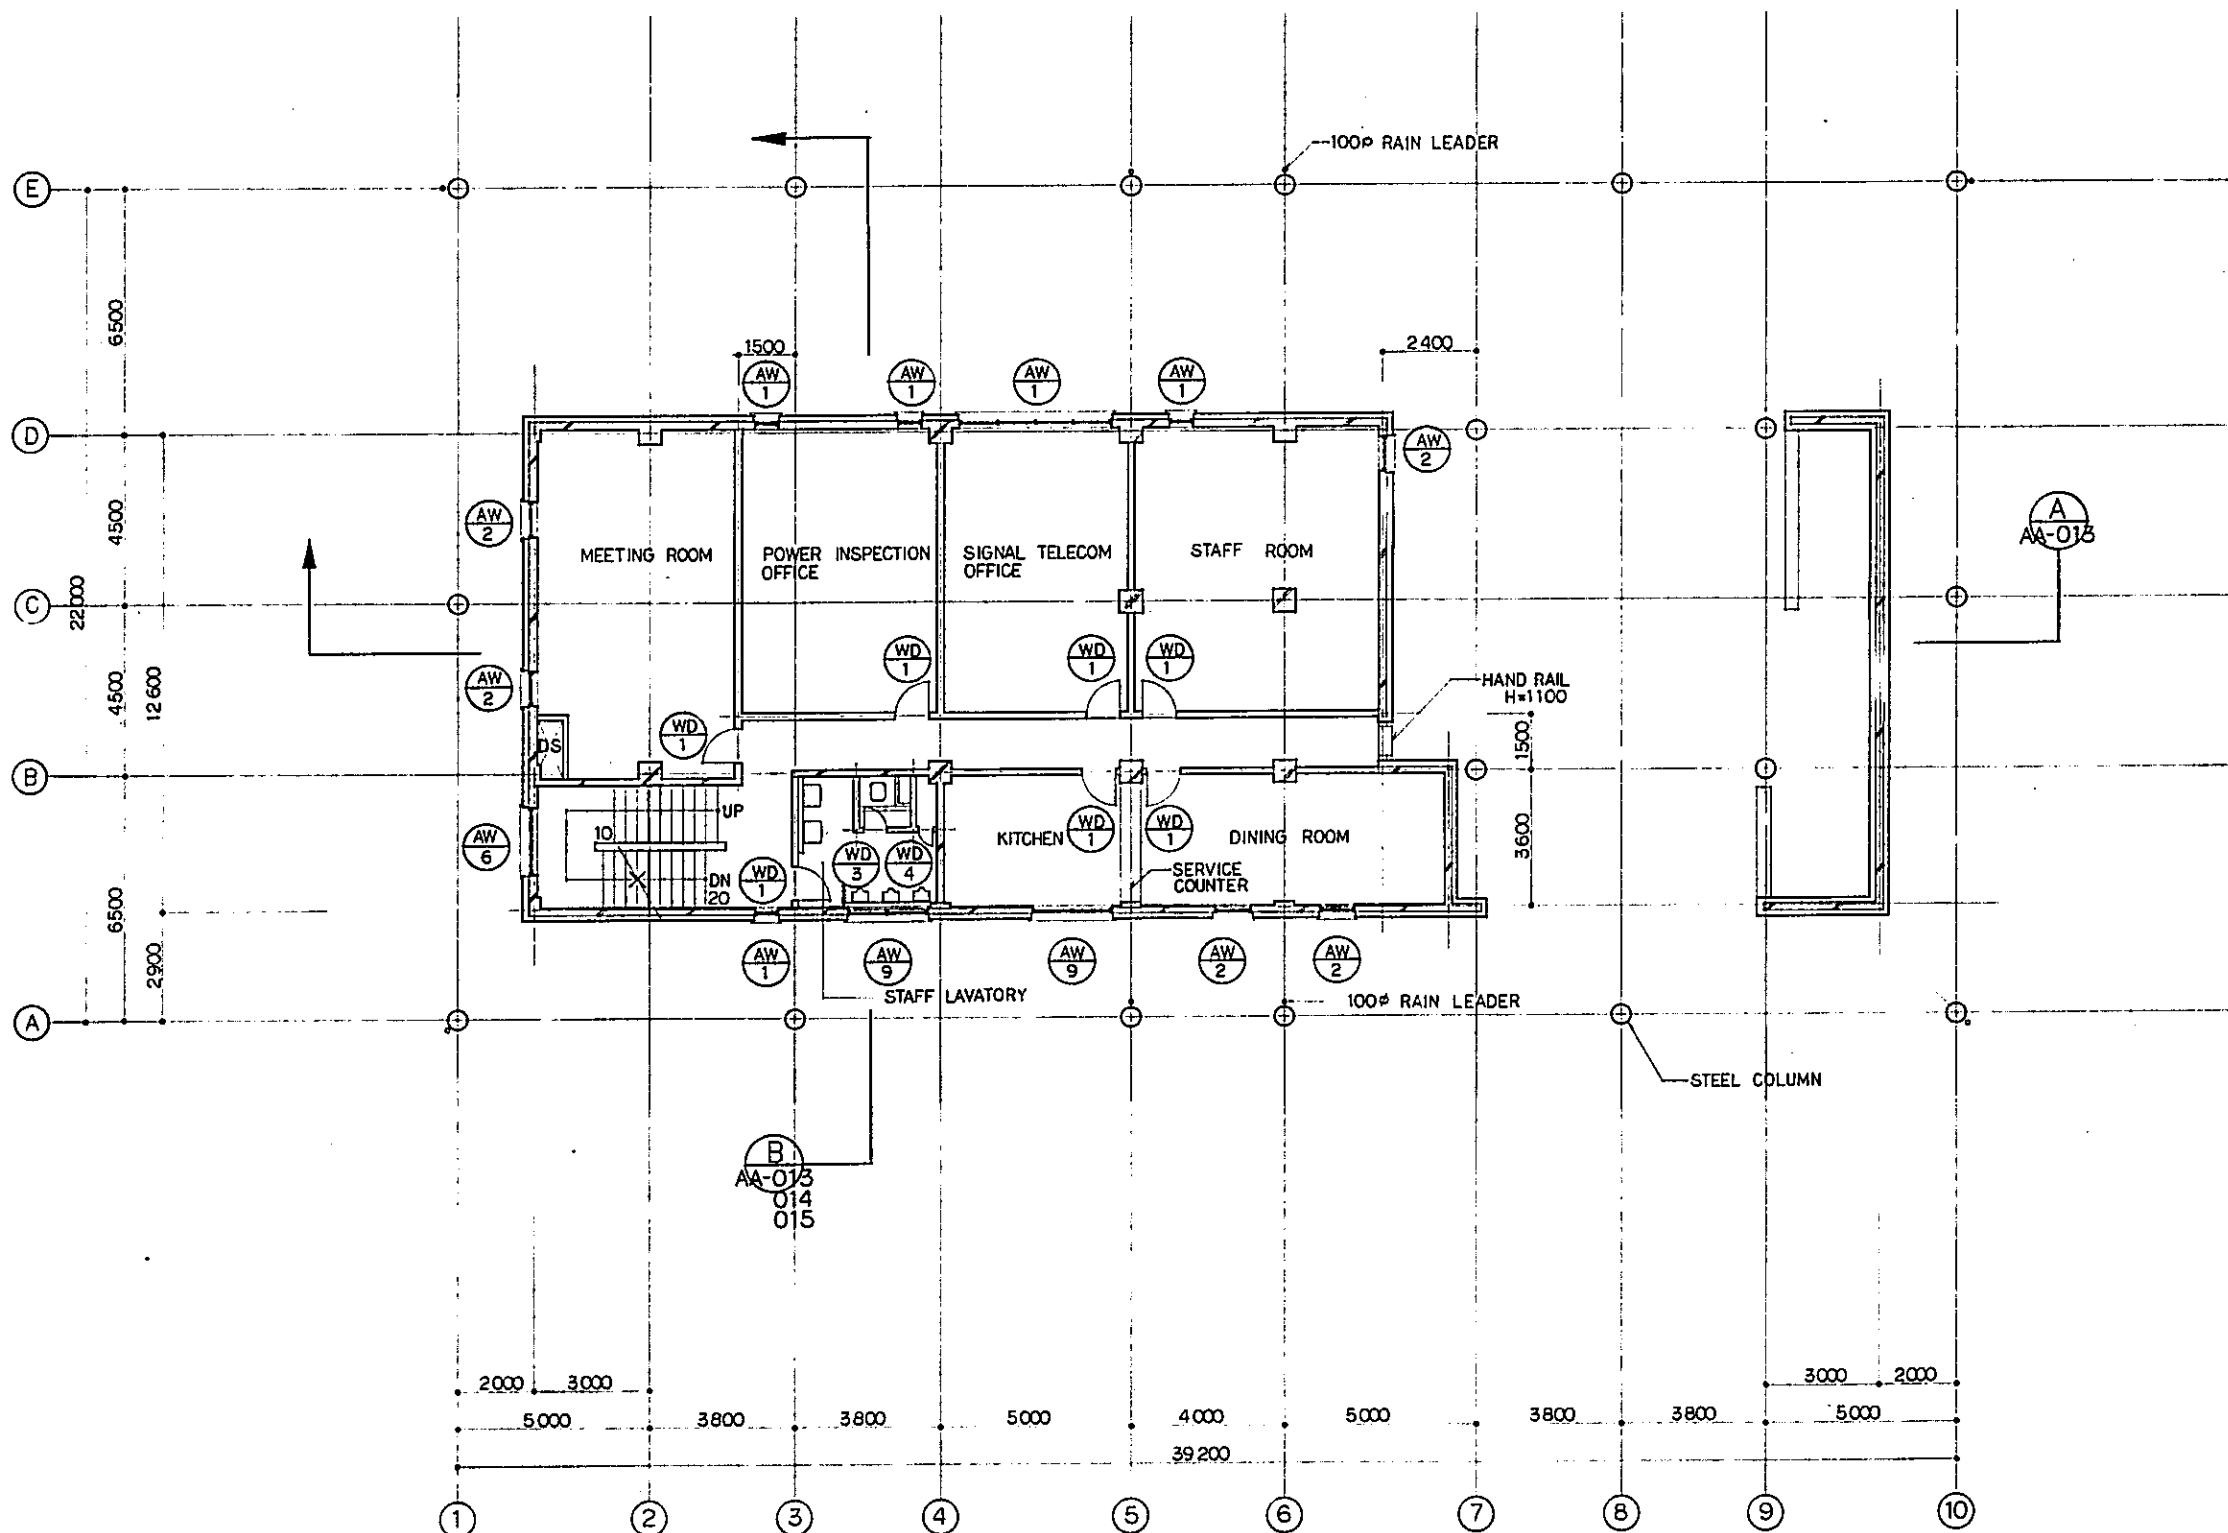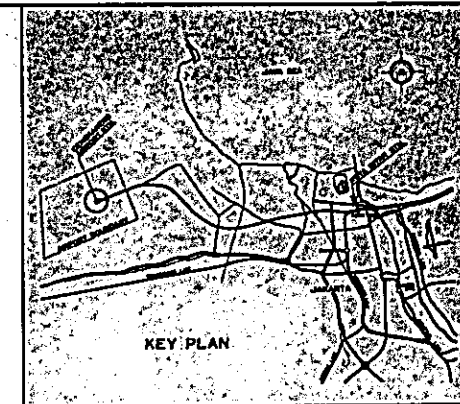

2nd FLOOR PLAN  
SCALE 1:100

REPUBLIC OF INDONESIA  
MINISTRY OF COMMUNICATIONS  
DIRECTORATE GENERAL OF LAND TRANSPORT  
AND INLAND WATERWAYS



NEW RAILWAY LINE FOR CENGKARENG AIRPORT  
CONSTRUCTION PROJECT

JAPAN INTERNATIONAL COOPERATION AGENCY  
(JICA)


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|-----------|-----------|----------|-------|---------|----------|-----------|
| B         | 1 AUG 87  | SK       | SK    | SK      | K.M.     | K.K.      |
| A         | 15 FEB 87 | SK       | SK    | SK      | K.M.     | K.K.      |
| REVISIONS | DATE      | DESIGNED | DRAWN | CHECKED | REVIEWED | SUBMITTED |

AIRPORT TERMINAL STATION  
TERMINAL BLDG.  
2F PLAN

PACKAGE: I CIVIL AND ARCHITECTURAL WORK  
SCALE: 1:100 DRAWING NO.: AA-007

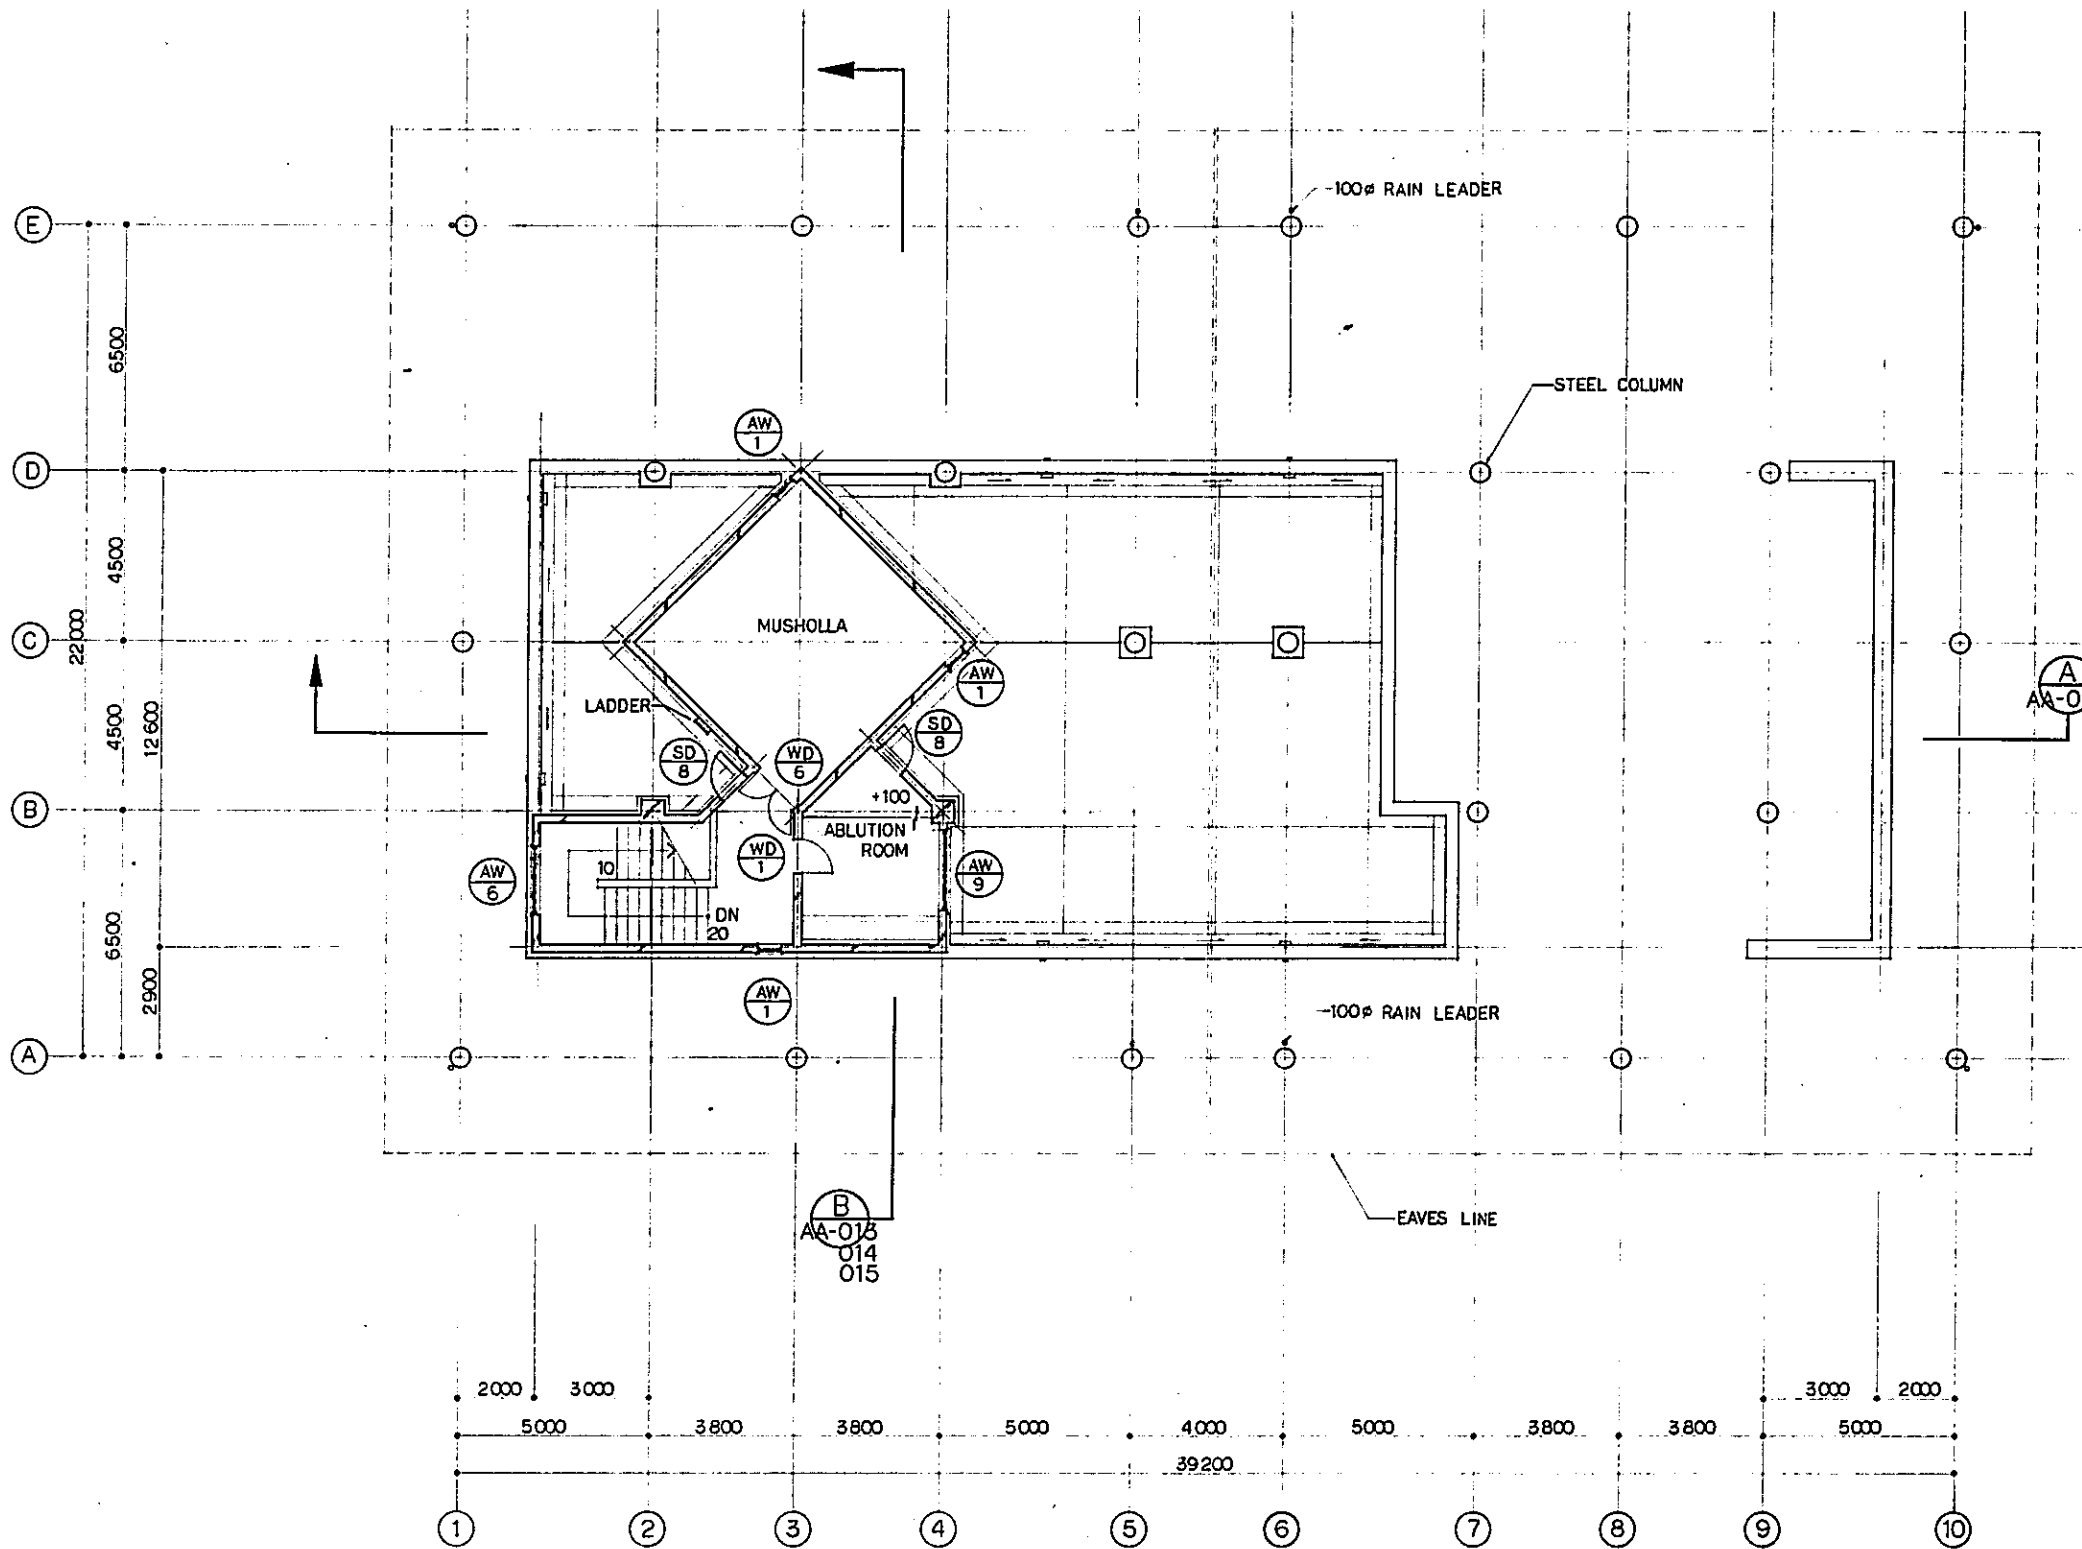
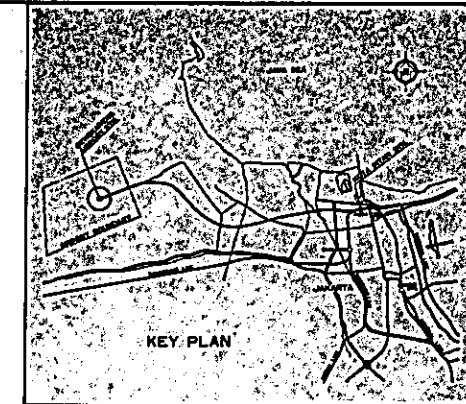


3rd FLOOR PLAN  
SCALE 1:100

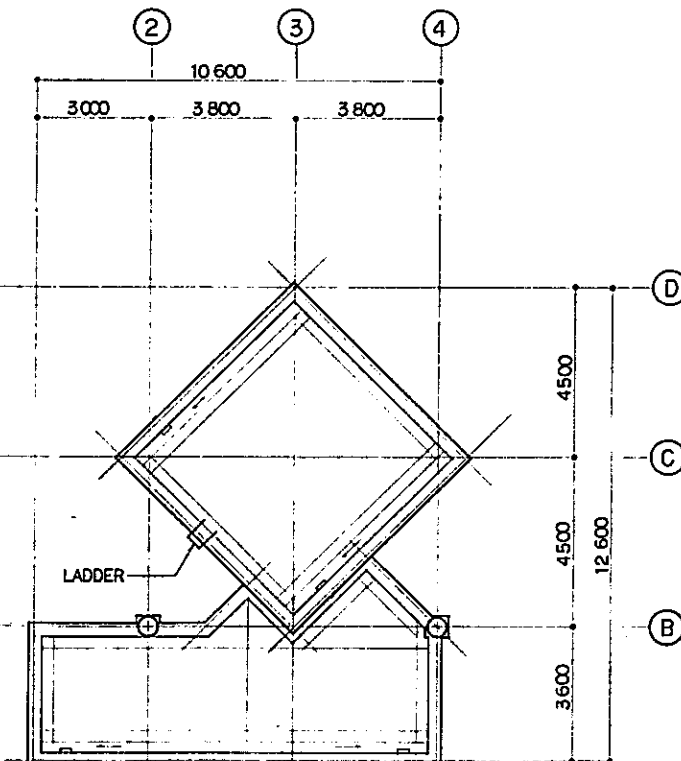


ROOF PLAN  
SCALE 1:100

|   |             |          |       |                   |           |
|---|-------------|----------|-------|-------------------|-----------|
| REPUBLIC OF INDONESIA.<br>MINISTRY OF COMMUNICATIONS<br>DIRECTORATE GENERAL OF LAND TRANSPORT<br>AND INLAND WATERWAYS |             |          |       |                   |           |
| NEW RAILWAY LINE FOR CENGKARENG AIRPORT<br>CONSTRUCTION PROJECT   |             |          |       |                   |           |
| JAPAN INTERNATIONAL COOPERATION AGENCY<br>(JICA)  |             |          |       |                   |           |
| B   | 1 AUG 88    | DESIGNED | BY    | S. S. K. M. A. K. |           |
| A   | 15 FEB 88   | DESIGNED | BY    | S. S. K. M. A. K. |           |
| REVISIONS   | DATE        | DESIGNED | DRAWN | CHECKED           | SUBMITTED |
| AIRPORT TERMINAL STATION<br>TERMINAL BLDG.<br>3F PLAN AND ROOF PLAN   |             |          |       |                   |           |
| PACKAGE: I CIVIL AND ARCHITECTURAL WORK   |             |          |       |                   |           |
| SCALE   | DRAWING NO. |          |       |                   |           |
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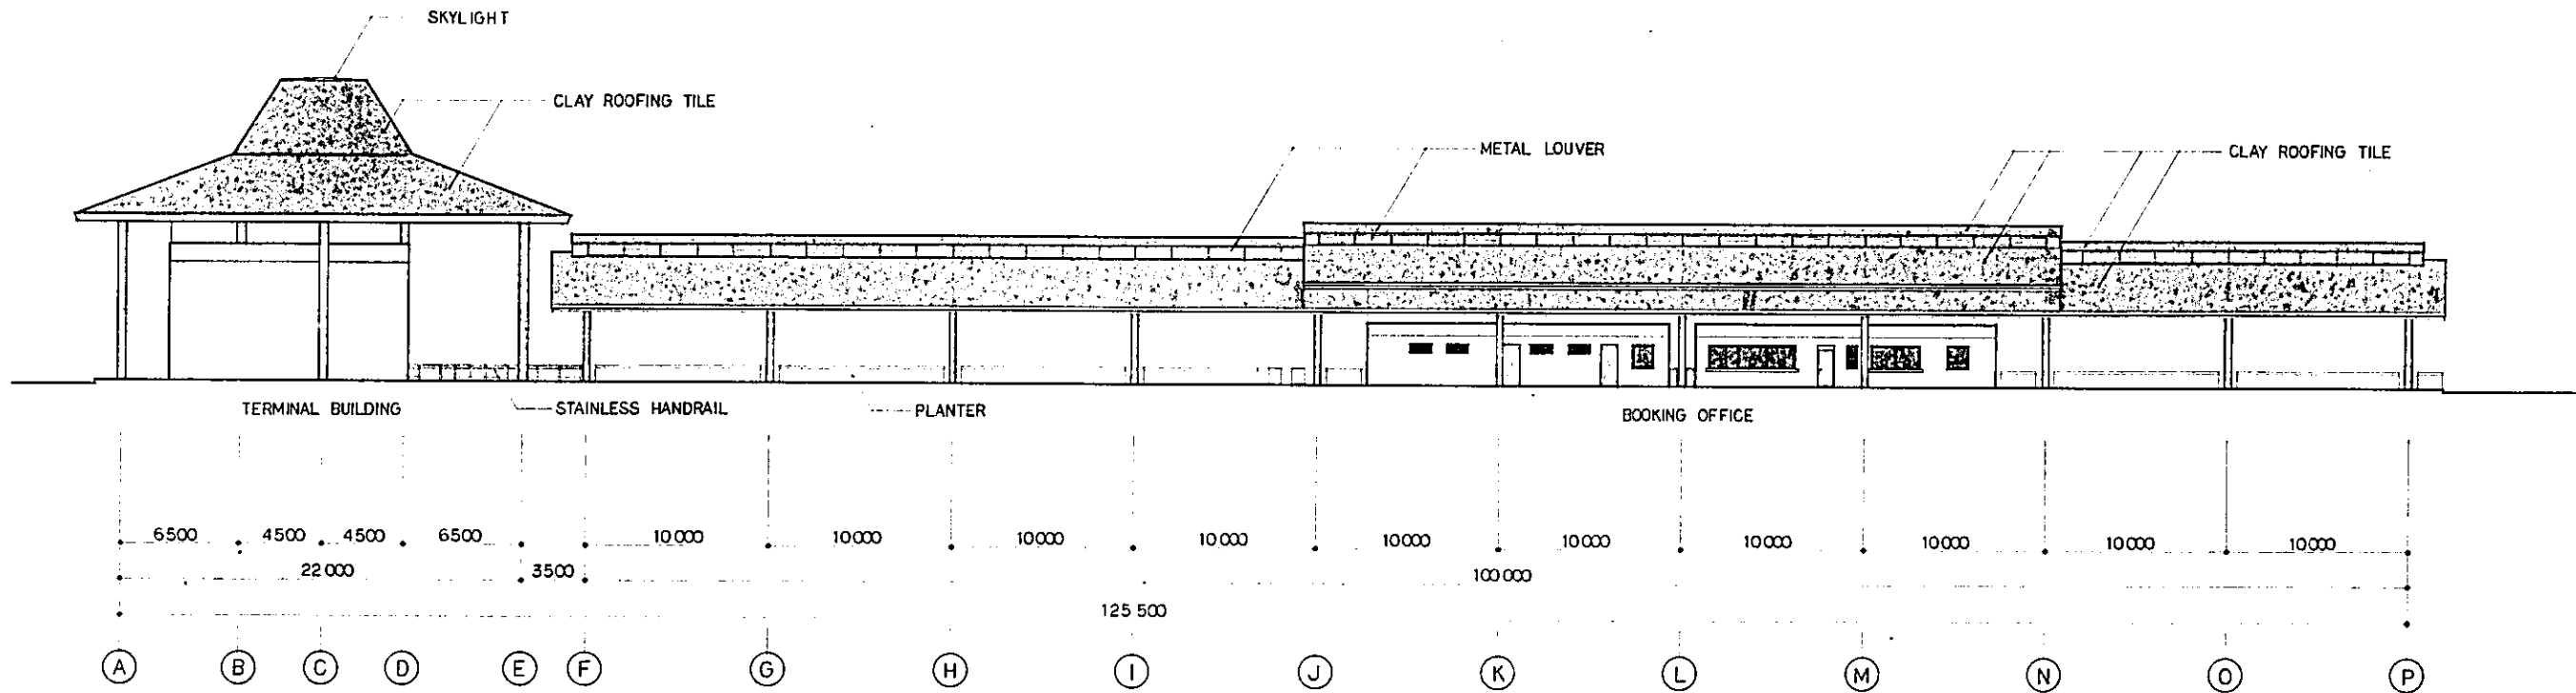


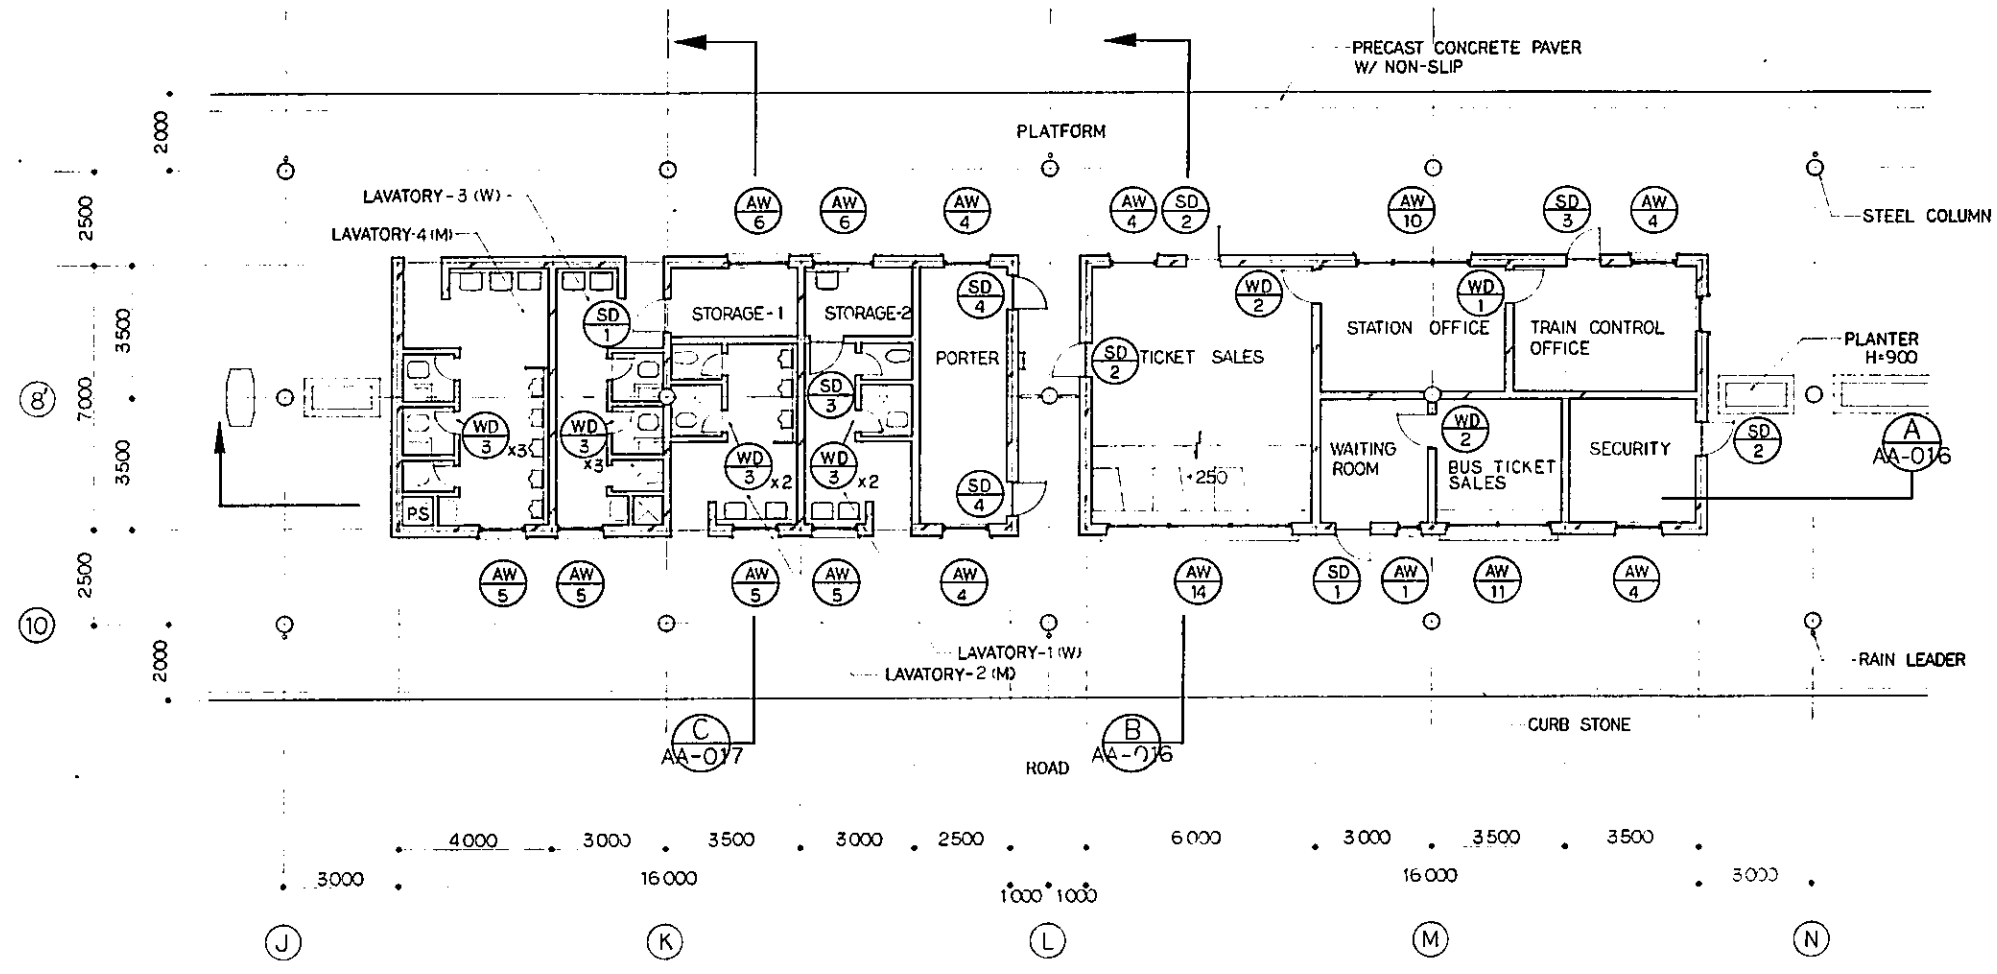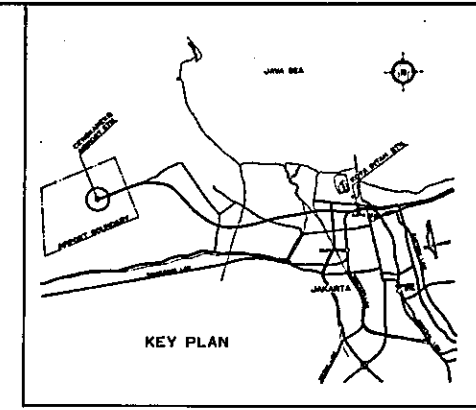FLOOR PLAN  
SCALE 1:100

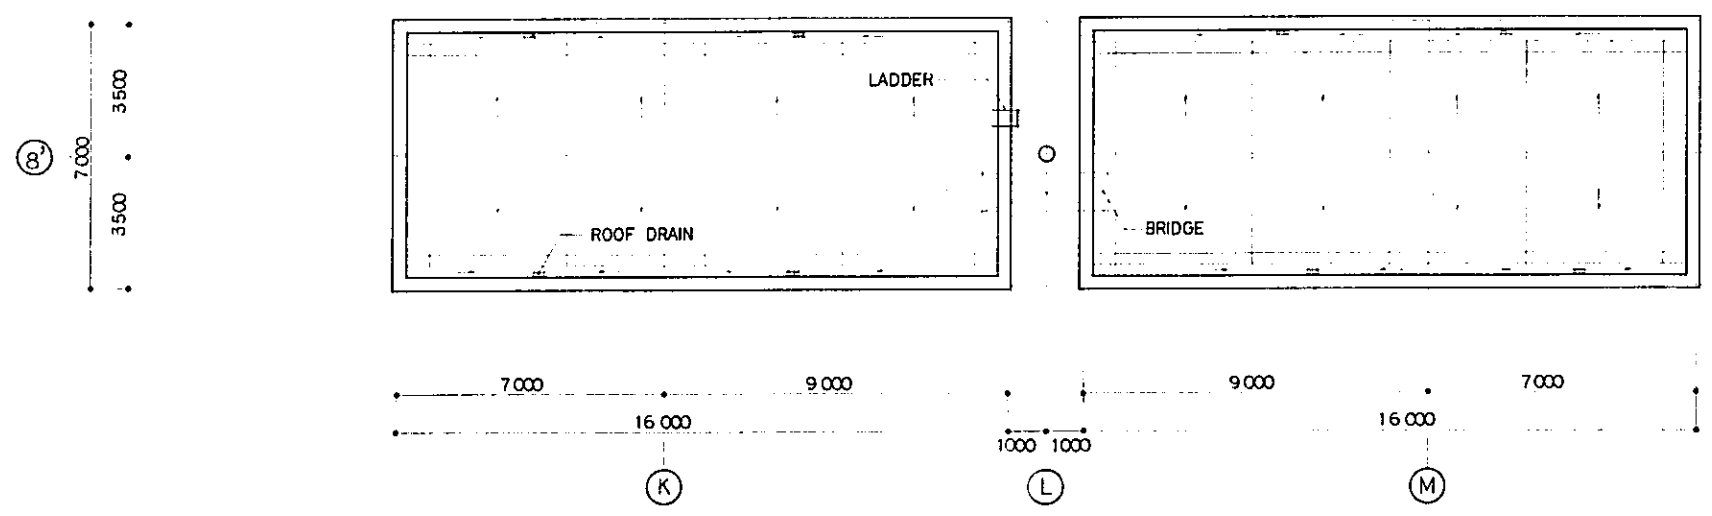


ROOF PLAN  
SCALE 1:100

|  |            |          |                      |             |          |
|--|------------|----------|----------------------|-------------|----------|
| REPUBLIC OF INDONESIA<br>MINISTRY OF COMMUNICATIONS<br>DIRECTORATE GENERAL OF LAND TRANSPORT<br>AND INLAND WATERWAYS |            |          |                      |             |          |
| NEW RAILWAY LINE FOR CENGKARENG AIRPORT<br>CONSTRUCTION PROJECT  |            |          |                      |             |          |
| JAPAN INTERNATIONAL COOPERATION AGENCY<br>(JICA)   |            |          |                      |             |          |
| B  | 1 AUG. 88  | DESIGNED | BY                   | SAITOH K.M. | AK       |
| A  | 15 FEB. 88 | DESIGNED | BY                   | SAITOH K.M. | AK       |
| REVISIONS  | DATE       | DESIGNED | DRAWN                | CHECKED     | REVIEWED |
| AIRPORT TERMINAL STATION<br>BOOKING OFFICE<br>FLOOR PLAN AND ROOF PLAN   |            |          |                      |             |          |
| PACKAGE: I CIVIL AND ARCHITECTURAL WORK  |            |          |                      |             |          |
| SCALE: 1:100   |            |          | DRAWING NO: AA - 009 |             |          |




**SOUTH ELEVATION**  
SCALE 1:200

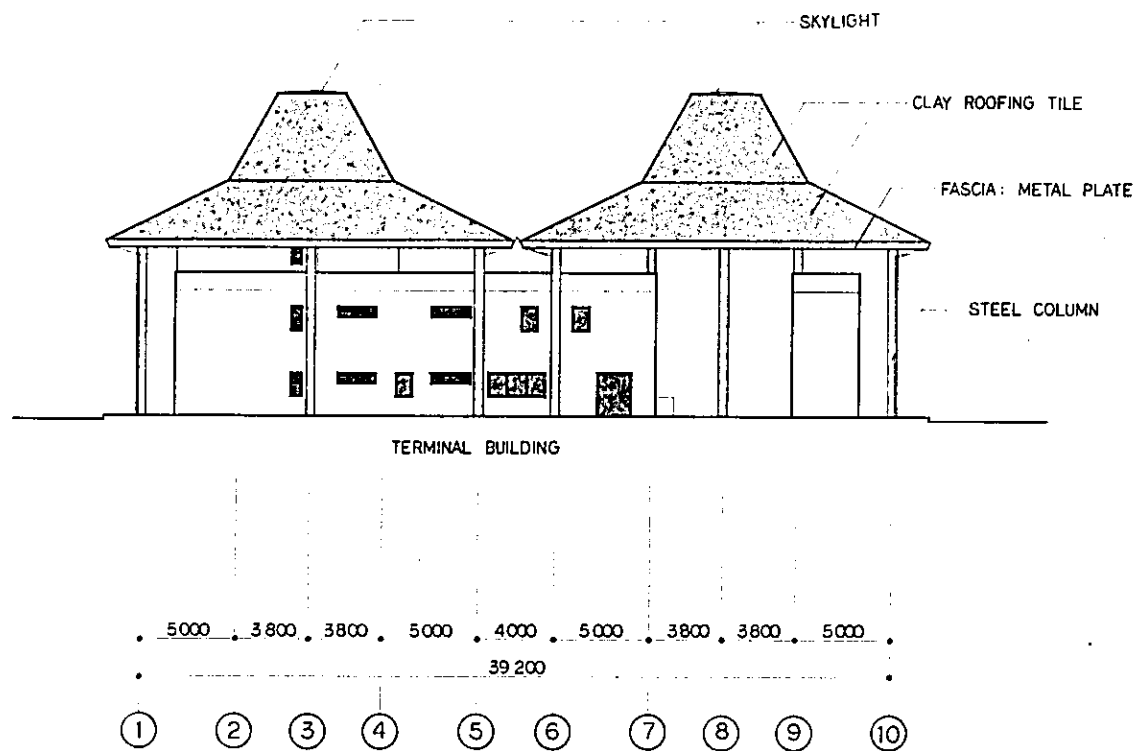

**WEST ELEVATION**  
SCALE 1:200

|  |           |          |                      |          |          |
|--|-----------|----------|----------------------|----------|----------|
| REPUBLIC OF INDONESIA<br>MINISTRY OF COMMUNICATIONS<br>DIRECTORATE GENERAL OF LAND TRANSPORT<br>AND INLAND WATERWAYS |           |          |                      |          |          |
| NEW RAILWAY LINE FOR CENGKARENG AIRPORT<br>CONSTRUCTION PROJECT  |           |          |                      |          |          |
| JAPAN INTERNATIONAL COOPERATION AGENCY<br>(JICA)   |           |          |                      |          |          |
| B  | 1 AUG 89  | DESIGNED | BY                   | REVIEWED | BY       |
| A  | 15 FEB 89 | DESIGNED | BY                   | REVIEWED | BY       |
| REVISIONS  | DATE      | DESIGNED | DRAWN                | CHECKED  | REVIEWED |
| AIRPORT TERMINAL STATION<br>ELEVATIONS   |           |          |                      |          |          |
| PACKAGE: I CIVIL AND ARCHITECTURAL WORK  |           |          |                      |          |          |
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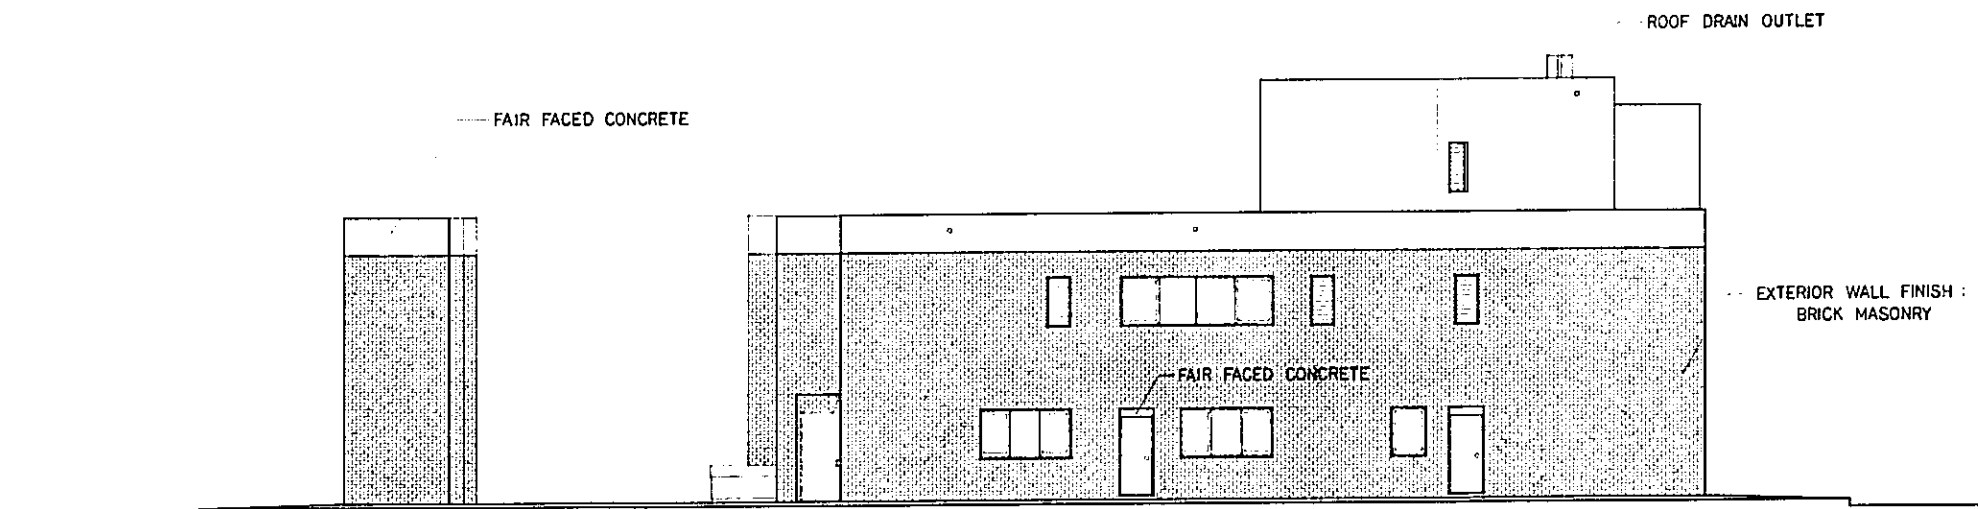


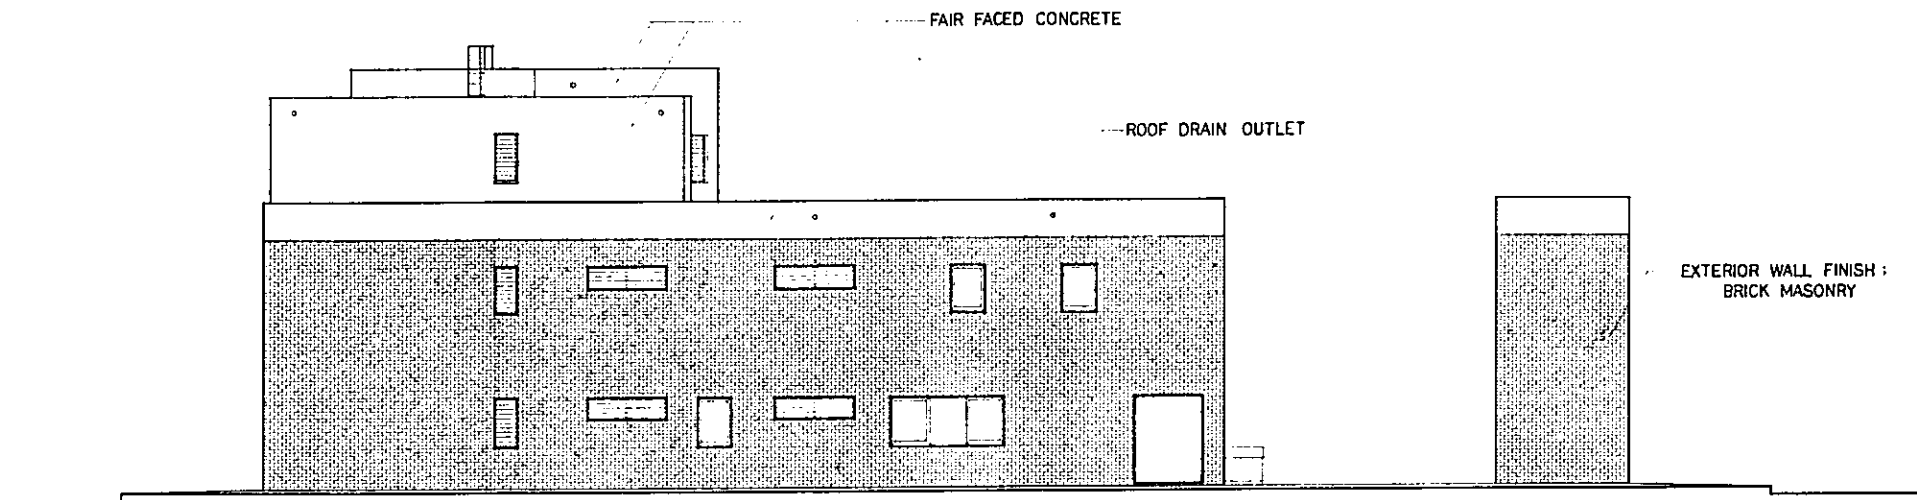WEST ELEVATION  
SCALE 1:100




NORTH ELEVATION  
SCALE 1:100

⑦ LINE ELEVATION  
SCALE 1:100




EAST ELEVATION  
SCALE 1:100


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|--|---------|----------------------|-------|---------|----------|-----------|
| REPUBLIC OF INDONESIA<br>MINISTRY OF COMMUNICATIONS<br>DIRECTORATE GENERAL OF LAND TRANSPORT<br>AND INLAND WATERWAYS |         |                      |       |         |          |           |
| NEW RAILWAY LINE FOR CENGKARENG AIRPORT<br>CONSTRUCTION PROJECT  |         |                      |       |         |          |           |
| JAPAN INTERNATIONAL COOPERATION AGENCY<br>(JICA)   |         |                      |       |         |          |           |
| B  | 1006.89 | S.G.                 | RT    | P.      | G.K.M.   | M.K.      |
| A  | 1577.89 | Kyuh                 | RT    | P.      | G.K.M.   | M.K.      |
| REVISIONS  | DATE    | DESIGNED             | DRAWN | CHECKED | REVIEWED | SUBMITTED |
| AIRPORT TERMINAL STATION<br>TERMINAL BLDG.<br>ELEVATIONS   |         |                      |       |         |          |           |
| PACKAGE: 1 CIVIL AND ARCHITECTURAL WORK  |         |                      |       |         |          |           |
| SCALE 1:100  |         | DRAWING NO: AA - 011 |       |         |          |           |

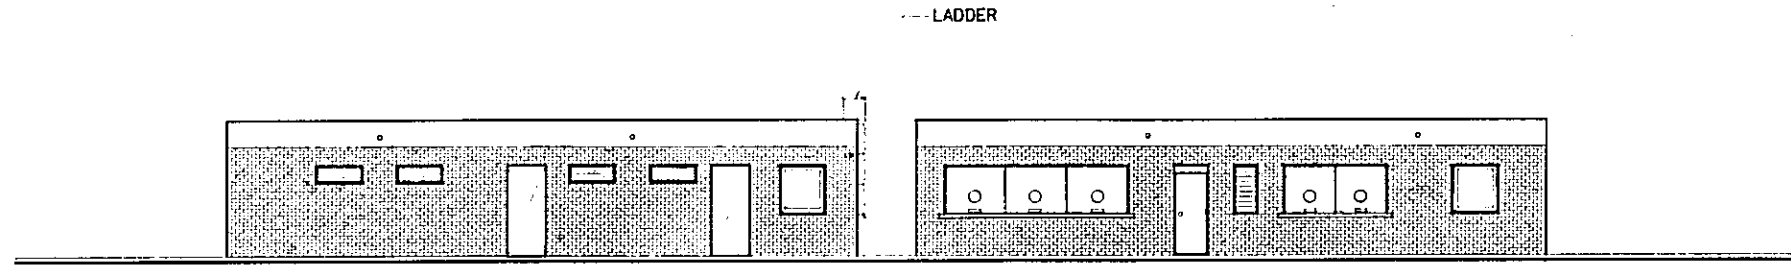

FRONT ELEVATION  
SCALE 1:100

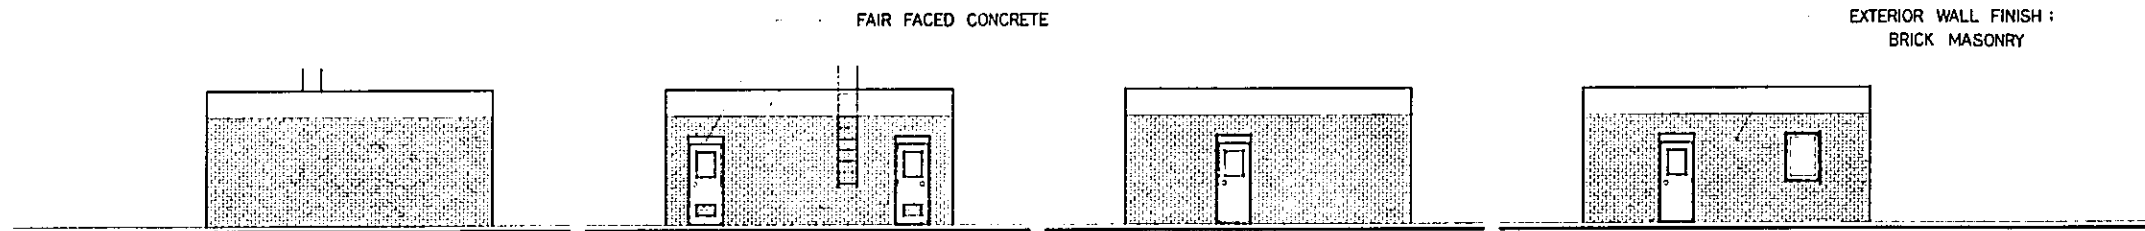


SIDE ELEVATIONS  
SCALE 1:100

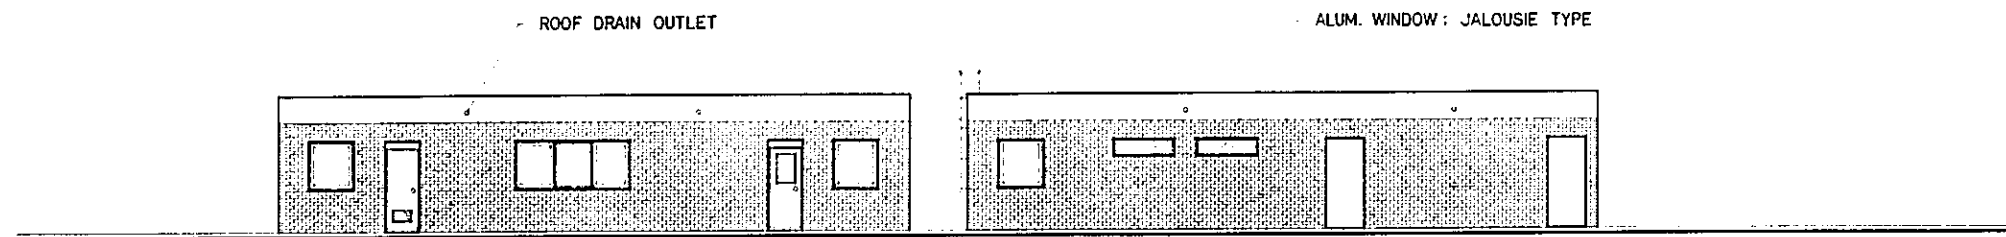


PLATFORM SIDE ELEVATION  
SCALE 1:100

|  |            |                      |       |             |          |           |
|--|------------|----------------------|-------|-------------|----------|-----------|
| REPUBLIC OF INDONESIA<br>MINISTRY OF COMMUNICATIONS<br>DIRECTORATE GENERAL OF LAND TRANSPORT<br>AND INLAND WATERWAYS |            |                      |       |             |          |           |
| NEW RAILWAY LINE FOR CENGKARENG AIRPORT<br>CONSTRUCTION PROJECT  |            |                      |       |             |          |           |
| JAPAN INTERNATIONAL COOPERATION AGENCY<br>(JICA)   |            |                      |       |             |          |           |
| B  | 1 AUG. 88  | REVISION             | BY    | F. S. K. M. | CHK      |           |
| A  | 15 FEB. 87 | REVISION             | BY    | F. S. K. M. | CHK      |           |
| REVISIONS  | DATE       | DESIGNED             | DRAWN | CHECKED     | REVIEWED | SUBMITTED |
| AIRPORT TERMINAL STATION<br>BOOKING OFFICE<br>ELEVATIONS   |            |                      |       |             |          |           |
| PACKAGE: I CIVIL AND ARCHITECTURAL WORK  |            |                      |       |             |          |           |
| SCALE 1:100  |            | DRAWING NO. AA - 012 |       |             |          |           |

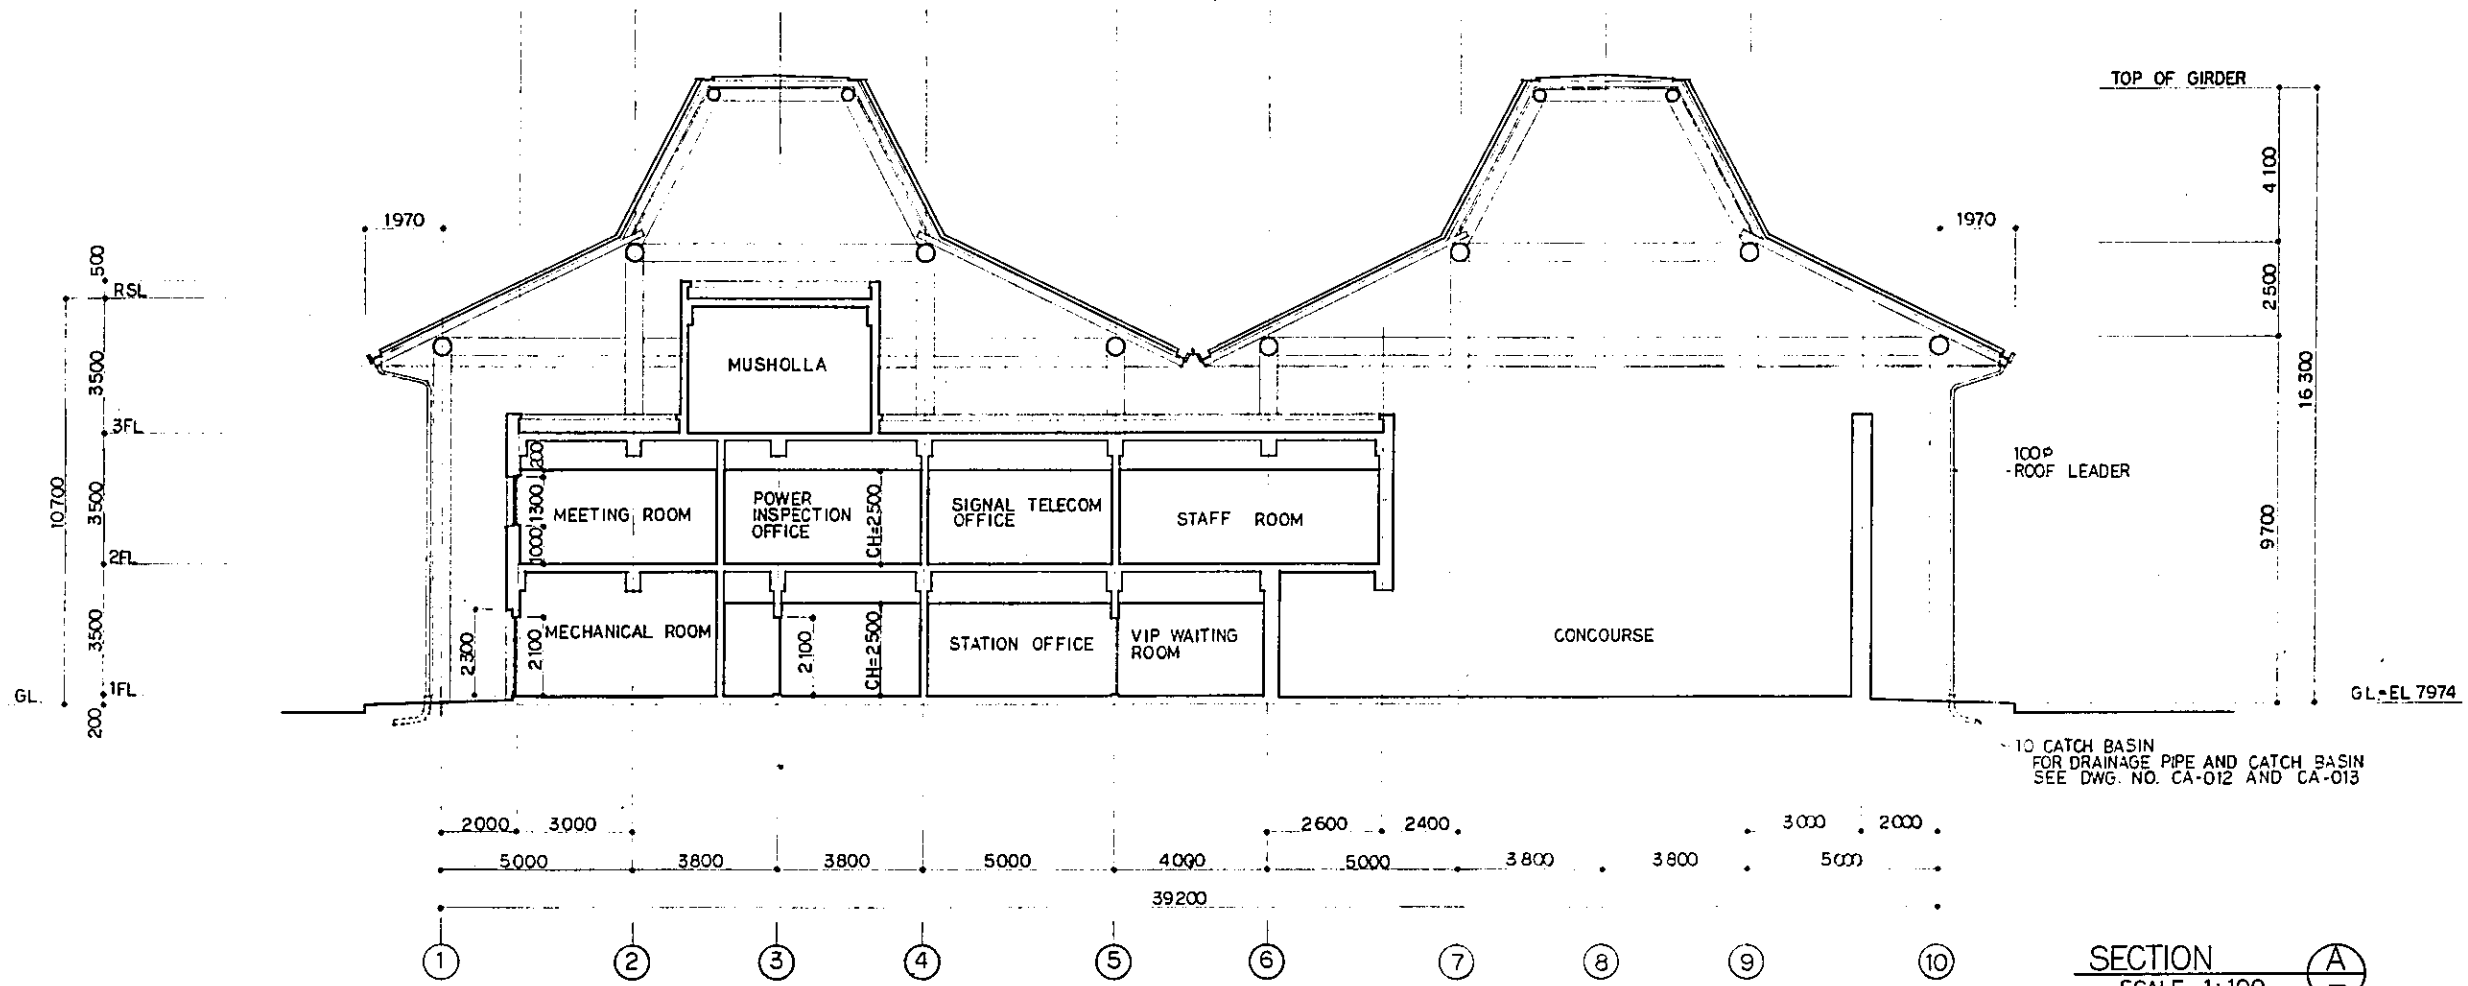


10 CATCH BASIN FOR DRAINAGE PIPE AND CATCH BASIN SEE DWG. NO. CA-012 AND CA-013

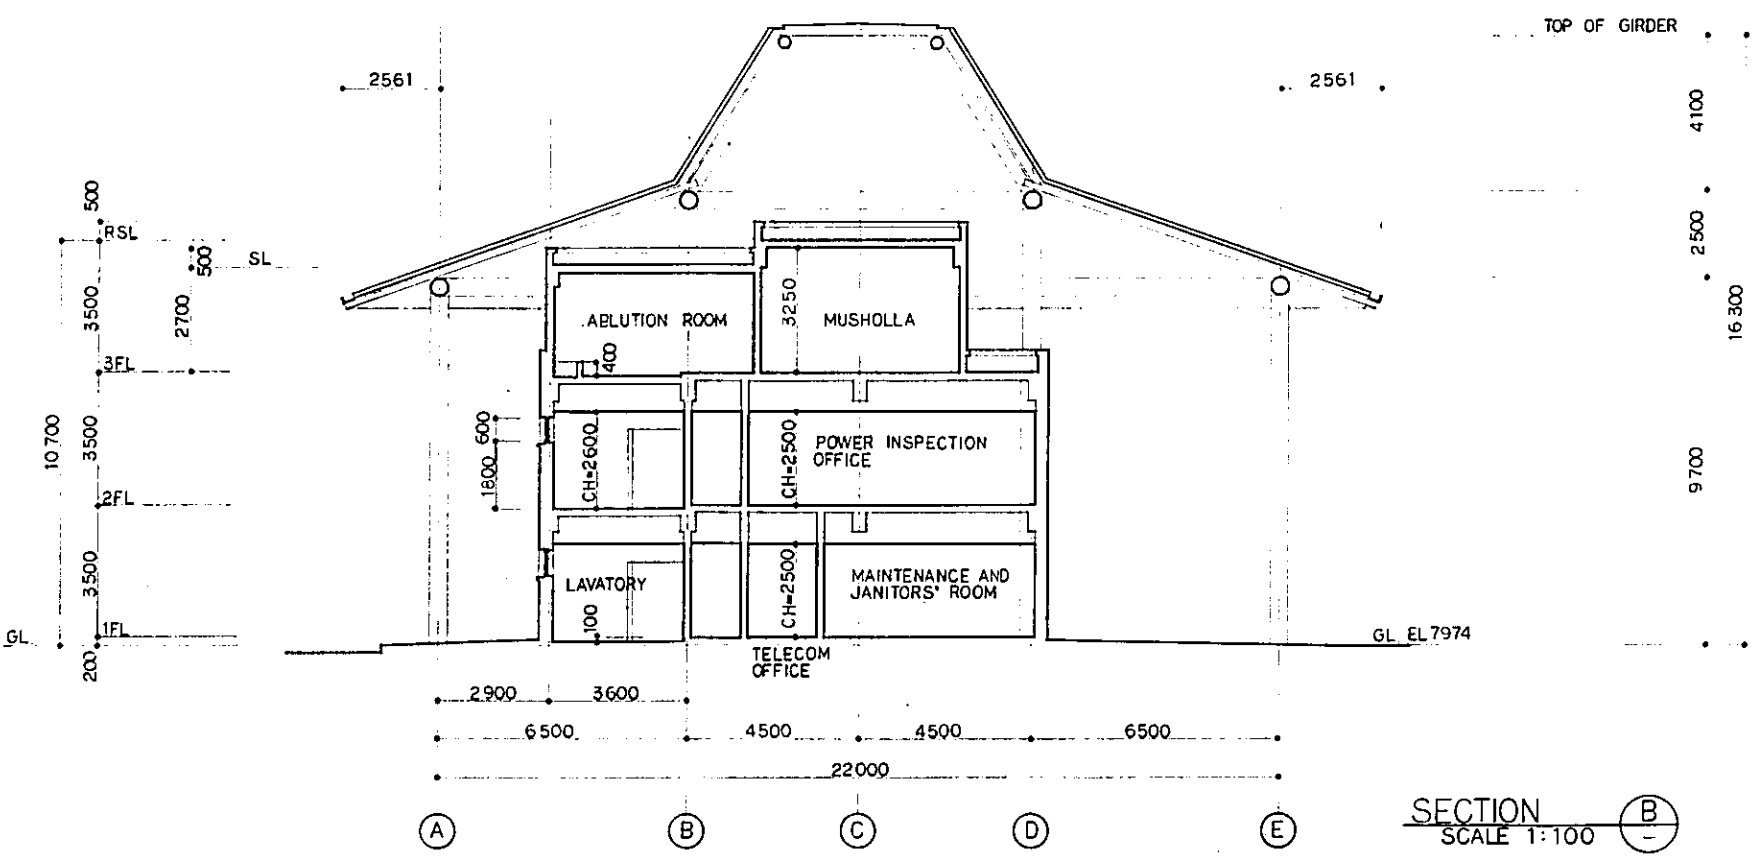


|  |                         |          |       |         |          |
|--|-------------------------|----------|-------|---------|----------|
| REPUBLIC OF INDONESIA<br>MINISTRY OF COMMUNICATIONS<br>DIRECTORATE GENERAL OF LAND TRANSPORT<br>AND INLAND WATERWAYS |                         |          |       |         |          |
| NEW RAILWAY LINE FOR CENGKARENG AIRPORT<br>CONSTRUCTION PROJECT  |                         |          |       |         |          |
| JAPAN INTERNATIONAL COOPERATION AGENCY<br>(JICA)   |                         |          |       |         |          |
| B  | 1 AUG 77                | Sub      | W     | Jimb    | K.M      |
| A  | 15 FEB 77               | Sub      | W     | Jimb    | K.M      |
| REVISIONS  | DATE                    | DESIGNED | DRAWN | CHECKED | REVIEWED |
| AIRPORT TERMINAL STATION<br>TERMINAL BLDG.<br>SECTIONS<br>( SHEET 1 OF 2 )   |                         |          |       |         |          |
| PACKAGE: 1 CIVIL AND ARCHITECTURAL WORK  |                         |          |       |         |          |
| SCALE<br>1:100   | DRAWING NO.<br>AA - 013 |          |       |         |          |




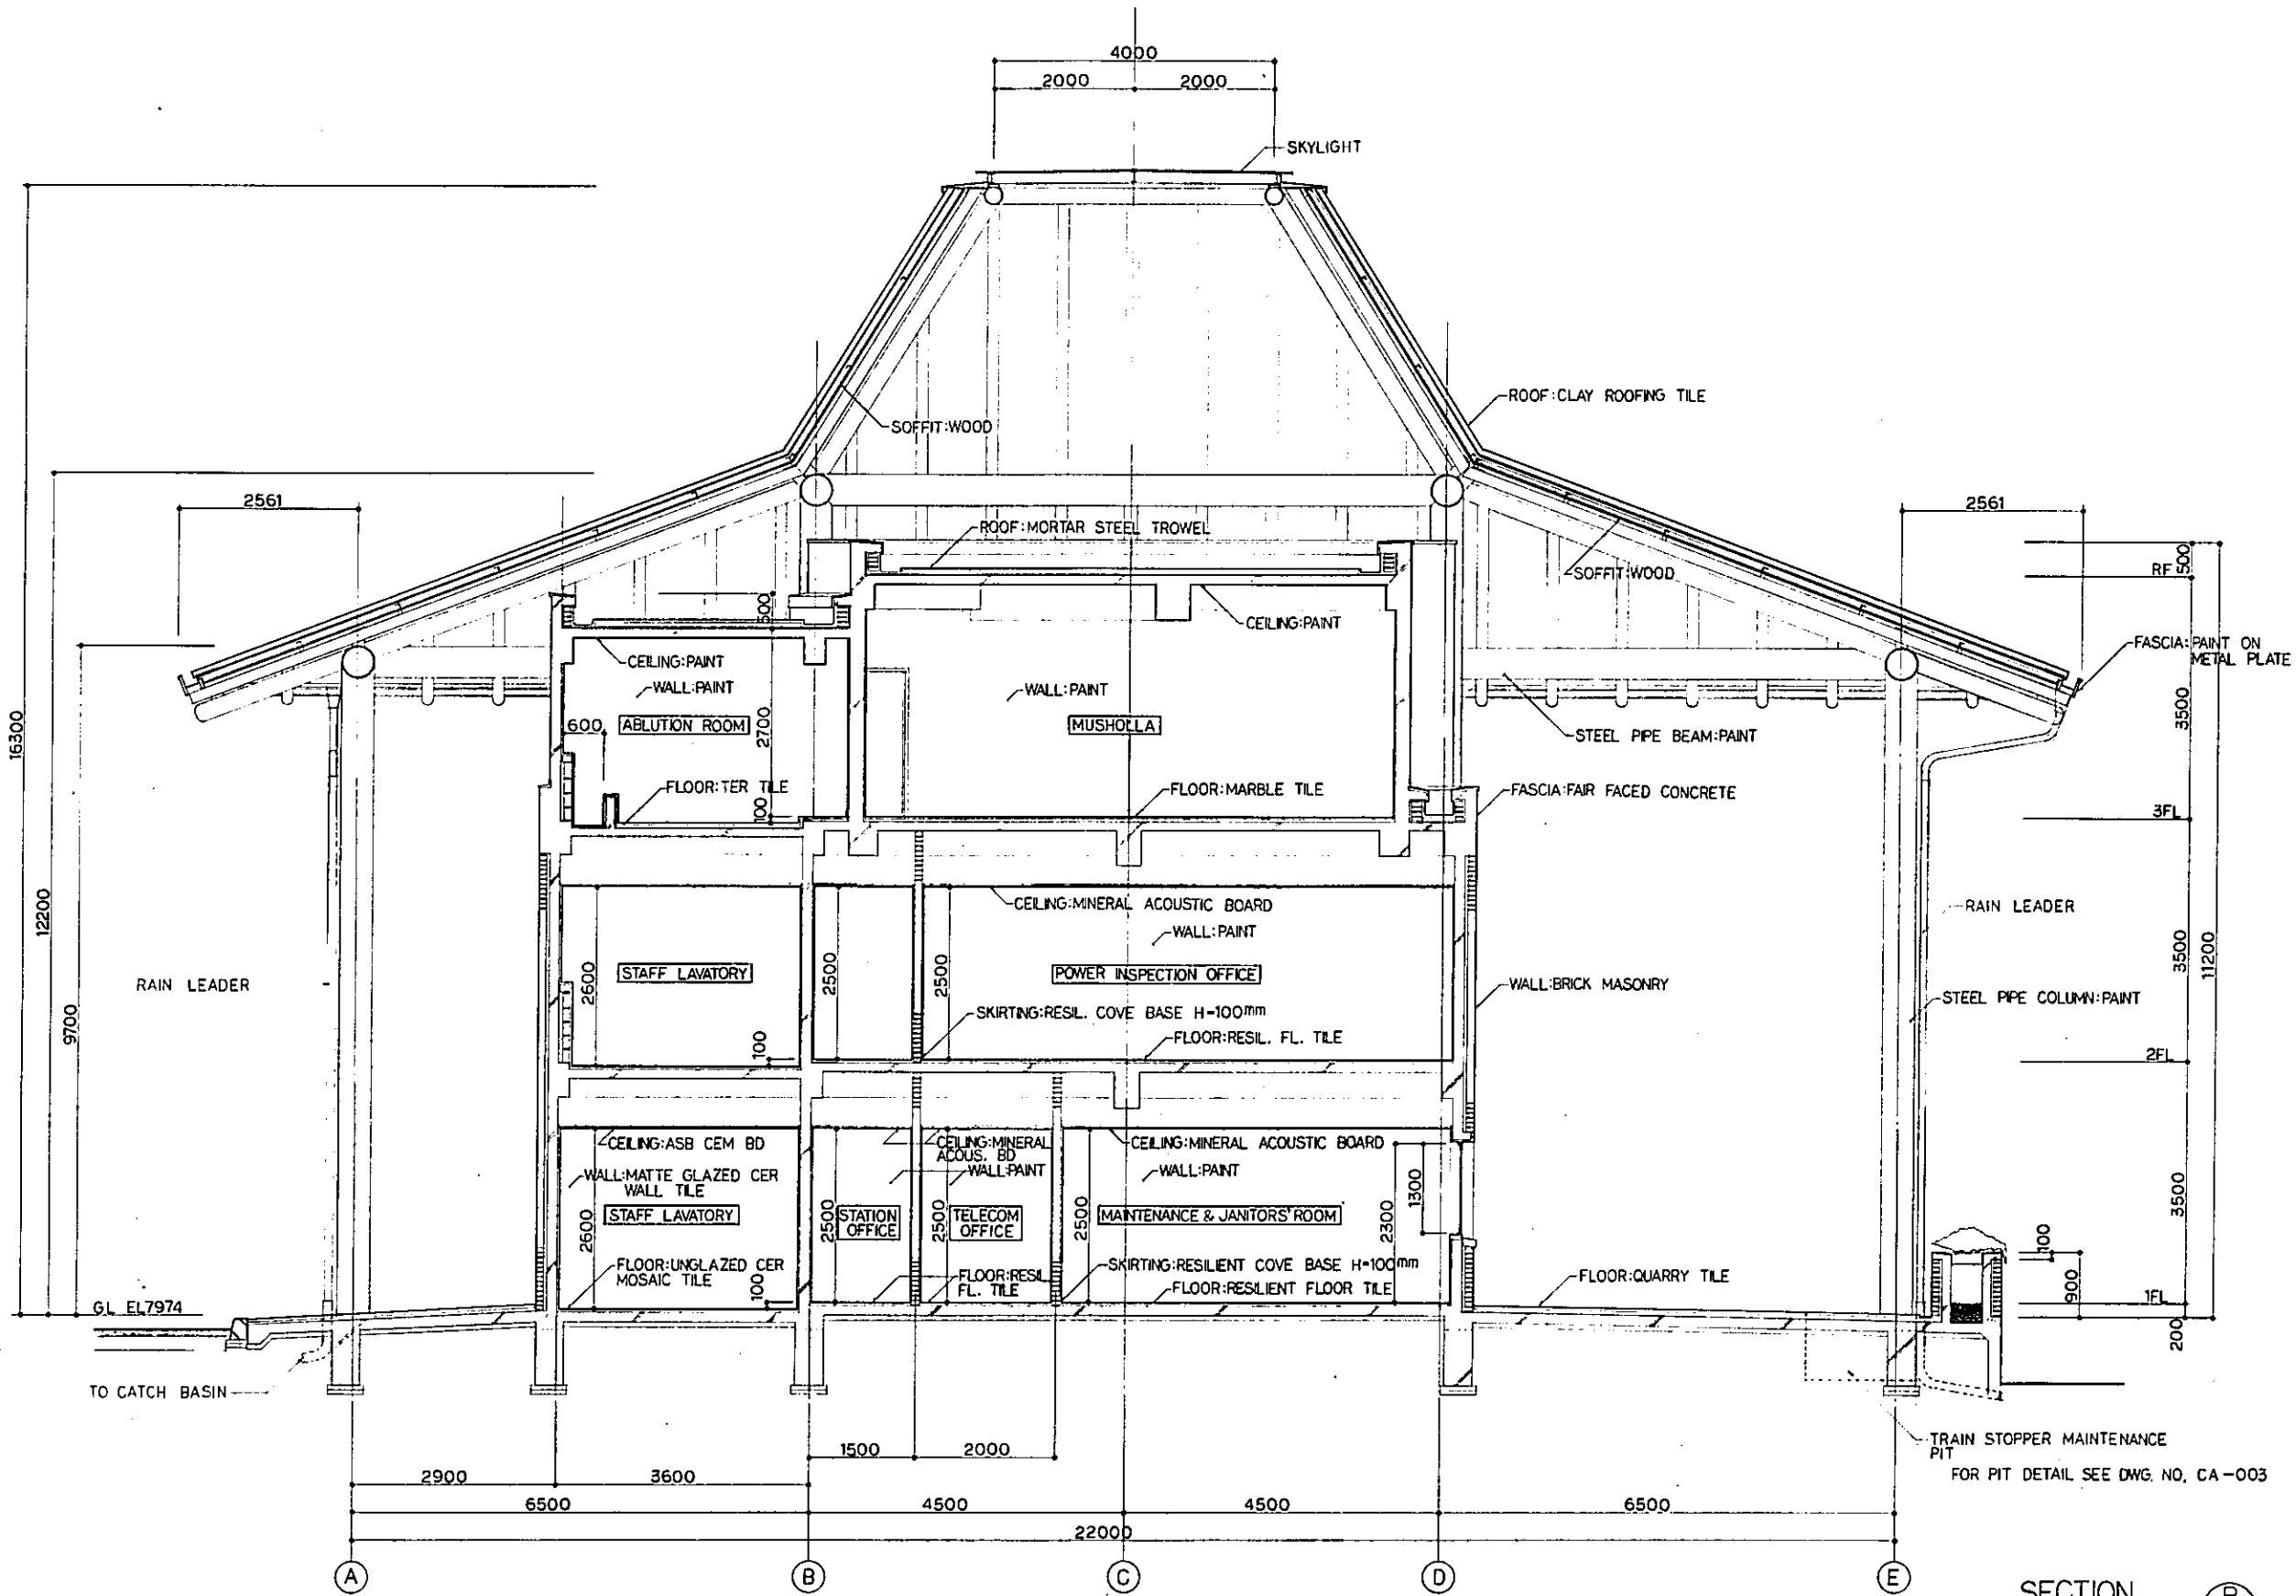


|  |           |                      |          |          |           |
|--|-----------|----------------------|----------|----------|-----------|
| REPUBLIC OF INDONESIA<br>MINISTRY OF COMMUNICATIONS<br>DIRECTORATE GENERAL OF LAND TRANSPORT<br>AND INLAND WATERWAYS |           |                      |          |          |           |
| NEW RAILWAY LINE FOR CENGKARENG AIRPORT<br>CONSTRUCTION PROJECT  |           |                      |          |          |           |
| JAPAN INTERNATIONAL COOPERATION AGENCY<br>(JICA)   |           |                      |          |          |           |
| REVISIONS  | DATE      | DESIGNED             | DRAWN    | CHECKED  | SUBMITTED |
| B  | 1 AUG 89  | P. S. S.             | A. T. S. | K. M. P. | K. M. P.  |
| A  | 15 FEB 89 | S. S. S.             | A. T. S. | K. M. P. | K. M. P.  |
| AIRPORT TERMINAL STATION<br>TERMINAL BLDG.<br>SECTIONS<br>( SHEET 2 OF 2 )   |           |                      |          |          |           |
| PACKAGE: I CIVIL AND ARCHITECTURAL WORK  |           |                      |          |          |           |
| SCALE: 1:50  |           | DRAWING NO: AA - 014 |          |          |           |

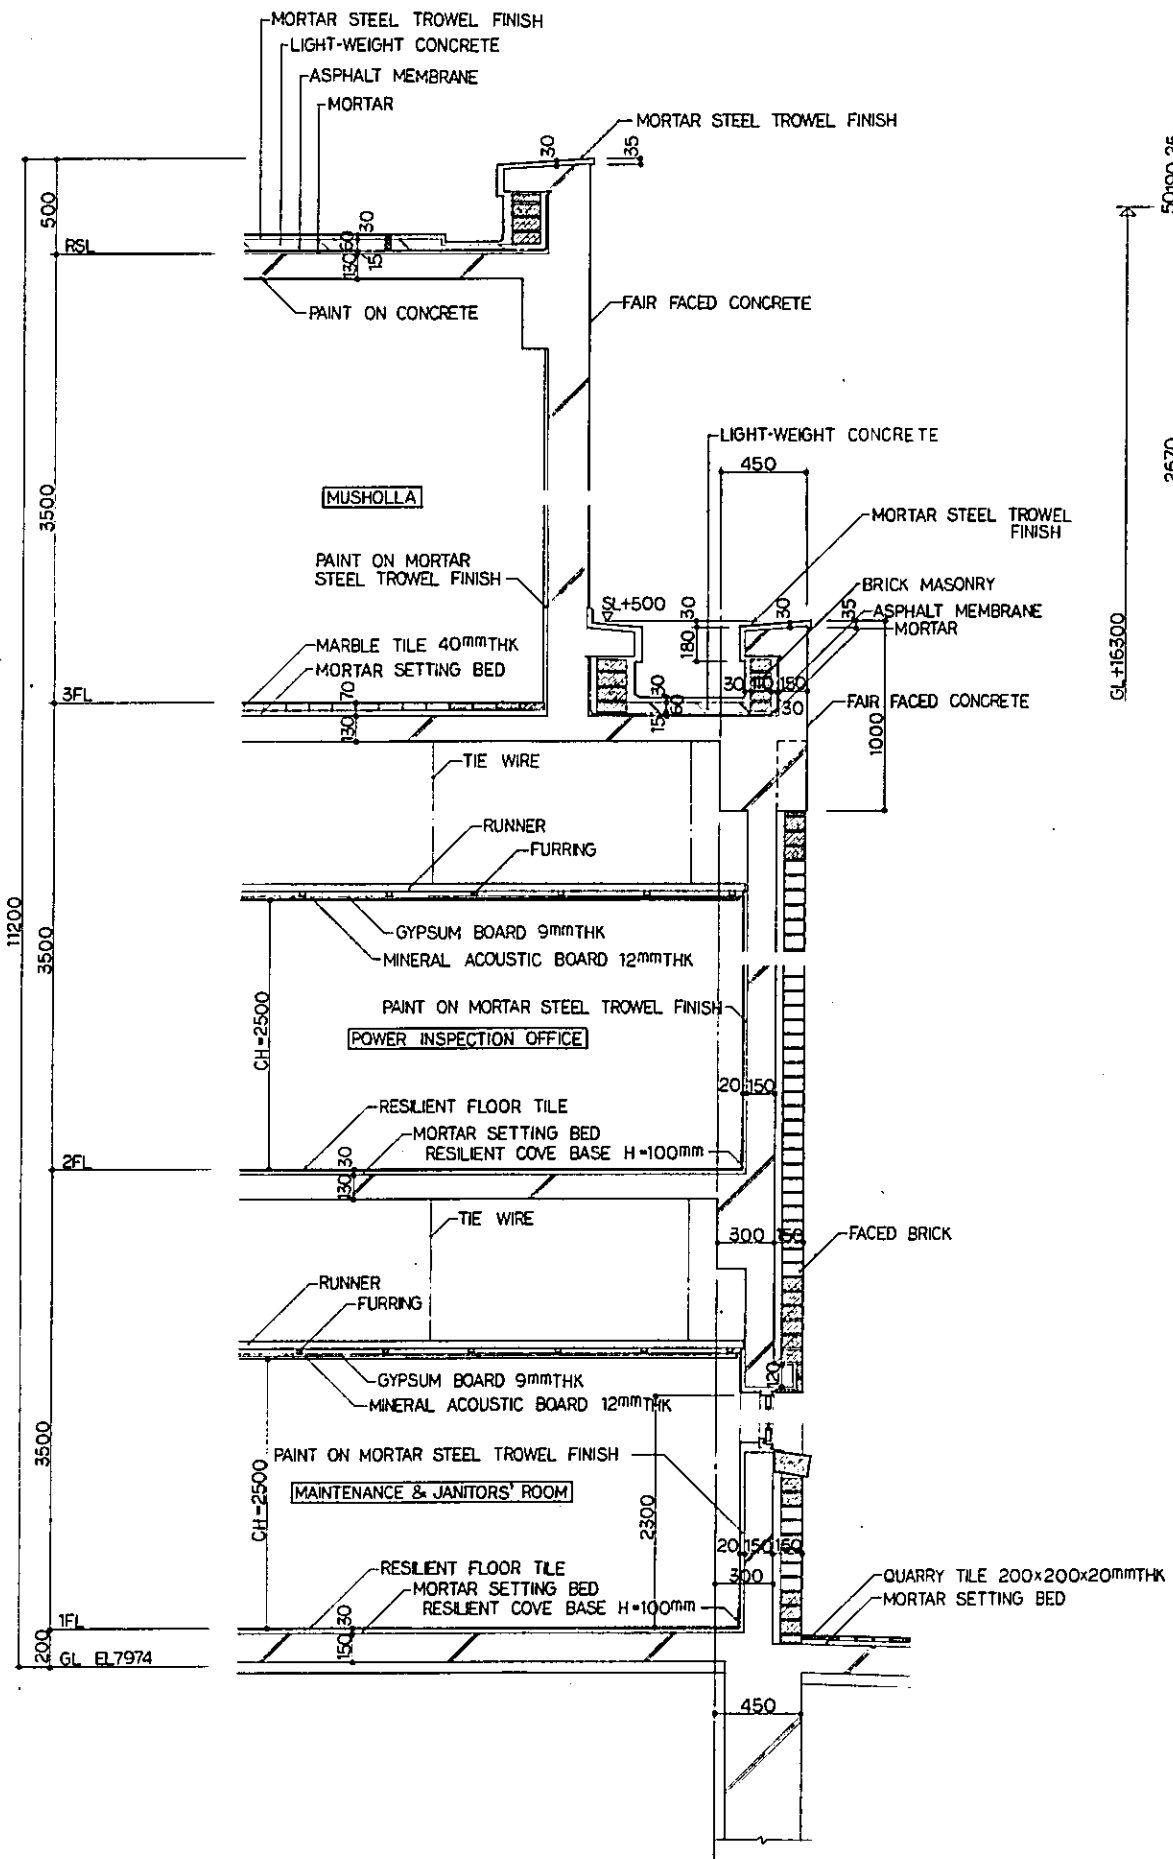


WALL SECTION (B)  
SCALE 1:20

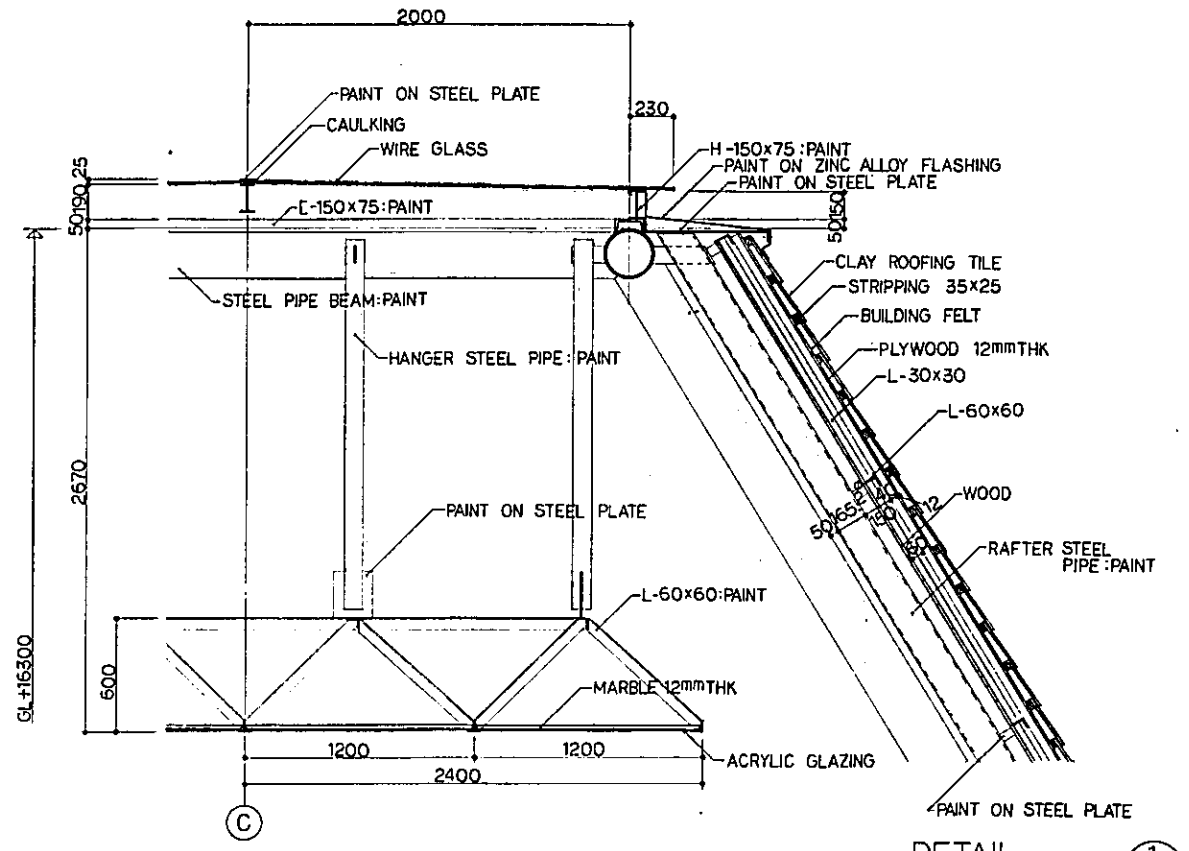

DETAIL (1)  
SCALE 1:20

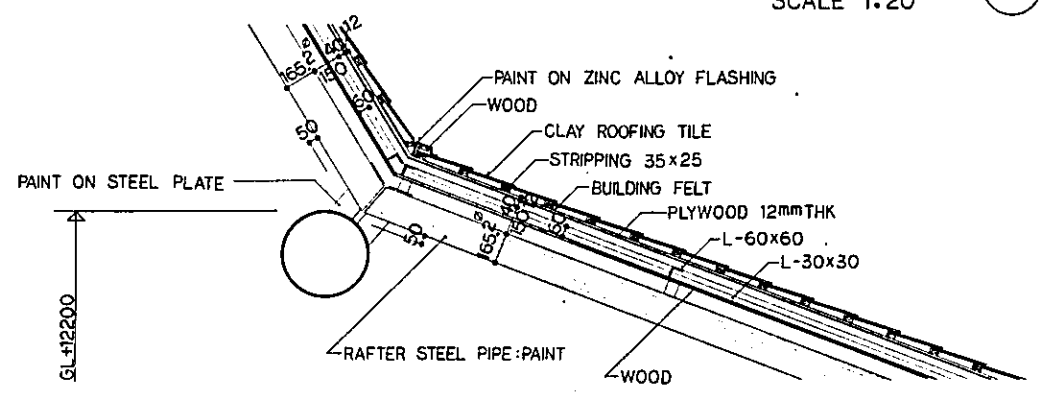


DETAIL (2)  
SCALE 1:20

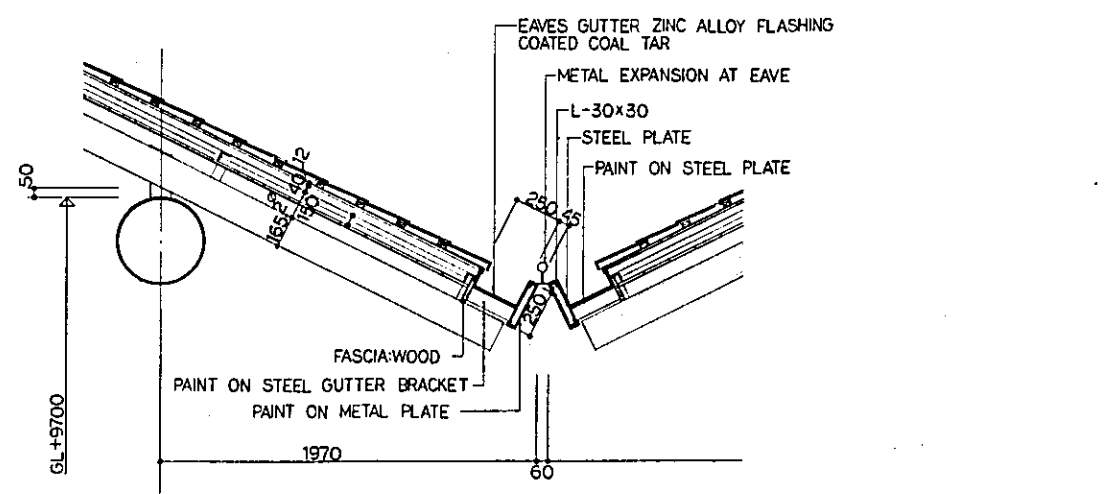


DETAIL (3)  
SCALE 1:20

|   |             |          |       |          |          |
|---|-------------|----------|-------|----------|----------|
| REPUBLIC OF INDONESIA<br>MINISTRY OF COMMUNICATIONS<br>DIRECTORATE GENERAL OF LAND TRANSPORT AND INLAND WATERWAYS |             |          |       |          |          |
| NEW RAILWAY LINE FOR CENGKARENG AIRPORT<br>CONSTRUCTION PROJECT   |             |          |       |          |          |
| JAPAN INTERNATIONAL COOPERATION AGENCY (JICA)   |             |          |       |          |          |
| B   | 1 AUG 89    | Sum      | AT    | Su B.K.M | AK       |
| A   | 15 FEB 89   | Sum      | AT    | Su B.K.M | AK       |
| REVISIONS   | DATE        | DESIGNED | DRAWN | CHECKED  | REVIEWED |
| AIRPORT TERMINAL STATION<br>TERMINAL BLDG.<br>WALL SECTION AND DETAILS  |             |          |       |          |          |
| PACKAGE: I CIVIL AND ARCHITECTURAL WORK   |             |          |       |          |          |
| SCALE   | DRAWING NO: |          |       |          |          |
| 1:20  | AA - 015    |          |       |          |          |

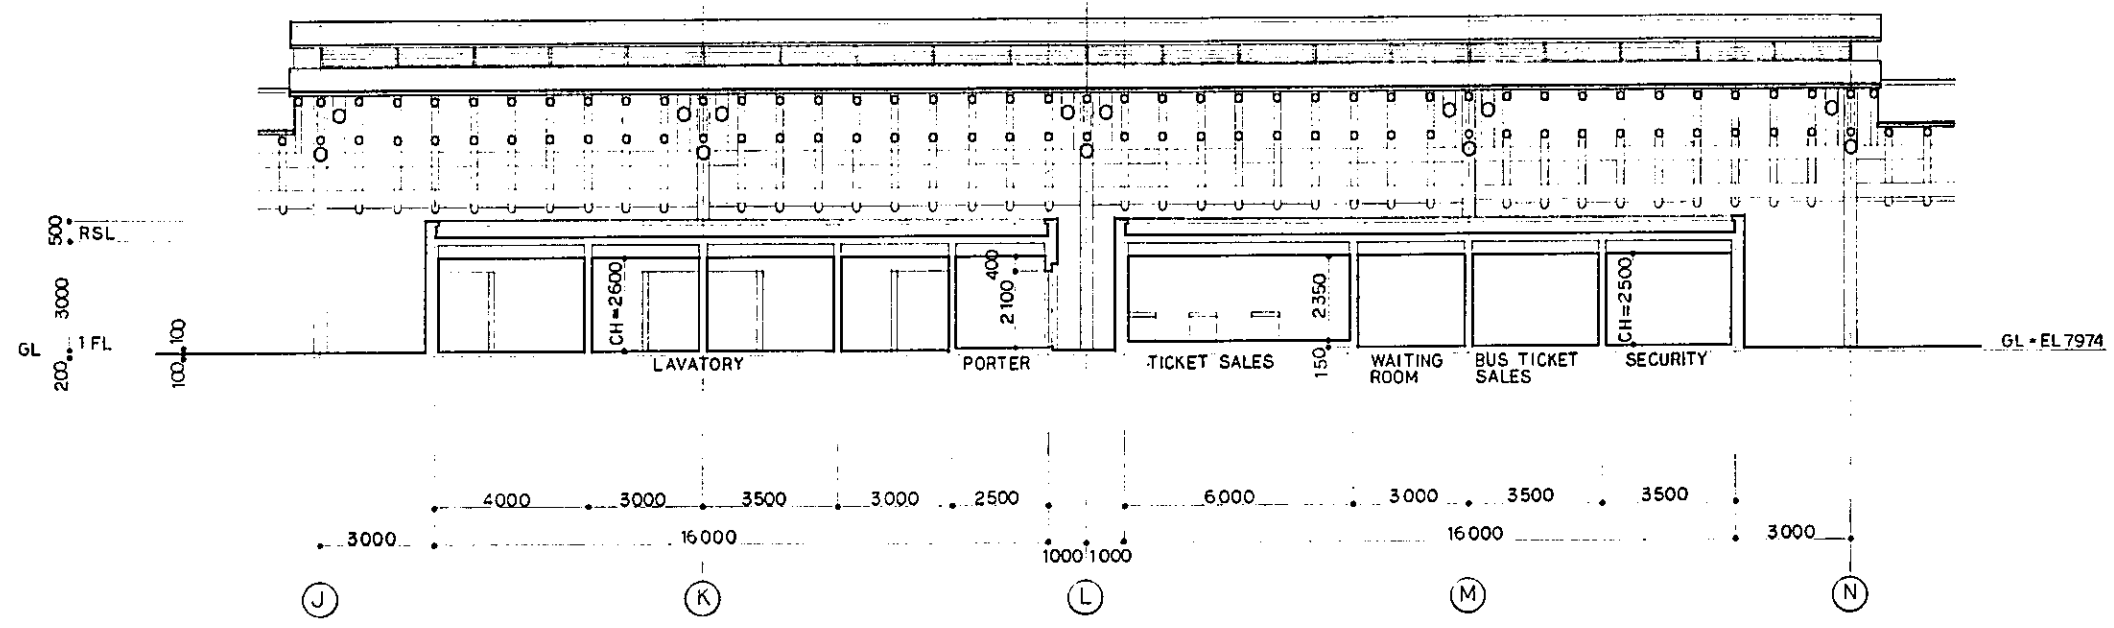


SECTION A  
SCALE 1:100

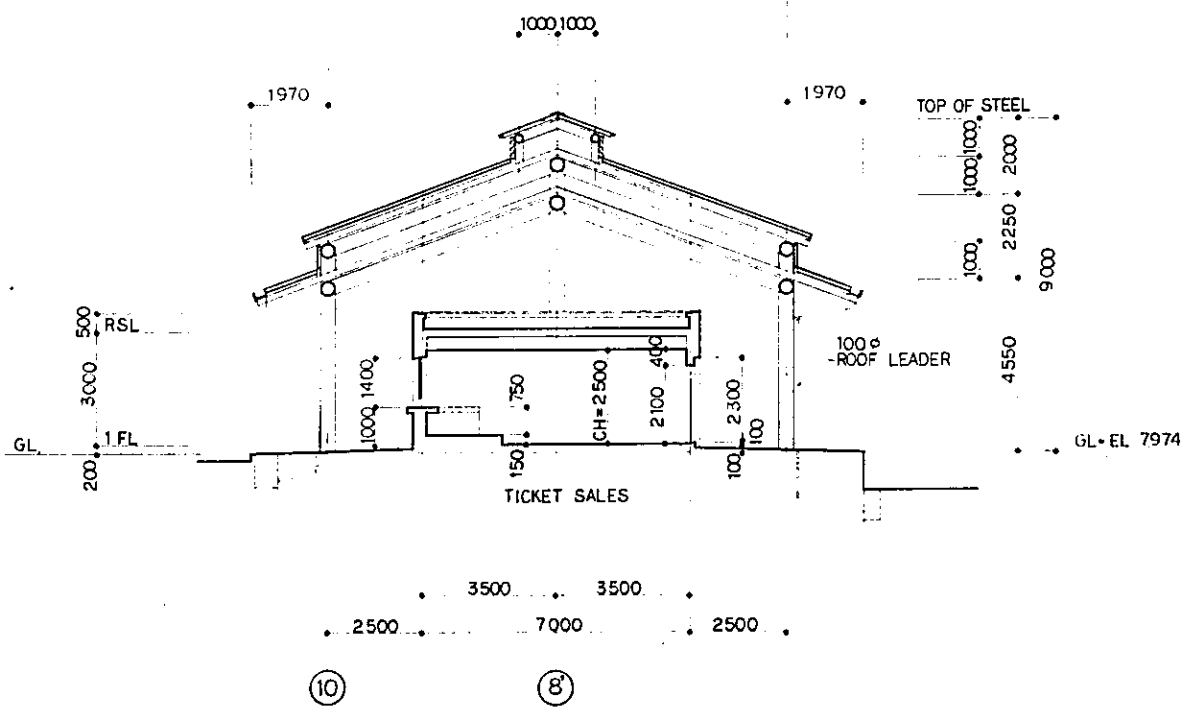


SECTION B  
SCALE 1:100

|  |           |                     |       |         |           |
|--|-----------|---------------------|-------|---------|-----------|
| REPUBLIC OF INDONESIA<br>MINISTRY OF COMMUNICATIONS<br>DIRECTORATE GENERAL OF LAND TRANSPORT<br>AND INLAND WATERWAYS |           |                     |       |         |           |
| NEW RAILWAY LINE FOR CENGKARENG AIRPORT<br>CONSTRUCTION PROJECT  |           |                     |       |         |           |
| JAPAN INTERNATIONAL COOPERATION AGENCY<br>(JICA)   |           |                     |       |         |           |
| B  | 1 AUG 89  | Final               | ✓     | ✓       | ✓         |
| A  | 15 FEB 89 | Final               | ✓     | ✓       | ✓         |
| REVISIONS  | DATE      | DESIGNED            | DRAWN | CHECKED | SUBMITTED |
| AIRPORT TERMINAL STATION<br>BOOKING OFFICE<br>SECTIONS   |           |                     |       |         |           |
| PACKAGE: I CIVIL AND ARCHITECTURAL WORK  |           |                     |       |         |           |
| SCALE: 1:100   |           | DRAWING NO: AA - 16 |       |         |           |

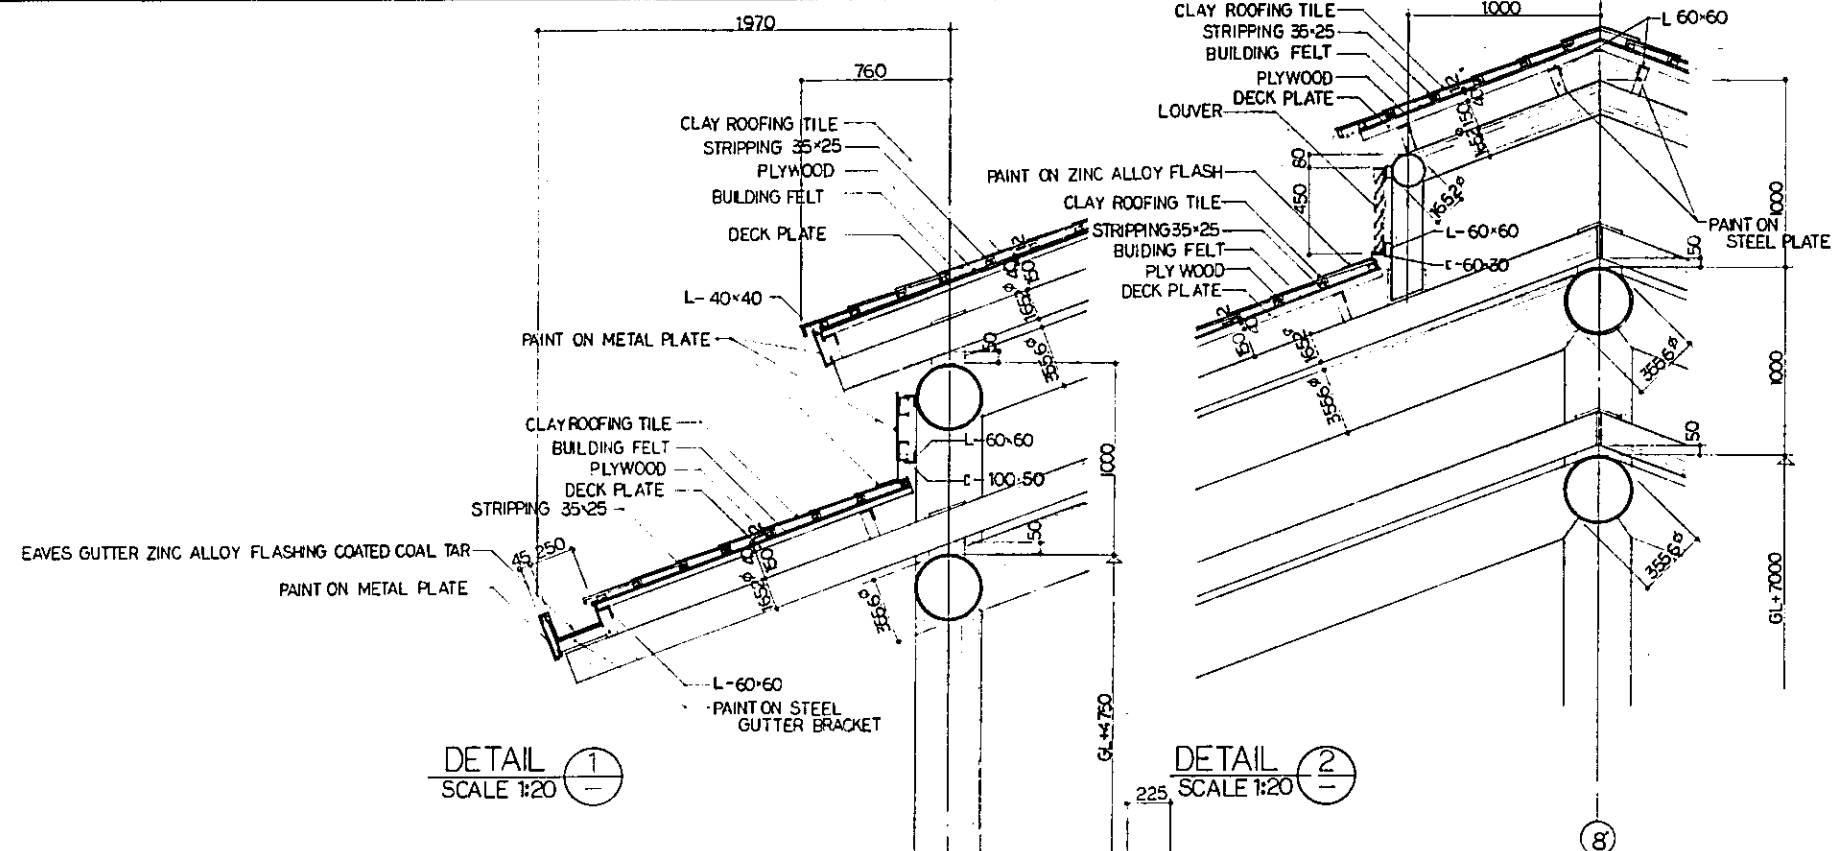


DETAIL 1  
SCALE 1:20

DETAIL 2  
SCALE 1:20


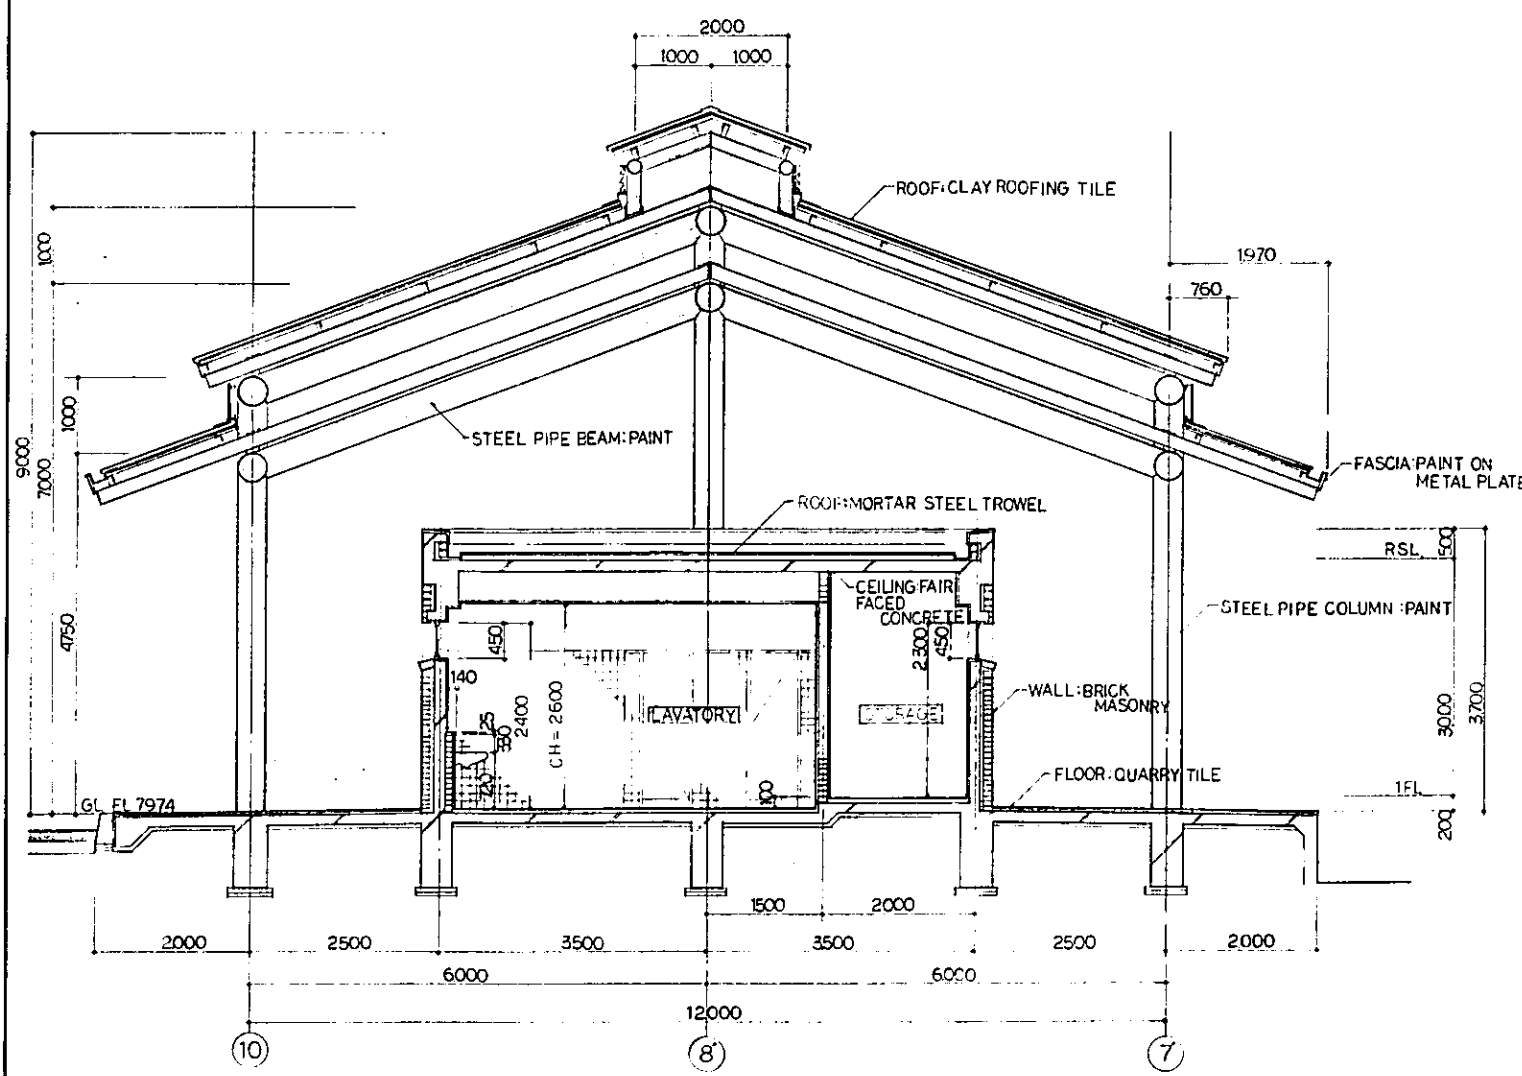


SECTION C  
SCALE 1:50

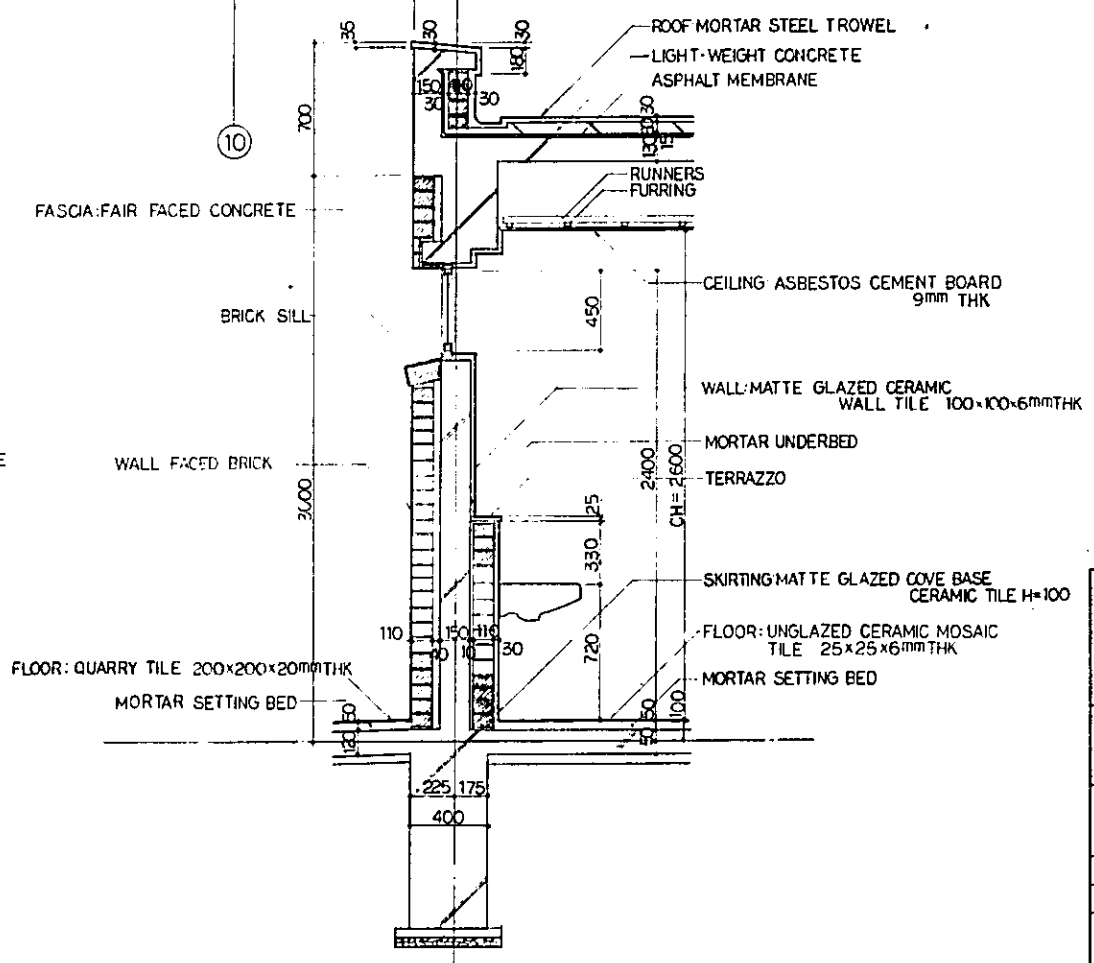

WALL SECTION C  
SCALE 1:20

|  |            |                         |             |             |             |
|--|------------|-------------------------|-------------|-------------|-------------|
| REPUBLIC OF INDONESIA<br>MINISTRY OF COMMUNICATIONS<br>DIRECTORATE GENERAL OF LAND TRANSPORT<br>AND INLAND WATERWAYS |            |                         |             |             |             |
| NEW RAILWAY LINE FOR CENGKARENG AIRPORT<br>CONSTRUCTION PROJECT  |            |                         |             |             |             |
| JAPAN INTERNATIONAL COOPERATION AGENCY<br>(JICA)   |            |                         |             |             |             |
| REVISIONS  | DATE       | DESIGNED                | DRAWN       | CHECKED     | REVIEWED    |
| B  | 1 AUG. 89  | [Signature]             | [Signature] | [Signature] | [Signature] |
| A  | 15 FEB. 89 | [Signature]             | [Signature] | [Signature] | [Signature] |
| AIRPORT TERMINAL STATION<br>BOOKING OFFICE<br>SECTIONS   |            |                         |             |             |             |
| PACKAGE: I CIVIL AND ARCHITECTURAL WORK  |            |                         |             |             |             |
| SCALE<br>1:20, 1:50  |            | DRAWING NO:<br>AA - 017 |             |             |             |

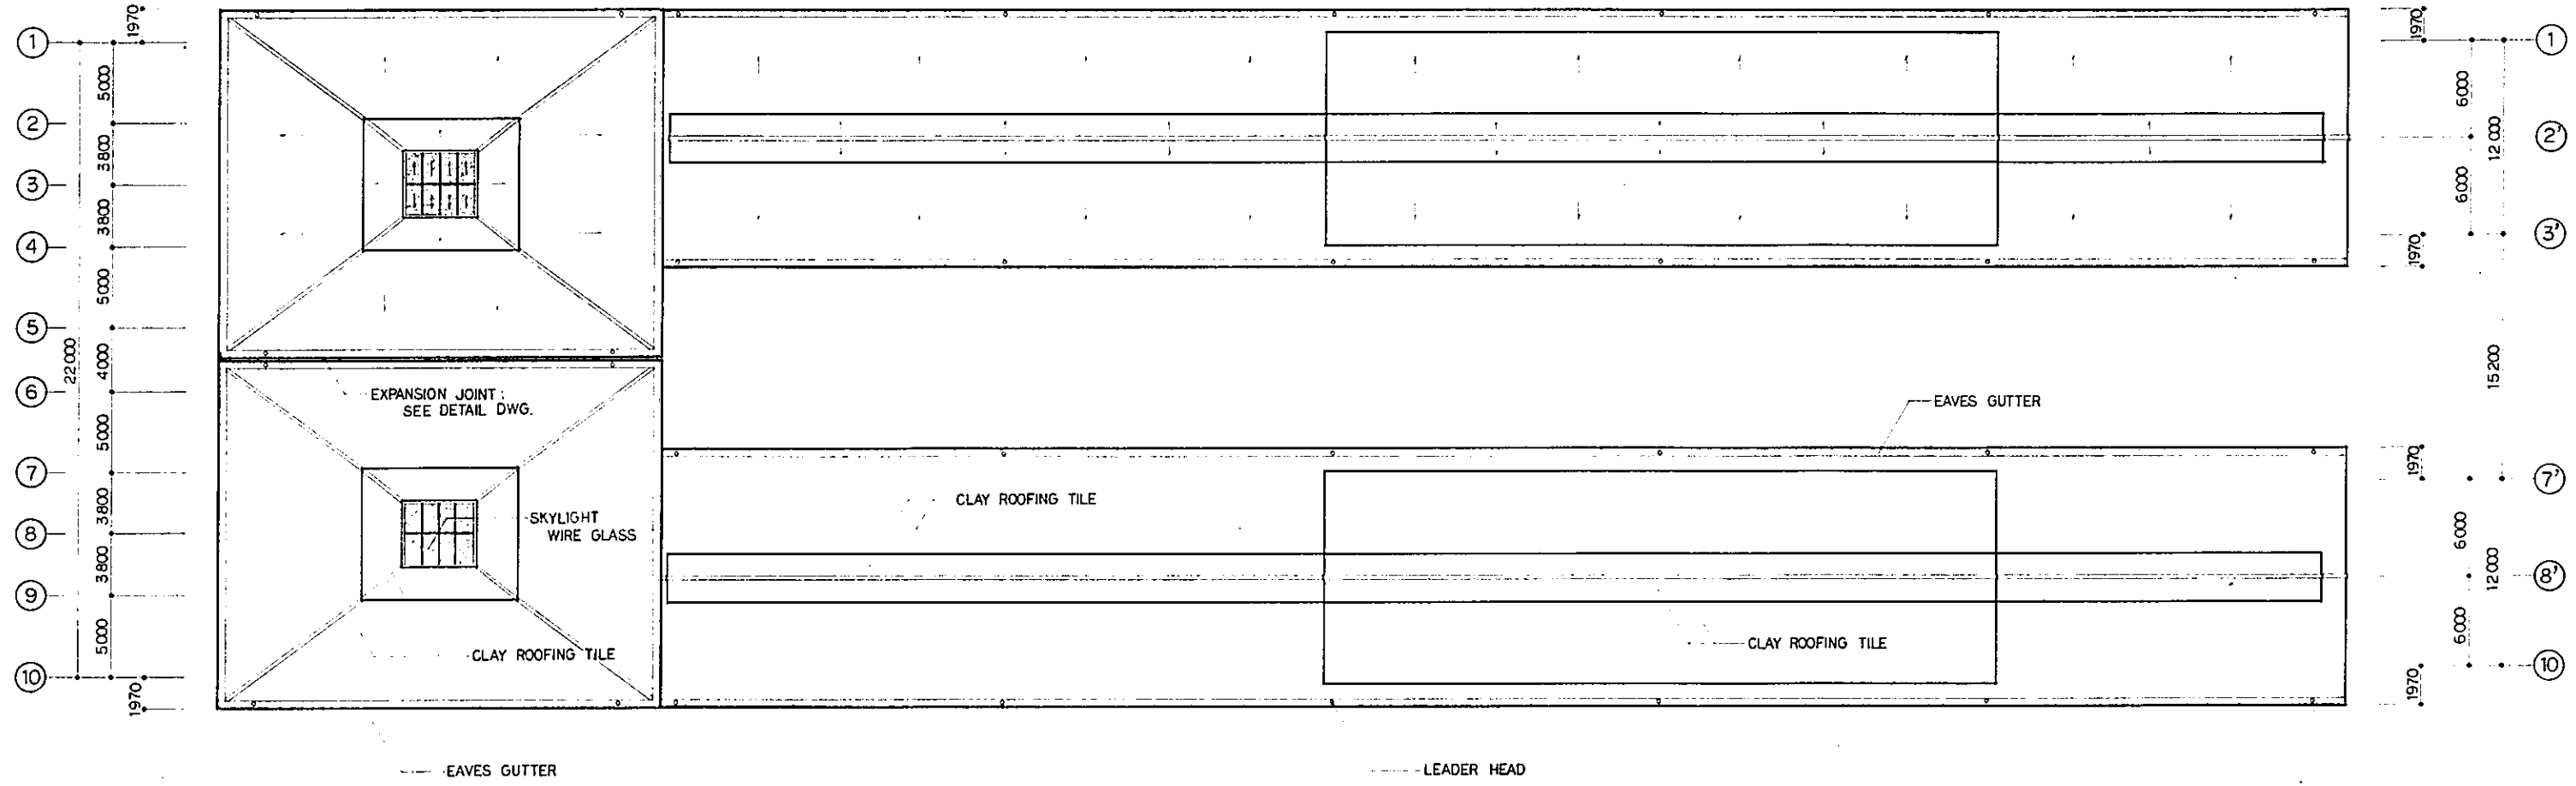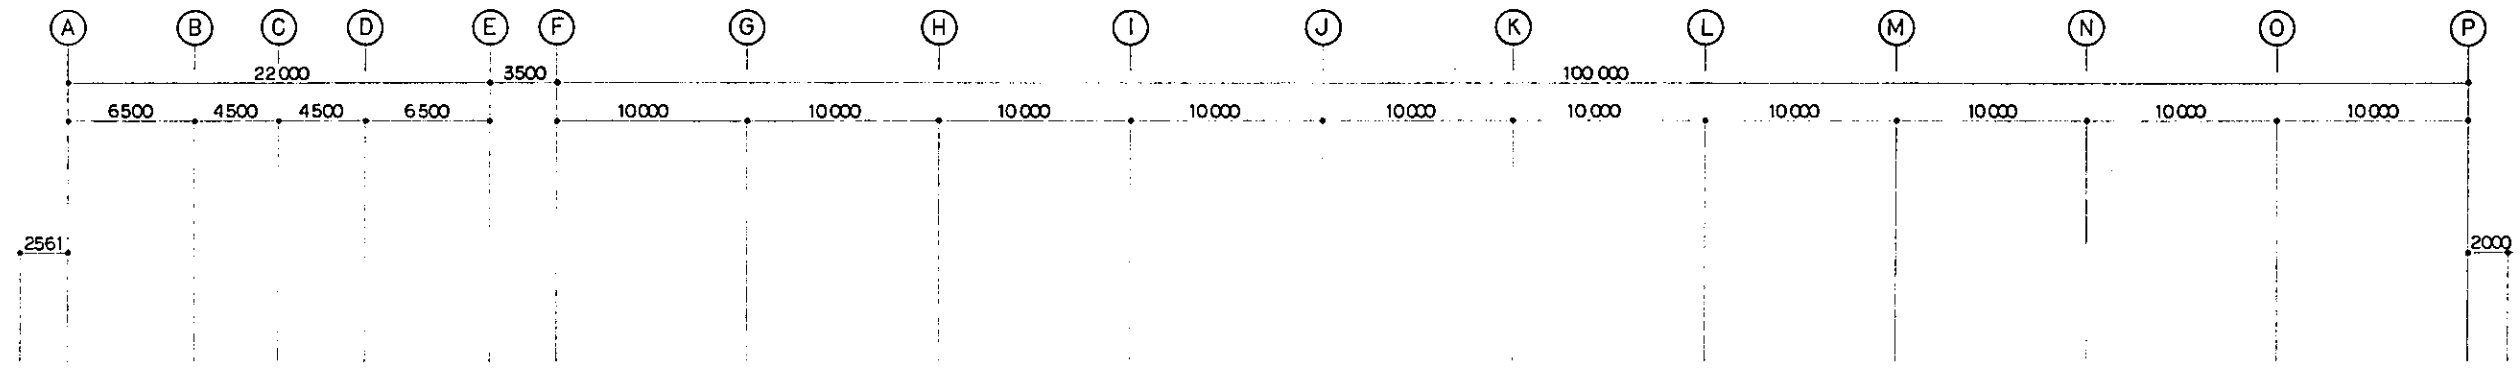

ROOF PLAN  
SCALE 1:200

REPUBLIC OF INDONESIA  
MINISTRY OF COMMUNICATIONS  
DIRECTORATE GENERAL OF LAND TRANSPORT  
AND INLAND WATERWAYS

NEW RAILWAY LINE FOR CENGKARENG AIRPORT  
CONSTRUCTION PROJECT



JAPAN INTERNATIONAL COOPERATION AGENCY  
(JICA)

| REVISIONS | DATE       | DESIGNED | DRAWN    | CHECKED | REVIEWED | SUBMITTED |
|-----------|------------|----------|----------|---------|----------|-----------|
| B         | 1 AUG. 89  | T. S. G. | S. K. M. | K. M.   |          |           |
| A         | 15 FEB. 89 | T. S. G. | S. K. M. | K. M.   |          |           |

AIRPORT TERMINAL STATION  
ROOF PLAN

PACKAGE: I CIVIL AND ARCHITECTURAL WORK

SCALE: 1:200      DRAWING NO: AA - 018

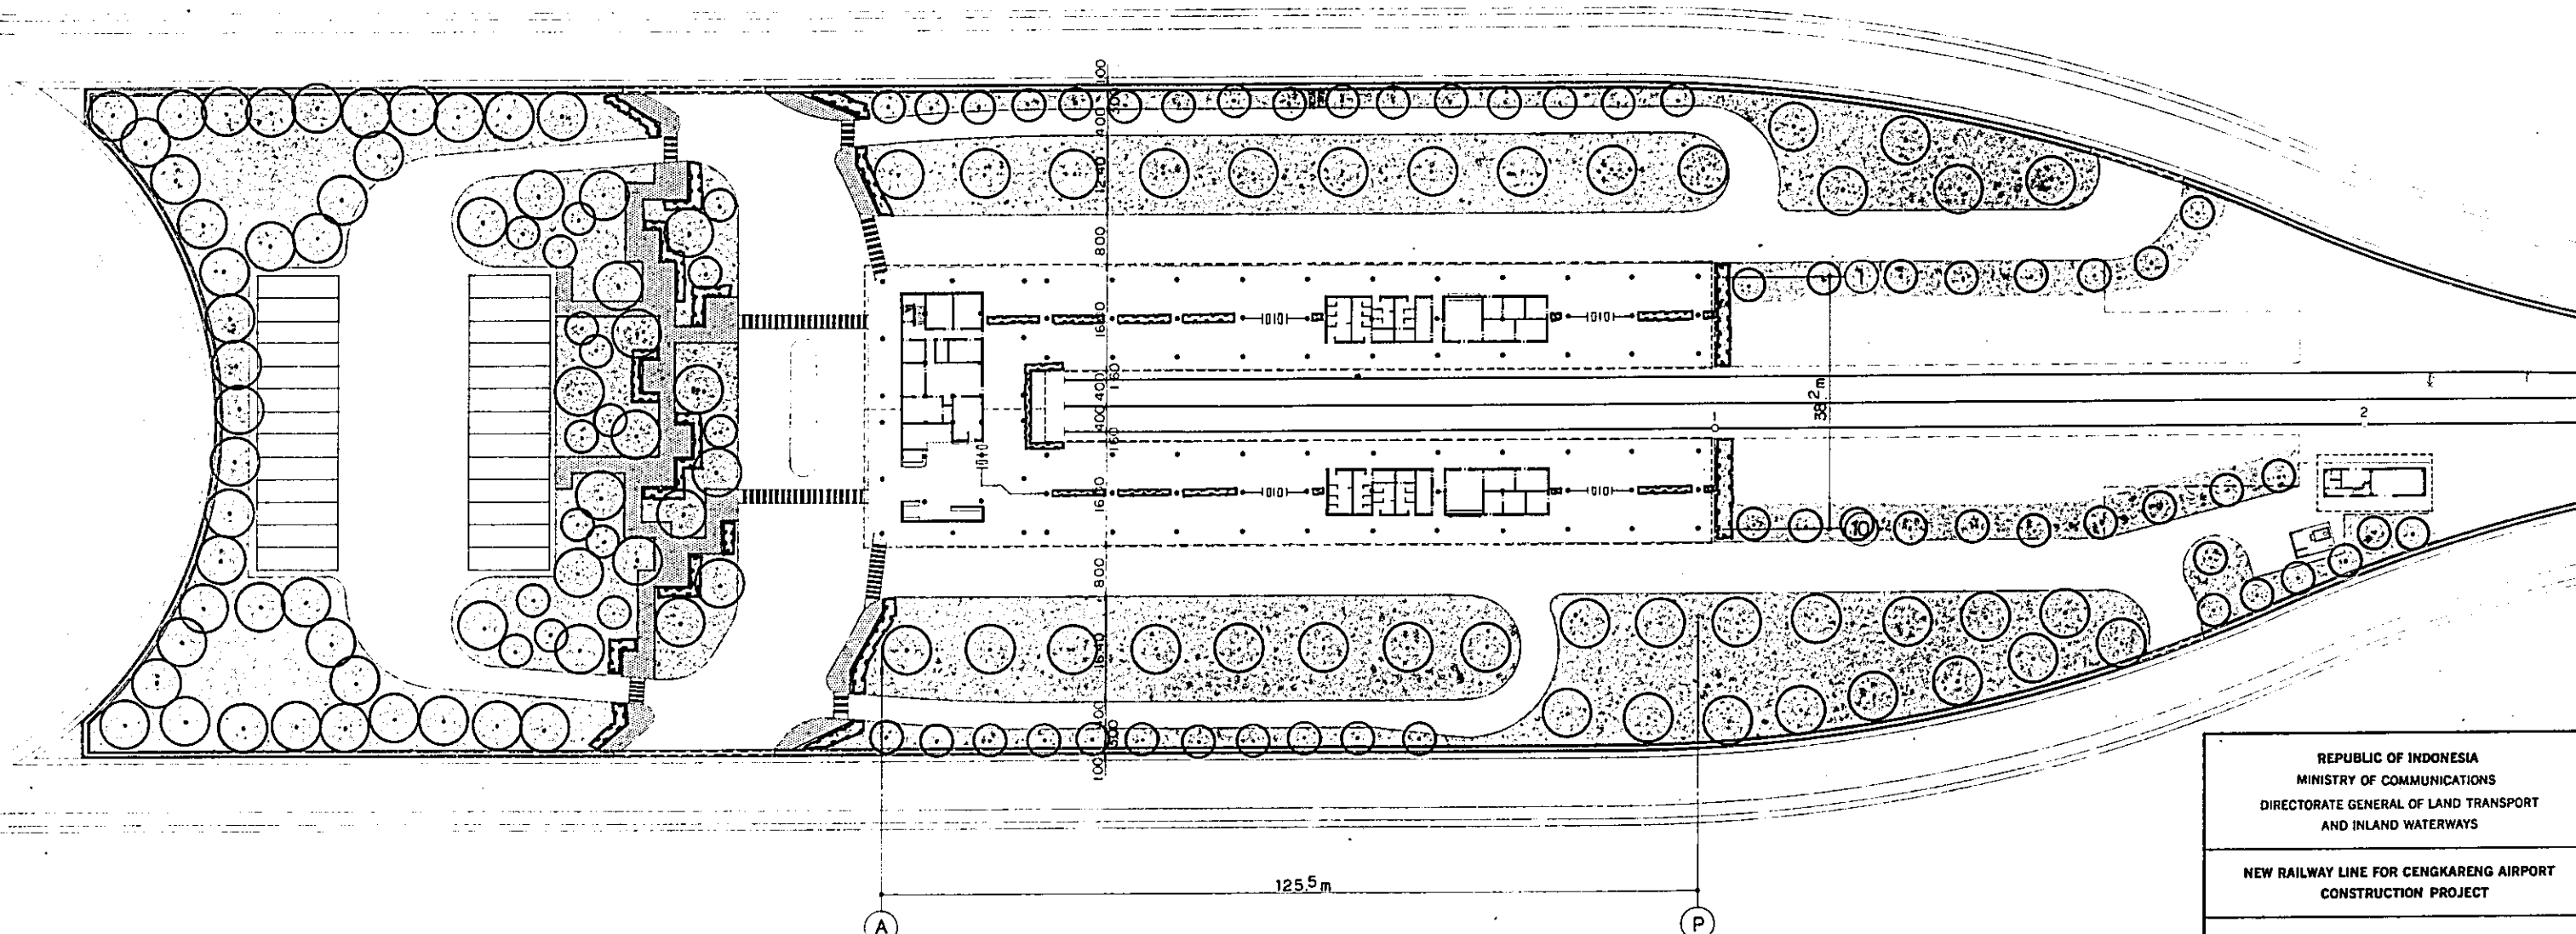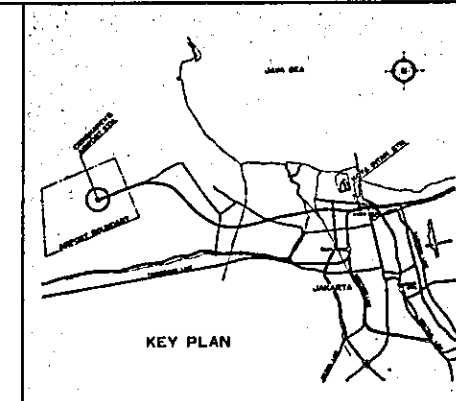


LANDSCAPING PLAN  
SCALE 1:500

LEGEND

- TREE - TALL 96
- TREE - MEDIUM 68
- SHRUB 408 m<sup>2</sup>
- GREEN ZONE 13610 m<sup>2</sup>
- PAVEMENT 790 m<sup>2</sup>

|  |            |                      |       |         |           |
|--|------------|----------------------|-------|---------|-----------|
| REPUBLIC OF INDONESIA<br>MINISTRY OF COMMUNICATIONS<br>DIRECTORATE GENERAL OF LAND TRANSPORT<br>AND INLAND WATERWAYS |            |                      |       |         |           |
| NEW RAILWAY LINE FOR CENGKARENG AIRPORT<br>CONSTRUCTION PROJECT  |            |                      |       |         |           |
| JAPAN INTERNATIONAL COOPERATION AGENCY<br>(JICA)   |            |                      |       |         |           |
| REVISIONS  | DATE       | DESIGNED             | DRAWN | CHECKED | REVIEWED  |
| B.   | 1 AUG. 88  | B. Sudo              | Sudo  | Sudo    | K.M. m.K. |
| A  | 15 FEB. 88 | B. Sudo              | Sudo  | Sudo    | K.M. m.K. |
| AIRPORT TERMINAL STATION<br>LANDSCAPING PLAN   |            |                      |       |         |           |
| PACKAGE: I CIVIL AND ARCHITECTURAL WORK  |            |                      |       |         |           |
| SCALE 1:500  |            | DRAWING NO. AA - 019 |       |         |           |

NOTE:  
REFER TO SPECIFICATIONS, SECTION:  
FURNITURE, FOR LIST OF PRODUCT REFERENCE  
DESIGNATIONS.

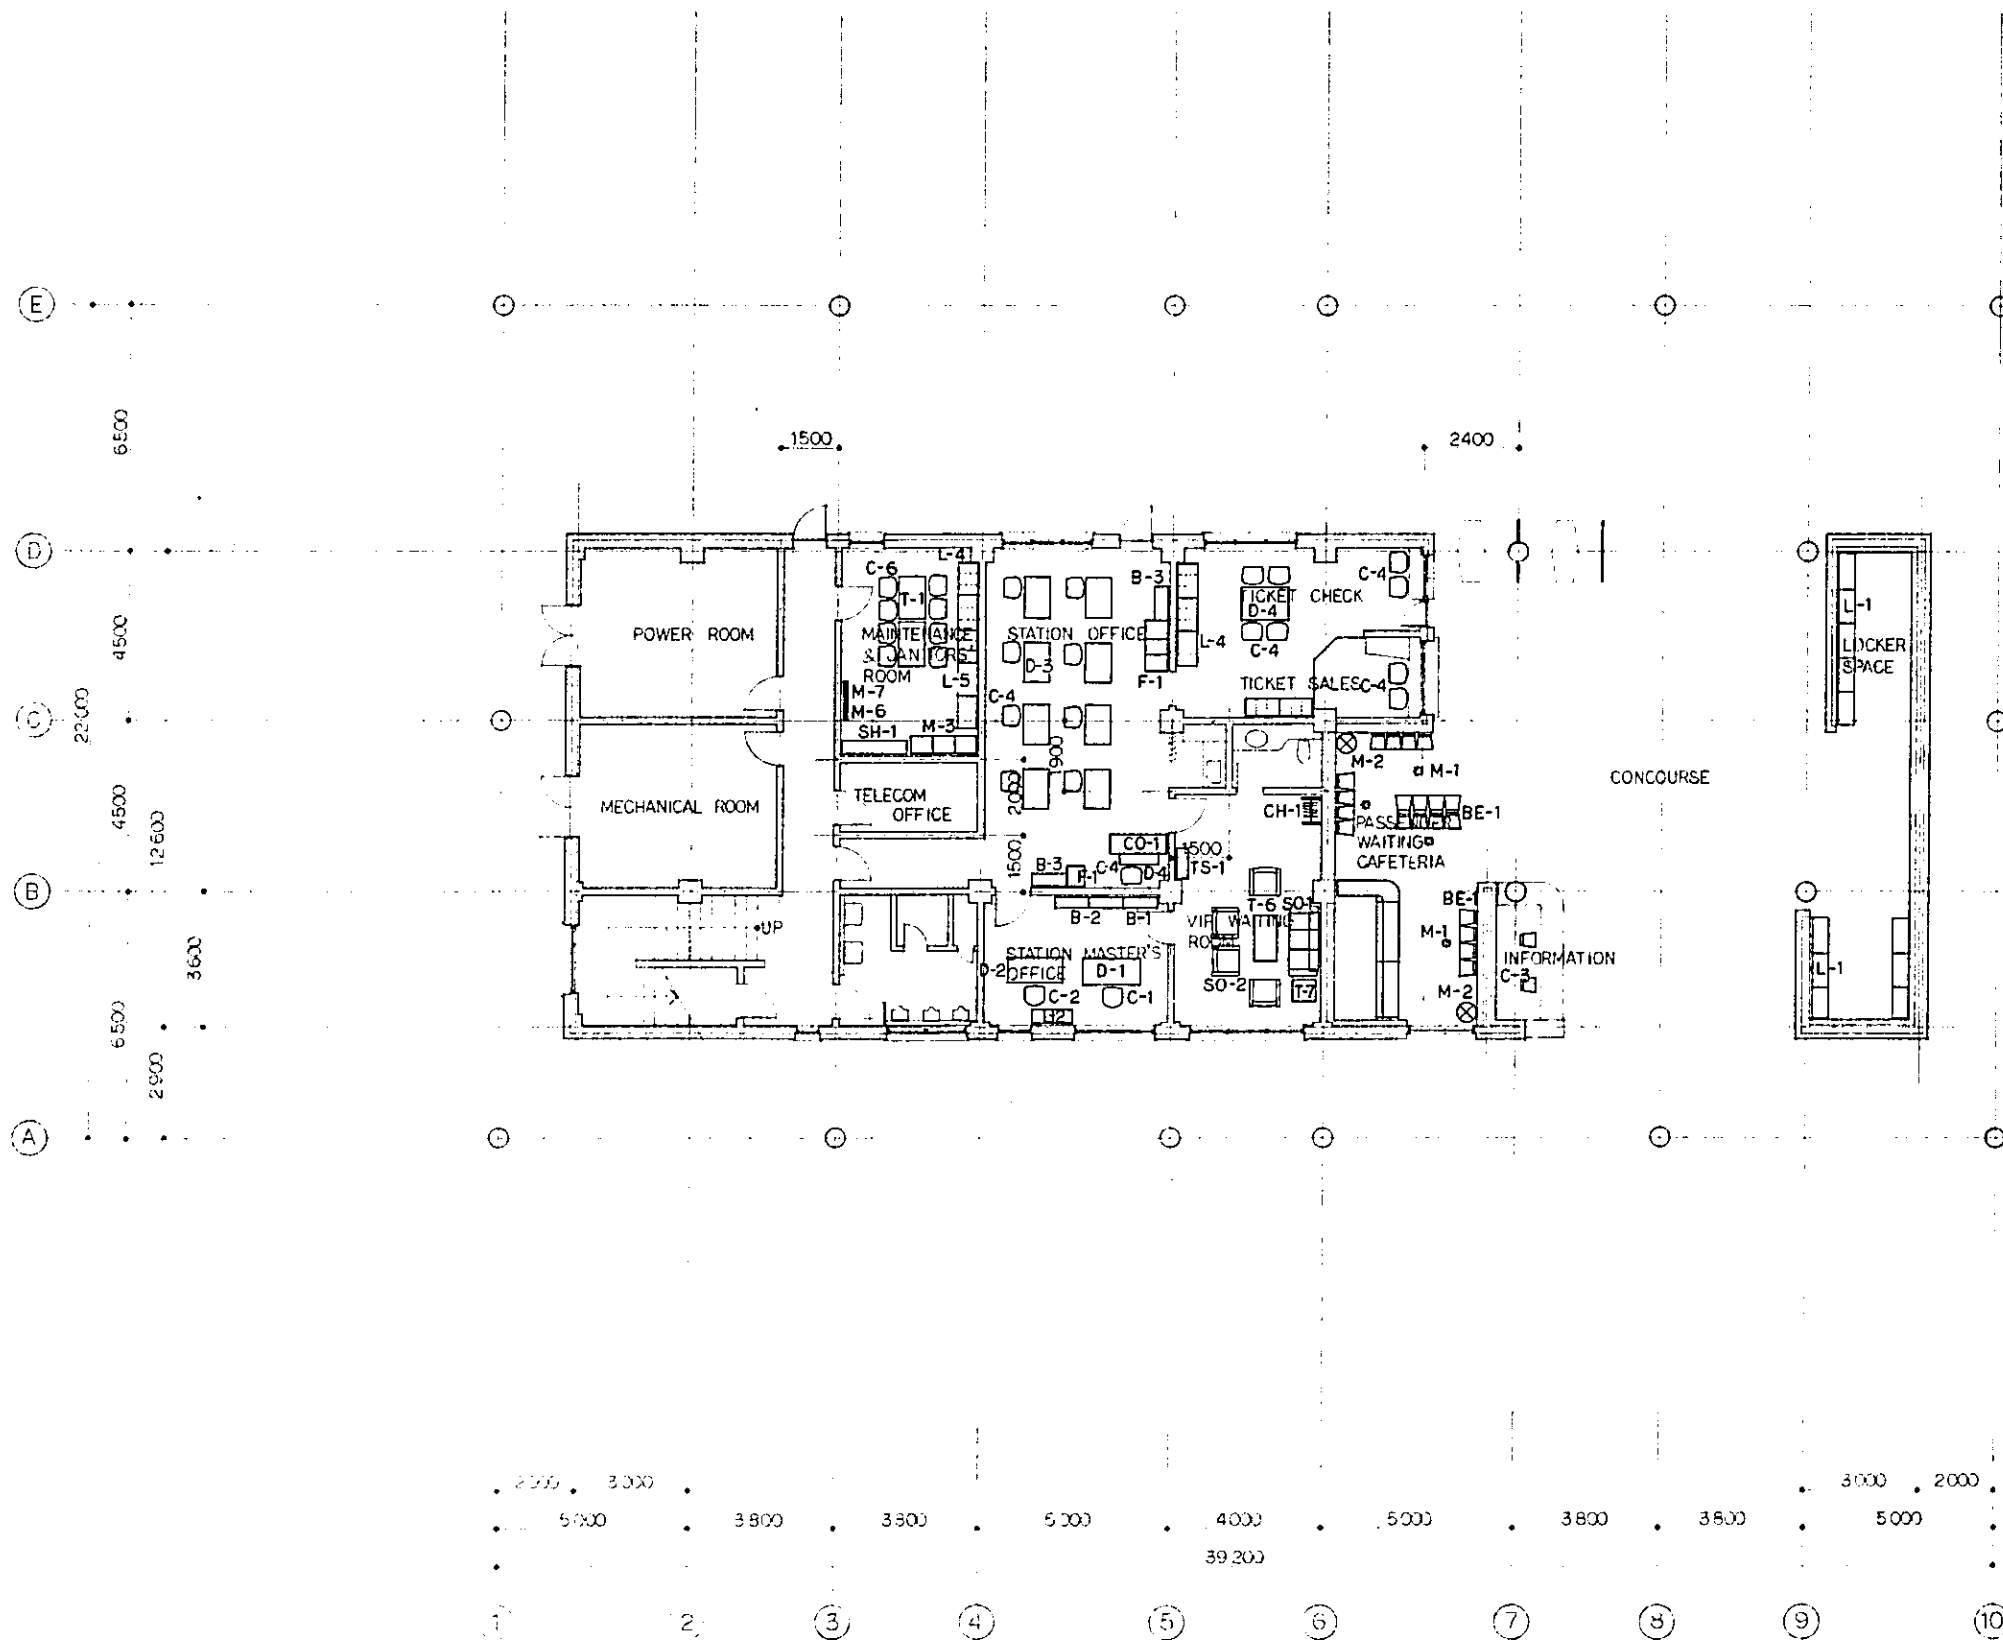

REPUBLIC OF INDONESIA  
MINISTRY OF COMMUNICATIONS  
DIRECTORATE GENERAL OF LAND TRANSPORT  
AND INLAND WATERWAYS

NEW RAILWAY LINE FOR CENGKARENG AIRPORT  
CONSTRUCTION PROJECT

JAPAN INTERNATIONAL COOPERATION AGENCY  
(JICA)


| REVISIONS | DATE       | DESIGNED           | DRAWN              | CHECKED            | REVIEWED           | SUBMITTED          |
|-----------|------------|--------------------|--------------------|--------------------|--------------------|--------------------|
| B         | 1 AUG. 88  | <i>[Signature]</i> | <i>[Signature]</i> | <i>[Signature]</i> | <i>[Signature]</i> | <i>[Signature]</i> |
| A         | 15 FEB. 88 | <i>[Signature]</i> | <i>[Signature]</i> | <i>[Signature]</i> | <i>[Signature]</i> | <i>[Signature]</i> |

AIRPORT TERMINAL STATION  
FURNITURE LAYOUT PLAN  
( SHEET 1 OF 4 )

PACKAGE: I CIVIL AND ARCHITECTURAL WORK

SCALE: 1:100      DRAWING NO: AA - 020

NOTE:  
 REFER TO SPECIFICATIONS, SECTION:  
 FURNITURE, FOR LIST OF PRODUCT REFERENCE  
 DESIGNATIONS.

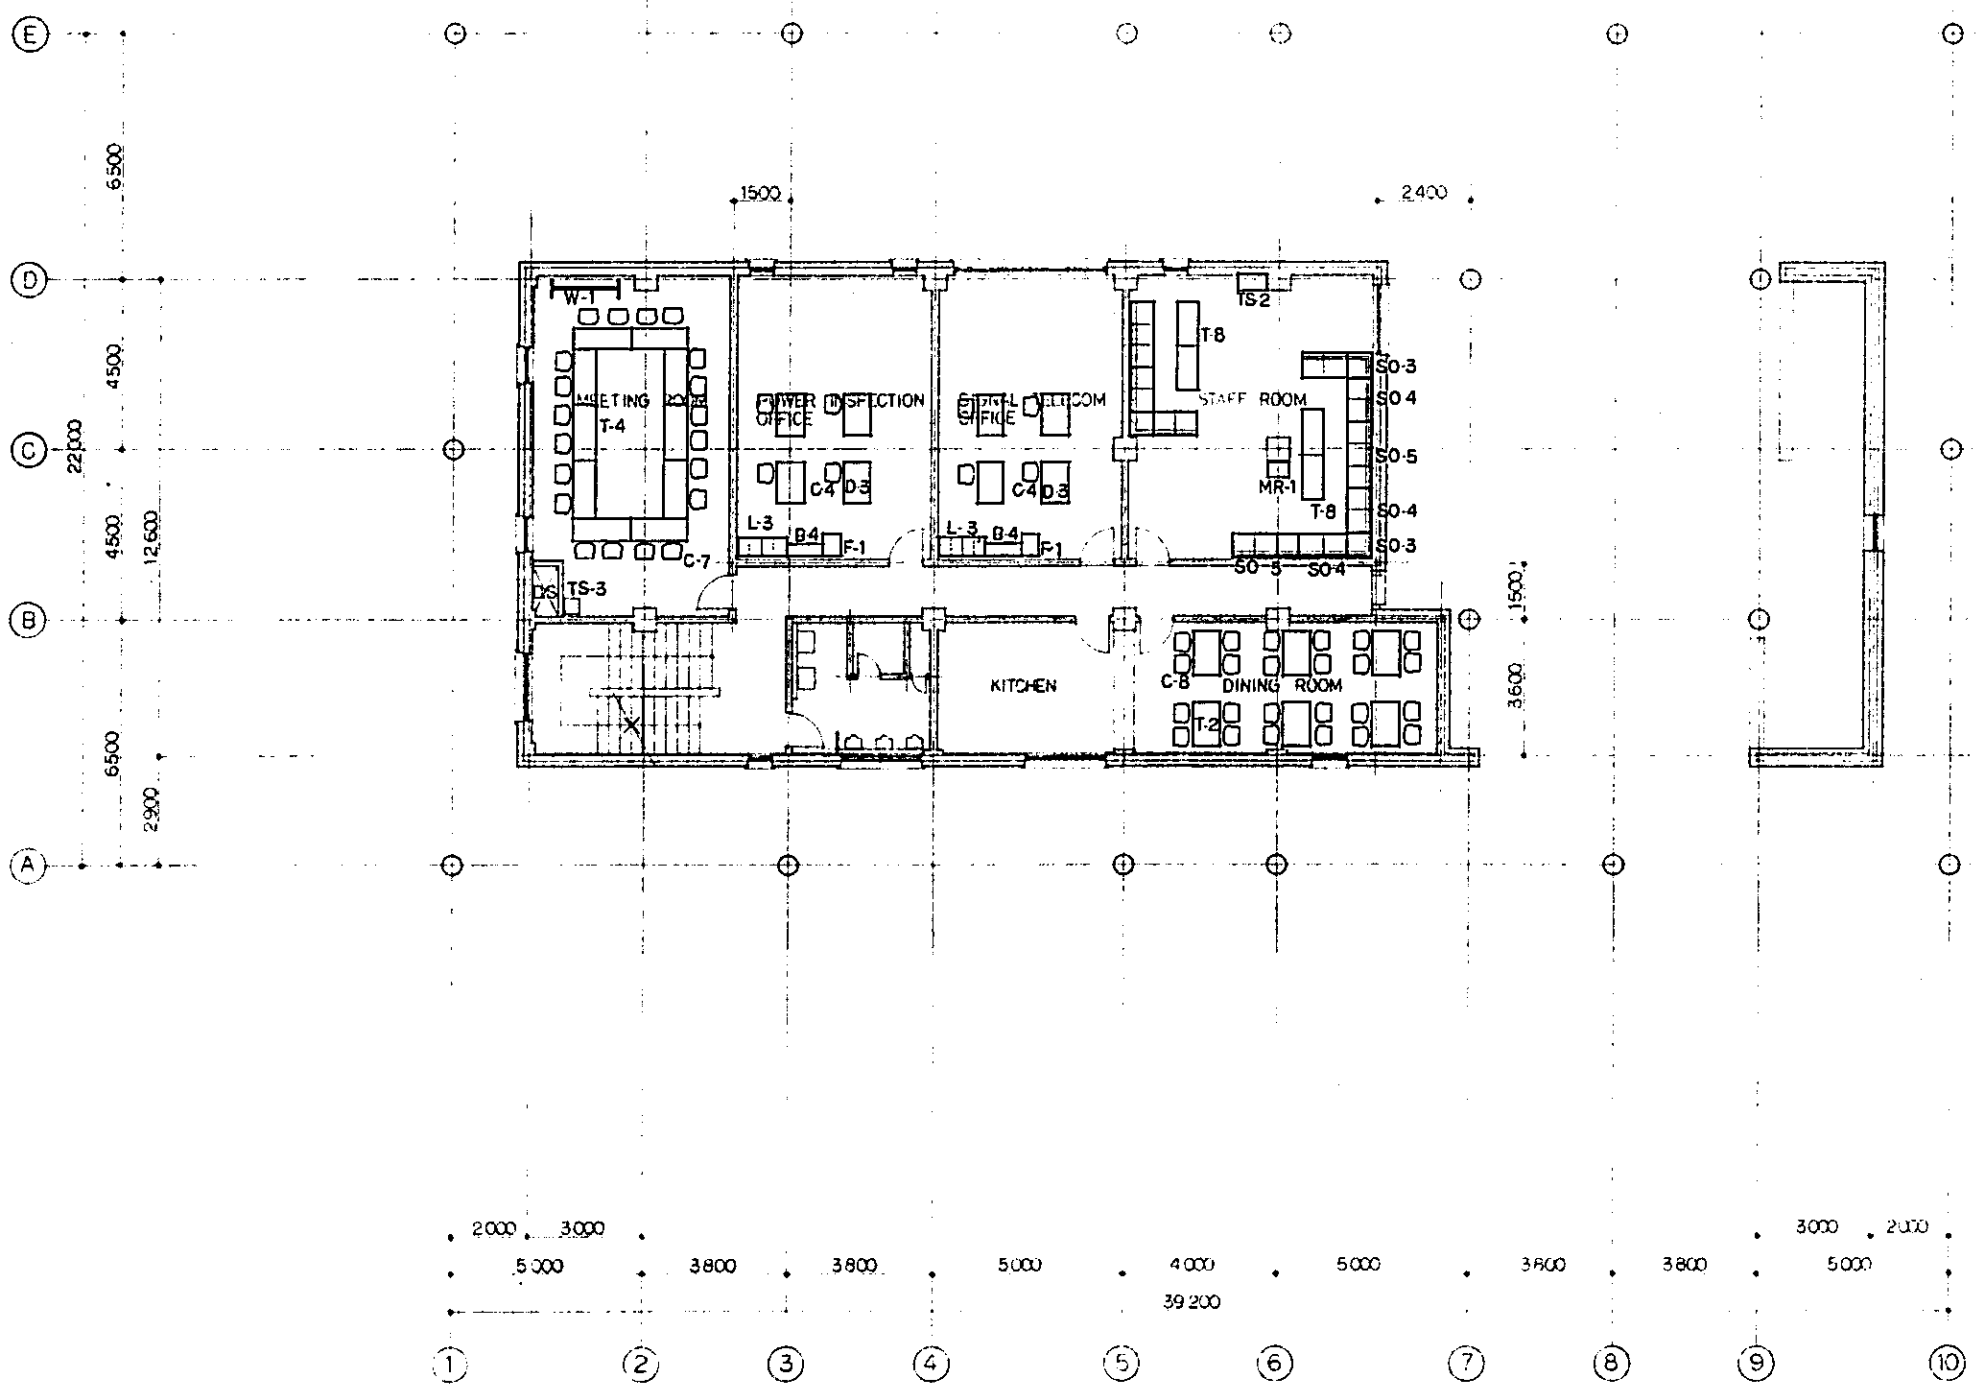

REPUBLIC OF INDONESIA  
 MINISTRY OF COMMUNICATIONS  
 DIRECTORATE GENERAL OF LAND TRANSPORT  
 AND INLAND WATERWAYS

NEW RAILWAY LINE FOR CENGKARENG AIRPORT  
 CONSTRUCTION PROJECT

JAPAN INTERNATIONAL COOPERATION AGENCY  
 (JICA)


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|-----------|-----------|----------|-------|---------|----------|-----------|
| B         | 1 AUG 89  | Randy    | Randy | Randy   | Randy    | Randy     |
| A         | 15 FEB 89 | Randy    | Randy | Randy   | Randy    | Randy     |
| REVISIONS | DATE      | DESIGNED | DRAWN | CHECKED | REVIEWED | SUBMITTED |

AIRPORT TERMINAL STATION  
 FURNITURE LAYOUT PLAN  
 ( SHEET 2 OF 4 )

|   |                      |
|---|----------------------|
| PACKAGE: I - CIVIL AND ARCHITECTURAL WORK | DRAWING NO: AA - 021 |
| SCALE: 1:100                              |                      |



NOTE:  
 REFER TO SPECIFICATIONS, SECTION  
 FURNITURE FOR LIST OF PRODUCT REFERENCE  
 DESIGNATIONS

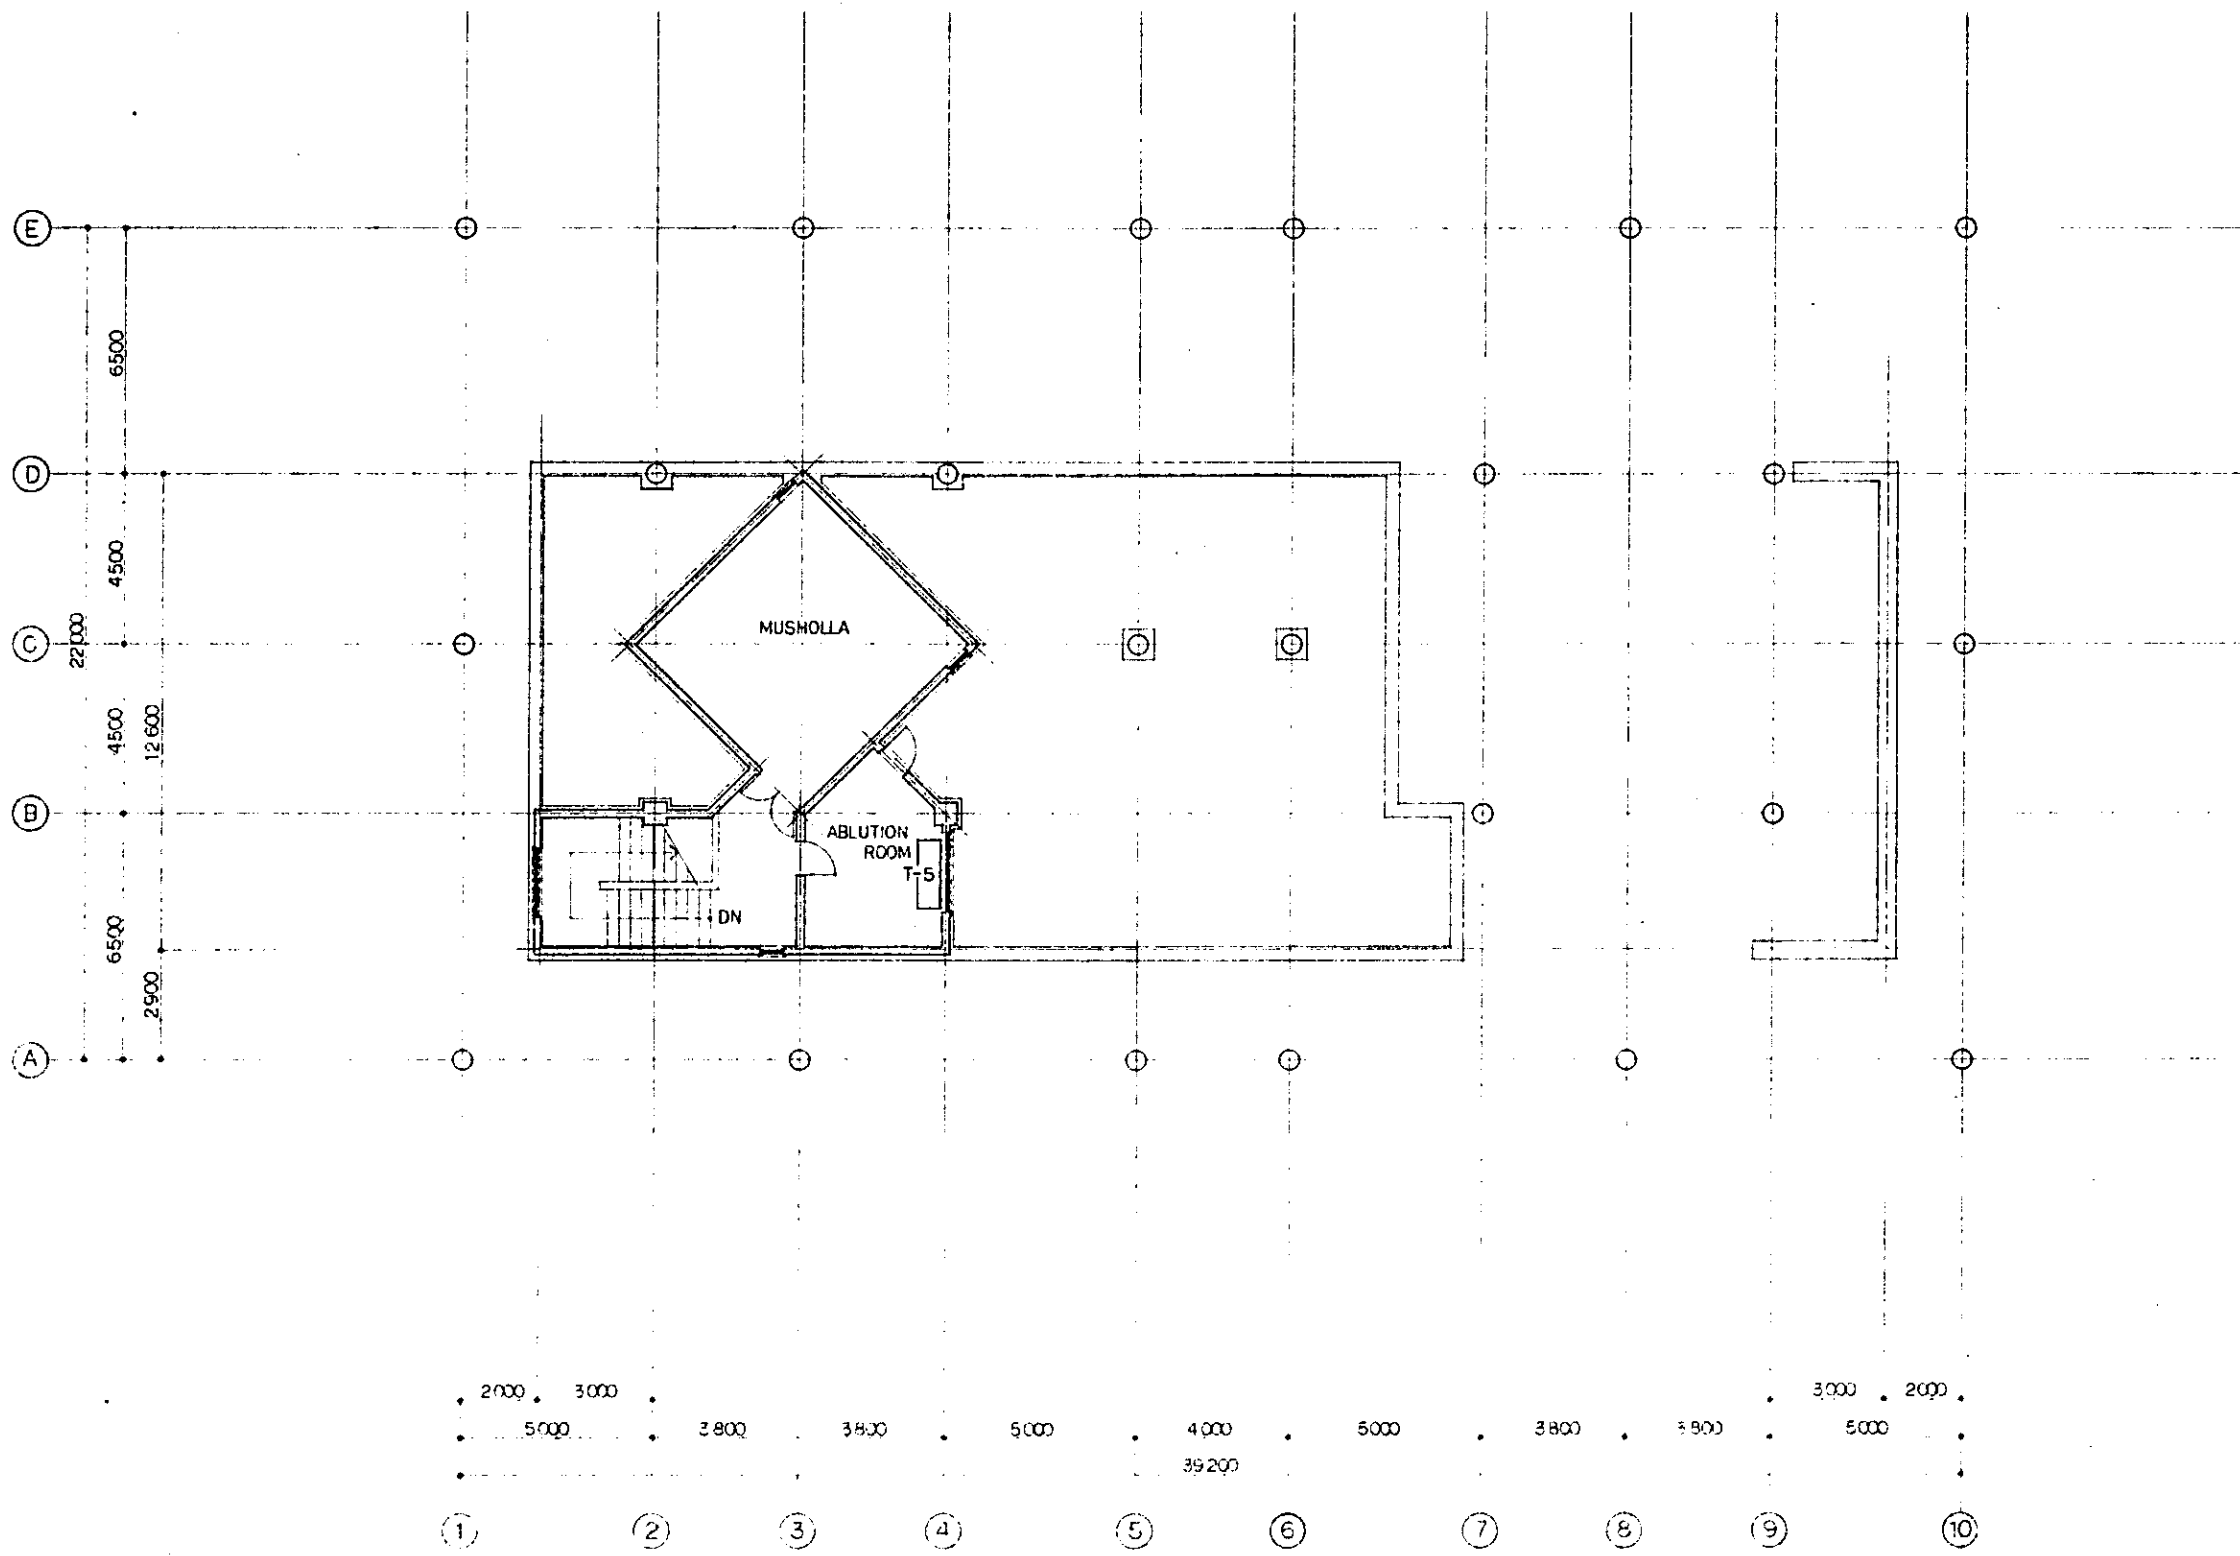

REPUBLIC OF INDONESIA  
 MINISTRY OF COMMUNICATIONS  
 DIRECTORATE GENERAL OF LAND TRANSPORT  
 AND INLAND WATERWAYS

NEW RAILWAY LINE FOR CENGKARENG AIRPORT  
 CONSTRUCTION PROJECT


JAPAN INTERNATIONAL COOPERATION AGENCY  
 (JICA)

|           |            |             |             |             |             |             |
|-----------|------------|-------------|-------------|-------------|-------------|-------------|
| REVISIONS | DATE       | DESIGNED    | DRAWN       | CHECKED     | REVIEWED    | SUBMITTED   |
| B         | 1.04.2011  | [Signature] | [Signature] | [Signature] | [Signature] | [Signature] |
| A         | 08.02.2011 | [Signature] | [Signature] | [Signature] | [Signature] | [Signature] |

AIRPORT TERMINAL STATION  
 FURNITURE LAYOUT PLAN  
 ( SHEET 3 OF 4 )

PACKAGE: I CIVIL AND ARCHITECTURAL WORK  
 SCALE: 1:100  
 DRAWING NO: AA - 022

NOTE: REFER TO SPECIFICATIONS, SECTION 1  
 FURNITURE (FOR LIST OF PRODUCT REFERENCE  
 DESIGNATIONS)

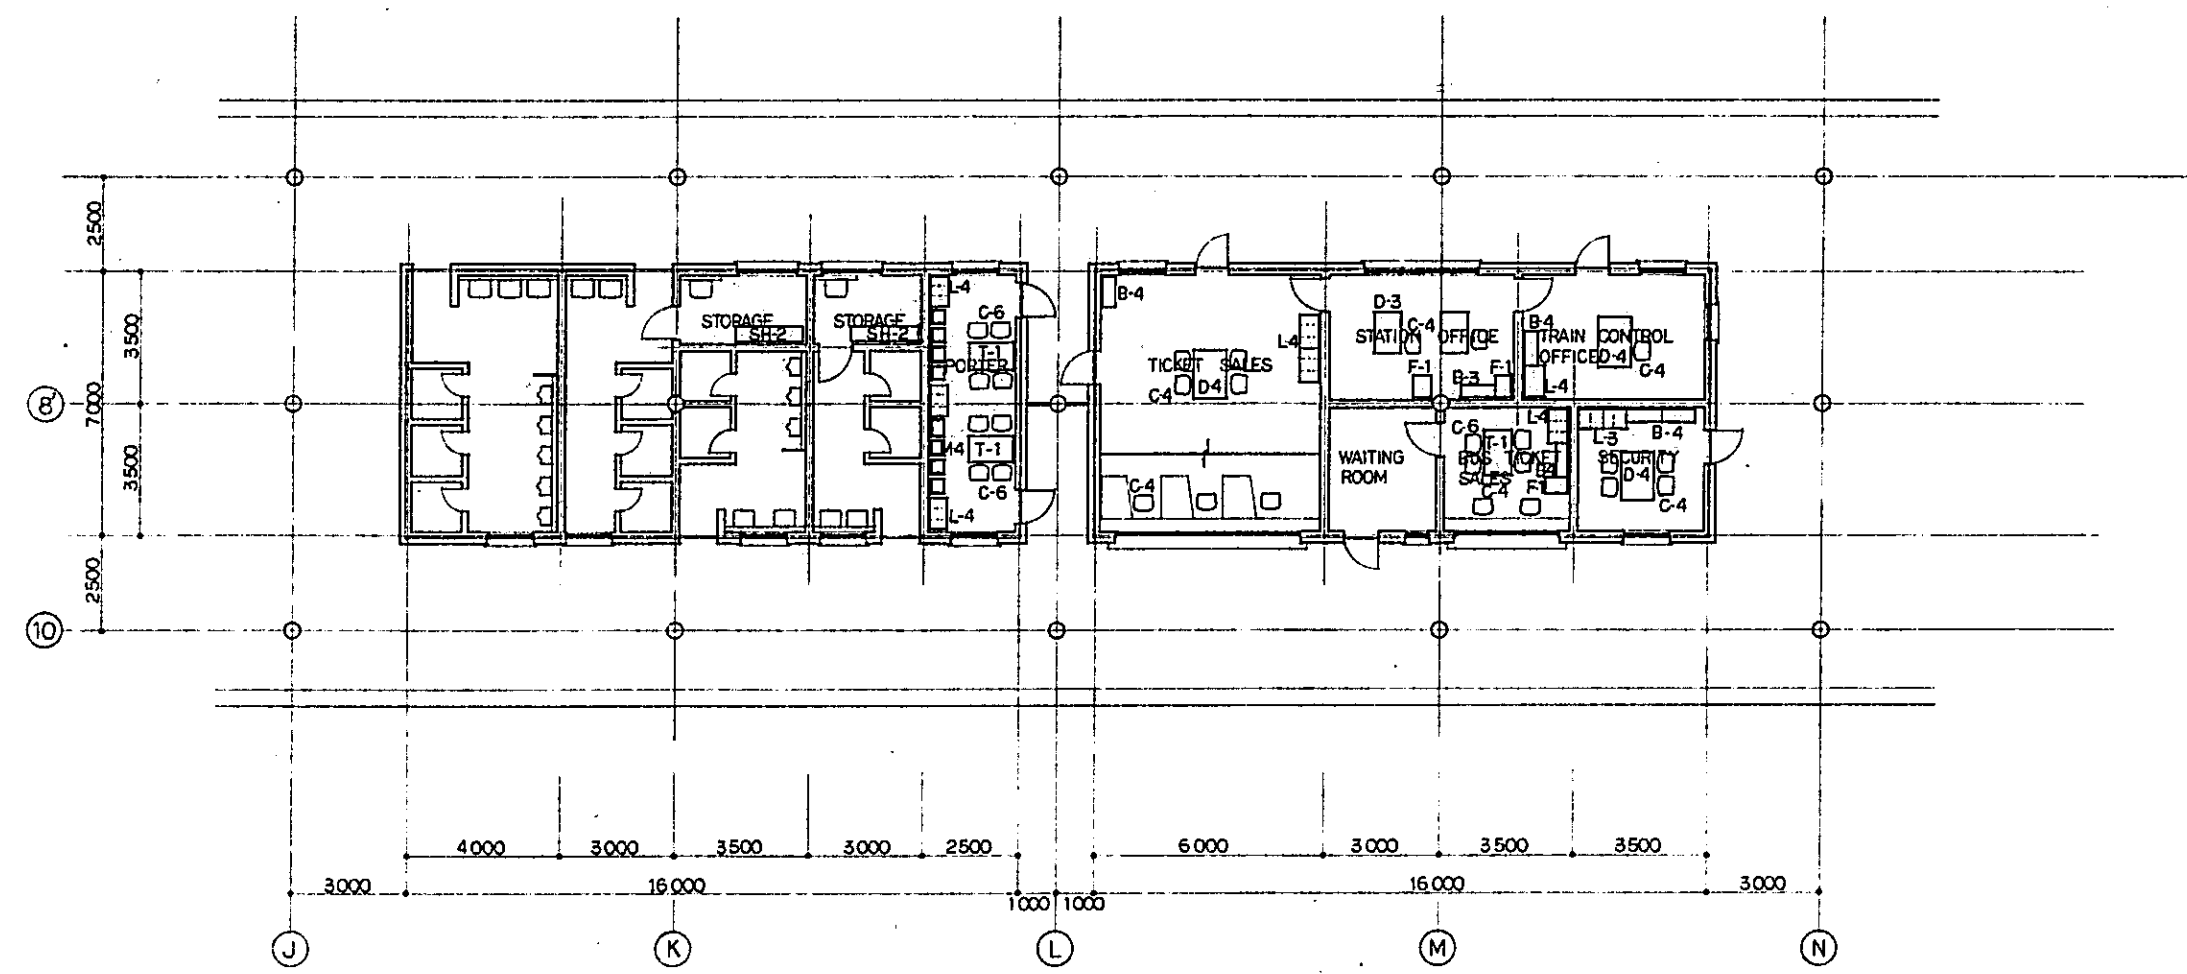

REPUBLIC OF INDONESIA  
 MINISTRY OF COMMUNICATIONS  
 DIRECTORATE GENERAL OF LAND TRANSPORT  
 AND INLAND WATERWAYS

NEW RAILWAY LINE FOR CENGKARENG AIRPORT  
 CONSTRUCTION PROJECT

JAPAN INTERNATIONAL COOPERATION AGENCY  
 (JICA)



|   |            |      |      |      |     |     |
|---|------------|------|------|------|-----|-----|
| B | 1 AUG. 87  | Suph | Suph | Suph | K.M | M.K |
| A | 15 FEB. 87 | Suph | Suph | Suph | K.M | M.K |

REVISIONS    DATE    DESIGNED    CHECKED    APPROVED    SUBMITTED

AIRPORT TERMINAL STATION  
 FURNITURE LAYOUT PLAN  
 ( SHEET 4 OF 4 )

PACKAGE: I. CIVIL AND ARCHITECTURAL WORK



SCALE: 1:100    DRAWING NO.: AA - 023

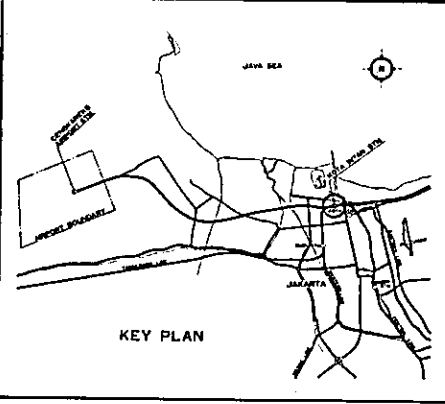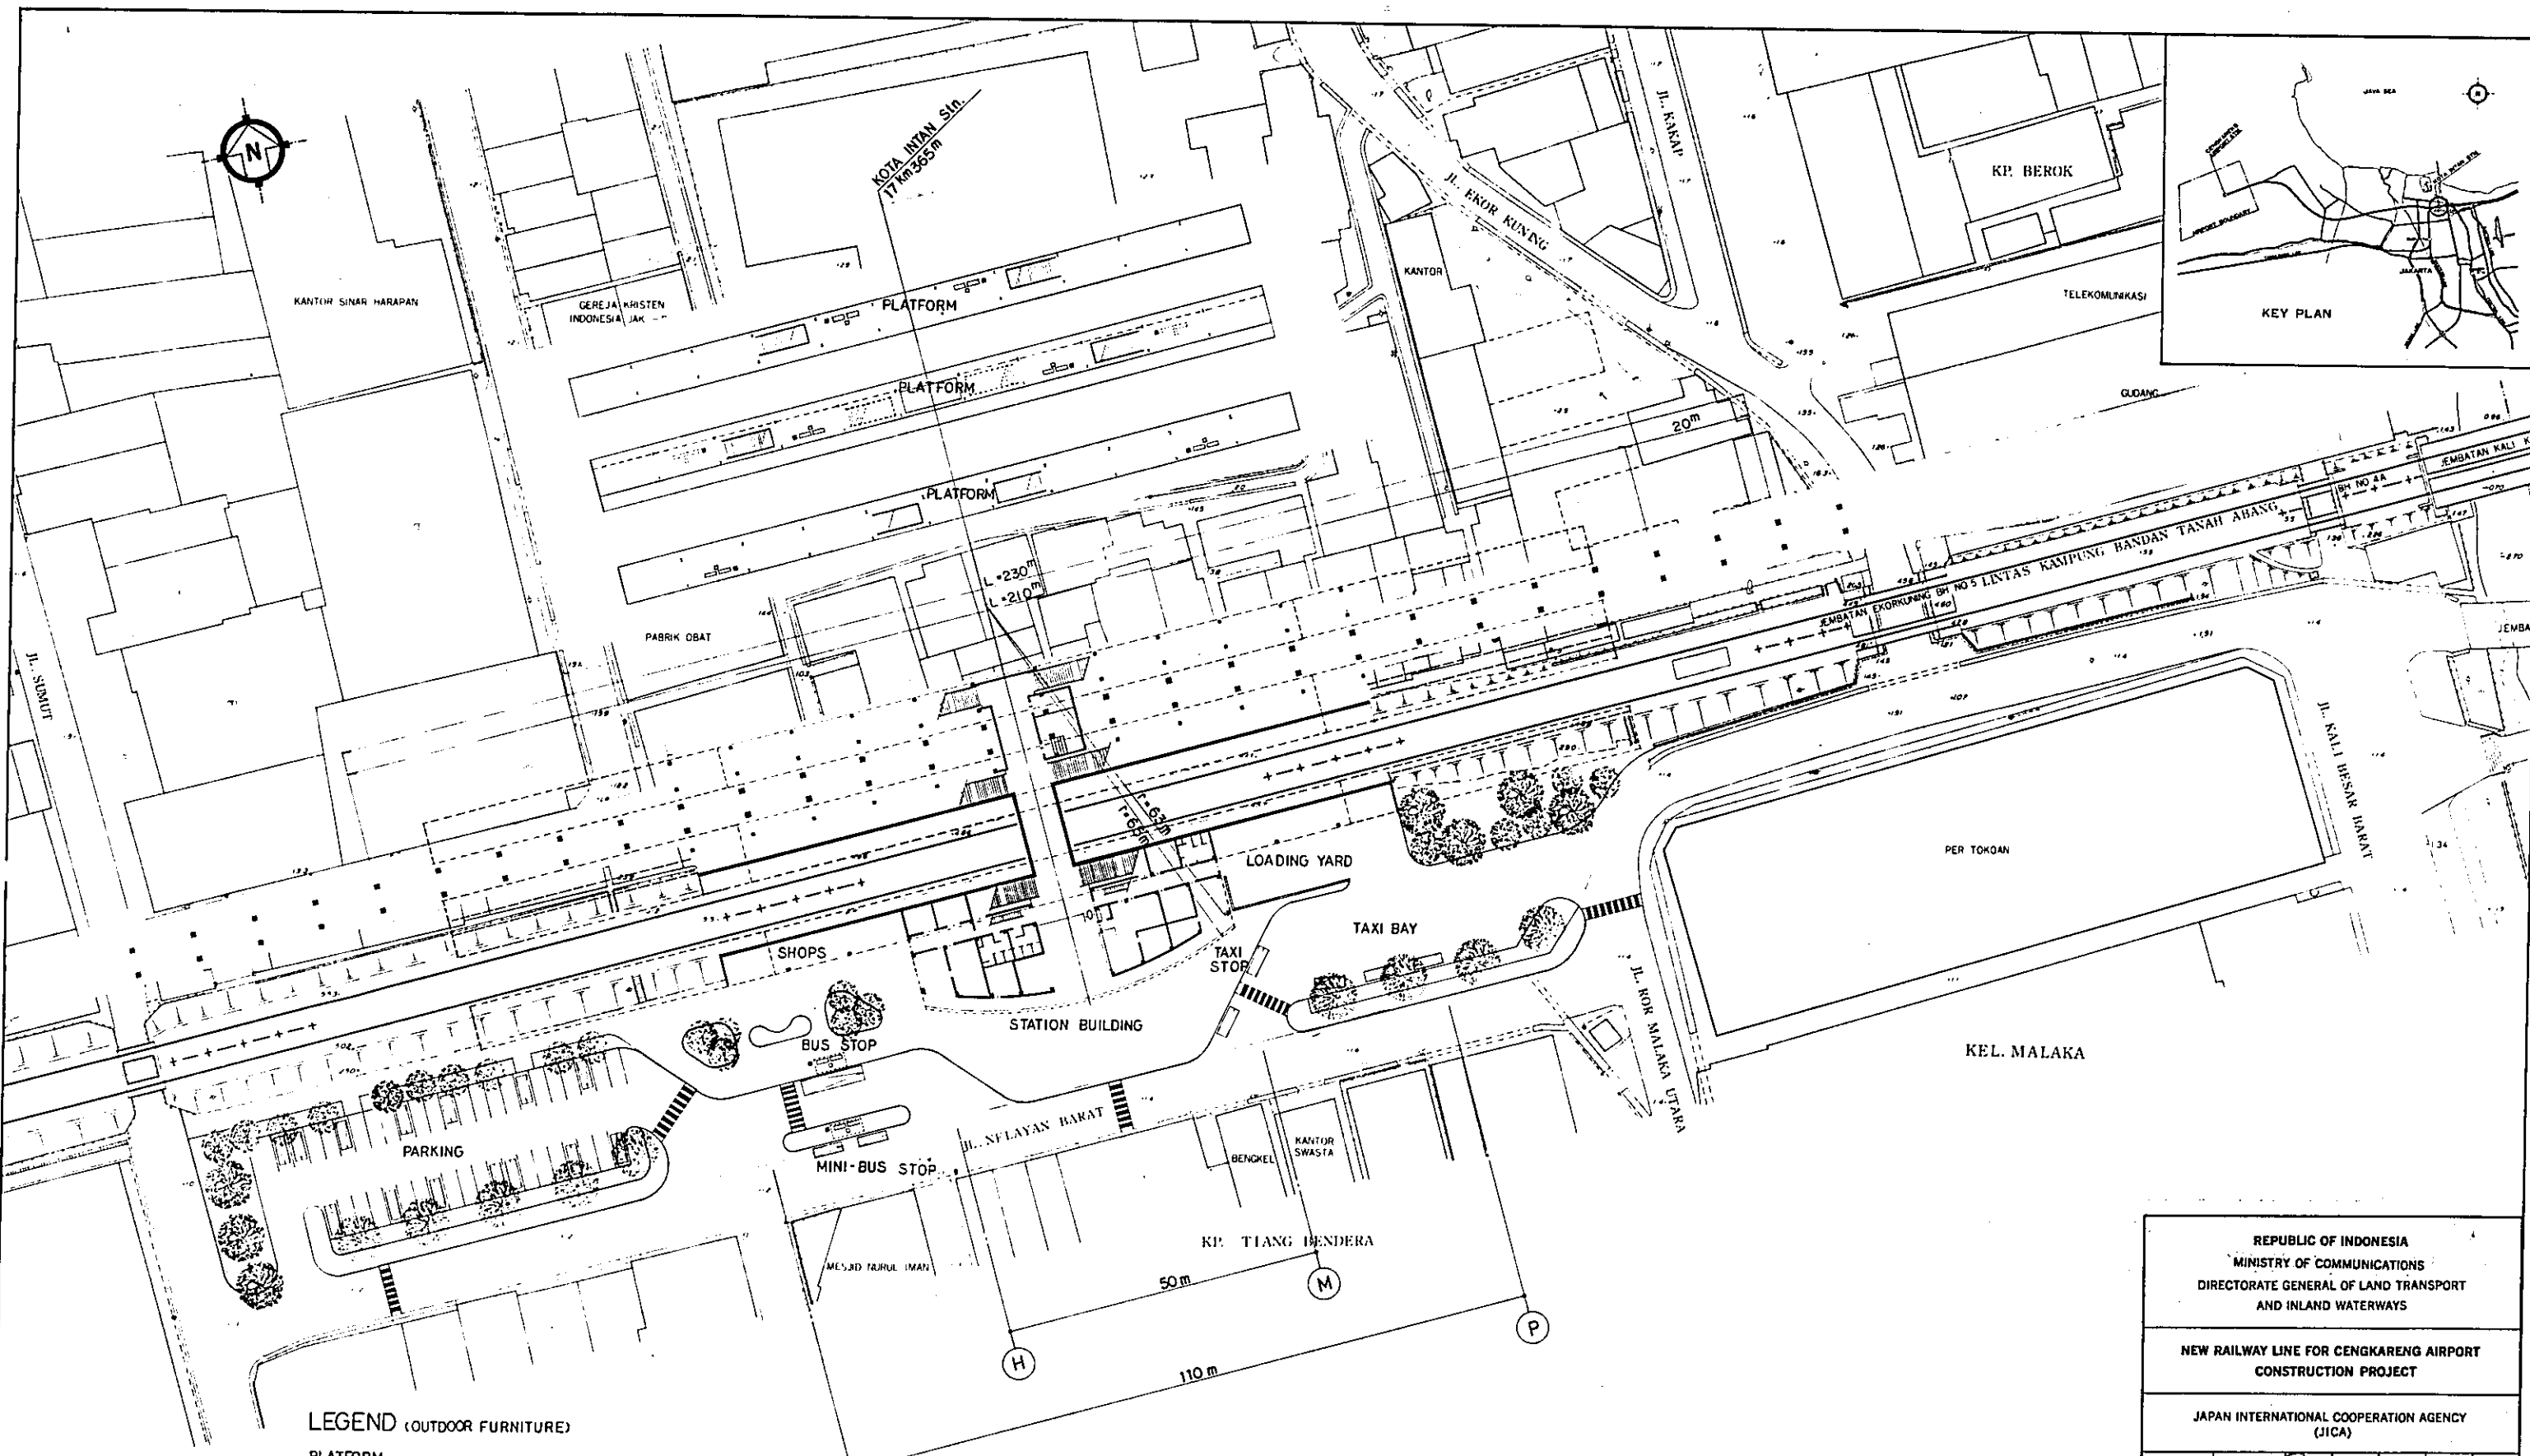



- LEGEND (OUTDOOR FURNITURE)**
- PLATFORM**
- ▭ BENCH TYPE C (FRP) 16 sets
  - SMOKING STAND TYPE B 8 sets
  - WASTEBASKET TYPE B 8 sets
- BUS STOP**
- ▭ BENCH TYPE C (FRP) 4 sets
  - SMOKING STAND TYPE B 2 sets
  - WASTEBASKET TYPE B 2 sets

**SITE PLAN**  
SCALE 1:500

|  |           |          |                      |         |          |
|--|-----------|----------|----------------------|---------|----------|
| REPUBLIC OF INDONESIA<br>MINISTRY OF COMMUNICATIONS<br>DIRECTORATE GENERAL OF LAND TRANSPORT<br>AND INLAND WATERWAYS |           |          |                      |         |          |
| NEW RAILWAY LINE FOR CENGKARENG AIRPORT<br>CONSTRUCTION PROJECT  |           |          |                      |         |          |
| JAPAN INTERNATIONAL COOPERATION AGENCY<br>(JICA)   |           |          |                      |         |          |
| B  | 1 AUG 88  | Semb     | Semb                 | I.M     | K.M      |
| A  | 15 FEB 88 | Semb     | Semb                 | Semb    | K.M      |
| REVISIONS  | DATE      | DESIGNED | DRAWN                | CHECKED | REVIEWED |
| <b>KOTA INTAN STATION</b><br><b>SITE PLAN</b>  |           |          |                      |         |          |
| PACKAGE: I CIVIL AND ARCHITECTURAL WORK  |           |          |                      |         |          |
| SCALE: 1:500   |           |          | DRAWING NO: AA - 024 |         |          |

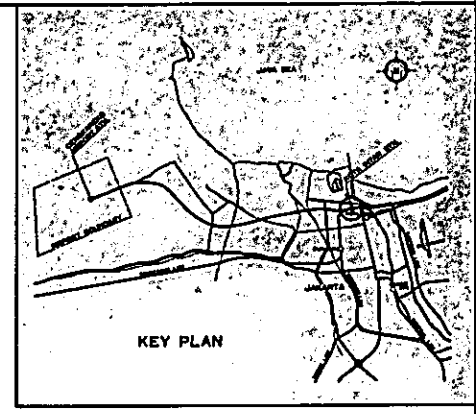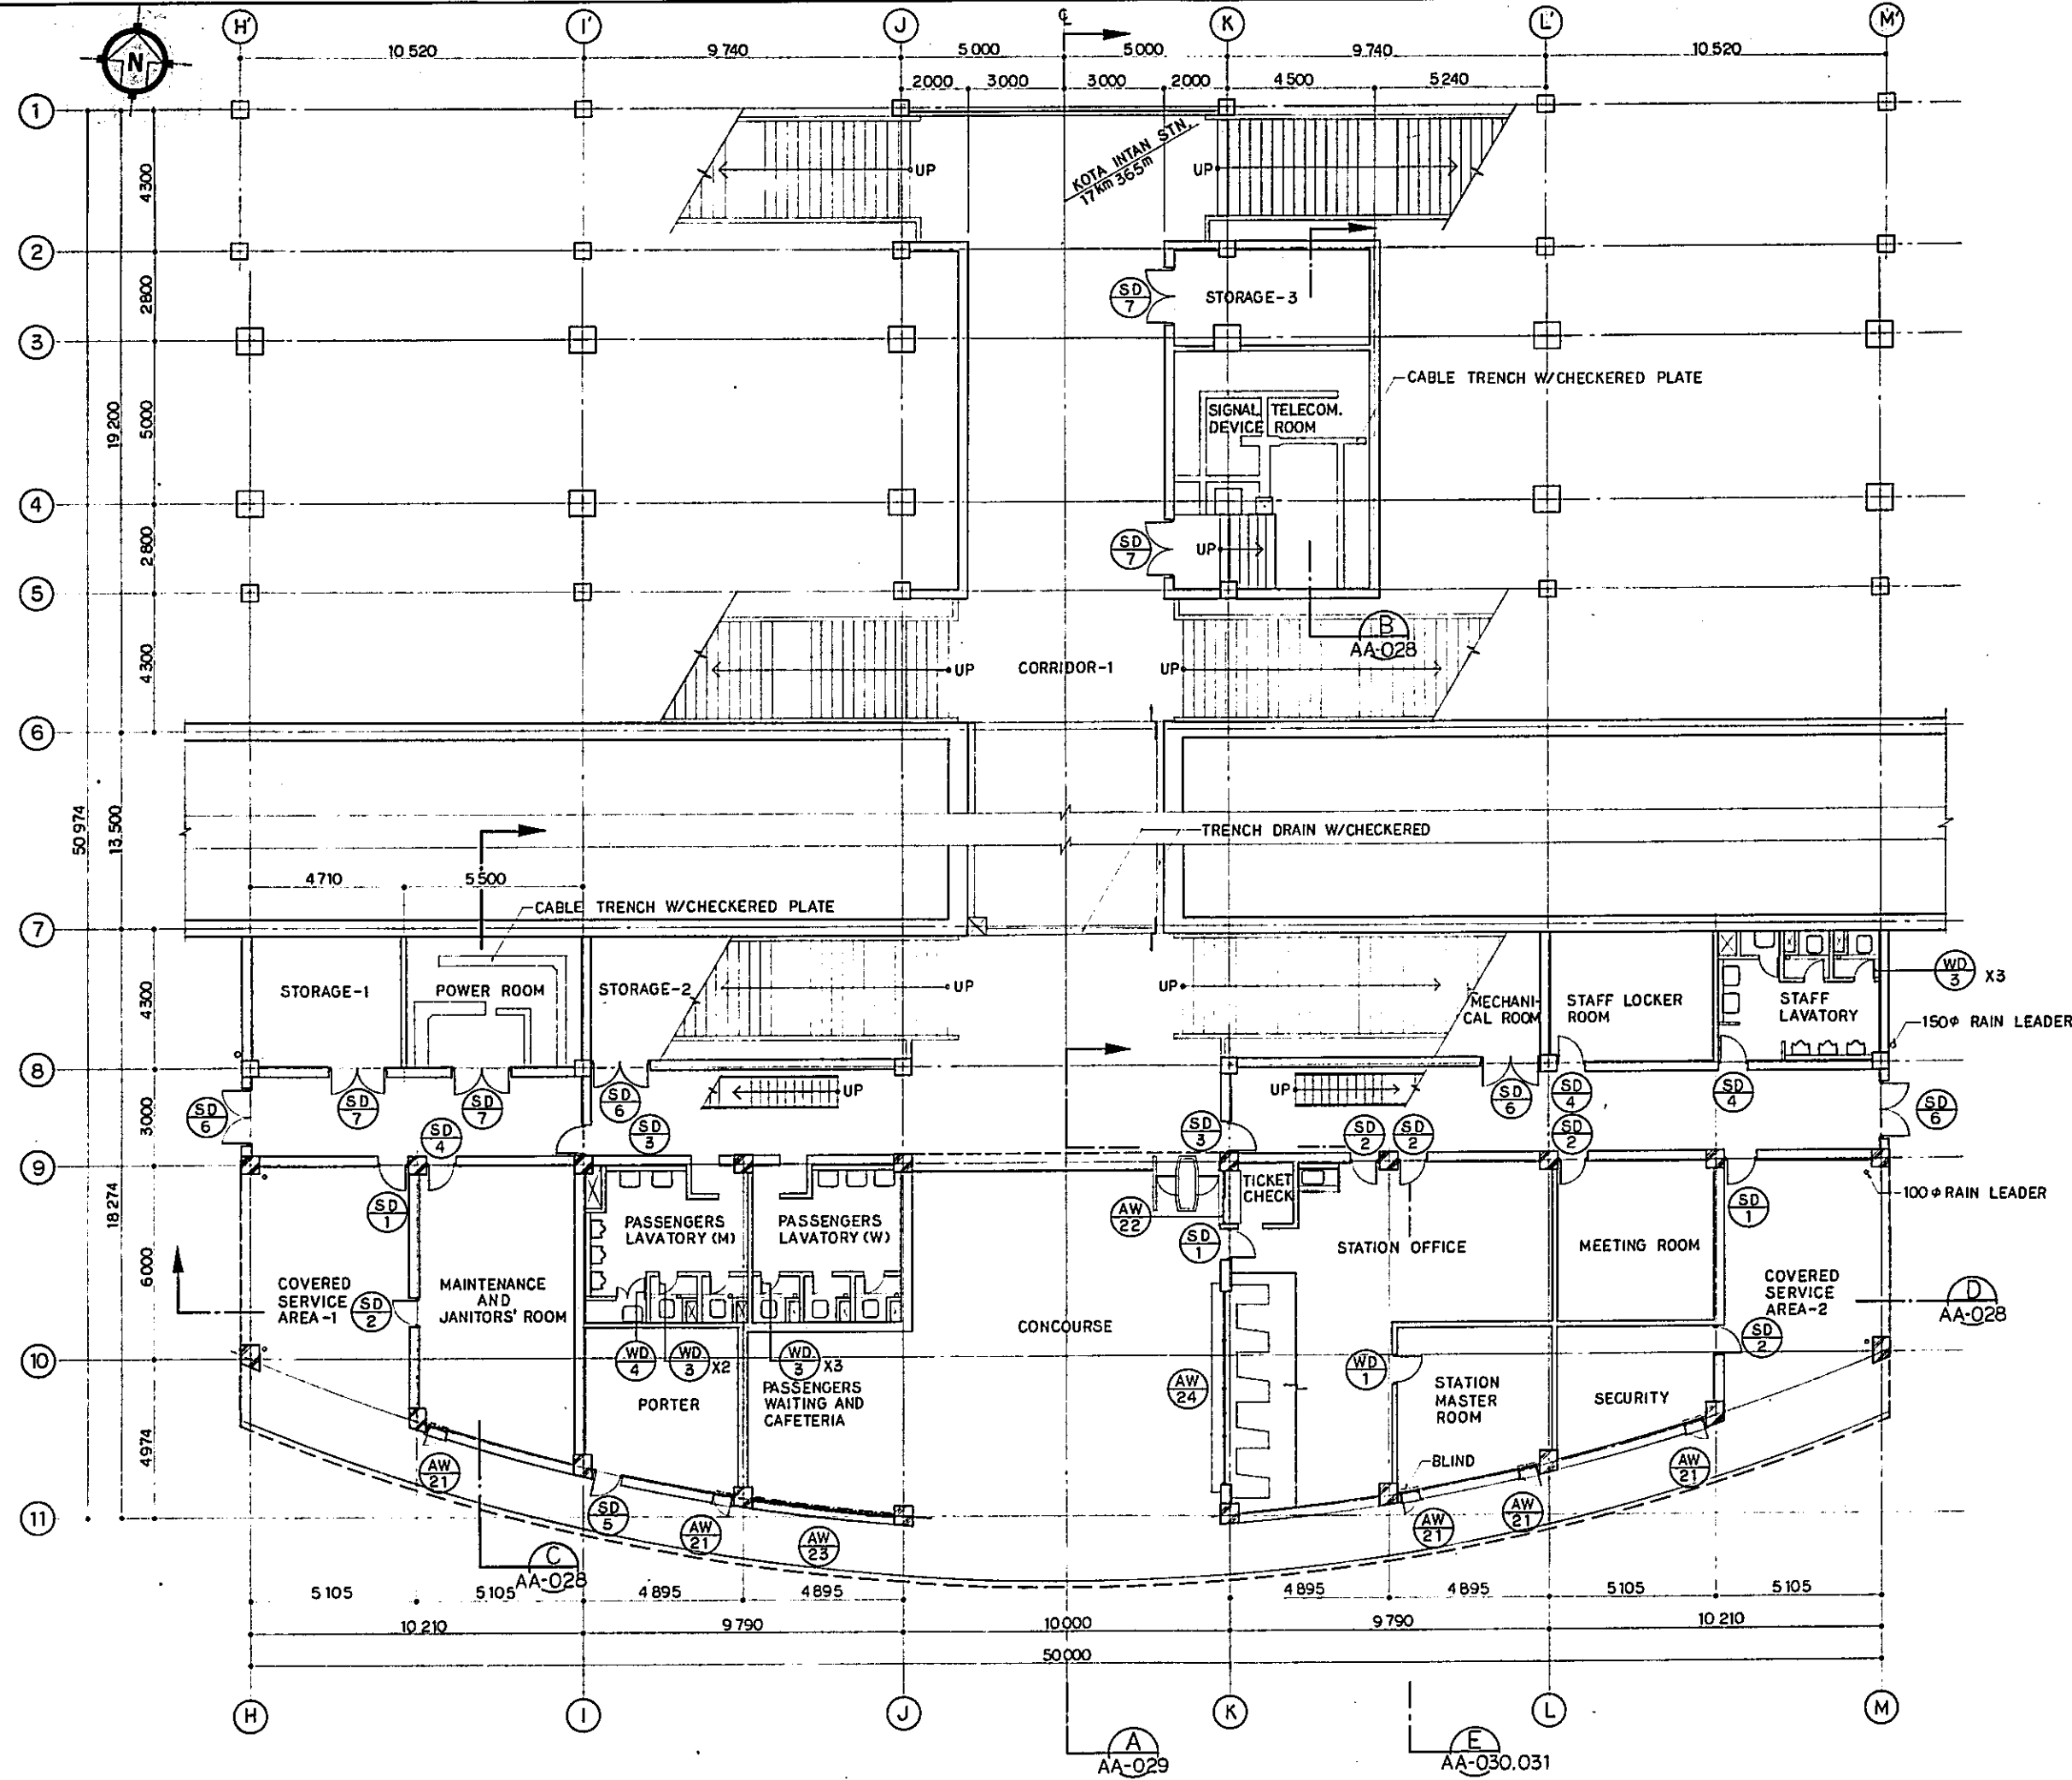

|  |            |                    |       |         |          |
|--|------------|--------------------|-------|---------|----------|
| REPUBLIC OF INDONESIA<br>MINISTRY OF COMMUNICATIONS<br>DIRECTORATE GENERAL OF LAND TRANSPORT<br>AND INLAND WATERWAYS |            |                    |       |         |          |
| NEW RAILWAY LINE FOR CENGKARENG AIRPORT<br>CONSTRUCTION PROJECT  |            |                    |       |         |          |
| JAPAN INTERNATIONAL COOPERATION AGENCY<br>(JICA)   |            |                    |       |         |          |
| REVISIONS  | DATE       | DESIGNED           | DRAWN | CHECKED | REVIEWED |
| B  | 1 AUG. 89  | Sumi               | T.J   | Sumi    | K.M. mil |
| A  | 15 FEB. 89 | Sumi               | T.J   | Sumi    | K.M. mil |
| <b>KOTA INTAN STATION</b><br><b>IF PLAN</b>  |            |                    |       |         |          |
| PACKAGE: I CIVIL AND ARCHITECTURAL WORK  |            |                    |       |         |          |
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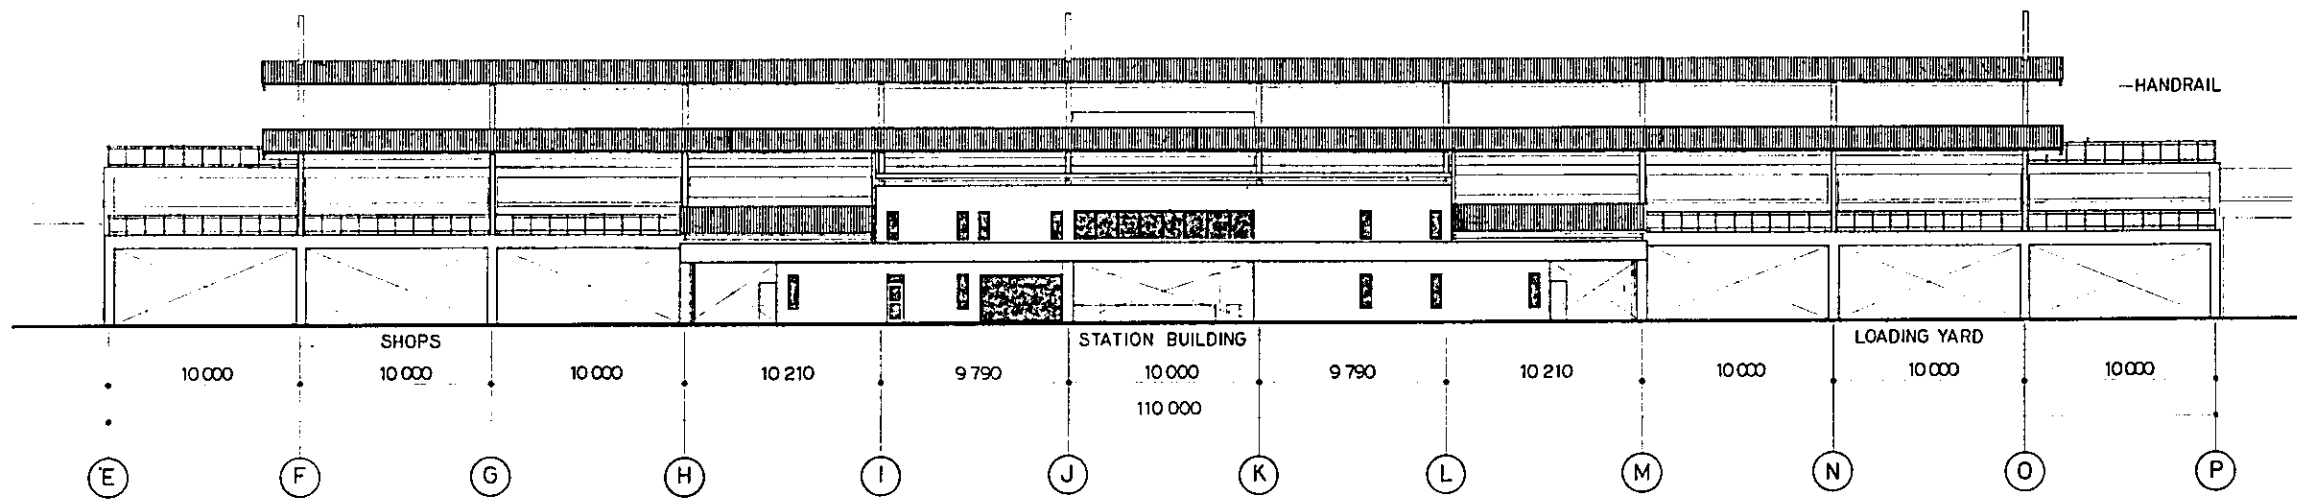

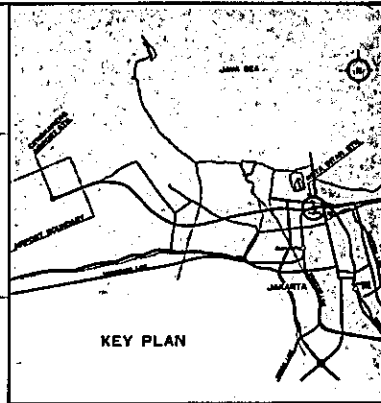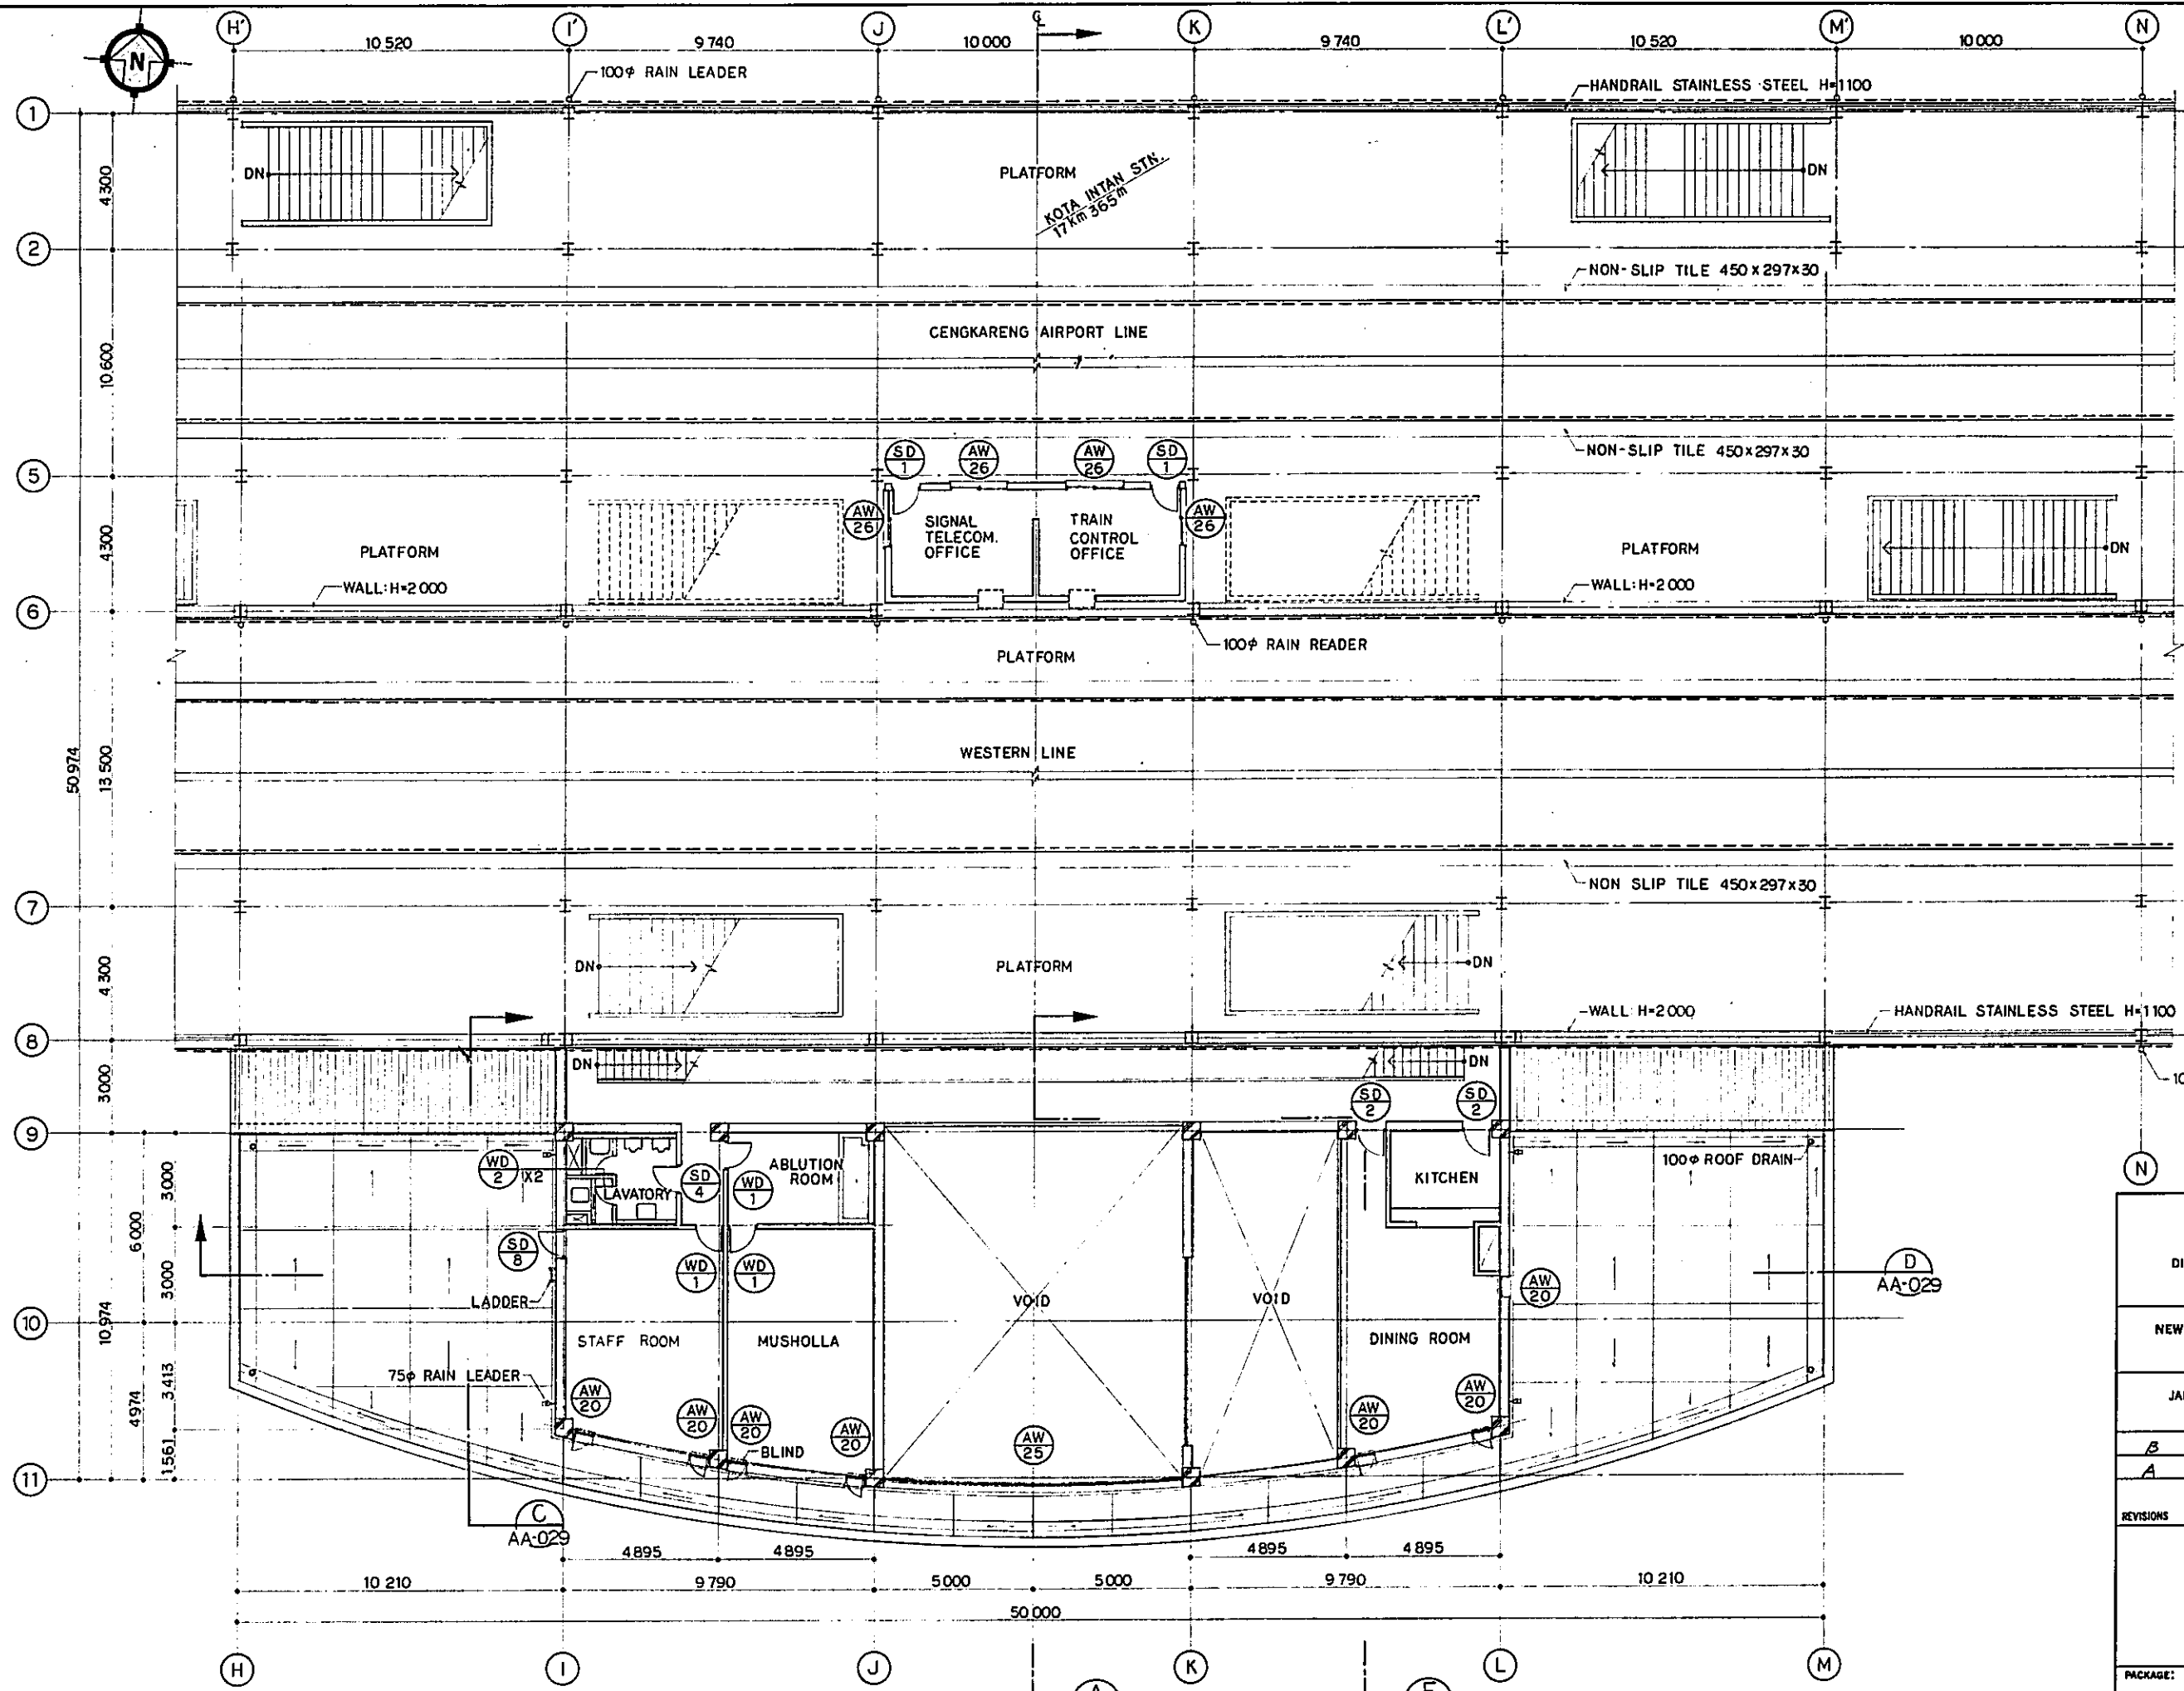
|  |            |                    |       |         |          |           |
|--|------------|--------------------|-------|---------|----------|-----------|
| REPUBLIC OF INDONESIA<br>MINISTRY OF COMMUNICATIONS<br>DIRECTORATE GENERAL OF LAND TRANSPORT<br>AND INLAND WATERWAYS |            |                    |       |         |          |           |
| NEW RAILWAY LINE FOR CENKARENG AIRPORT<br>CONSTRUCTION PROJECT   |            |                    |       |         |          |           |
| JAPAN INTERNATIONAL COOPERATION AGENCY<br>(JICA)   |            |                    |       |         |          |           |
| B  | 1 AUG. 89  | 2                  | 2     | 2       | K.M.     | M.K.      |
| A  | 15 FEB. 89 | 2                  | 2     | 2       | K.M.     | M.K.      |
| REVISIONS  | DATE       | DESIGNED           | DRAWN | CHECKED | REVIEWED | SUBMITTED |
| KOTA INTAN STATION<br>2F PLAN  |            |                    |       |         |          |           |
| PACKAGE: I CIVIL AND ARCHITECTURAL WORK  |            |                    |       |         |          |           |
| SCALE: 1:100   |            | DRAWING NO: AA-026 |       |         |          |           |

AA-029


AA-030.031

— ROOF: CORRUGATED ASBESTOS CEMENT SHEET




SOUTH ELEVATION  
SCALE 1:200

EXTERIOR WALL FINISH:  
SPRAYED ACRYLIC RESIN COATING

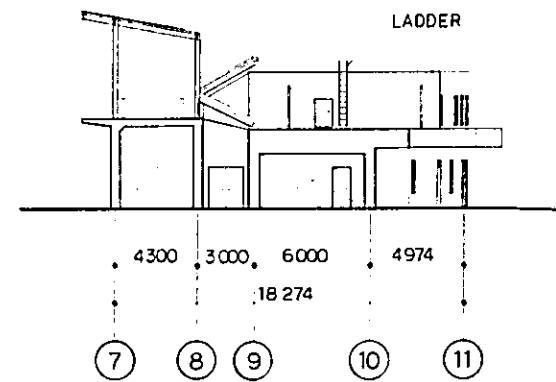


WEST ELEVATION  
SCALE 1:200

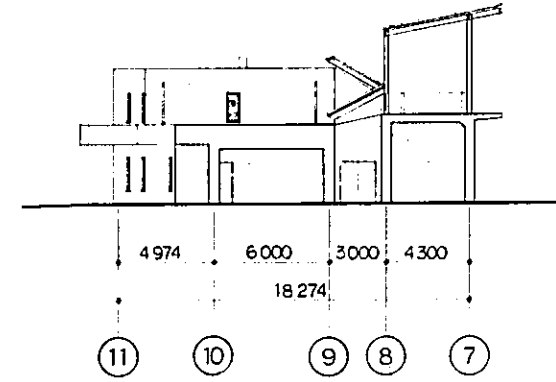

EAST ELEVATION  
SCALE 1:200

|  |           |                         |       |         |          |
|--|-----------|-------------------------|-------|---------|----------|
| REPUBLIC OF INDONESIA<br>MINISTRY OF COMMUNICATIONS<br>DIRECTORATE GENERAL OF LAND TRANSPORT<br>AND INLAND WATERWAYS |           |                         |       |         |          |
| NEW RAILWAY LINE FOR CENGKARENG AIRPORT<br>CONSTRUCTION PROJECT  |           |                         |       |         |          |
| JAPAN INTERNATIONAL COOPERATION AGENCY<br>(JICA)   |           |                         |       |         |          |
| B  | 1 AUG 89  | TS                      | RJ    | PK      | K.M. / K |
| A  | 15 FEB 89 | TS                      | RJ    | PK      | K.M. / K |
| REVISIONS  | DATE      | DESIGNED                | DRAWN | CHECKED | REVIEWED |
| KOTA INTAN STATION<br>ELEVATIONS<br>( SHEET 1 OF 2 )   |           |                         |       |         |          |
| PACKAGE: I CIVIL AND ARCHITECTURAL WORK  |           |                         |       |         |          |
| SCALE<br>1:200   |           | DRAWING NO:<br>AA - 027 |       |         |          |

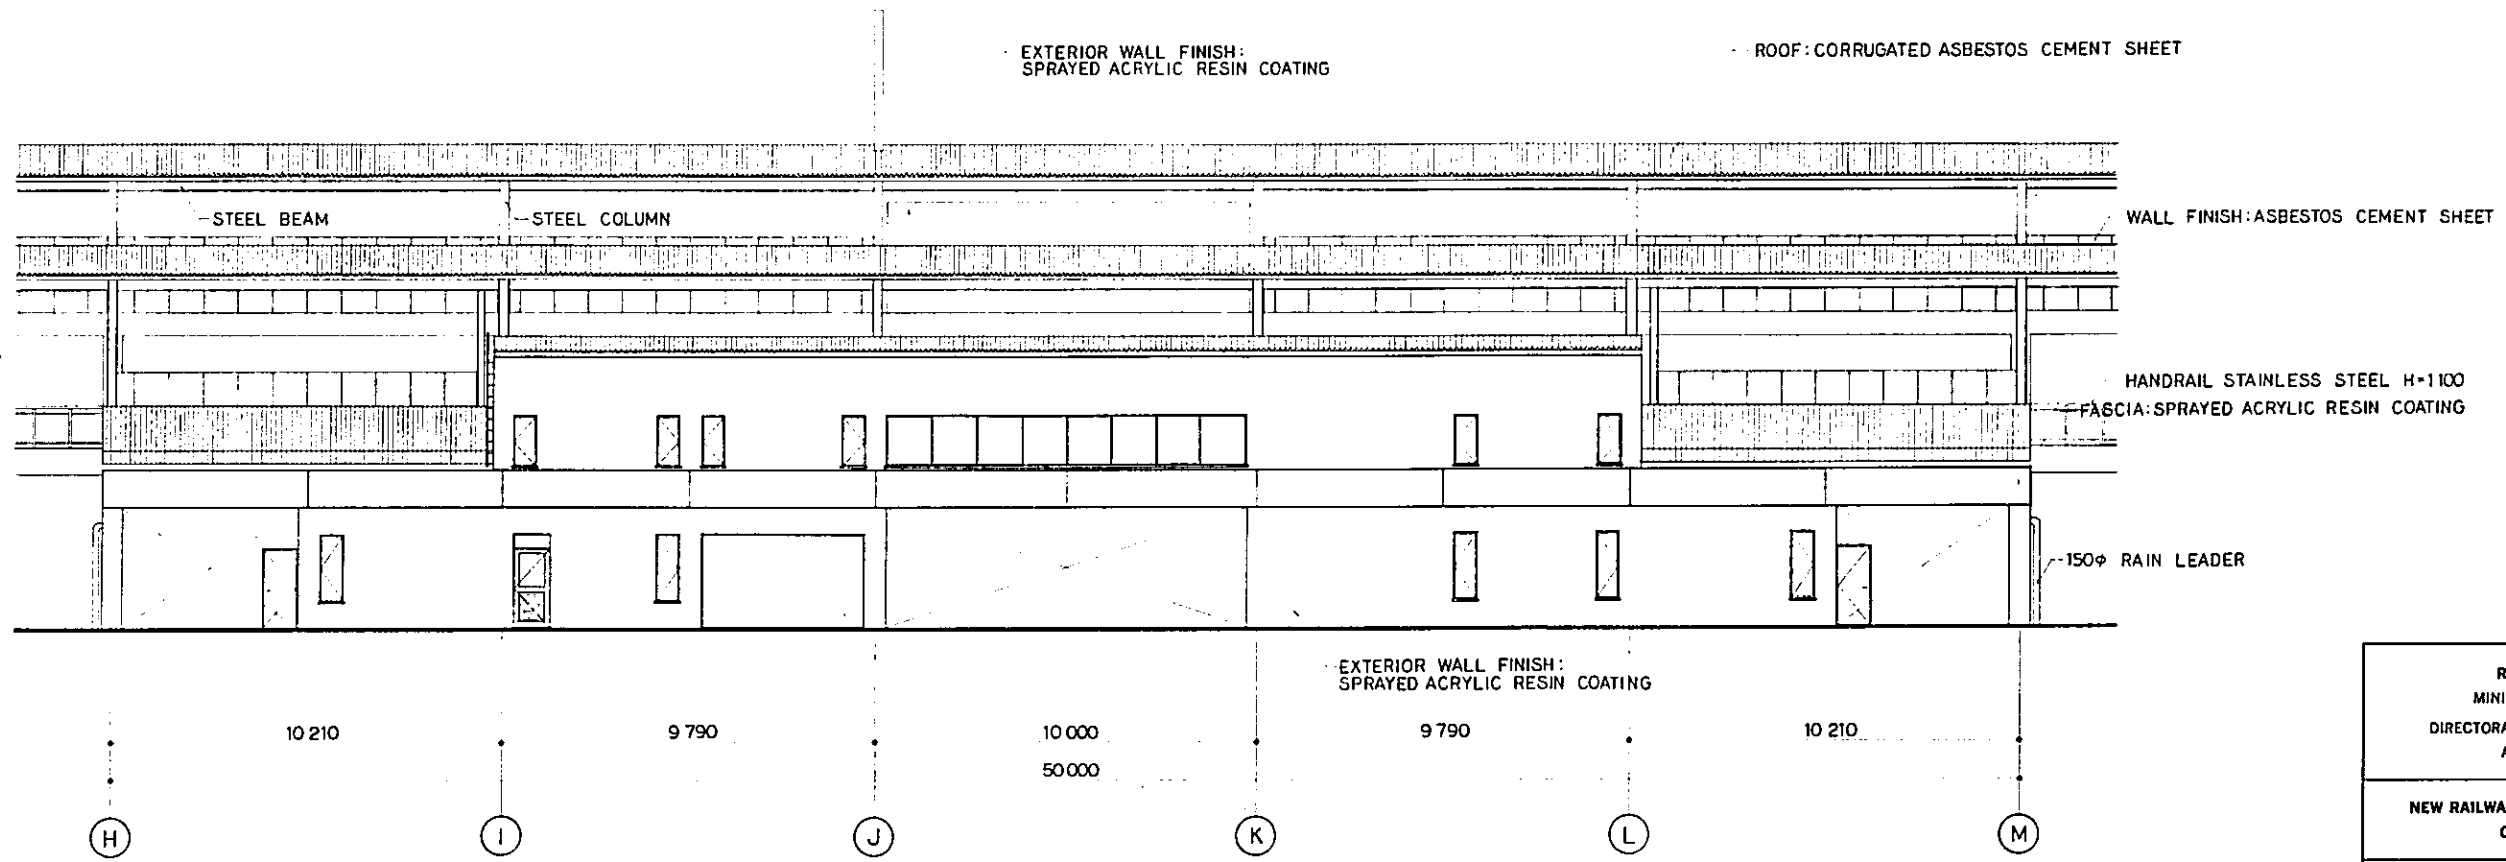

**SOUTH ELEVATION**  
SCALE 1:100

REPUBLIC OF INDONESIA  
MINISTRY OF COMMUNICATIONS  
DIRECTORATE GENERAL OF LAND TRANSPORT  
AND INLAND WATERWAYS

NEW RAILWAY LINE FOR CENGKARENG AIRPORT  
CONSTRUCTION PROJECT

JAPAN INTERNATIONAL COOPERATION AGENCY  
(JICA)


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|---|-----------|-------|-----|-------|-----|-----|
| B | 1 AUG 88  | Final | K.J | Final | K.M | M.K |
| A | 15 FEB 88 | Final | K.J | Final | K.M | M.K |

| REVISIONS | DATE | DESIGNED | DRAWN | CHECKED | REVIEWED | SUBMITTED |
|-----------|------|----------|-------|---------|----------|-----------|
|           |      |          |       |         |          |           |


KOTA INTAN STATION  
ELEVATIONS  
( SHEET 2 OF 2 )

PACKAGE: I CIVIL AND ARCHITECTURAL WORK


SCALE 1:100 DRAWING NO: AA - 028

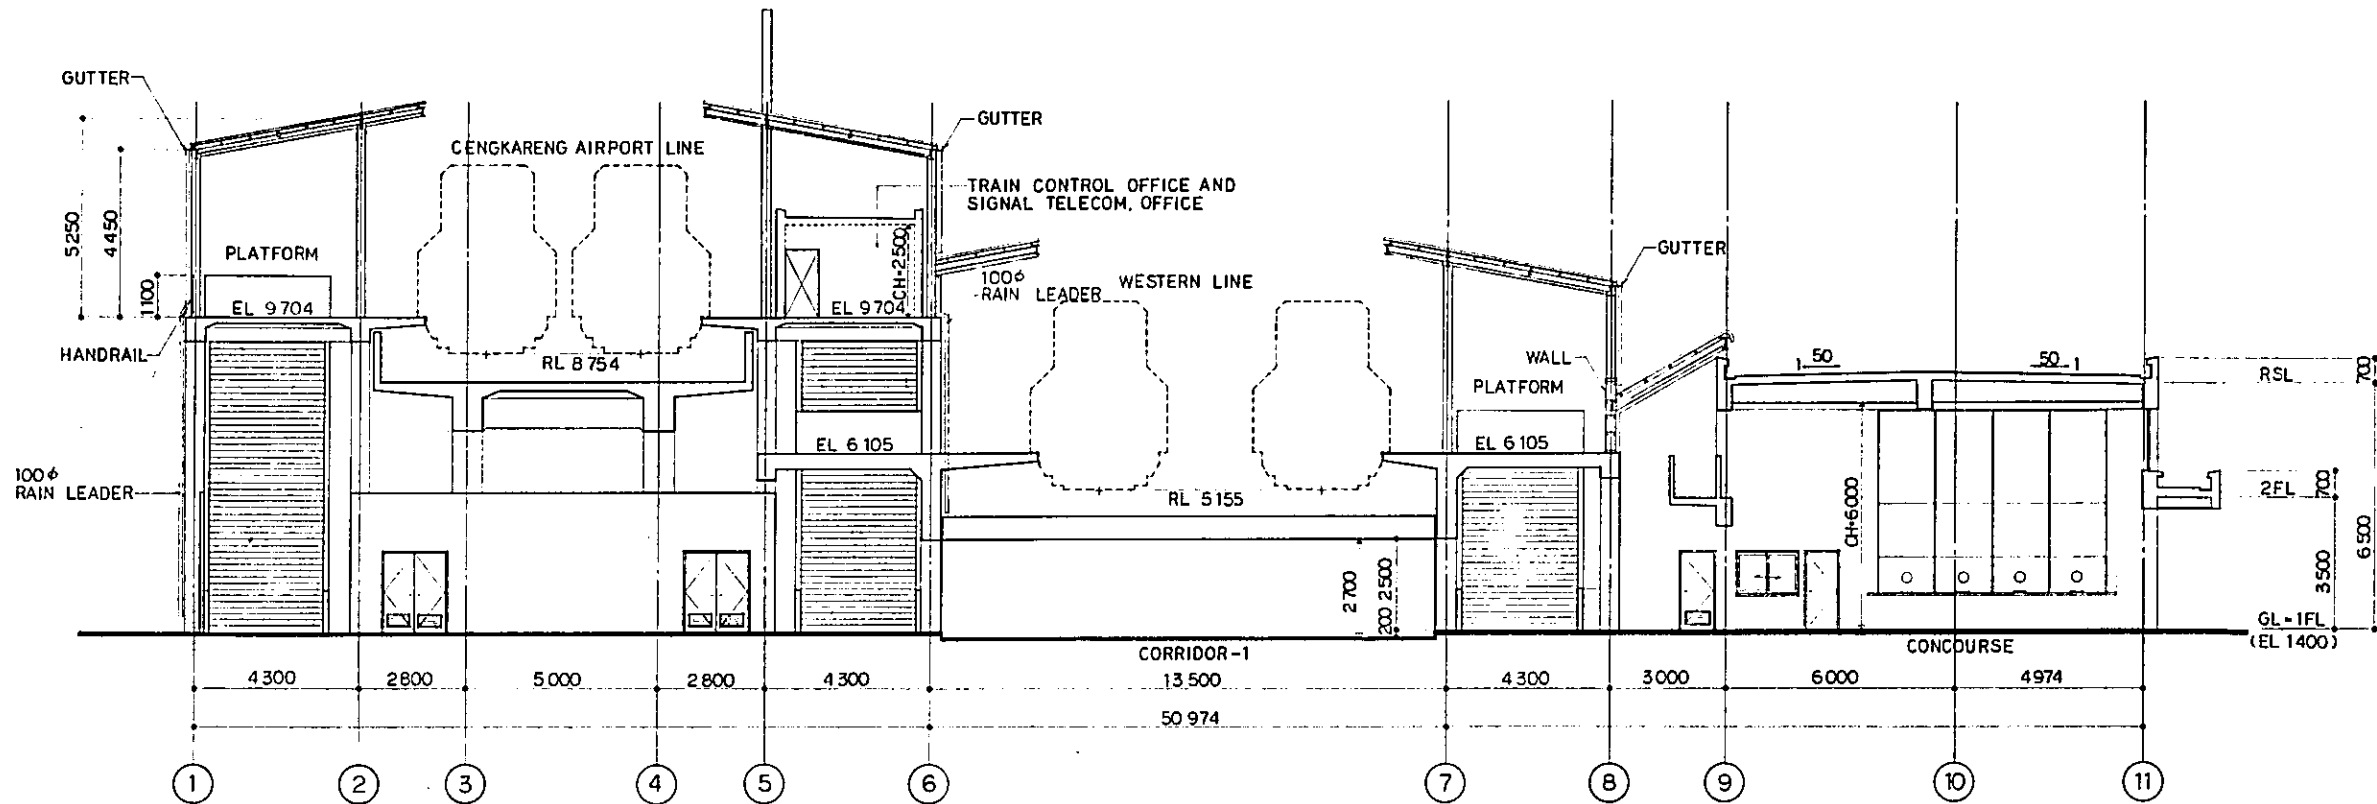


SECTION A  
SCALE 1:100

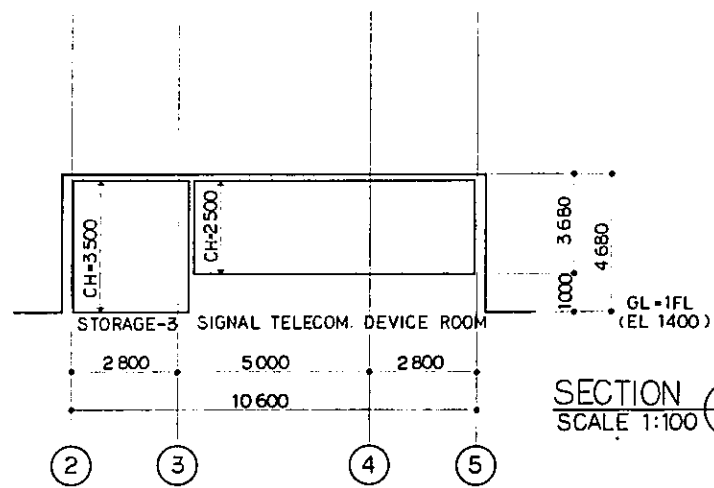

SECTION B  
SCALE 1:100

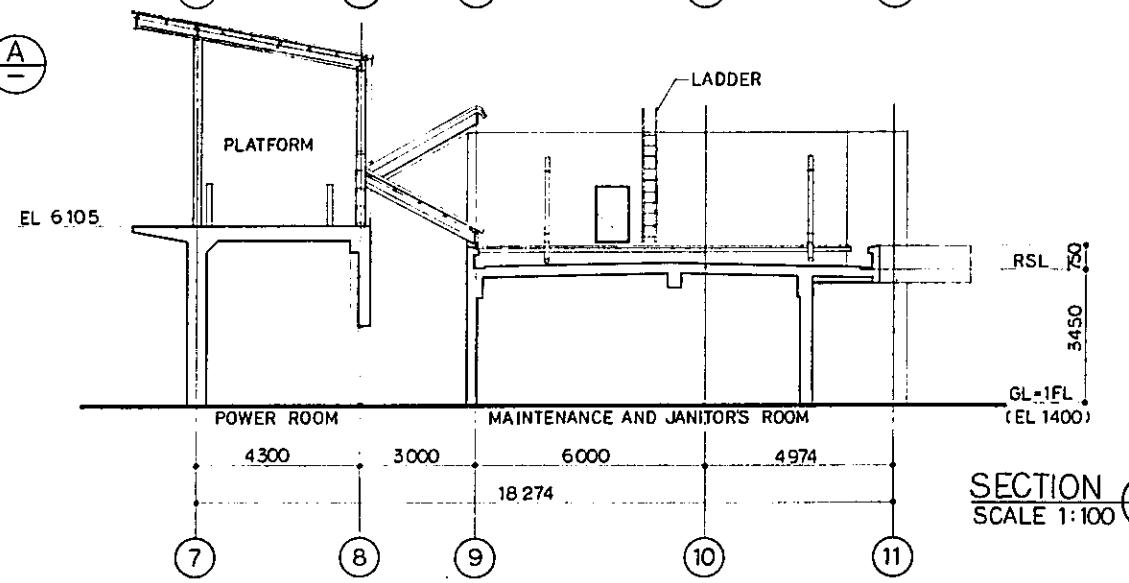


SECTION C  
SCALE 1:100

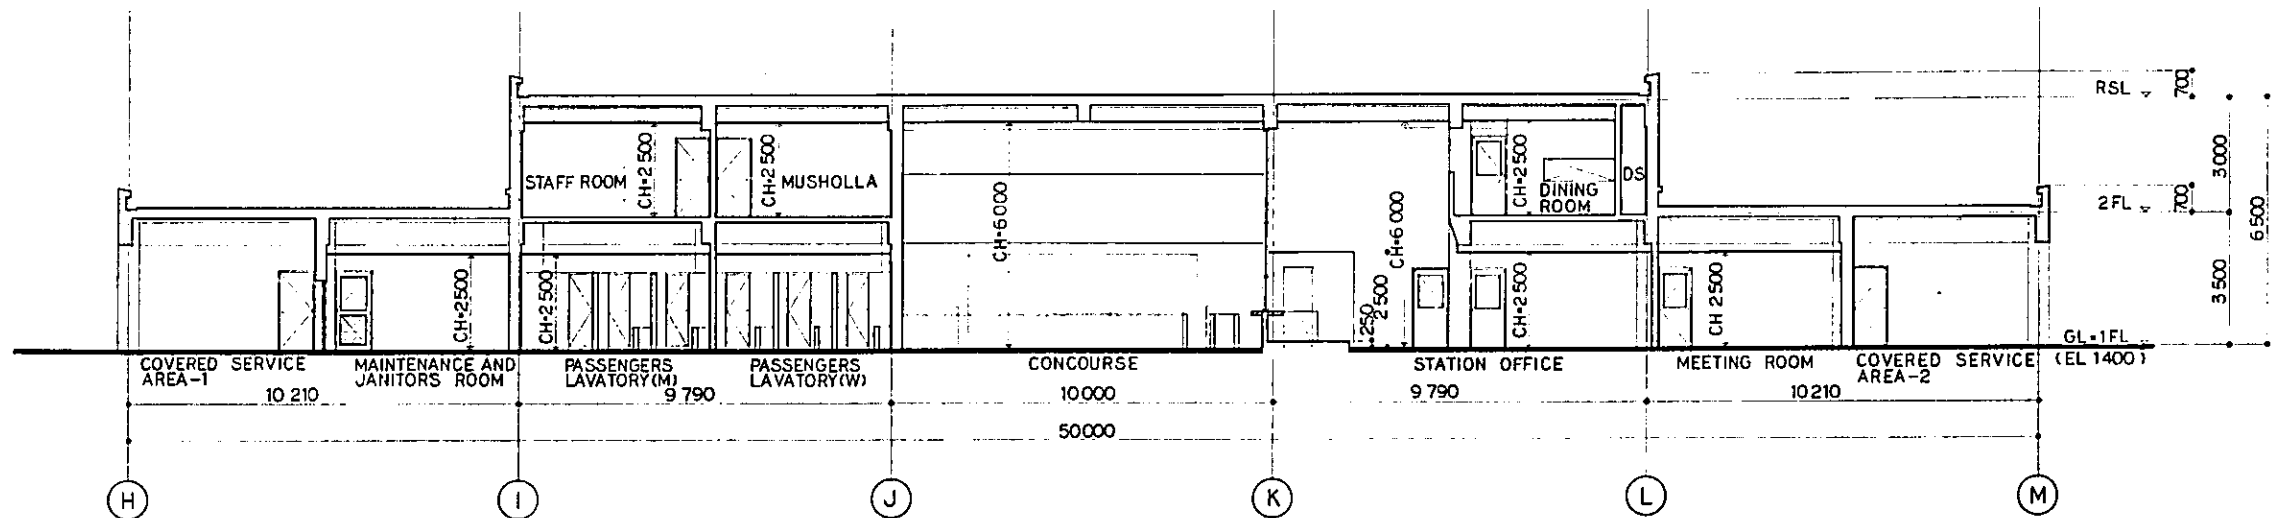

SECTION D  
SCALE 1:100


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| REPUBLIC OF INDONESIA<br>MINISTRY OF COMMUNICATIONS<br>DIRECTORATE GENERAL OF LAND TRANSPORT<br>AND INLAND WATERWAYS |            |                      |       |         |          |           |
| NEW RAILWAY LINE FOR CENKARENG AIRPORT<br>CONSTRUCTION PROJECT   |            |                      |       |         |          |           |
| JAPAN INTERNATIONAL COOPERATION AGENCY<br>(JICA)   |            |                      |       |         |          |           |
| B  | 1 AUG. 89  | Endo                 | 2.5   | Endo    | K.M.     | K.K.      |
| A  | 15 FEB. 89 | Endo                 | 2.5   | Endo    | K.M.     | K.K.      |
| REVISIONS  | DATE       | DESIGNED             | DRAWN | CHECKED | REVIEWED | SUBMITTED |
| KOTA INTAN STATION<br>SECTIONS<br>( SHEET 1 OF 2 )   |            |                      |       |         |          |           |
| PACKAGE: I CIVIL AND ARCHITECTURAL WORK  |            |                      |       |         |          |           |
| SCALE: 1:100   |            | DRAWING NO: AA - 029 |       |         |          |           |



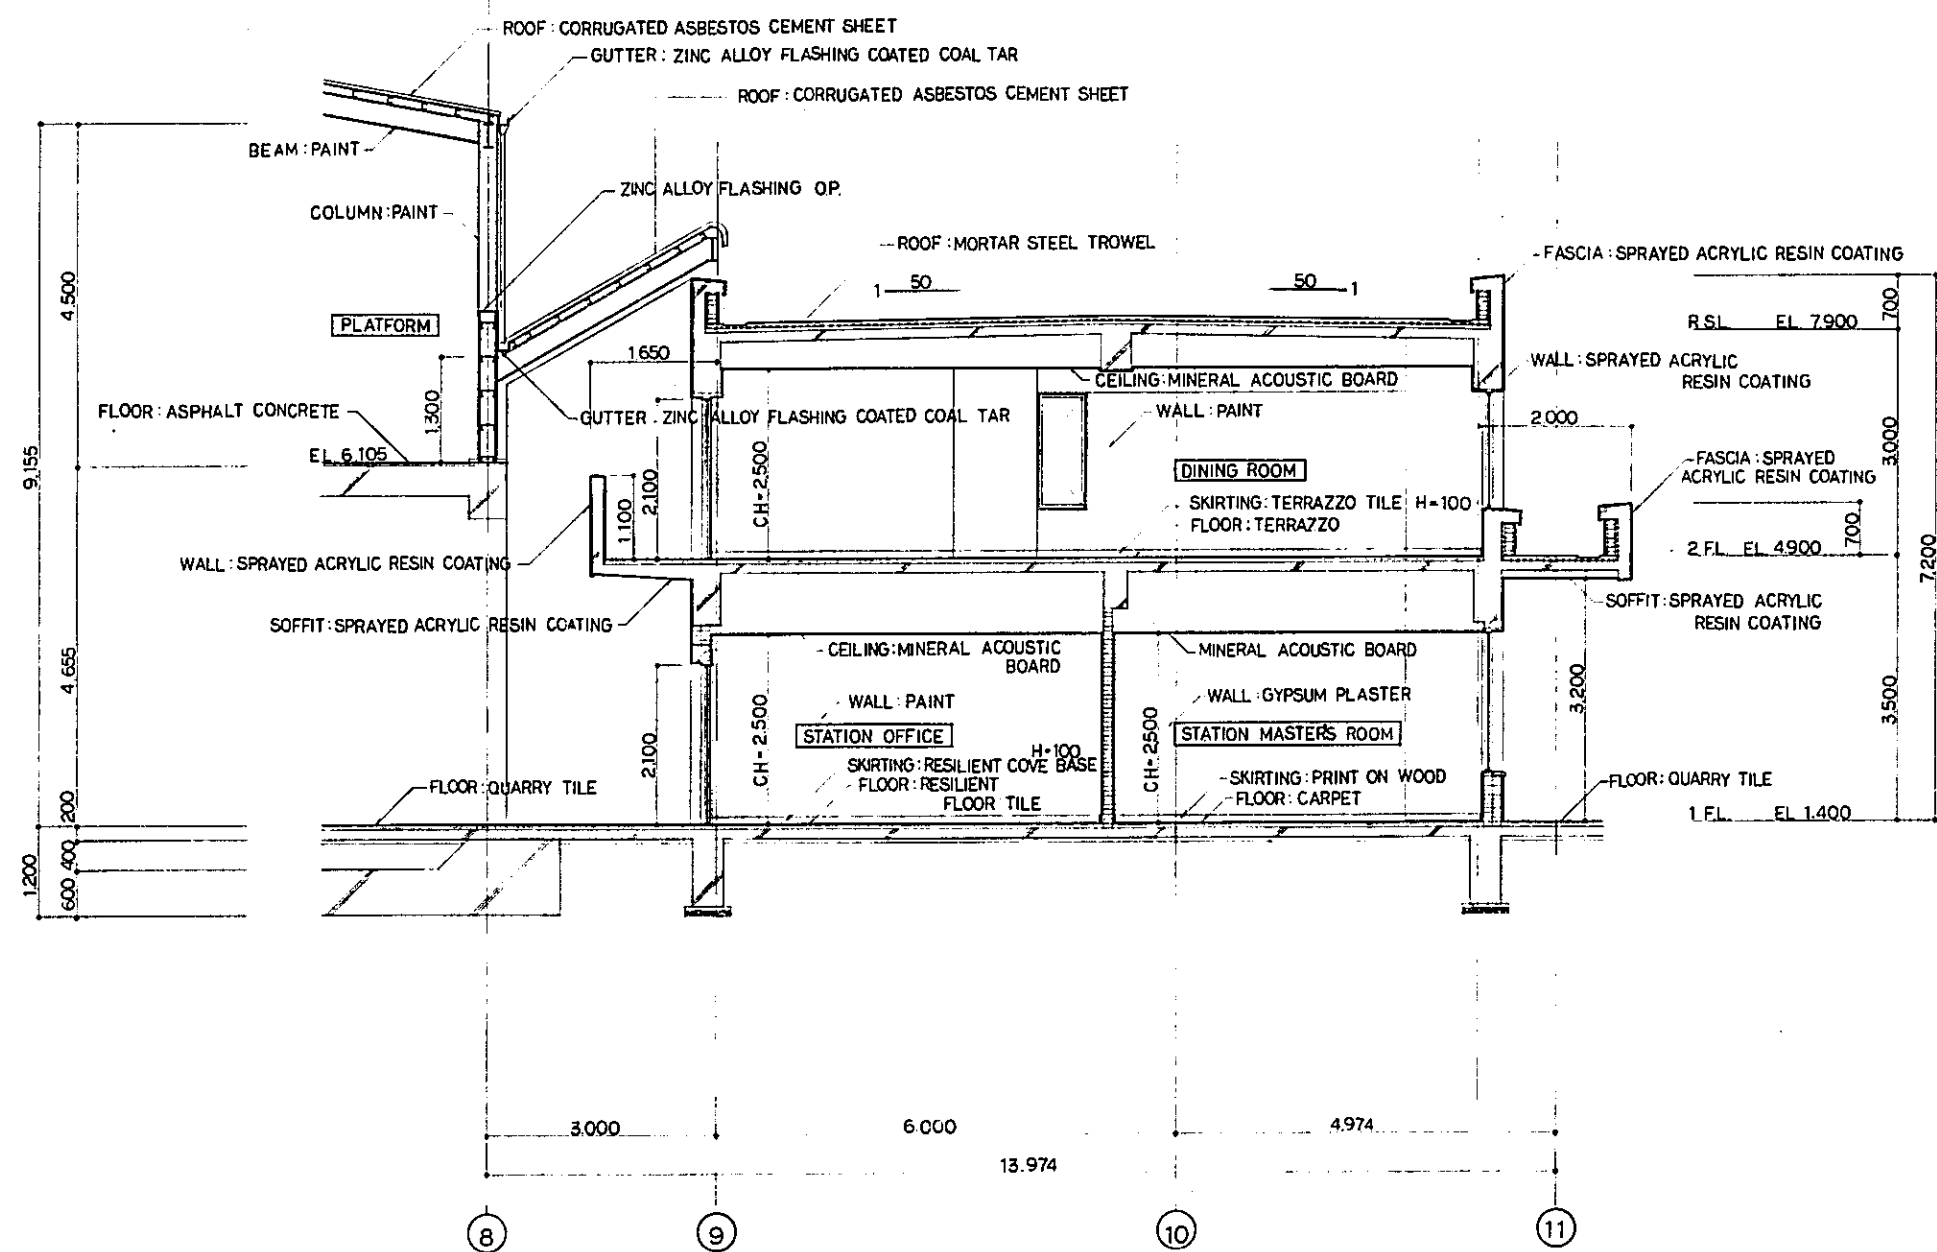



SECTION **E**  
SCALE 1:50

|  |             |           |           |           |           |
|--|-------------|-----------|-----------|-----------|-----------|
| REPUBLIC OF INDONESIA<br>MINISTRY OF COMMUNICATIONS<br>DIRECTORATE GENERAL OF LAND TRANSPORT<br>AND INLAND WATERWAYS |             |           |           |           |           |
| NEW RAILWAY LINE FOR CENGKARENG AIRPORT<br>CONSTRUCTION PROJECT  |             |           |           |           |           |
| JAPAN INTERNATIONAL COOPERATION AGENCY<br>(JICA)   |             |           |           |           |           |
| REVISIONS  | DATE        | DESIGNED  | DRAWN     | CHECKED   | REVIEWED  |
| B  | 1 AUG '89   | Eng. J.S. | Eng. H.M. | Eng. K.M. | Eng. M.K. |
| A  | 15 FEB '88  | Eng. J.S. | Eng. H.M. | Eng. K.M. | Eng. M.K. |
| KOTA INTAN STATION<br>SECTIONS<br>( SHEET 2 OF 2 )   |             |           |           |           |           |
| PACKAGE: I CIVIL AND ARCHITECTURAL WORK  |             |           |           |           |           |
| SCALE  | DRAWING NO: |           |           |           |           |
| 1:50   | AA - 030    |           |           |           |           |

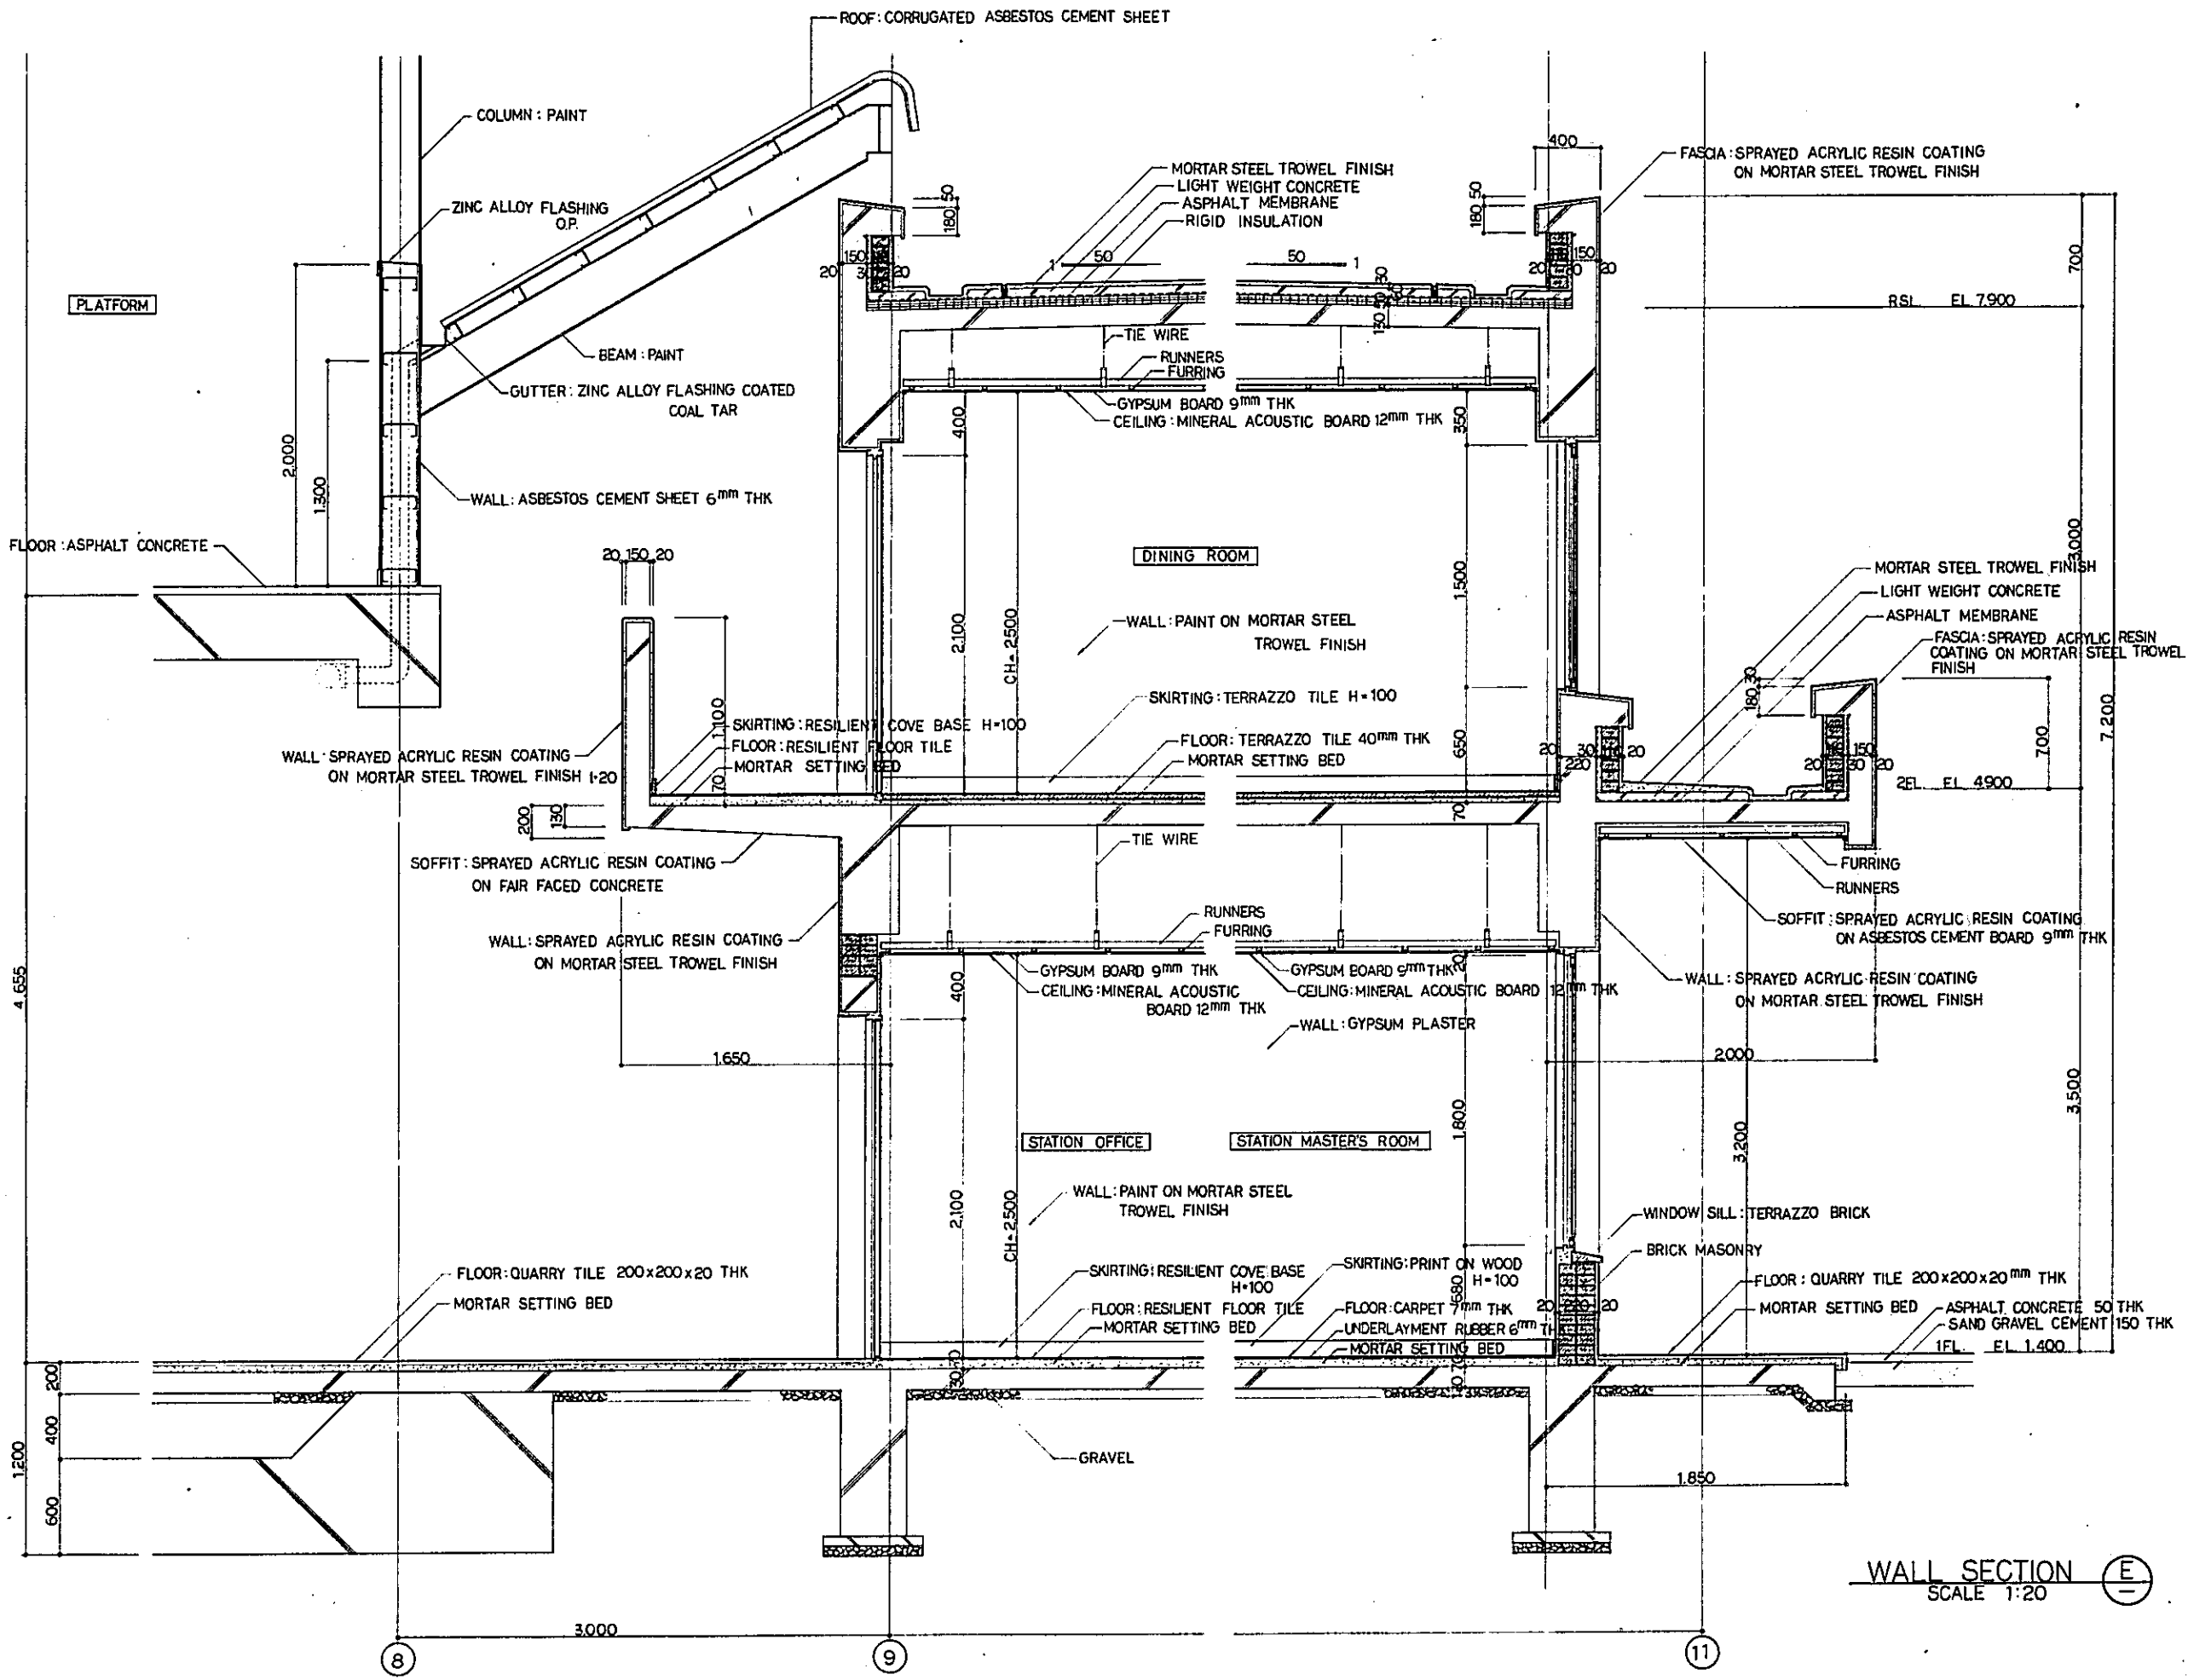


WALL SECTION (E)  
SCALE 1:20

|  |           |                      |          |          |           |
|--|-----------|----------------------|----------|----------|-----------|
| REPUBLIC OF INDONESIA<br>MINISTRY OF COMMUNICATIONS<br>DIRECTORATE GENERAL OF LAND TRANSPORT<br>AND INLAND WATERWAYS |           |                      |          |          |           |
| NEW RAILWAY LINE FOR CENGKARENG AIRPORT<br>CONSTRUCTION PROJECT  |           |                      |          |          |           |
| JAPAN INTERNATIONAL COOPERATION AGENCY<br>(JICA)   |           |                      |          |          |           |
| REVISIONS  | DATE      | DESIGNED             | DRAWN    | CHECKED  | SUBMITTED |
| B  | 1 AUG 88  | S. S. S.             | S. S. S. | K. M. K. | K. M. K.  |
| A  | 15 FEB 88 | S. S. S.             | S. S. S. | K. M. K. | K. M. K.  |
| KOTA INTAN STATION<br>WALL SECTION   |           |                      |          |          |           |
| PACKAGE: I CIVIL AND ARCHITECTURAL WORK  |           |                      |          |          |           |
| SCALE: 1:20  |           | DRAWING NO: AA - 031 |          |          |           |

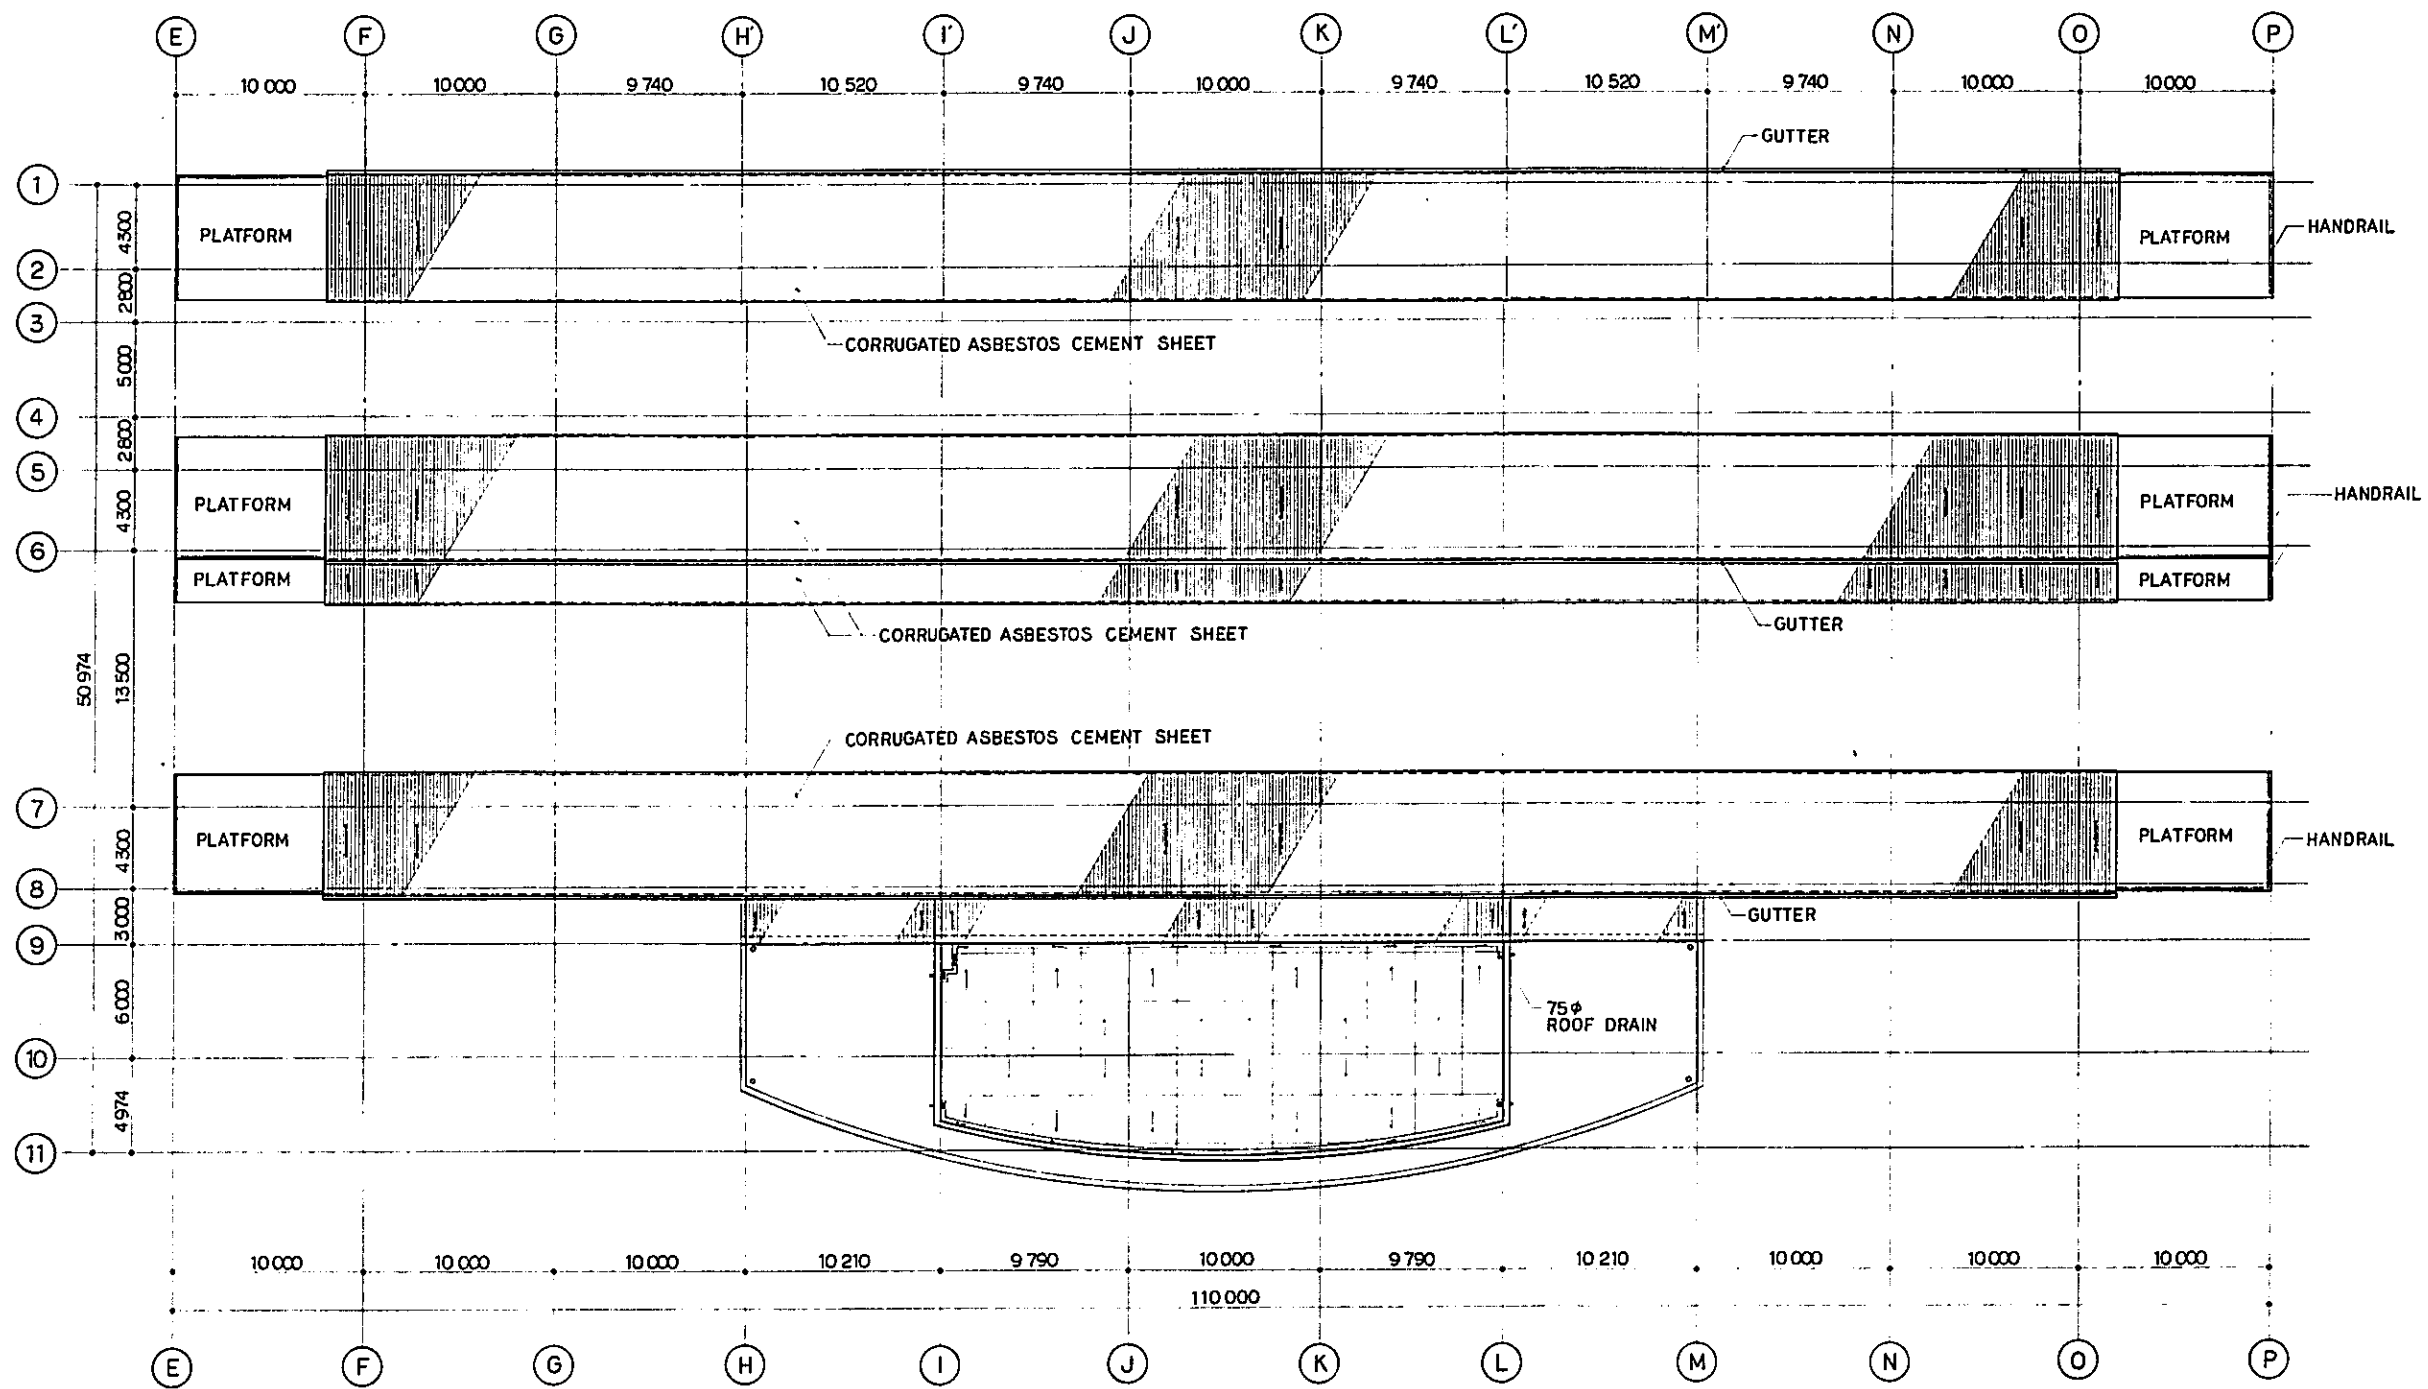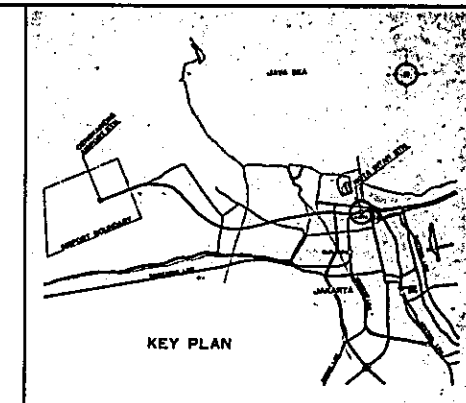

ROOF PLAN  
SCALE 1:200

|  |           |                      |       |             |          |
|--|-----------|----------------------|-------|-------------|----------|
| REPUBLIC OF INDONESIA<br>MINISTRY OF COMMUNICATIONS<br>DIRECTORATE GENERAL OF LAND TRANSPORT<br>AND INLAND WATERWAYS |           |                      |       |             |          |
| NEW RAILWAY LINE FOR CENGKARENG AIRPORT<br>CONSTRUCTION PROJECT  |           |                      |       |             |          |
| JAPAN INTERNATIONAL COOPERATION AGENCY<br>(JICA)   |           |                      |       |             |          |
| B  | 1 AUG 87  | TSUB                 | 23    | P. S. K. M. | M. K.    |
| A  | 15 FEB 87 | TSUB                 | 25    | P. S. K. M. | M. K.    |
| REVISIONS  | DATE      | DESIGNED             | DRAWN | CHECKED     | REVIEWED |
| KOTA INTAN STATION<br>ROOF PLAN  |           |                      |       |             |          |
| PACKAGE: I CIVIL AND ARCHITECTURAL WORK  |           |                      |       |             |          |
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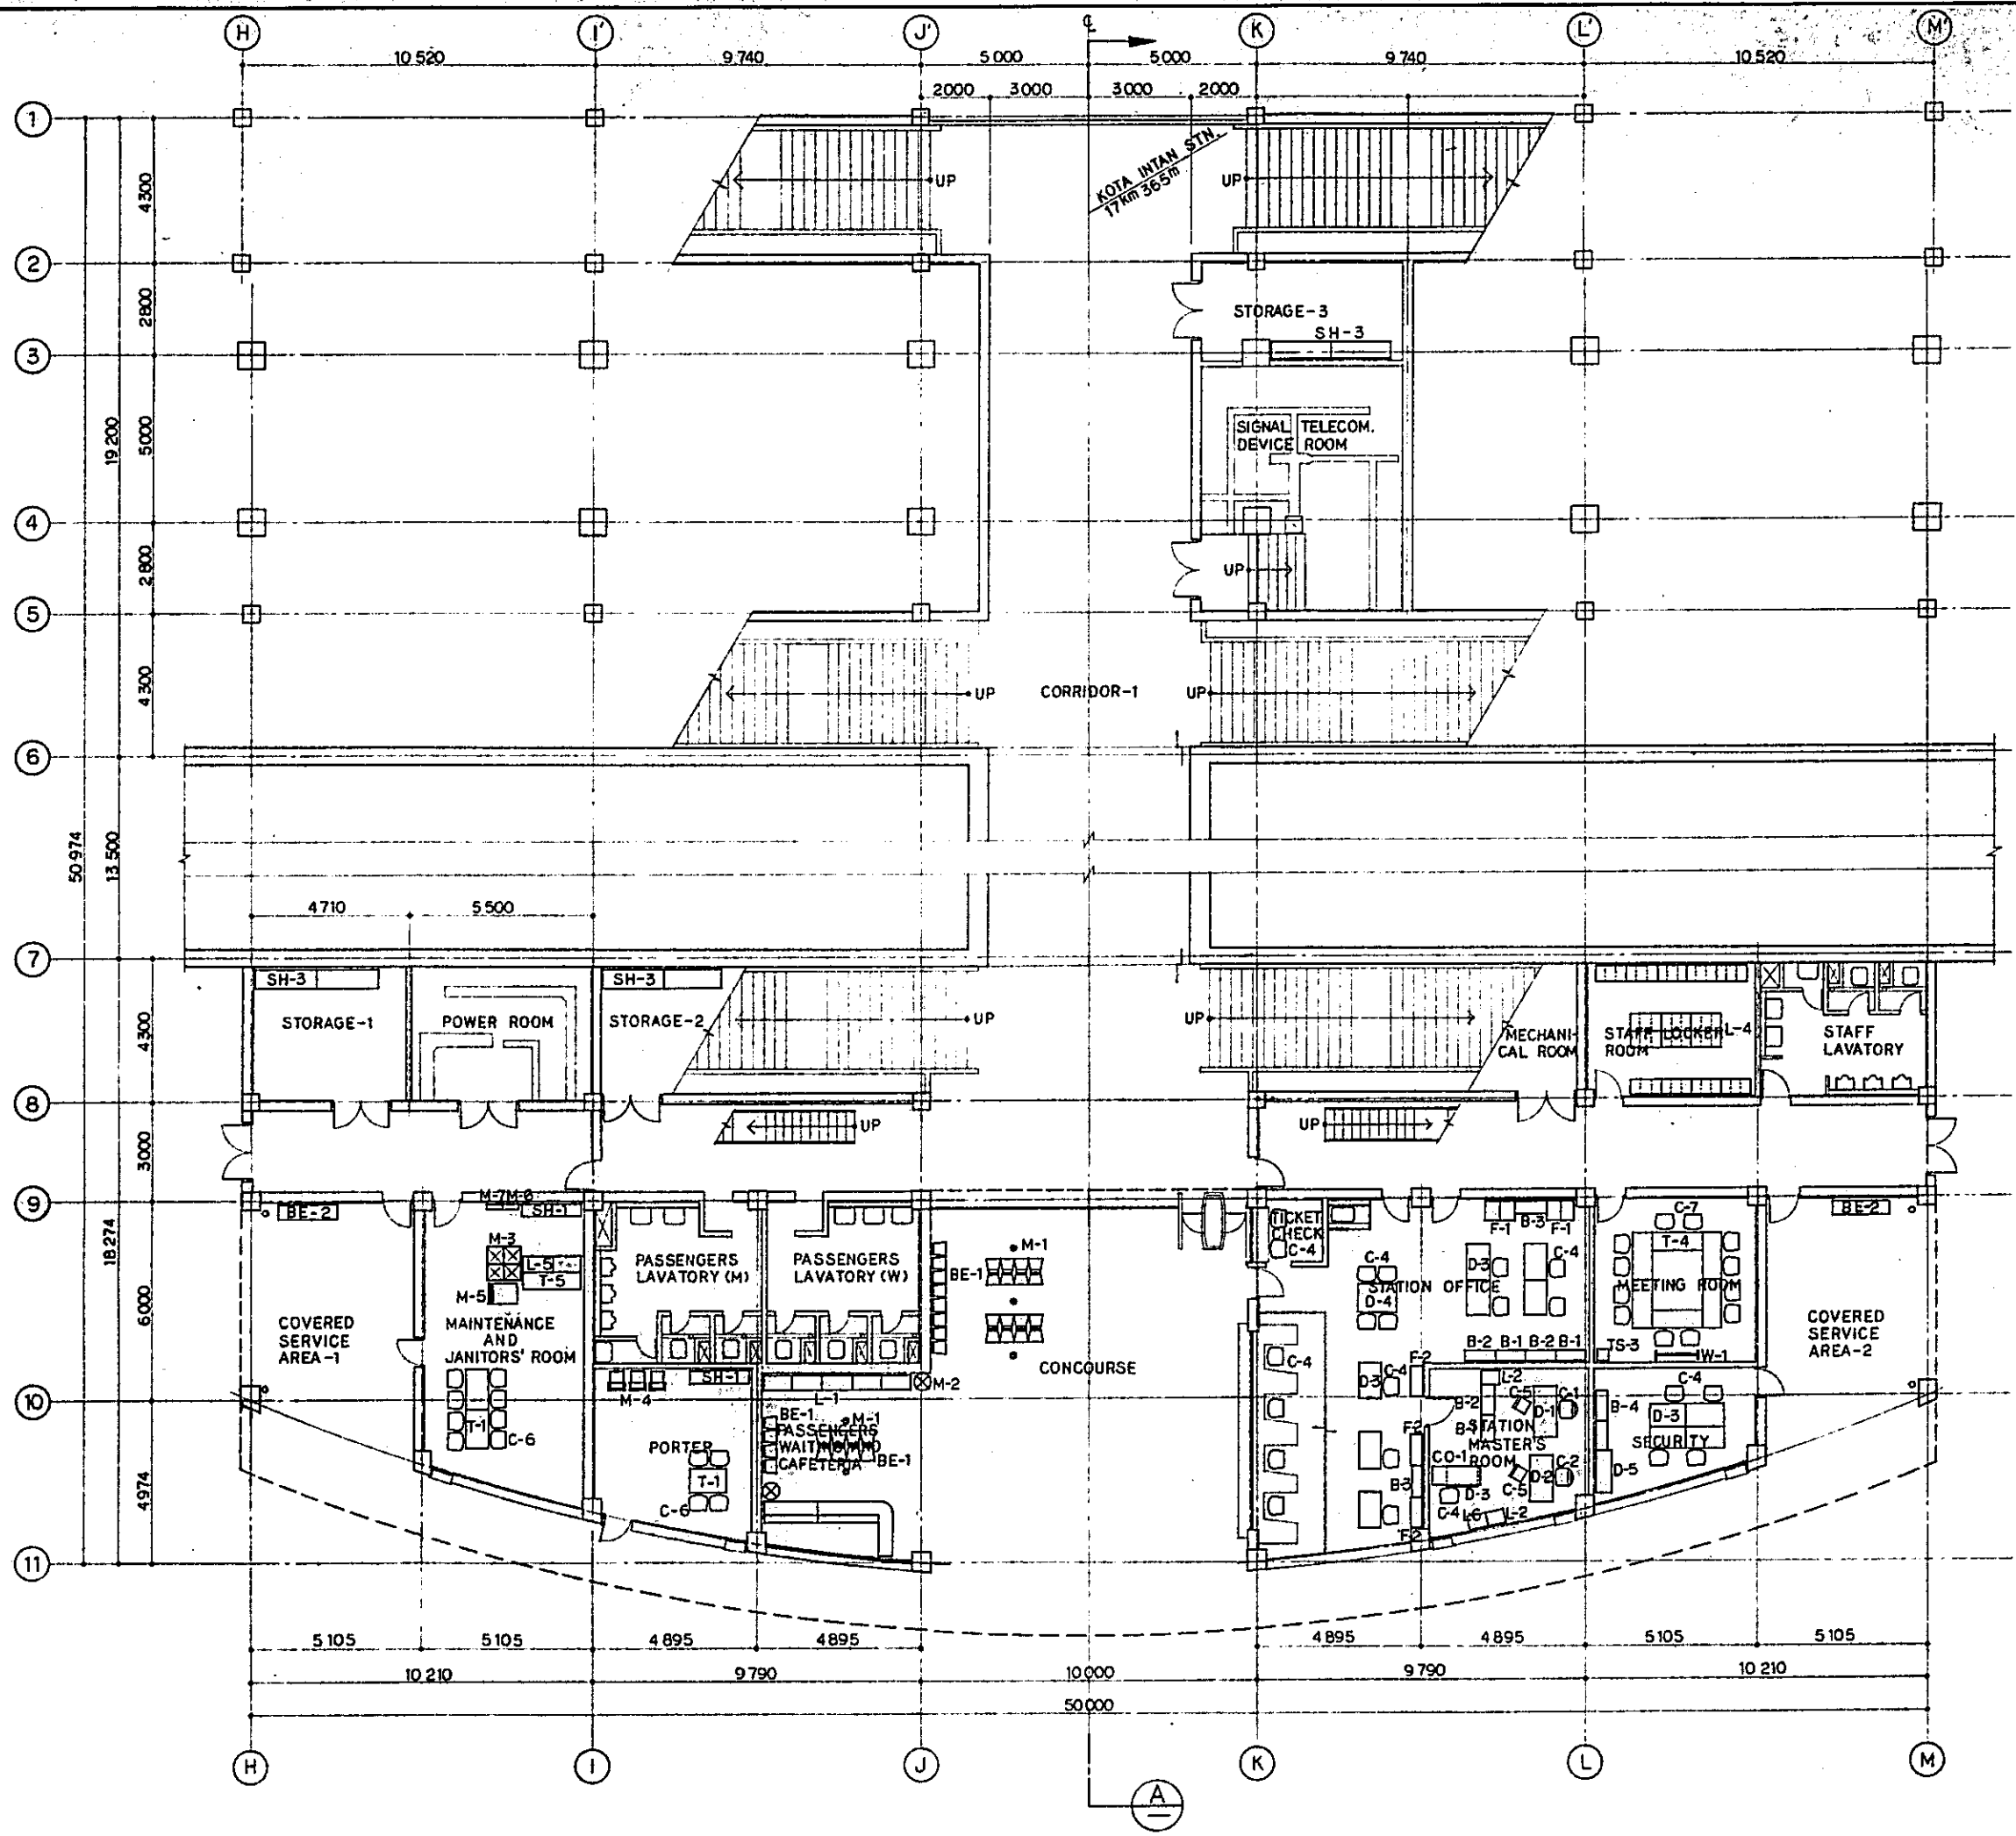


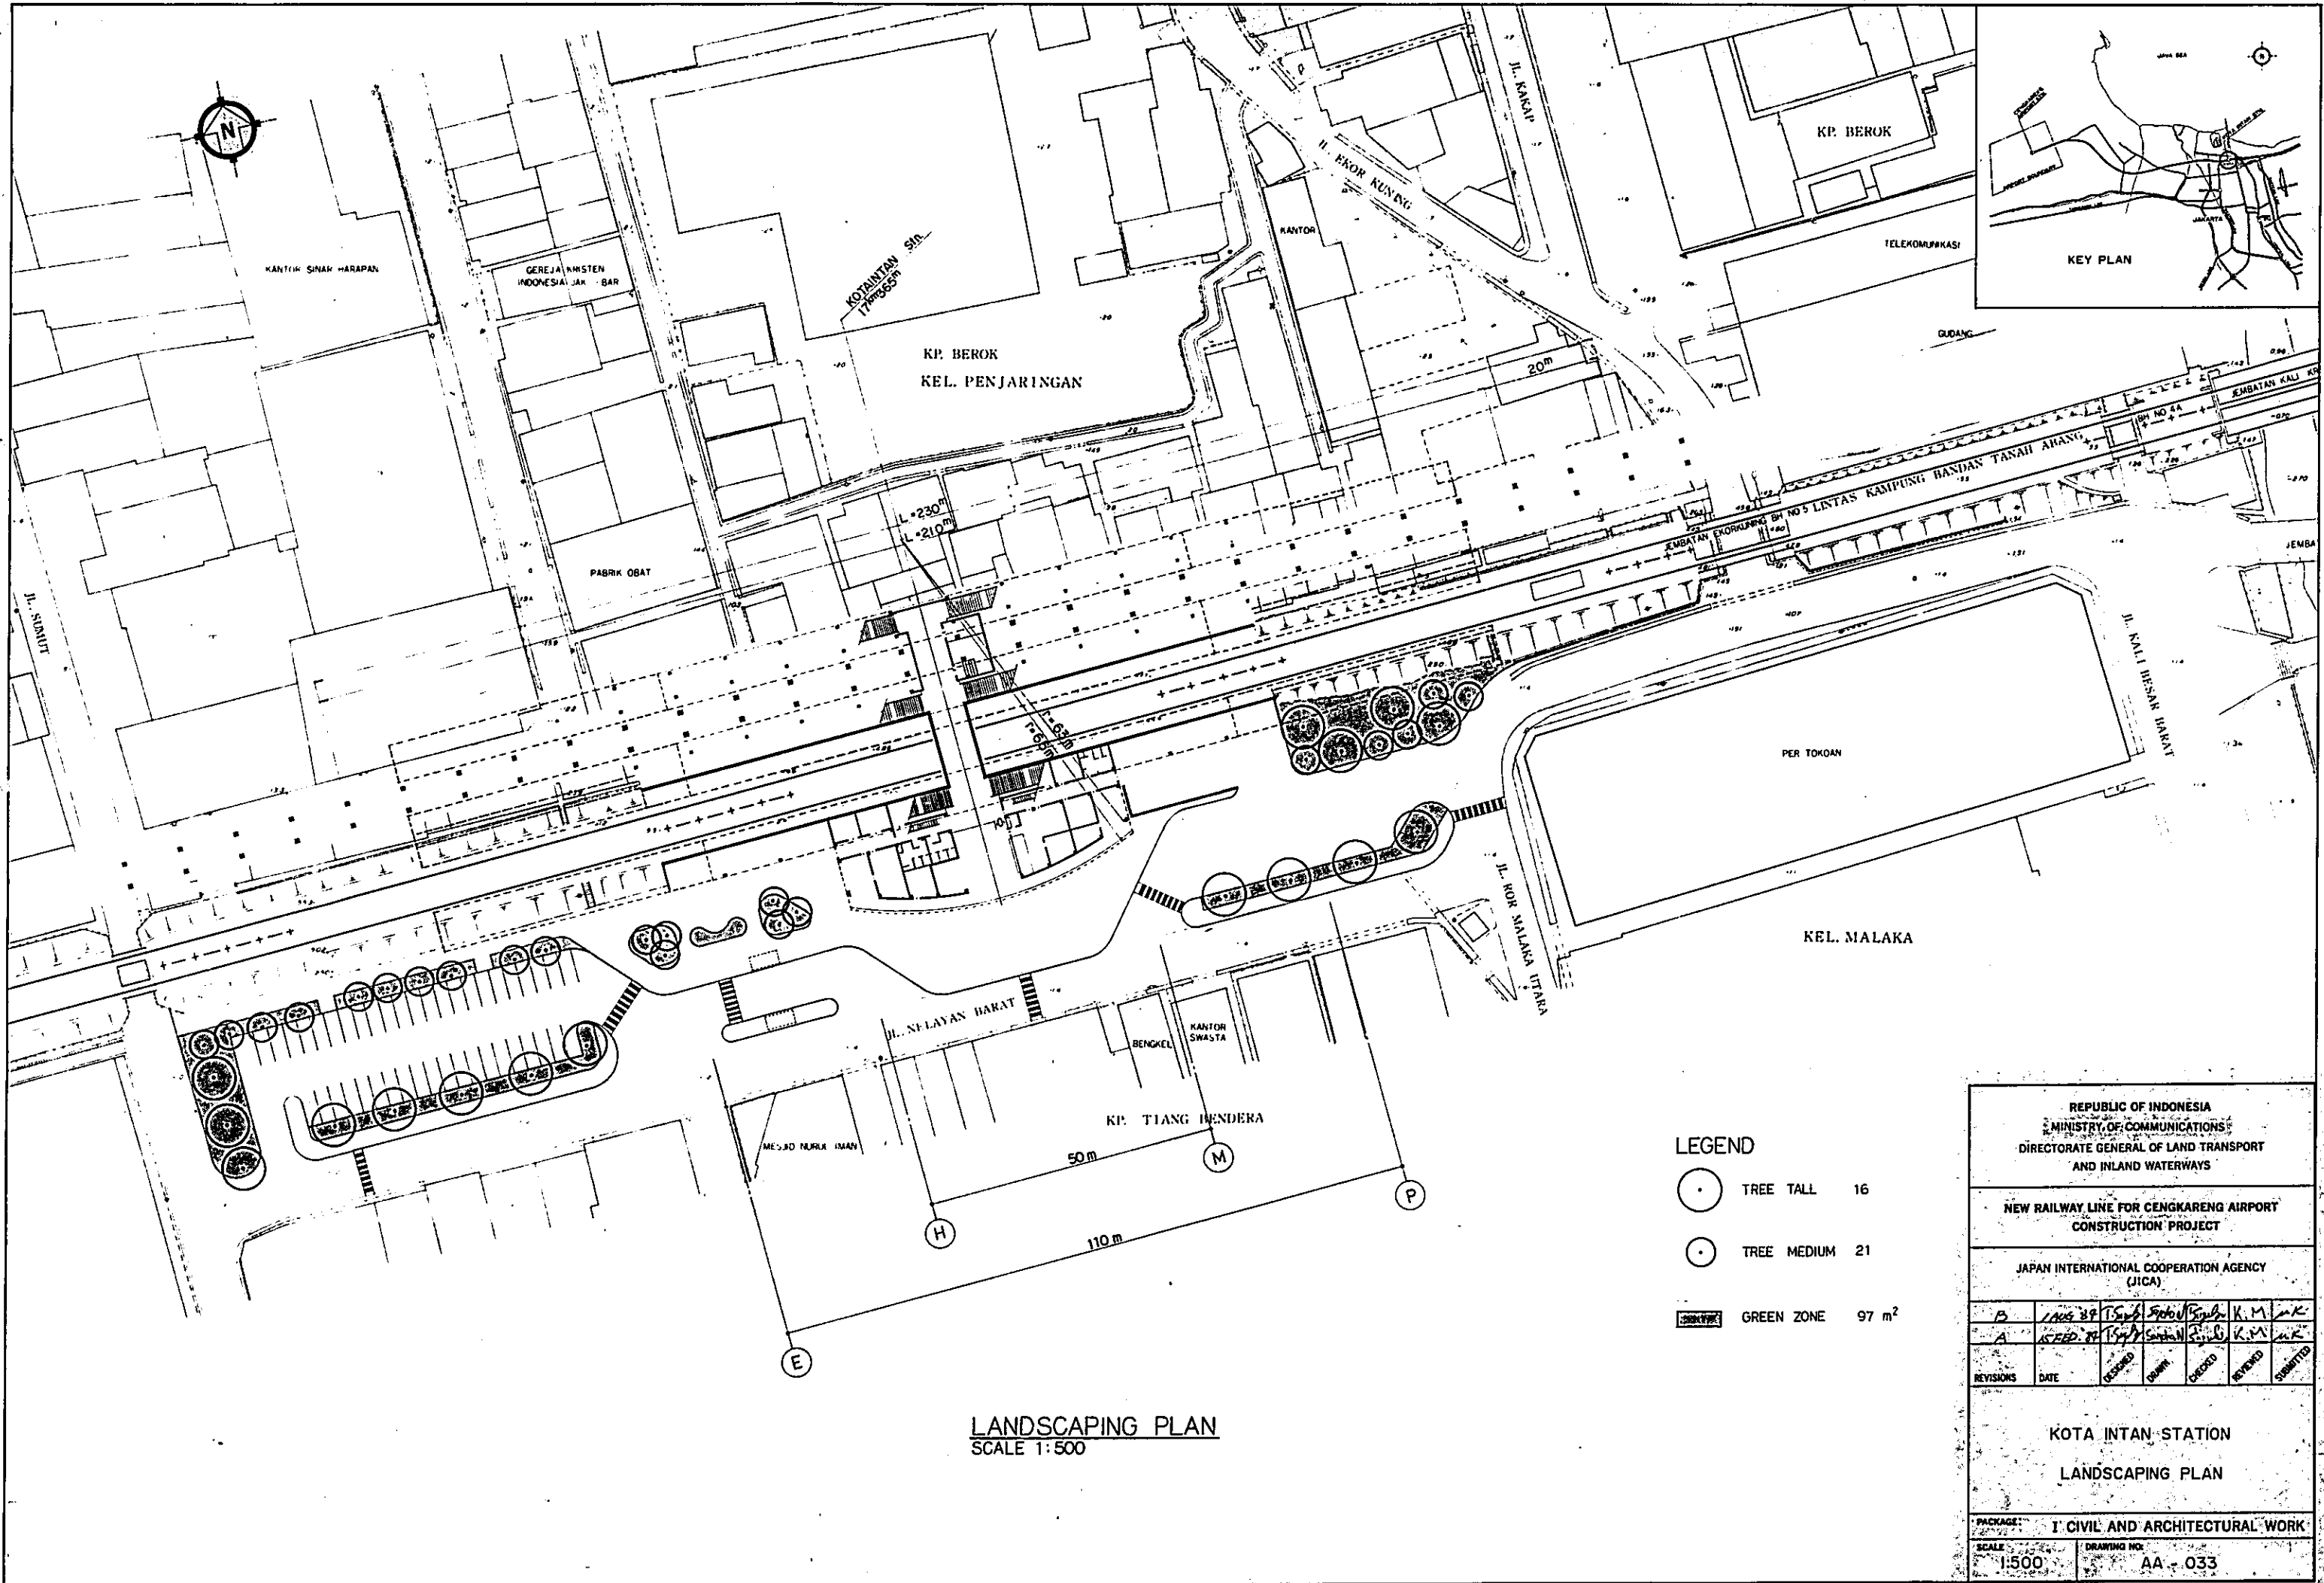LANDSCAPING PLAN  
SCALE 1:500

- LEGEND**
- TREE TALL 16
  - TREE MEDIUM 21
  - GREEN ZONE 97 m<sup>2</sup>

|  |             |          |       |         |          |
|--|-------------|----------|-------|---------|----------|
| REPUBLIC OF INDONESIA<br>MINISTRY OF COMMUNICATIONS<br>DIRECTORATE GENERAL OF LAND TRANSPORT<br>AND INLAND WATERWAYS |             |          |       |         |          |
| NEW RAILWAY LINE FOR GENGKARENG AIRPORT<br>CONSTRUCTION PROJECT  |             |          |       |         |          |
| JAPAN INTERNATIONAL COOPERATION AGENCY<br>(JICA)   |             |          |       |         |          |
|  |             |          |       |         |          |
|  |             |          |       |         |          |
| REVISIONS  | DATE        | DESIGNED | DRAWN | CHECKED | REVIEWED |
|  |             |          |       |         |          |
| KOTA INTAN STATION<br>LANDSCAPING PLAN   |             |          |       |         |          |
| PACKAGE: I CIVIL AND ARCHITECTURAL WORK  |             |          |       |         |          |
| SCALE  | DRAWING NO. |          |       |         |          |
| 1:500  | AA - 033    |          |       |         |          |

NOTE: REFER TO SPECIFICATIONS SECTION FOR FURNITURE FOR LIST OF PRODUCT REFERENCE DESIGNATIONS



REPUBLIC OF INDONESIA  
 MINISTRY OF COMMUNICATIONS  
 DIRECTORATE GENERAL OF LAND TRANSPORT AND INLAND WATERWAYS

NEW RAILWAY LINE FOR CENKARENG AIRPORT  
 CONSTRUCTION PROJECT


JAPAN INTERNATIONAL COOPERATION AGENCY (JICA)

|           |         |     |         |          |          |     |         |
|-----------|---------|-----|---------|----------|----------|-----|---------|
| REVISIONS | DATE    | BY  | CHECKED | REVISION | DATE     | BY  | CHECKED |
| B         | 1.05.89 | ... | ...     | A        | 15.02.89 | ... | ...     |

KOTA INTAN STATION  
 FURNITURE LAYOUT PLAN  
 (SHEET 1 OF 2)

PACKAGE: 1' CIVIL AND ARCHITECTURAL WORK

SCALE: 1:100  
 DRAWING NO.: AA-034

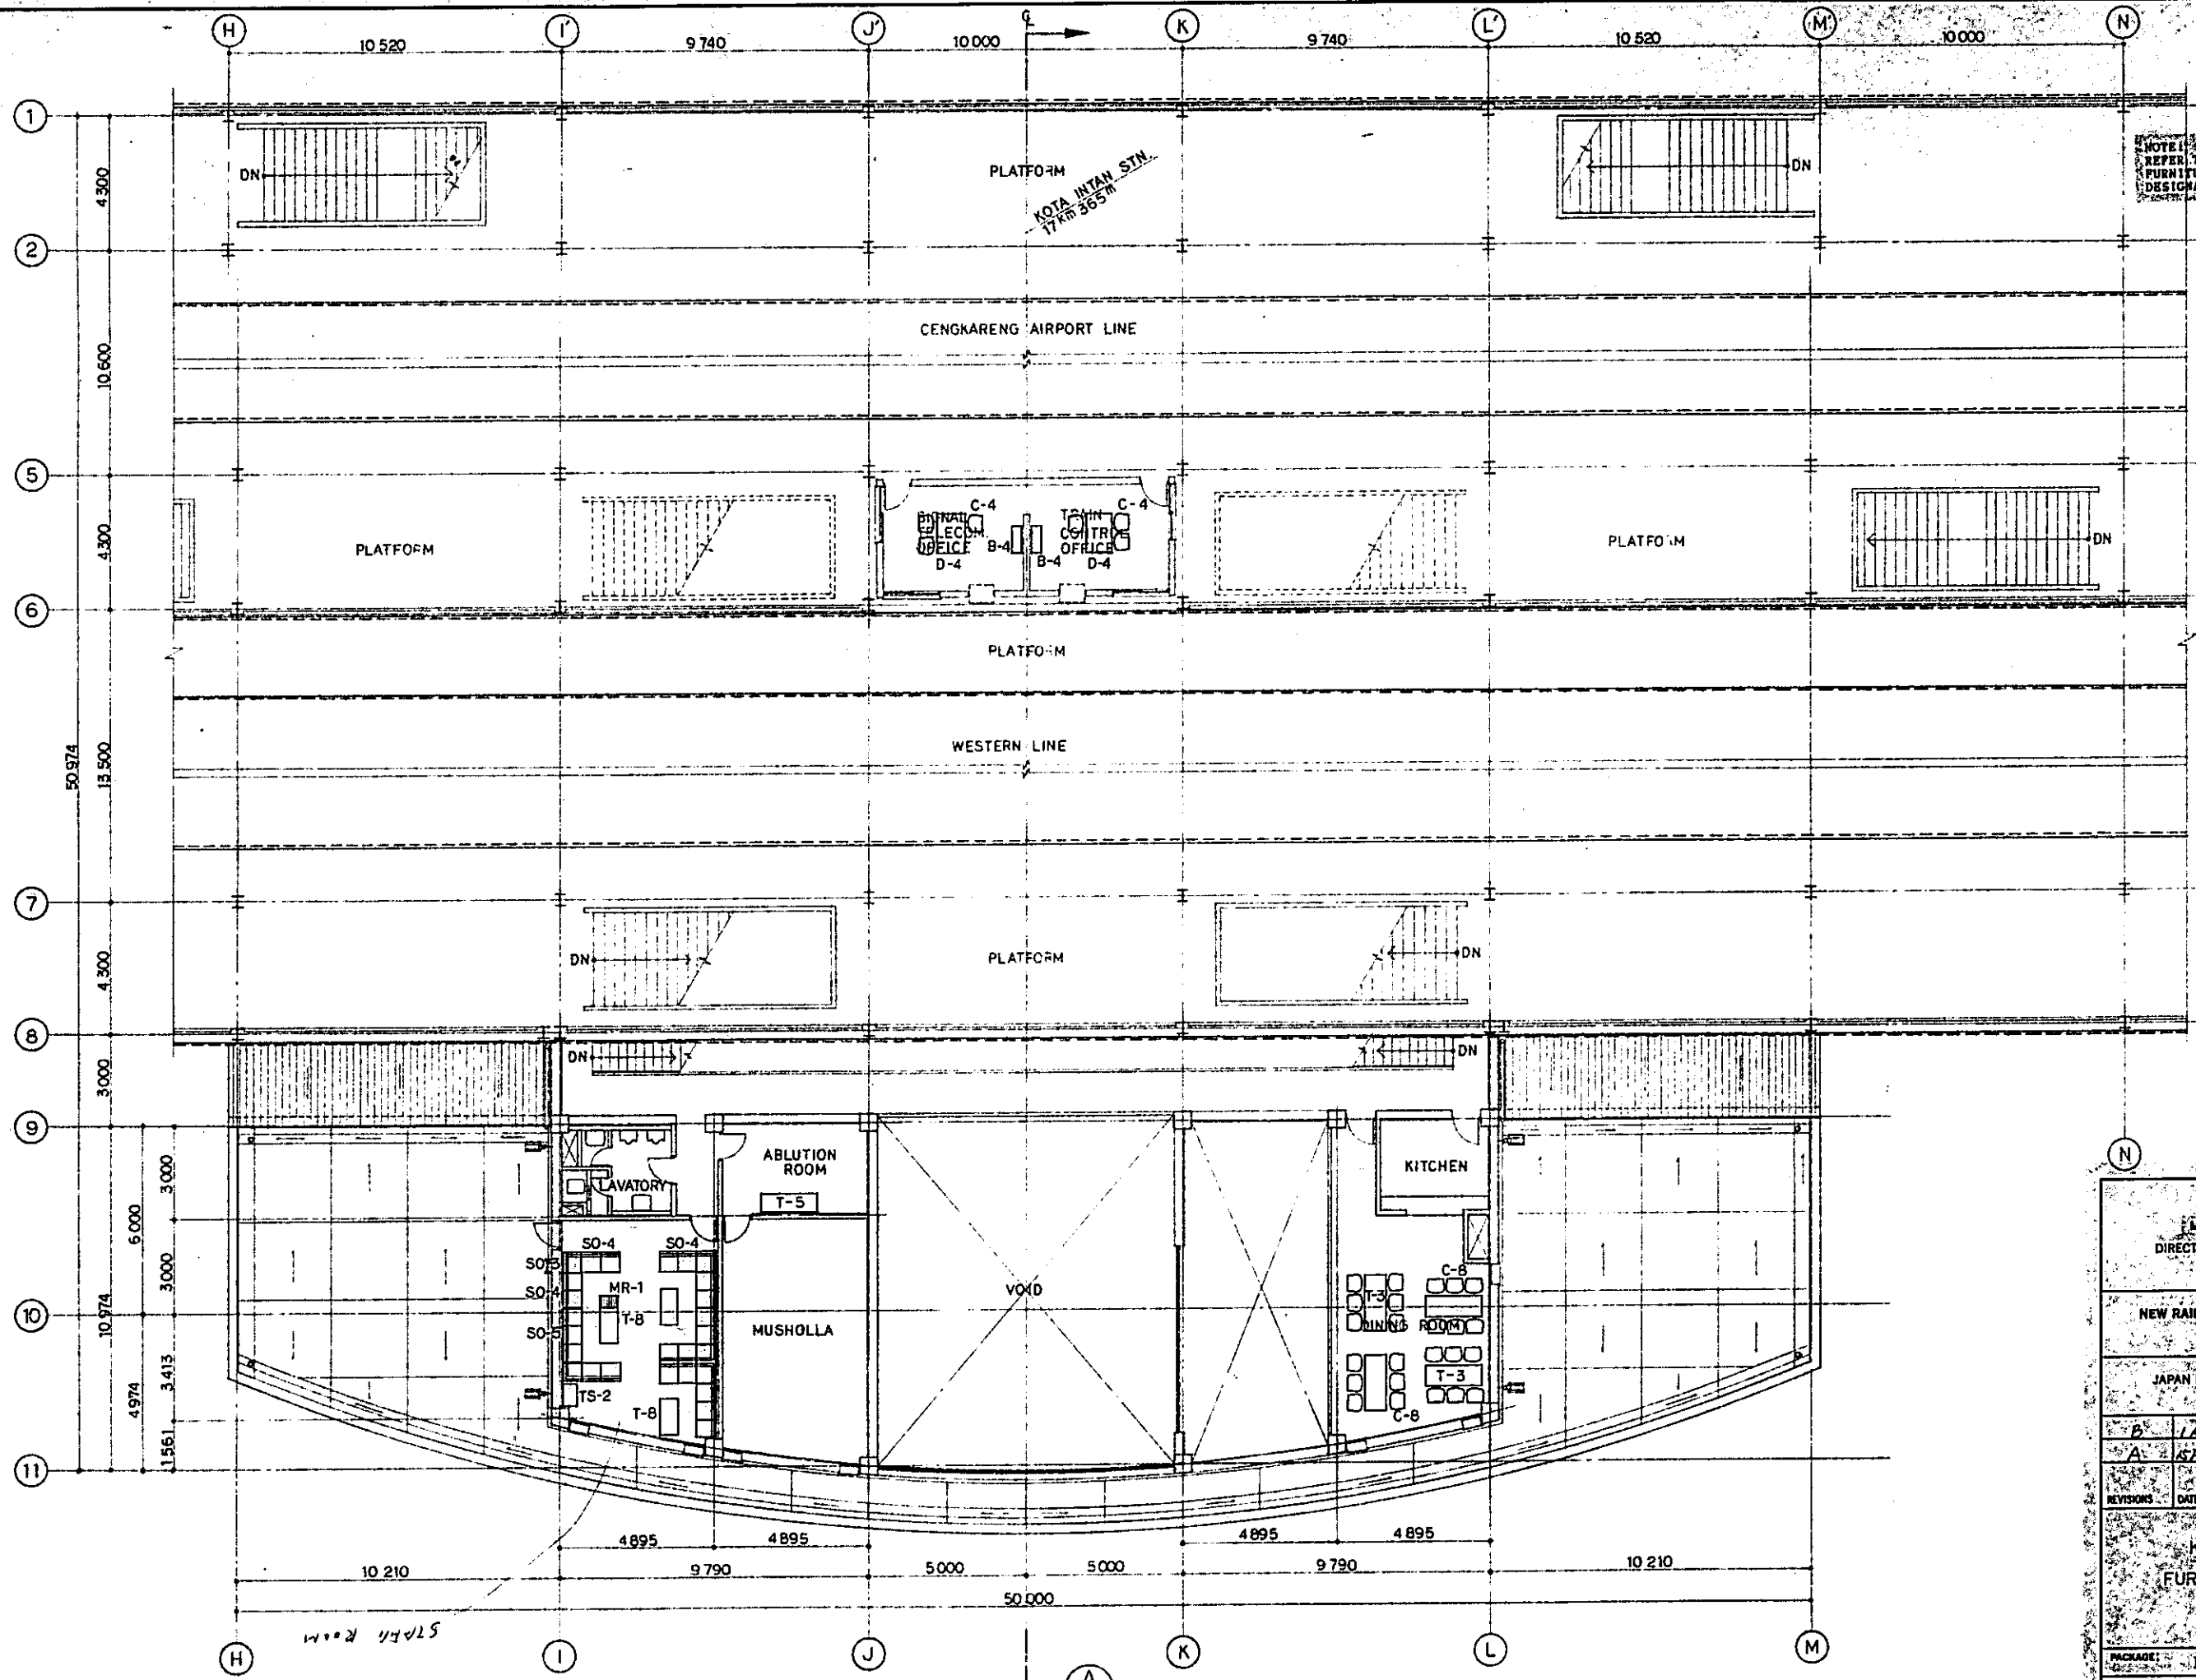

NOTE: REFER TO SPECIFICATIONS, SECTION AND FURNITURE FOR LIST OF PRODUCT REFERENCE DESIGNATIONS.

REPUBLIC OF INDONESIA  
 MINISTRY OF COMMUNICATIONS  
 DIRECTORATE GENERAL OF LAND TRANSPORT AND INLAND WATERWAYS




NEW RAILWAY LINE FOR CENKARENG AIRPORT CONSTRUCTION PROJECT

JAPAN INTERNATIONAL COOPERATION AGENCY (JICA)



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|-----------|---------|----------|---------|----------|----------|-----------|
| B         | 1/10/89 | 1/10/89  | 1/10/89 | 1/10/89  | 1/10/89  | 1/10/89   |
| A         | 1/10/89 | 1/10/89  | 1/10/89 | 1/10/89  | 1/10/89  | 1/10/89   |
| REVISIONS | DATE    | DESIGNED | CHECKED | APPROVED | REVIEWED | SUBMITTED |

KOTA INTAN STATION  
 FURNITURE LAYOUT PLAN  
 ( SHEET 2 OF 2 )

PACKAGE: CIVIL AND ARCHITECTURAL WORK  
 SCALE: 1:100  
 DRAWING NO: AA - 035

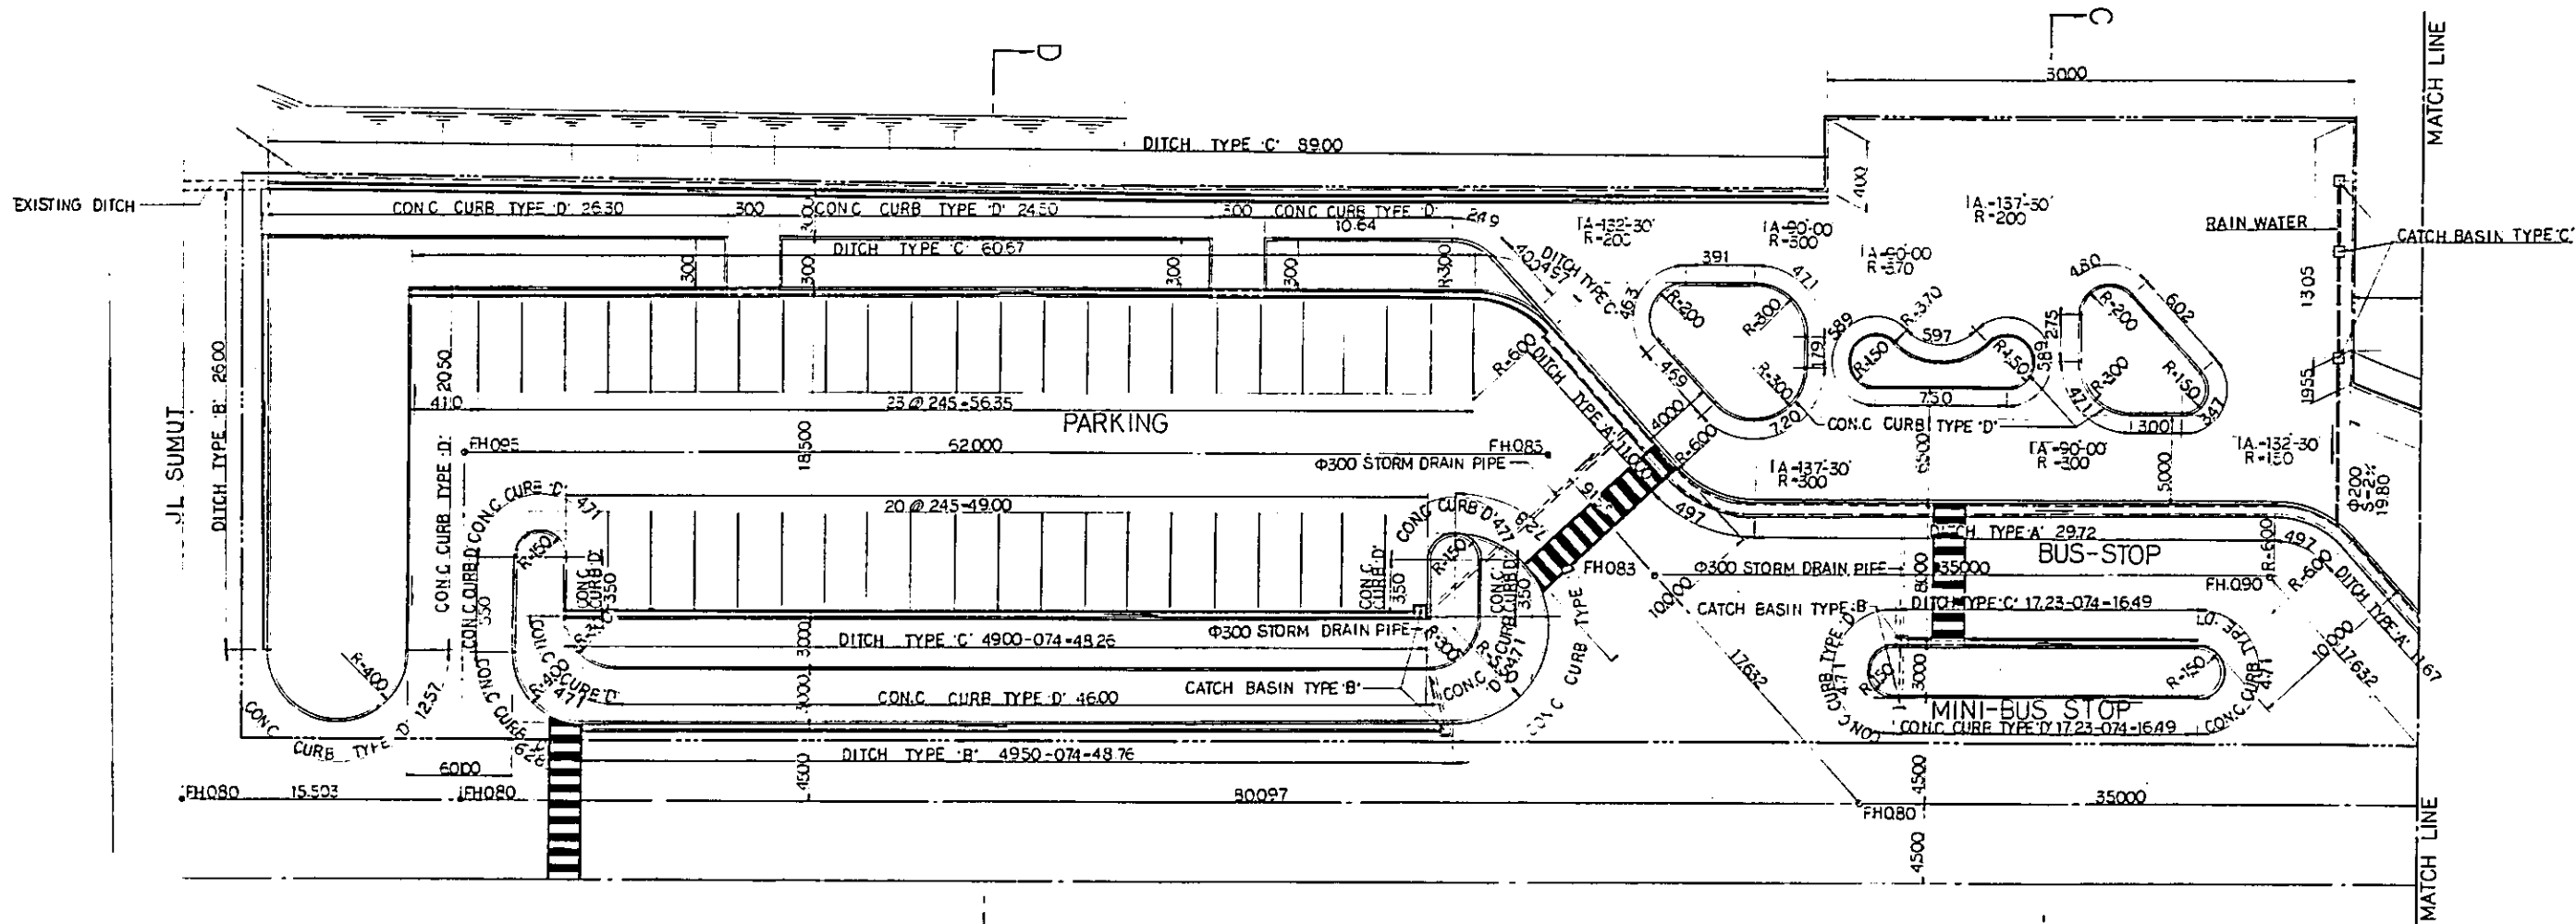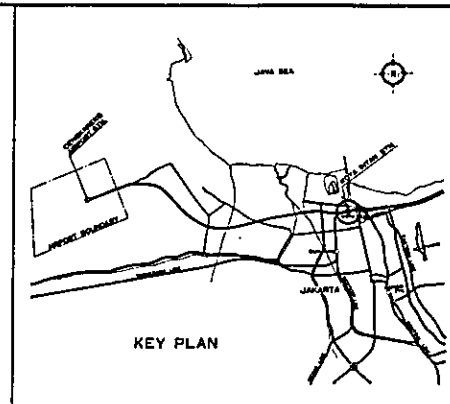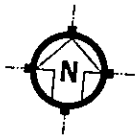


|  |          |                      |        |         |           |
|--|----------|----------------------|--------|---------|-----------|
| REPUBLIC OF INDONESIA<br>MINISTRY OF COMMUNICATIONS<br>DIRECTORATE GENERAL OF LAND TRANSPORT<br>AND INLAND WATERWAYS |          |                      |        |         |           |
| NEW RAILWAY LINE FOR CENGKARENG AIRPORT<br>CONSTRUCTION PROJECT  |          |                      |        |         |           |
| JAPAN INTERNATIONAL COOPERATION AGENCY<br>(JICA)   |          |                      |        |         |           |
| REVISIONS  | DATE     | DESIGNED             | DRAWN  | CHECKED | SUBMITTED |
| B  | 1 AUG 89 | SAITOH               | SAITOH | SAITOH  | U.M.      |
| A  | 1 FEB 89 | SAITOH               | SAITOH | SAITOH  | K.M.      |
| KOTA INTAN STATION<br>STATION PLAZA<br>PLAN 1<br>( SHEET 1 OF 2 )  |          |                      |        |         |           |
| PACKAGE: I CIVIL AND ARCHITECTURAL WORK  |          |                      |        |         |           |
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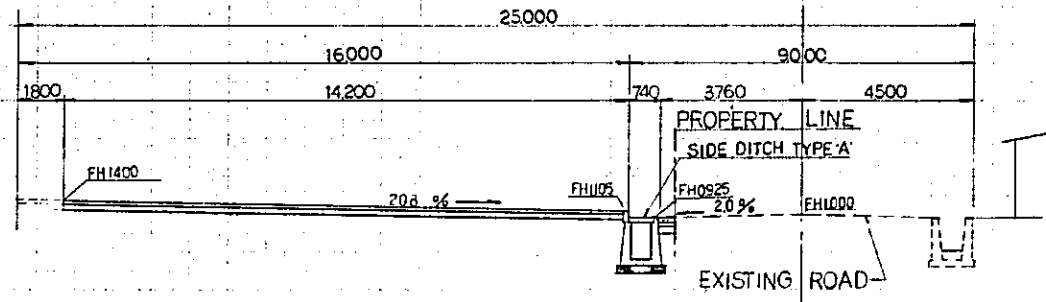

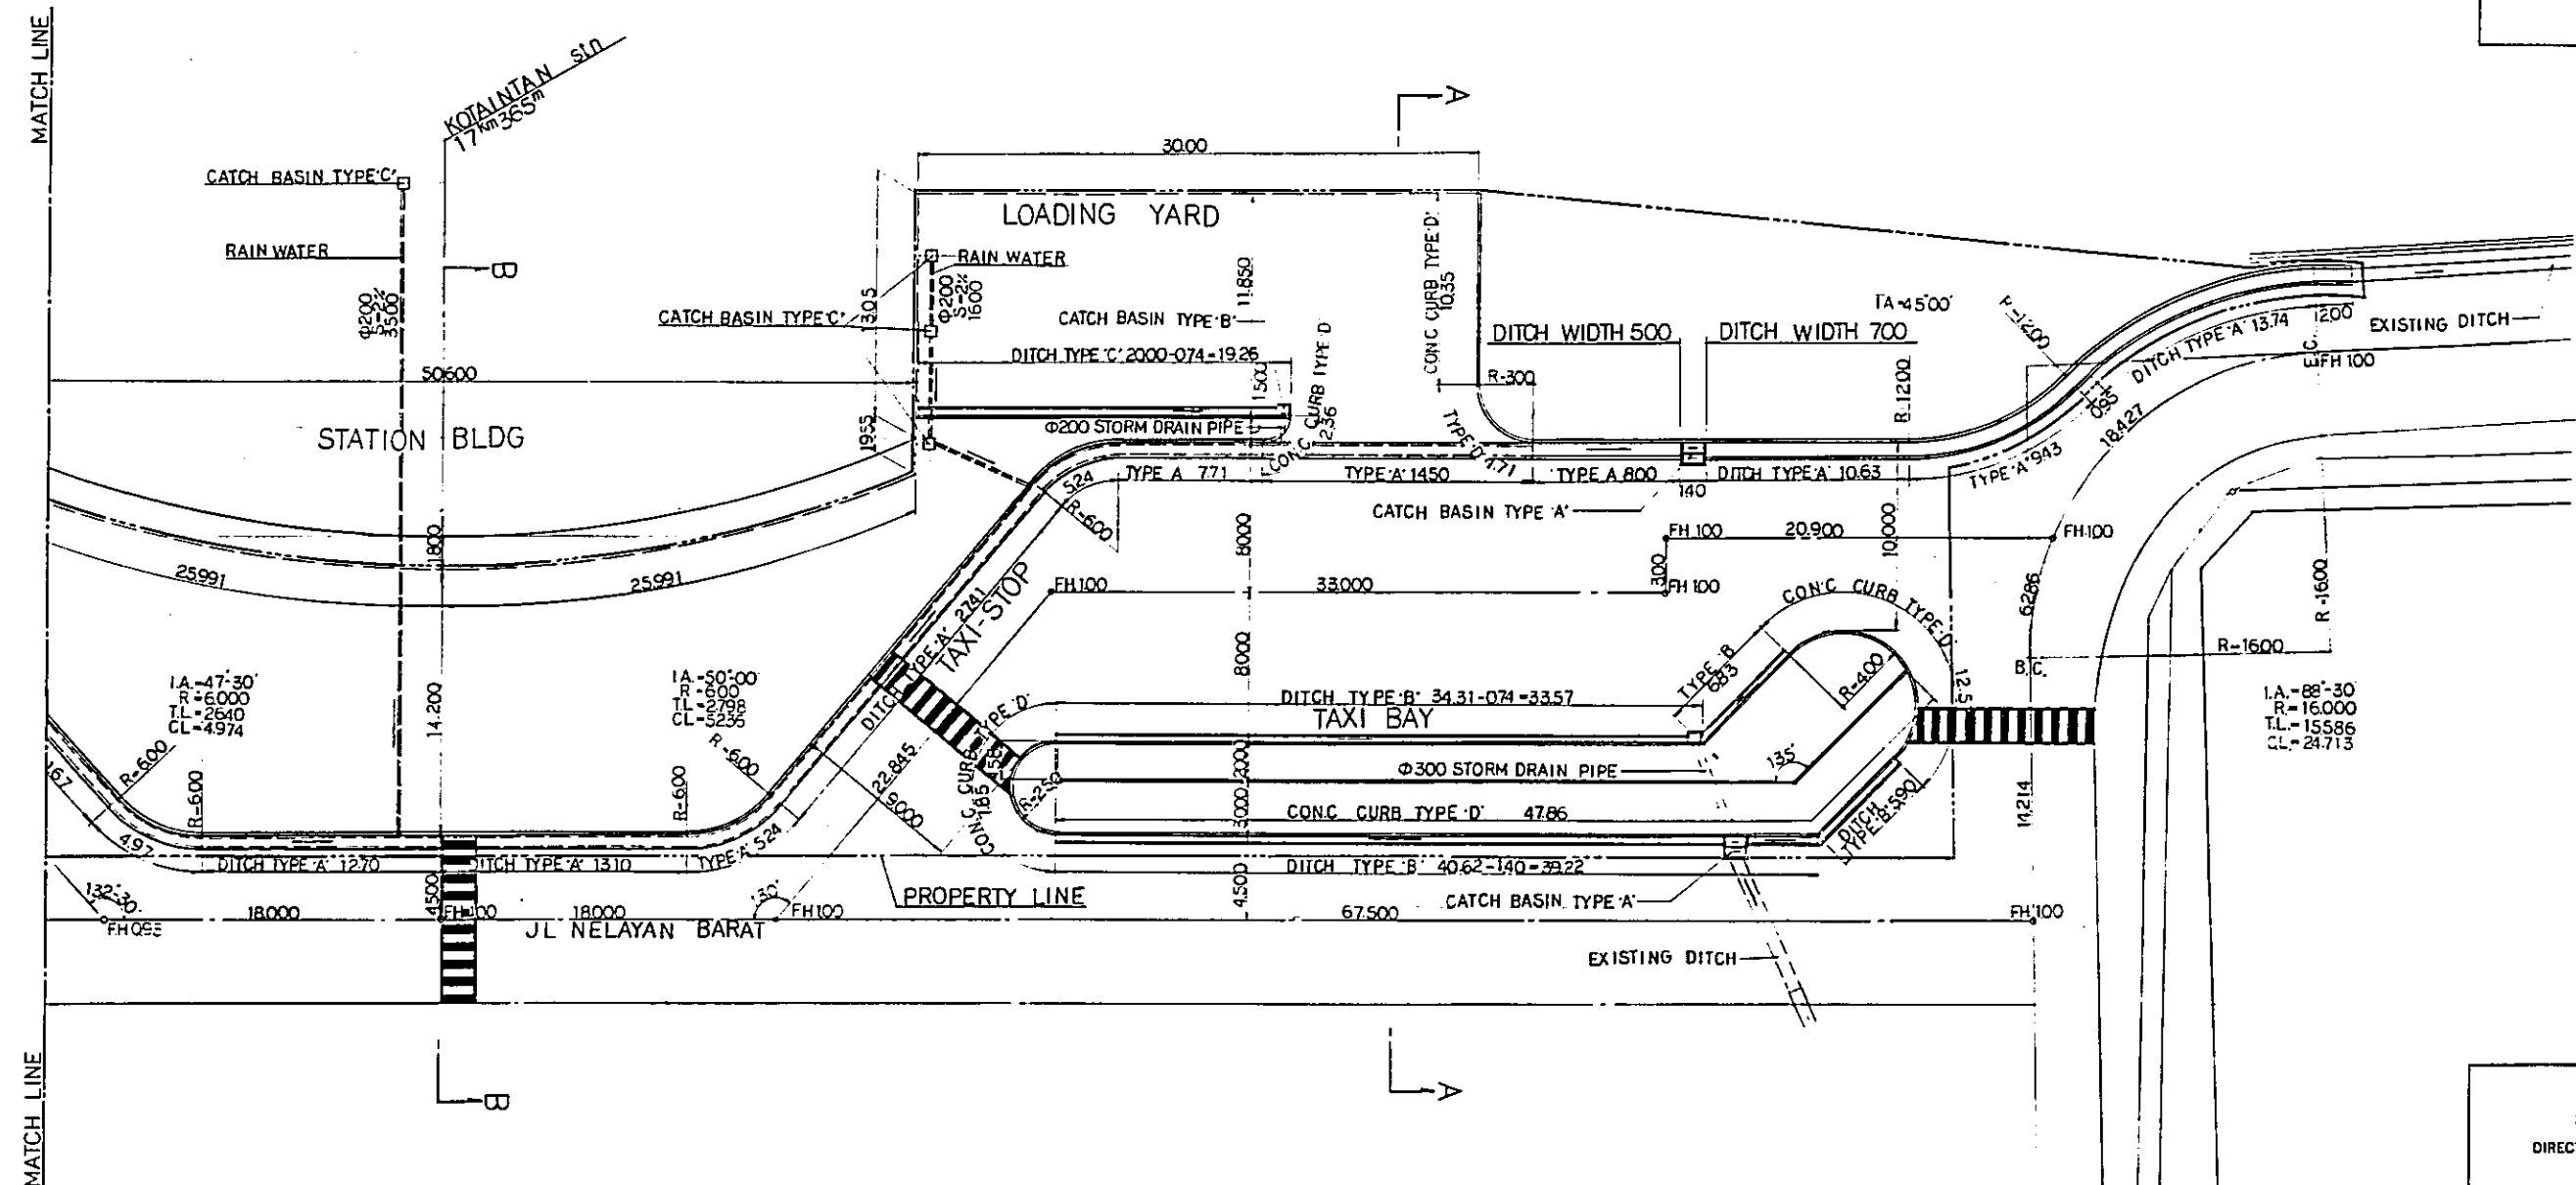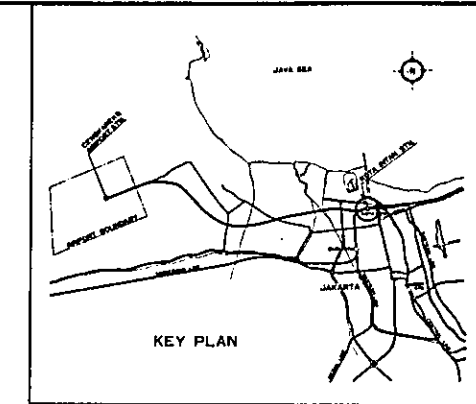
|  |             |                      |       |         |          |
|--|-------------|----------------------|-------|---------|----------|
| REPUBLIC OF INDONESIA<br>MINISTRY OF COMMUNICATIONS<br>DIRECTORATE GENERAL OF LAND TRANSPORT<br>AND INLAND WATERWAYS |             |                      |       |         |          |
| NEW RAILWAY LINE FOR CENGKARENG AIRPORT<br>CONSTRUCTION PROJECT  |             |                      |       |         |          |
| JAPAN INTERNATIONAL COOPERATION AGENCY<br>(JICA)   |             |                      |       |         |          |
| B  | 1 AUG 2011  | DESIGNED             | DRAWN | CHECKED | REVIEWED |
| A  | 15 FEB 2011 | DESIGNED             | DRAWN | CHECKED | REVIEWED |
| REVISIONS  | DATE        | DESIGNED             | DRAWN | CHECKED | REVIEWED |
| KOTA INTAN STATION<br>STATION PLAZA<br>PLAN 2<br>( SHEET 2 OF 2 )  |             |                      |       |         |          |
| PACKAGE: I CIVIL AND ARCHITECTURAL WORK  |             |                      |       |         |          |
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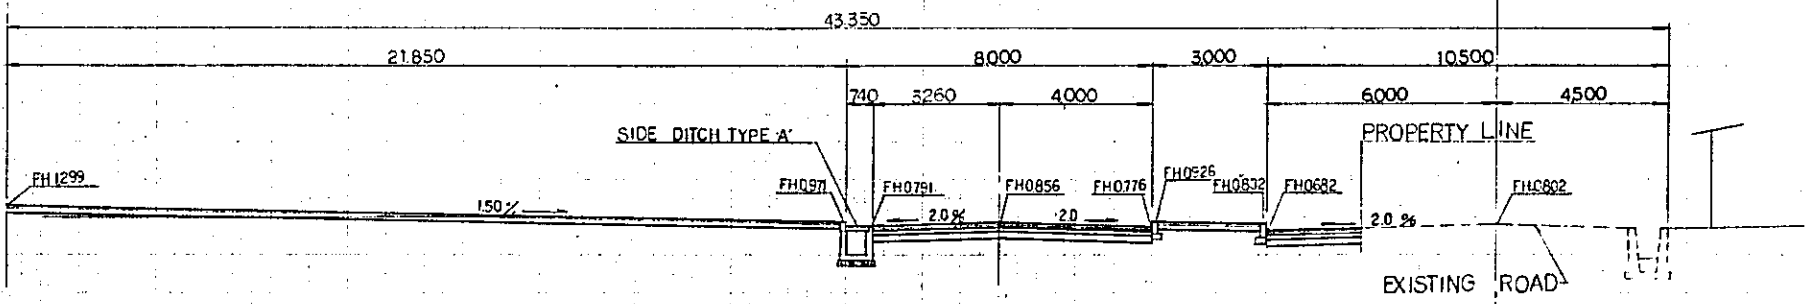





SECTION A-A

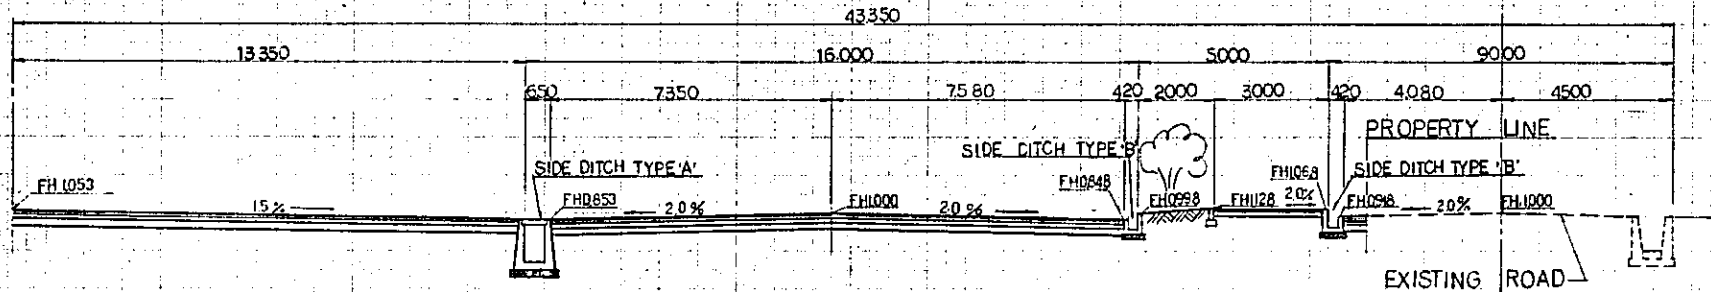

SECTION B-B



SECTION C-C

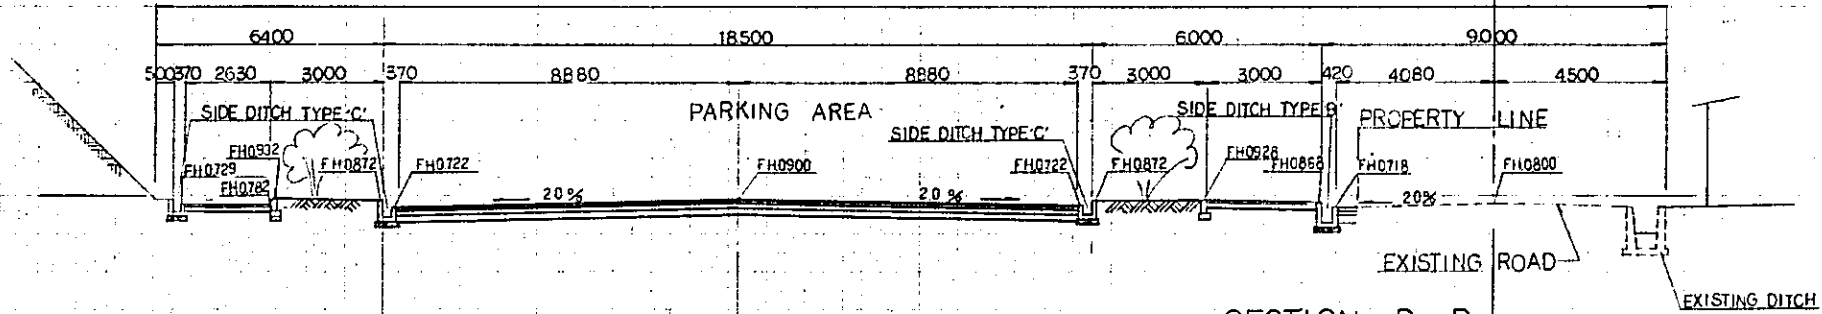

SECTION D-D

REPUBLIC OF INDONESIA  
 MINISTRY OF COMMUNICATIONS  
 DIRECTORATE GENERAL OF LAND TRANSPORT  
 AND INLAND WATERWAYS


NEW RAILWAY LINE FOR CENGKARENG AIRPORT  
 CONSTRUCTION PROJECT

JAPAN INTERNATIONAL COOPERATION AGENCY  
 (JICA)








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|-----------|-----------|----------|----------|---------|----------|
| B         | 1 AUG 85  | S. G. B. | E. B.    | K. M.   | M. K.    |
| A         | 15 FEB 84 | S. G. B. | S. G. B. | K. M.   | M. K.    |
| REVISIONS | DATE      | DESIGNED | DRAWN    | CHECKED | REVIEWED |

KOTA INTAN STATION  
 STATION PLAZA  
 SECTIONS







PACKAGE: I CIVIL AND ARCHITECTURAL WORK  
 SCALE: 1:100      DRAWING NO: AA - 038

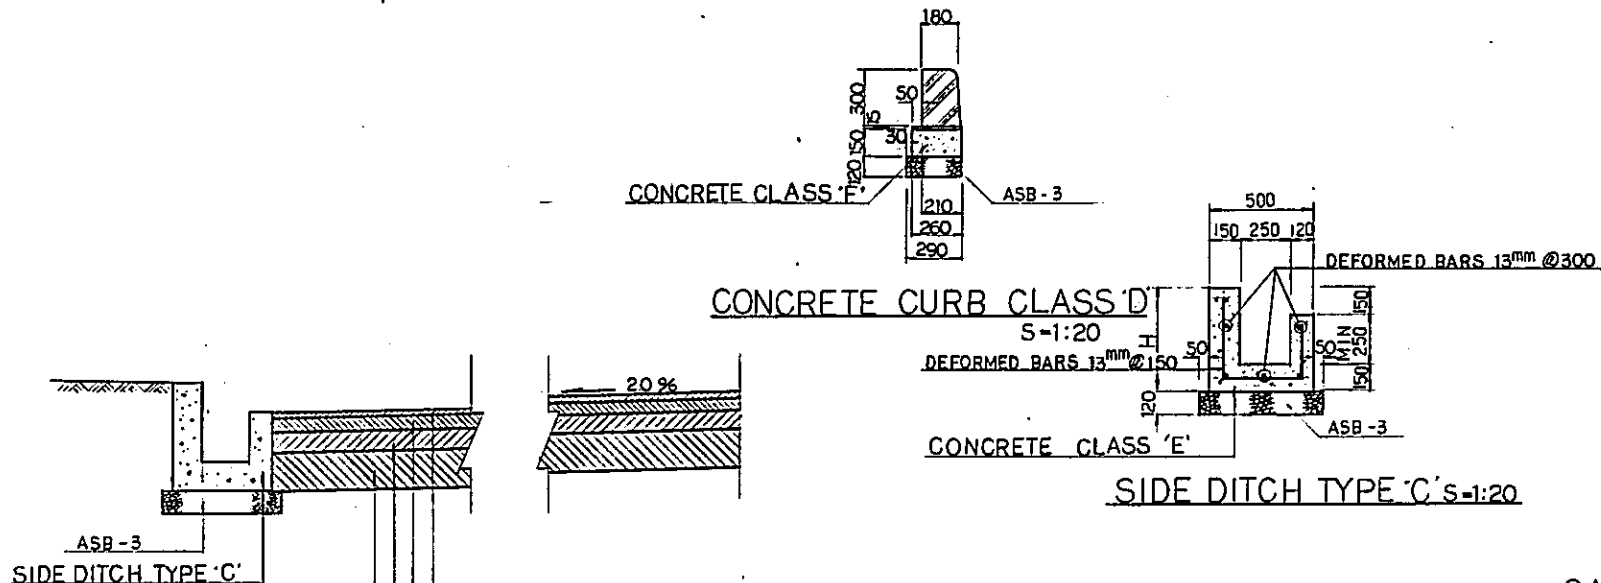



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 7cm ASPHALT CONCRETE BASE TYPE ACB-1  
 10cm ASPHALT CONCRETE BASE TYPE ACB-2  
 20cm ASPHALT STABILIZED BASE ACSB  
 TOTAL 40cm

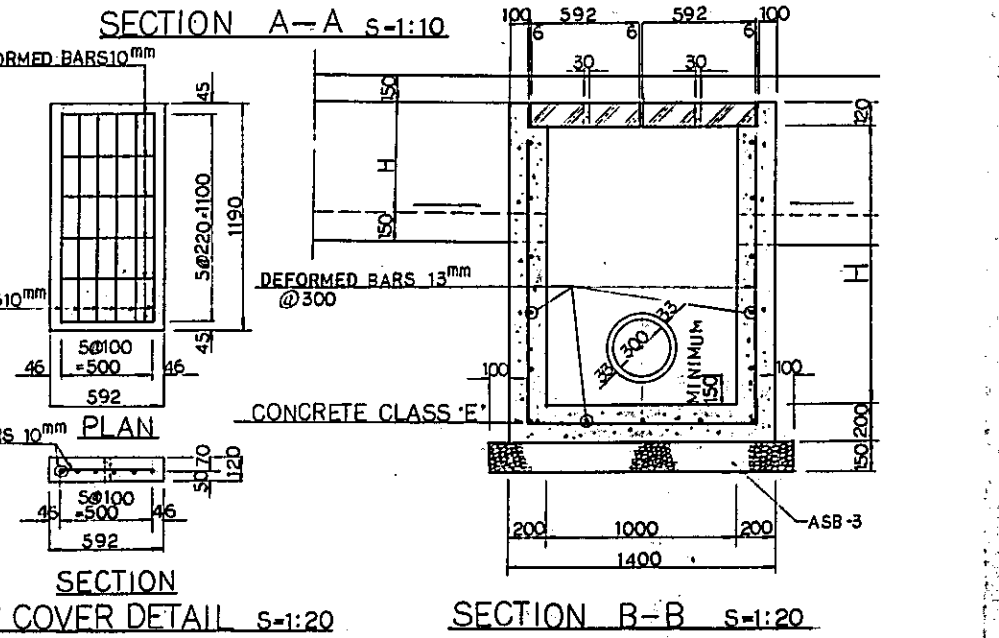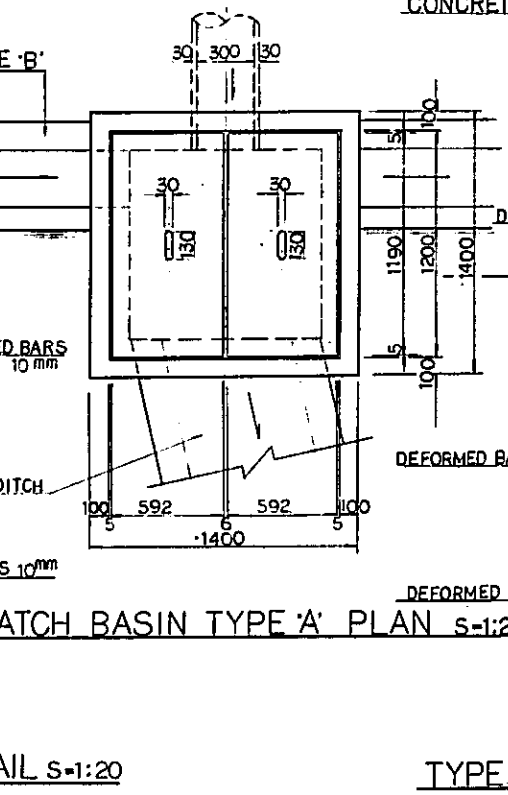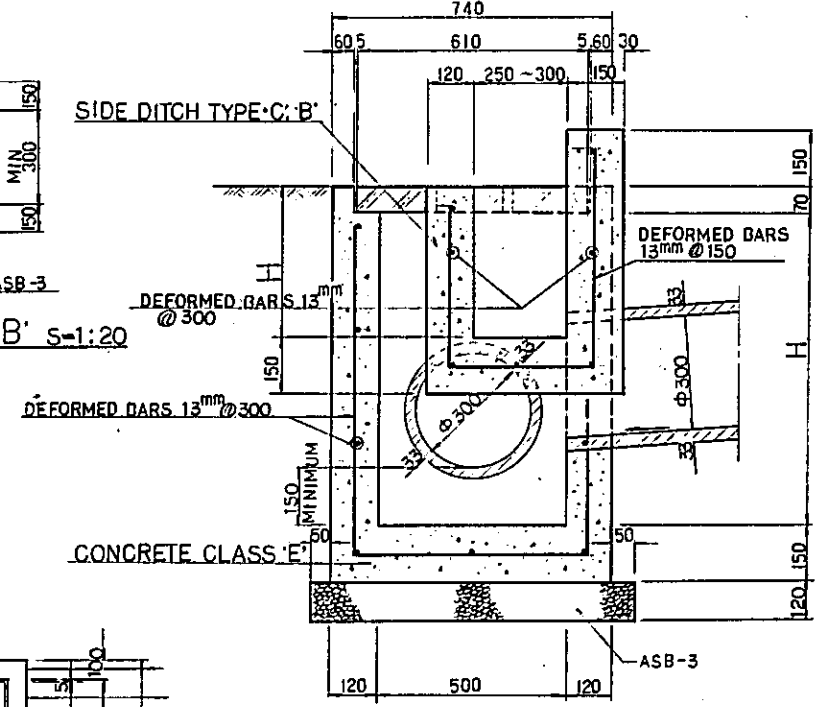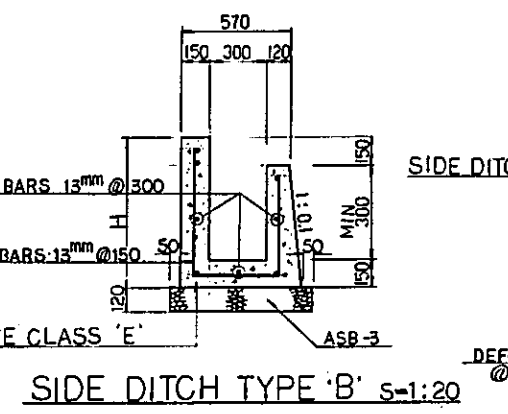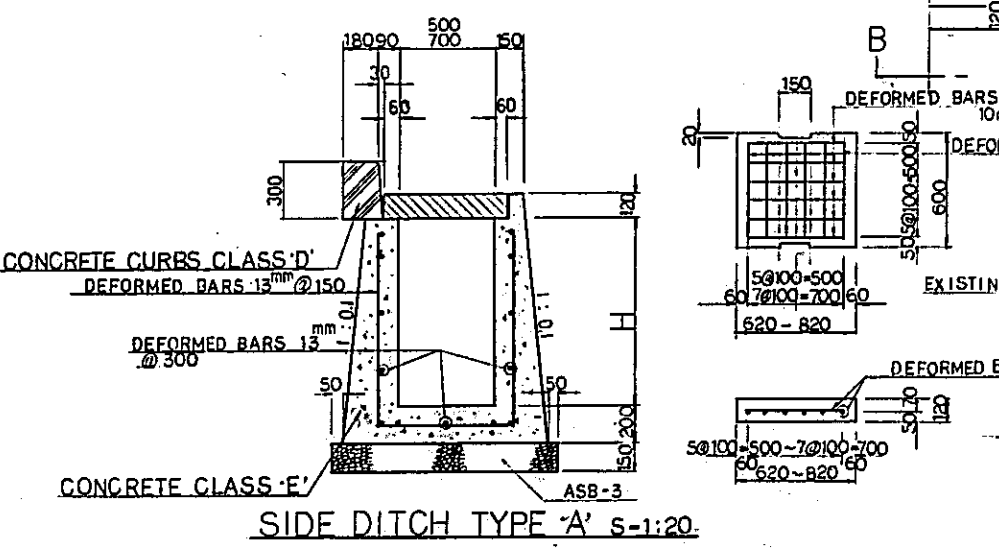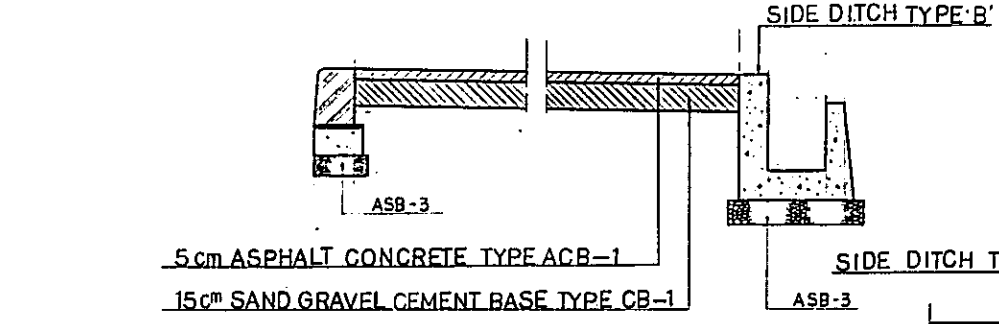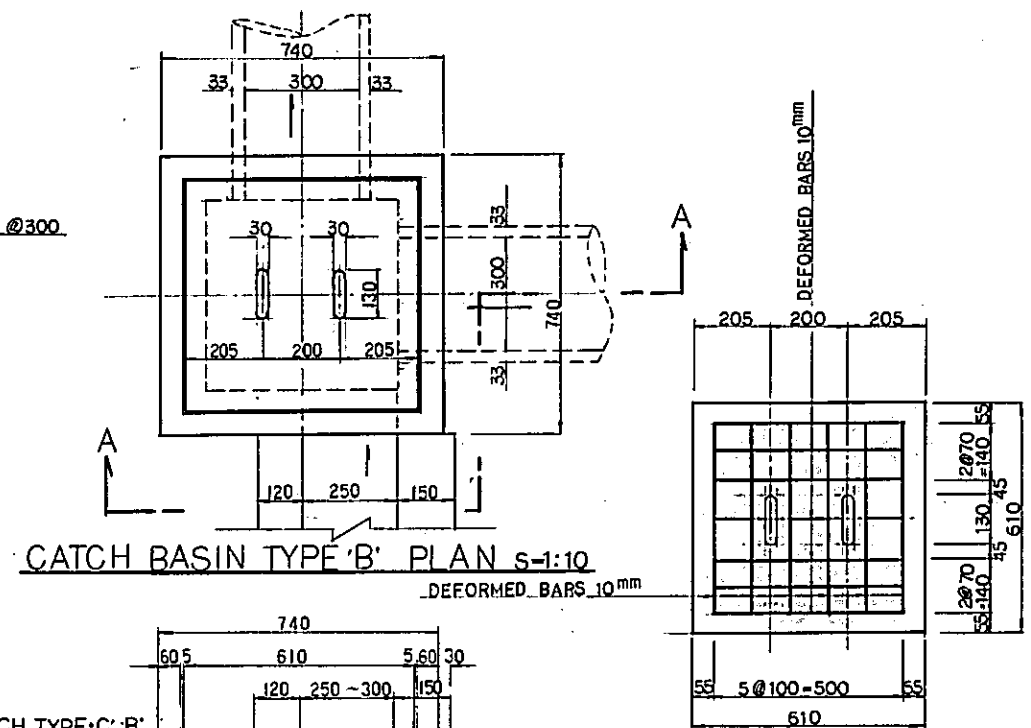


|  |                      |             |             |             |
|--|----------------------|-------------|-------------|-------------|
| REPUBLIC OF INDONESIA<br>MINISTRY OF COMMUNICATIONS<br>DIRECTORATE GENERAL OF LAND TRANSPORT<br>AND INLAND WATERWAYS |                      |             |             |             |
| NEW RAILWAY LINE FOR CENGKARENG AIRPORT<br>CONSTRUCTION PROJECT  |                      |             |             |             |
| JAPAN INTERNATIONAL COOPERATION AGENCY<br>(JICA)   |                      |             |             |             |
| REVISIONS  | DATE                 | DESIGNED    | DRAWN       | CHECKED     |
| B  | 1 AUG 89             | [Signature] | [Signature] | [Signature] |
| A  | 15 FEB 89            | [Signature] | [Signature] | [Signature] |
| KOTA INTAN STATION<br>STATION PLAZA<br>DETAILS   |                      |             |             |             |
| PACKAGE: I CIVIL AND ARCHITECTURAL WORK  |                      |             |             |             |
| SCALE: 1:10, 1:20  | DRAWING NO. AA - 039 |             |             |             |

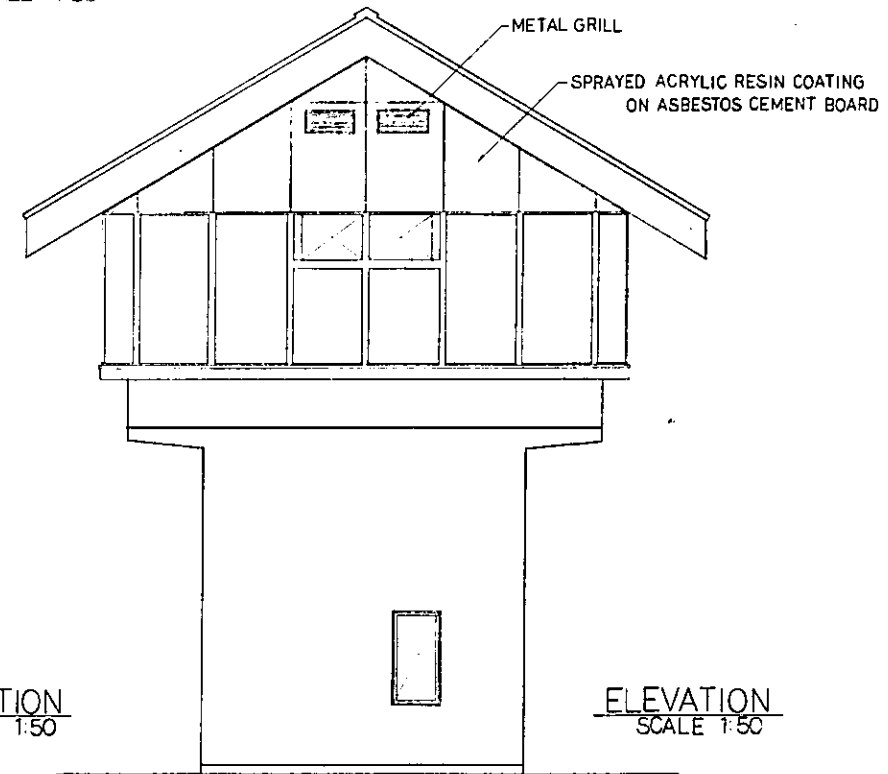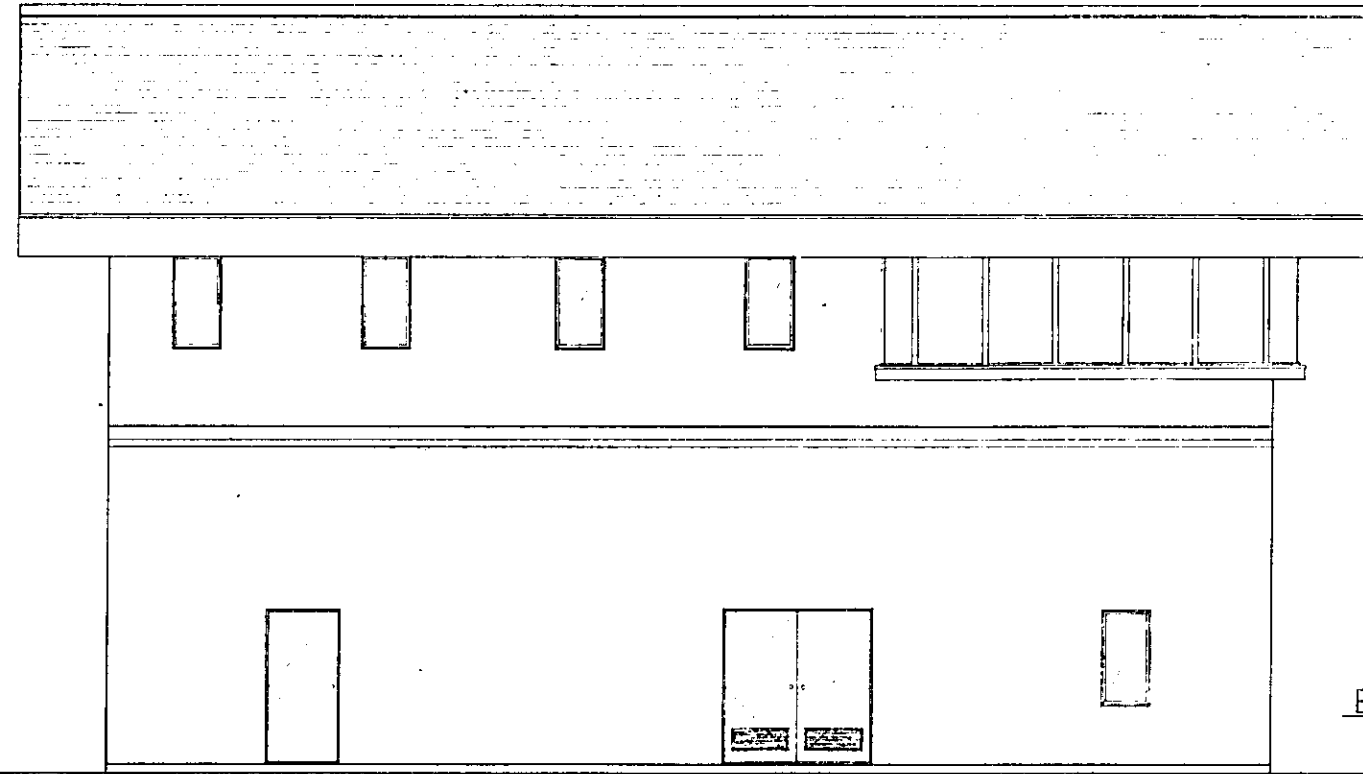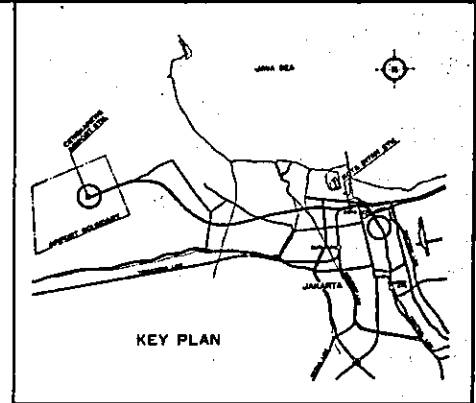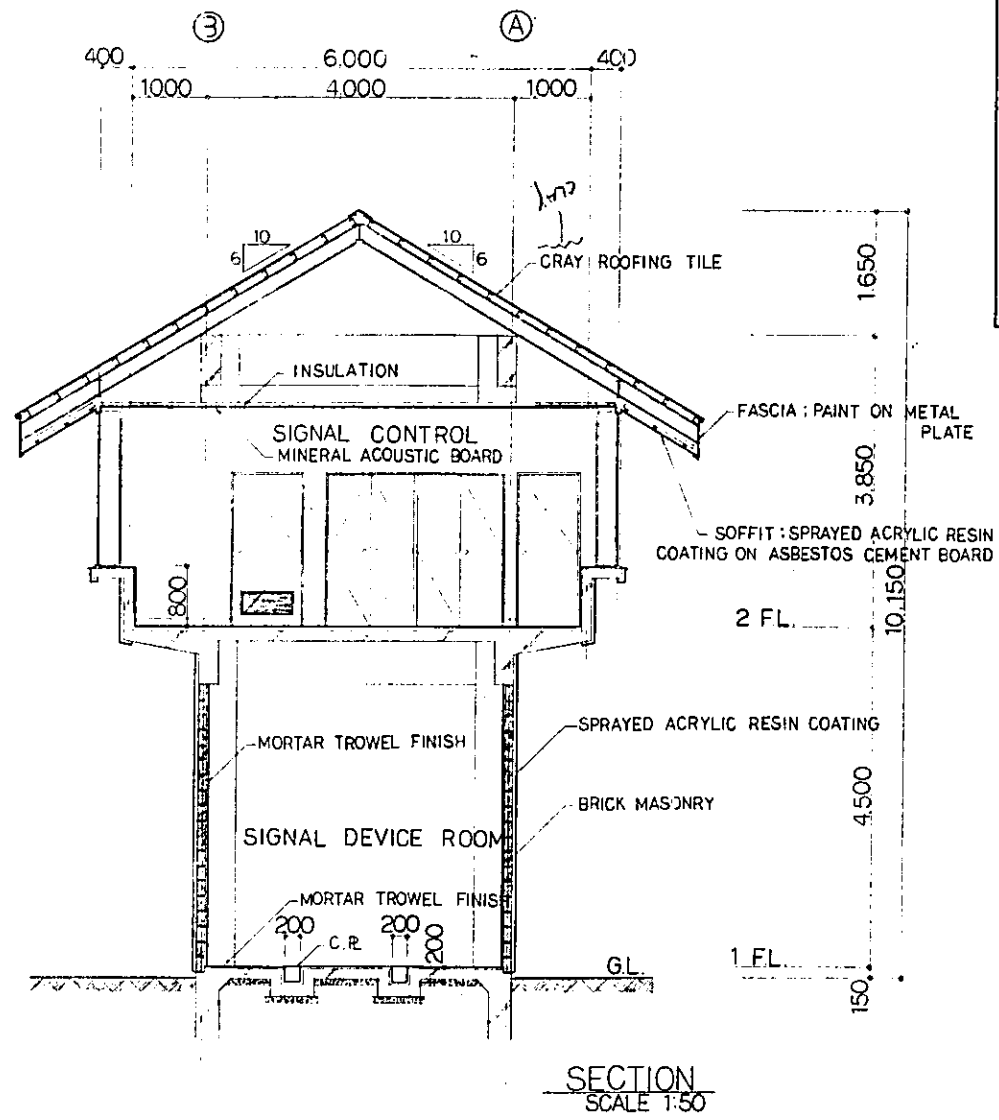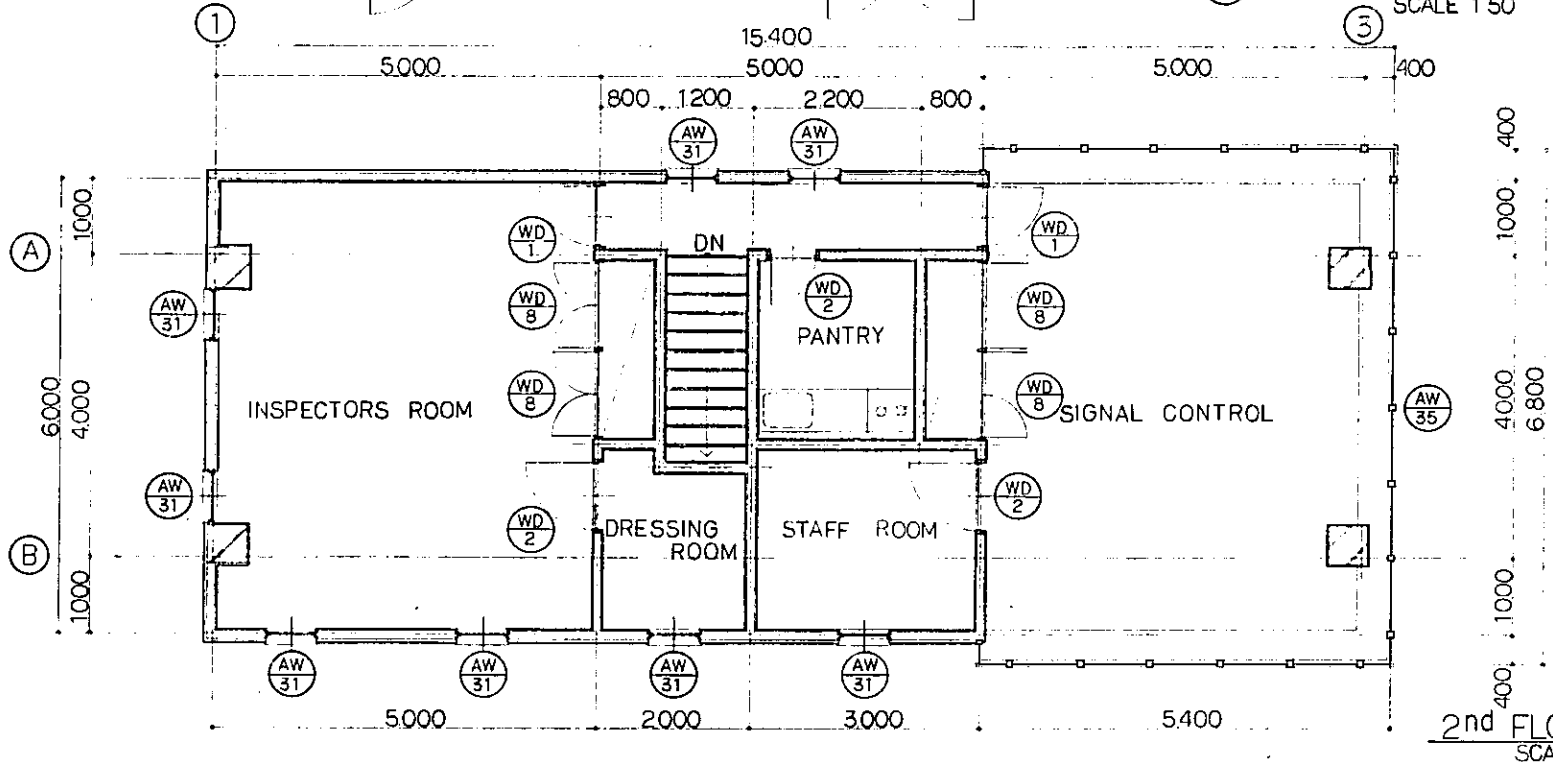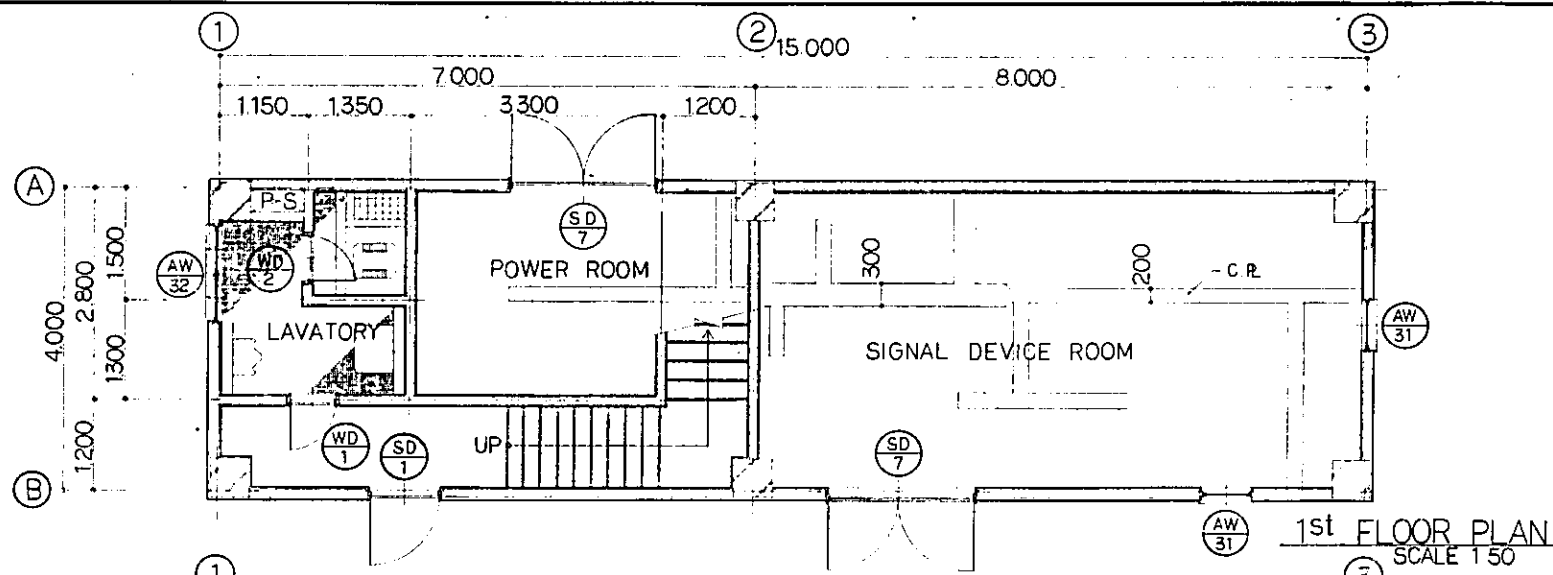


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|--|-----------|----------------------|-------------|-------------|-------------|
| REPUBLIC OF INDONESIA<br>MINISTRY OF COMMUNICATIONS<br>DIRECTORATE GENERAL OF LAND TRANSPORT<br>AND INLAND WATERWAYS |           |                      |             |             |             |
| NEW RAILWAY LINE FOR CENGKARENG AIRPORT<br>CONSTRUCTION PROJECT  |           |                      |             |             |             |
| JAPAN INTERNATIONAL COOPERATION AGENCY<br>(JICA)   |           |                      |             |             |             |
| REVISIONS  | DATE      | DESIGNED             | DRAWN       | CHECKED     | REVIEWED    |
| B  | 1 AUG 88  | [Signature]          | [Signature] | [Signature] | [Signature] |
| A  | 15 FEB 88 | [Signature]          | [Signature] | [Signature] | [Signature] |
| SIGNAL CABIN A   |           |                      |             |             |             |
| PACKAGE: I CIVIL AND ARCHITECTURAL WORK  |           |                      |             |             |             |
| SCALE: 1:50  |           | DRAWING NO: AA - 040 |             |             |             |

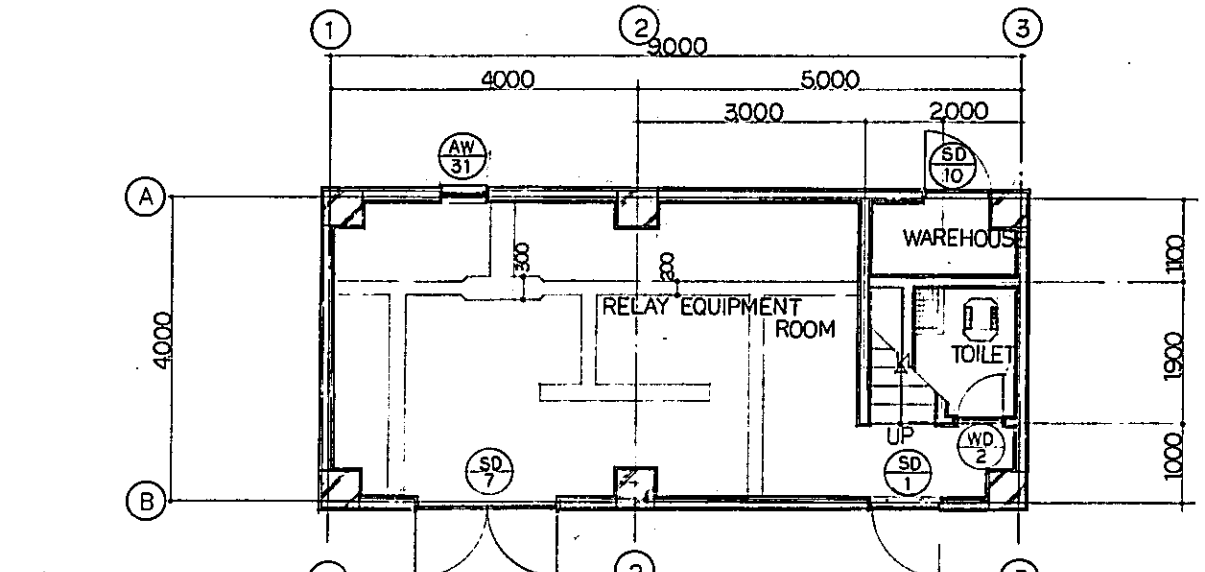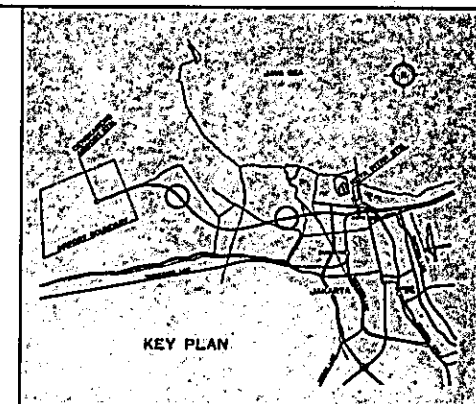


1st FLOOR PLAN  
SCALE 1:50

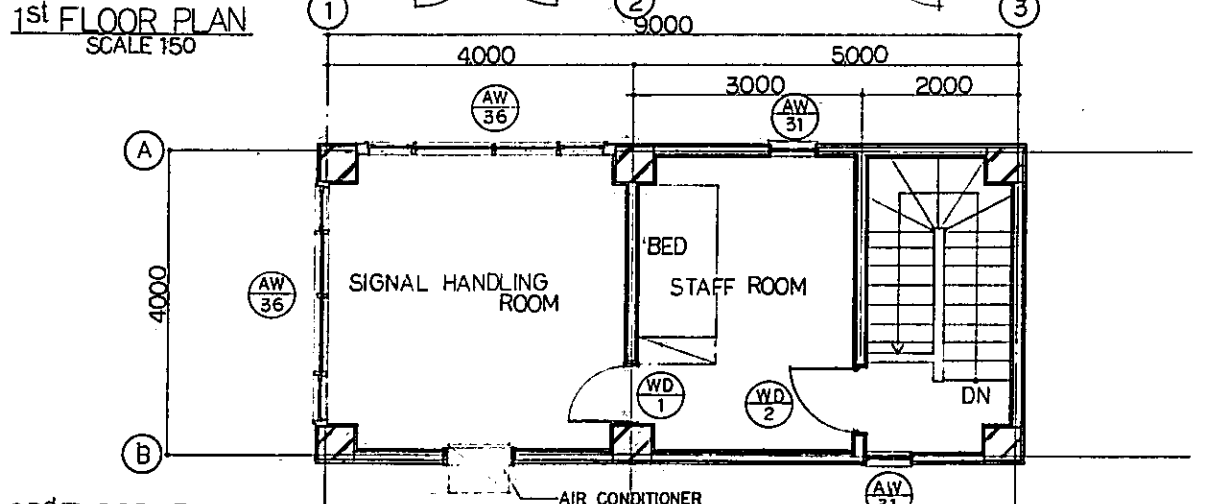


2nd FLOOR PLAN  
SCALE 1:50

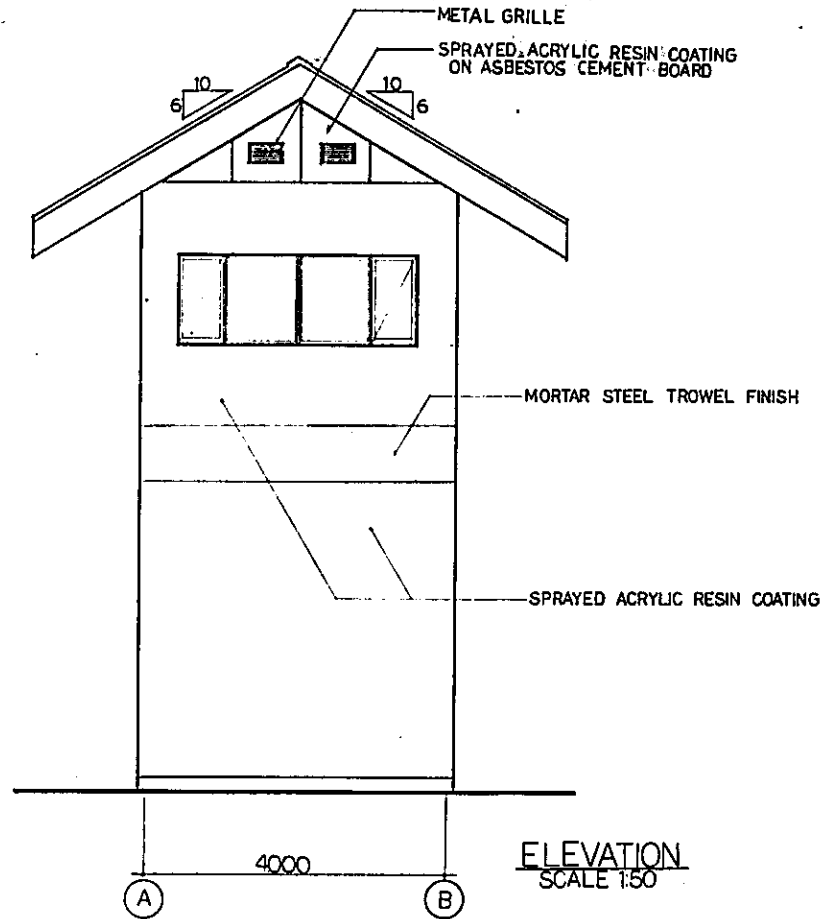

ELEVATION  
SCALE 1:50


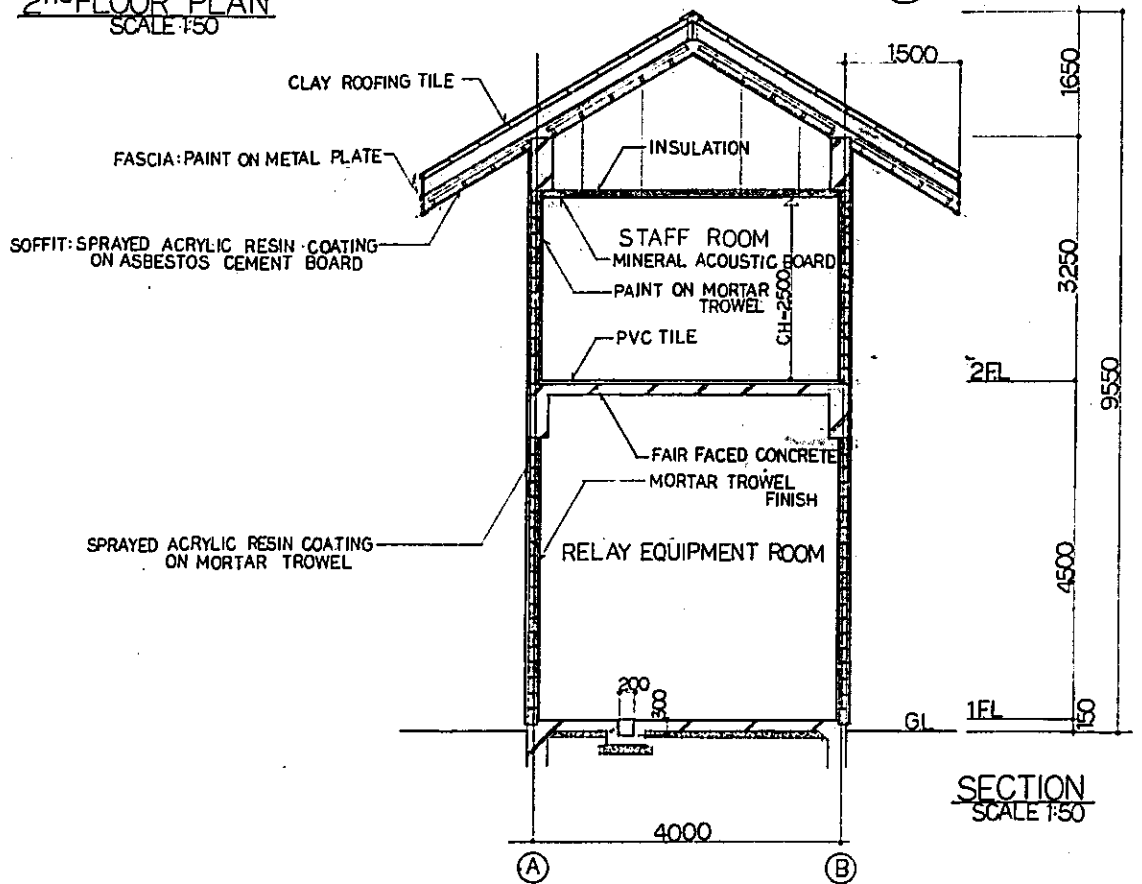


SECTION  
SCALE 1:50

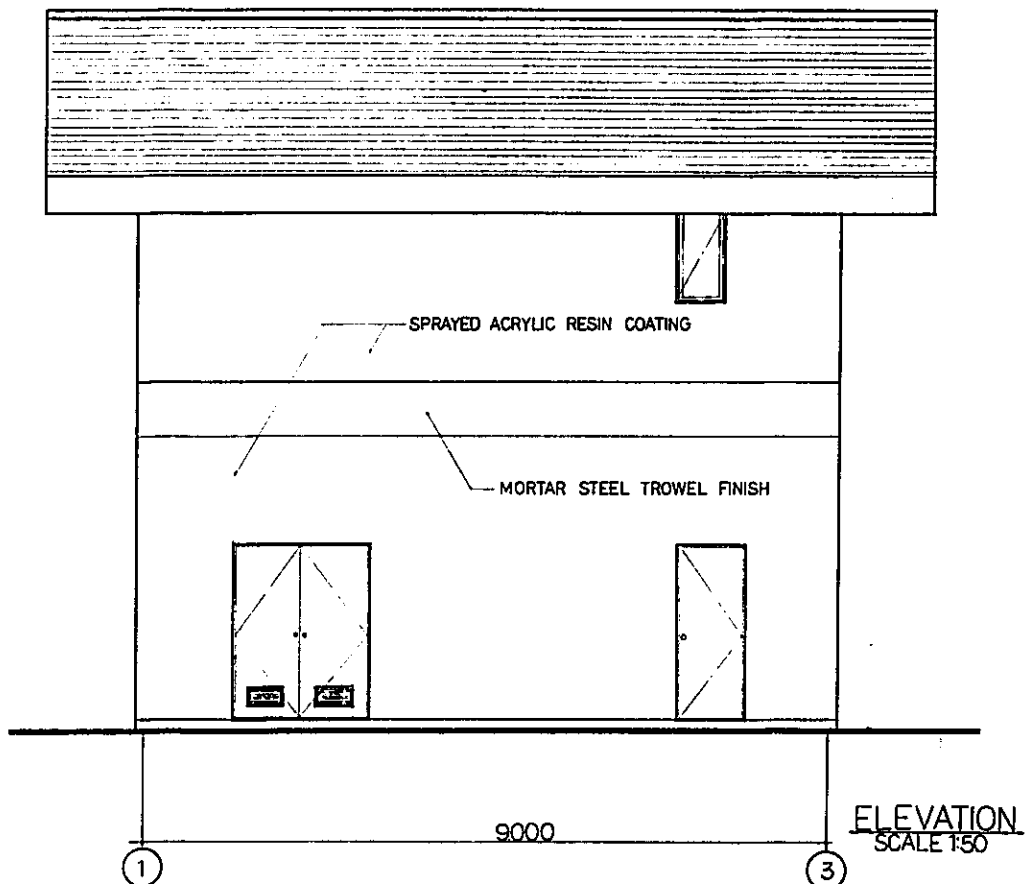


ELEVATION  
SCALE 1:50


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|---|-------------|----------|----------|----------|-----------|
| REPUBLIC OF INDONESIA<br>MINISTRY OF COMMUNICATIONS<br>DIRECTORATE GENERAL OF LAND TRANSPORT AND INLAND WATERWAYS |             |          |          |          |           |
| NEW RAILWAY LINE FOR CENGKARENG AIRPORT<br>CONSTRUCTION PROJECT   |             |          |          |          |           |
| JAPAN INTERNATIONAL COOPERATION AGENCY<br>(JICA)  |             |          |          |          |           |
| REVISIONS   | DATE        | DESIGNED | DRAWN    | CHECKED  | SUBMITTED |
| B   | 1 AUG 88    | Y. M. K. | Y. M. K. | Y. M. K. | Y. M. K.  |
| A   | 15 FEB 88   | Y. M. K. | Y. M. K. | Y. M. K. | Y. M. K.  |
| SIGNAL CABIN B  |             |          |          |          |           |
| PACKAGE: I. CIVIL AND ARCHITECTURAL WORK  |             |          |          |          |           |
| SCALE   | DRAWING NO. |          |          |          |           |
| 1:50  | AA - 041    |          |          |          |           |

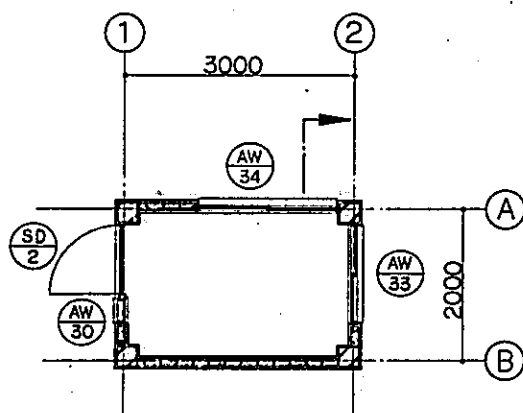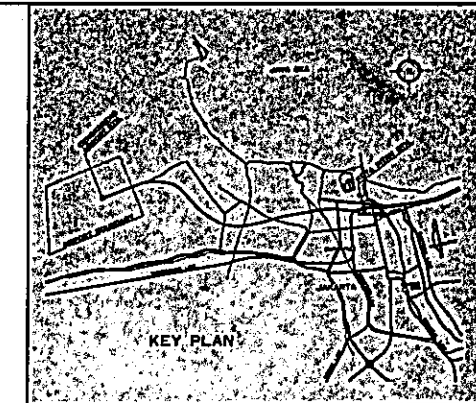


PLAN SCALE 1:50

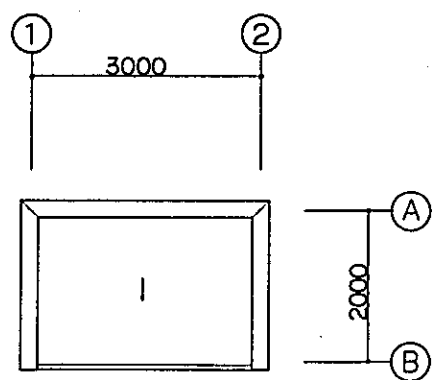


ROOF PLAN SCALE 1:50

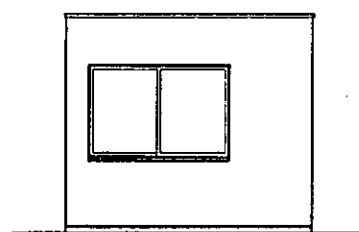


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SCALE 1:50

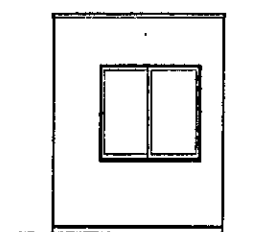


ELEVATION  
SCALE 1:50

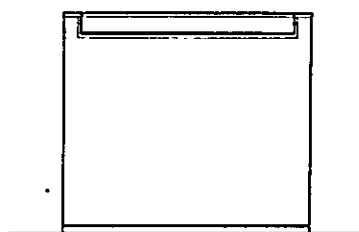

ELEVATION  
SCALE 1:50

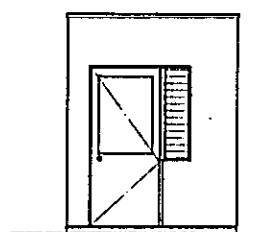

ELEVATION  
SCALE 1:50

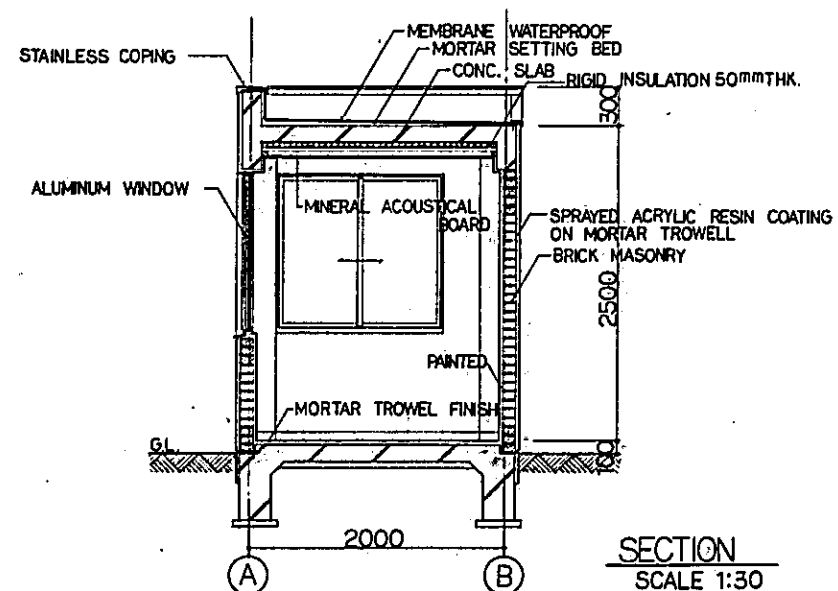


SECTION  
SCALE 1:30

|  |            |             |          |          |          |
|--|------------|-------------|----------|----------|----------|
| REPUBLIC OF INDONESIA<br>MINISTRY OF COMMUNICATIONS<br>DIRECTORATE GENERAL OF LAND TRANSPORT<br>AND INLAND WATERWAYS |            |             |          |          |          |
| NEW RAILWAY LINE FOR CENKARENG AIRPORT<br>CONSTRUCTION PROJECT   |            |             |          |          |          |
| JAPAN INTERNATIONAL COOPERATION AGENCY<br>(JICA)   |            |             |          |          |          |
| B  | 1 AUG 79   | 15/10/79    | 15/10/79 | 15/10/79 | 15/10/79 |
| A  | 15 FEB 79  | 15/10/79    | 15/10/79 | 15/10/79 | 15/10/79 |
| REVISIONS  | DATE       | DESIGNED    | DRAWN    | CHECKED  | APPROVED |
| CROSSING WATCHMAN'S BOX  |            |             |          |          |          |
| PACKAGE: I - CIVIL AND ARCHITECTURAL WORK  |            |             |          |          |          |
| SCALE  | 1:30, 1:50 | DRAWING NO. | AA - 042 |          |          |

DOOR AND WINDOW SCHEDULE - I

| MARK  | TYPE | LOCATION                 | DIMENSION |           |        |        |           |                |                   |                  |                 |          | GRADE  |       | DOOR AND WINDOW |                 |        |        | FRAME       |      |      |         | HARDWARE |          |          |           |                 |             |       |            |            |                  |             | REMARKS |       |                |            |           |       |      |       |                    |
|---|
|       |      |                          | QUANTITY  | UNDER CUT |        | HEIGHT | THICKNESS | SOUND PROOFING | FIRE RATING (FRR) | THK OF FASER SHT | EXPLOSION PROOF | MATERIAL | FINISH | WIDTH | HEIGHT          | GLAZING THK=6MM |        | LOUVER | DETAIL MARK |      |      |         | LOCK SET |          |          | HINGE     |                 | CLOSER      |       | PUSH PLATE | FLUSH BOLT | TRACK AND BOTTOM | HANGER RAIL |         | PLACE | TOTAL QUANTITY |            |           |       |      |       |                    |
|       |      |                          |           | WIDTH     | HEIGHT |        |           |                |                   |                  |                 |          |        |       |                 | WIDTH           | HEIGHT |        | HEAD        | JAMB | SILL | TRANSOM | MEETING  | CYLINDER | DEADLOCK | DEADLATCH | MORTISE BIT KEY | SWING LATCH | PIVOT |            |            |                  |             |         |       |                | BUTT 127mm | BUTT 65mm | FLOOR | DOOR | FLOOR | STOPPER AND HOLDER |
| AW-1  | A    | AIRPORT TERMINAL STATION | -         | 600       | 1300   |        |           |                |                   |                  |                 |          |        |       |                 | ALUM            |        |        |             |      |      |         |          |          |          |           |                 |             |       |            |            |                  |             |         |       | 10             |            |           |       |      |       |                    |
| AW-2  | B    |                          | 7         | 900       | 1300   |        |           7              |            |           |       |      |       |                    |
| AW-3  | C    |                          | 1         | 1100      | 1300   |        |           1              |            |           |       |      |       |                    |
| AW-4  | B    |                          | 5         | 1200      | 1300   |        |           10         |           |       |      |       |                    |
| AW-5  | A    |                          | 4         | 1200      | 450    |        |           8          |           |       |      |       |                    |
| AW-6  | A    |                          | -         | 1600      | 450    |        |           7          |           |       |      |       |                    |
| AW-7  | E    |                          | -         | 1600      | 3000   |        |           -          |           |       |      |       |                    |
| AW-8  | F    |                          | 1         | 1800      | 1340   |        |           1         |       |      |       |                    |
| AW-9  | A    |                          | 5         | 2100      | 600    |        |           5         |       |      |       |                    |
| AW-10 | E    |                          | -         | 2400      | 1300   |        |           4         |       |      |       |                    |
| AW-11 | G    |                          | 1         | 2700      | 1400   |        |           2         |       |      |       |                    |
| AW-12 | E    |                          | 1         | 3000      | 1300   |        |           1     |      |       |                    |
| AW-13 | E    |                          | 1         | 4000      | 1300   |        |           1     |      |       |                    |
| AW-14 | H    |                          | 1         | 4800      | 1400   |        |           2     |      |       |                    |
| AW-15 | D    | AIRPORT TERMINAL STATION | 1         | 1800      | 2300   |        |           1    |       |                    |
| AW-20 | I    | KOTA INTAN STATION       | 7         | 600       | 1500   |        |           7     |      |       |                    |
| AW-21 | I    |                          | 5         | 600       | 1800   |        |           5    |       |                    |
| AW-22 | C    |                          | 1         | 1650      | 1200   |        |           1    |       |                    |
| AW-23 | D    |                          | 1         | 4400      | 2500   |        |           1    |       |                    |
| AW-24 | J    |                          | 1         | 6000      | 4350   |        |           1    |       |                    |
| AW-25 | K    |                          | 1         | 9500      | 1500   |        |           1    |       |                    |
| AW-26 | C    | KOTA INTAN STATION       | 4         | 1800      | 900    |        |           4     |                    |

DOOR AND WINDOW TYPES

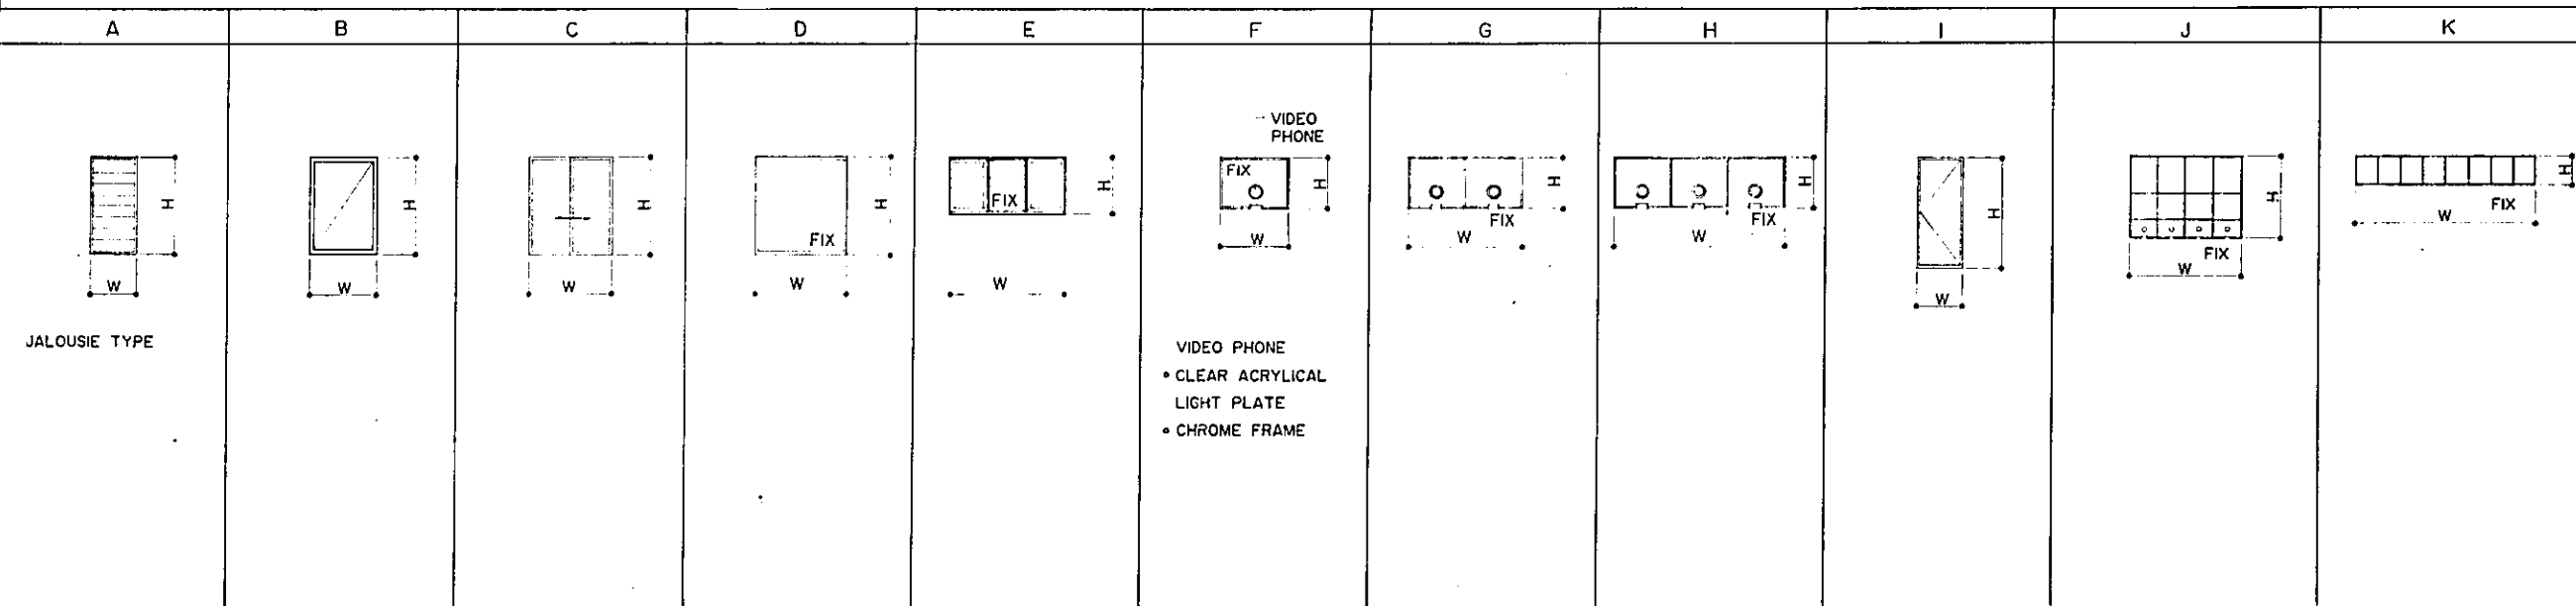

REPUBLIC OF INDONESIA  
MINISTRY OF COMMUNICATIONS  
DIRECTORATE GENERAL OF LAND TRANSPORT AND INLAND WATERWAYS

NEW RAILWAY LINE FOR CENKARENG AIRPORT  
CONSTRUCTION PROJECT

JAPAN INTERNATIONAL COOPERATION AGENCY (JICA)

|   |           |       |       |      |      |      |
|---|-----------|-------|-------|------|------|------|
| B | 1 AUG 88  | E.M.  | S. K. | E.M. | K.M. | M.K. |
| A | 15 FEB 88 | S. K. | S. K. | E.M. | K.M. | M.K. |

REVISIONS    DATE    DESIGNED    DRAWN    CHECKED    REVIEWED    SUBMITTED


DOOR AND WINDOW SCHEDULE  
( SHEET 1 OF 2 )

PACKAGE: I CIVIL AND ARCHITECTURAL WORK  
SCALE: NONE    DRAWING NO: AA - 043

DOOR AND WINDOW SCHEDULE - 2

| MARK  | TYPE | LOCATION                 | QUANTITY | DIMENSION       |        |        | GRADE | DOOR AND WINDOW |                |                   |                  | FRAME           |        |       |               | HARDWARE |               |      |      |       |                    |         |              |  |                            |       | TOTAL QUANTITY | REMARKS |             |  |       |  |    |    |    |                         |    |
|-------|------|--------------------------|----------|-----------------|--------|--------|-------|-----------------|----------------|-------------------|------------------|-----------------|--------|-------|---------------|----------|---------------|------|------|-------|--------------------|---------|--------------|--|----------------------------|-------|----------------|---------|-------------|--|-------|--|----|----|----|-------------------------|----|
|       |      |                          |          | UNDER CUT       | WIDTH  | HEIGHT |       | THICKNESS       | SOUND PROOFING | FIRE RATING (HFR) | TKK OF FASER SHT | EXPLOSION PROOF | FINISH | WIDTH | HEIGHT ( H' ) | WIDTH    | HEIGHT ( H' ) | HEAD | JAMB | SILL  | TRANSOM            | MEETING | LOCK SET     |  |                            | HINGE |                |         | CLOSER      |  |       |  |    |    |    |                         |    |
|       |      |                          |          | GLAZING THK=6MM | LOUVER |        |       | DETAIL MARK     |                |                   |                  | PIVOT           |        |       | BUTT 127mm    |          | BUTT 65mm     |      | DOOR | FLOOR | STOPPER AND HOLDER |         | PUSH PLATE   |  | FLUSH BOT (TOP AND BOTTOM) |       | TRACK RAIL     |         | HANGER RAIL |  | PLACE |  |    |    |    |                         |    |
| AW-30 | A    | CROSSING WATCHMAN'S BOX  | 1        | 300             | 1200   |        |       |                 |                | ALUM              | -                |                 |        |       | ALUM          | -        |               |      |      |       | ASSEMBLY           | BY      | MANUFACTURER |  |                            |       |                |         |             |  |       |  | 15 | 15 |    |                         |    |
| AW-31 | B    | SIGNAL CABIN             | 17       | 600             | 1200   |        |       |                 |                |                   |                  |                 |        |       |               |          |               |      |      |       |                    | DO      |              |  |                            |       |                |         |             |  |       |  | 2  | 34 |    |                         |    |
| AW-32 | A    | SIGNAL CABIN             | 1        | 1200            | 450    |        |       |                 |                |                   |                  |                 |        |       |               |          |               |      |      |       |                    | DO      |              |  |                            |       |                |         |             |  |       |  | 2  | 2  |    |                         |    |
| AW-33 | C    | CROSSING WATCHMAN'S BOX  | 1        | 1200            | 1200   |        |       |                 |                |                   |                  |                 |        |       |               |          |               |      |      |       |                    | DO      |              |  |                            |       |                |         |             |  |       |  | 15 | 15 |    |                         |    |
| AW-34 | C    | CROSSING WATCHMAN'S BOX  | 1        | 1800            | 1200   |        |       |                 |                |                   |                  |                 |        |       |               |          |               |      |      |       |                    | DO      |              |  |                            |       |                |         |             |  |       |  | 15 | 15 |    |                         |    |
| AW-35 | L    | SIGNAL CABIN             | 1        | 18200           | 2000   |        |       |                 |                |                   |                  |                 |        |       |               |          |               |      |      |       |                    | DO      |              |  |                            |       |                |         |             |  |       |  | 2  | 2  |    |                         |    |
| AW-36 | E    | SIGNAL CABIN             | 2        | 3100            | 1200   |        |       |                 |                | ALUM              | -                |                 |        |       | ALUM          | -        |               |      |      |       | ASSEMBLY           | BY      | MANUFACTURER |  |                            |       |                |         |             |  |       |  |    | 2  | 4  |                         |    |
| SD-1  | M    | COMMON                   | -        | 900             | 2100   | 45     |       |                 | STEEL          | PANT              |                  |                 |        |       | STEEL         | PANT     |               |      |      |       |                    | ③       |              |  |                            |       |                |         |             |  |       |  |    | -  | 16 | COMMON TO ALL BUILDINGS |    |
| SD-2  | N    | DO                       | -        | 900             | 2100   | 45     |       |                 |                |                   | 700              | 930             |        |       |               |          |               |      |      |       |                    | ③       |              |  |                            |       |                |         |             |  |       |  |    |    | -  | 33                      | DO |
| SD-3  | O    | DO                       | -        | 900             | 2100   | 45     |       |                 |                |                   |                  |                 | 700    | 350   |               |          |               |      |      |       |                    | ③       |              |  |                            |       |                |         |             |  |       |  |    | -  | 7  | COMMON TO ALL BUILDINGS |    |
| SD-4  | P    | DO                       | 4        | 900             | 2100   | 45     |       |                 |                |                   |                  |                 | 700    | 930   | 700           | 800      |               |      |      |       |                    | ③       |              |  |                            |       |                |         |             |  |       |  |    | 1  | 4  |                         |    |
| SD-5  | Q    | KOTA INTAN STATION       | 1        | 900             | 2500   | 45     |       |                 |                |                   |                  |                 | 700    | 930   | 700           | 800      |               |      |      |       |                    | ⑤       |              |  |                            |       |                |         |             |  |       |  |    | 1  | 1  |                         |    |
| SD-6  | R    | KOTA INTAN STATION       | 4        | 1800            | 2100   | 45     |       |                 |                |                   |                  |                 |        |       |               |          |               |      |      |       |                    | ⑥       |              |  |                            |       |                |         |             |  |       |  |    | 1  | 4  |                         |    |
| SD-7  | S    | COMMON                   | -        | 1800            | 2100   | 45     |       |                 |                |                   |                  |                 | 700    | 350   |               |          |               |      |      |       |                    | ⑥       |              |  |                            |       |                |         |             |  |       |  |    | -  | 12 | COMMON TO ALL BUILDINGS |    |
| SD-8  | M    | COMMON                   | -        | 900             | 1500   | 45     |       |                 |                |                   |                  |                 |        |       |               |          |               |      |      |       |                    | ②       |              |  |                            |       |                |         |             |  |       |  |    | -  | 3  | COMMON TO ALL BUILDINGS |    |
| SD-9  | M    | AIRPORT TERMINAL STATION | 1        | 650             | 2100   | 45     |       |                 |                |                   |                  |                 |        |       |               |          |               |      |      |       |                    | ②       |              |  |                            |       |                |         |             |  |       |  |    | 1  | 1  |                         |    |
| SD-10 | O    | SIGNAL CABIN             | 1        | 900             | 1800   | 45     |       |                 | STEEL          | PANT              |                  |                 | 600    | 300   | STEEL         | PANT     |               |      |      |       |                    | ②       |              |  |                            |       |                |         |             |  |       |  |    | 2  | 2  |                         |    |
| WD-1  | M    | COMMON                   | -        | 750             | 2100   | 45     |       |                 | WOOD           | PANT              |                  |                 |        |       | WOOD          | PANT     |               |      |      |       |                    | ③       |              |  |                            |       |                |         |             |  |       |  |    | -  | 36 | COMMON TO ALL BUILDINGS |    |
| WD-2  | O    | SIGNAL CABIN             | 5        | 750             | 2100   | 45     |       |                 |                |                   |                  | 550             | 250    |       |               |          |               |      |      |       |                    | ③       |              |  |                            |       |                |         |             |  |       |  |    | 2  | 10 |                         |    |
| WD-3  | M    | COMMON                   | -        | 100             | 600    | 2100   | 45    |                 |                |                   |                  |                 |        |       |               |          |               |      |      |       |                    | ③       |              |  |                            |       |                |         |             |  |       |  |    | -  | 32 | COMMON TO ALL BUILDINGS |    |
| WD-4  | M    | AIRPORT TERMINAL STATION | 2        | 400             | 2100   | 45     |       |                 |                |                   |                  |                 |        |       |               |          |               |      |      |       |                    | ③       |              |  |                            |       |                |         |             |  |       |  |    | 1  | 2  |                         |    |
| WD-5  | T    | KOTA INTAN STATION       | 1        | 900             | 2100   | 45     |       |                 |                |                   |                  |                 |        |       |               |          |               |      |      |       |                    | ⑥       |              |  |                            |       |                |         |             |  |       |  |    | 1  | 1  |                         |    |
| WD-6  | R    | AIRPORT TERMINAL STATION | 1        | 1400            | 2100   | 45     |       |                 |                |                   |                  |                 |        |       |               |          |               |      |      |       |                    | ⑥       |              |  |                            |       |                |         |             |  |       |  |    | 1  | 1  |                         |    |
| WD-7  | M    | COMMON                   | 1        | 700             | 700    | 30     |       |                 |                |                   |                  |                 |        |       |               |          |               |      |      |       |                    | ②       |              |  |                            |       |                |         |             |  |       |  |    | 1  | 1  |                         |    |
| WD-8  | R    | SIGNAL CABIN             | 4        | 1100            | 2100   | 45     |       |                 | WOOD           | PANT              |                  |                 |        |       | WOOD          | PANT     |               |      |      |       |                    | ⑥       |              |  |                            |       |                |         |             |  |       |  |    | 2  | 8  |                         |    |

DOOR AND WINDOW TYPE

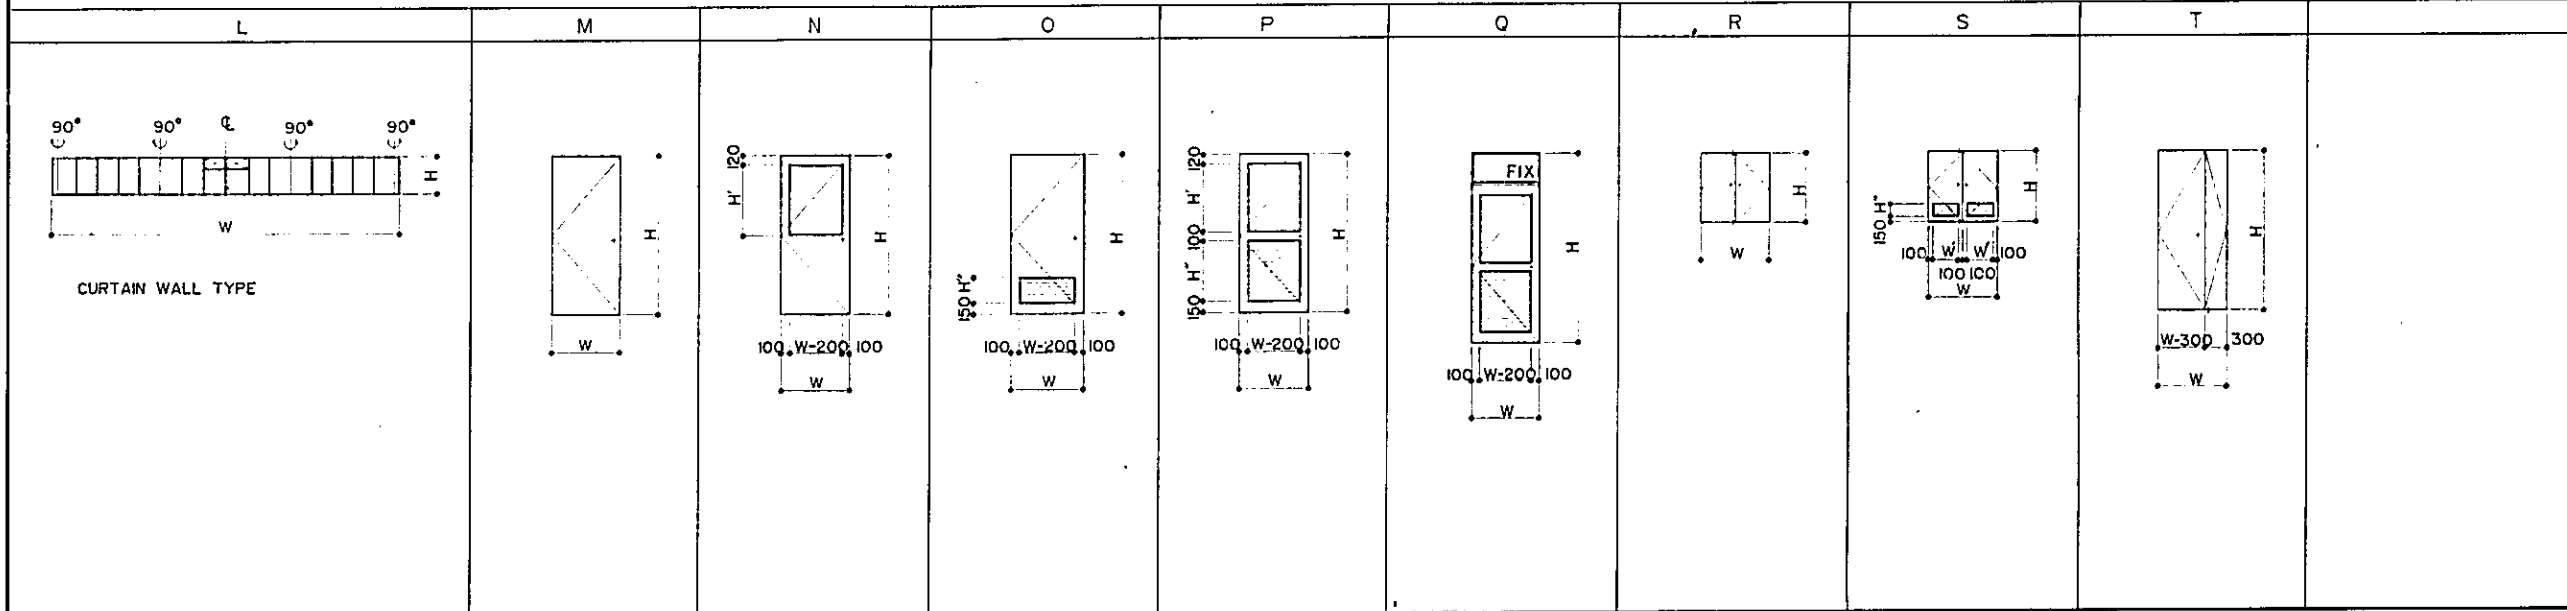

**REPUBLIC OF INDONESIA**  
**MINISTRY OF COMMUNICATIONS**  
**DIRECTORATE GENERAL OF LAND TRANSPORT AND INLAND WATERWAYS**

**NEW RAILWAY LINE FOR CENGKARENG AIRPORT CONSTRUCTION PROJECT**

**JAPAN INTERNATIONAL COOPERATION AGENCY (JICA)**


|           |           |          |       |         |          |           |
|-----------|-----------|----------|-------|---------|----------|-----------|
| B         | 1 AUG 89  | Smb      | Sipon | Sijob   | K.M      | ark       |
| A         | 15 FEB 89 | Smb      | Sipon | Sijob   | K.M      | ark       |
| REVISIONS | DATE      | DESIGNED | DRAWN | CHECKED | REVIEWED | SUBMITTED |

**DOOR AND WINDOW SCHEDULE**  
**( SHEET 2 OF 2 )**

PACKAGE: I CIVIL AND ARCHITECTURAL WORK

SCALE: NONE DRAWING NO: AA - 044


**FOUNDATION SCHEDULE**  
SCALE 1:30

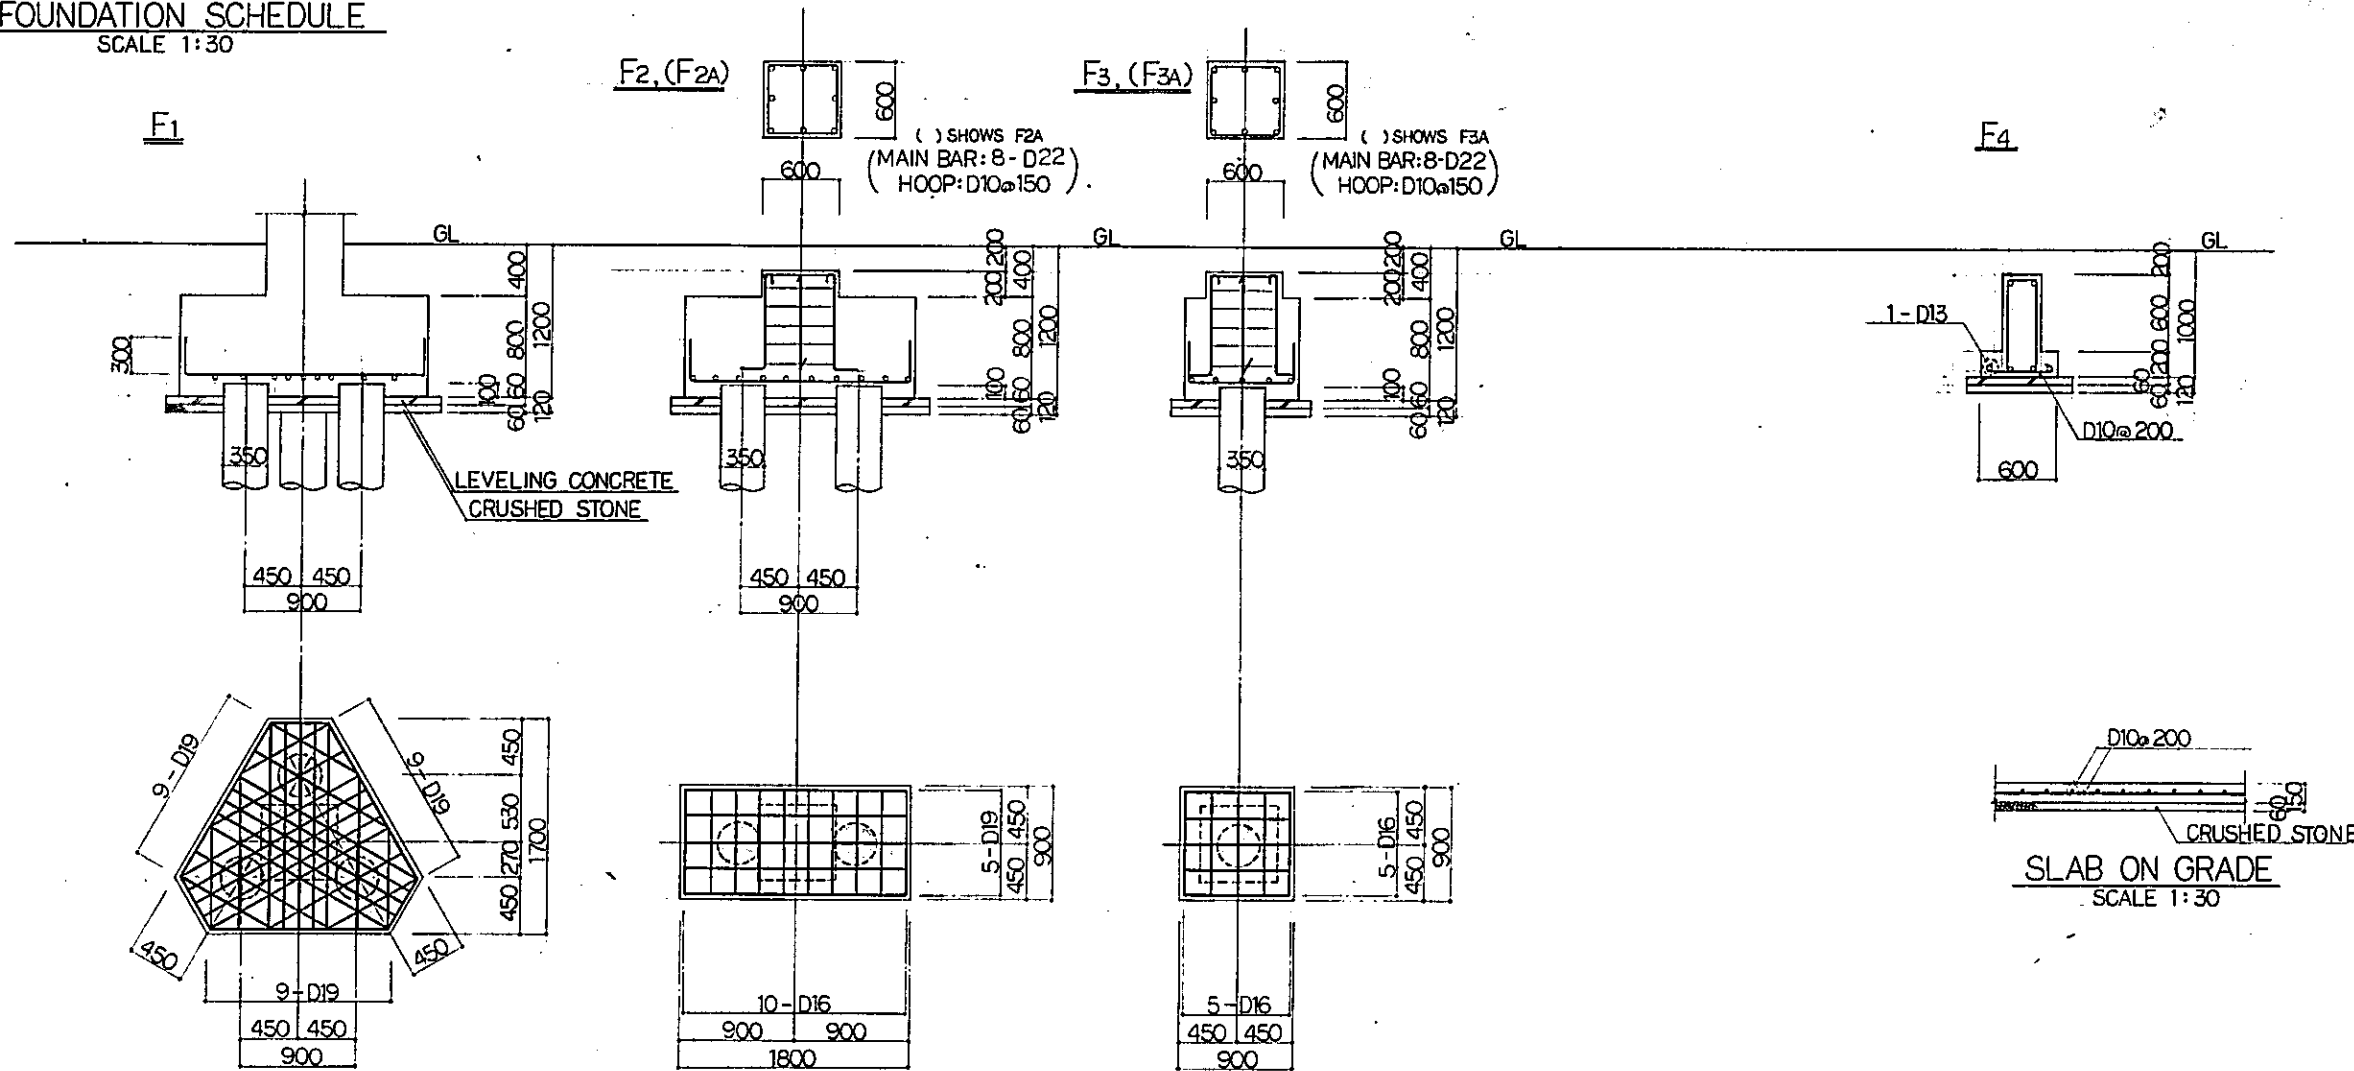

**GIRDER SCHEDULE**  
SCALE 1:30

--- SHOWS TIE BAR : D10@600

| MARK       | FG1     | FG2     | FG3     |         | FG4     |         | FG5     |
|------------|---------|---------|---------|---------|---------|---------|---------|
| POSITION   | ALL     | ALL     | END     | CENTER  | END     | CENTER  | ALL     |
| SECTION    |         |         |         |         |         |         |         |
| B x D      | 300x800 | 400x800 | 400x800 |         | 400x900 |         | 400x900 |
| TOP BAR    | 3 - D25 | 4 - D25 | 6 - D25 | 4 - D25 | 6 - D25 | 3 - D25 | 4 - D25 |
| BOTTOM BAR | 3 - D25 | 4 - D25 | 6 - D25 | 6 - D25 | 6 - D25 | 6 - D25 | 4 - D25 |
| STIRRUP    | D13@200 | D13@200 | D13@200 |         | D13@200 |         | D13@200 |
| WEB BAR    | 2 - D13 | 2 - D13 | 2 - D13 |         | 2 - D13 |         | 2 - D13 |

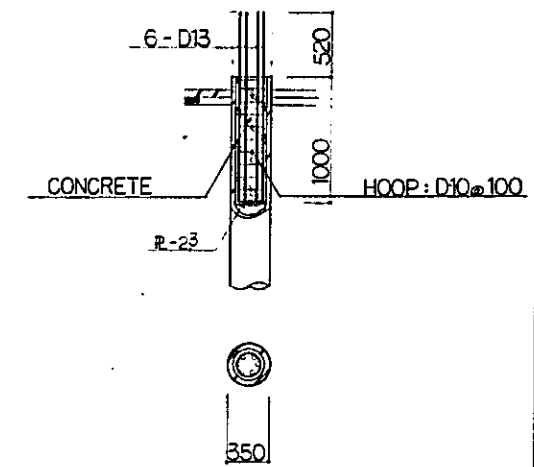

PILE HEAD DETAIL

|  |             |             |         |          |           |
|--|-------------|-------------|---------|----------|-----------|
| REPUBLIC OF INDONESIA<br>MINISTRY OF COMMUNICATIONS<br>DIRECTORATE GENERAL OF LAND TRANSPORT<br>AND INLAND WATERWAYS |             |             |         |          |           |
| NEW RAILWAY LINE FOR CENGKARENG AIRPORT<br>CONSTRUCTION PROJECT  |             |             |         |          |           |
| JAPAN INTERNATIONAL COOPERATION AGENCY<br>(JICA)   |             |             |         |          |           |
| B  | 1 AUG 2014  | AM          | TSUBUKI | KV       | MIK       |
| A  | 10 FEB 2014 | AM          | TSUBUKI | KV       | MIK       |
| REVISIONS  | DATE        | DESIGNED    | DRAWN   | CHECKED  | SUBMITTED |
| FOUNDATION SCHEDULE  |             |             |         |          |           |
| PACKAGE: I CIVIL AND ARCHITECTURAL WORK  |             |             |         |          |           |
| SCALE  | 1:30        | DRAWING NO. |         | AS - 001 |           |



STEEL MEMBER SCHEDULE

| MARK | SIZE                 |
|------|----------------------|
| C1   | $\phi$ -355.6 x 7.9  |
| C2   | $\phi$ -457.2 x 9.5  |
| G1   | $\phi$ -355.6 x 7.9  |
| G2   | $\phi$ -355.6 x 9.5  |
| G3   | $\phi$ -355.6 x 6.4  |
| G4   | $\phi$ -457.2 x 9.5  |
| G5   | $\phi$ -267.4 x 6    |
| G6   | $\phi$ -165.2 x 4    |
| B1   | $\phi$ -267.4 x 6    |
| B2   | $\phi$ -165.2 x 4    |
| B3   | L-75 x 75 x 6        |
| V1   | H 250 x 250 x 9 x 14 |
| P1   | $\phi$ -355.6 x 6.4  |
| P2   | $\phi$ -267.4 x 6    |
| P3   | $\phi$ -165.2 x 4    |

| MARK | SIZE                  |
|------|-----------------------|
| KC1  | H-250 x 250 x 9 x 14  |
| KG1  | H-300 x 150 x 6.5 x 9 |
| KG2  | H-300 x 150 x 6.5 x 9 |
| KB1  | H-248 x 124 x 5 x 8   |
| KB2  | H-175 x 90 x 5 x 8    |
| KB3  | C-100 x 50 x 20 x 2.3 |
| KB4  | H-300 x 150 x 6.5 x 9 |
| KP1  | H-244 x 175 x 7 x 11  |

| MARK | SIZE                   |
|------|------------------------|
| SG1  | H-250 x 125 x 6 x 9    |
| SB1  | 2C-100 x 50 x 20 x 2.3 |

COLUMN SCHEDULE

SCALE 1:30

| MARK                          | C10       | C11       | KC10      | SC10      | SC11      |
|-------------------------------|-----------|-----------|-----------|-----------|-----------|
| 3 <sup>rd</sup> STORY SECTION |           |           |           |           |           |
| B x D                         | 600 x 600 |           |           |           |           |
| MAIN BAR                      | 24-D22    |           |           |           |           |
| HOOP                          | D13@100   |           |           |           |           |
| D.HOOP                        | D10@600   |           |           |           |           |
| 2 <sup>nd</sup> STORY SECTION |           |           |           |           |           |
| B x D                         | 600 x 600 | 300 x 600 | 600 x 600 | 500 x 500 |           |
| MAIN BAR                      | 24-D22    | 10-D19    | 20-D25    | 8-D25     |           |
| HOOP                          | D13@100   | D10@100   | D13@100   | D13@100   |           |
| D.HOOP                        | D10@600   | D10@600   | D10@600   | D10@600   |           |
| 1 <sup>st</sup> STORY SECTION |           |           |           |           |           |
| B x D                         | 600 x 600 | 300 x 600 | 600 x 600 | 500 x 500 | 400 x 400 |
| MAIN BAR                      | 24-D22    | 10-D19    | 20-D25    | 8-D25     | 8-D16     |
| HOOP                          | D13@100   | D10@100   | D13@100   | D13@100   | D10@100   |
| D.HOOP                        | D10@600   | D10@600   | D10@600   | D10@600   | D10@600   |

GIRDER SCHEDULE

SCALE 1:30

--- SHOWS TIE BAR D10@600

| MARK                          | WG1       | KG10        | KG11        | KG12      | SG10        | SG11      | SG12      |
|-------------------------------|-----------|-------------|-------------|-----------|-------------|-----------|-----------|
| POSITION                      |           | END CENTER  | END CENTER  | ALL       | END CENTER  | ALL       |           |
| ROOF SECTION                  |           |             |             |           |             |           |           |
| B x D                         |           | 400 x 800   | 350 x 800   | 350 x 800 | 300 x 600   | 300 x 600 |           |
| TOP BAR                       |           | 6-D25 4-D25 | 5-D25 3-D25 | 4-D25     | 3-D22 3-D22 | 3-D19     |           |
| BOTTOM BAR                    |           | 3-D25 7-D25 | 3-D25 6-D25 | 4-D25     | 3-D22 5-D22 | 3-D19     |           |
| STIRRUP                       |           | D13@100     | D13@100     | D10@200   | D10@200     | D10@200   |           |
| WEB BAR                       |           | 2-D13       | 2-D13       | 2-D10     | 2-D10       | 2-D10     |           |
| POSITION                      | ALL       | END CENTER  | END CENTER  | ALL       | END CENTER  | ALL       | ALL       |
| 2 <sup>nd</sup> STORY SECTION |           |             |             |           |             |           |           |
| B x D                         | 150 x 600 | 400 x 800   | 350 x 800   | 350 x 800 | 300 x 600   | 300 x 600 | 250 x 500 |
| TOP BAR                       | 1-D13     | 5-D25 3-D25 | 5-D25 3-D25 | 4-D25     | 5-D22 3-D22 | 3-D22     | 2-D19     |
| BOTTOM BAR                    | 1-D13     | 3-D25 6-D25 | 3-D25 6-D25 | 4-D25     | 3-D22 5-D22 | 3-D22     | 2-D19     |
| STIRRUP                       | D10@200   | D13@100     | D13@100     | D10@200   | D10@200     | D10@200   | D10@200   |
| WEB BAR                       | 2-D10     | 2-D13       | 2-D13       | 2-D10     | 2-D10       | 2-D10     |           |

GIRDER SCHEDULE

SCALE 1:30

--- SHOWS TIE BAR D10@600

| MARK                          | G10          | G11         | G12       | CG10      |
|-------------------------------|--------------|-------------|-----------|-----------|
| POSITION                      | END CENTER   | ALL         | ALL       |           |
| ROOF SECTION                  |              |             |           |           |
| B x D                         | 300 x 500    | 250 x 500   | 250 x 650 |           |
| TOP BAR                       | 3-D22 3-D22  | 2-D22       | 2-D22     |           |
| BOTTOM BAR                    | 3-D22 5-D22  | 2-D22       | 2-D22     |           |
| STIRRUP                       | D10@200      | D10@200     | D10@200   |           |
| WEB BAR                       |              |             | 2-D10     |           |
| POSITION                      | END CENTER   | END CENTER  | ALL       | ALL       |
| 3 <sup>rd</sup> STORY SECTION |              |             |           |           |
| B x D                         | 400 x 700    | 350 x 700   | 300 x 600 | 350 x 700 |
| TOP BAR                       | 8-D25 4-D25  | 5-D25 3-D25 | 3-D25     | 5-D25     |
| BOTTOM BAR                    | 4-D25 10-D25 | 3-D25 3-D25 | 3-D25     | 3-D25     |
| STIRRUP                       | D13@100      | D13@200     | D10@200   | D10@200   |
| WEB BAR                       | 2-D13        | 2-D13       | 2-D10     | 2-D10     |
| POSITION                      | END CENTER   | END CENTER  | ALL       | ALL       |
| 2 <sup>nd</sup> STORY SECTION |              |             |           |           |
| B x D                         | 400 x 700    | 350 x 700   | 300 x 600 | 350 x 700 |
| TOP BAR                       | 8-D25 4-D25  | 6-D25 3-D25 | 3-D25     | 5-D25     |
| BOTTOM BAR                    | 4-D25 6-D25  | 5-D25 3-D25 | 3-D25     | 3-D25     |
| STIRRUP                       | D13@100      | D13@200     | D10@200   | D10@200   |
| WEB BAR                       | 2-D13        | 2-D13       | 2-D10     | 2-D10     |

REPUBLIC OF INDONESIA  
 MINISTRY OF COMMUNICATIONS &  
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 AND INLAND WATERWAYS

NEW RAILWAY LINE FOR CENGKARENG AIRPORT  
 CONSTRUCTION PROJECT

JAPAN INTERNATIONAL COOPERATION AGENCY  
 (JICA)

|   |             |    |    |    |    |    |    |
|---|-------------|----|----|----|----|----|----|
| B | 1 AUG 2011  | DR | DR | DR | DR | DR | DR |
| A | 15 FEB 2011 | DR | DR | DR | DR | DR | DR |

REVISIONS DATE REASON DRAWN CHECKED REVIEWED SUBMITTED

COLUMN AND GIRDER SCHEDULE

PACKAGE: I CIVIL AND ARCHITECTURAL WORK  
 SCALE 1:30 DRAWING NO. AS - 002

**BEAM SCHEDULE**





SCALE 1:30

SHOWS TIE BAR D10@600

| MARK       | B10       |         | B11       | B12       |         | B13       | B14       |         | B15       |         | B16       |
|------------|-----------|---------|-----------|-----------|---------|-----------|-----------|---------|-----------|---------|-----------|
|            | END       | CENTER  | ALL       | END       | CENTER  | ALL       | END       | CENTER  | END       | CENTER  | ALL       |
| SECTION    |           |         |           |           |         |           |           |         |           |         |           |
| B x D      | 350 x 650 |         | 300 x 500 | 300 x 600 |         | 200 x 500 | 400 x 800 |         | 400 x 700 |         | 400 x 600 |
| TOP BAR    | 3 - D22   | 3 - D22 | 3 - D22   | 3 - D22   | 3 - D22 | 2 - D19   | 5 - D25   | 3 - D25 | 5 - D25   | 3 - D25 | 3 - D25   |
| BOTTOM BAR | 3 - D22   | 5 - D22 | 3 - D22   | 3 - D22   | 5 - D22 | 2 - D19   | 3 - D25   | 6 - D25 | 5 - D25   | 3 - D25 | 3 - D25   |
| STIRRUP    | D10 @ 200 |         | D10 @ 200 | D10 @ 200 |         | D10 @ 200 | D13 @ 200 |         | D13 @ 200 |         | D13 @ 200 |
| WEB BAR    | 2 - D10   |         | —         | 2 - D10   |         | 2 - D10   | 2 - D13   |         | 2 - D13   |         | 2 - D13   |

**SLAB SCHEDULE**

| MARK | THICKNESS | POSITION | SHORT SPAN    |               | LONG SPAN     |               | NOTE |
|------|-----------|----------|---------------|---------------|---------------|---------------|------|
|      |           |          | END           | CENTER        | END           | CENTER        |      |
| S1   | 130       | TOP      | D10 D13 @ 200 | D10 D13 @ 200 | D10 D13 @ 200 | D10 D13 @ 200 |      |
|      |           | BOTTOM   | D10 D13 @ 200 | D10 D13 @ 200 | D10 D13 @ 200 | D10 D13 @ 200 |      |
| S2   | 130       | TOP      | D10 D13 @ 200 | D10 D13 @ 200 | D10 @ 200     | D10 @ 200     |      |
|      |           | BOTTOM   | D10 D13 @ 200 | D10 D13 @ 200 | D10 @ 200     | D10 @ 200     |      |
| S3   | 150       | TOP      | D13 @ 200     |               | D13 @ 200     |               |      |
|      |           | BOTTOM   | D13 @ 200     |               | D13 @ 200     |               |      |
| CS1  | 150       | TOP      | D13 @ 200     |               | D10 @ 200     |               |      |
|      |           | BOTTOM   | D10 @ 200     |               | D10 @ 200     |               |      |
| CS2  | 200       | TOP      | D13 @ 200     |               | D10 @ 200     |               |      |
|      |           | BOTTOM   | D10 @ 200     |               | D10 @ 200     |               |      |

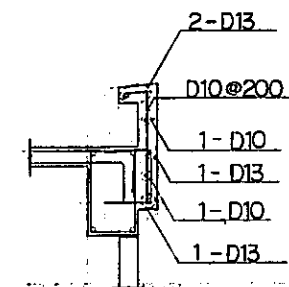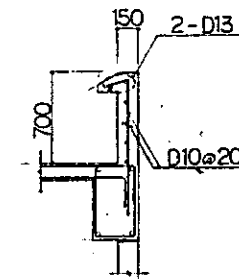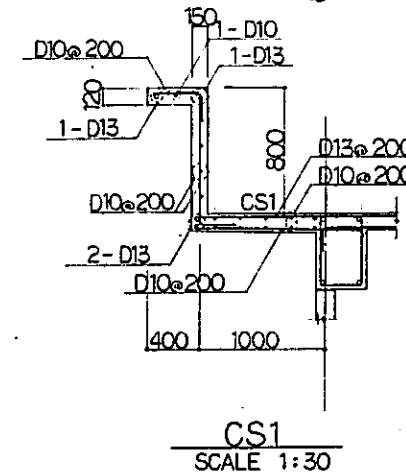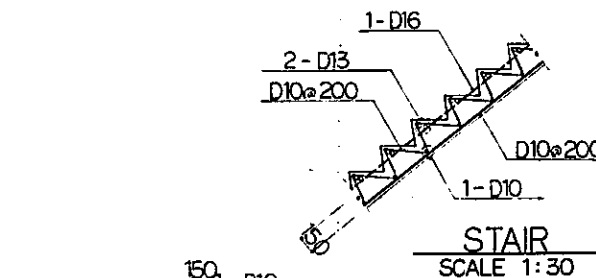

**WALL SCHEDULE**

SCALE 1:30

| MARK       | W15     | W18           |
|------------|---------|---------------|
| SECTION    |         |               |
| THICKNESS  | 150     | 180           |
| VERTI. BAR | D10@200 | D10 D13 @ 200 |
| HORL. BAR  | D10@200 | D10@200       |
| TIE BAR    | —       | D10@1000      |

REPUBLIC OF INDONESIA  
 MINISTRY OF COMMUNICATIONS  
 DIRECTORATE GENERAL OF LAND TRANSPORT AND INLAND WATERWAYS

NEW RAILWAY LINE FOR CENGKARENG AIRPORT  
 CONSTRUCTION PROJECT


JAPAN INTERNATIONAL COOPERATION AGENCY (JICA)

|   |             |    |    |    |    |
|---|-------------|----|----|----|----|
| B | 1 AUG 2014  | HM | GS | KM | JK |
| A | 15 FEB 2014 | HM | GS | KM | JK |

REVISIONS    DATE    DESIGNED    DRAWN    CHECKED    REVIEWED    SUBMITTED

BEAM, SLAB AND WALL SCHEDULE

PACKAGE: I CIVIL AND ARCHITECTURAL WORK  
 SCALE: 1:30    DRAWING NO: AS-003

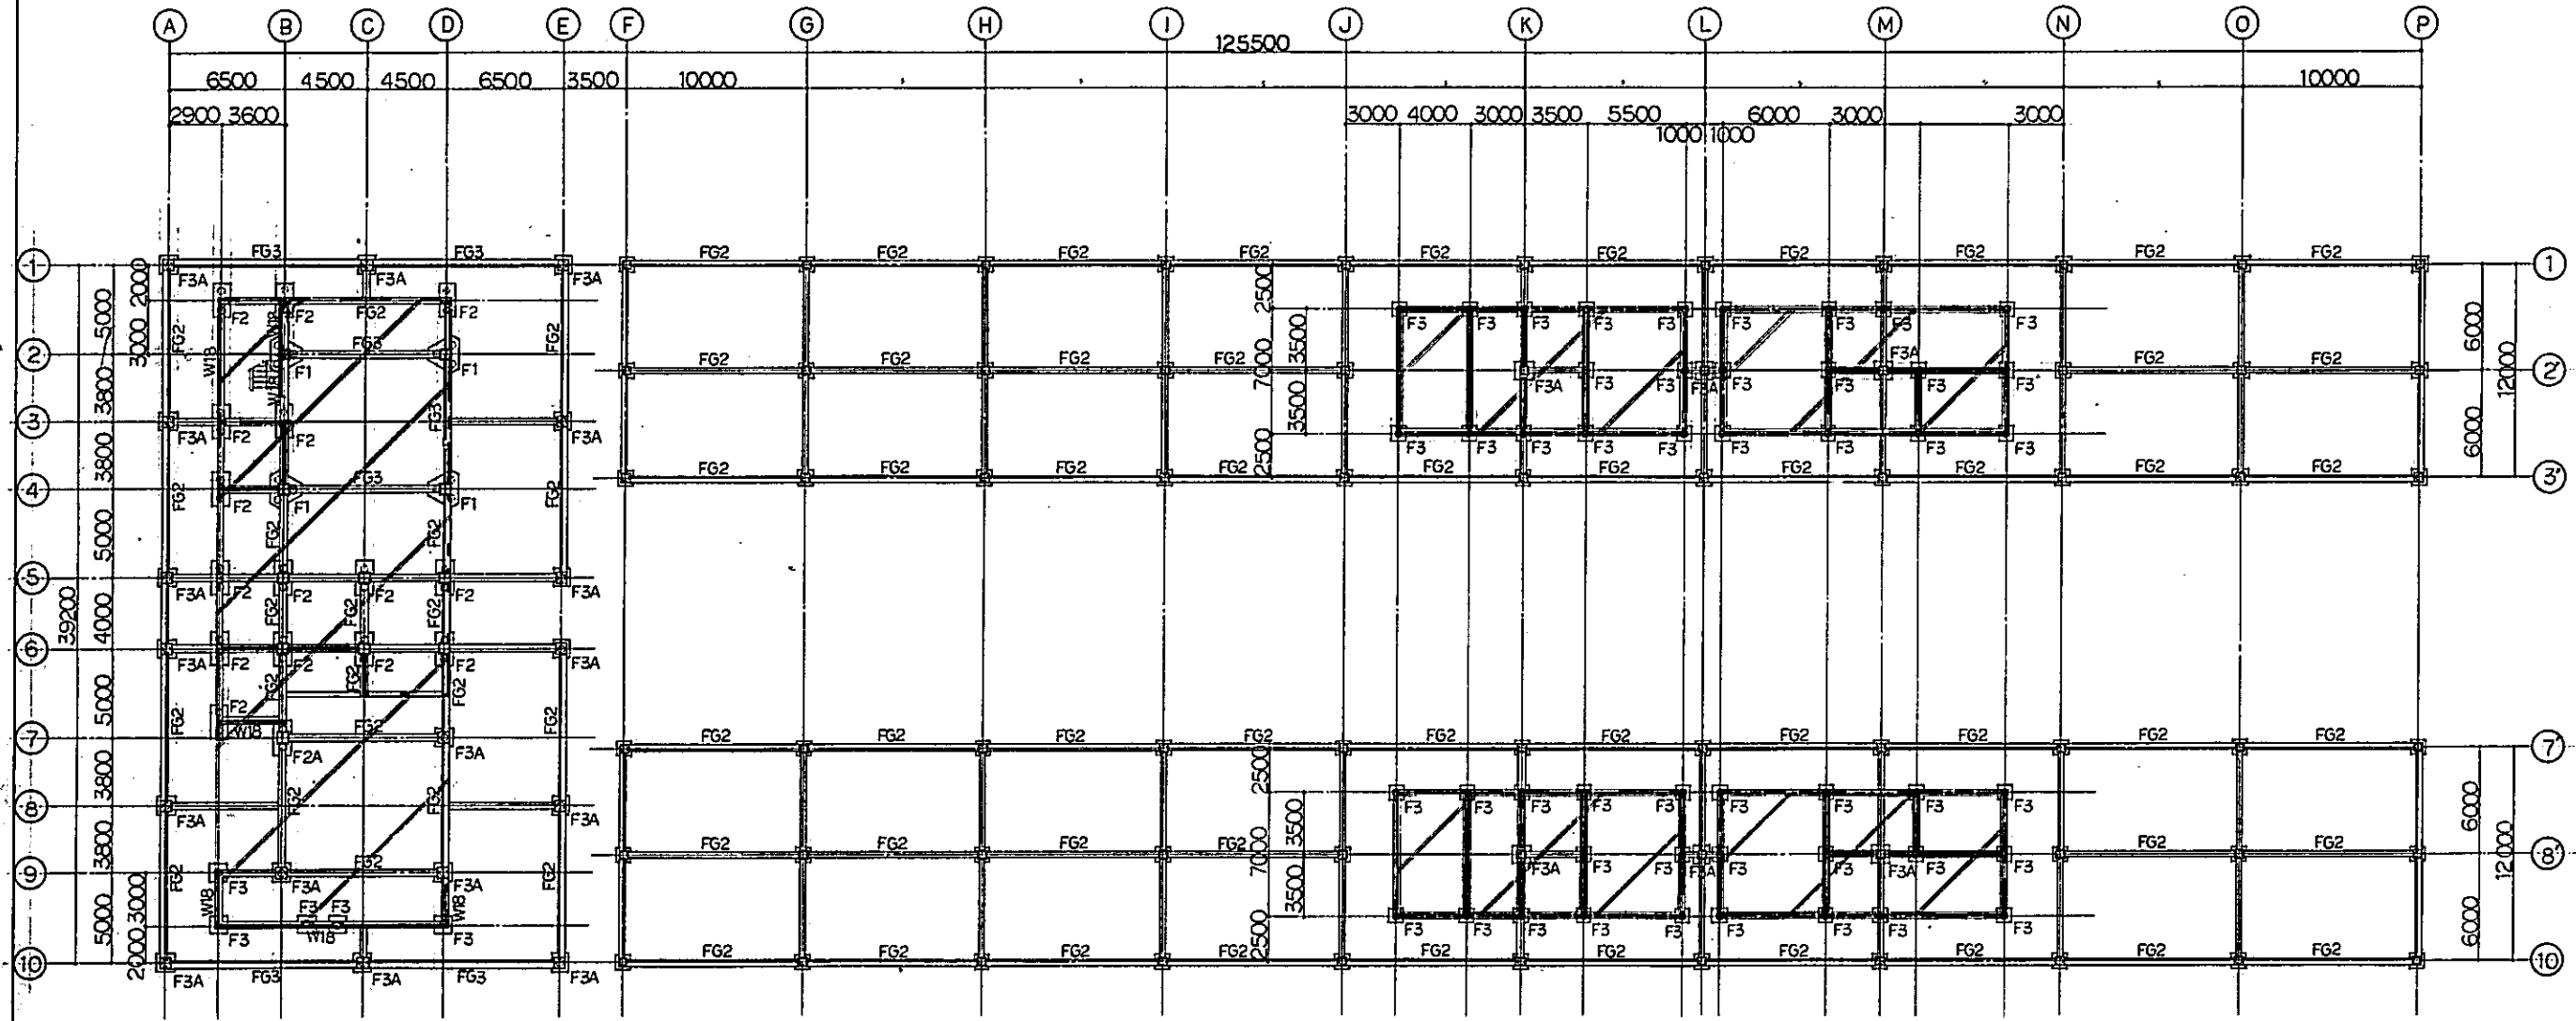


**FOUNDATION PLAN**

SCALE 1:200

UNLESS OTHERWISE NOTED

1. GIRDER MARK : FG1
2. WALL MARK : W15
3. FOOTING MARK : F3A
4. : SHOWS SLAB ON GRADE

|  |           |                      |       |         |           |
|--|-----------|----------------------|-------|---------|-----------|
| REPUBLIC OF INDONESIA<br>MINISTRY OF COMMUNICATIONS<br>DIRECTORATE GENERAL OF LAND TRANSPORT<br>AND INLAND WATERWAYS |           |                      |       |         |           |
| NEW RAILWAY LINE FOR CENKARENG AIRPORT<br>CONSTRUCTION PROJECT   |           |                      |       |         |           |
| JAPAN INTERNATIONAL COOPERATION AGENCY<br>(JICA)   |           |                      |       |         |           |
| B  | 1 AUG 78  | S.A.                 | H.N.  | T.G.    | K.M.      |
| A  | 15 FEB 78 | S.A.                 | H.N.  | S.A.    | K.M.      |
| REVISIONS  | DATE      | DESIGNED             | DRAWN | CHECKED | REVIEWED  |
|  |           |                      |       |         | SUBMITTED |
| AIRPORT TERMINAL STATION<br>FOUNDATION PLAN  |           |                      |       |         |           |
| PACKAGE: I CIVIL AND ARCHITECTURAL WORK  |           |                      |       |         |           |
| SCALE 1:200  |           | DRAWING NO. AS - 004 |       |         |           |

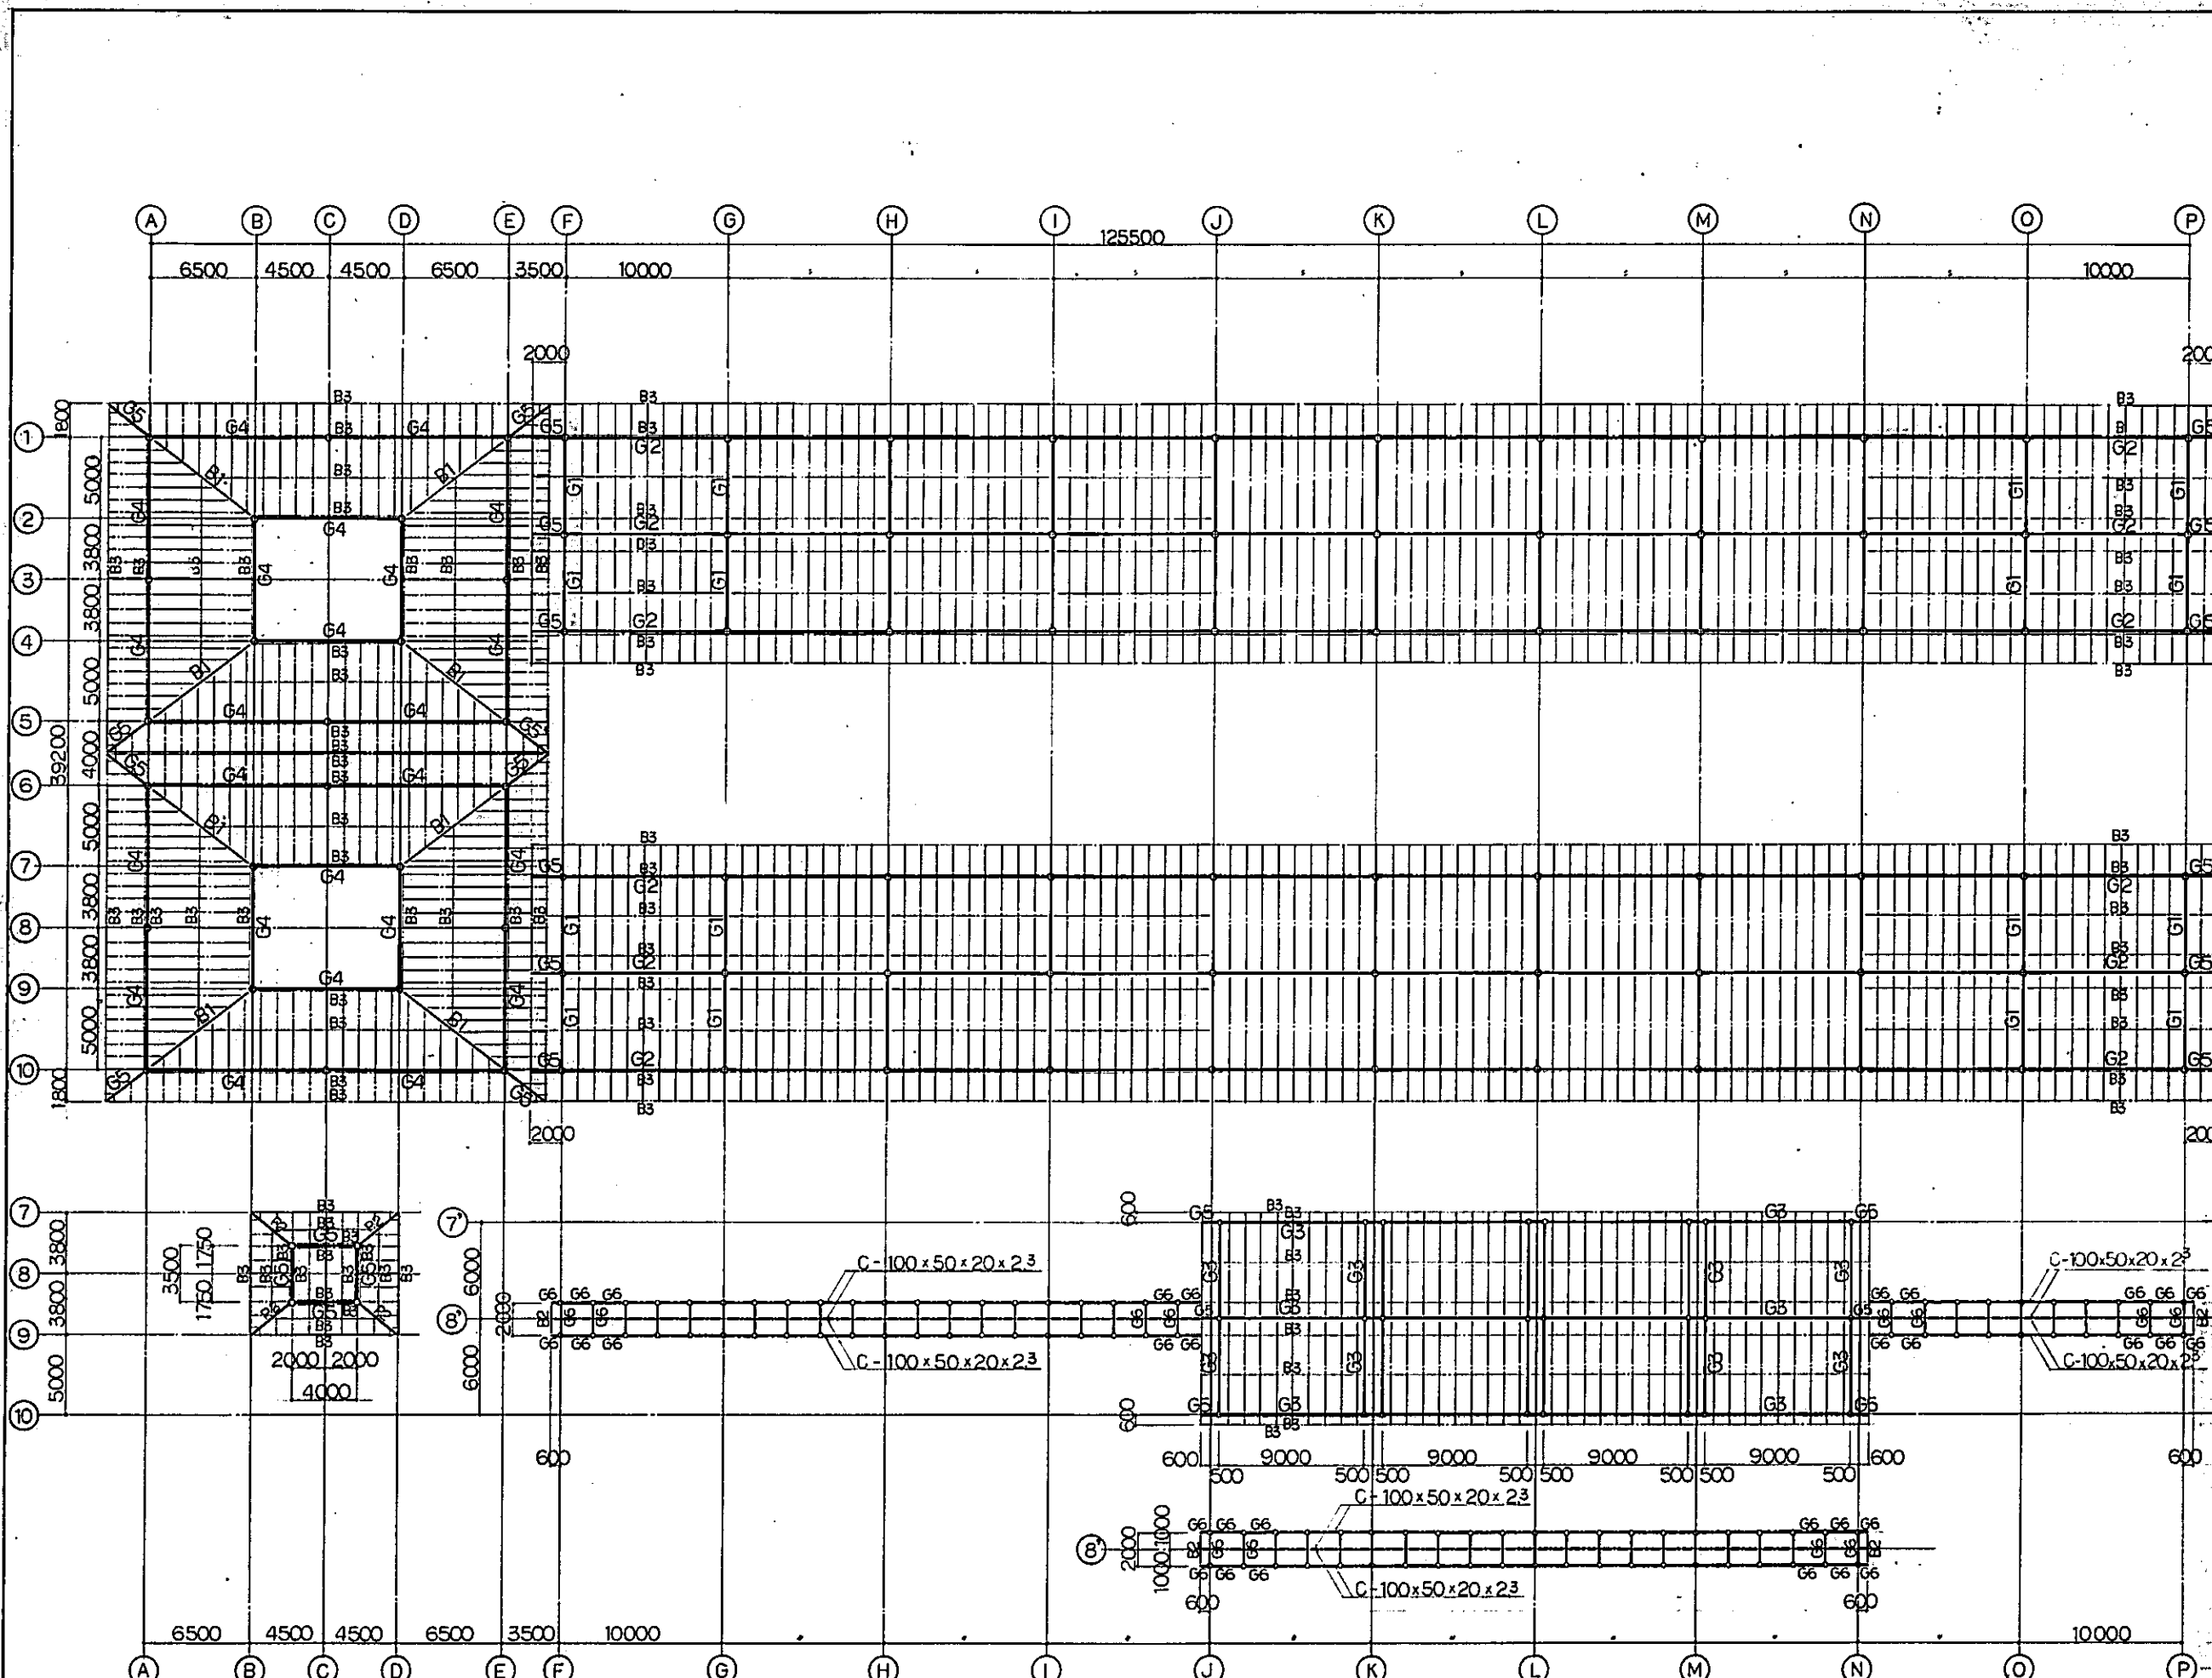

**ROOF FRAMING PLAN**  
SCALE 1:200

UNLESS OTHERWISE NOTED  
 1. PURLIN : ø -1652 x 4 (B2)  
 2. ROOF DECKING : V50 TYPE I -16

REPUBLIC OF INDONESIA  
 MINISTRY OF COMMUNICATIONS  
 DIRECTORATE GENERAL OF LAND TRANSPORT  
 AND INLAND WATERWAYS

**NEW RAILWAY LINE FOR CENGKARENG AIRPORT  
 CONSTRUCTION PROJECT**


JAPAN INTERNATIONAL COOPERATION AGENCY  
 (JICA)

|   |                |    |     |     |
|---|----------------|----|-----|-----|
| B | LACA, 29/04/74 | HA | SKM | SKM |
| A | ASEB, 27/04/74 | HA | SKM | SKM |

| REVISIONS | DATE | DESIGNED | DRAWN | CHECKED | REVIEWED | SUBMITTED |
|-----------|------|----------|-------|---------|----------|-----------|
|           |      |          |       |         |          |           |

**AIRPORT TERMINAL STATION  
 ROOF FRAMING PLAN**

PACKAGE: I: CIVIL AND ARCHITECTURAL WORK  
 SCALE: 1:200 DRAWING NO: AS - 005

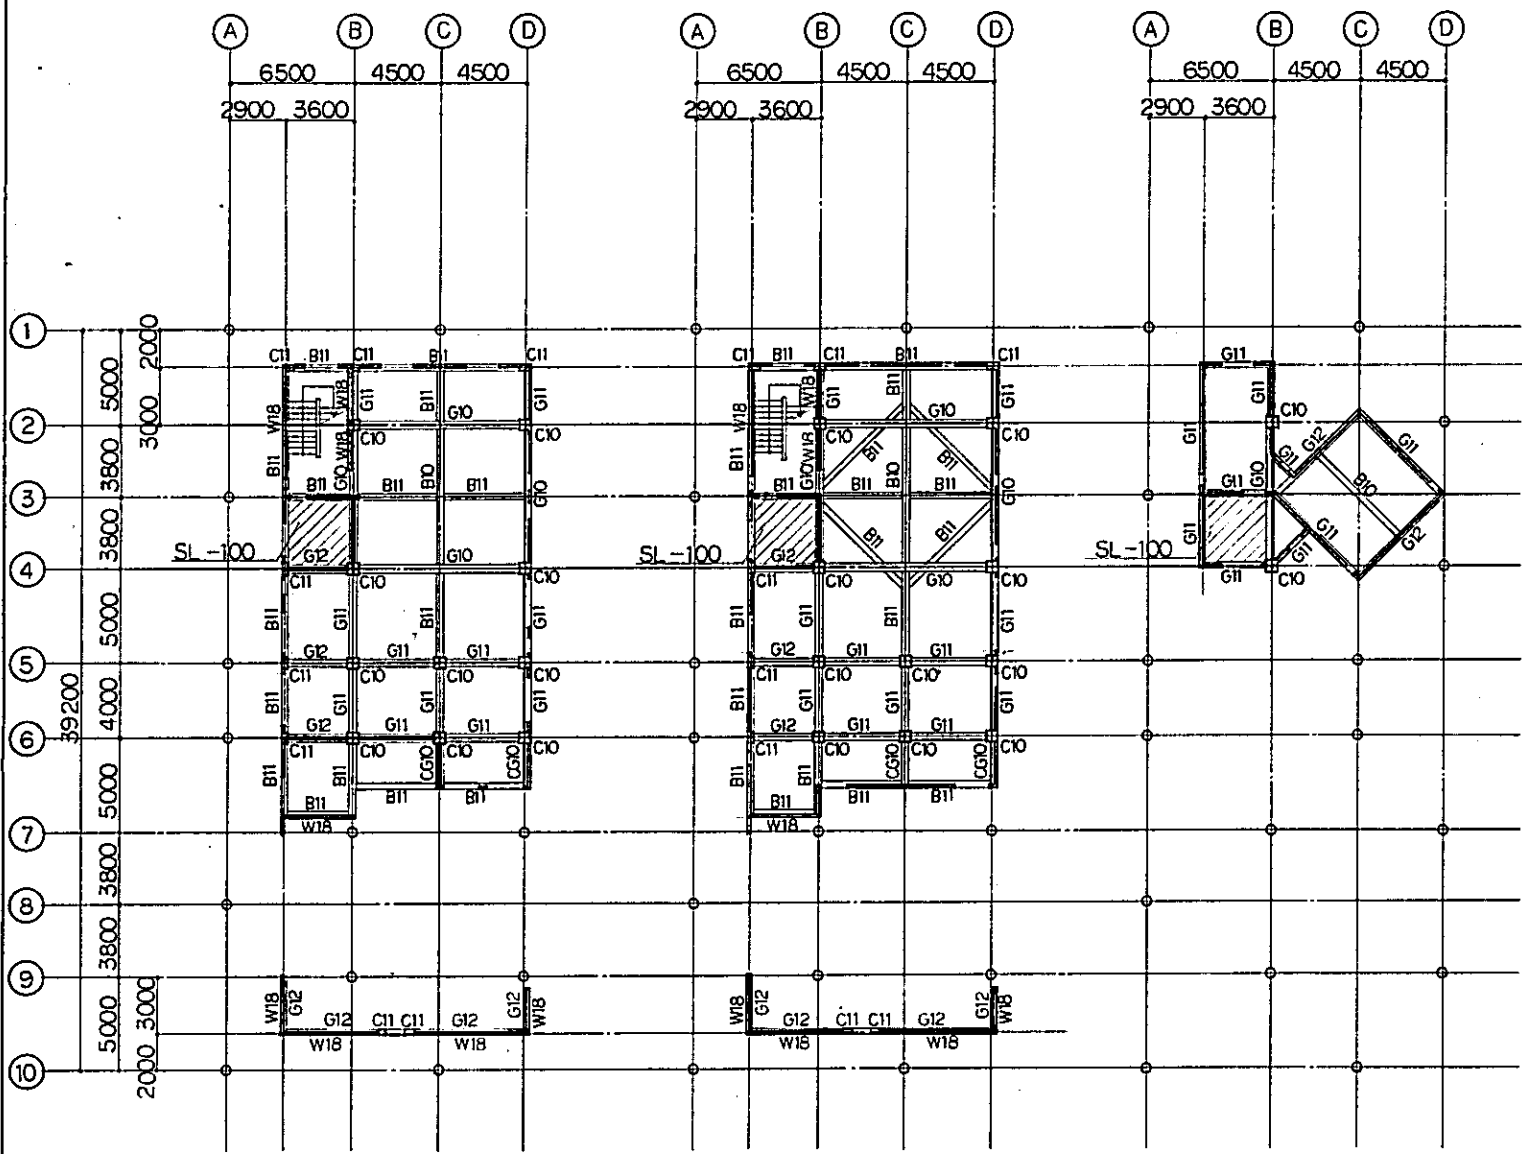

2<sup>nd</sup> FLOOR

3<sup>rd</sup> FLOOR


ROOF

**FRAMING PLAN**

SCALE 1:200

UNLESS OTHERWISE NOTED

- 1. SLAB MARK : S1
- 2. WALL MARK : W15

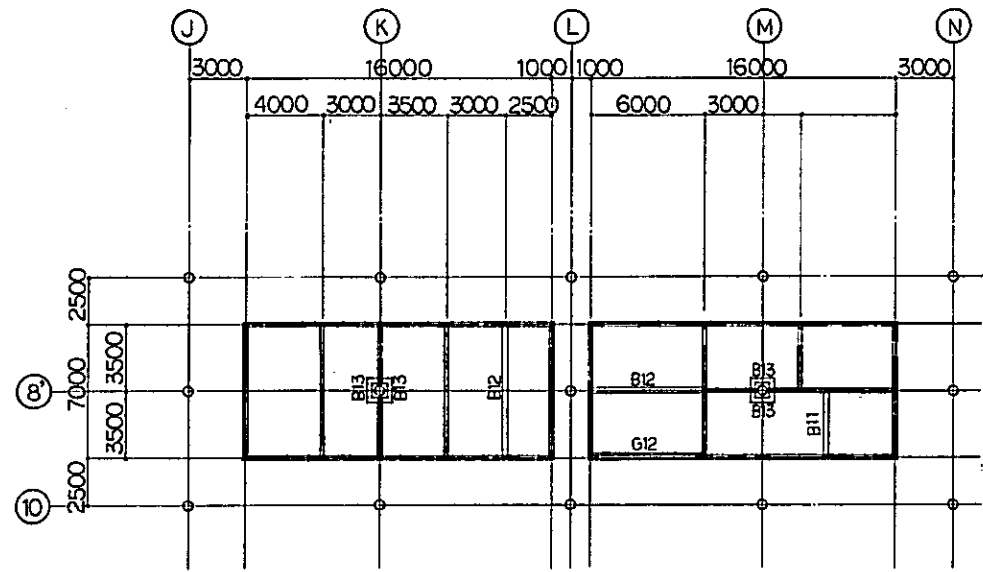


**ROOF FRAMING PLAN**

SCALE 1:200


UNLESS OTHERWISE NOTED

- 1. SLAB MARK : S1
- 2. GIRDER MARK : WG1
- 3. WALL MARK : W15


|  |           |                      |          |          |          |
|--|-----------|----------------------|----------|----------|----------|
| REPUBLIC OF INDONESIA<br>MINISTRY OF COMMUNICATIONS<br>DIRECTORATE GENERAL OF LAND TRANSPORT<br>AND INLAND WATERWAYS |           |                      |          |          |          |
| NEW RAILWAY LINE FOR CENGKARENG AIRPORT<br>CONSTRUCTION PROJECT  |           |                      |          |          |          |
| JAPAN INTERNATIONAL COOPERATION AGENCY<br>(JICA)   |           |                      |          |          |          |
| B  | 1 AUG 89  | BIM                  | AK       | S. K. M. | AK       |
| A  | 15 FEB 88 | AK                   | S. K. M. | AK       | AK       |
| REVISIONS  | DATE      | DESIGNED             | DRAWN    | CHECKED  | REVIEWED |
|  |           |                      |          |          |          |
| AIRPORT TERMINAL STATION.<br>FRAMING PLAN  |           |                      |          |          |          |
| PACKAGE: I CIVIL AND ARCHITECTURAL WORK.   |           |                      |          |          |          |
| SCALE: 1:200   |           | DRAWING NO: AS - 006 |          |          |          |

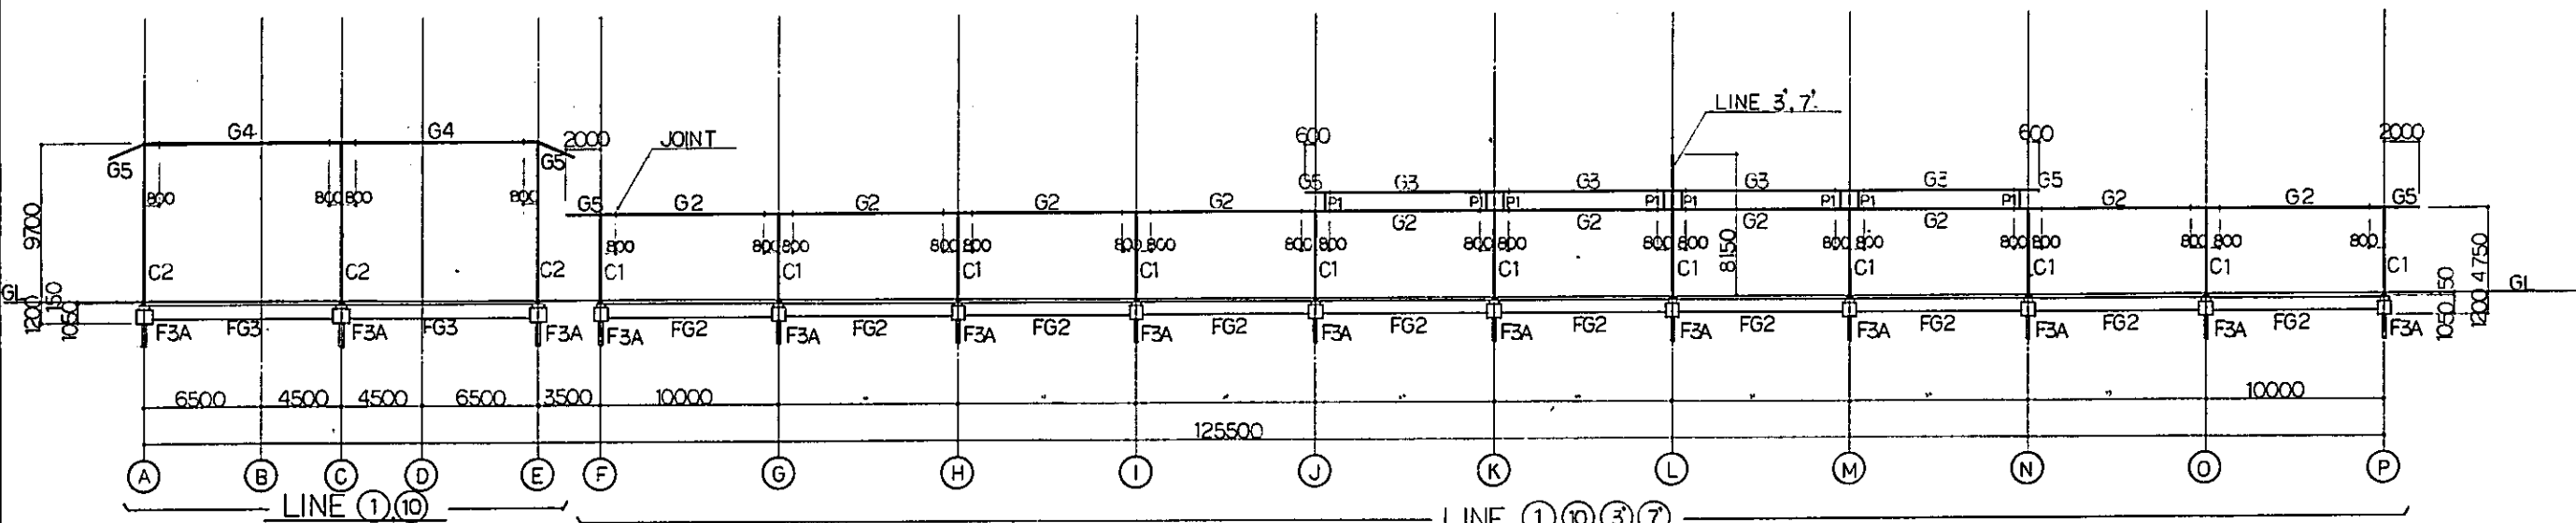


LINE 1 (10) (3) (7)  
SCALE 1:200

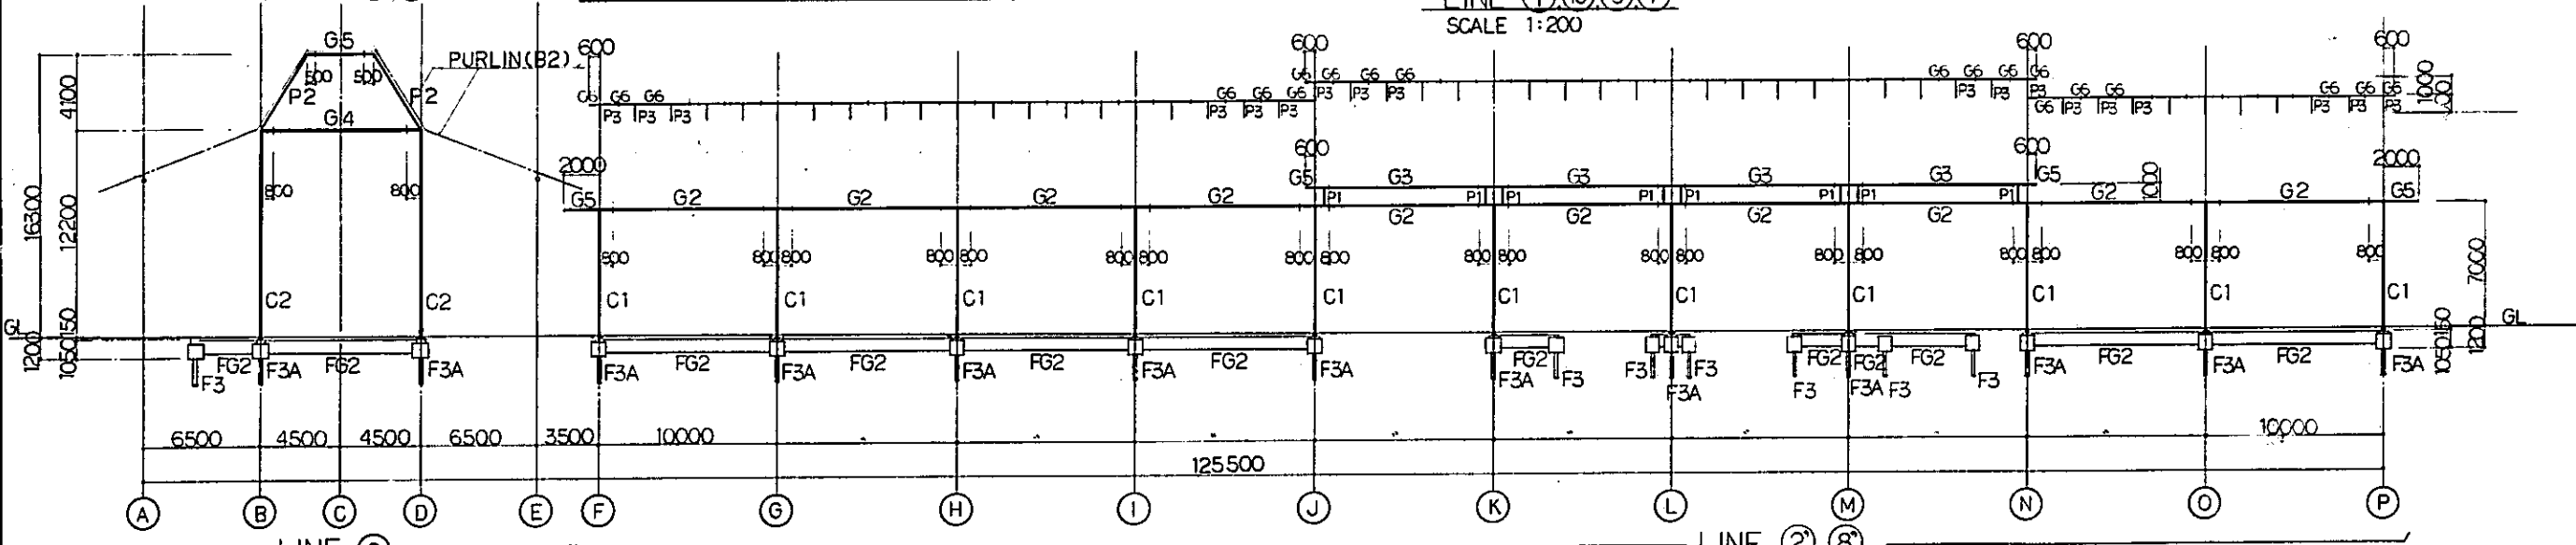

LINE 2 (8)  
SCALE 1:200

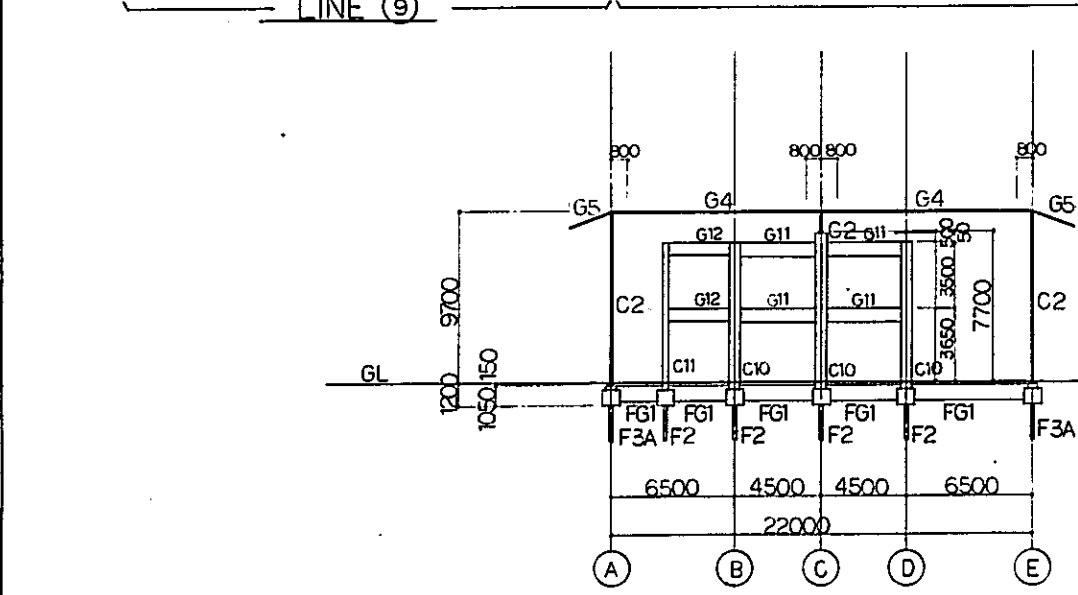


LINE 5  
SCALE 1:200

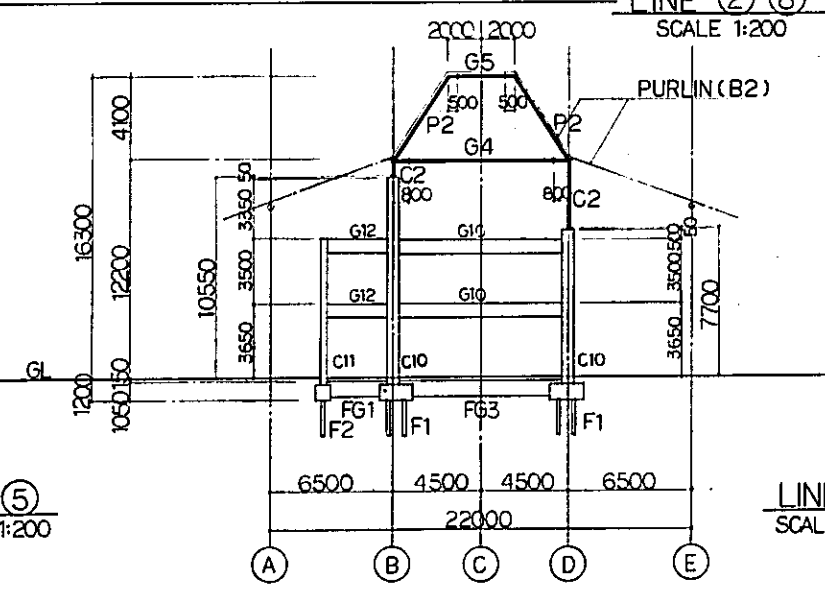


LINE 4  
SCALE 1:200


|  |                         |         |       |          |          |
|--|-------------------------|---------|-------|----------|----------|
| REPUBLIC OF INDONESIA<br>MINISTRY OF COMMUNICATIONS<br>DIRECTORATE GENERAL OF LAND TRANSPORT<br>AND INLAND WATERWAYS |                         |         |       |          |          |
| NEW RAILWAY LINE FOR CENGKARENG AIRPORT<br>CONSTRUCTION PROJECT  |                         |         |       |          |          |
| JAPAN INTERNATIONAL COOPERATION AGENCY<br>(JICA)   |                         |         |       |          |          |
| B  | 1 AUG. 89               | OK      | HM    | S. K. M. | MK       |
| A  | 15 FEB. 89              | OK      | HM    | S. K. M. | MK       |
| REVISIONS  | DATE                    | CHECKED | DRAWN | CHECKED  | REVIEWED |
| AIRPORT TERMINAL STATION<br>FRAMING ELEVATION<br>( SHEET 1 OF 2 )  |                         |         |       |          |          |
| PACKAGE: I CIVIL AND ARCHITECTURAL WORK  |                         |         |       |          |          |
| SCALE<br>1:200   | DRAWING NO:<br>AS - 007 |         |       |          |          |

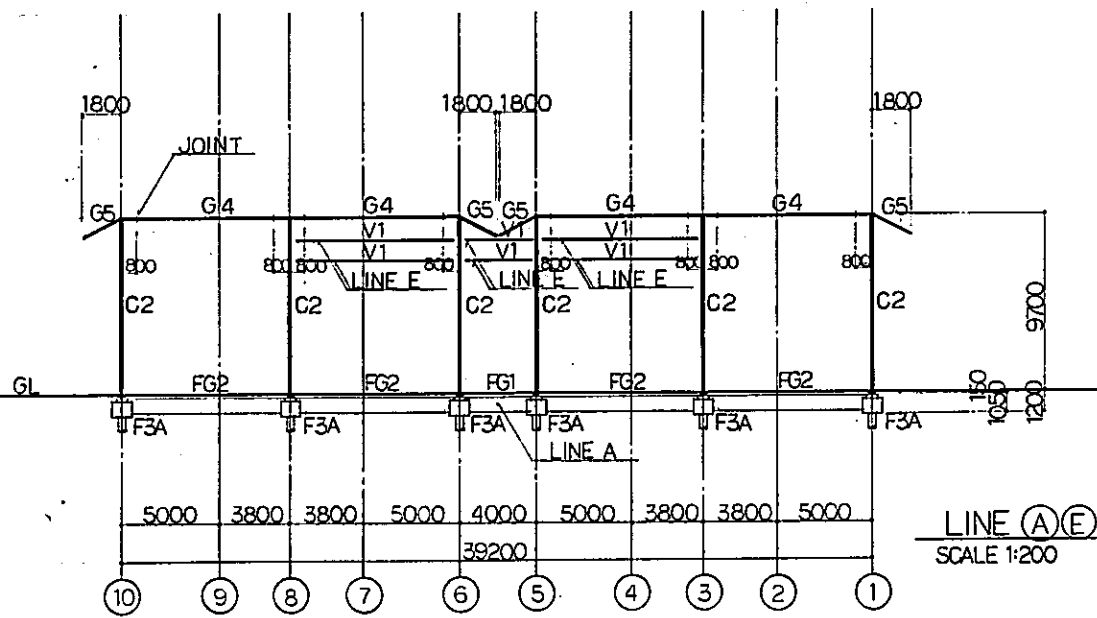


LINE A-E  
SCALE 1:200

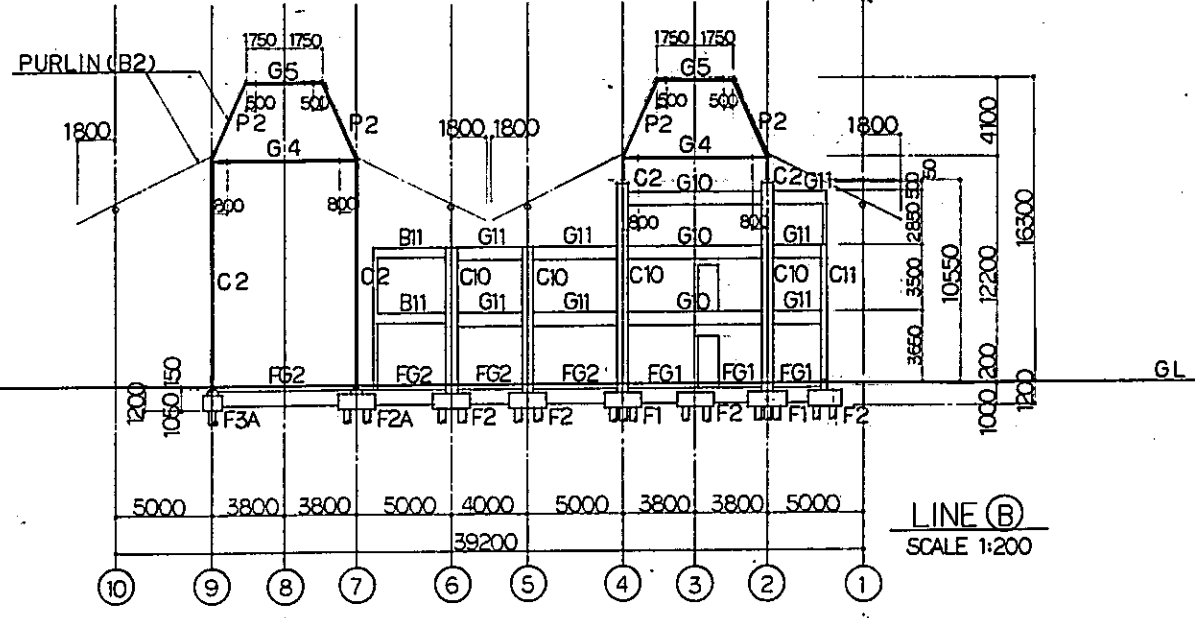


LINE B  
SCALE 1:200

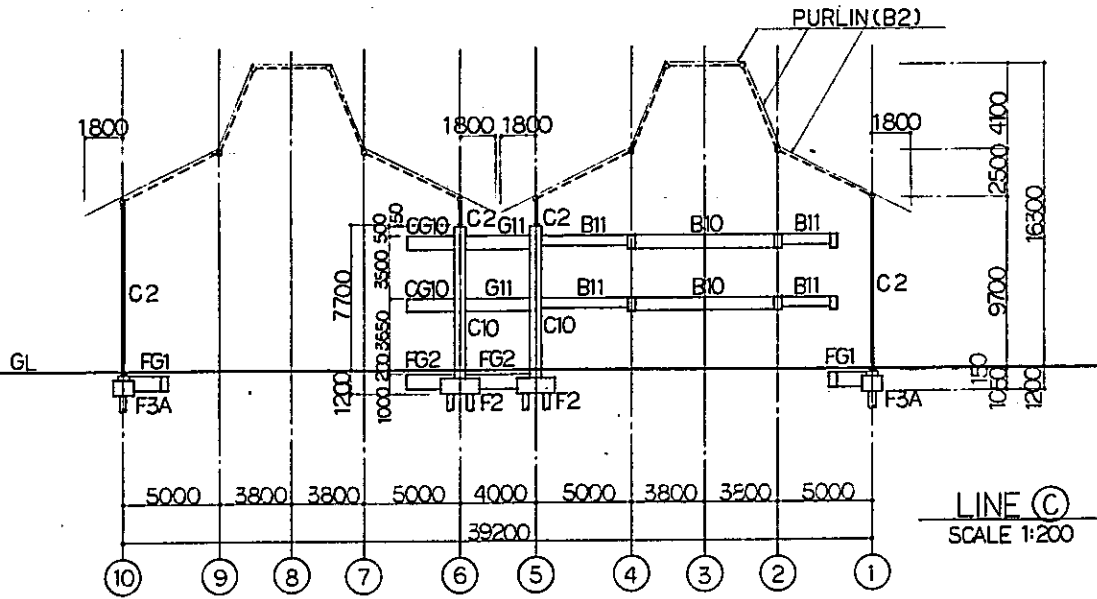


LINE C  
SCALE 1:200

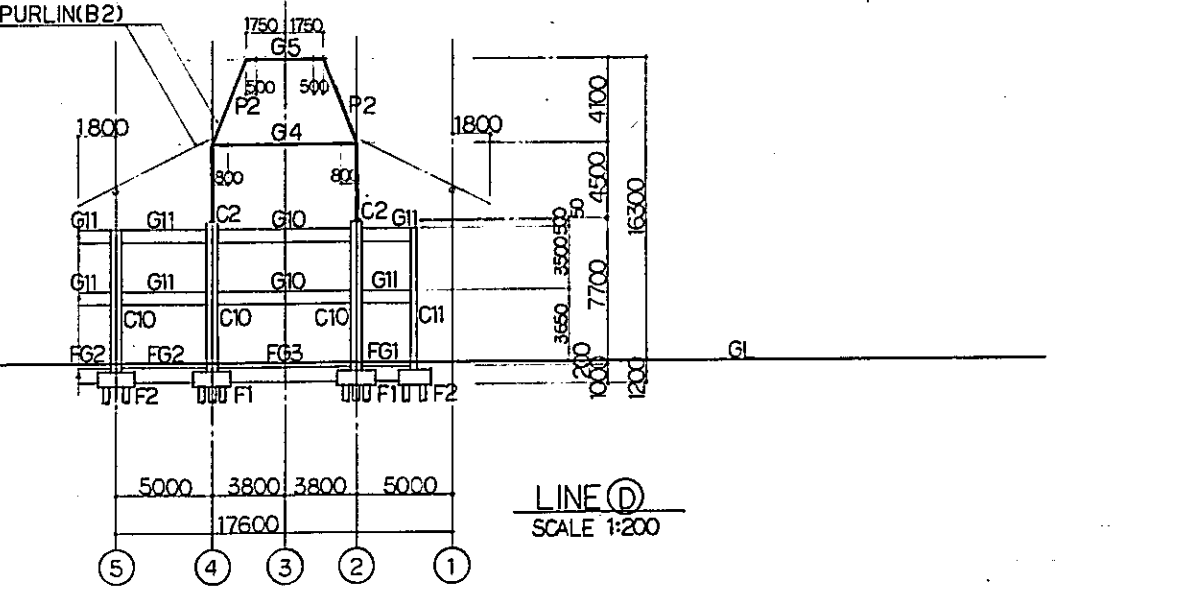


LINE D  
SCALE 1:200

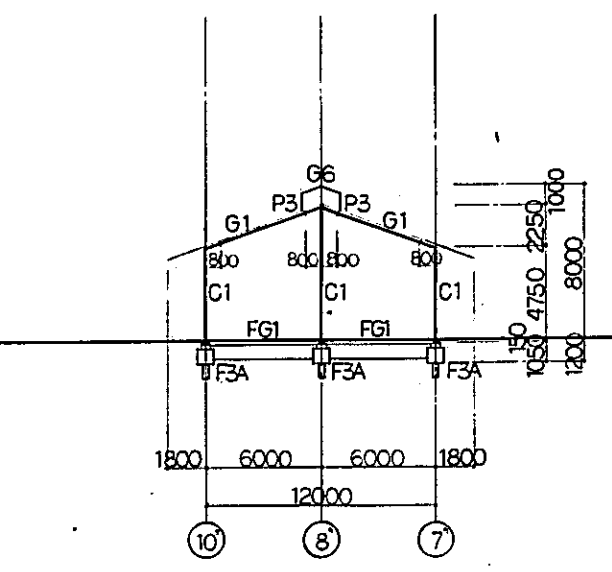

LINE F-O-P  
SCALE 1:200

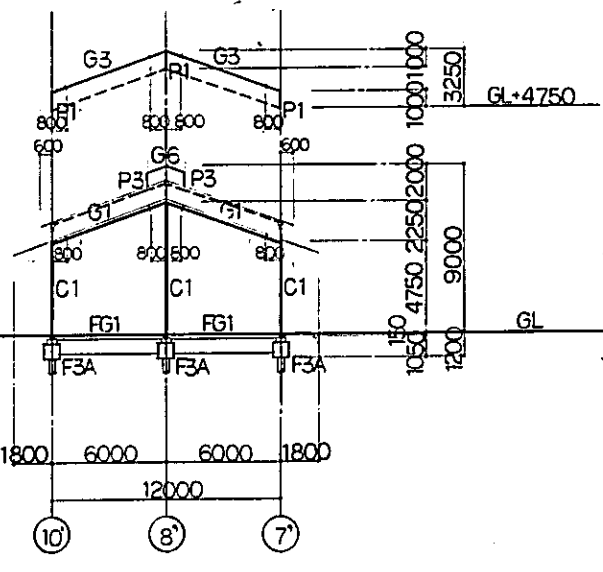


LINE J-N  
SCALE 1:200

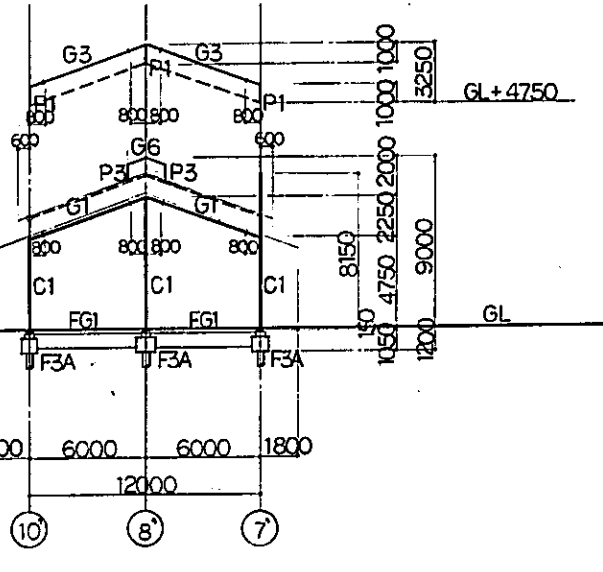


LINE L  
SCALE 1:200

|  |           |                      |       |         |           |
|--|-----------|----------------------|-------|---------|-----------|
| REPUBLIC OF INDONESIA<br>MINISTRY OF COMMUNICATIONS<br>DIRECTORATE GENERAL OF LAND TRANSPORT<br>AND INLAND WATERWAYS |           |                      |       |         |           |
| NEW RAILWAY LINE FOR CENGKARENG AIRPORT<br>CONSTRUCTION PROJECT  |           |                      |       |         |           |
| JAPAN INTERNATIONAL COOPERATION AGENCY<br>(JICA)   |           |                      |       |         |           |
| REVISIONS  | DATE      | DESIGNED             | DRAWN | CHECKED | SUBMITTED |
| B  | 1 AUG 88  | GH                   | JK    | SK      | JK        |
| A  | 15 FEB 88 | GH                   | JK    | SK      | JK        |
| AIRPORT TERMINAL STATION<br>FRAMING ELEVATION<br>( SHEET 2 OF 2 )  |           |                      |       |         |           |
| PACKAGE: 1 CIVIL AND ARCHITECTURAL WORK  |           |                      |       |         |           |
| SCALE: 1:200   |           | DRAWING NO: AS - 008 |       |         |           |

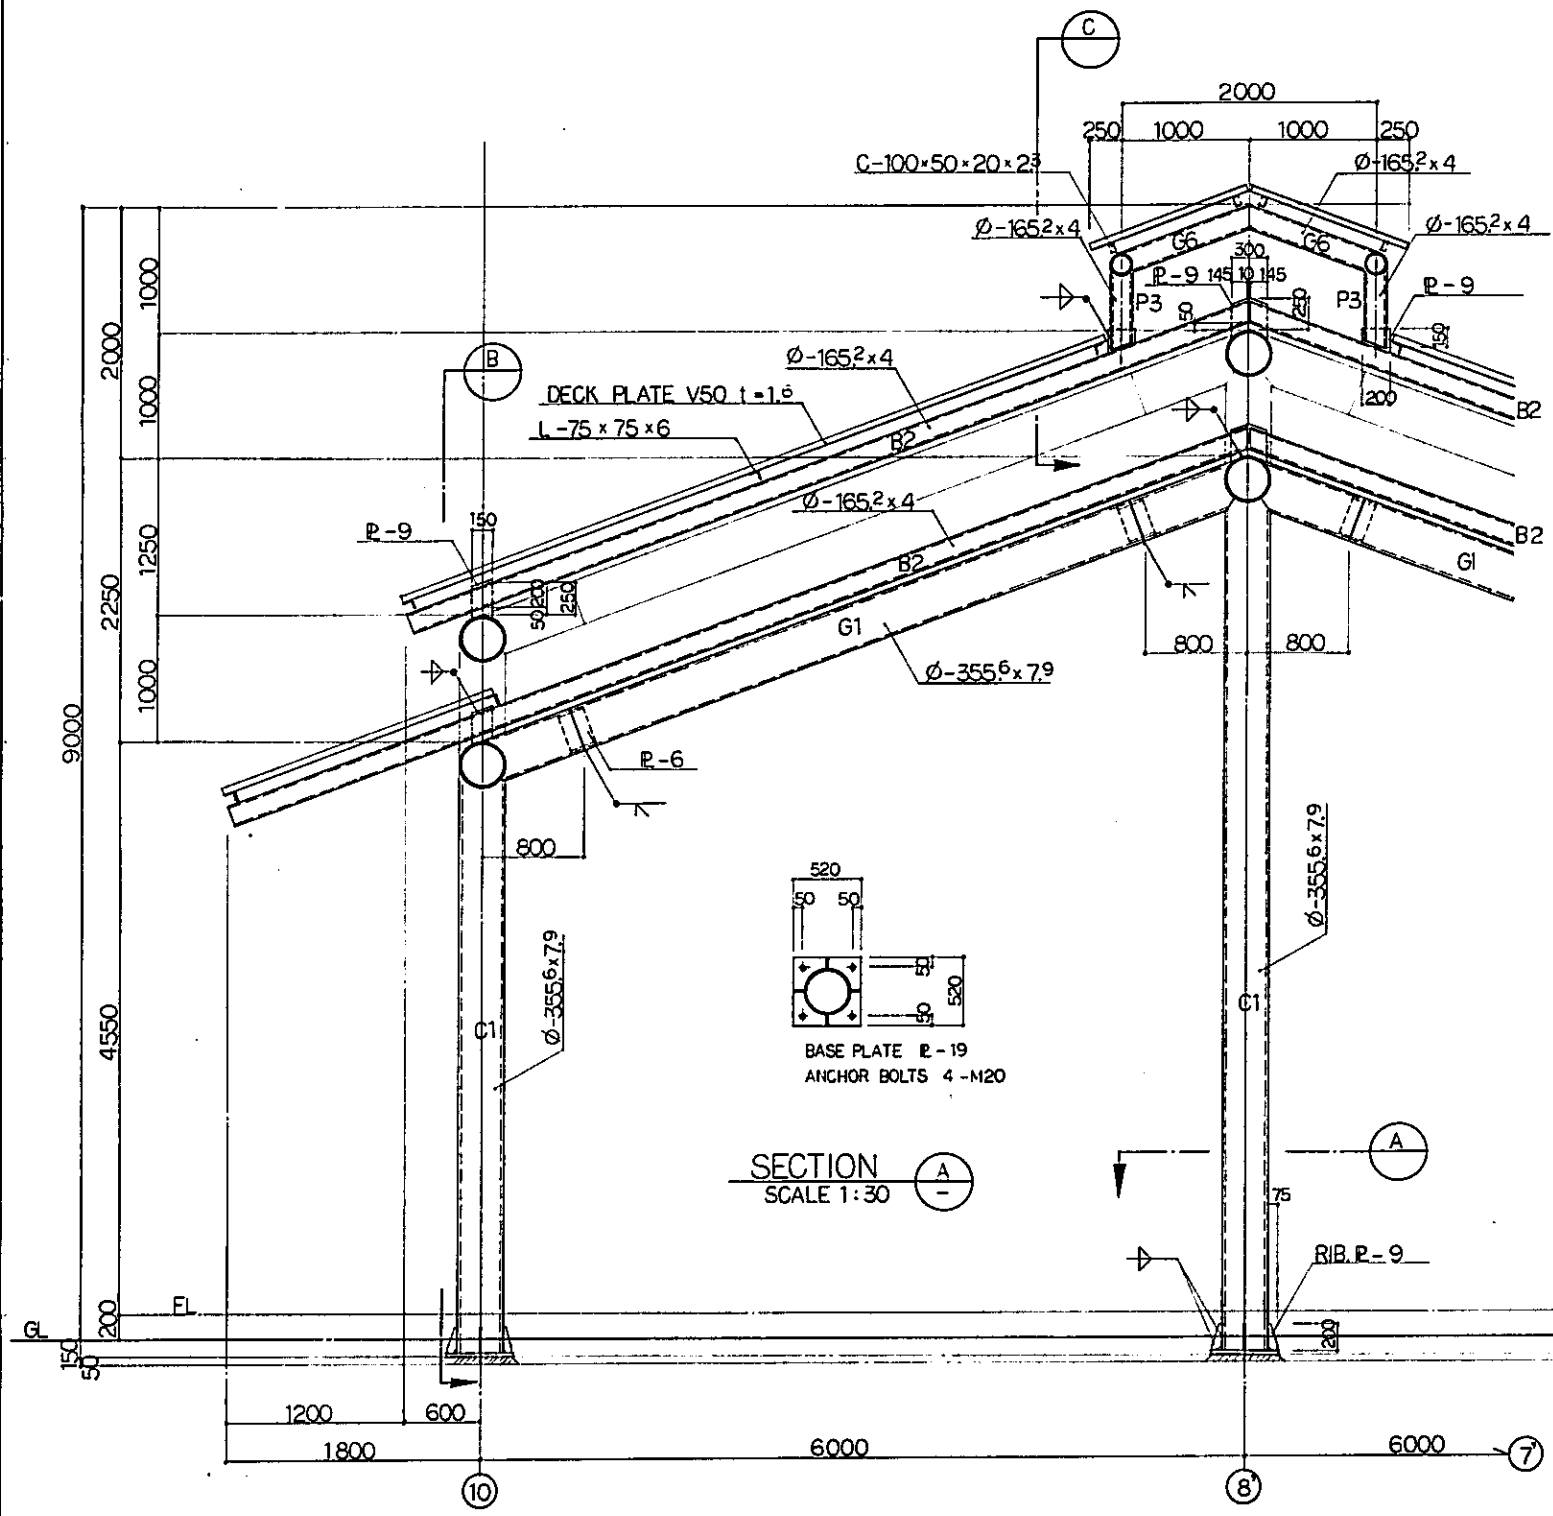

SECTION A  
SCALE 1:30

LINE FRAMING DETAIL  
SCALE 1:30

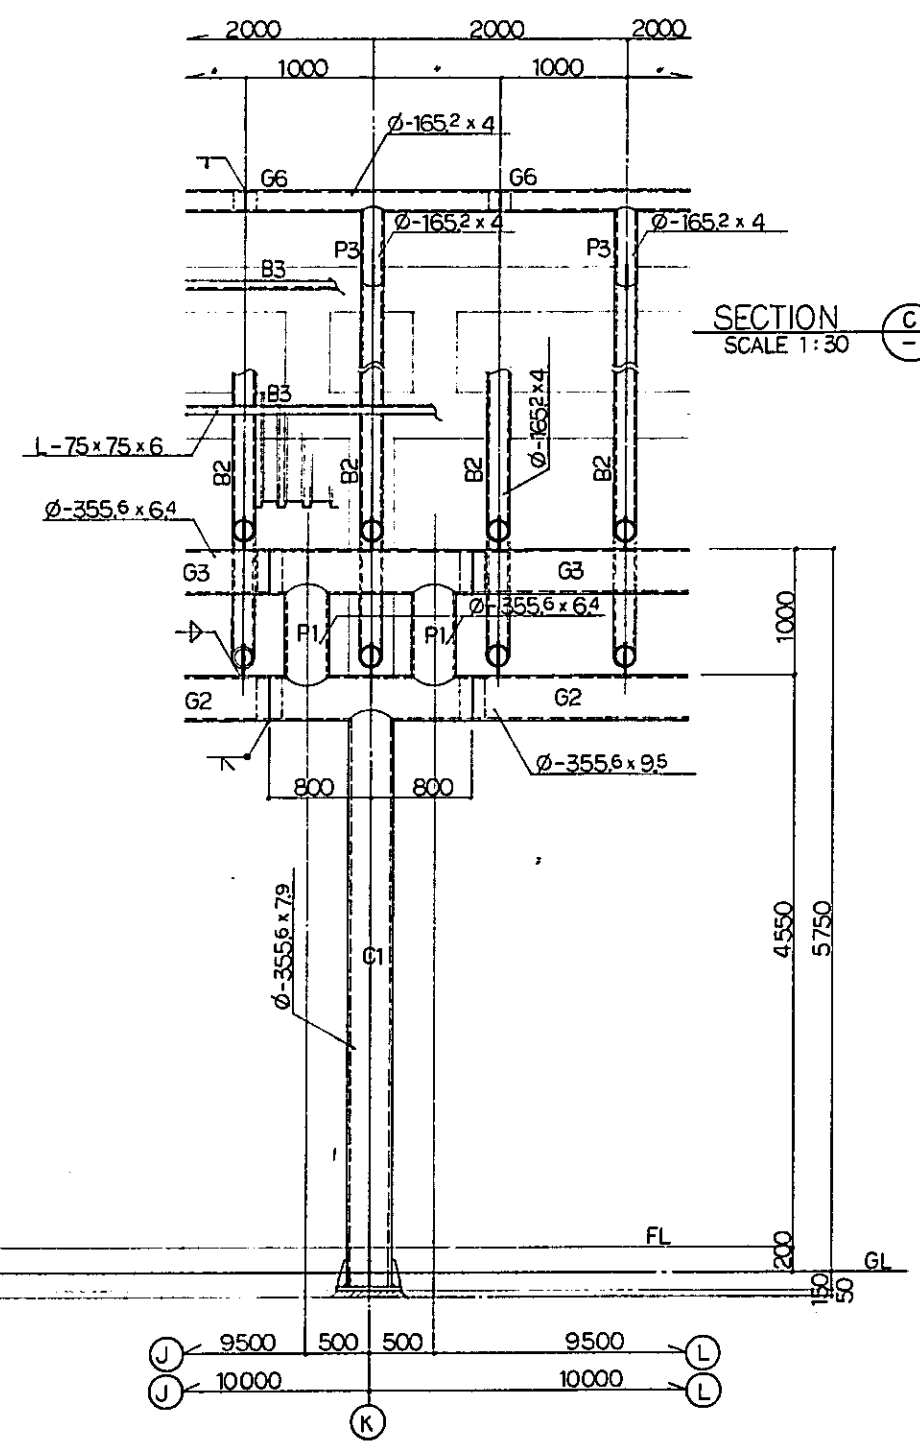


SECTION C  
SCALE 1:30

SECTION B  
SCALE 1:30

|  |             |          |       |         |          |
|--|-------------|----------|-------|---------|----------|
| REPUBLIC OF INDONESIA<br>MINISTRY OF COMMUNICATIONS<br>DIRECTORATE GENERAL OF LAND TRANSPORT<br>AND INLAND WATERWAYS |             |          |       |         |          |
| NEW RAILWAY LINE FOR CENKARENG AIRPORT<br>CONSTRUCTION PROJECT   |             |          |       |         |          |
| JAPAN INTERNATIONAL COOPERATION AGENCY<br>(JICA)   |             |          |       |         |          |
| B  | 1 AUG 88    | GH       | HM    | SKM     | KK       |
| A  | 15 FEB 88   | GH       | HM    | SKM     | KK       |
| REVISIONS  | DATE        | DESIGNED | DRAWN | CHECKED | REVIEWED |
| AIRPORT TERMINAL STATION<br>FRAMING DETAIL<br>( SHEET 1 OF 4 )   |             |          |       |         |          |
| PACKAGE: I CIVIL AND ARCHITECTURAL WORK  |             |          |       |         |          |
| SCALE  | DRAWING NO. |          |       |         |          |
| 1:30   | AS - 009    |          |       |         |          |




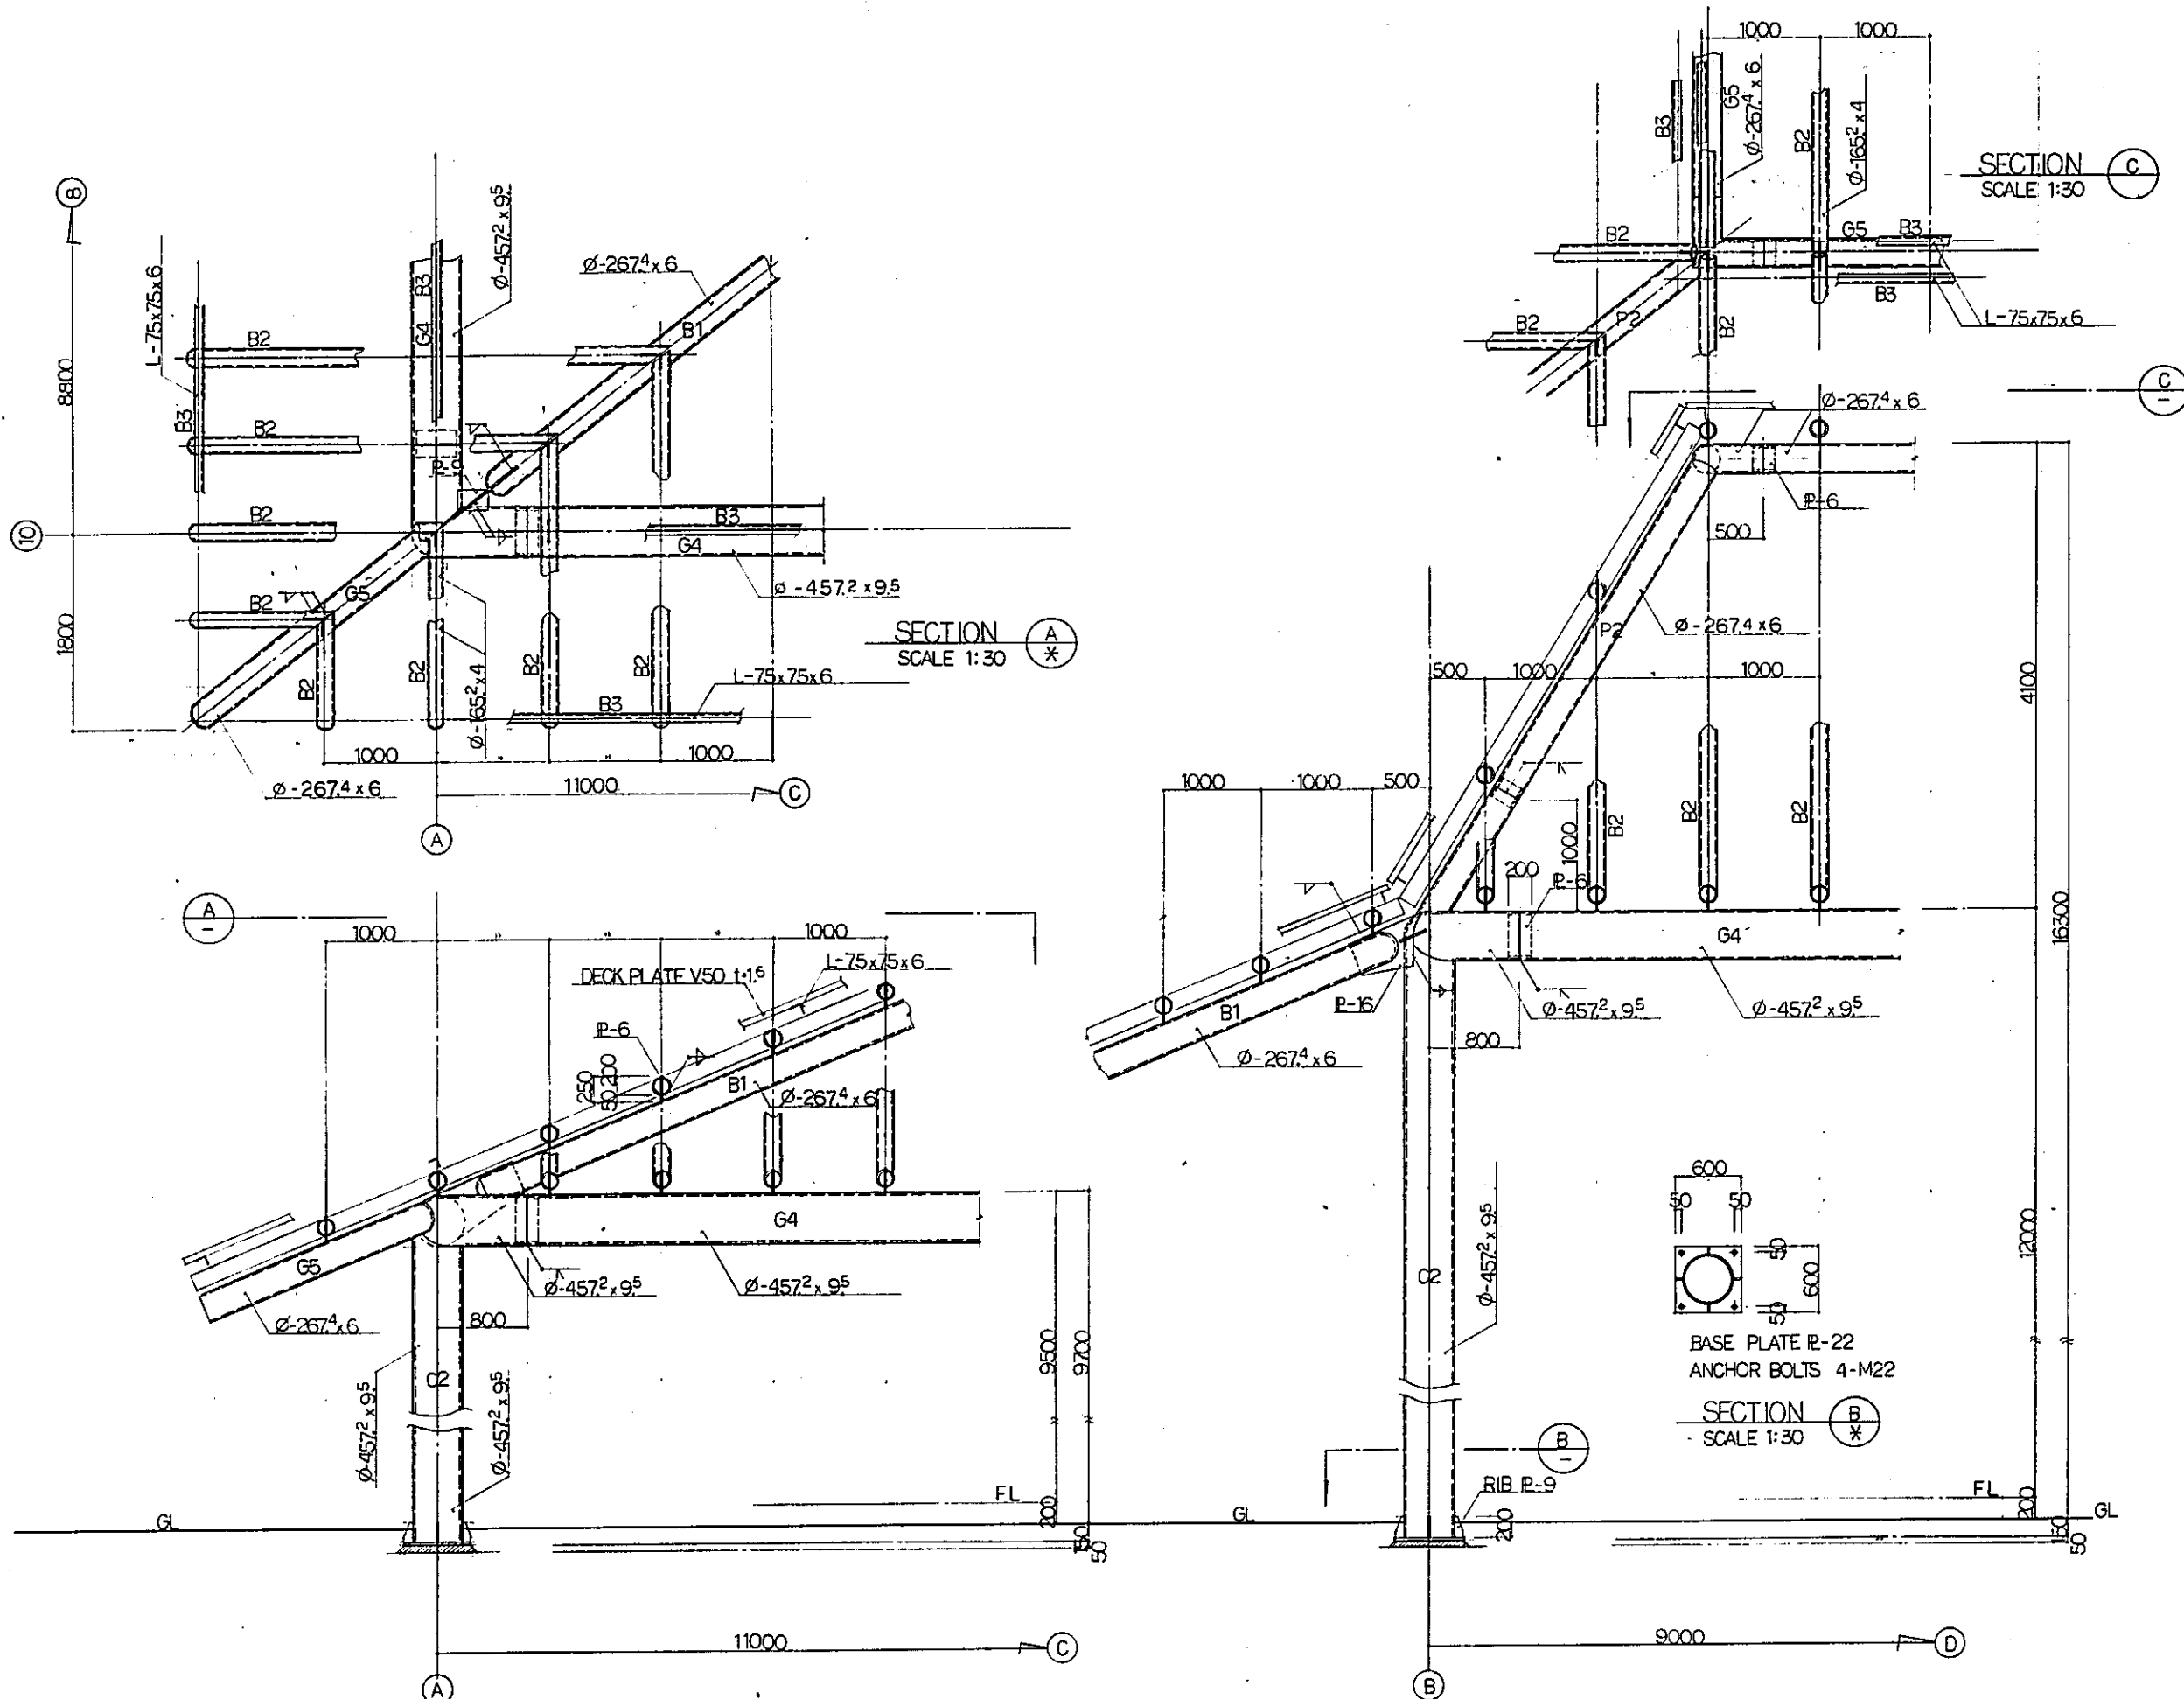

⑩ LINE FRAMING DETAIL  
SCALE 1:30


⑨ LINE FRAMING DETAIL  
SCALE 1:30

|  |           |                      |       |             |             |
|--|-----------|----------------------|-------|-------------|-------------|
| REPUBLIC OF INDONESIA<br>MINISTRY OF COMMUNICATIONS<br>DIRECTORATE GENERAL OF LAND TRANSPORT<br>AND INLAND WATERWAYS |           |                      |       |             |             |
| NEW RAILWAY LINE FOR CENGKARENG AIRPORT<br>CONSTRUCTION PROJECT  |           |                      |       |             |             |
| JAPAN INTERNATIONAL COOPERATION AGENCY<br>(JICA)   |           |                      |       |             |             |
| REVISIONS  | DATE      | DESIGNED             | DRAWN | CHECKED     | SUBMITTED   |
| B  | 1 AUG 79  | M.G.                 | Y.M.  | P.          | K.M. / M.K. |
| A  | 15 FEB 80 | Y.M.                 | P.    | K.M. / M.K. |             |
| AIRPORT TERMINAL STATION<br>FRAMING DETAIL<br>( SHEET 2 OF 4 )   |           |                      |       |             |             |
| PACKAGE: I CIVIL AND ARCHITECTURAL WORK  |           |                      |       |             |             |
| SCALE: 1:30  |           | DRAWING NO: AS - 010 |       |             |             |

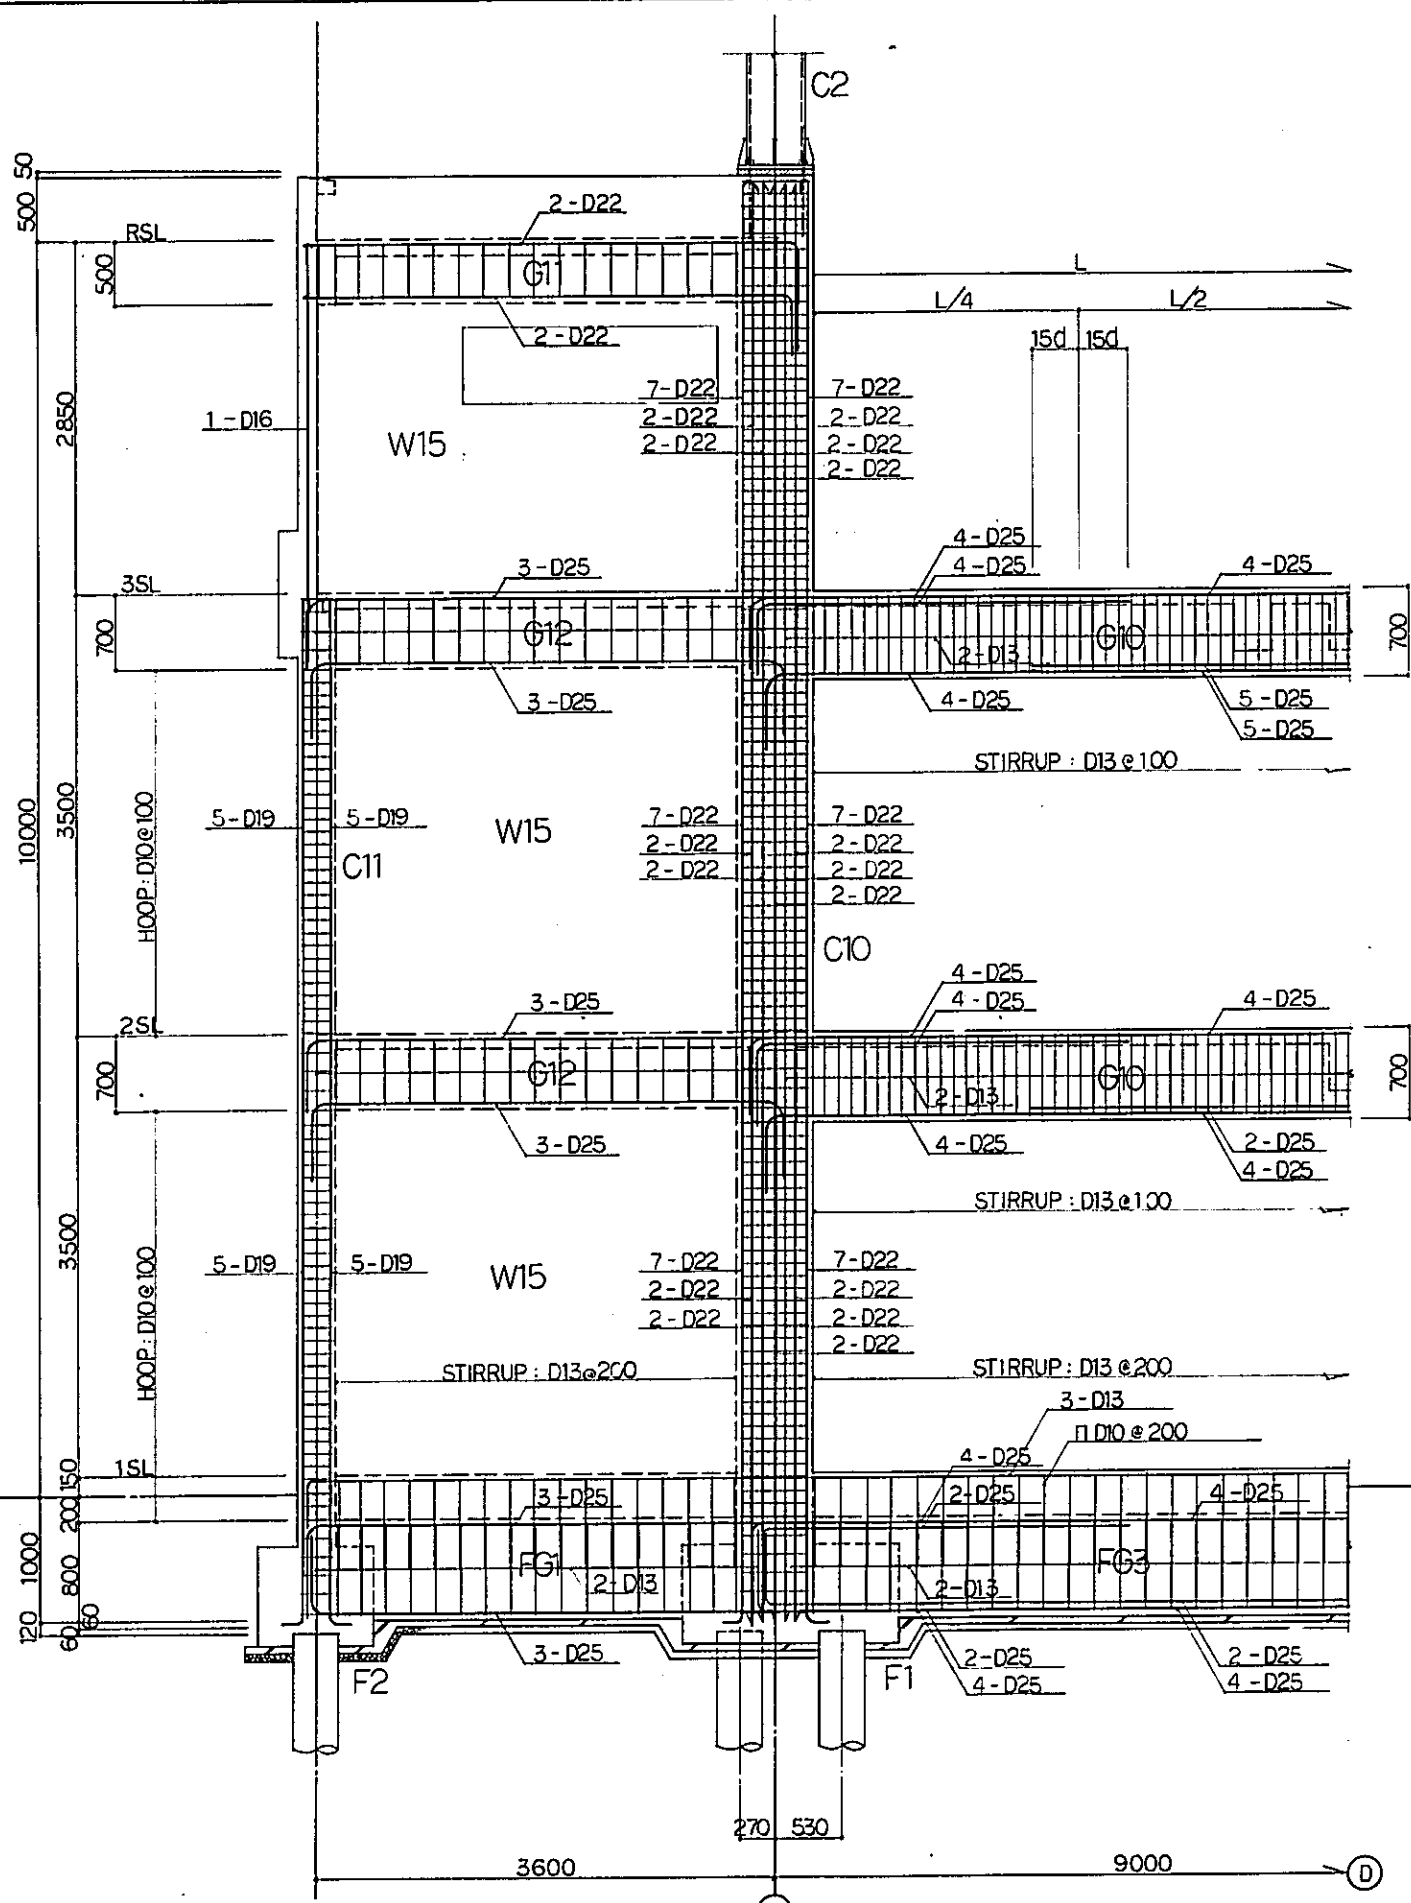

**(A) LINE FRAMING DETAIL**  
SCALE 1:30

UNLESS OTHERWISE NOTED  
 1. STIRRUP : D10 @ 200  
 2. HOOP : D10 @ 150  
 3. WEB BAR : 2-D10

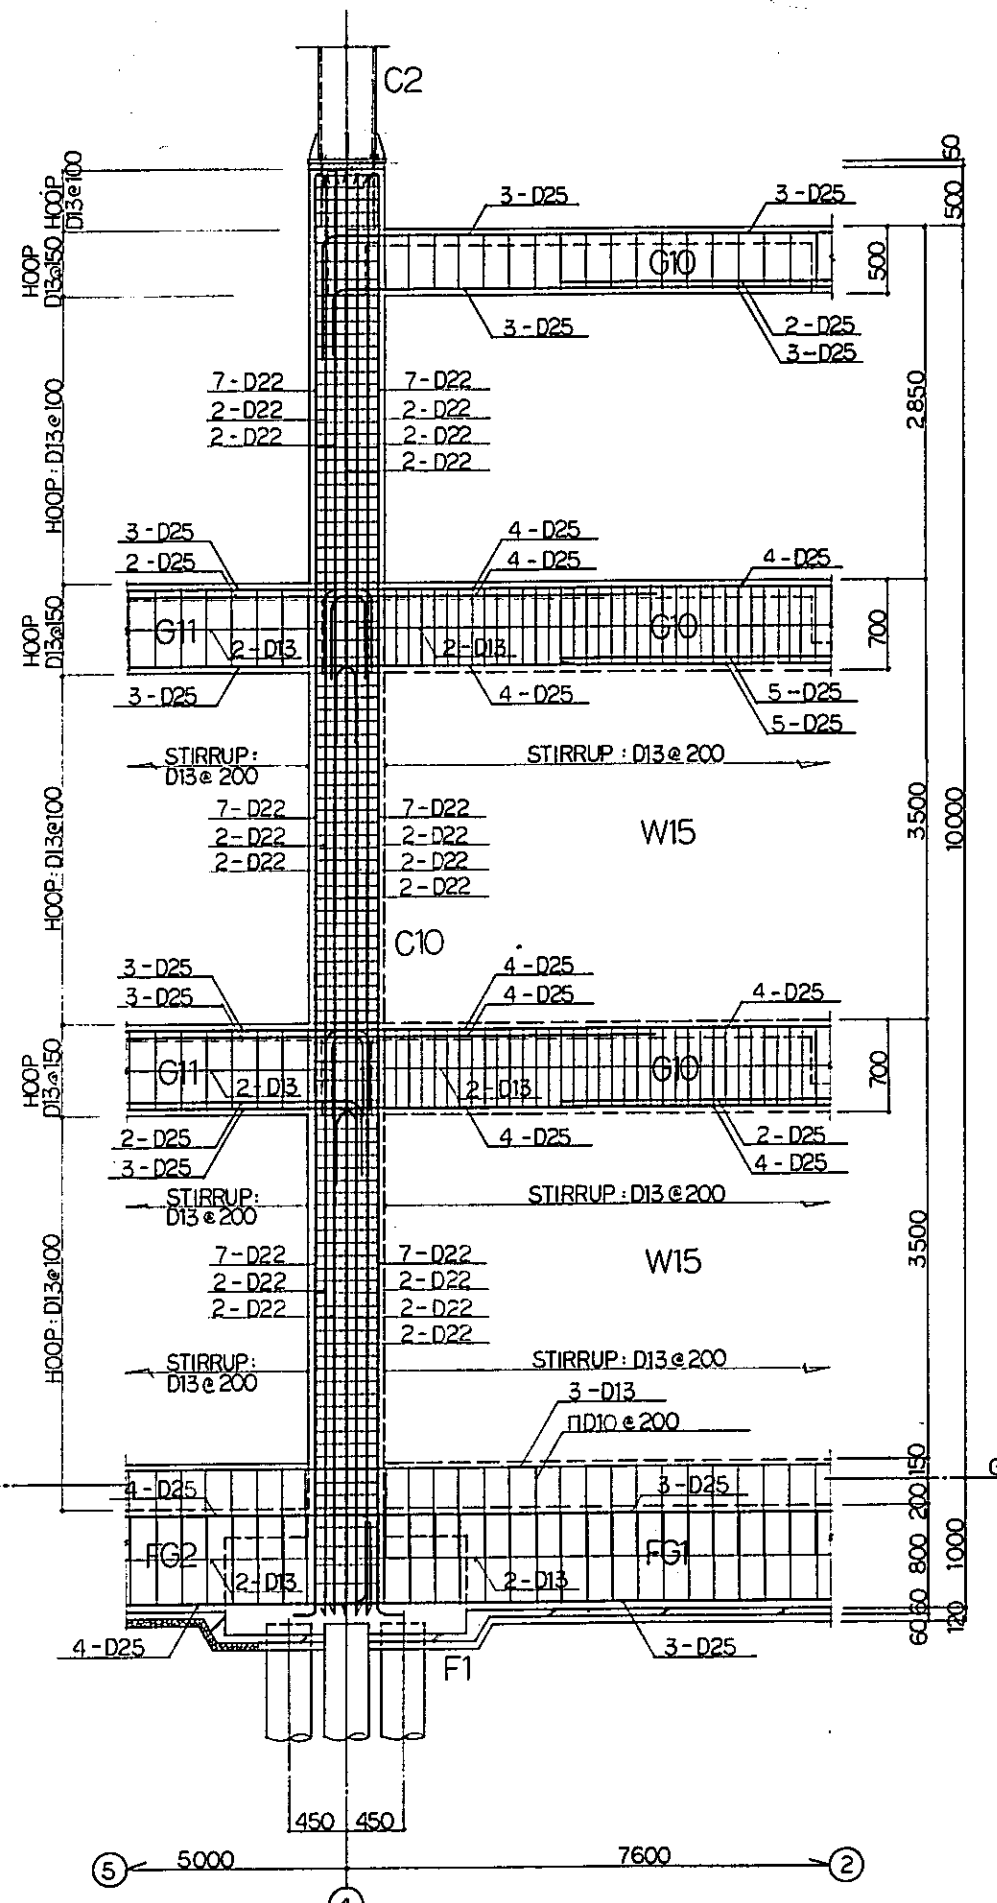

**(B) LINE FRAMING DETAIL**  
SCALE 1:30

REPUBLIC OF INDONESIA  
 MINISTRY OF COMMUNICATIONS  
 DIRECTORATE GENERAL OF LAND TRANSPORT  
 AND INLAND WATERWAYS

NEW RAILWAY LINE FOR CENGKARENG AIRPORT  
 CONSTRUCTION PROJECT


JAPAN INTERNATIONAL COOPERATION AGENCY  
 (JICA)

|   |            |    |    |    |      |   |
|---|------------|----|----|----|------|---|
| B | 1 AUG. 89  | GM | GM | GM | K.M. | K |
| A | 15 FEB. 89 | GM | GM | GM | K.M. | K |

REVISIONS    DATE    DESIGNED    DRAWN    CHECKED    REVIEWED    SUBMITTED


AIRPORT TERMINAL STATION  
 FRAMING DETAIL  
 ( SHEET 3 OF 4 )

PACKAGE: I CIVIL AND ARCHITECTURAL WORK  
 SCALE: 1:30    DRAWING NO: AS-011

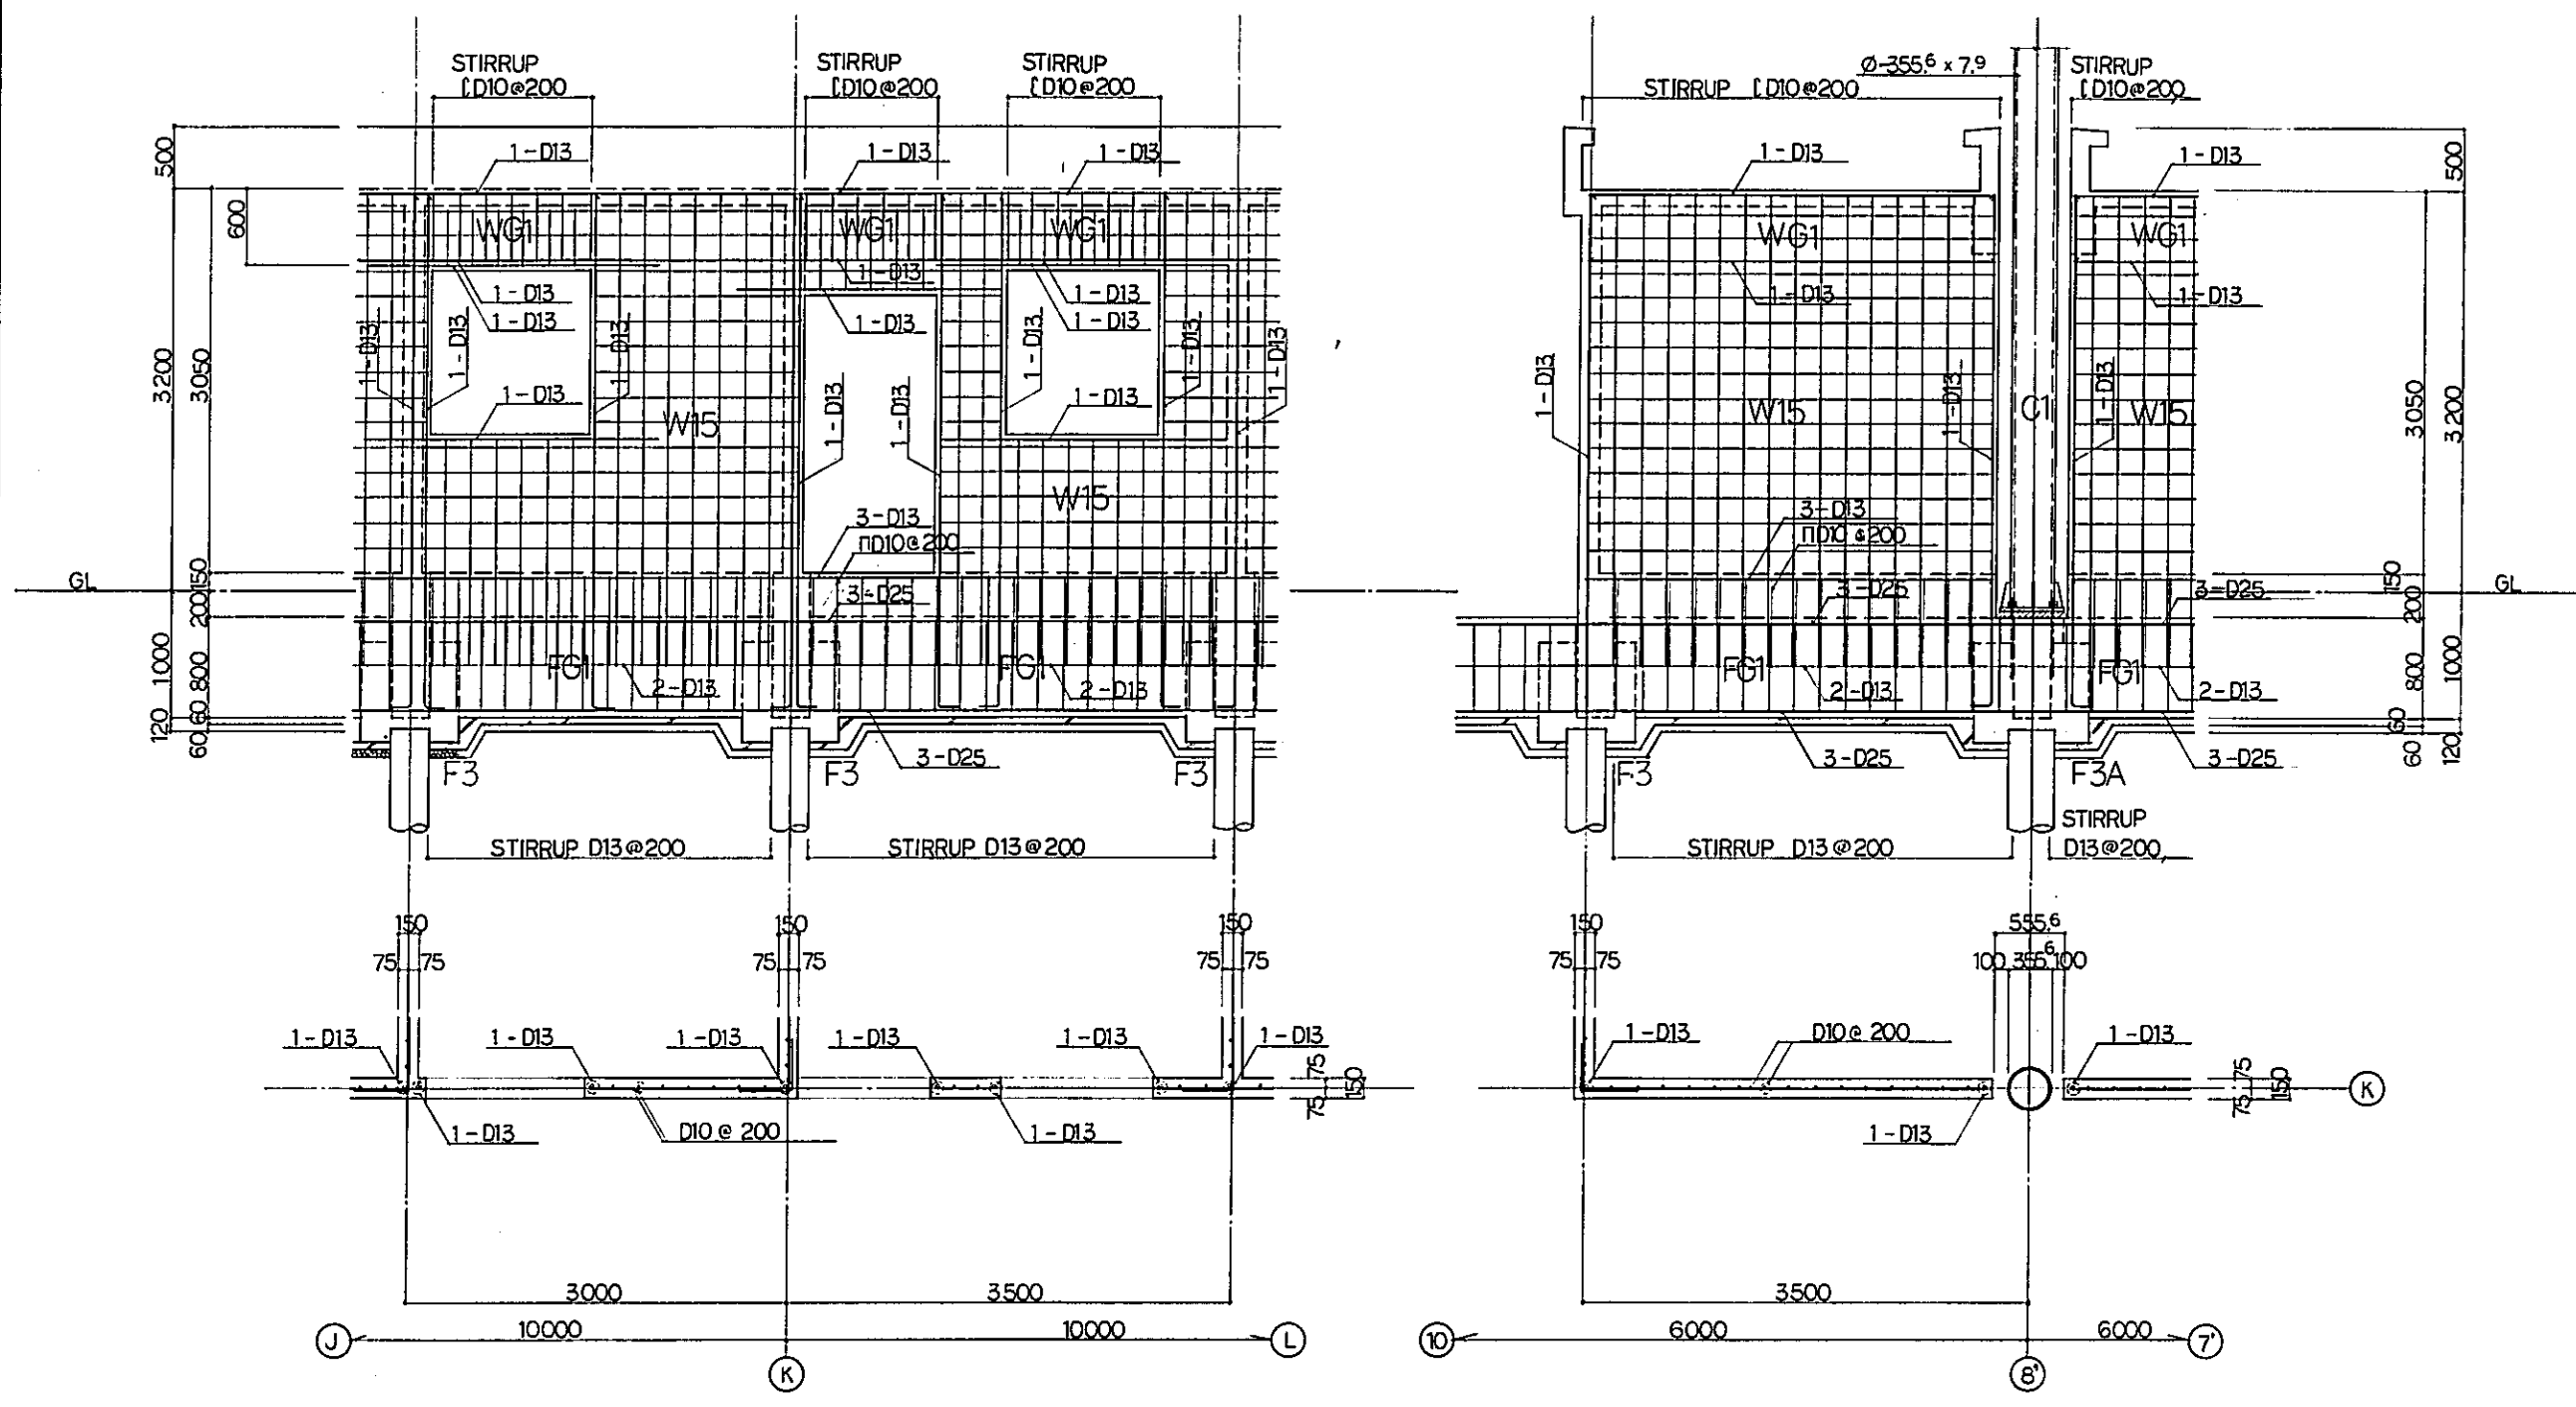

FRAMING DETAIL  
SCALE 1:30

|  |             |          |       |         |          |           |
|--|-------------|----------|-------|---------|----------|-----------|
| REPUBLIC OF INDONESIA<br>MINISTRY OF COMMUNICATIONS<br>DIRECTORATE GENERAL OF LAND TRANSPORT<br>AND INLAND WATERWAYS |             |          |       |         |          |           |
| NEW RAILWAY LINE FOR CENGKARENG AIRPORT<br>CONSTRUCTION PROJECT  |             |          |       |         |          |           |
| JAPAN INTERNATIONAL COOPERATION AGENCY<br>(JICA)   |             |          |       |         |          |           |
| B  | 1 AUG 88    | GM       | HN    | Emb     | K.M      | M.K       |
| A  | 15 FEB 88   | GM       | HN    | Emb     | K.M      | M.K       |
| REVISIONS  | DATE        | DESIGNED | DRAWN | CHECKED | REVIEWED | SUBMITTED |
| AIRPORT TERMINAL STATION<br>FRAMING DETAIL<br>( SHEET 4 OF 4 )   |             |          |       |         |          |           |
| PACKAGE: I CIVIL AND ARCHITECTURAL WORK  |             |          |       |         |          |           |
| SCALE  | DRAWING NO: |          |       |         |          |           |
| 1:30   | AS - 012    |          |       |         |          |           |

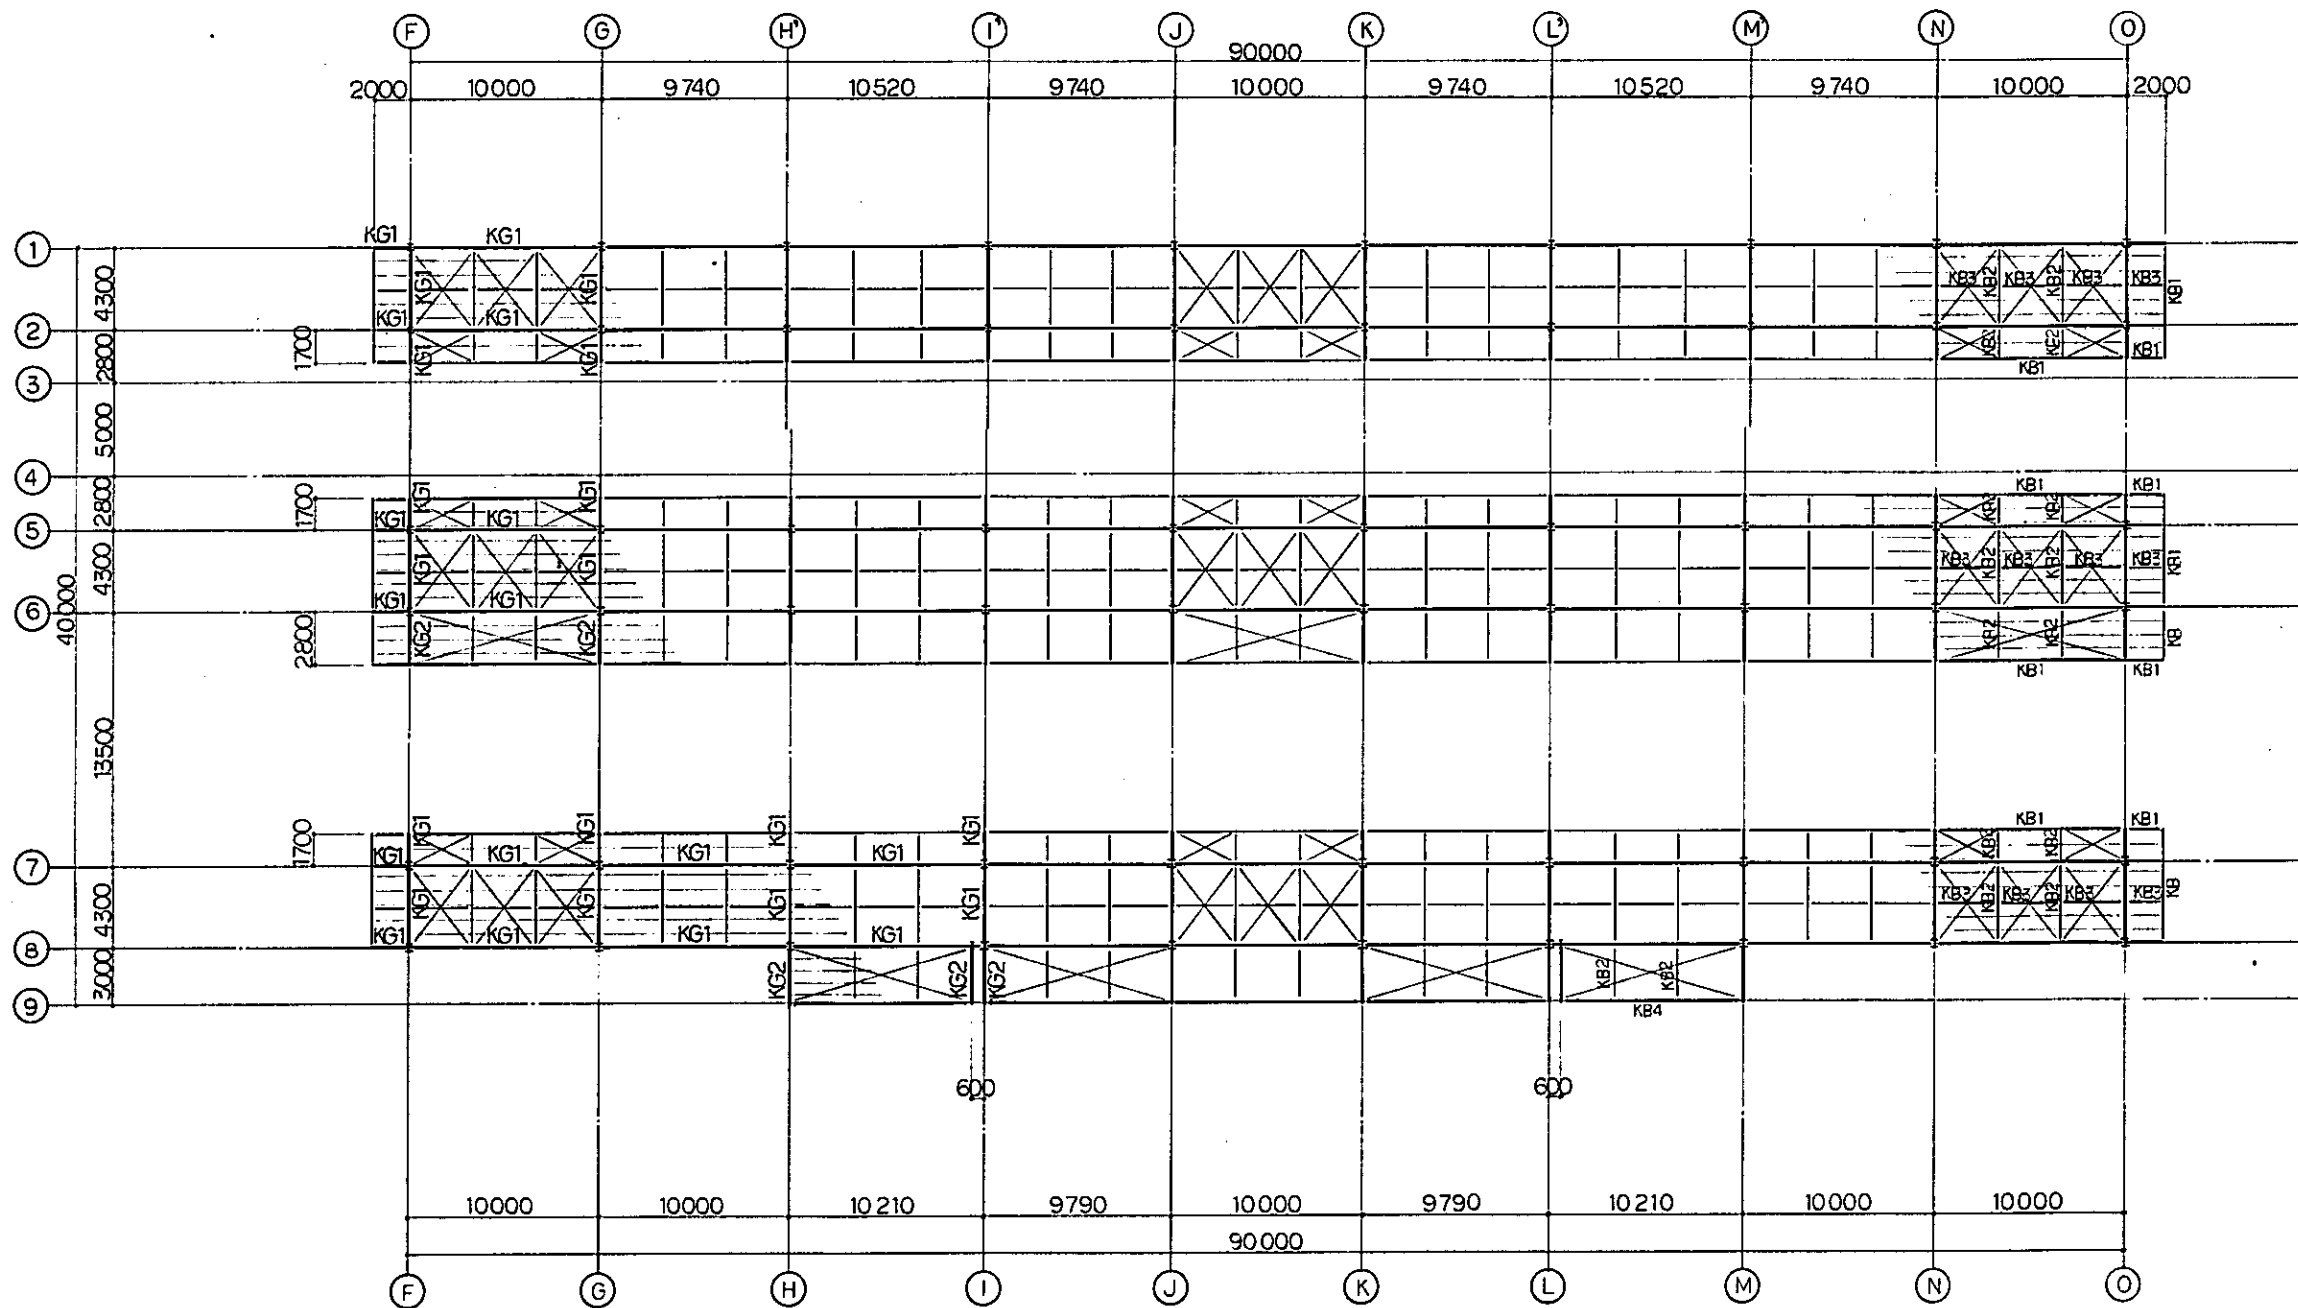

ROOF FRAMING PLAN  
 SCALE 1:200  
 UNLESS OTHERWISE NOTED  
 1. BRACE : 1-16 φ  
 2. PURLIN: C-100×50×20×23 e 750

REPUBLIC OF INDONESIA  
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 DIRECTORATE GENERAL OF LAND TRANSPORT  
 AND INLAND WATERWAYS

NEW RAILWAY LINE FOR CENGKARENG AIRPORT  
 CONSTRUCTION PROJECT

JAPAN INTERNATIONAL COOPERATION AGENCY  
 (JICA)


|   |           |    |    |      |      |    |
|---|-----------|----|----|------|------|----|
| B | 10/09/89  | OK | DM | E.S. | K.M. | AK |
| A | 15/FEB/88 | OK | DM | Syuh | K.M. | AK |

|           |      |          |       |         |          |           |
|-----------|------|----------|-------|---------|----------|-----------|
| REVISIONS | DATE | DESIGNED | DRAWN | CHECKED | REVIEWED | SUBMITTED |
|-----------|------|----------|-------|---------|----------|-----------|


KOTA INTAN STATION  
 ROOF FRAMING PLAN

PACKAGE: I CIVIL AND ARCHITECTURAL WORK


SCALE: 1:200      DRAWING NO.: AS - 013

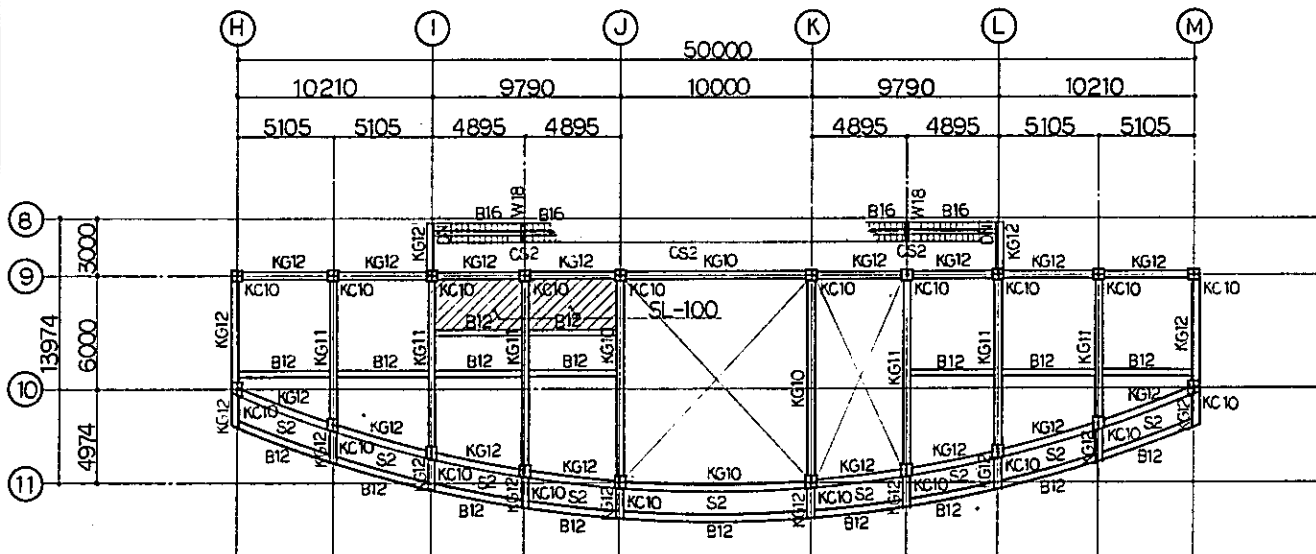

**2<sup>nd</sup> FLOOR FRAMING PLAN**  
 SCALE 1:200  
 UNLESS OTHERWISE NOTED  
 1. SLAB MARK : S3

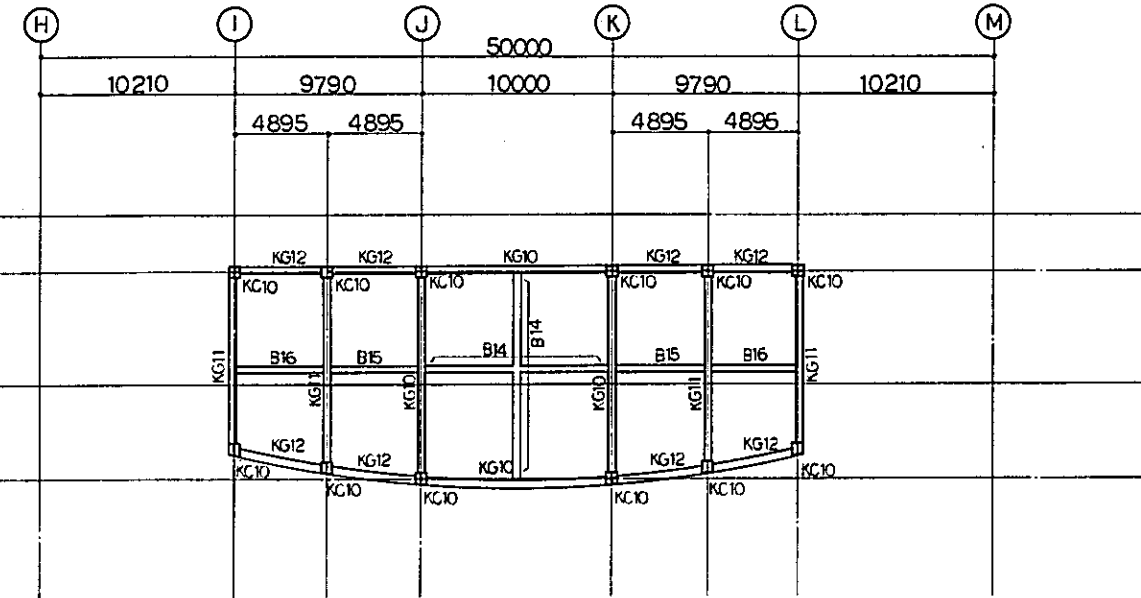


**ROOF FRAMING PLAN**  
 SCALE 1:200  
 UNLESS OTHERWISE NOTED  
 1. SLAB MARK : S3

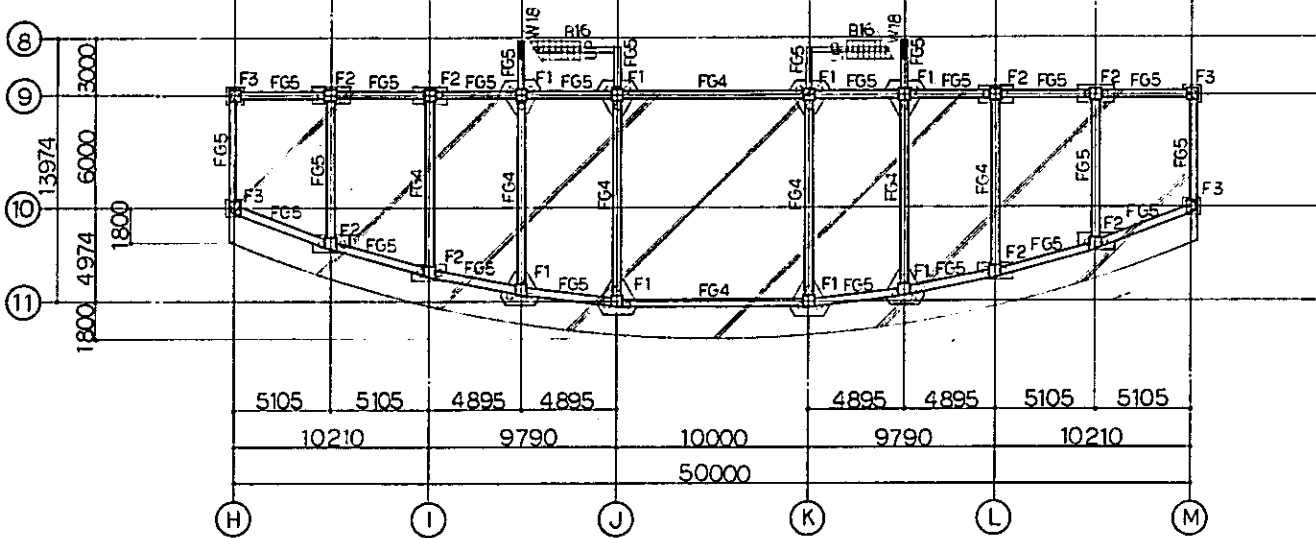


**FOUNDATION PLAN**  
 SCALE 1:200  
 NOTE SHOWS SLAB ON GRADE


|  |           |                      |       |         |          |           |
|--|-----------|----------------------|-------|---------|----------|-----------|
| REPUBLIC OF INDONESIA<br>MINISTRY OF COMMUNICATIONS<br>DIRECTORATE GENERAL OF LAND TRANSPORT<br>AND INLAND WATERWAYS |           |                      |       |         |          |           |
| NEW RAILWAY LINE FOR CENGKARENG AIRPORT<br>CONSTRUCTION PROJECT  |           |                      |       |         |          |           |
| JAPAN INTERNATIONAL COOPERATION AGENCY<br>(JICA)   |           |                      |       |         |          |           |
| B  | 1 AUG 88  | AKH                  | Edm   | Edm     | K.M      | mk        |
| A  | 15 FEB 88 | AKH                  | Edm   | Edm     | K.M      | mk        |
| REVISIONS  | DATE      | DESIGNED             | DRAWN | CHECKED | REVIEWED | SUBMITTED |
| KOTA INTAN STATION<br>FRAMING PLAN   |           |                      |       |         |          |           |
| PACKAGE: 1 CIVIL AND ARCHITECTURAL WORK  |           |                      |       |         |          |           |
| SCALE 1:200  |           | DRAWING NO. AS - 014 |       |         |          |           |

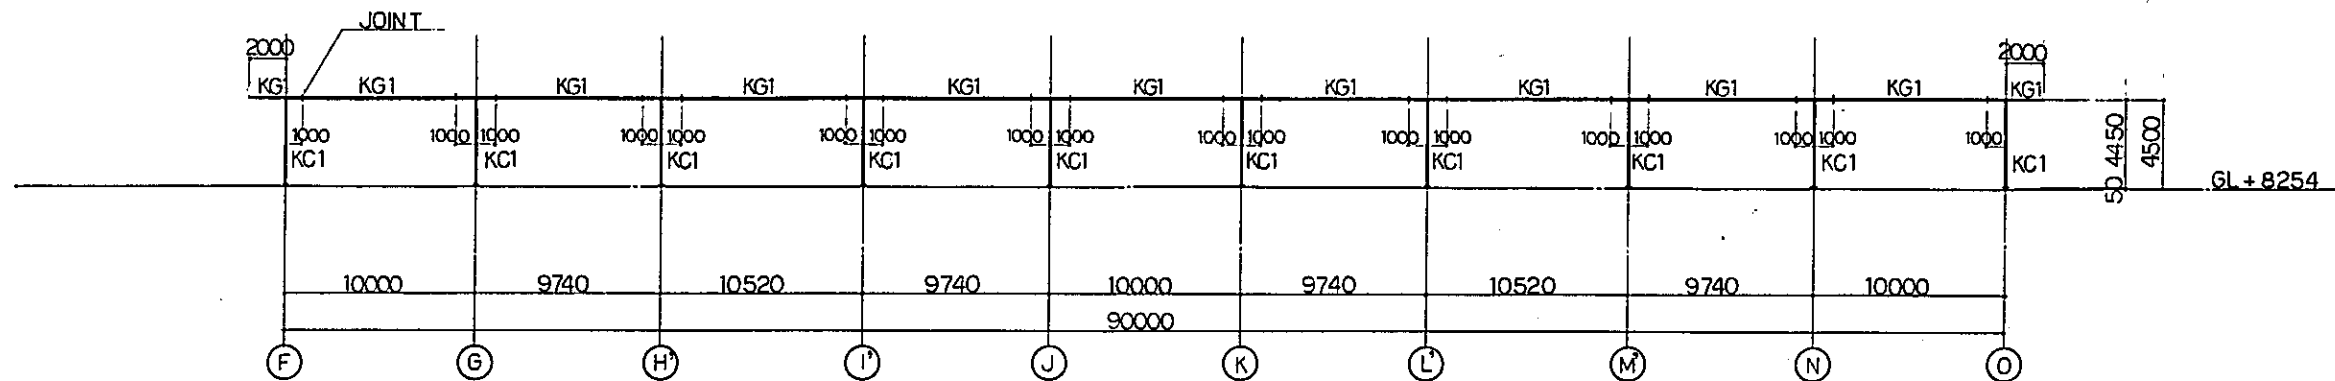


LINE ①  
SCALE 1:200

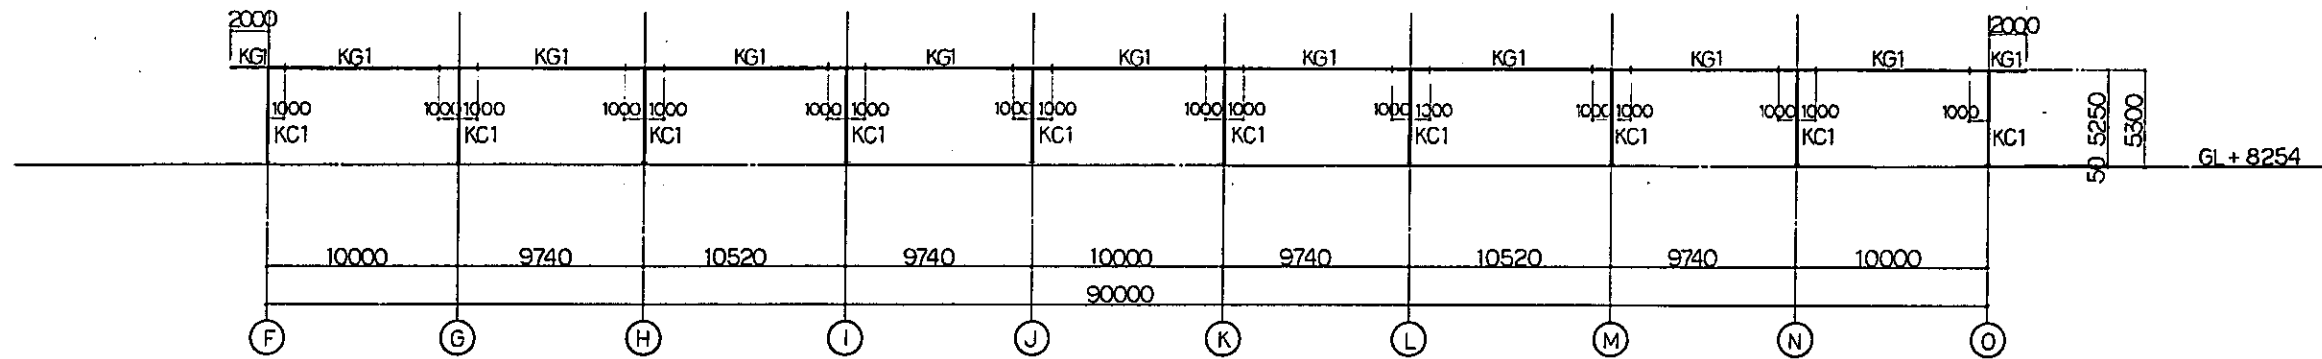

LINE ②  
SCALE 1:200

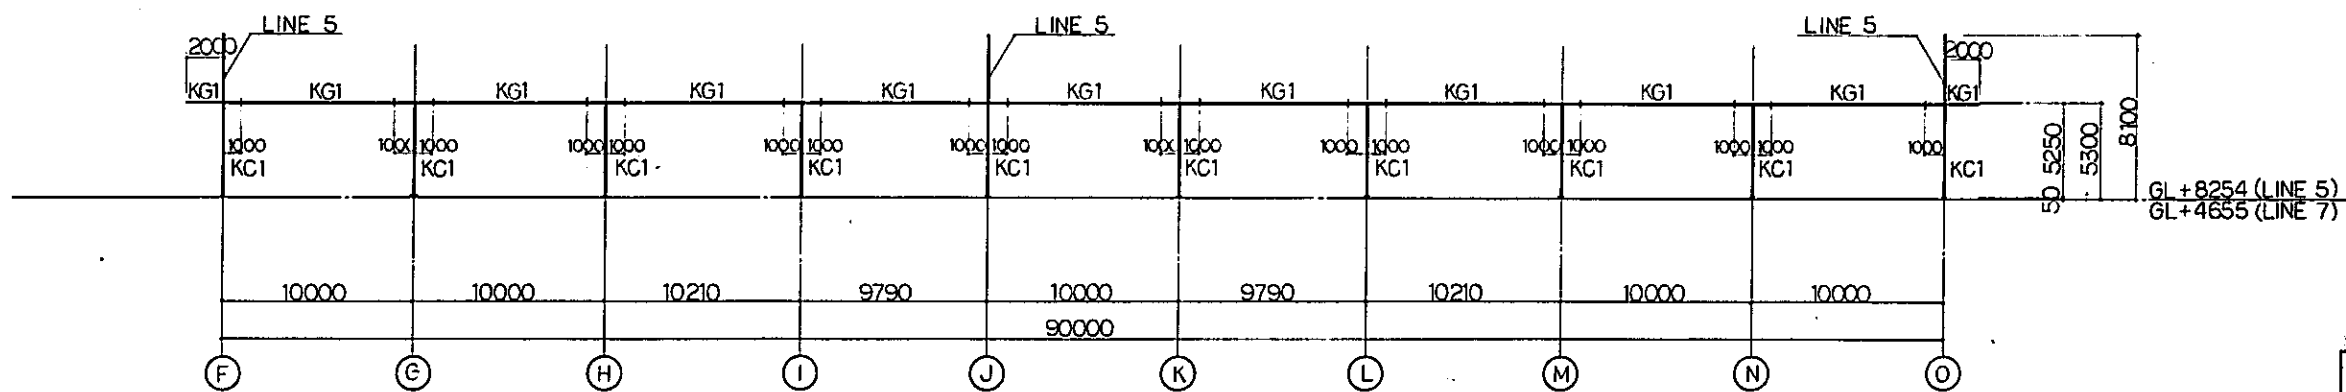

LINE ⑤⑦  
SCALE 1:200

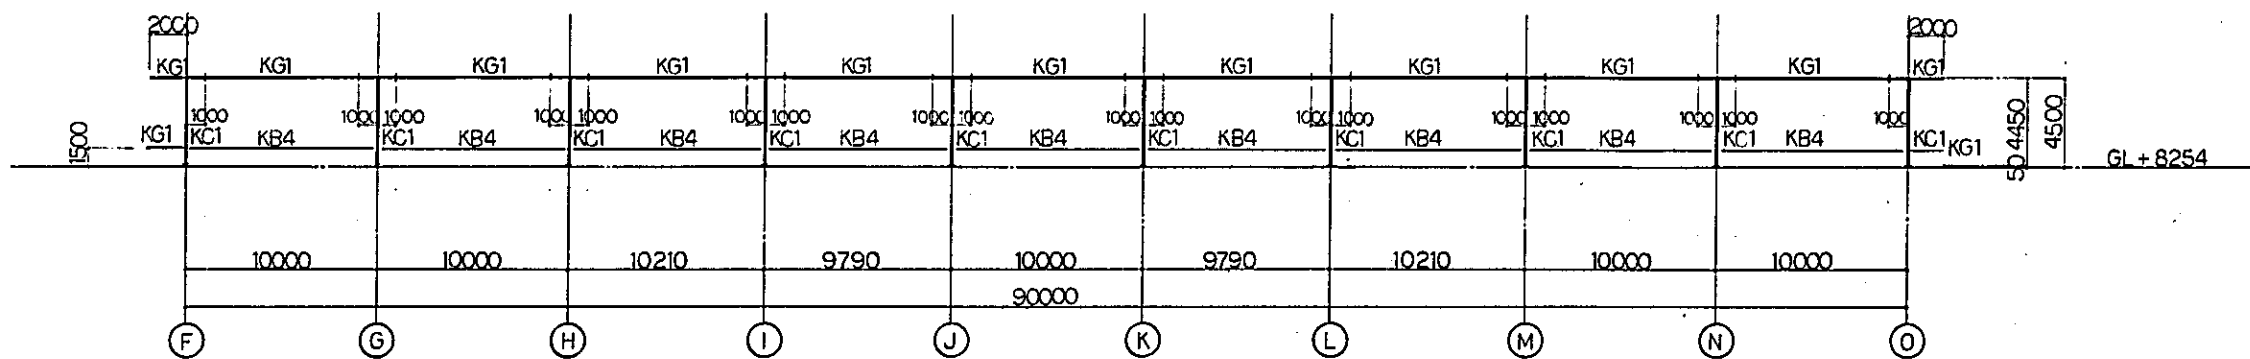

LINE ⑥  
SCALE 1:200

REPUBLIC OF INDONESIA  
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AND INLAND WATERWAYS

NEW RAILWAY LINE FOR CENGKARENG AIRPORT  
CONSTRUCTION PROJECT

JAPAN INTERNATIONAL COOPERATION AGENCY  
(JICA)


|   |                |     |    |     |    |
|---|----------------|-----|----|-----|----|
| B | 1 AUG 29 1994  | JLN | SK | K.M | MK |
| A | 15 FEB 29 1994 | Q.N | SK | K.M | MK |

| REVISIONS | DATE | DESIGNED | DRAWN | CHECKED | REVIEWED | SUBMITTED |
|-----------|------|----------|-------|---------|----------|-----------|
|           |      |          |       |         |          |           |


KOTA INTAN STATION  
FRAMING ELEVATION  
( SHEET 1 OF 2 )

PACKAGE: I CIVIL AND ARCHITECTURAL WORK


SCALE: 1:200 DRAWING NO: AS - 015.

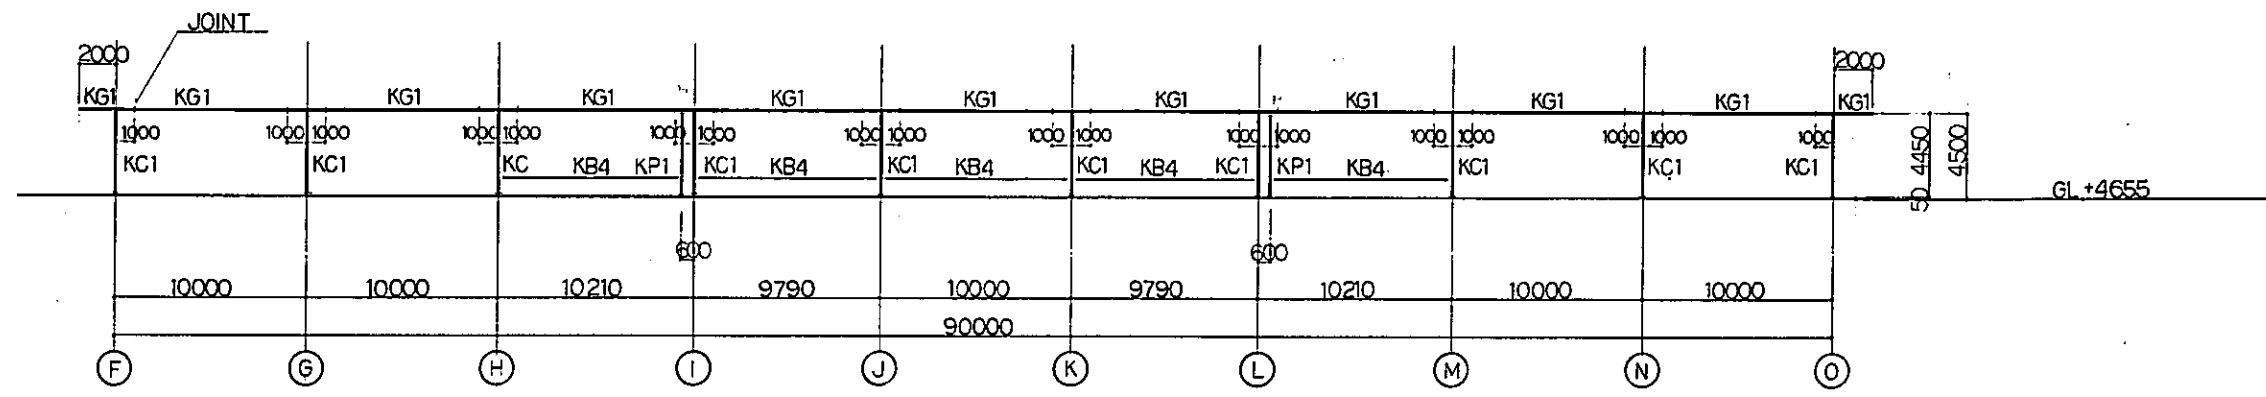


LINE 8  
SCALE 1:200

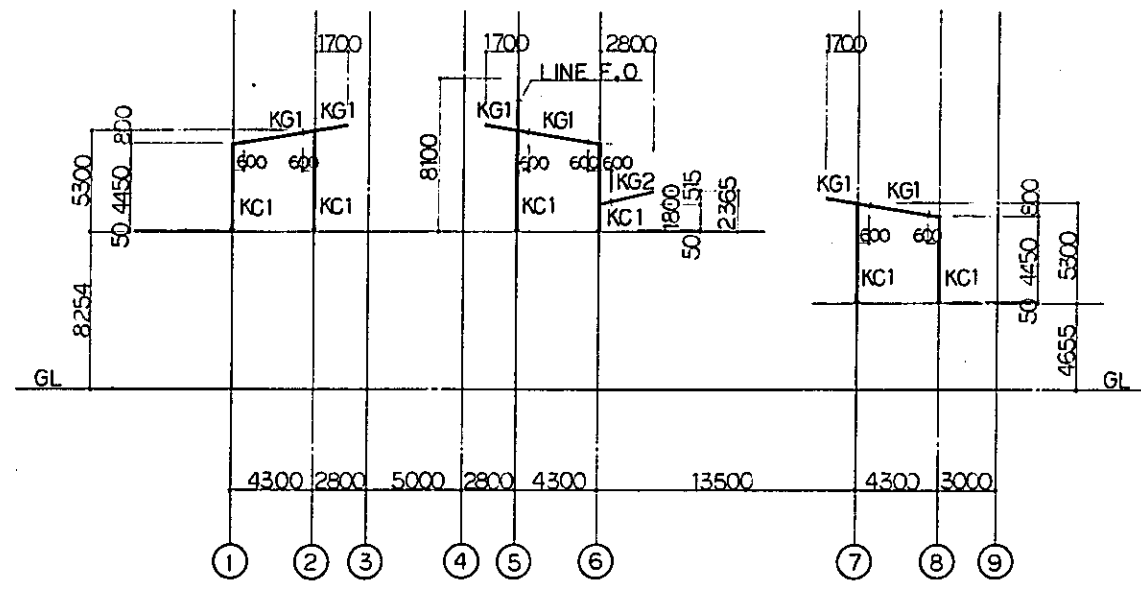


LINE F, G, N, O  
SCALE 1:200

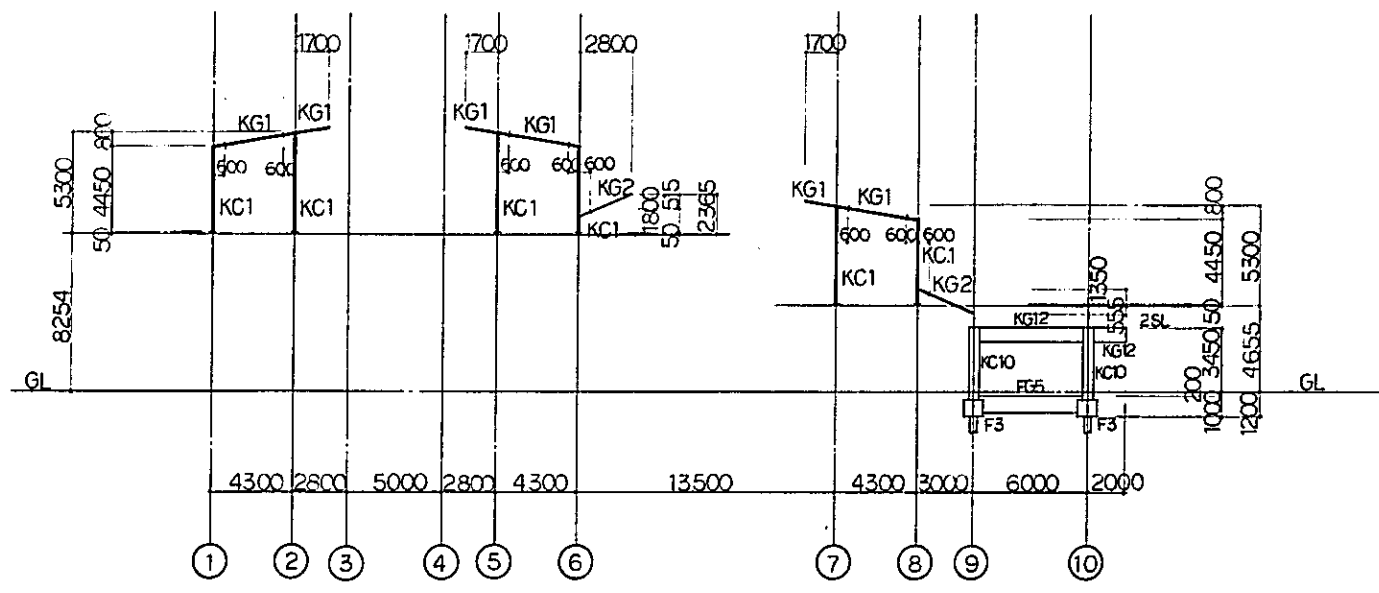

LINE H, M  
SCALE 1:200

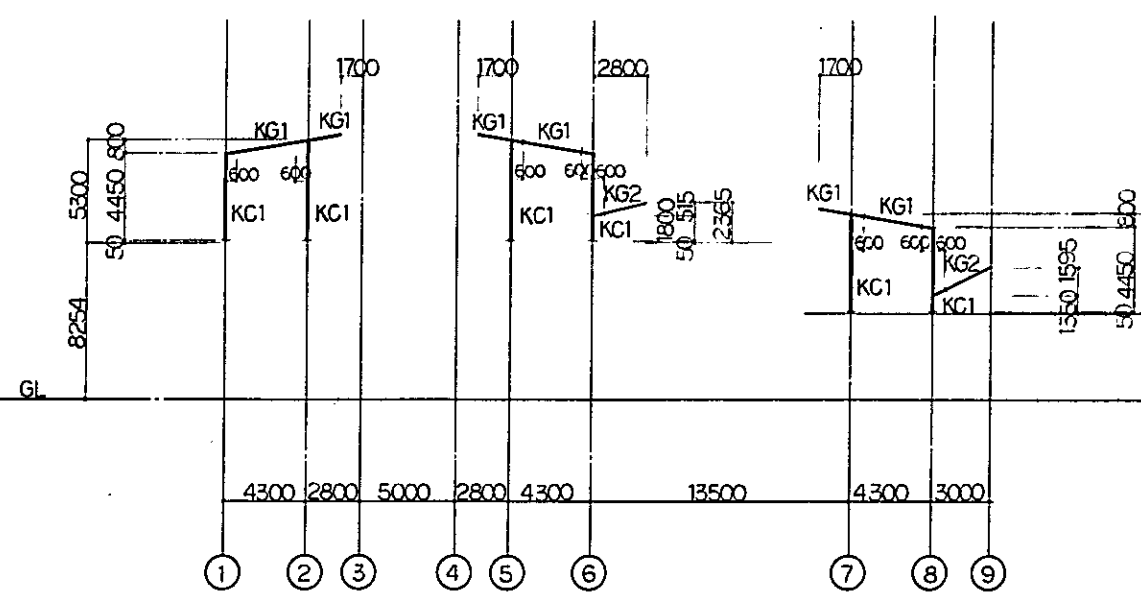

LINE I, K, L  
SCALE 1:200

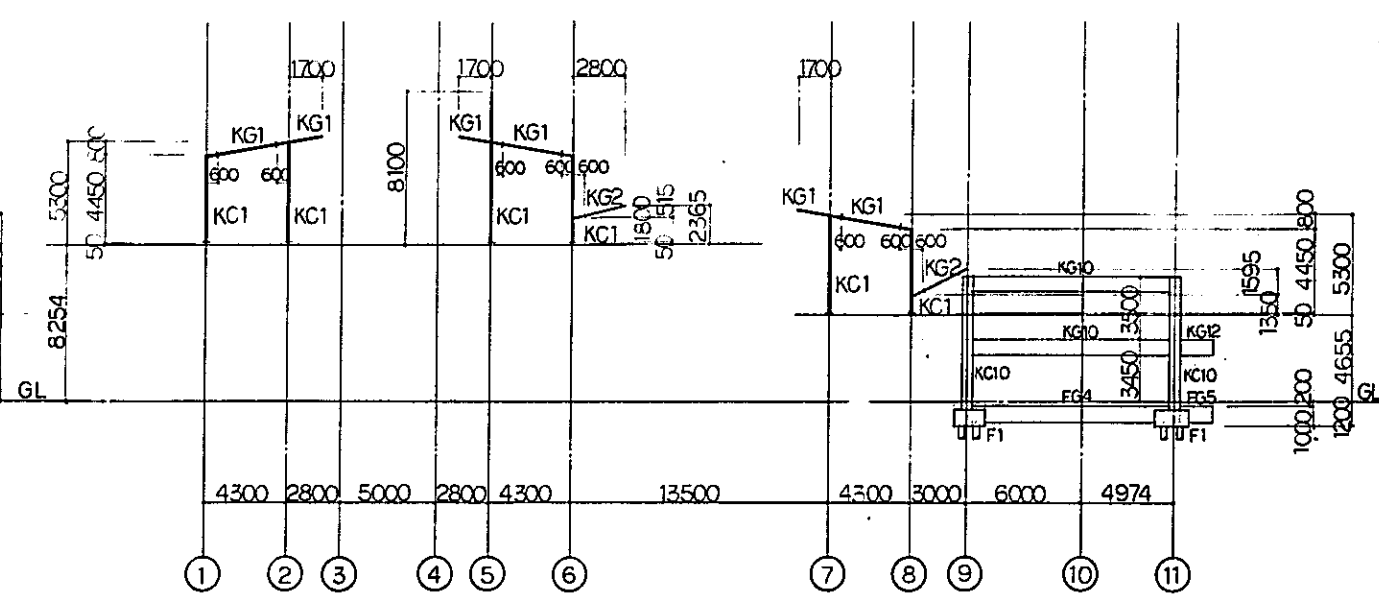

LINE J  
SCALE 1:200

REPUBLIC OF INDONESIA  
MINISTRY OF COMMUNICATIONS  
DIRECTORATE GENERAL OF LAND TRANSPORT  
AND INLAND WATERWAYS


NEW RAILWAY LINE FOR CENGKARENG AIRPORT  
CONSTRUCTION PROJECT

JAPAN INTERNATIONAL COOPERATION AGENCY  
(JICA)

| REVISIONS | DATE           | DESIGNED | DRAWN | CHECKED | REVIEWED | SUBMITTED |
|-----------|----------------|----------|-------|---------|----------|-----------|
| B         | 14 FEB 29 2011 | HM       | SM    | K.M.    | AK       |           |
| A         | 14 FEB 29 2011 | HM       | SM    | K.M.    | AK       |           |

KOTA INTAN STATION  
FRAMING ELEVATION  
( SHEET 2 OF 2 )

PACKAGE: I CIVIL AND ARCHITECTURAL WORK  
SCALE: 1:200 DRAWING NO: AS - 016

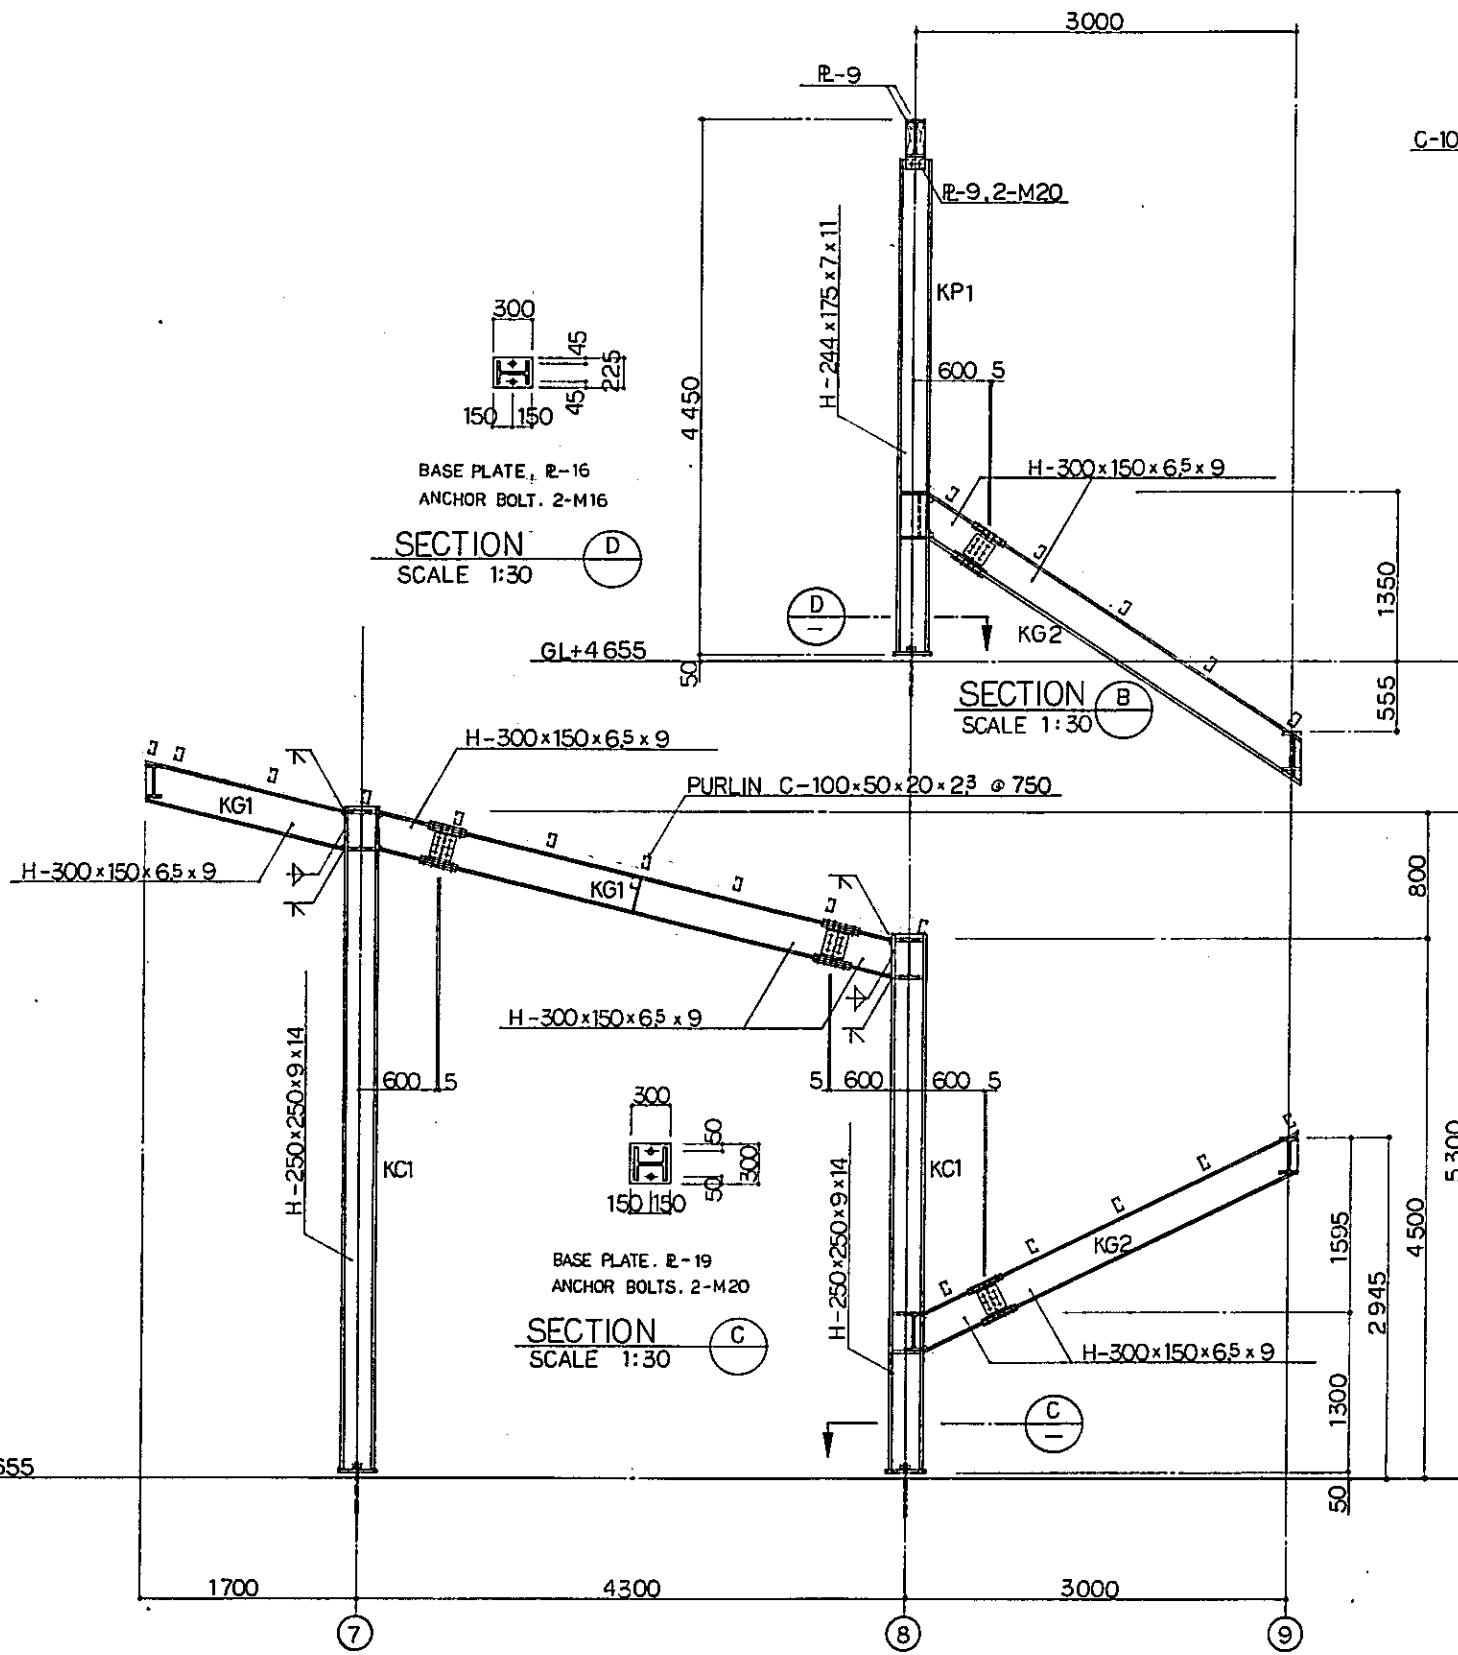


SECTION D  
SCALE 1:30

SECTION B  
SCALE 1:30

SECTION C  
SCALE 1:30

① LINE FRAMING DETAIL  
SCALE 1:30

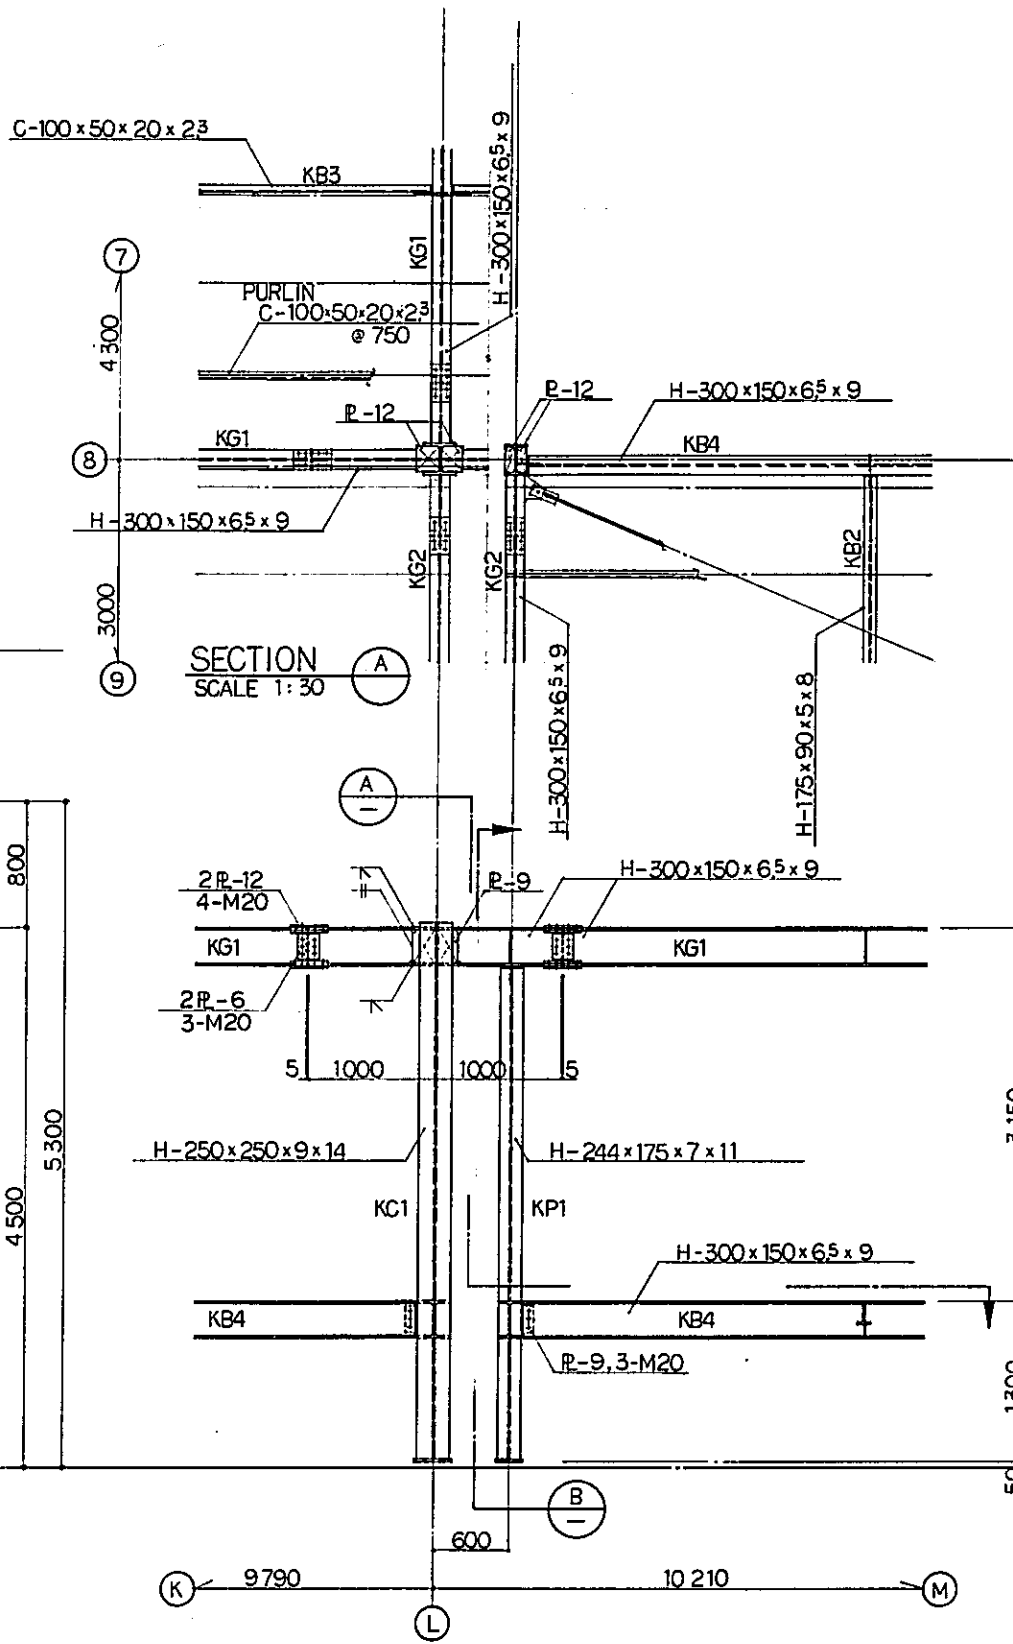


SECTION A  
SCALE 1:30

② LINE FRAMING DETAIL  
SCALE 1:30


|  |             |          |       |         |          |
|--|-------------|----------|-------|---------|----------|
| REPUBLIC OF INDONESIA<br>MINISTRY OF COMMUNICATIONS<br>DIRECTORATE GENERAL OF LAND TRANSPORT<br>AND INLAND WATERWAYS |             |          |       |         |          |
| NEW RAILWAY LINE FOR CENGKARENG AIRPORT<br>CONSTRUCTION PROJECT  |             |          |       |         |          |
| JAPAN INTERNATIONAL COOPERATION AGENCY<br>(JICA)   |             |          |       |         |          |
| B  | 1 AUG 89    | PLAN     | PLAN  | PLAN    | K.M.     |
| A  | 1 FEB 88    | PLAN     | PLAN  | PLAN    | K.M.     |
| REVISIONS  | DATE        | DESIGNED | DRAWN | CHECKED | REVIEWED |
| KOTA INTAN STATION<br>FRAMING DETAIL<br>( SHEET 1 OF 2 )   |             |          |       |         |          |
| PACKAGE: I CIVIL AND ARCHITECTURAL WORK  |             |          |       |         |          |
| SCALE  | DRAWING NO. |          |       |         |          |
| 1:30   | AS - 017    |          |       |         |          |



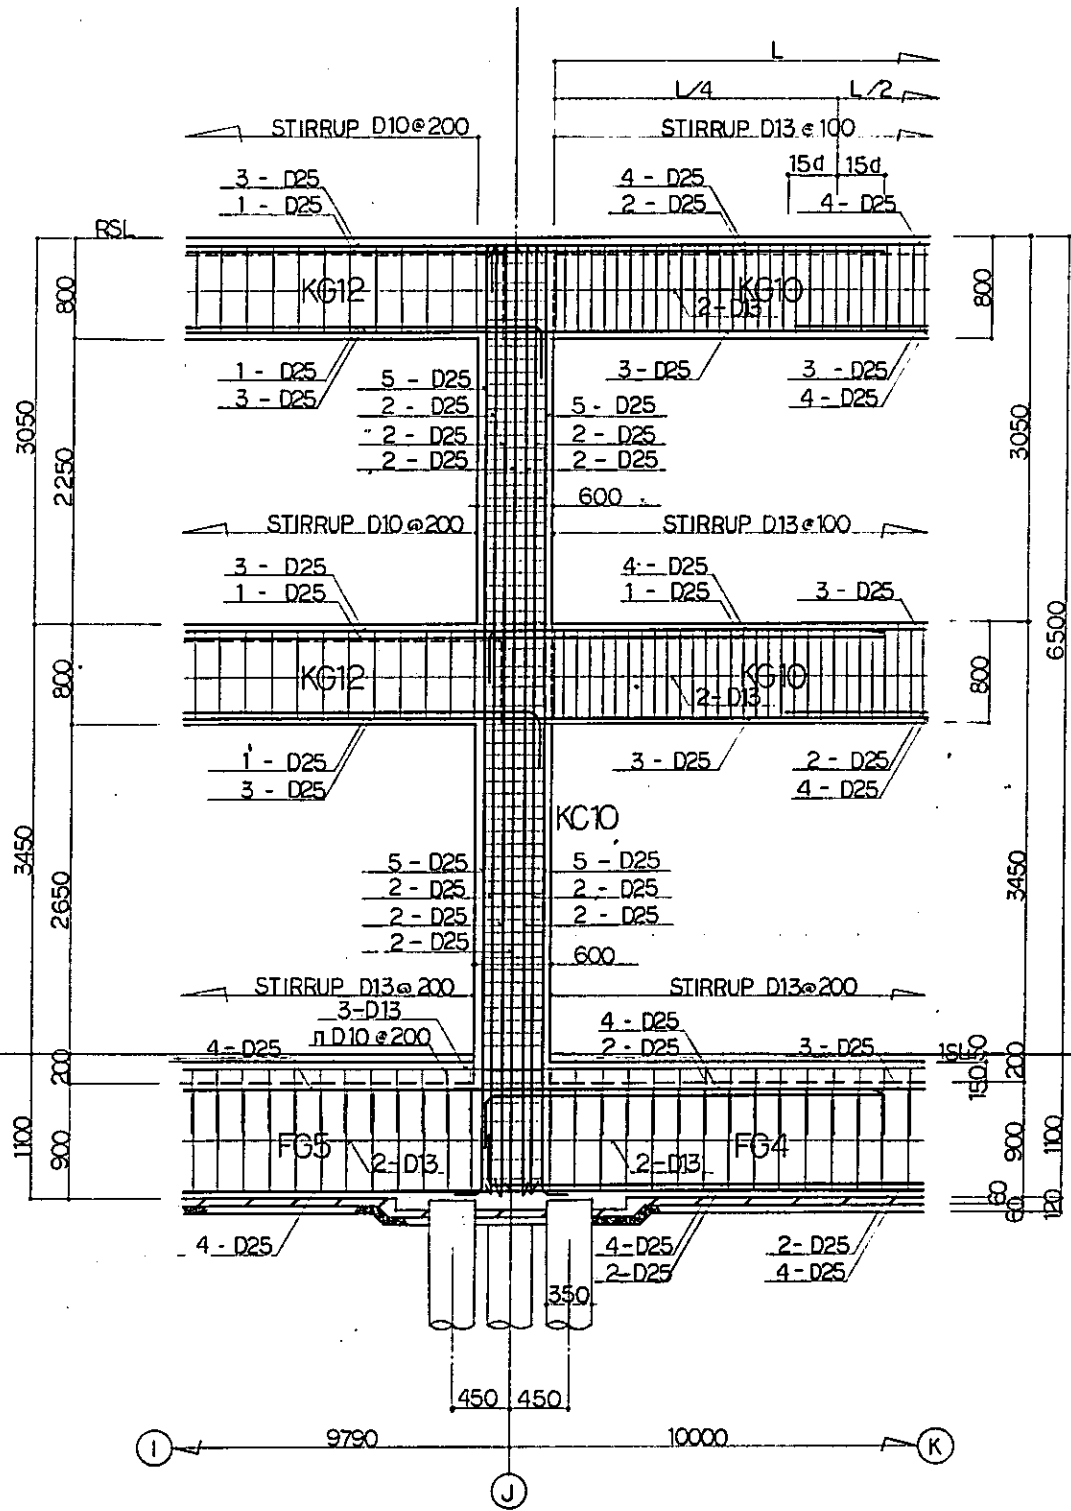

(I) LINE FRAMING DETAIL  
SCALE 1:30

UNLESS OTHERWISE NOTED  
WEB BAR : 2-D10

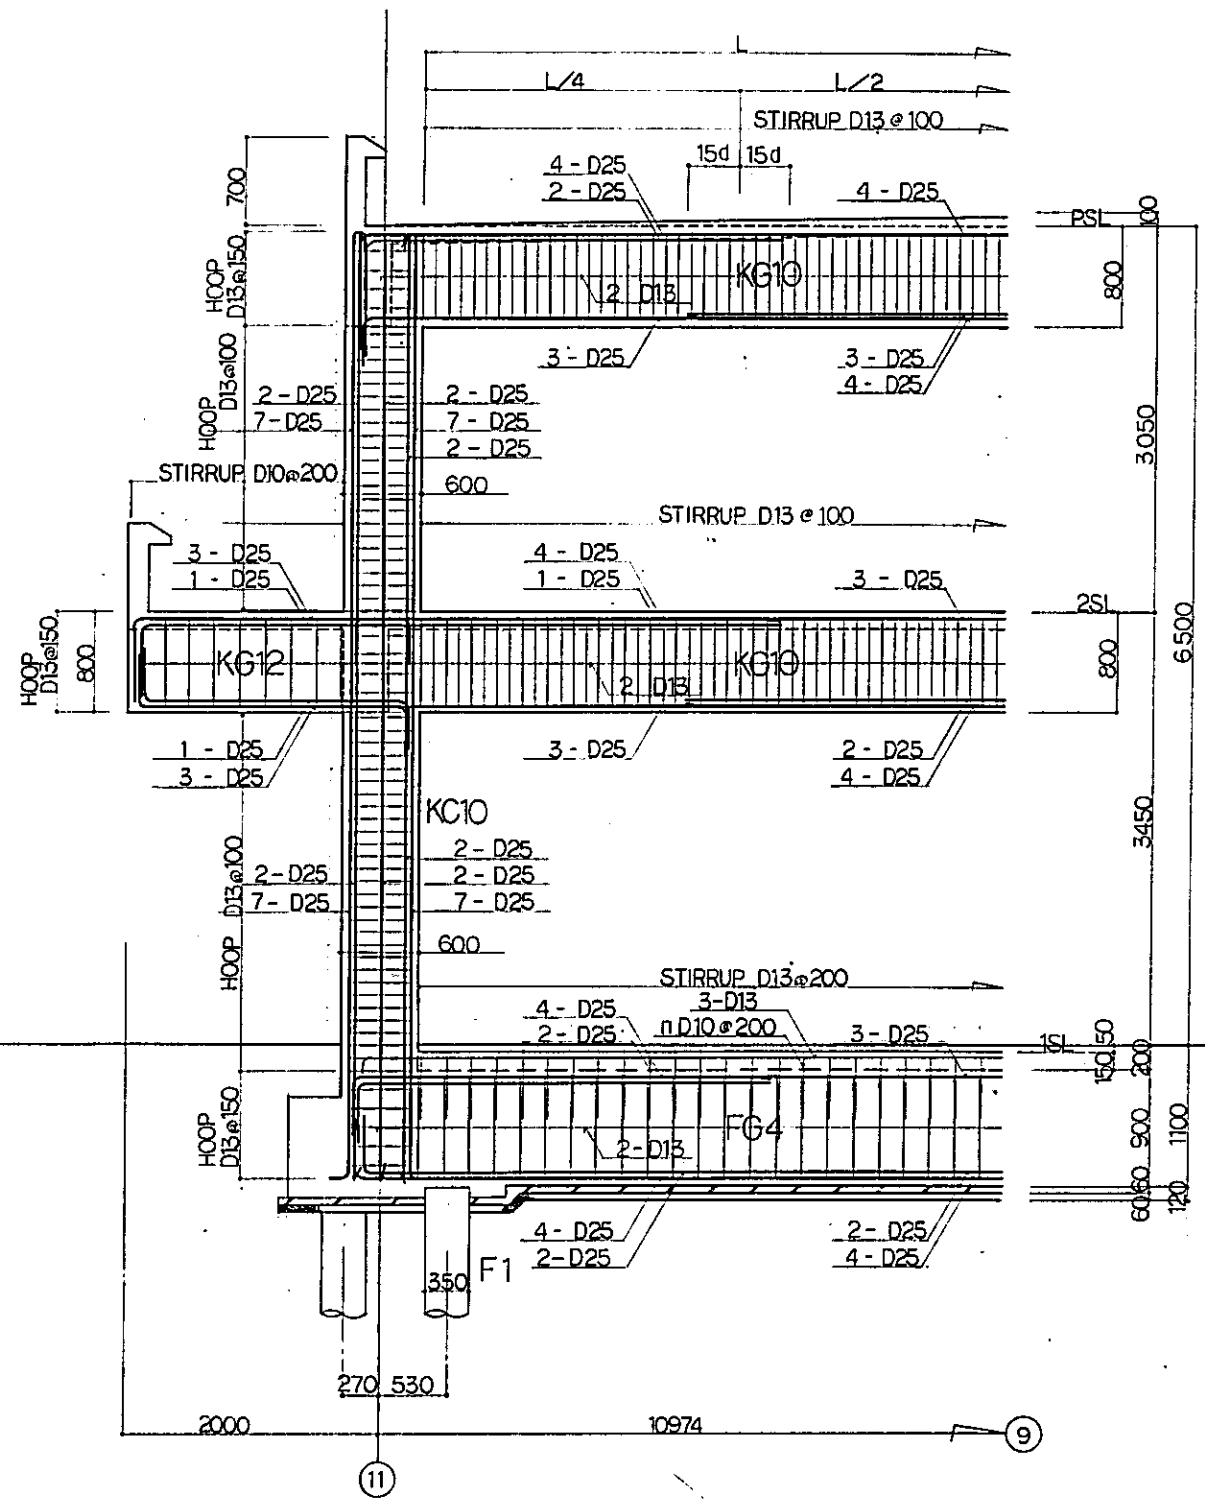

(J) LINE FRAMING DETAIL  
SCALE 1:30

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AND INLAND WATERWAYS

NEW RAILWAY LINE FOR CENGKARENG AIRPORT  
CONSTRUCTION PROJECT

JAPAN INTERNATIONAL COOPERATION AGENCY  
(JICA)


|   |           |    |    |    |    |    |
|---|-----------|----|----|----|----|----|
| B | 1 AUG 89  | DR | DR | DR | DR | DR |
| A | 15 FEB 89 | DR | DR | DR | DR | DR |

REVISIONS    DATE    DESIGNED    DRAWN    CHECKED    REVIEWED    SUBMITTED

KOTA INTAN STATION  
FRAMING DETAIL  
( SHEET 2 OF 2 )

PACKAGE: I CIVIL AND ARCHITECTURAL WORK  
SCALE: 1:30    DRAWING NO: AS - 018


SIGNAL CABIN (A)

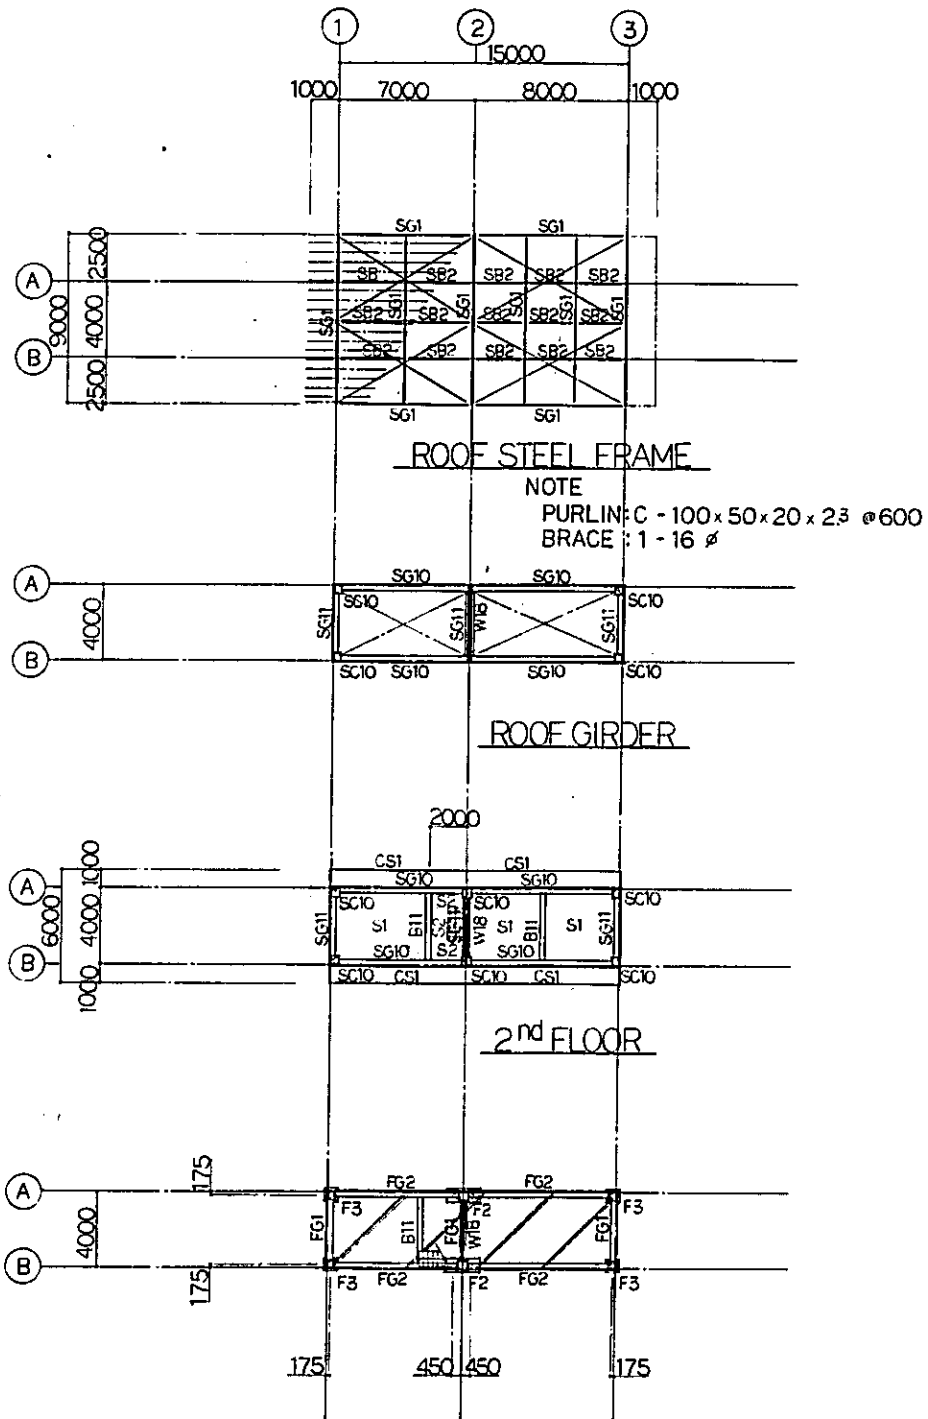

FOUNDATION PLAN  
NOTE: [Hatched Box] SHOWS SLAB ON GRADE

FRAMING PLAN  
SCALE 1:200


SIGNAL CABIN (B)

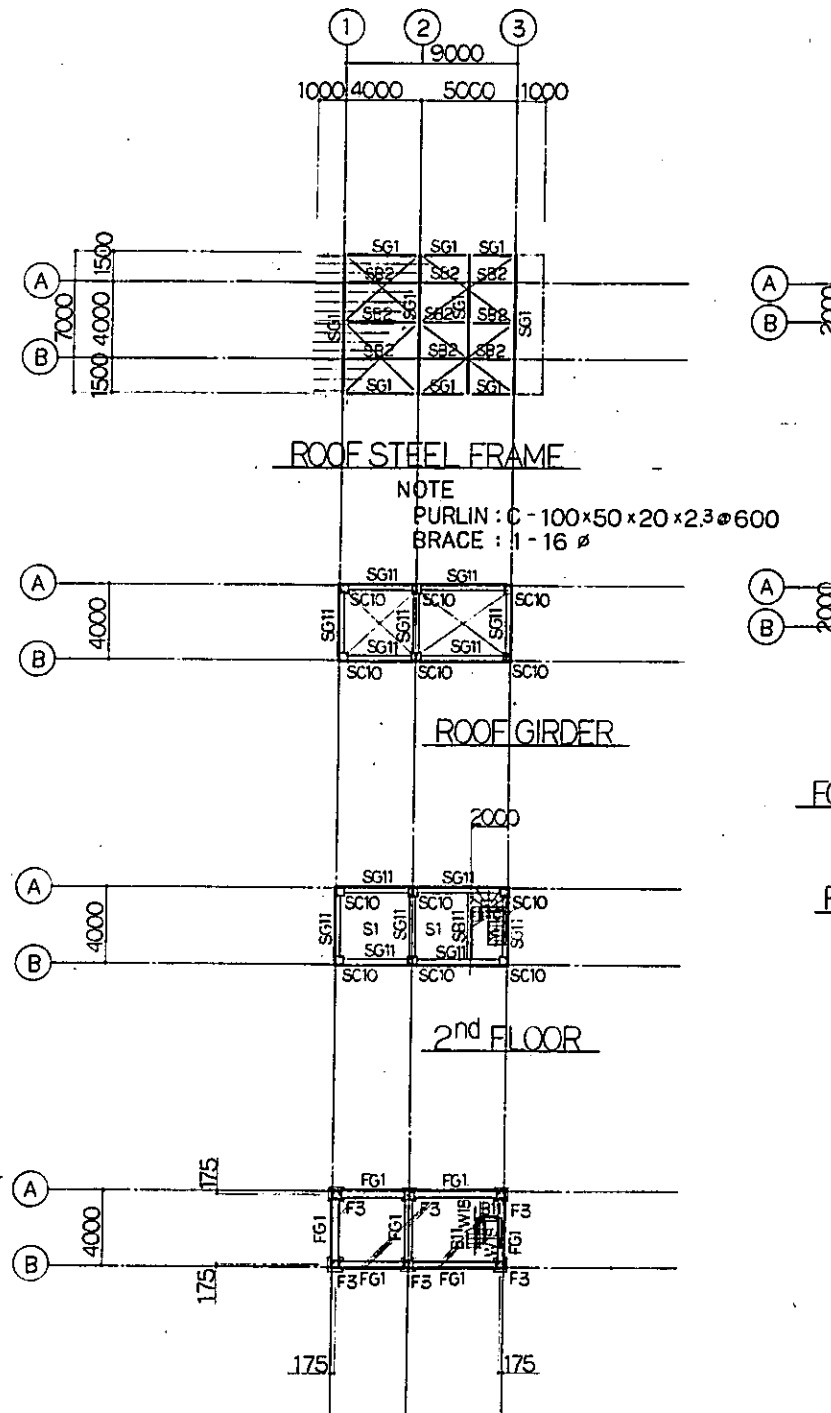

FOUNDATION PLAN  
NOTE: [Hatched Box] SHOWS SLAB ON GRADE

FRAMING PLAN  
SCALE 1:200


WATCHMAN BOX

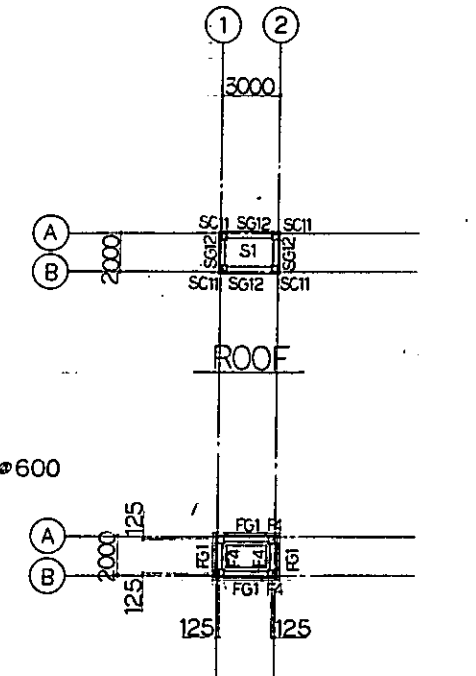

FOUNDATION PLAN  
NOTE: [Hatched Box] SHOWS SLAB ON GRADE

FRAMING PLAN  
SCALE 1:200

|  |             |          |       |         |          |
|--|-------------|----------|-------|---------|----------|
| REPUBLIC OF INDONESIA<br>MINISTRY OF COMMUNICATIONS<br>DIRECTORATE GENERAL OF LAND TRANSPORT<br>AND INLAND WATERWAYS |             |          |       |         |          |
| NEW RAILWAY LINE FOR CENKARENG AIRPORT<br>CONSTRUCTION PROJECT   |             |          |       |         |          |
| JAPAN INTERNATIONAL COOPERATION AGENCY<br>(JICA)   |             |          |       |         |          |
| REVISIONS  | DATE        | DESIGNED | DRAWN | CHECKED | REVIEWED |
| B  | 1 AUG. 79   | AK       | Ban   | K.M.    | AK       |
| A  | 15 FEB. 79  | AK       | Sig   | K.M.    | AK       |
| SIGNAL CABIN A, B AND<br>CROSSING WATCHMAN'S BOX<br>FRAMING PLAN   |             |          |       |         |          |
| PACKAGE: 1 CIVIL AND ARCHITECTURAL WORK  |             |          |       |         |          |
| SCALE  | DRAWING NO. |          |       |         |          |
| 1:200  | AS - 019    |          |       |         |          |

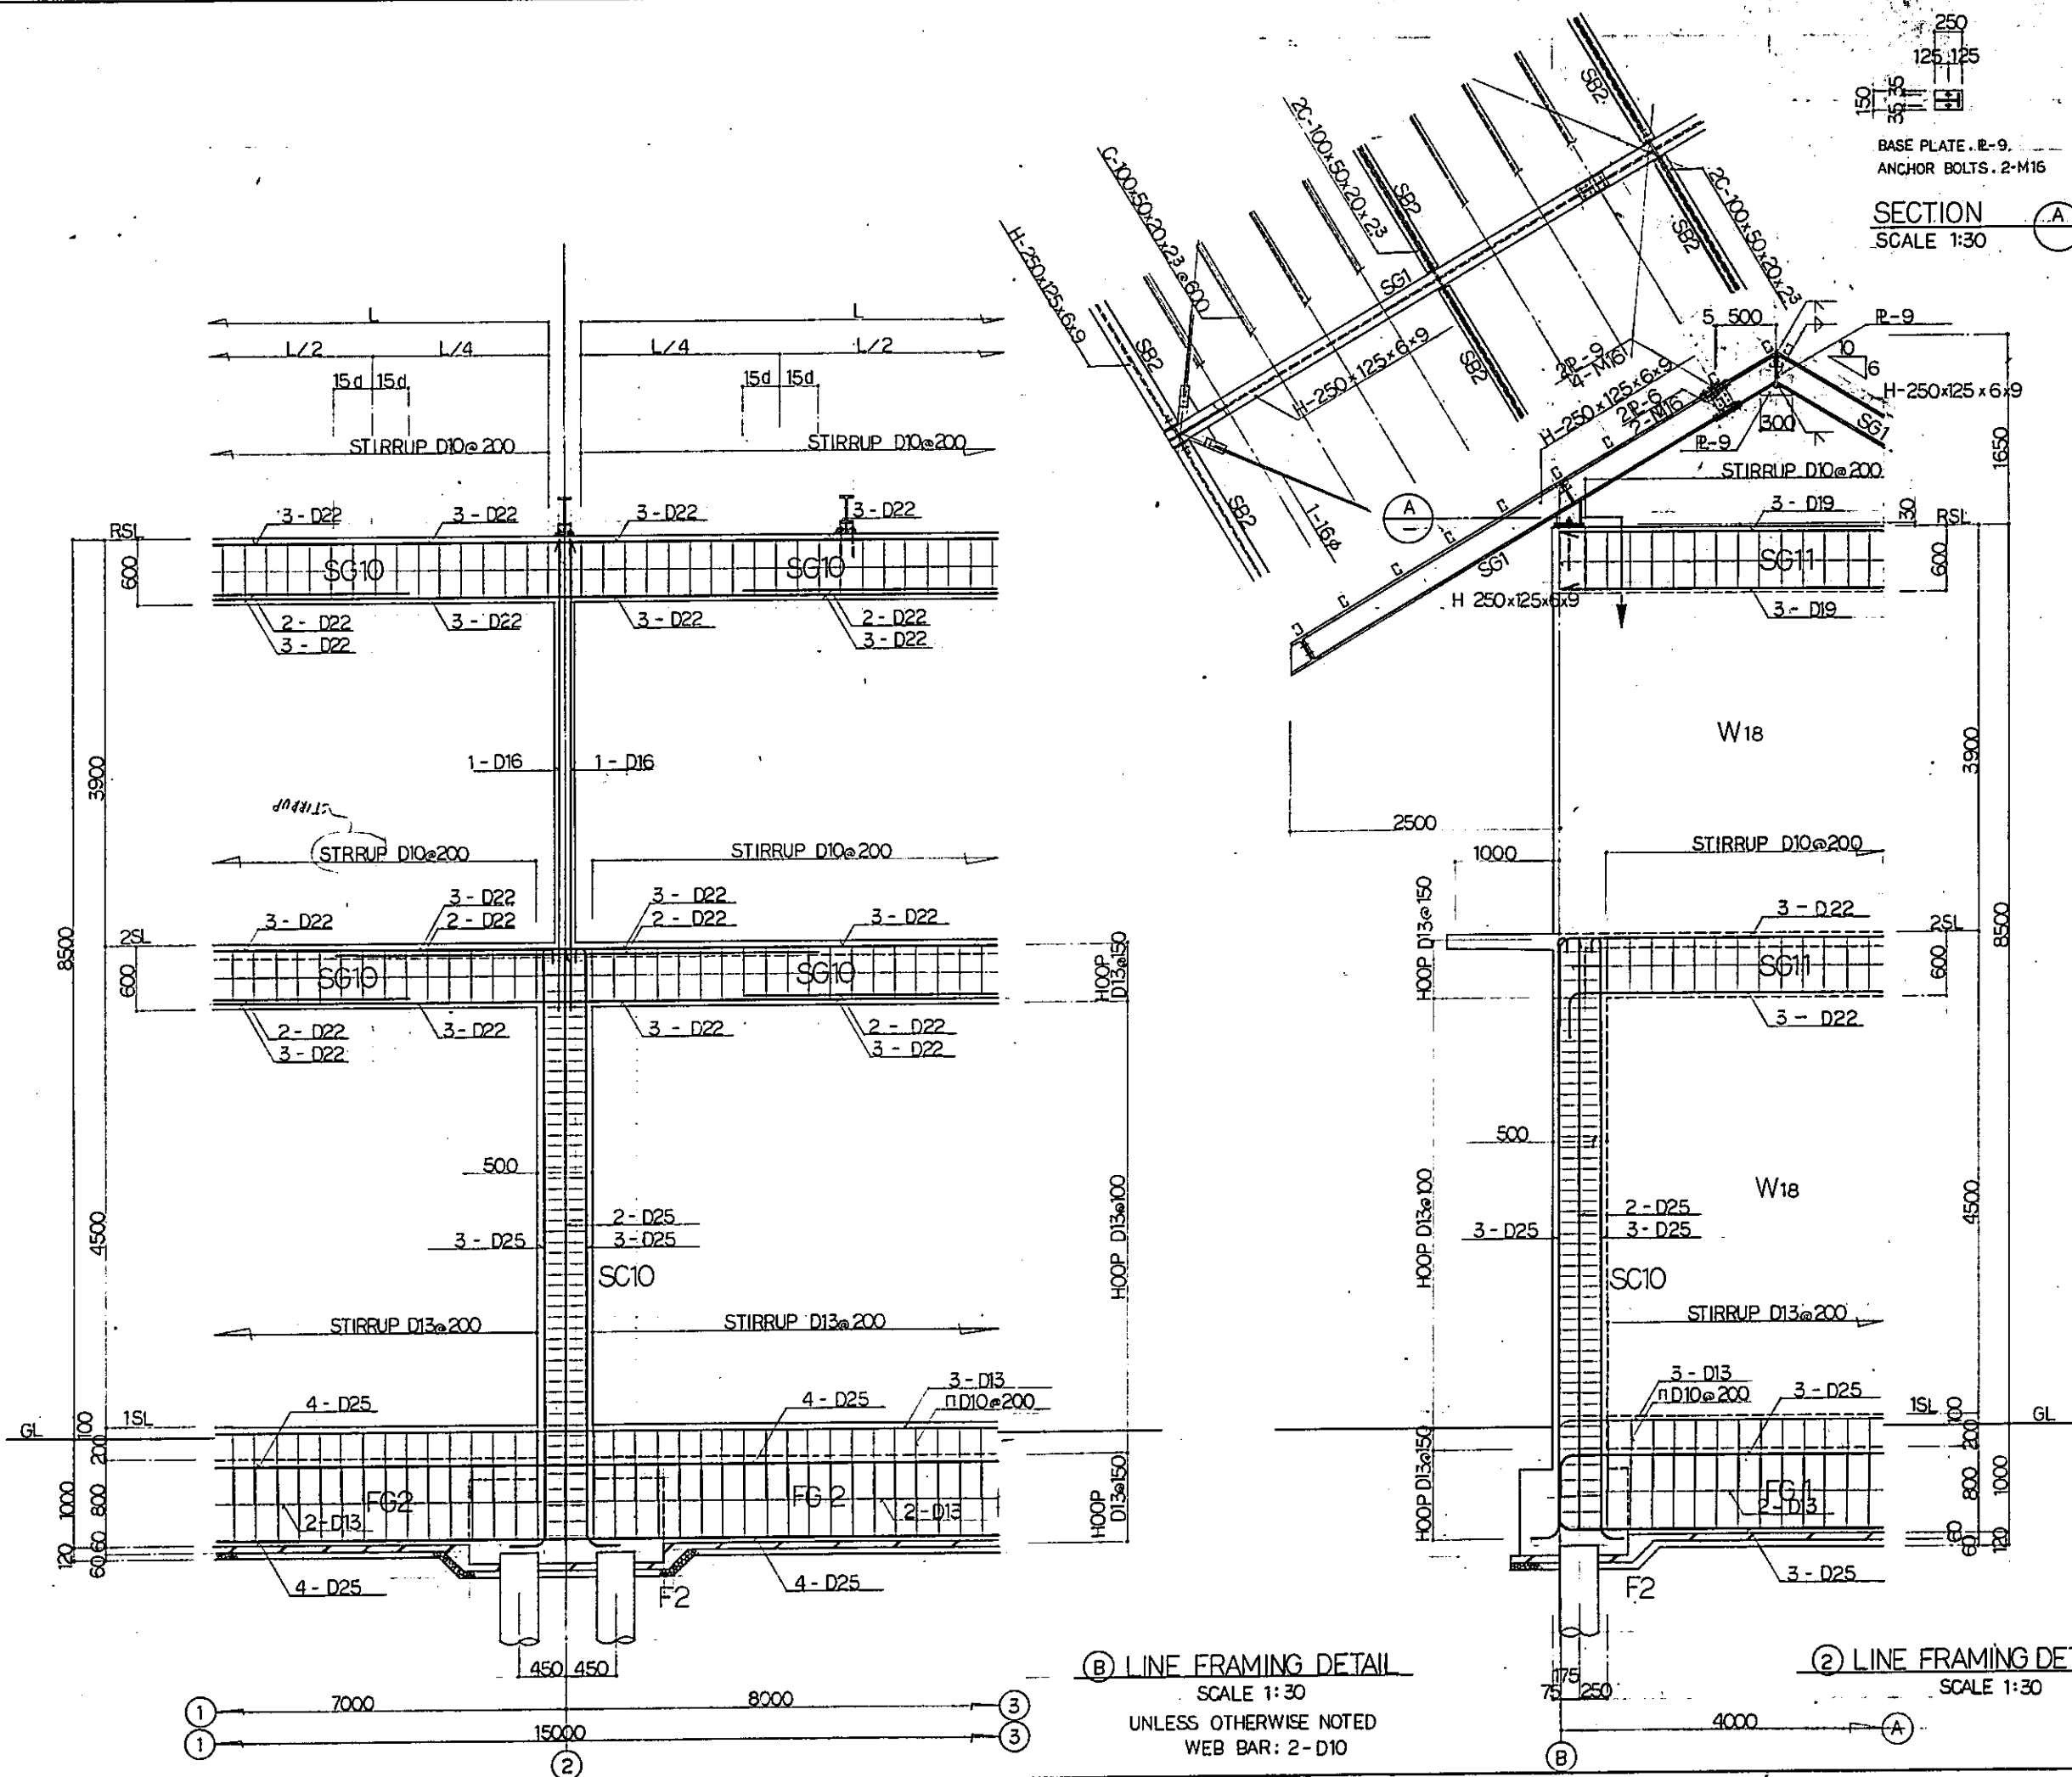

250  
125.125  
50  
36  
BASE PLATE . R-9  
ANCHOR BOLTS . 2-M16  
SECTION **A**  
SCALE 1:30

**(B) LINE FRAMING DETAIL**  
SCALE 1:30  
UNLESS OTHERWISE NOTED  
WEB BAR : 2-D10

**(A) LINE FRAMING DETAIL**  
SCALE 1:30

|  |                    |          |         |         |          |
|--|--------------------|----------|---------|---------|----------|
| REPUBLIC OF INDONESIA<br>MINISTRY OF COMMUNICATIONS<br>DIRECTORATE GENERAL OF LAND TRANSPORT<br>AND INLAND WATERWAYS |                    |          |         |         |          |
| NEW RAILWAY LINE FOR CENGKARENG AIRPORT<br>CONSTRUCTION PROJECT  |                    |          |         |         |          |
| JAPAN INTERNATIONAL COOPERATION AGENCY<br>(JICA)   |                    |          |         |         |          |
| B  | 1 AUG 79           | 1/1/79   | 2/1/79  | 3/1/79  | K.M. MK  |
| A  | 15 FEB 84          | 9/1/84   | 11/1/84 | 12/1/84 | K.M. MK  |
| REVISIONS  | DATE               | DESIGNED | DRAWN   | CHECKED | REVIEWED |
| SIGNAL CABIN A<br>FRAMING DETAIL   |                    |          |         |         |          |
| PACKAGE: I CIVIL AND ARCHITECTURAL WORK  |                    |          |         |         |          |
| SCALE 1:30   | DRAWING NO. AS-020 |          |         |         |          |